FED. ROAD STATE		FED. AID PROJ. NO.	FISCAL YEAR	SHEET NO.	TOTAL SHEETS	
HAWAII	HAW.	I-H3-1(75), UNIT I	1996	350	405	

<u>ABBREVIATIONS</u>

COMM Communications

CMB Comcrete Median Barrier

DA (XX) Detector Amplifier

Diameter DIA

Electrical Ground GND

Electrical Service Panel CS

ECG (XX) Emergency Crossover Gate

ECGC (XX) Emergency Crossover Gate Controller

ETIB (XX) Emergency Telephone Inbound

ETOB (XX) Emergency Telephone Outbound

FO HUB (XX) Fiber Optic Hub

Galvanized Ridgid Steel

Multimode Fiberoptic Cable (XX) MM

National Electrical Manufacturers Association NEMA

GRS

Programmable Logic Controller

Pair

RECPT Receptacle

Street Lighting

TV (XX) Television Controller

TC (XX) Traffic Controller

KVA 1,000 Volt Amps

With Shield W/SHLD

<u>SYMBOLS</u>

Advance Warning Sign

Conduit/Cable Note

Construction Note


Emergency Crossover Gate Emergency Crossover Gate Controller

Existing Electrical Service

Existing Fiberoptic Hub

Existing Pullbox

Existing Traffic Controller

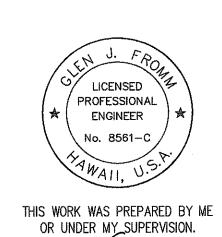

STATE OF HAWAII

DEPARTMENT OF TRANSPORTATION

HIGHWAYS DIVISION

SYSTEMS LEGEND AND ABBREVIATION

INTERSTATE ROUTE H-3 FAIP NO. I-H3-1(75), UNIT I

SCALE: NONE

DATE: JANUARY 1996

SHEET NO. SY1 OF 9 SHEETS


Last Saved: J:\H3RF\U1\CROSSOVR\LEGEND.dwg 01/08/96 at 15:10

FED. ROAD DIST. NO.	Ι ΔΙΔΙΘ Ι		FISCAL YEAR	SHEET NO.	TOTAL SHEETS
HAWAII	HAW.	I-H3-1(75), UNIT I	1996	351	405

			CONDUIT / CAE	BLE SCHEDULE			
RUN NO. NEW		NDUIT EXISTING	CABLE / CONDUCTOR	USED FOR	REMARKS		
1 2"			1—24mm (Existing)	Data/Comm.	Use 2 Fiber for ECGC 02 & 03		
0			1—12mm (Existing)	Data/Control	Use 2 Fiber for ECGC 03		
2		2"	1-4mm	Data/Control	Use 2 Fiber for ECGC 02		
3		3"	1—12mm (Existing)	Data/Control	Use 2 Fiber for ECGC 03		
A		-, %	3-#2 & GND	Power	480V Power to ECG 02 & 03		
4		3"	3-#2 & GND (Existing)	Power	480V Power to TC 38, 39 & 4		
5		2"	3-#2 & GND	Power	480V Power to ECG 02		
		739	3-#2 & GND (Existing)	Power	480V Power to TC 39 & 40.		
6		3"	3-#2 & GND	Power	480V Power to ECG 03		
7 4"		4"	1-4mm	Data/Control	Use 2 Fiber for ECGC 02		
8		4"	1-4mm	Data/Control	Use 2 Fiber for ECGC 02		
O		4	3-#8 & GND	Signals	120V Power, ECG 02 Beacon		
9		2"	3-#8 & GND	Signals	120V Power, ECG 02 Beacon		
10		2"	2-#6 & GND	Power	480V Power to TC 38		
19	0	3"	1—12mm (Existing)	Data/Comm.	Use 2 Fiber for ECGC 03		
			1-4mm	Data/Control	Use 2 Fiber for ECGC 03		
20		3"	3-#2 & GND (Existing)	Power	480V Power to TC 39 & 40.		
25		7,33	3-#2 & GND (Existing)	Power	480V Power to TC 38,39 & 40		
25		3"	3-#2 & GND	Power	480V Power to ECG 03		

CONSTRUCTION	NOTES

- Install wiring from conduit run #4 into existing panel CS and connect to "Future TC" breaker as indicated on Panel Schedule shown on Sheet E-6.
- Install, coil and store 5 feet of fiberoptic cable into existing fiberoptic hub FO 13. Seal end of cable from moisture and leakage of water blocking material. Fiber terminations to be done by others.
- Install, coil and store 5 feet of 1—4mm fiberoptic cable from ECGC 02 into existing TV 8E cabinet. Seal end of cable from moisture and leakage of water blocking material. Fiber terminations to be done by others.
- Provide splices in power feeder conductors for 480V power to ECG 02 & 03.
- Install, coil and store 5 feet of 1—4mm fiberoptic cable from ECGC 03 into existing splice cabinet. Seal end of cable from moisture and leakage of water blocking material. Fiber terminations to be done by others.
- Terminate 480V power feeder conductors in existing electrical pullbox adjacent to TC 39. Provide minimum 10 feet of slack in conductors and seal ends against moisture.

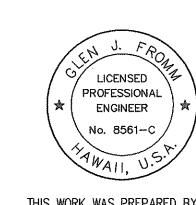


THIS WORK WAS PREPARED BY ME OR UNDER MY SUPERVISION.

STATE OF HAWAII DEPARTMENT OF TRANSPORTATION HIGHWAYS DIVISION SYSTEMS

EMERGENCY CROSSOVER KANEOHE INTERCHANGE

> INTERSTATE ROUTE H-3 FAIP NO. I-H3-1(75), UNIT I

SCALE: 1" = 200' DATE: JANUARY 1996 SHEET NO. SY2 OF 9 SHEETS

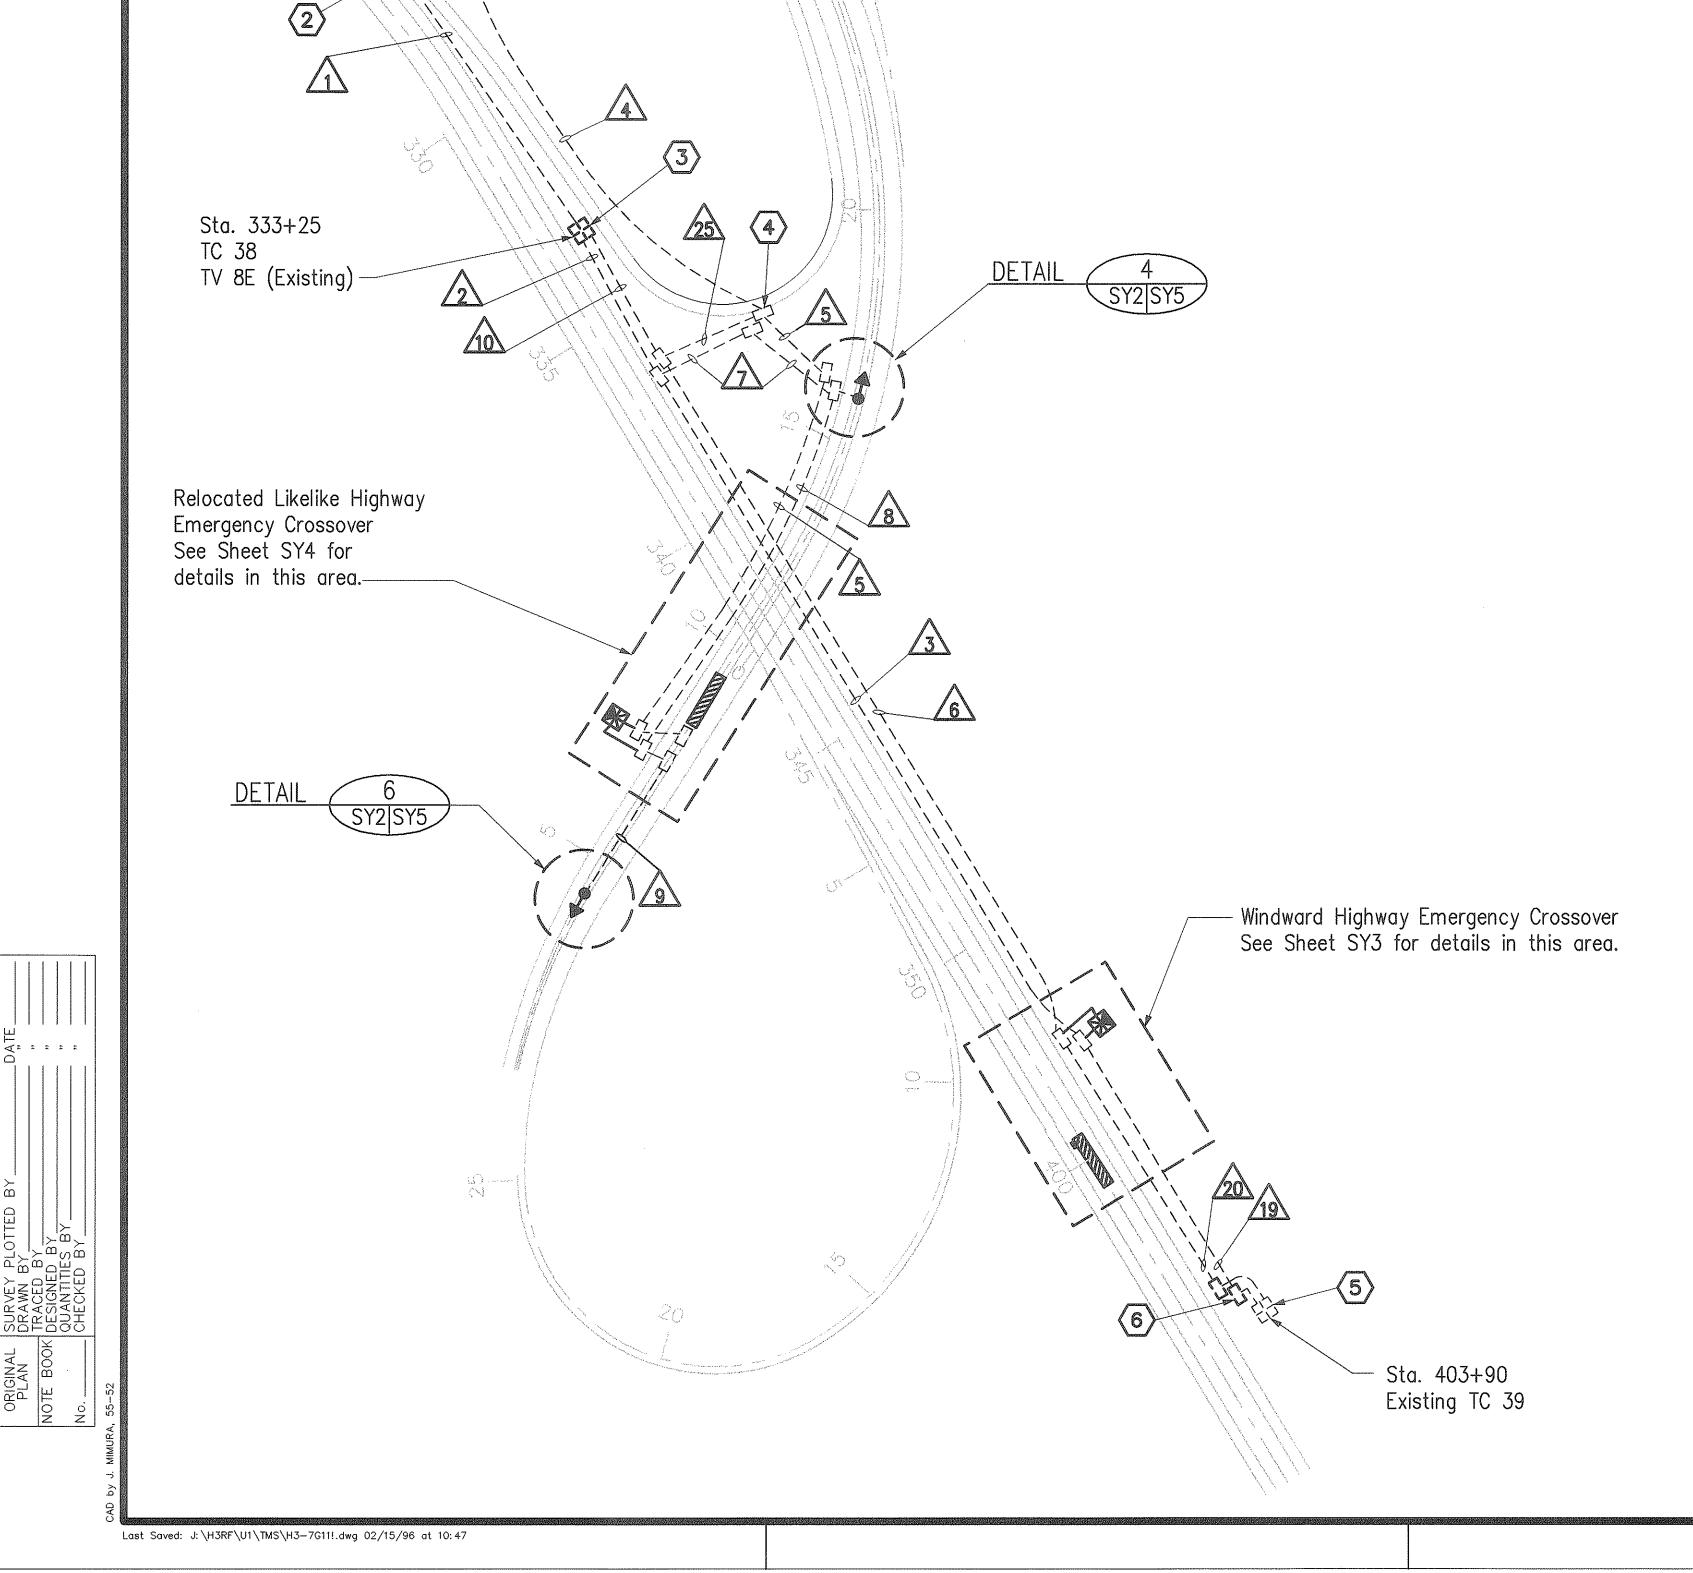


—Existing Electrical

-Sta. 1110+30

FO HUB 13 (Existing)

Service

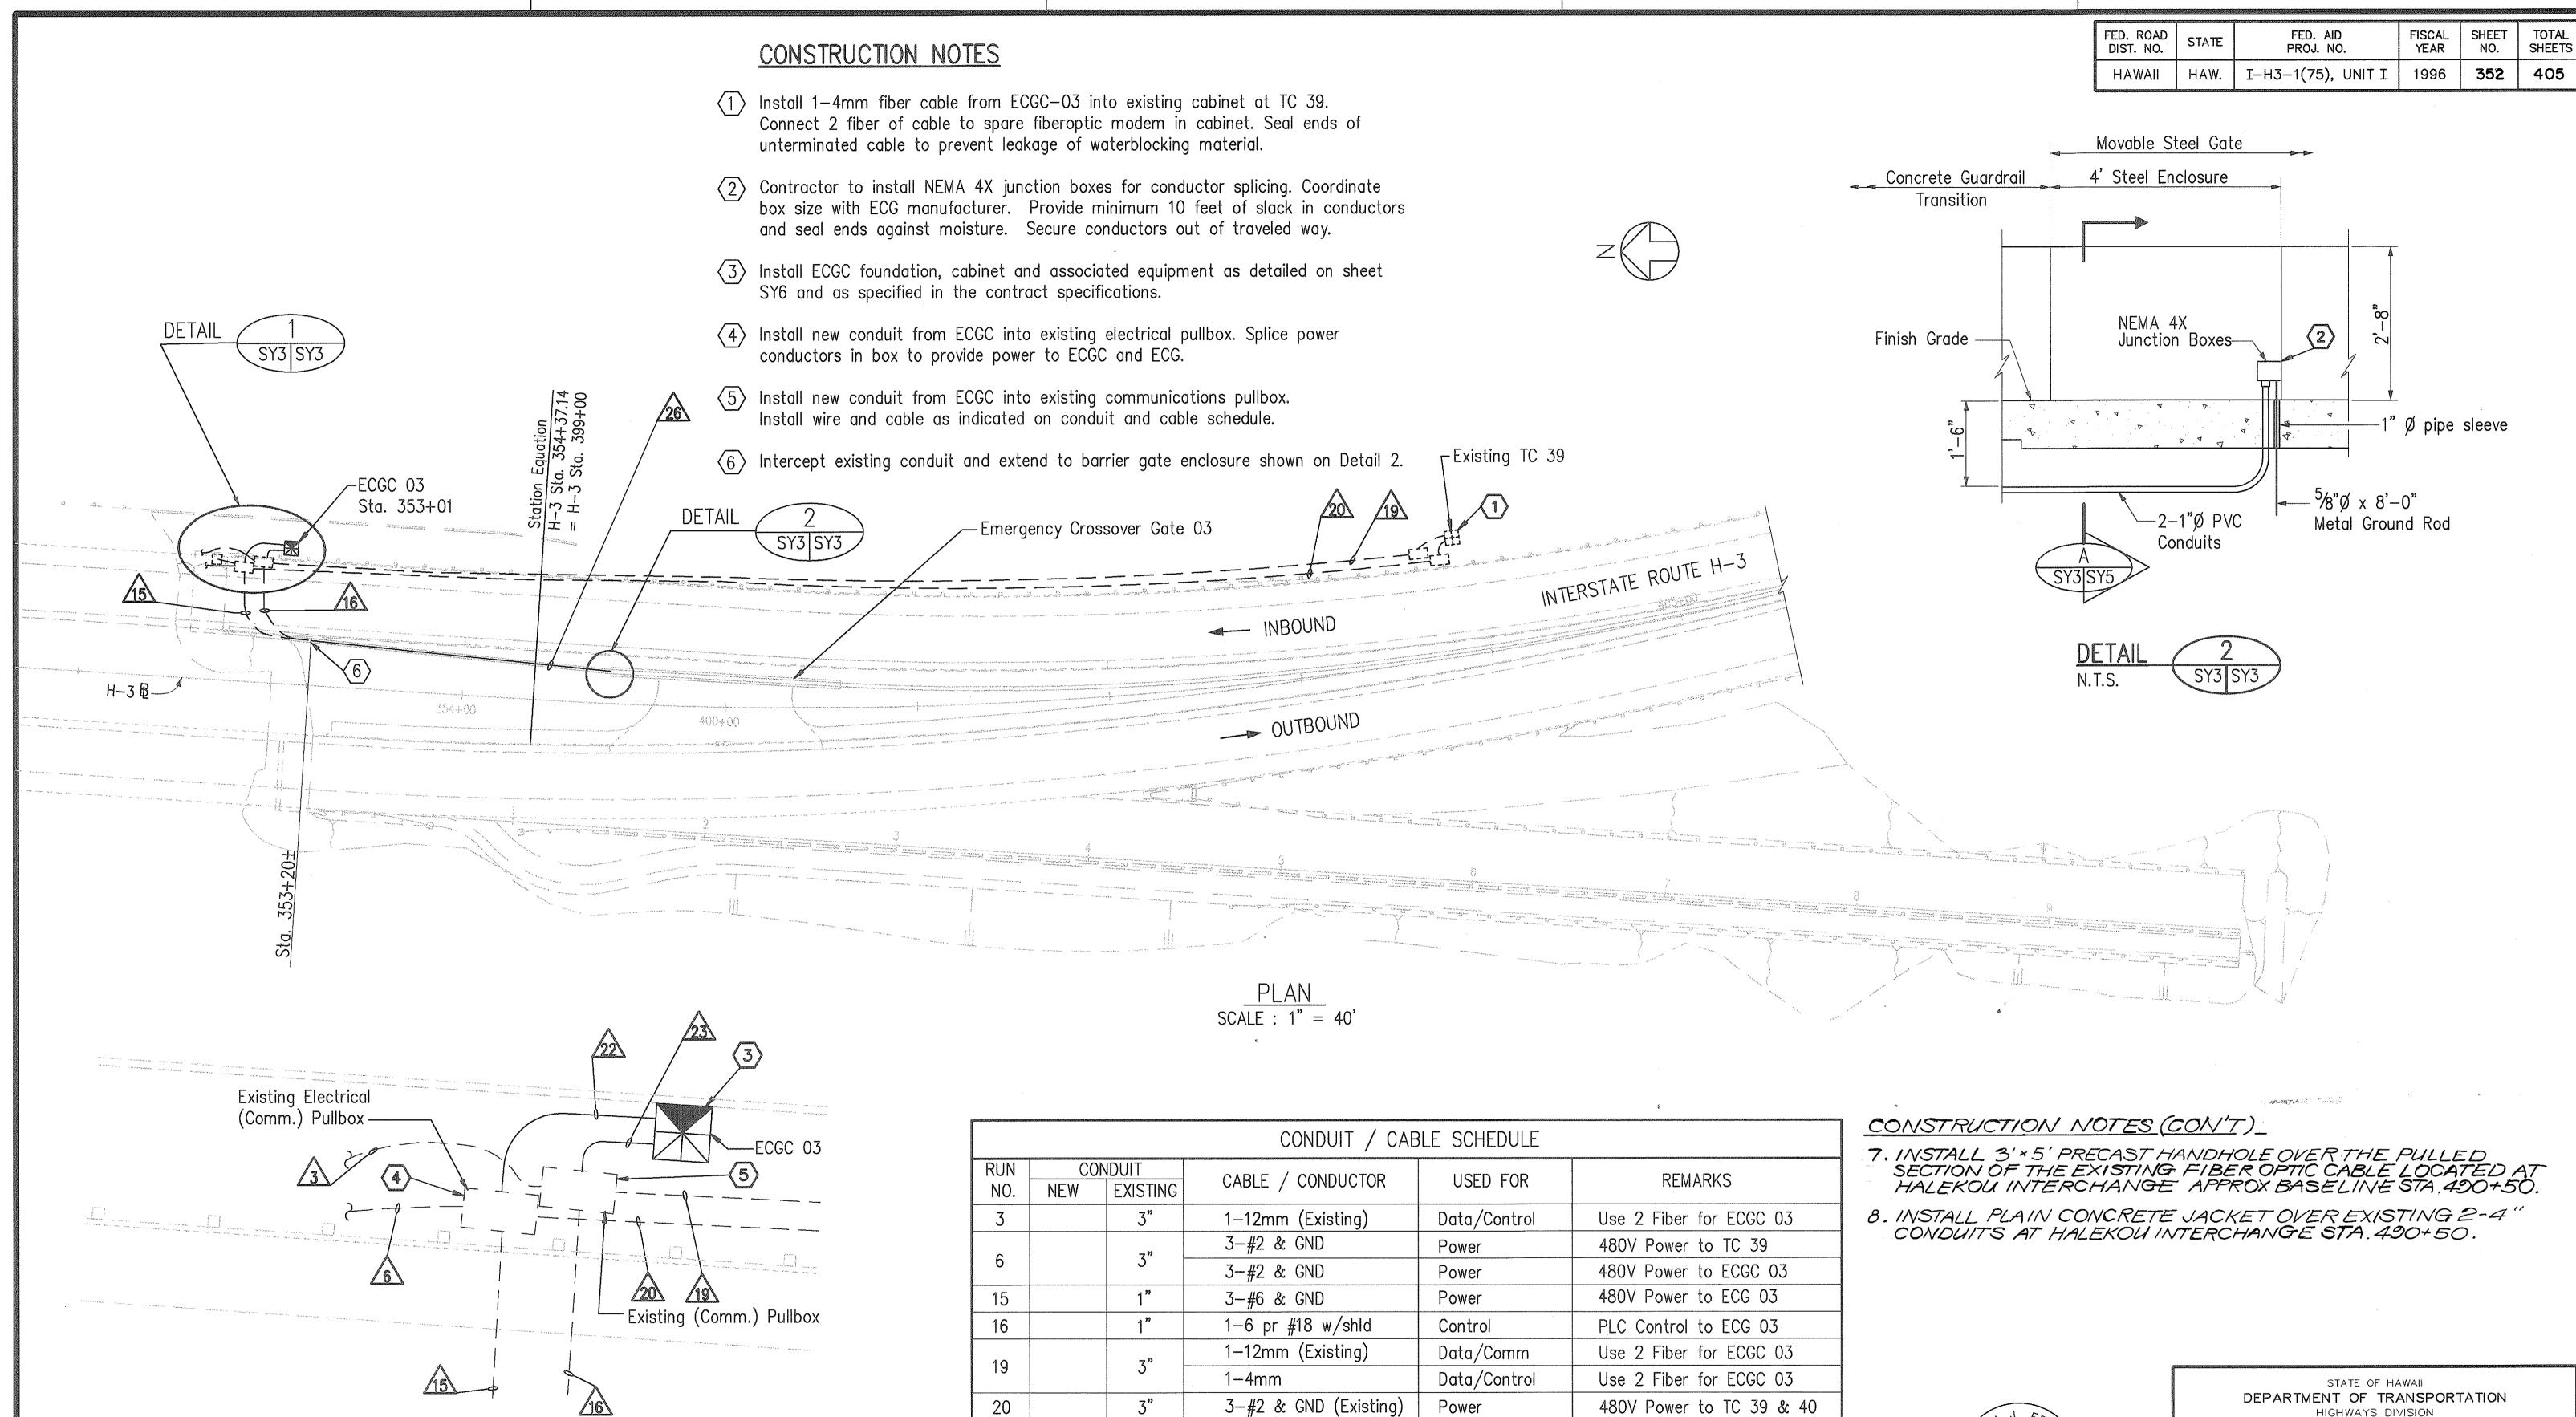

3-#6 & GND

3-#6 & GND

1-6 pr #18 w/shld

1-6 pr #18 w/shld

1-4mm

Power

Control

Power

Control

Data/Control

22

23

ECGC 03

STA. 353+01

Last Saved: J:\H3RF\U1\TMS\WNPLN__1!.dwg 02/14/96 at 08:35

2-1"

LICENSED PROFESSIONAL ENGINEER

480V Power to ECGC 03

Use 2 Fiber for ECGC 03

PLC Control to ECG 03

480V Power to ECG 03

PLC Control to ECG 03


THIS WORK WAS PREPARED BY ME OR UNDER MY SUPERVISION.

HIGHWAYS DIVISION <u>SYSTEMS</u> EMERGENCY CROSSOVER WINDWARD HIGHWAY

> INTERSTATE ROUTE H-3 FAIP NO. I-H3-1(75), UNIT I


DATE: JANUARY 1996 SCALE: AS SHOWN SHEET NO. SY3 OF 9 SHEETS


352

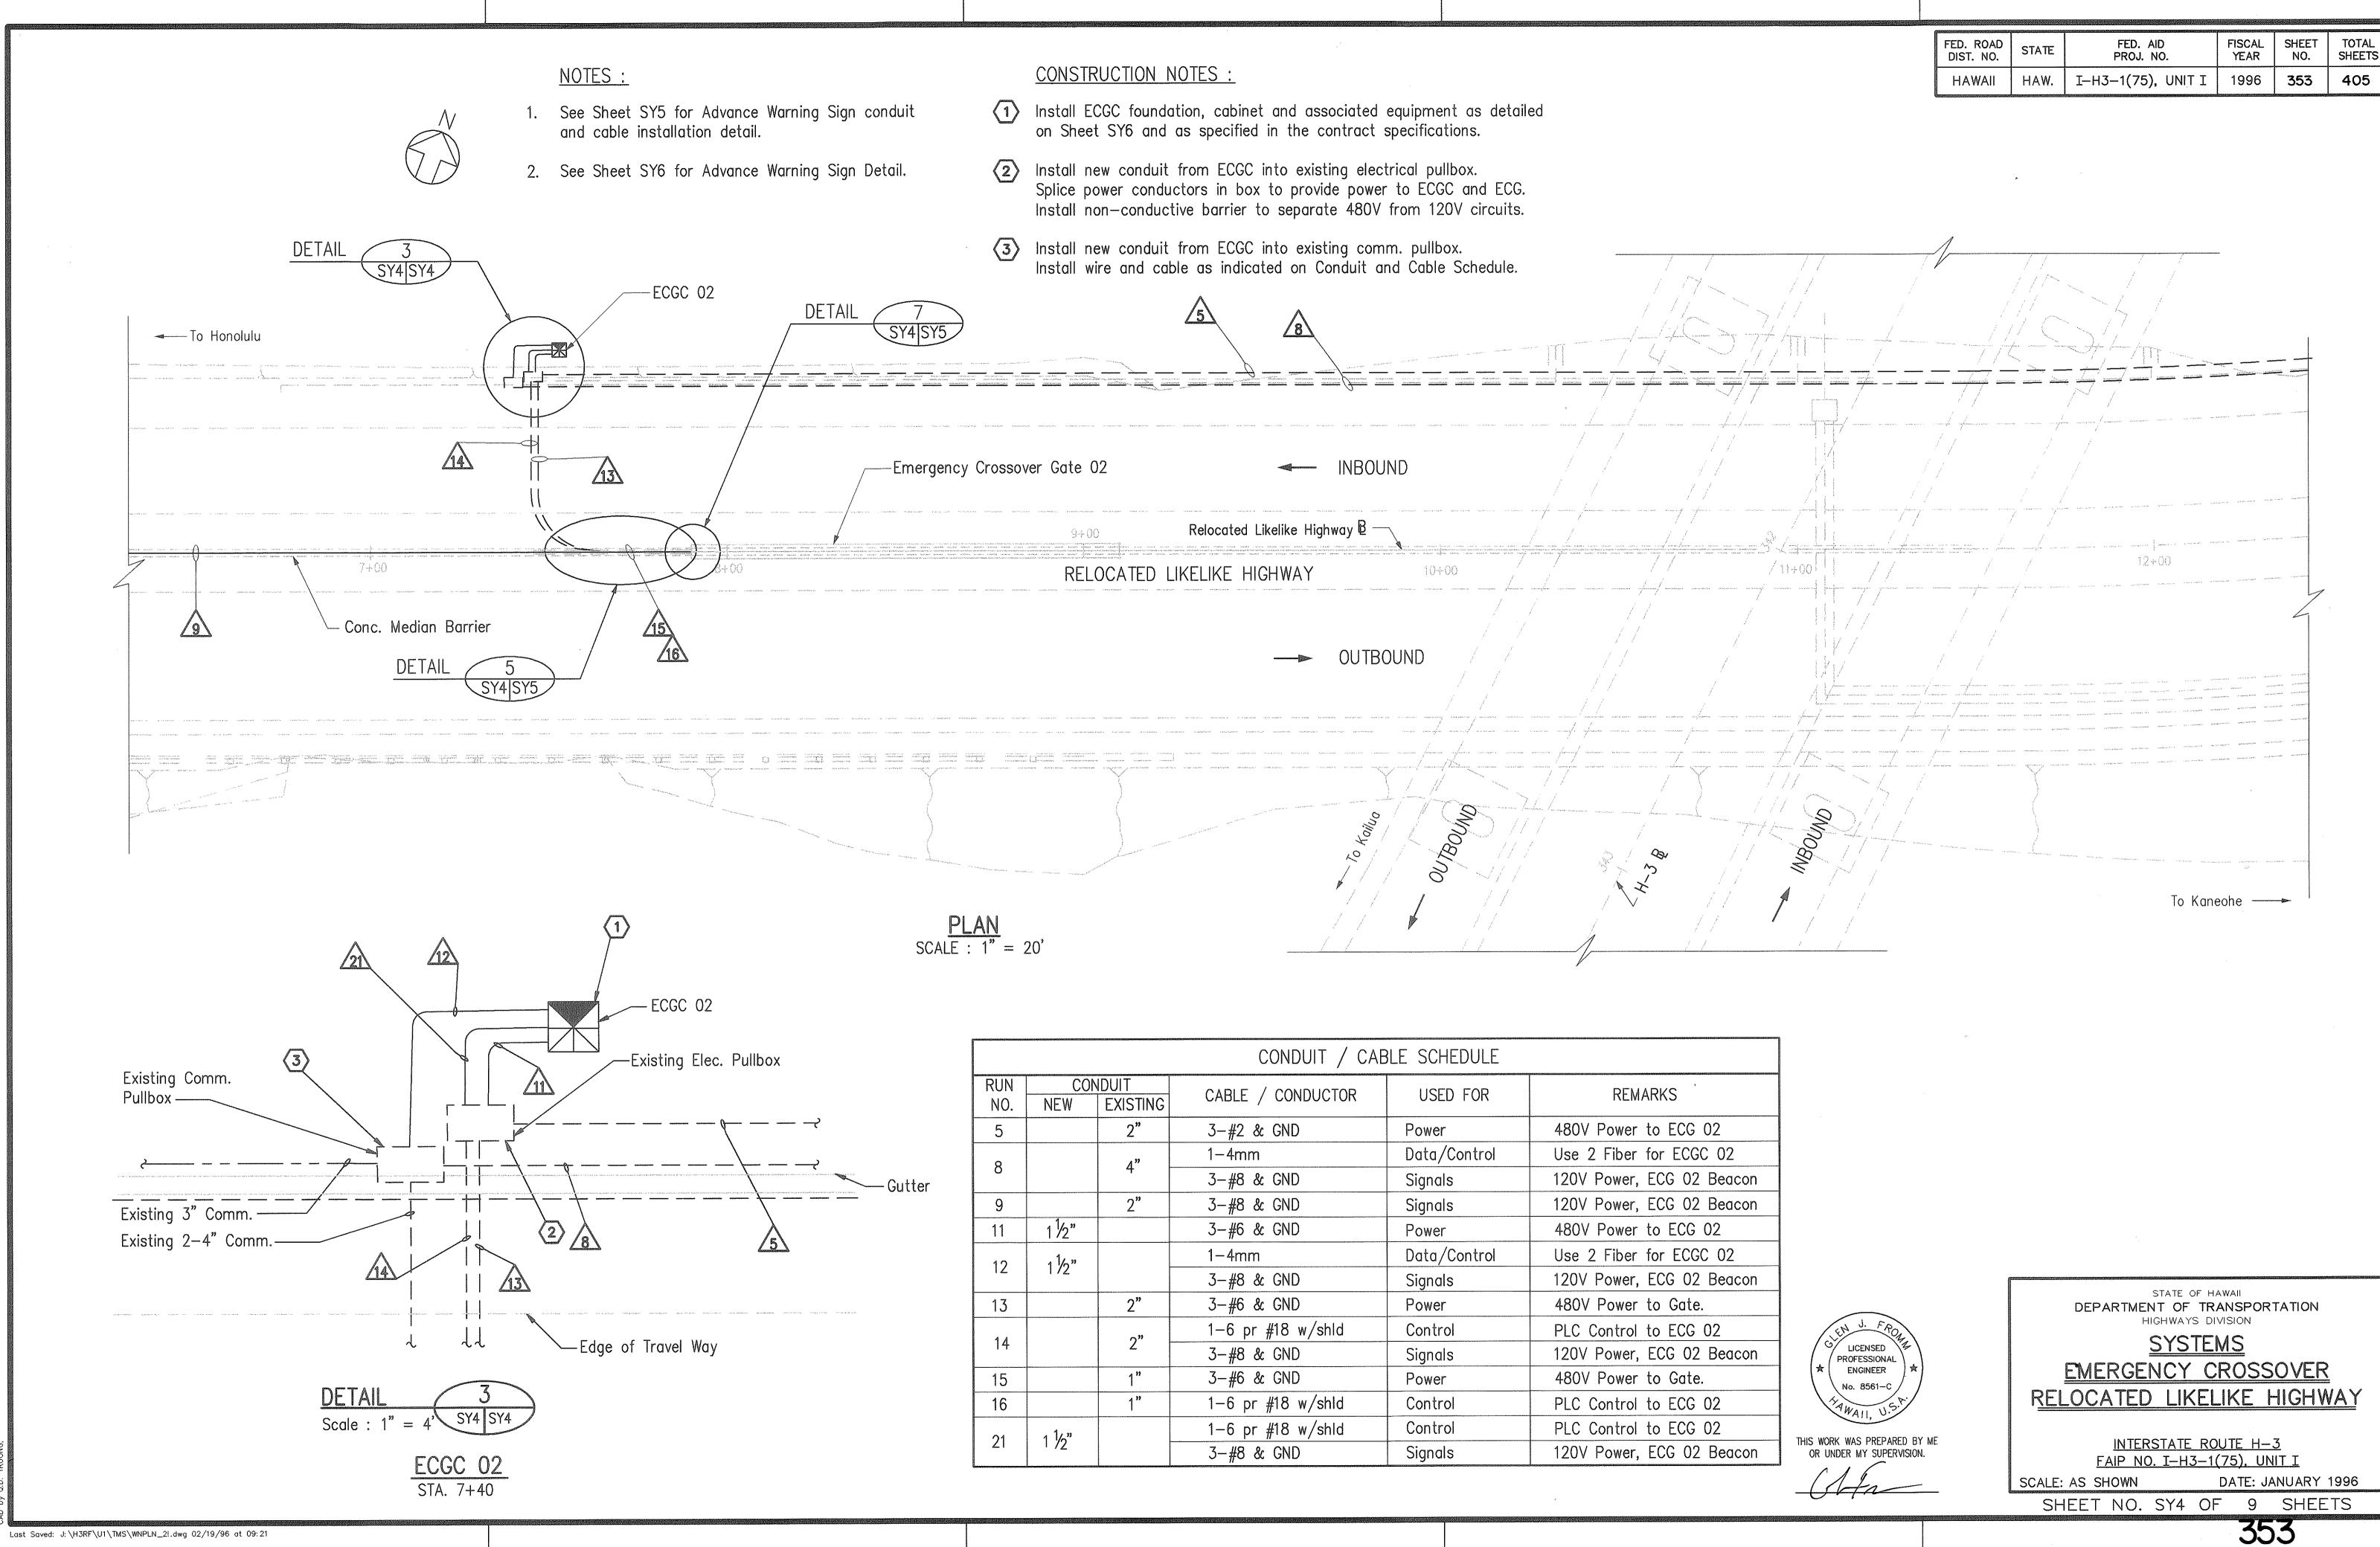

A.


ORIGINAL SURVEY PLOTTED E
PLAN DRAWN BY
NOTE BOOK DESIGNED BY
QUANTITIES BY
CHECKED BY

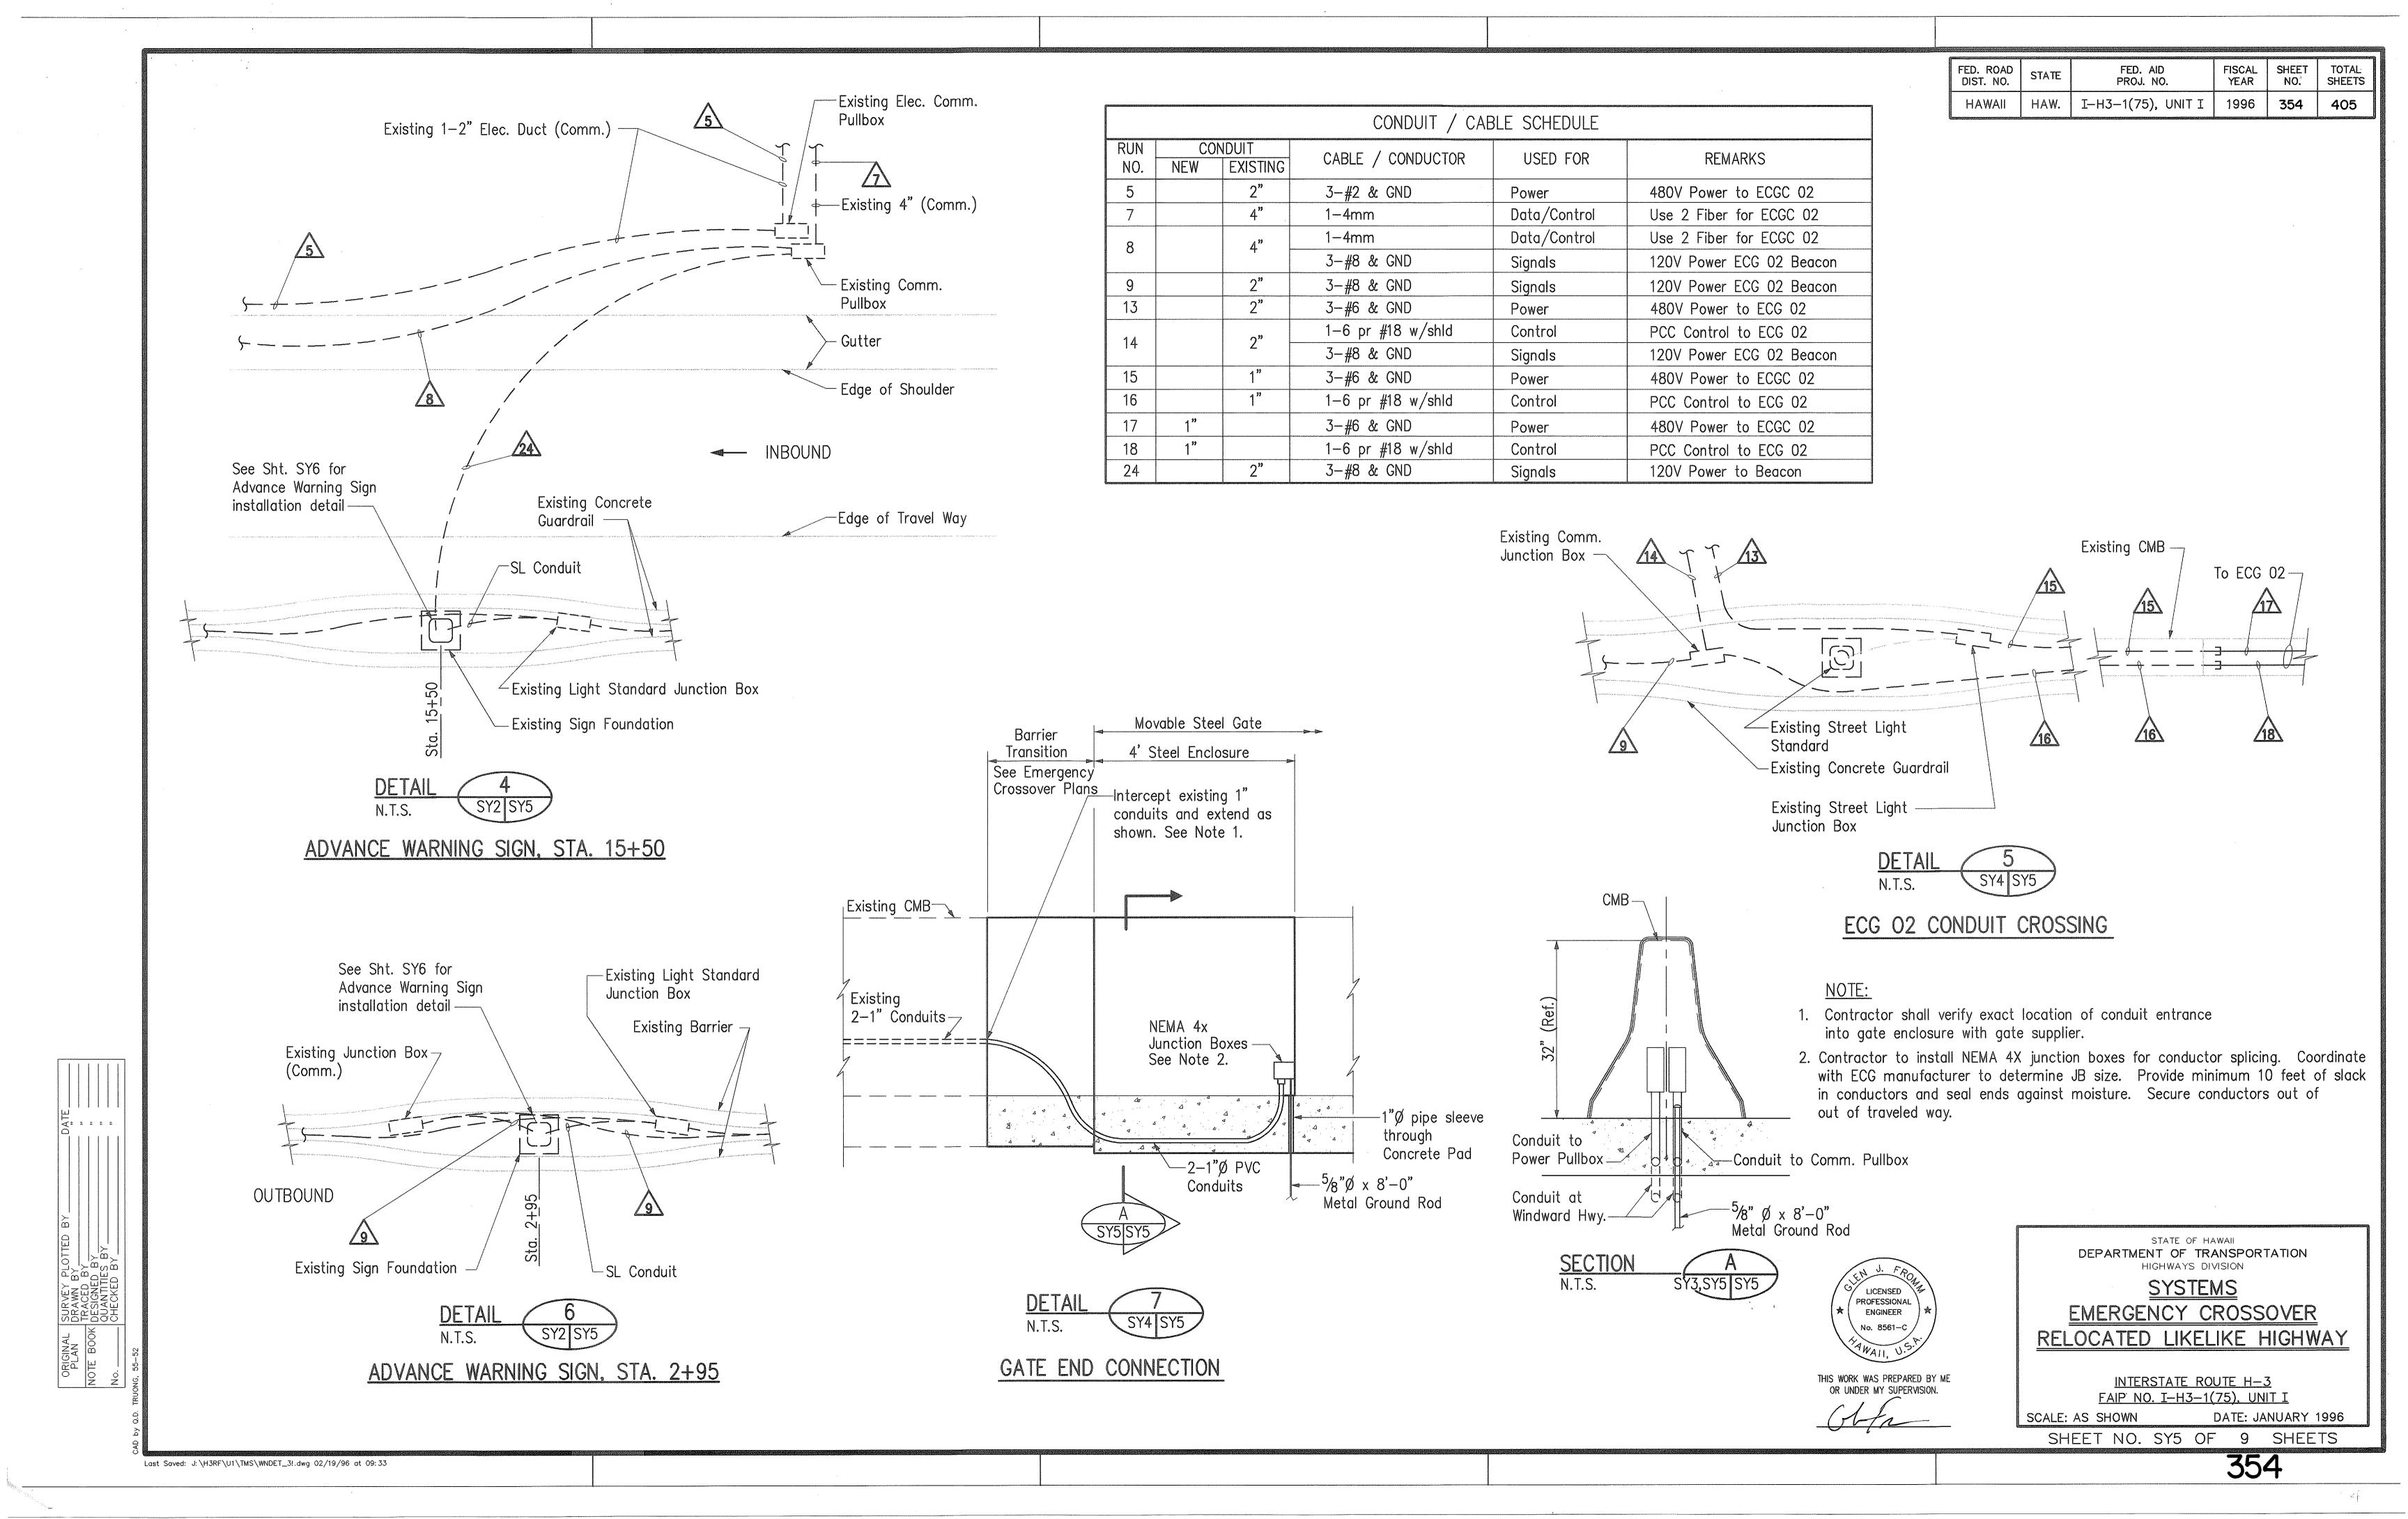

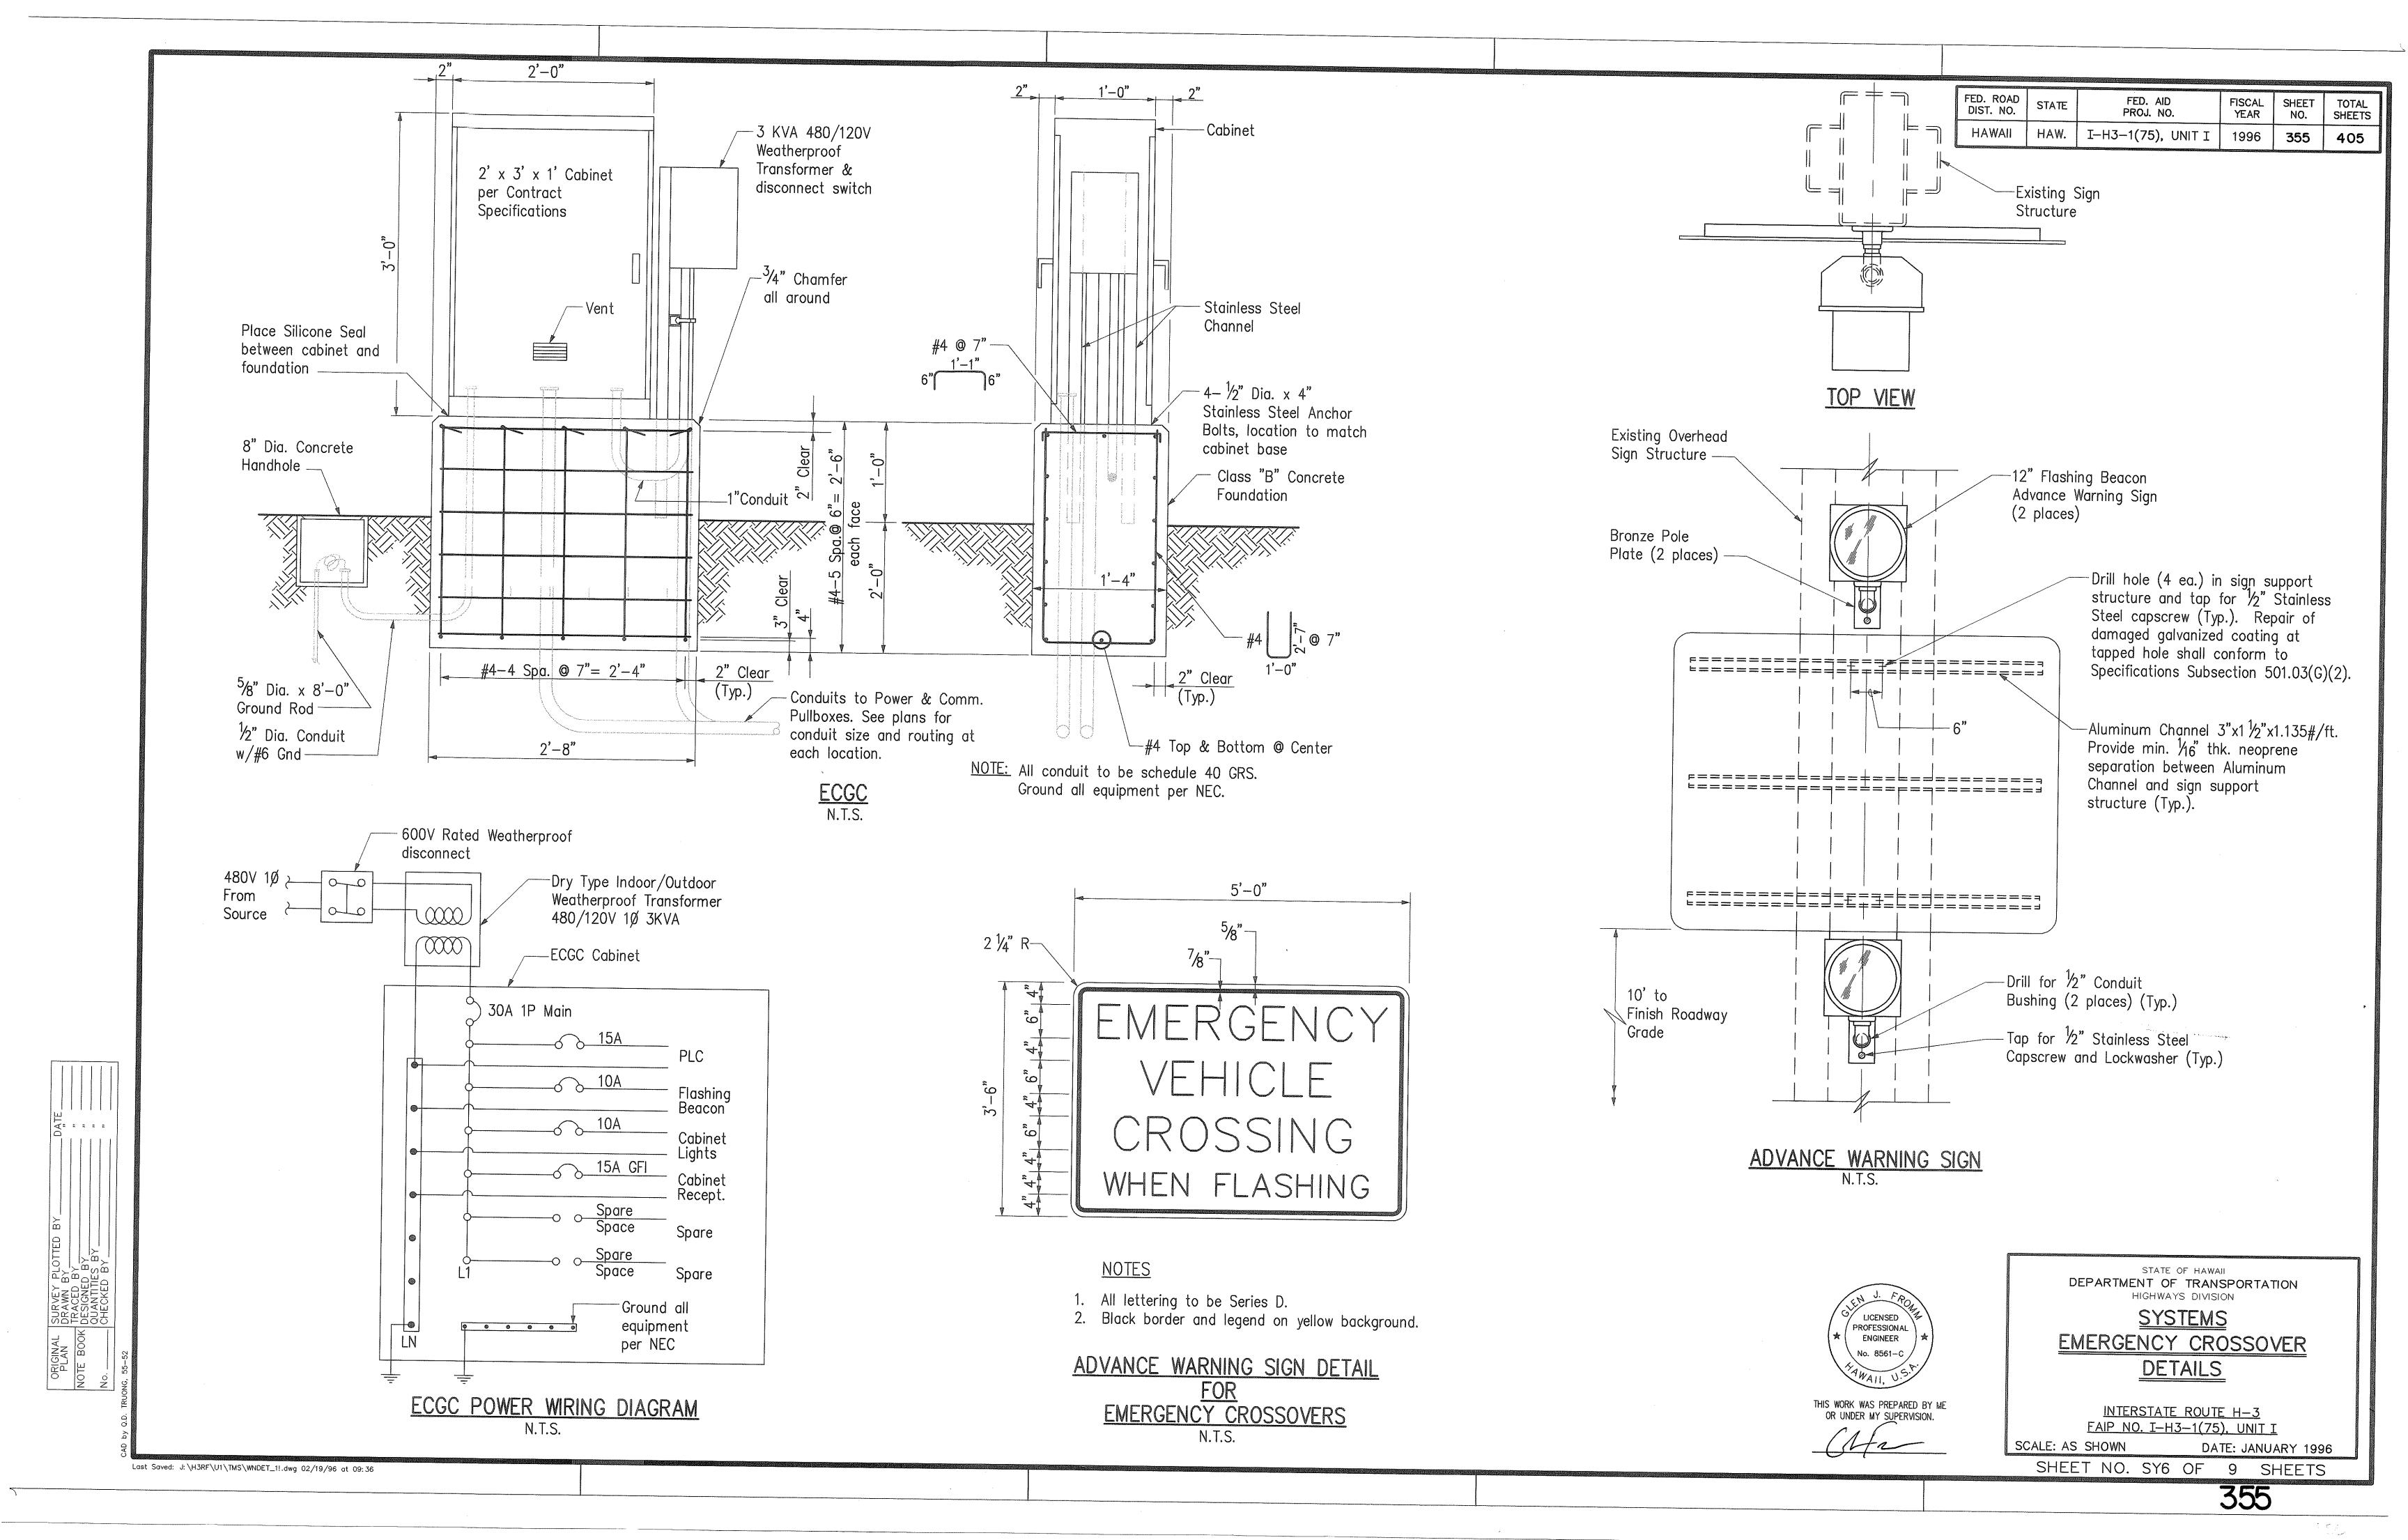

FED. ROAD
DIST. NO.STATEFED. AID
PROJ. NO.FISCAL
YEARSHEET
NO.TOTAL
SHEETSHAWAIIHAW.I-H3-1(75), UNIT I1996356405



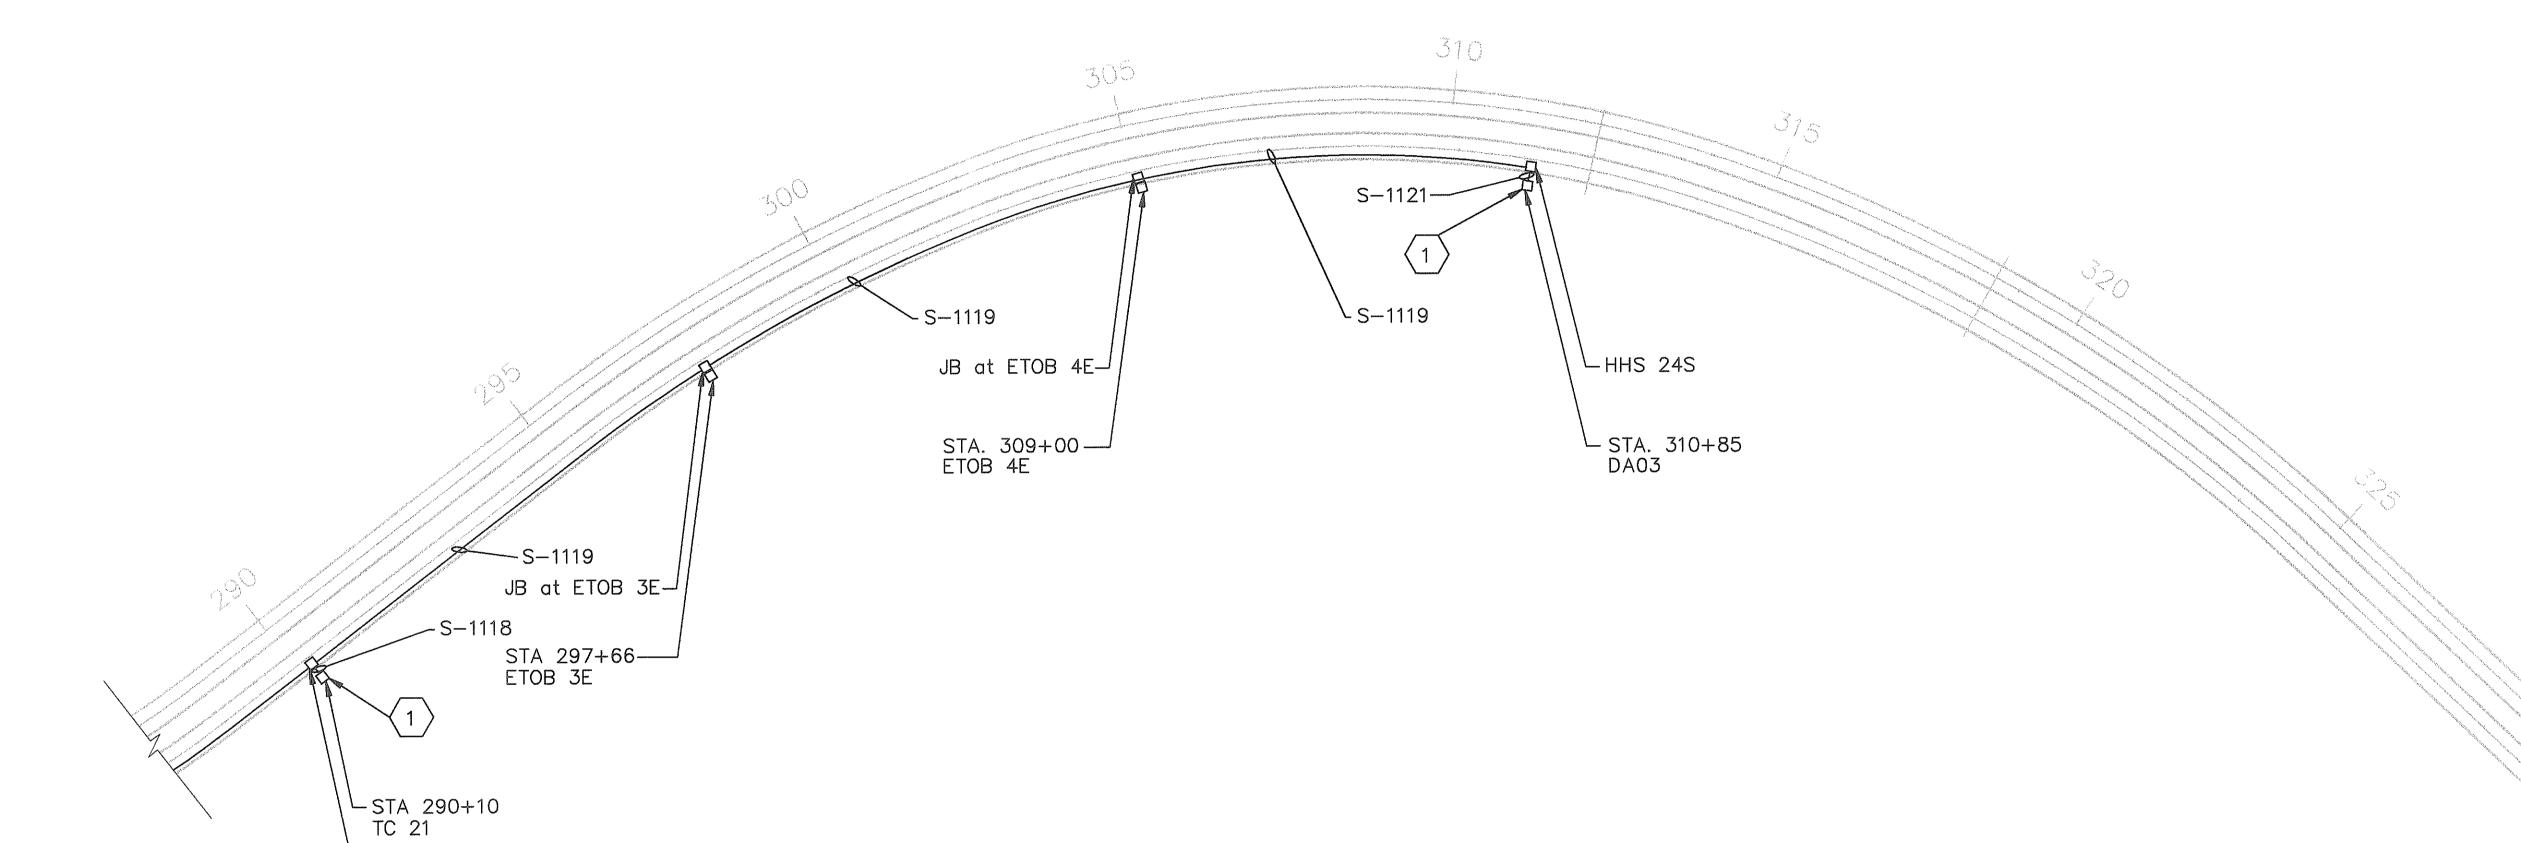

CONSTRUCTION NOTES:

Coil 10' cable in cabinet for future use.

Last Saved: J:\H3RF\U1\TMS\H375G10!.dwg 02/19/96 at 10:15

HHS 225

EXIST. RUN NO.	CIRCUIT ID	FROM	ТО	SIZE INCH	CABLE	QUANTITY
S-1118	СО	TC 21	HHS 22S	2.00	1-4MM (TC21 to FO HUB 07)	1-4MM Fiber (DAO3)
S-1119	CO	HHS 22S	ETOB 3E	2.00	1-2pr #22 (ETOB 3E)	1-4MM Fiber (DA03)
S-1119	СО	ETOB 3E	ETOB 4E	2.00	empty	1-4MM Fiber (DA03)
S-1119	СО	ETOB 4E	HHS 24S	2.00	1-2pr #22 (ETOB 4E)	1-4MM Fiber (DA03)
S-1121	CO	HHS 24S	DA03	2.00	empty	1-4MM Fiber (DA03)

Existing per previous contracts New per FAIP NO. I—H3—1(75), UNIT I

LICENSED PROFESSIONAL ENGINEER
No. 8561-C

THIS WORK WAS PREPARED BY ME OR UNDER MY SUPERVISION.

STATE OF HAWAII

DEPARTMENT OF TRANSPORTATION

HIGHWAYS DIVISION


<u>SYSTEMS</u> <u>HAIKU APPROACH</u>

<u>INTERSTATE ROUTE H-3</u> FAIP NO. I-H3-1(75), UNIT I

SCALE: NTS DATE: JANUARY 1996

SHEET NO. SY7 OF 9 SHEETS

HAIKU APPROACH

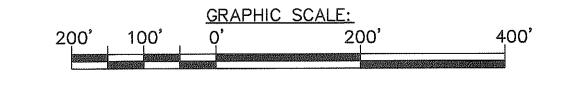


356

25/10

FED. ROAD DIST. NO.	STATE	FED. AID PROJ. NO.	FISCAL YEAR	SHEET NO.	TOTAL SHEETS
HAWAII	HAW.	I-H3-1(75), UNIT I	1996	357	405



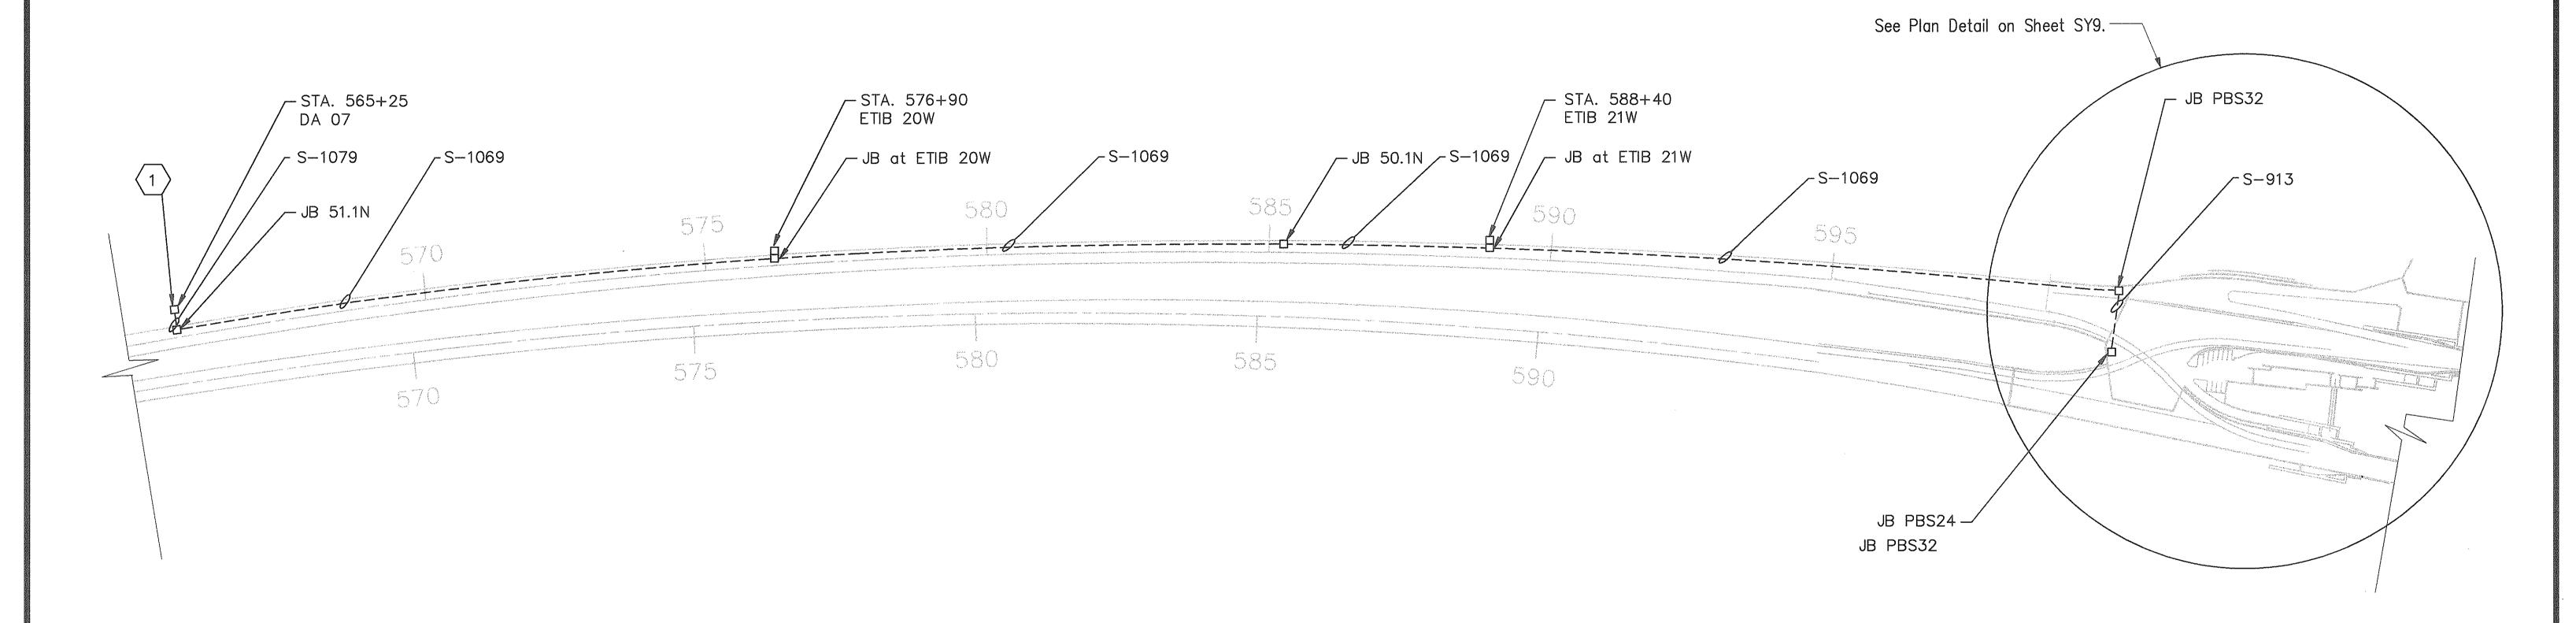

CONSTRUCTION NOTES:


. Last Saved: J:\H3RF\U1\TMS\H375G8!.dwg 02/19/96 at 10:41

Coil 10' of cable in DA07 cabinet for future use.

EXIST. RUN NO.	CIRCUIT ID	FROM	ТО	SIZE INCH	CABLE QUANTITY	
S-913	COMM	PBS 24	PBS 32	3.00	4-2pr #22 (ETIB 18W-21W)	1-4MM Fiber (DA07)
S-1069	COMM	PBS 32	ETIB 21W	3.00	4-2pr #22 (ETIB 18W-21W)	1-4MM Fiber (DA07)
S-1069	COMM	ETIB 21W	HHS 50.1N	3.00	3-2pr #22 (ETIB 18W-20W)	1-4MM Fiber (DA07)
S-1069	COMM	HHS 50.1N	ETIB 20W	3.00	3-2pr #22 (ETIB 18W-20W)	1-4MM Fiber (DA07)
S-1069	COMM	ETIB 20W	HHS 51.1N	3.00	2-2pr #22 (ETIB 18W-19W)	1-4MM Fiber (DA07)
S-1079	COMM	HHS 51.1N	DA07	2.00		1-4MM Fiber (DA07)

Existing per previous contracts

New per FAIP NO. I—H3—1(75), UNIT I

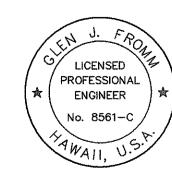

THIS WORK WAS PREPARED BY ME OR UNDER MY SUPERVISION.

STATE OF HAWAII

DEPARTMENT OF TRANSPORTATION

HIGHWAYS DIVISION

<u>SYSTEMS</u> HALAWA APROACH

<u>INTERSTATE ROUTE H-3</u> FAIP NO. I-H3-1(75). UNIT I

SCALE: NTS DATE: JANUARY 1996 SHEET NO. SY8 OF 9 SHEETS

357

HALAWA APPROACH

