
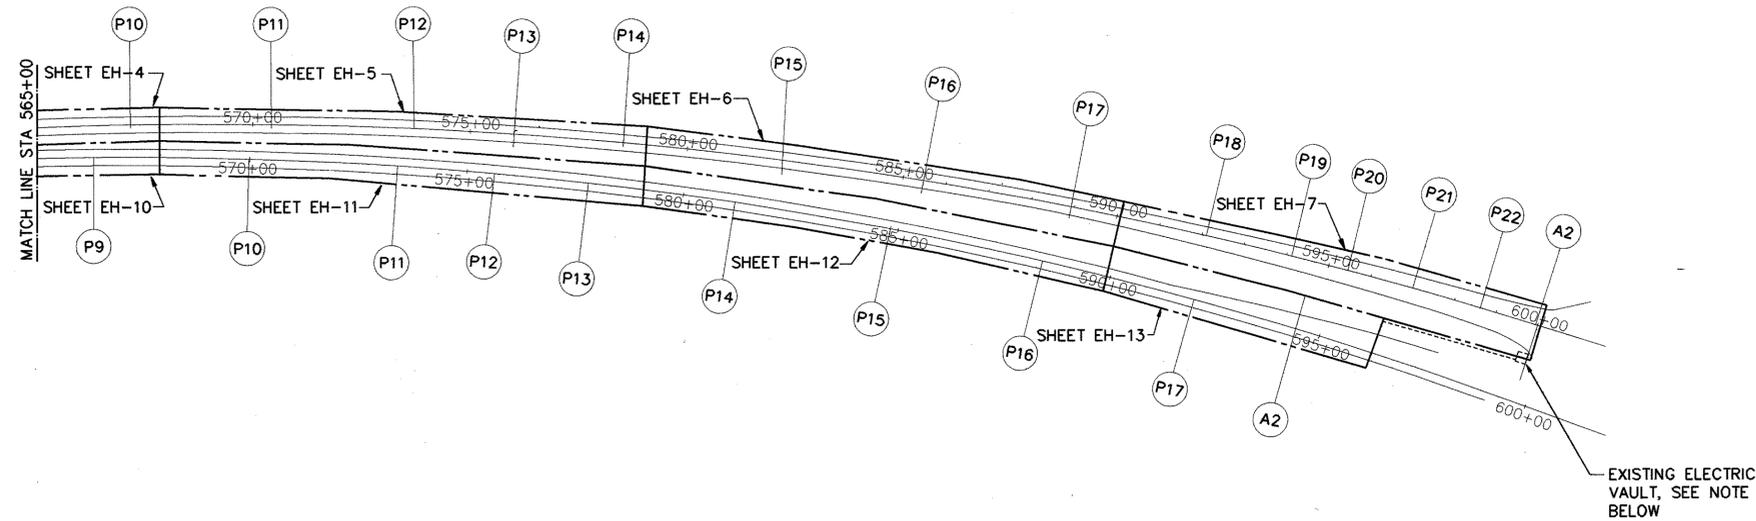



FED. ROAD DIST. NO.	STATE	FED. AID PROJ. NO.	FISCAL YEAR	SHEET NO.	TOTAL SHEETS
HAWAII	HAW.	I-H3-1(75), UNIT 1	1996	292	405

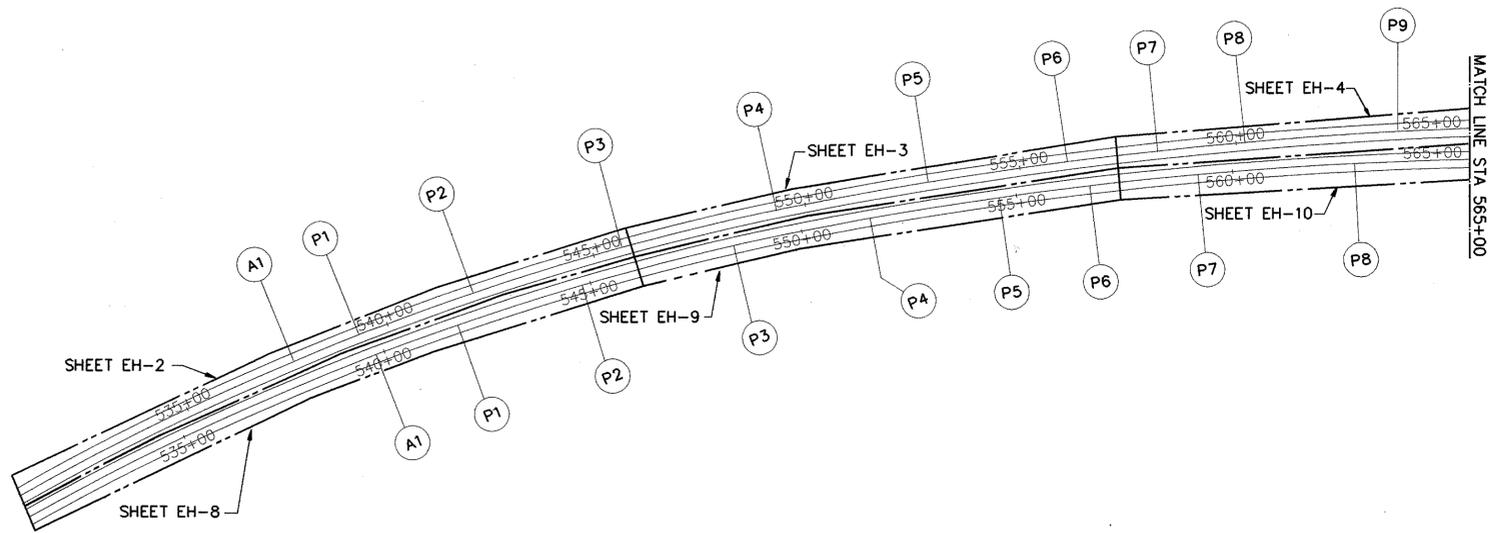


ELECTRICAL SYMBOLS AND LEGEND

EXISTING	NEW	DESCRIPTION
	○	LIGHT STANDARD POLE (OWNER FURNISHED CONTRACTOR INSTALLED)
⊕		46KV MANHOLE ON GRADE, 6' X 11" X 6' DEEP
⊕		46KV MANHOLE ON STRUCTURE, 6' X 11" X 6' DEEP
⊕		TELEPHONE JUNCTION BOX, CAST METAL, WP, 34" X 10" X 6"D
⊕		LIGHTING J.B., CAST METAL, WP, 30" L X 10" W X 6" D
⊕		COMMUNICATION J.B., CAST METAL, WP, 24" L X 8" W X 6"D
⊕		EXISTING JUNCTION BOX GROUP
⊕		TRAFFIC DETECTOR LOOP, 6' X 6'
⊕		SIGNAL J.B., CAST METAL, WP, 24" L X 8" W X 6" D
---	—E—	ELECTRIC DUCT LINES
---	—S—	SIGNAL DUCT LINES
---	—L—	LIGHTING DUCT LINES
---	—C—	COMMUNICATION DUCT LINES
⊕		PANELBOARD
	(P)	PIER NUMBER AND LOCATION INDICATOR
	(A)	ABUTMENT NUMBER AND LOCATION INDICATOR
---	---	TELEPHONE DUCT LINES
---	---	EXISTING SIGNAL DUCT LINES
---	---	EXISTING LIGHTING DUCT LINES
---	---	EXISTING COMMUNICATION DUCT LINES
⊕		TYPICAL EXISTING EXPANSION JOINTS WITH SLEEVES

DETAIL INDICATOR

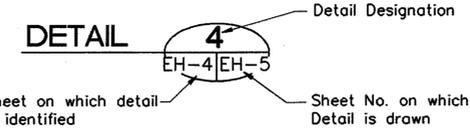


SECTION INDICATOR

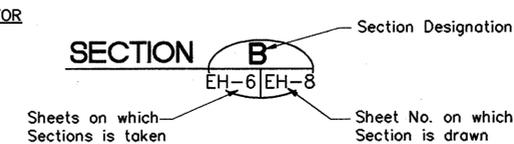

GENERAL ELECTRICAL PLAN - EXTERIOR
SCALE: 1"=200'

NOTE:
ALL (LIGHTING AND TRAFFIC CONTROLLER POWER FEEDERS TO BE INSTALLED IN EXISTING RACEWAYS AND TERMINATED TO RELATED PANELBOARDS AS INDICATED IN THE ONE-LINE DIAGRAM.

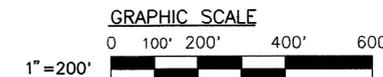

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Clarence C. K. Kim
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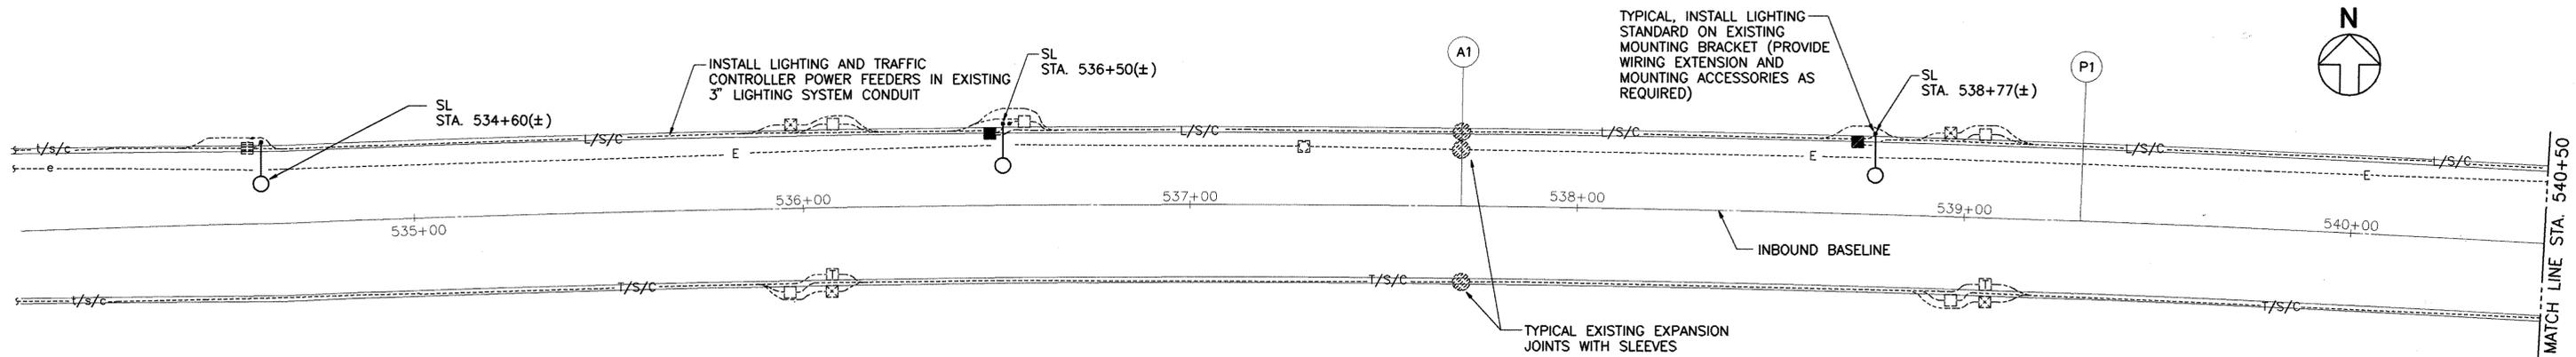
STATE OF HAWAII
DEPARTMENT OF TRANSPORTATION
HIGHWAYS DIVISION

**GENERAL ELECTRICAL
PLAN-EXTERIOR**
NORTH HALAWA VALLEY VIADUCT
INTERSTATE ROUTE H-3
F.A.I. PROJECT NO. I-H3-1 (75) UNIT 1


SCALE: 1" = 200' DATE: JAN. 1996
SHEET NO. EH-1 OF 32 SHEETS

DATE REVISION


FED. ROAD DIST. NO.	STATE	FED. AID PROJ. NO.	FISCAL YEAR	SHEET NO.	TOTAL SHEETS
HAWAII	HAW.	I-H3-1(75), UNIT 1	1996	293	405



PARTIAL ELECTRICAL PLAN - INBOUND
SCALE: 1"=20'

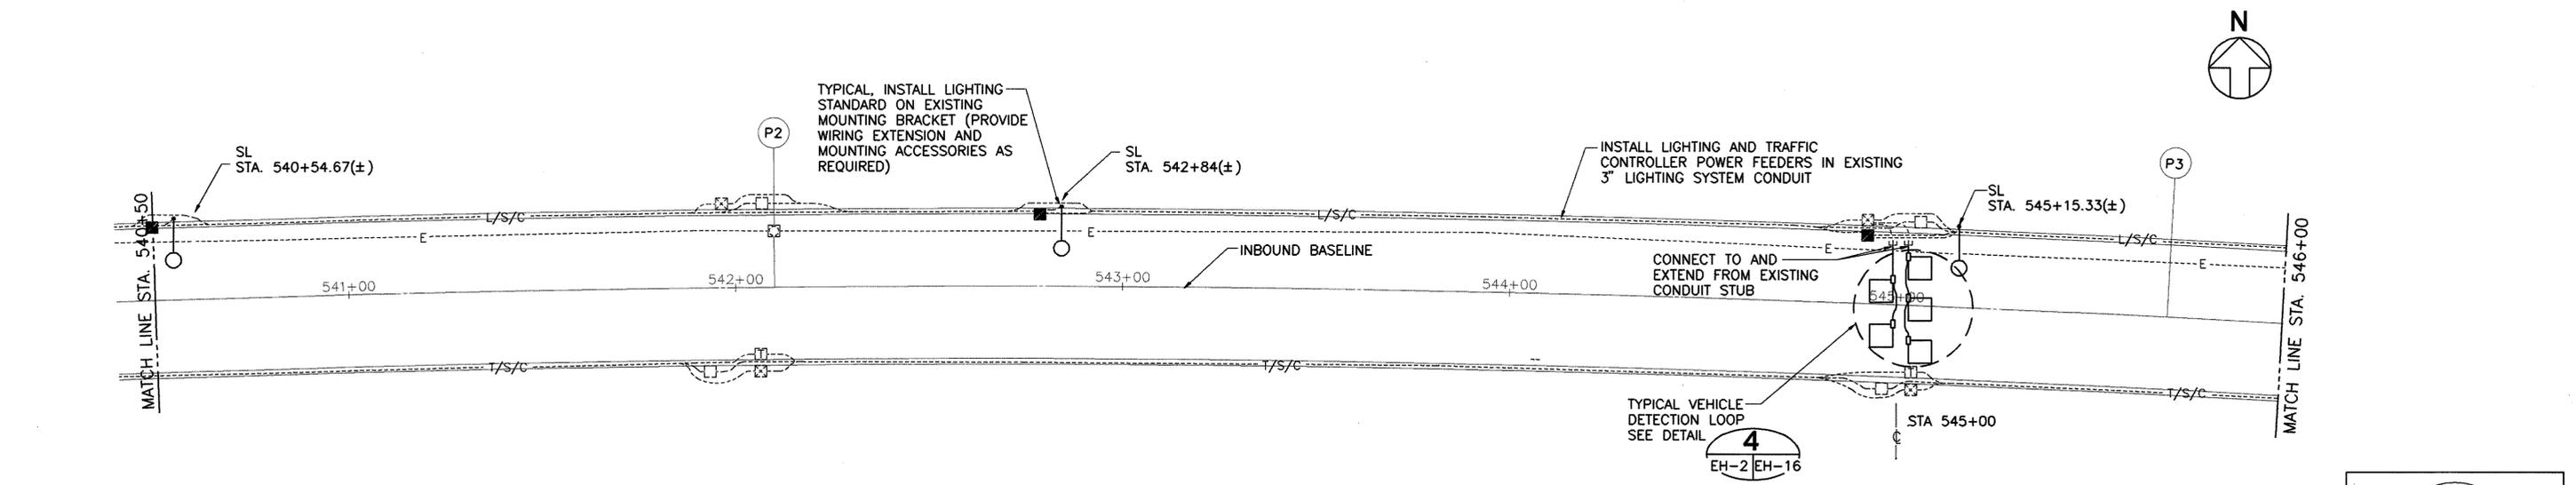

PARTIAL ELECTRICAL PLAN - INBOUND
SCALE: 1"=20'

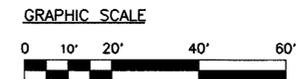


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Clarence C. K. Kim
SIGNATURE

ORIGINAL PLAN	DATE
SURVEY PLOTTED BY	
DRAWN BY	
DESIGNED BY	
QUANTITIES BY	
CHECKED BY	
NO.	


DATE	REVISION
STATE OF HAWAII DEPARTMENT OF TRANSPORTATION HIGHWAYS DIVISION PARTIAL ELECTRICAL PLAN - INBOUND EXTERIOR STA. 534+22.93 TO 546+00 INTERSTATE ROUTE H-3 F.A.I. PROJECT NO. I-H3-1 (75) UNIT 1 SCALE: 1" = 20' DATE: JAN. 1996 SHEET NO. EH-2 OF 32 SHEETS	

FED. ROAD DIST. NO.	STATE	FED. AID PROJ. NO.	FISCAL YEAR	SHEET NO.	TOTAL SHEETS
HAWAII	HAW.	I-H3-1(75), UNIT 1	1996	294	405

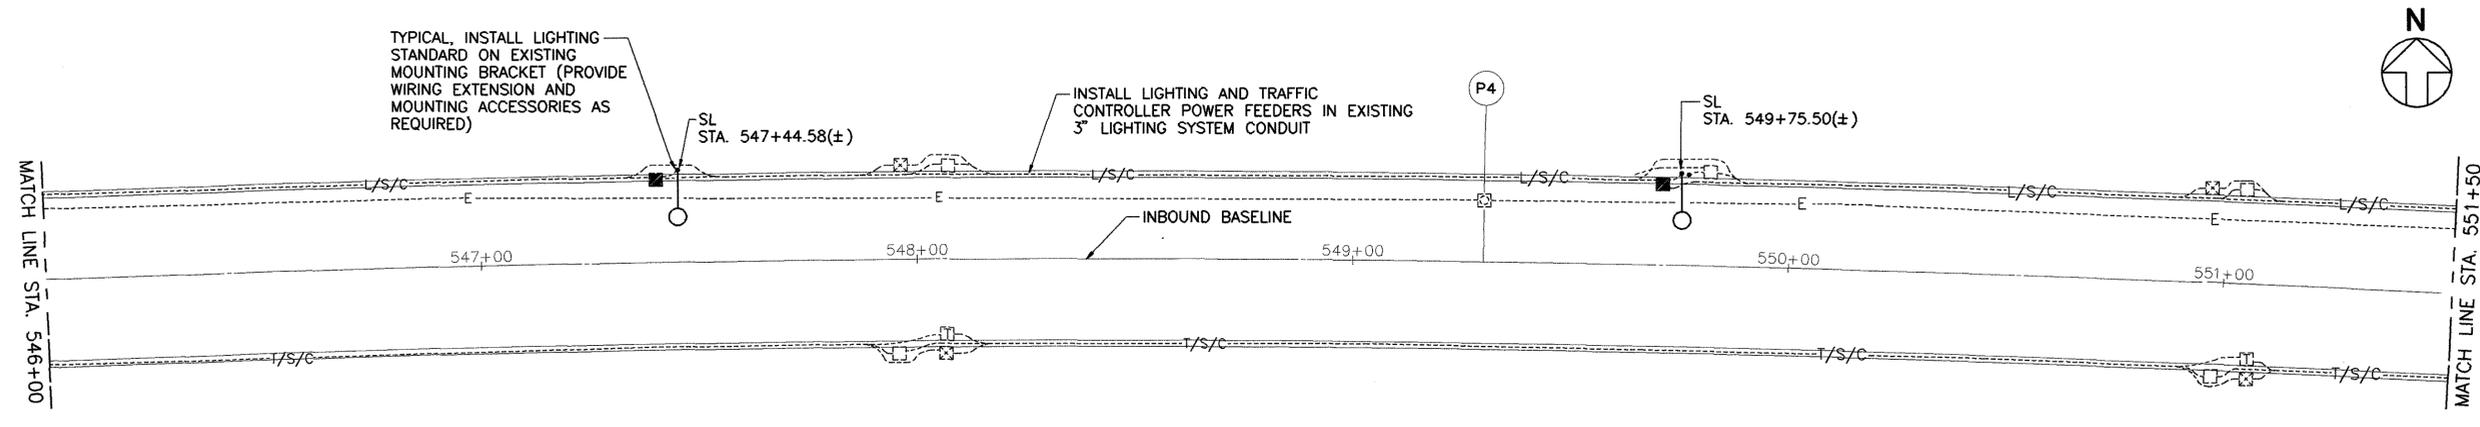


PARTIAL ELECTRICAL PLAN - INBOUND

SCALE: 1"=20'

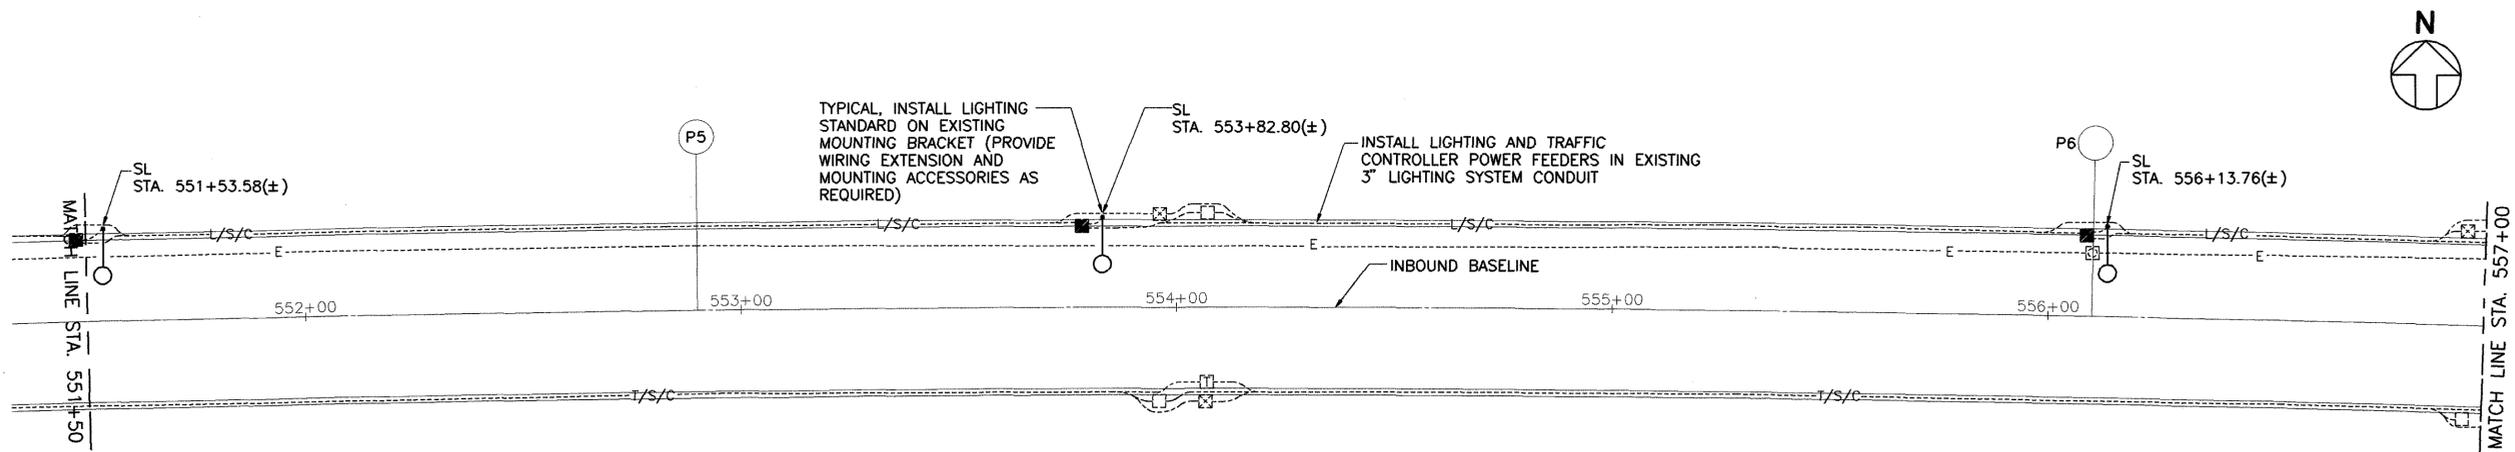

PARTIAL ELECTRICAL PLAN - INBOUND

SCALE: 1"=20'

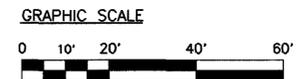


This work was prepared by me or under my supervision.

C. Kim
SIGNATURE


DATE	
SURVEY PLOTTED BY	
DRAWN BY	
DESIGNED BY	
QUANTITIES BY	
CHECKED BY	
ORIGINAL PLAN	
REVISION	
NO.	

DATE	REVISION
STATE OF HAWAII DEPARTMENT OF TRANSPORTATION HIGHWAYS DIVISION PARTIAL ELECTRICAL PLAN - INBOUND EXTERIOR STA. 546+00 TO 557+00 INTERSTATE ROUTE H-3 F.A.I. PROJECT NO. I-H3-1 (75) UNIT 1 SCALE: 1" = 20' DATE: JAN. 1996 SHEET NO. EH-3 OF 32 SHEETS	


FED. ROAD DIST. NO.	STATE	FED. AID PROJ. NO.	FISCAL YEAR	SHEET NO.	TOTAL SHEETS
HAWAII	HAW.	I-H3-1(75), UNIT I	1996	295	405

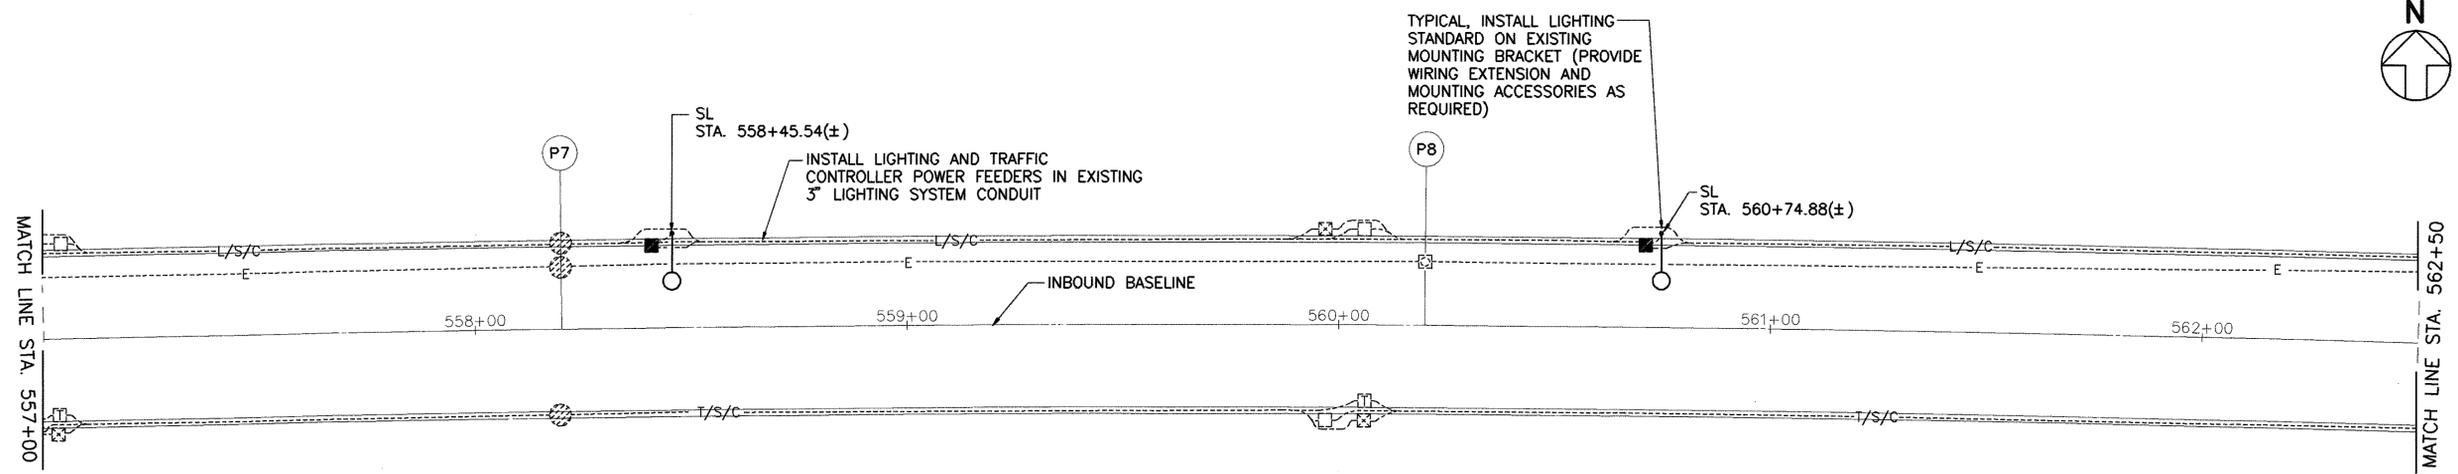

PARTIAL ELECTRICAL PLAN - INBOUND
SCALE: 1" = 20'

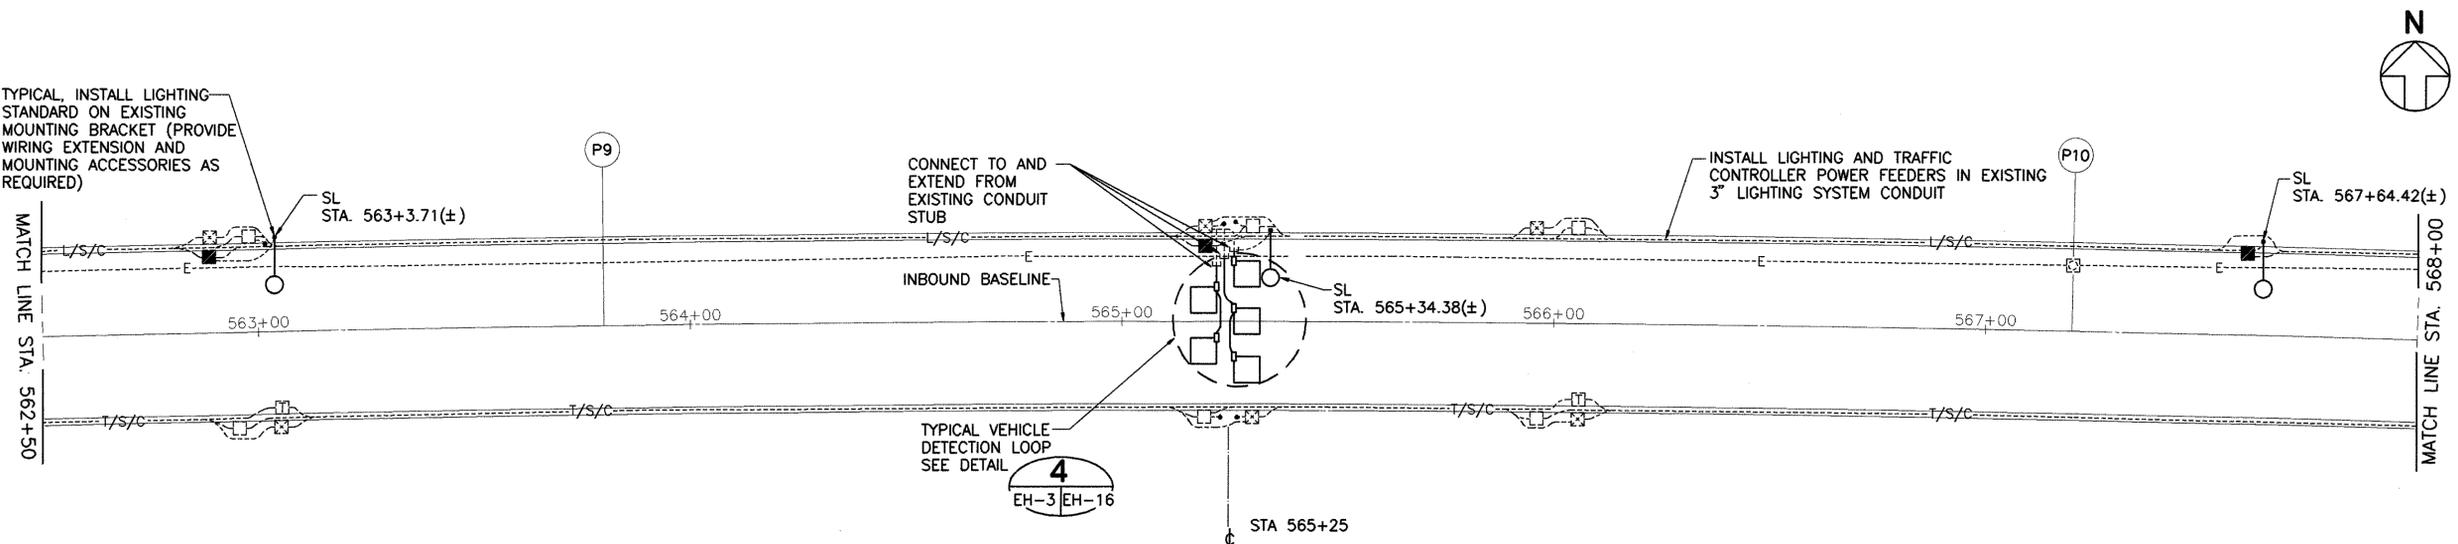

PARTIAL ELECTRICAL PLAN - INBOUND
SCALE: 1" = 20'

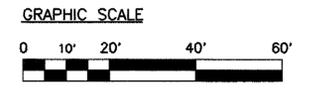

CLARENCE C. K. KAM
LICENSED PROFESSIONAL ENGINEER
No. 1765-E
HAWAII, U.S.A.

This work was prepared by me or under my supervision.

C. K. Kam
SIGNATURE

DATE	_____
DESIGNED BY	_____
DRAWN BY	_____
CHECKED BY	_____
QUANTITIES BY	_____
TRACED BY	_____
PLOTTED BY	_____
ORIGINAL PLAN	_____
NOTEBOOK	_____
No.	_____

STATE OF HAWAII
DEPARTMENT OF TRANSPORTATION
HIGHWAYS DIVISION


**PARTIAL ELECTRICAL PLAN-
INBOUND EXTERIOR**

STA. 557+00 TO 568+00
INTERSTATE ROUTE H-3
F.A.I. PROJECT NO. I-H3-1 (75) UNIT 1

SCALE: 1" = 20' DATE: JAN. 1996
SHEET NO. EH-4 OF 32 SHEETS


DATE	REVISION

FED. ROAD DIST. NO.	STATE	FED. AID PROJ. NO.	FISCAL YEAR	SHEET NO.	TOTAL SHEETS
HAWAII	HAW.	I-H3-1(75), UNIT 1	1996	296	405

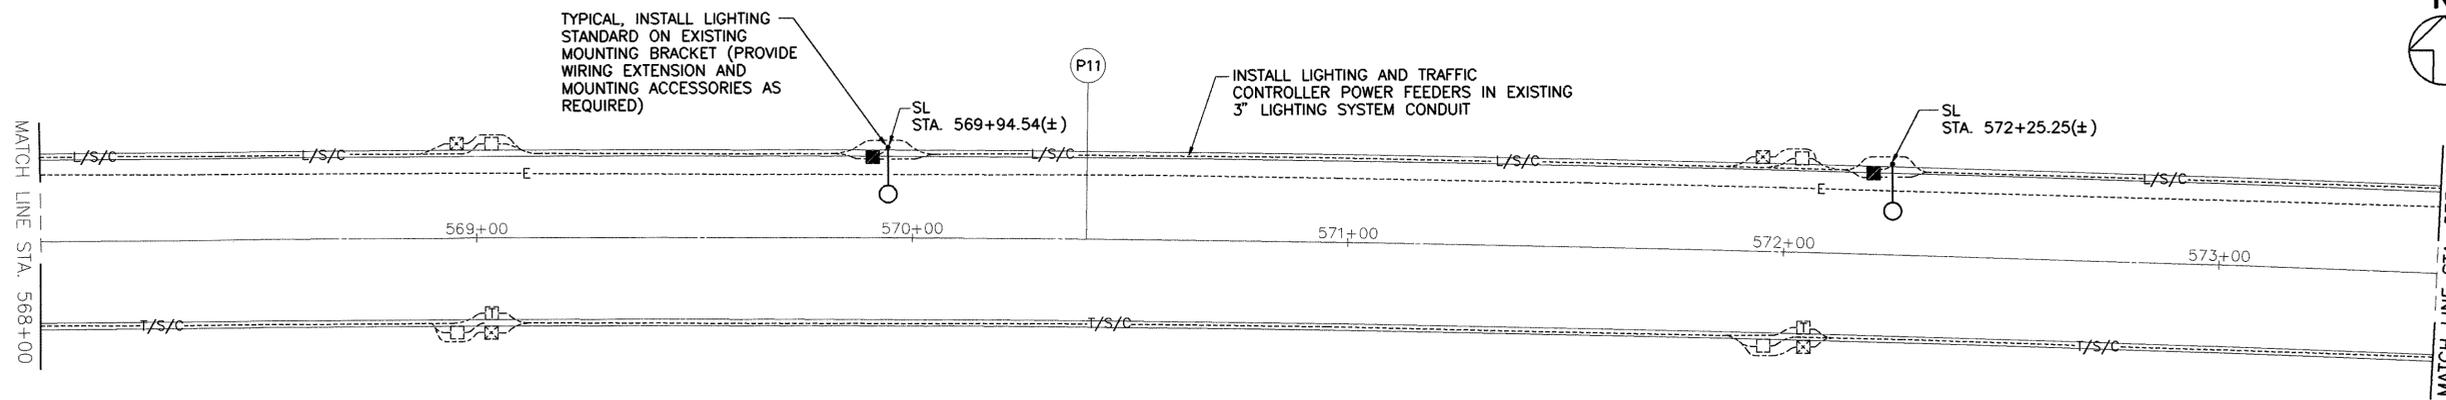


PARTIAL ELECTRICAL PLAN - INBOUND

SCALE: 1"=20'

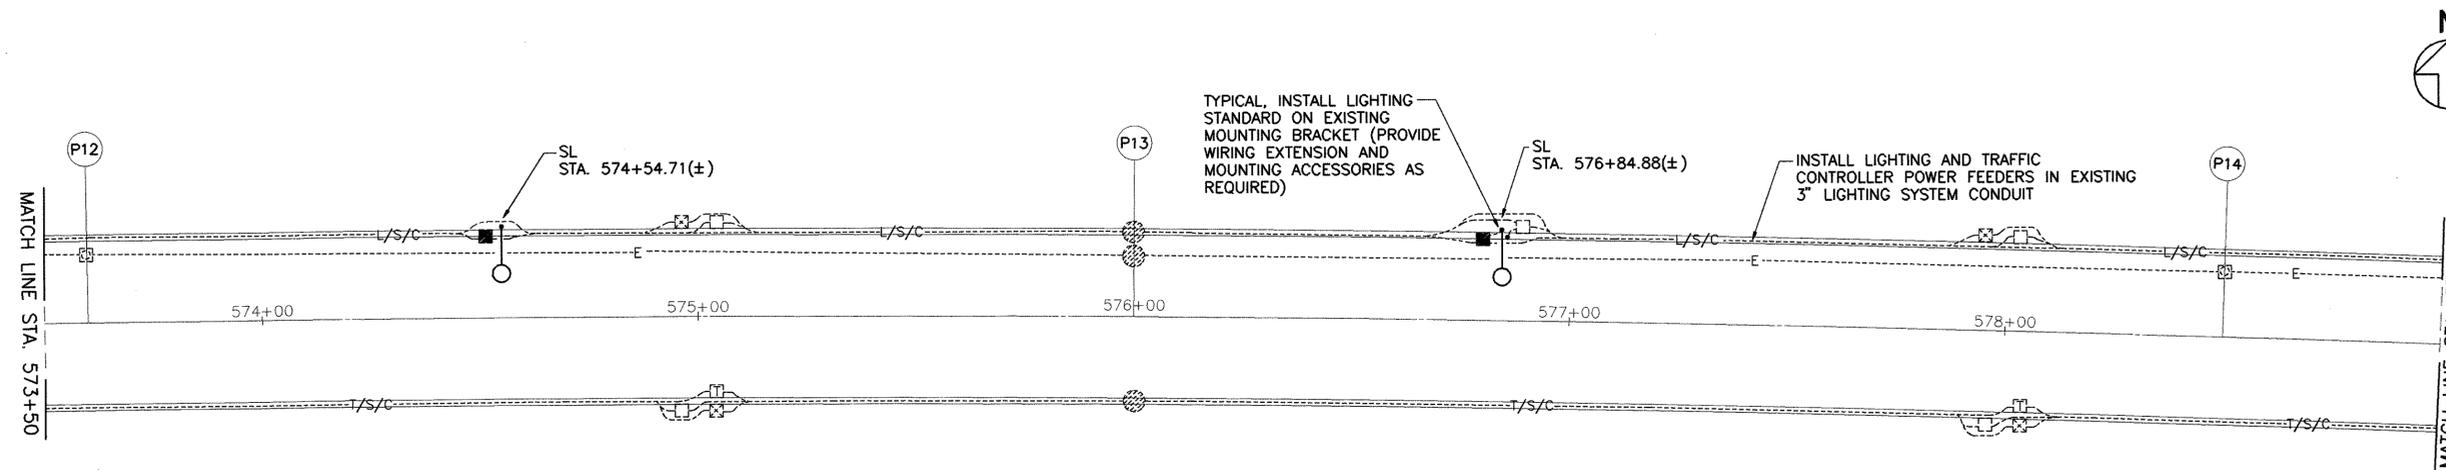

PARTIAL ELECTRICAL PLAN - INBOUND

SCALE: 1"=20'

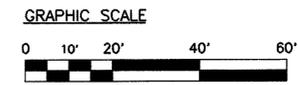



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(Signature)
 SIGNATURE

DATE	_____
DESIGNED BY	_____
TRACED BY	_____
QUANTITIES BY	_____
CHECKED BY	_____
ORIGINAL PLAN	_____
NOTEBOOK	_____
No.	_____


STATE OF HAWAII DEPARTMENT OF TRANSPORTATION HIGHWAYS DIVISION
PARTIAL ELECTRICAL PLAN- INBOUND EXTERIOR
STA. 568+00 TO 579+00
INTERSTATE ROUTE H-3
F.A.I. PROJECT NO. I-H3-1 (75) UNIT 1
SCALE: 1" = 20' DATE: JAN. 1996
SHEET NO. EH-5 OF 32 SHEETS

DATE	REVISION

FED. ROAD DIST. NO.	STATE	FED. AID PROJ. NO.	FISCAL YEAR	SHEET NO.	TOTAL SHEETS
HAWAII	HAW.	I-H3-1(75), UNIT 1	1996	297	405

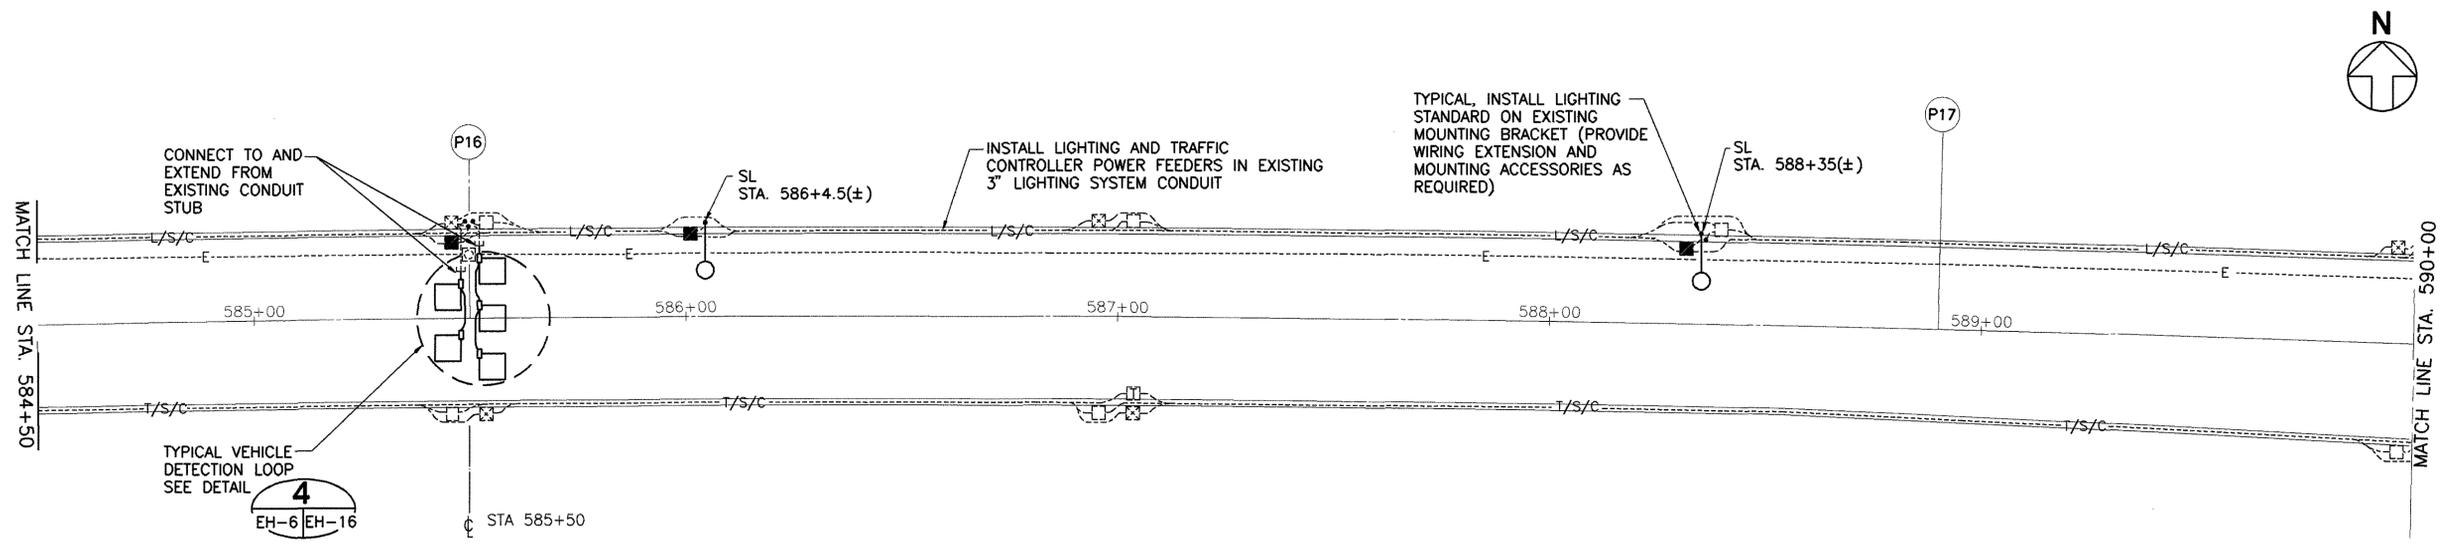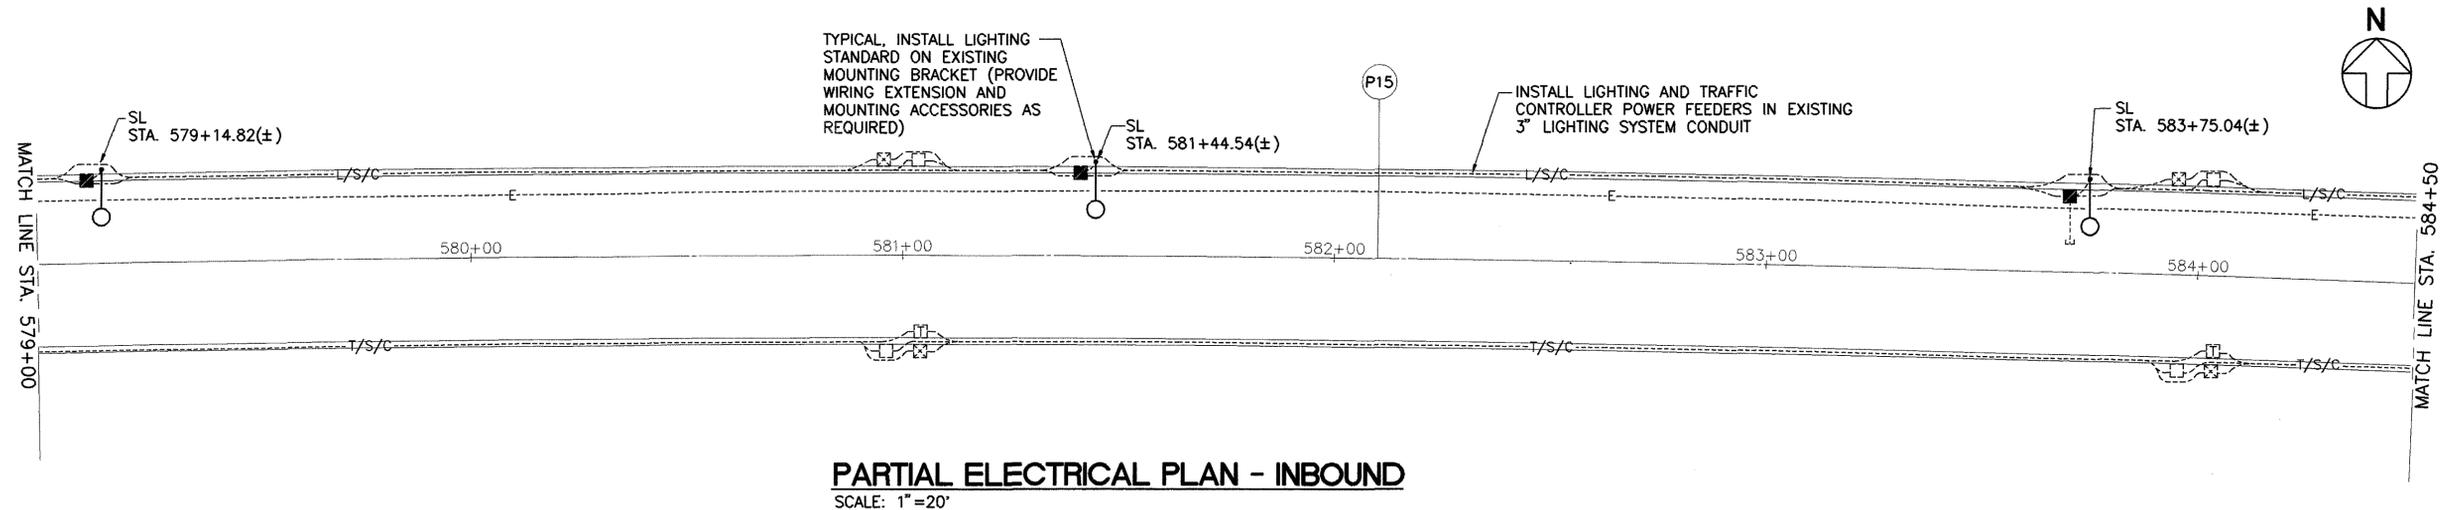

SURVEY PLOTTED BY	_____
DRAWN BY	_____
DESIGNED BY	_____
QUANTITIES BY	_____
CHECKED BY	_____
ORIGINAL PLAN	_____
REVISION	_____
NO.	_____

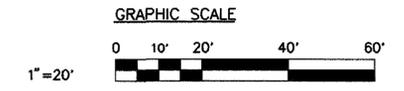

CLARENCE C. K. KAI
 LICENSED PROFESSIONAL ENGINEER
 No. 1765-E
 HAWAII, U.S.A.

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C. Kai
 SIGNATURE


STATE OF HAWAII
 DEPARTMENT OF TRANSPORTATION
 HIGHWAYS DIVISION

PARTIAL ELECTRICAL PLAN - INBOUND EXTERIOR
 STA. 579+00 TO 590+00
 INTERSTATE ROUTE H-3
 F.A.I. PROJECT NO. I-H3-1 (75) UNIT 1

SCALE: 1" = 20' DATE: JAN. 1996
 SHEET NO. EH-6 OF 32 SHEETS


DATE	REVISION

FED. ROAD DIST. NO.	STATE	FED. AID PROJ. NO.	FISCAL YEAR	SHEET NO.	TOTAL SHEETS
HAWAII	HAW.	I-H3-1(75), UNIT 1	1996	298	405

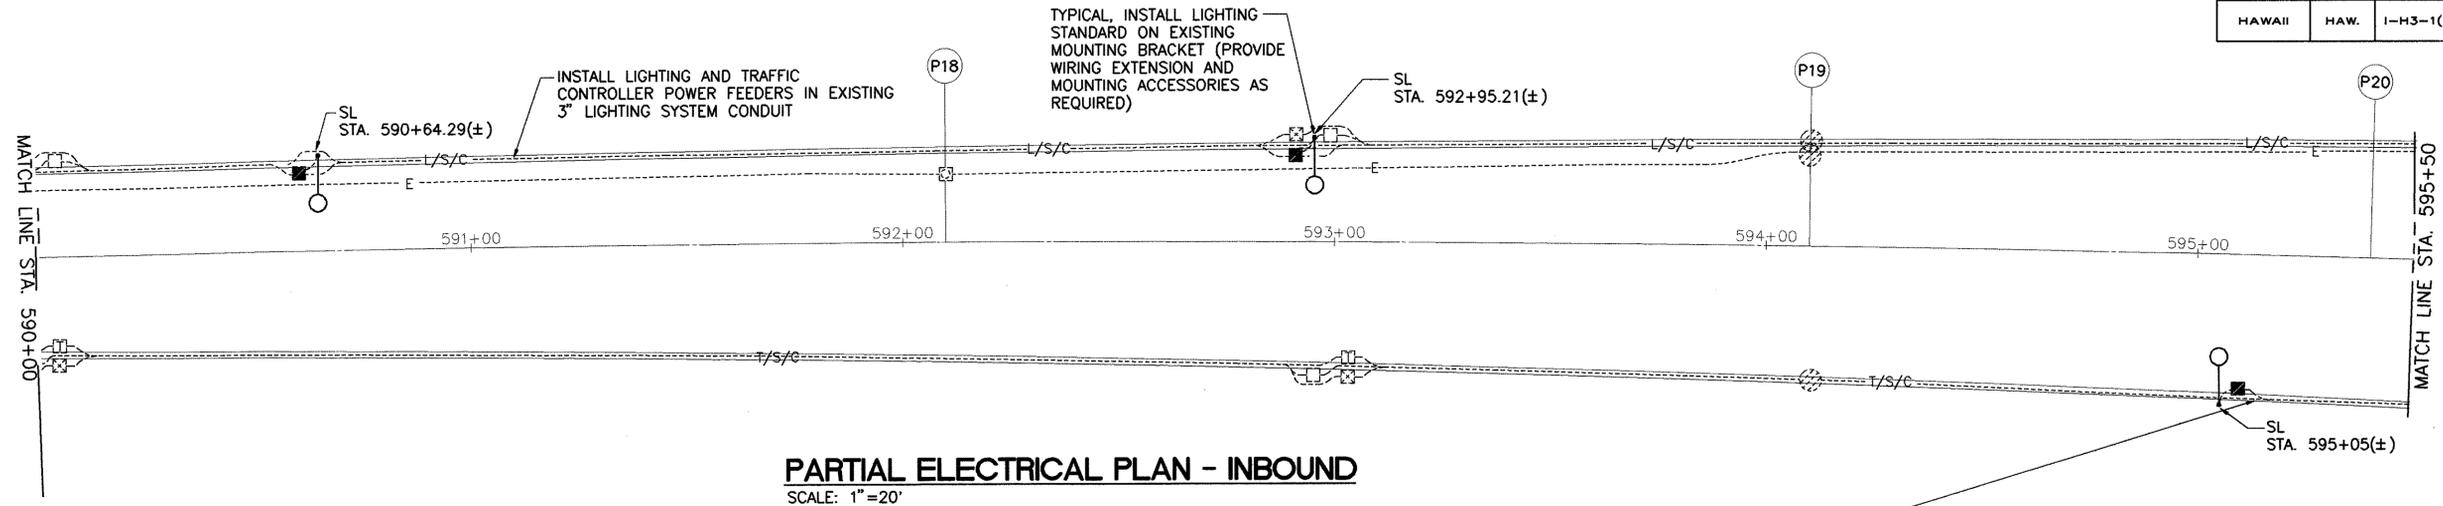

PARTIAL ELECTRICAL PLAN - INBOUND


SCALE: 1"=20'

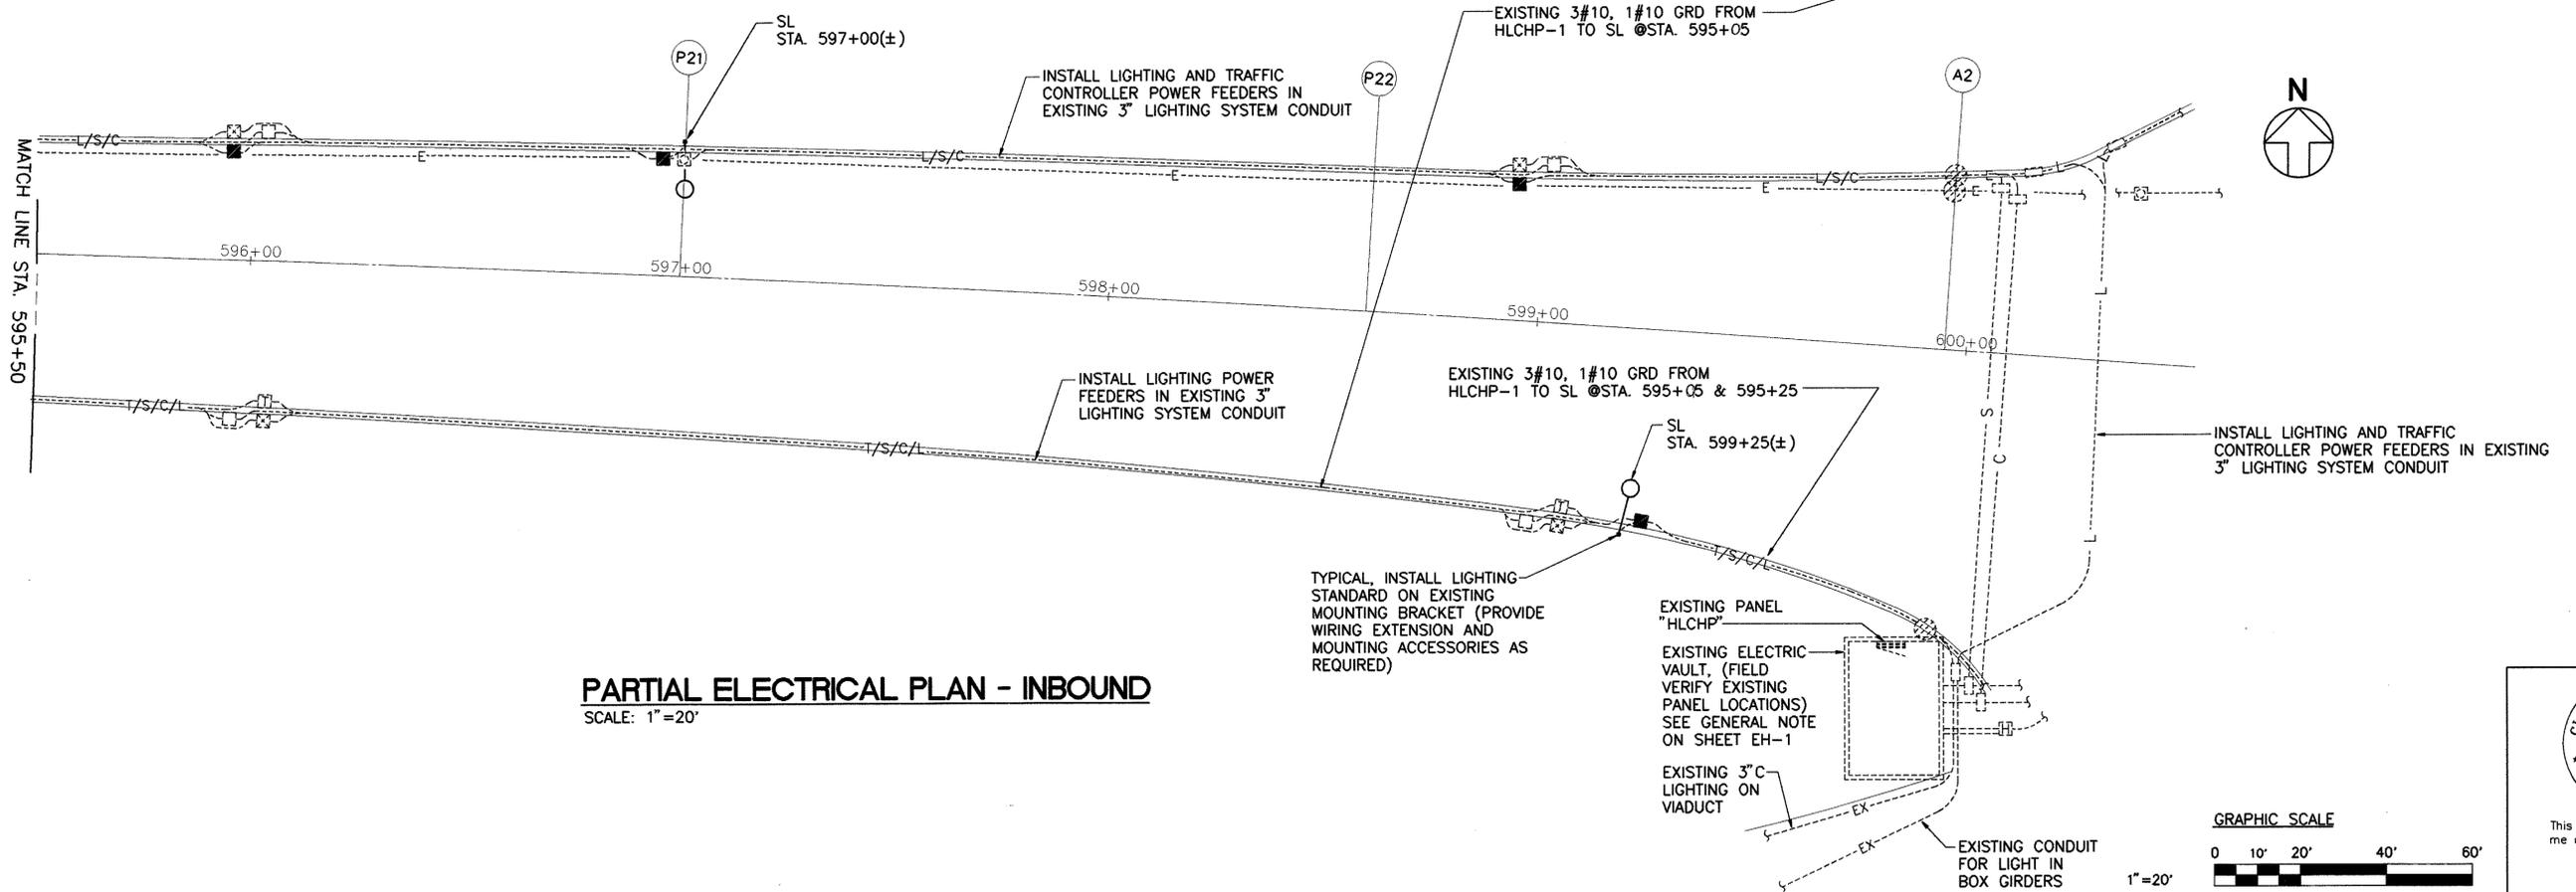

PARTIAL ELECTRICAL PLAN - INBOUND

SCALE: 1"=20'

DATE	
SURVEY PLOTTED BY	
DRAWN BY	
DESIGNED BY	
NOTED BY	
CHECKED BY	
NO.	

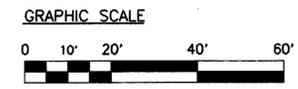


 LICENSED PROFESSIONAL ENGINEER
 No. 1765-E
 HAWAII, U.S.A.

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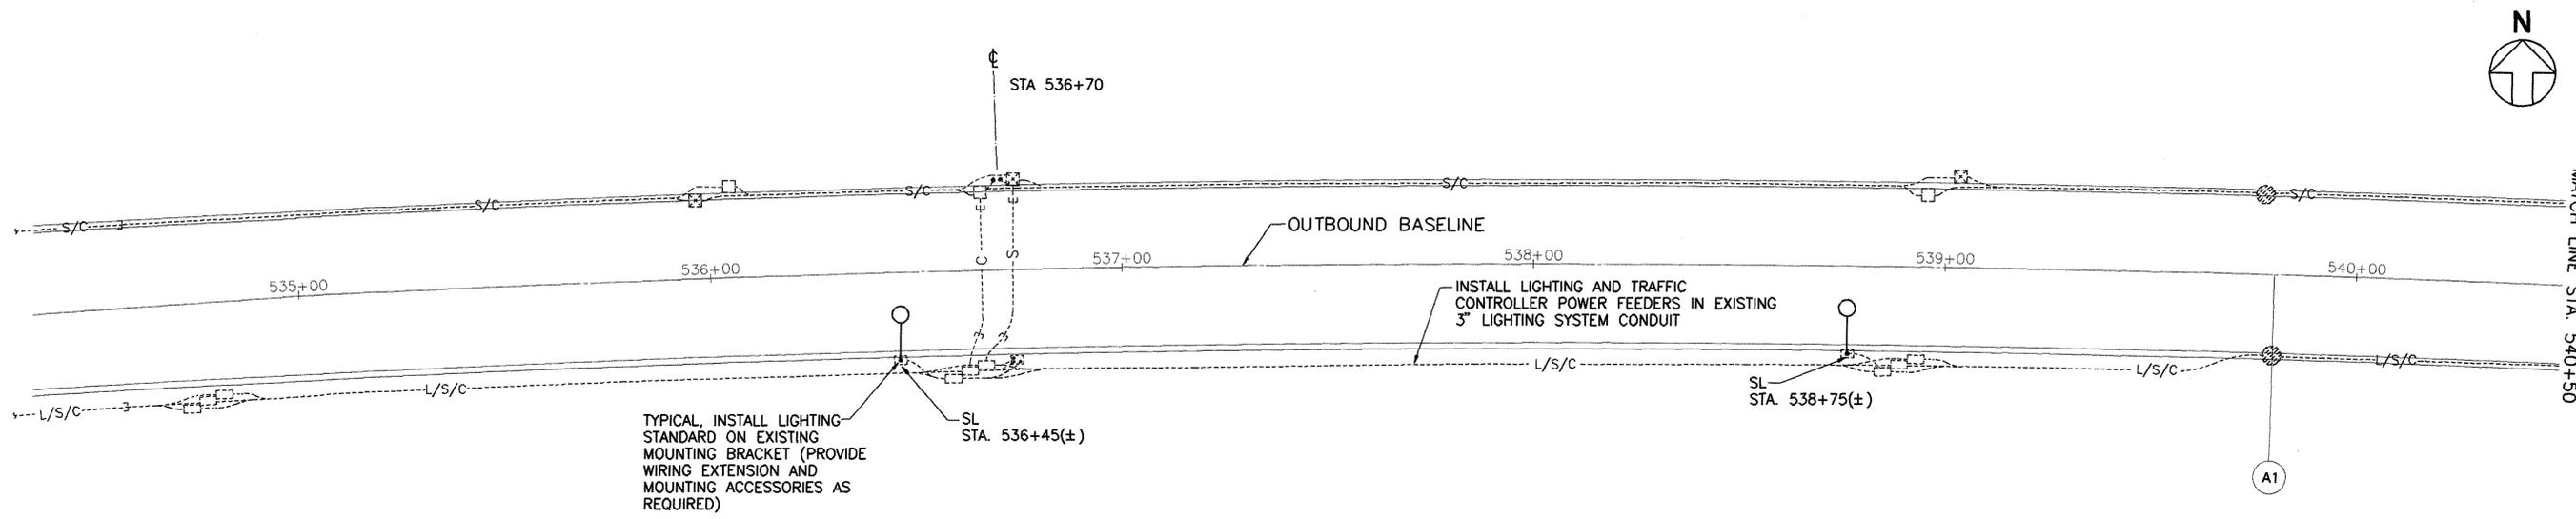
 SIGNATURE

STATE OF HAWAII
 DEPARTMENT OF TRANSPORTATION
 HIGHWAYS DIVISION
PARTIAL ELECTRICAL PLAN-
INBOUND EXTERIOR
STA. 590+00 TO 599+00
 INTERSTATE ROUTE H-3
 F.A.I. PROJECT NO. I-H3-1 (75) UNIT 1


SCALE: 1" = 20' DATE: JAN. 1996
 SHEET NO. EH-7 OF 32 SHEETS

DATE	REVISION

FED. ROAD DIST. NO.	STATE	FED. AID PROJ. NO.	FISCAL YEAR	SHEET NO.	TOTAL SHEETS
HAWAII	HAW.	I-H3-1(75), UNIT I	1996	299	405





PARTIAL ELECTRICAL PLAN - OUTBOUND
SCALE: 1" = 20'

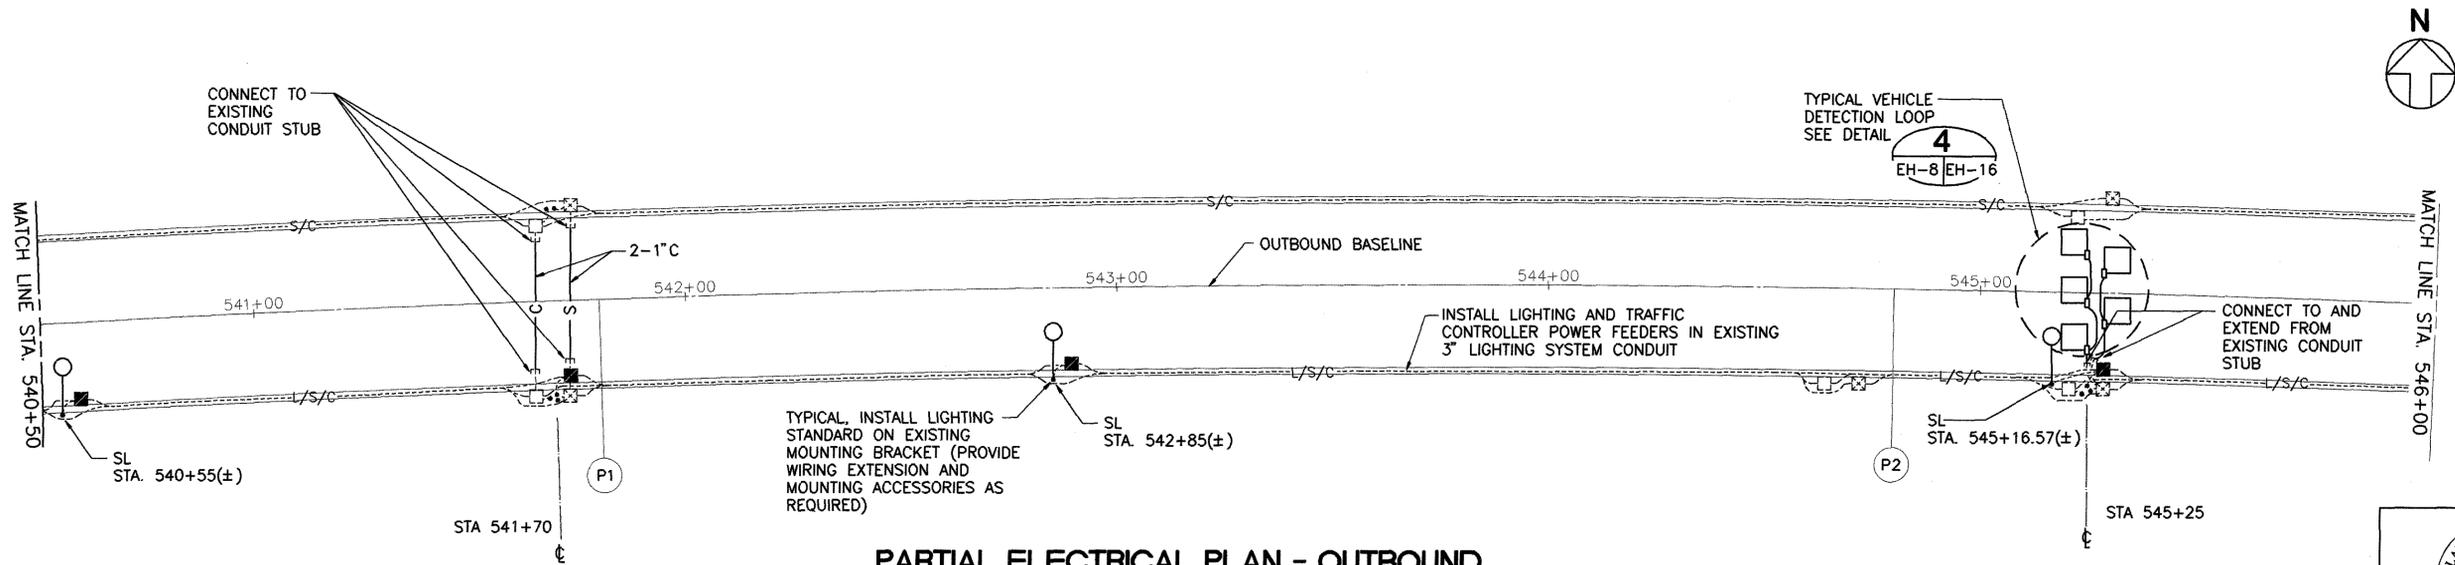

PARTIAL ELECTRICAL PLAN - OUTBOUND
SCALE: 1" = 20'

NOTE
REMOVE AND REPLACE THE PVC CONDUITS AND ADD TWO ONE-INCH CONDUITS, ONE FOR COMMUNICATION AND THE OTHER FOR THE SIGNAL SYSTEM IN THE VICINITY OF STA. 541+70 OF NORTH HALAWA VALLEY VIADUCT OUTBOUND.

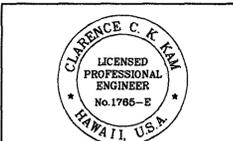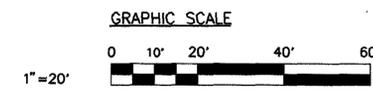

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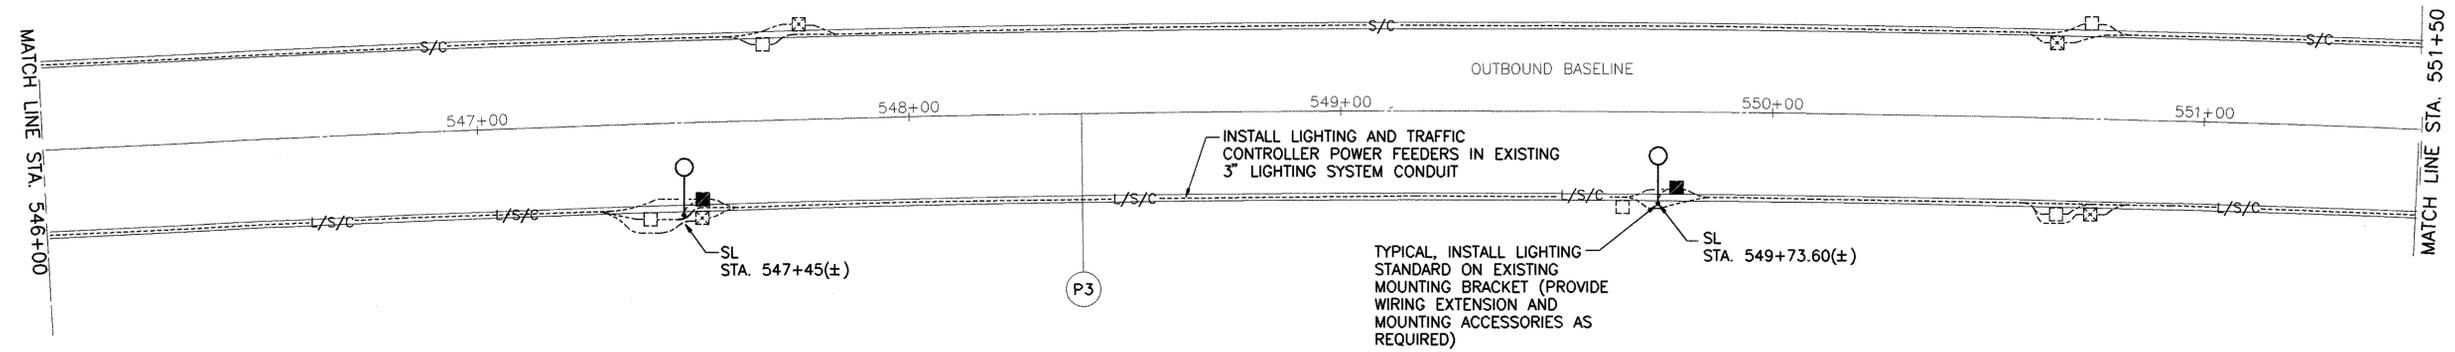
C. K. Ham
SIGNATURE

SURVEY PLOTTED BY	DATE
DRAWN BY	
TRACED BY	
QUANTIFIED BY	
CHECKED BY	
ORIGINAL PLAN	
NO. _____	


STATE OF HAWAII
DEPARTMENT OF TRANSPORTATION
HIGHWAYS DIVISION
**PARTIAL ELECTRICAL PLAN-
OUTBOUND EXTERIOR**
STA. 534+58.24 TO 546+00
INTERSTATE ROUTE H-3
F.A.I. PROJECT NO. I-H3-1 (75) UNIT 1
SCALE: 1" = 20' DATE: JAN. 1996
SHEET NO. EH-8 OF 32 SHEETS

DATE	REVISION

FED. ROAD DIST. NO.	STATE	FED. AID PROJ. NO.	FISCAL YEAR	SHEET NO.	TOTAL SHEETS
HAWAII	HAW.	I-H3-1(75), UNIT 1	1996	300	405



PARTIAL ELECTRICAL PLAN - OUTBOUND
SCALE: 1"=20'

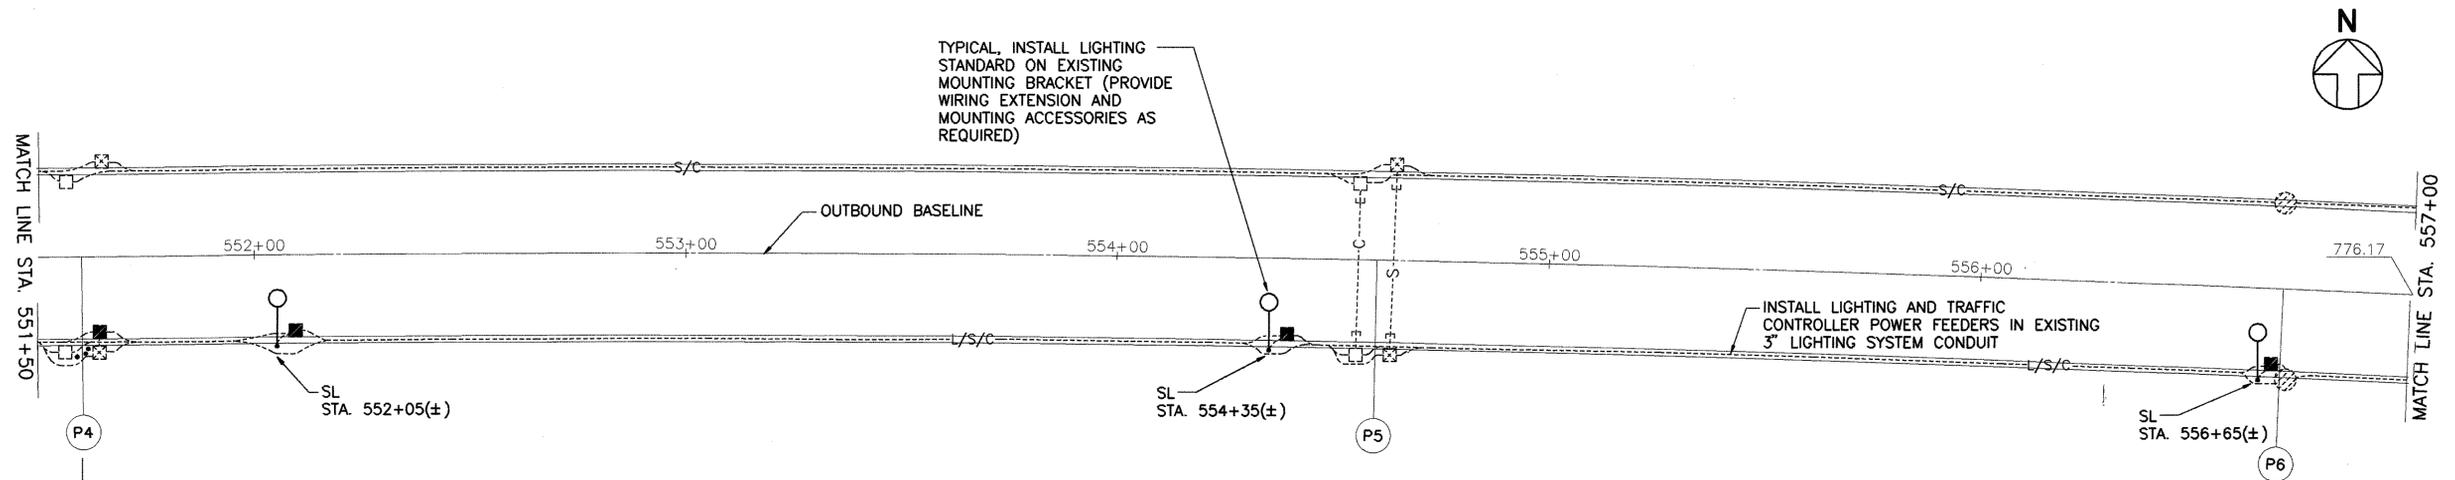


PARTIAL ELECTRICAL PLAN - OUTBOUND
SCALE: 1"=20'



SURVEY PLOTTED BY	DATE
DRAWN BY	
DESIGNED BY	
QUANTITIES BY	
CHECKED BY	
ORIGINAL PLAN	
NOTEBOOK	
No.	

STA 551+60

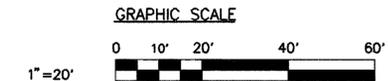


This work was prepared by me or under my supervision.

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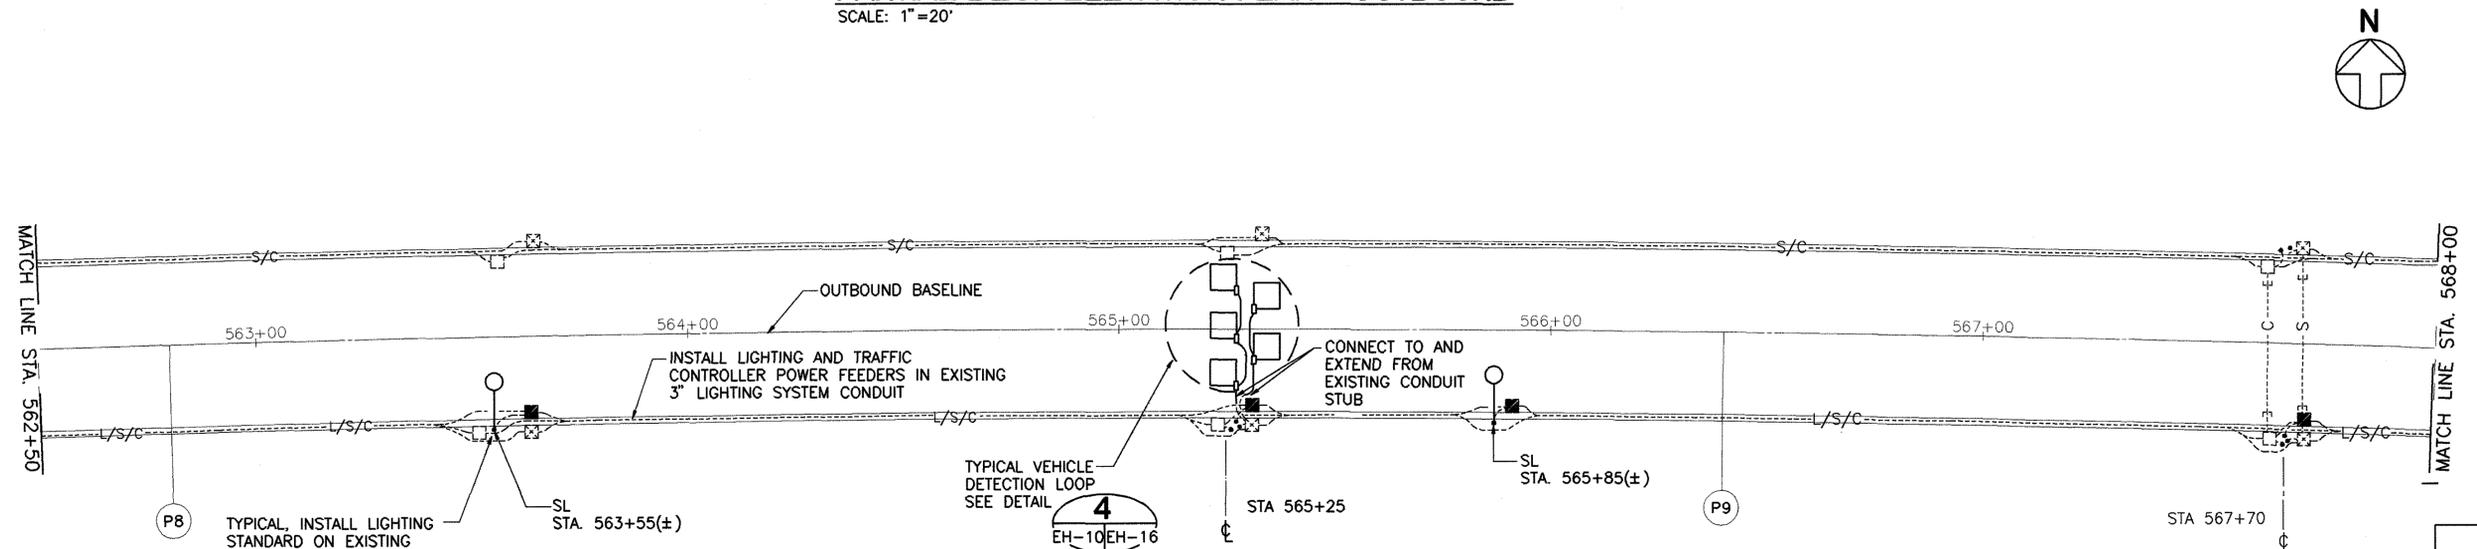
STATE OF HAWAII
 DEPARTMENT OF TRANSPORTATION
 HIGHWAYS DIVISION
PARTIAL ELECTRICAL PLAN -
OUTBOUND EXTERIOR
STA. 546+00 TO 557+00
 INTERSTATE ROUTE H-3
 F.A.I. PROJECT NO. I-H3-1 (75) UNIT 1
 SCALE: 1" = 20' DATE: JAN. 1996
 SHEET NO. EH-9 OF 32 SHEETS

DATE	REVISION

FED. ROAD DIST. NO.	STATE	FED. AID PROJ. NO.	FISCAL YEAR	SHEET NO.	TOTAL SHEETS
HAWAII	HAW.	I-H3-1(75), UNIT 1	1996	301	405

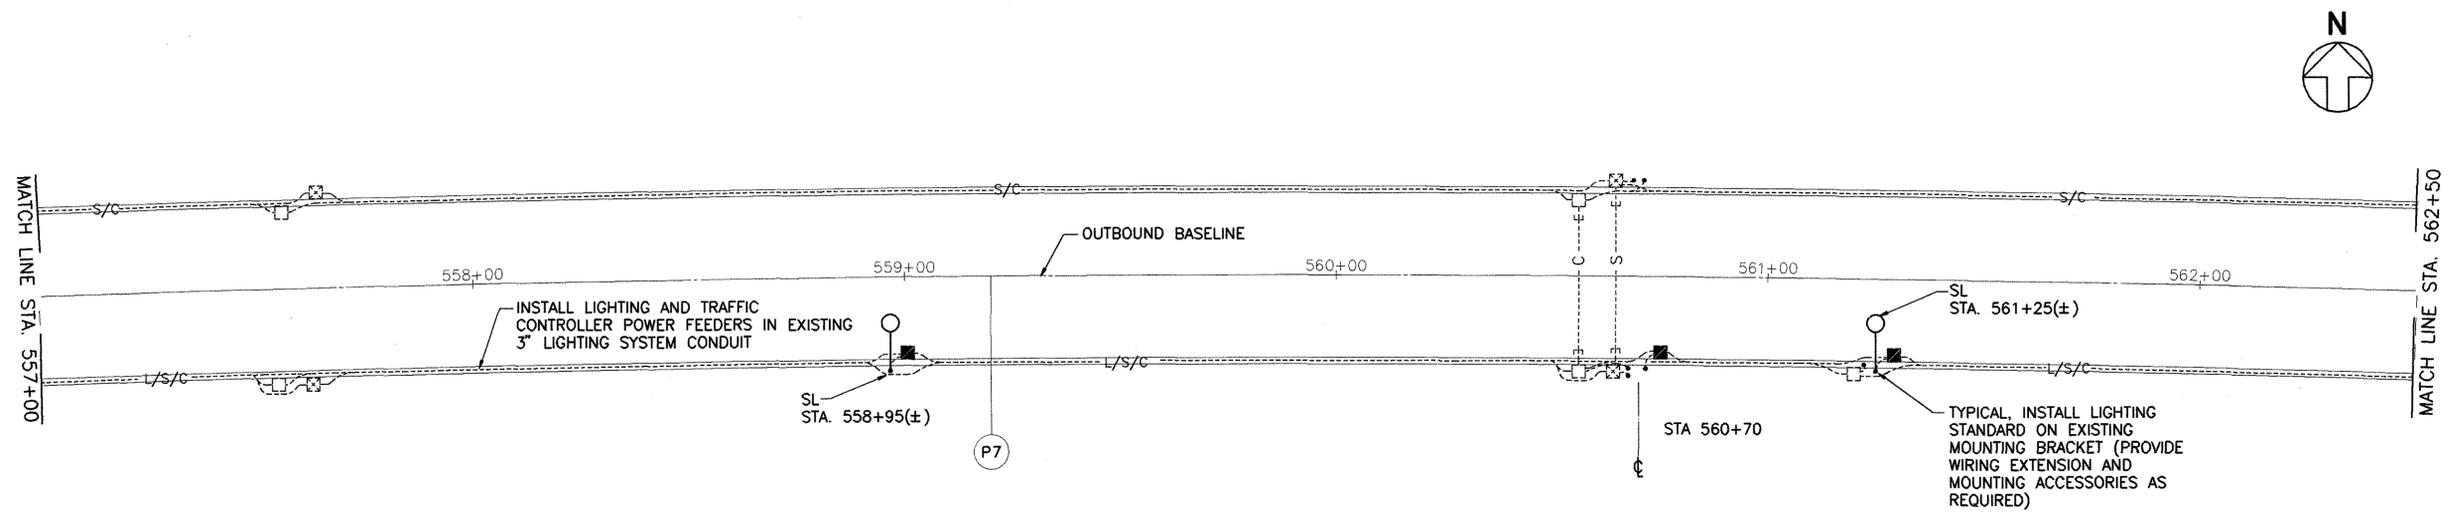


PARTIAL DECK ELEVATION PLAN - OUTBOUND
SCALE: 1"=20'



PARTIAL DECK ELEVATION PLAN - OUTBOUND
SCALE: 1"=20'

SURVEY LOCATED BY	DATE
DRAWN BY	
DESIGNED BY	
QUANTITIES BY	
CHECKED BY	
ORIGINAL PLAN	
NOTEBOOK	
No.	

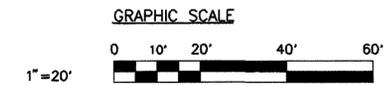


CLARENCE C. K. KAM
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C. K. Kam
SIGNATURE


STATE OF HAWAII
DEPARTMENT OF TRANSPORTATION
HIGHWAYS DIVISION
PARTIAL ELECTRICAL PLAN -
OUTBOUND EXTERIOR
STA. 557+00 TO 568+00
INTERSTATE ROUTE H-3
F.A.I. PROJECT NO. I-H3-1 (75) UNIT 1
SCALE: 1" = 20' DATE: JAN. 1996
SHEET NO. EH-10 OF 32 SHEETS

DATE	REVISION

FED. ROAD DIST. NO.	STATE	FED. AID PROJ. NO.	FISCAL YEAR	SHEET NO.	TOTAL SHEETS
HAWAII	HAW.	I-H3-1(75), UNIT 1	1996	302	405

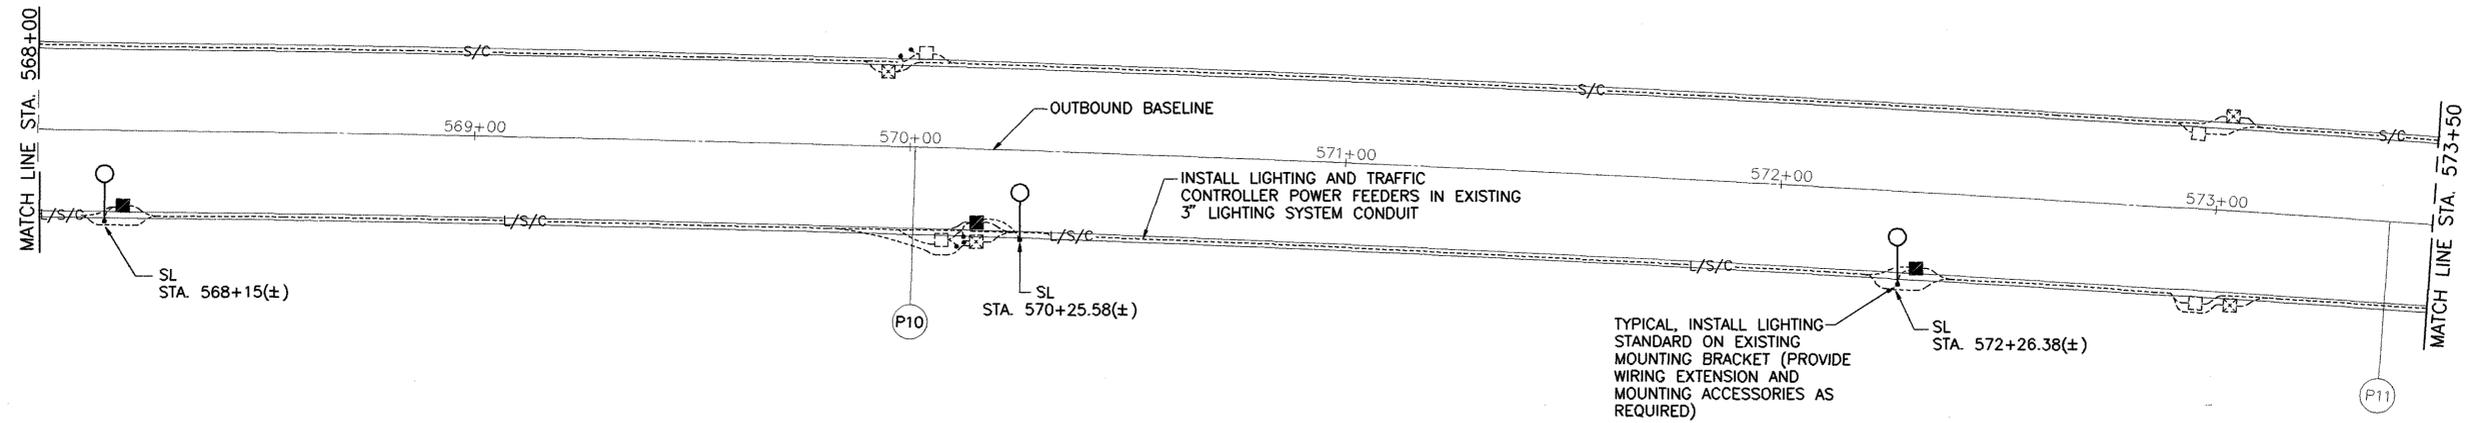


PARTIAL ELECTRICAL PLAN - OUTBOUND
SCALE: 1"=20'

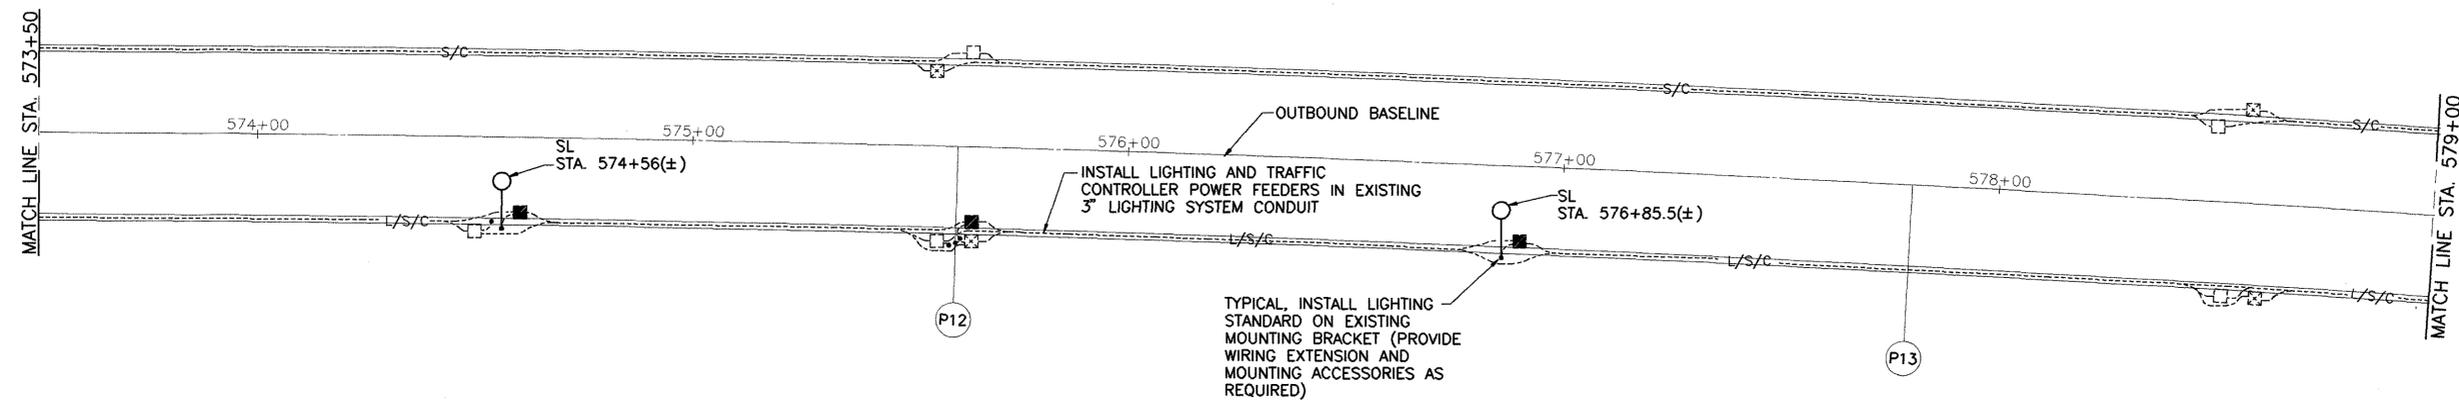

PARTIAL ELECTRICAL PLAN - OUTBOUND
SCALE: 1"=20'

GRAPHIC SCALE

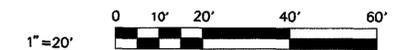

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(Signature)
SIGNATURE


STATE OF HAWAII
DEPARTMENT OF TRANSPORTATION
HIGHWAYS DIVISION
PARTIAL ELECTRICAL PLAN -
OUTBOUND EXTERIOR
STA. 568+00 TO 579+00
INTERSTATE ROUTE H-3
F.A.I. PROJECT NO. I-H3-1 (75) UNIT 1

SCALE: 1" = 20' DATE: JAN. 1996
SHEET NO. EH-11 OF 32 SHEETS


DATE	REVISION

SURVEY PLOTTED BY	DATE
DRAWN BY	
DESIGNED BY	
QUANTITIES BY	
CHECKED BY	
ORIGINAL PLAN	
NOTEBOOK	
No.	

FED. ROAD DIST. NO.	STATE	FED. AID PROJ. NO.	FISCAL YEAR	SHEET NO.	TOTAL SHEETS
HAWAII	HAW.	I-H3-1(75), UNIT 1	1996	303	405

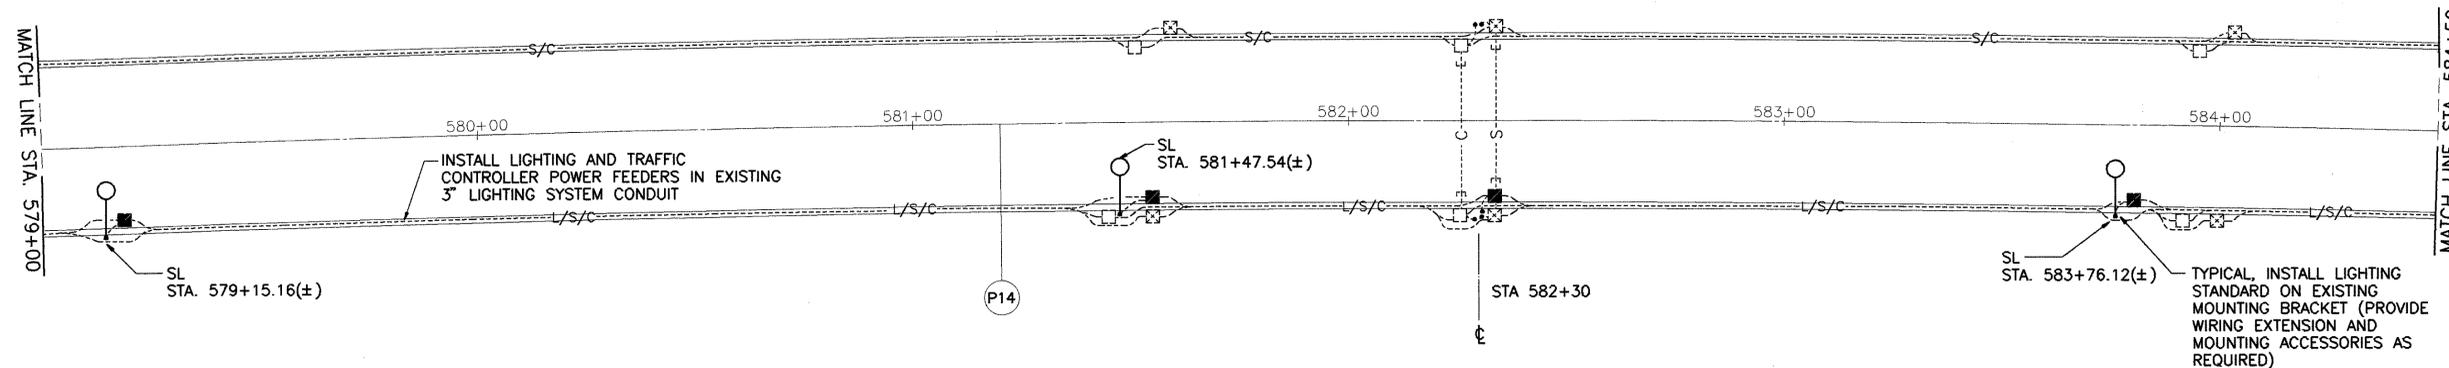

PARTIAL ELECTRICAL PLAN - OUTBOUND
SCALE: 1"=20'

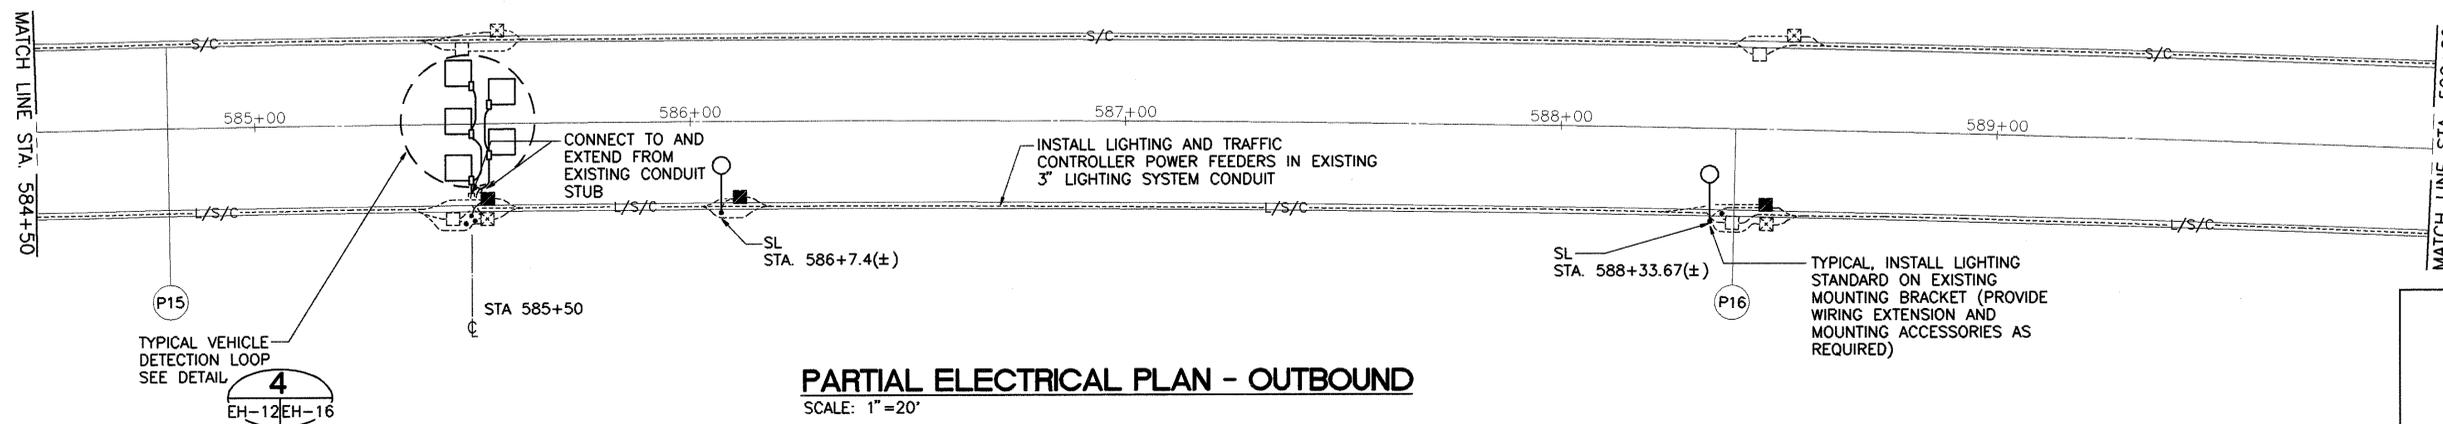


PARTIAL ELECTRICAL PLAN - OUTBOUND
SCALE: 1"=20'

DATE	_____
SURVEY PLANNED BY	_____
DRAWN BY	_____
TRACED BY	_____
DESIGNED BY	_____
QUANTITIES BY	_____
CHECKED BY	_____
NO.	_____

TYPICAL VEHICLE DETECTION LOOP
SEE DETAIL
4
EH-12/EH-16

GRAPHIC SCALE

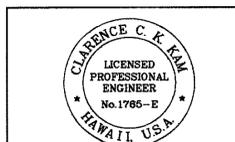

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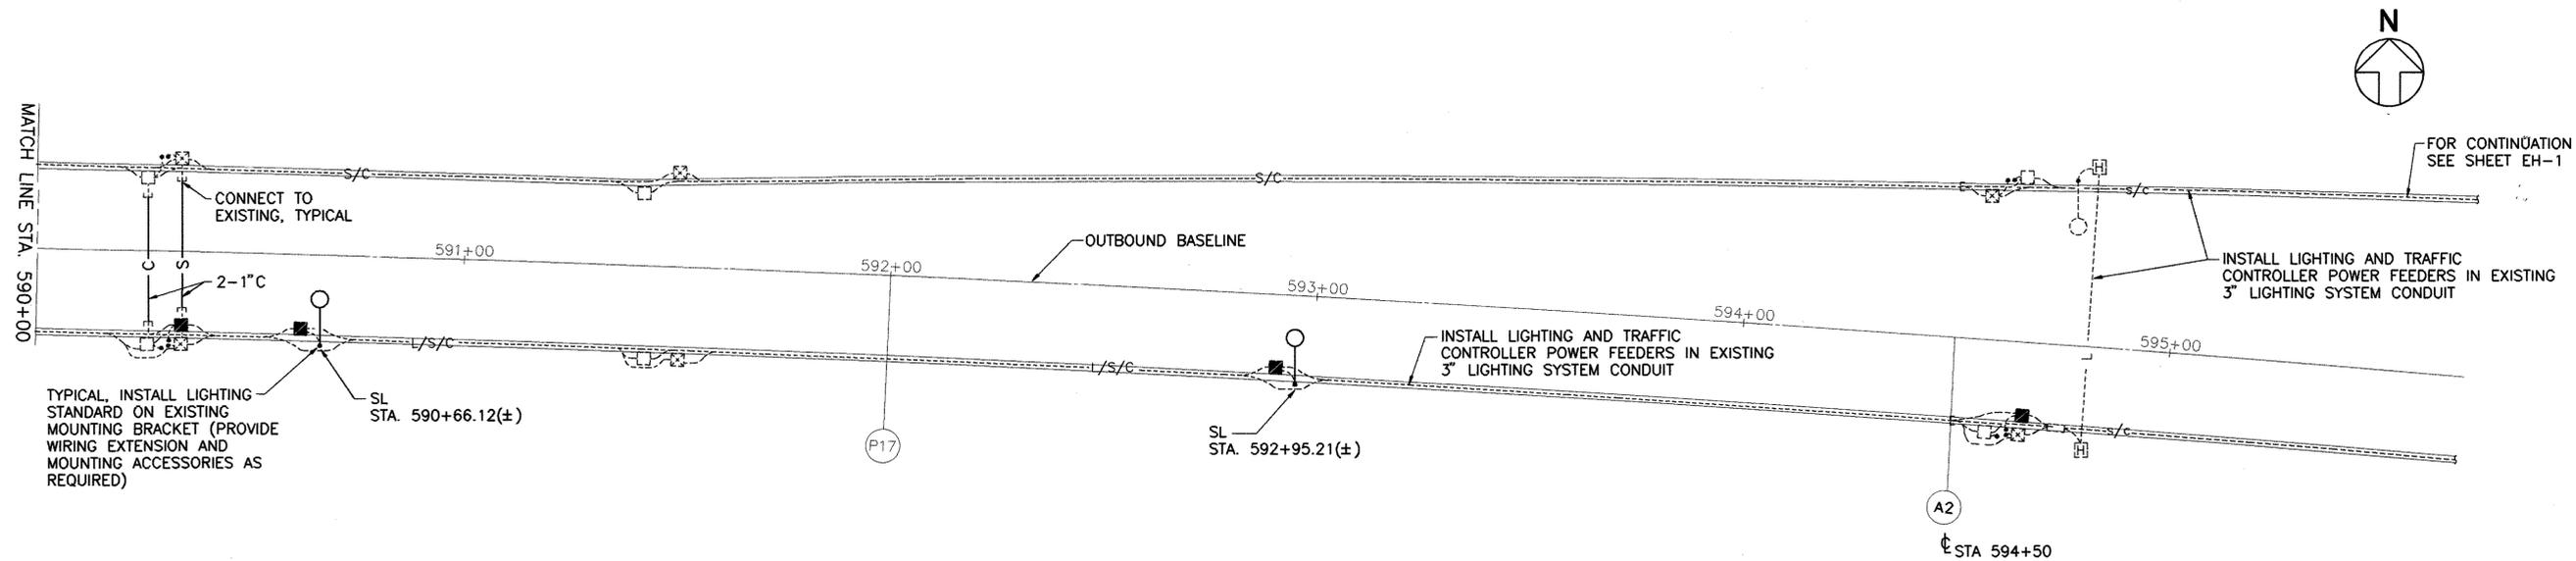
Clarence C. K. Kam
SIGNATURE

STATE OF HAWAII
DEPARTMENT OF TRANSPORTATION
HIGHWAYS DIVISION
**PARTIAL ELECTRICAL PLAN -
OUTBOUND EXTERIOR**
STA. 579+00 TO 590+00
INTERSTATE ROUTE H-3
F.A.I. PROJECT NO. I-H3-1 (75) UNIT 1

SCALE: 1" = 20' DATE: JAN. 1996
SHEET NO. EH-12 OF 32 SHEETS


DATE	REVISION

FED. ROAD DIST. NO.	STATE	FED. AID PROJ. NO.	FISCAL YEAR	SHEET NO.	TOTAL SHEETS
HAWAII	HAW.	I-H3-1(75), UNIT 1	1996	304	405



PARTIAL DECK ELEVATION PLAN - OUTBOUND
SCALE: 1" = 20'

DATE	_____
SURVEY PLOTTED BY	_____
DRAWN BY	_____
TRACED BY	_____
DESIGNED BY	_____
QUANTITIES BY	_____
CHECKED BY	_____
ORIGINAL PLAN	_____
NOTEBOOK	_____
No.	_____

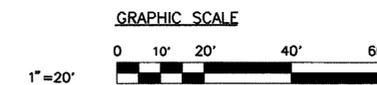

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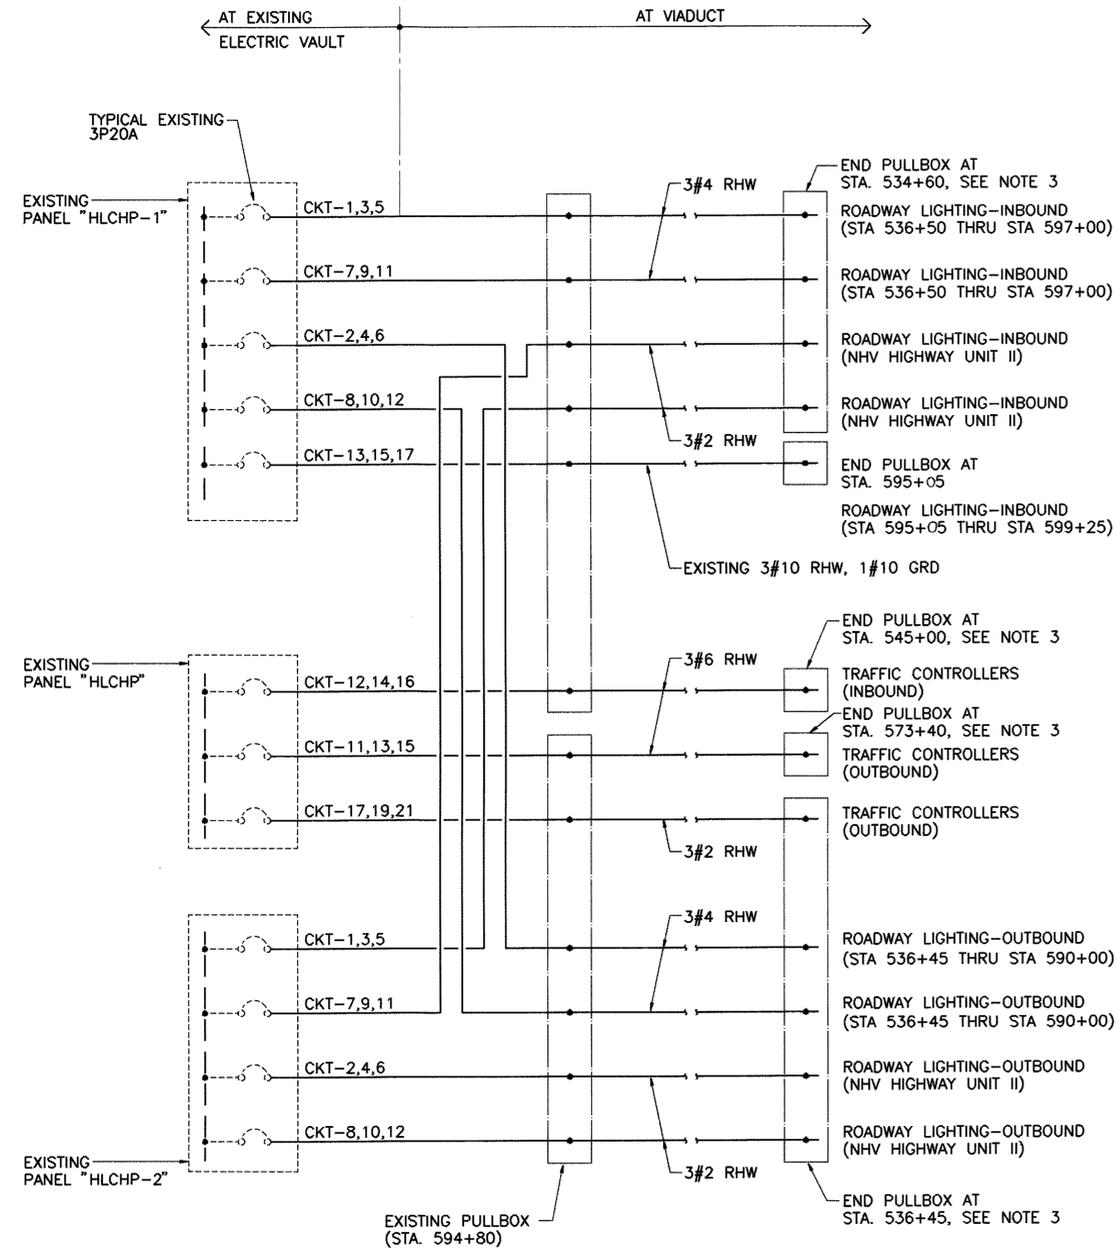
Clarence C. K. Kim
SIGNATURE

STATE OF HAWAII
DEPARTMENT OF TRANSPORTATION
HIGHWAYS DIVISION
**PARTIAL ELECTRICAL PLAN -
OUTBOUND EXTERIOR**
STA. 590+00 TO 594+50
INTERSTATE ROUTE H-3
F.A.I. PROJECT NO. I-H3-1 (75) UNIT 1

SCALE: 1" = 20' DATE: JAN. 1996
SHEET NO. EH-13 OF 32 SHEETS

DATE	REVISION


FED. ROAD DIST. NO.	STATE	FED. AID PROJ. NO.	FISCAL YEAR	SHEET NO.	TOTAL SHEETS
HAWAII	HAW.	I-H3-1(75), UNIT 1	1996	305	405



ONE-LINE DIAGRAM
NOT TO SCALE

NOTES:

1. ALL LINES IN DASH ARE EXISTING, SOLID ARE (NEW) TO BE PROVIDED IN THIS CONTRACT.
2. STREET LIGHTING AND TRAFFIC CONTROLLERS CIRCUITS SHALL BE INSTALLED IN COMMON CONDUIT SYSTEM IN EACH VIADUCT. (PROVIDE COMMON GROUND WIRE PER NEC REQUIREMENT MIN. #2 AWG.)
3. TERMINATE POWER CABLES IN PULLBOX. PROVIDE MINIMUM 5 FEET SLACK AND SEAL ENDS AGAINST MOISTURE.

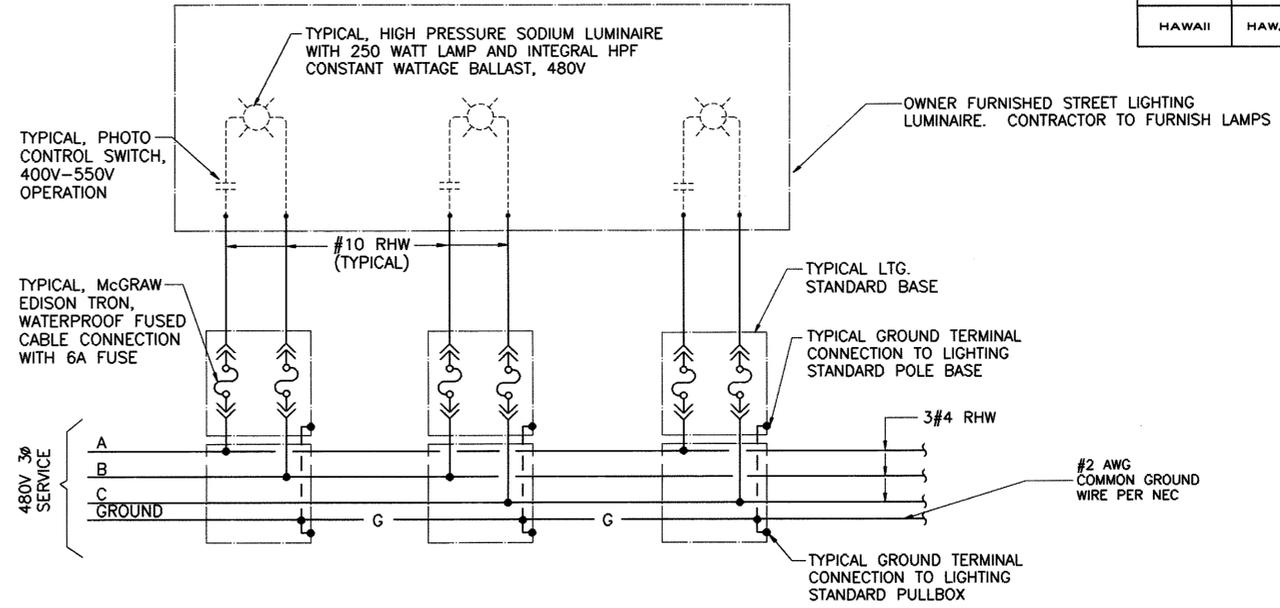

TYPICAL STREET LIGHTING WIRING DIAGRAM
NOT TO SCALE

DATE	_____
DESIGNED BY	_____
DRAWN BY	_____
CHECKED BY	_____
NOTED BY	_____
QUANTITIES BY	_____
REVISIONS	_____

CLARENCE C. K. KIM
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No. 1765-E
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SIGNATURE

STATE OF HAWAII
DEPARTMENT OF TRANSPORTATION
HIGHWAYS DIVISION


ELECTRICAL
ONE-LINE DIAGRAM

INTERSTATE ROUTE H-3
F.A.I. PROJECT NO. I-H3-1 (75) UNIT 1


SCALE: 1" = 1' DATE: JAN. 1996
SHEET NO. EH-14 OF 32 SHEETS

DATE	REVISION


FED. ROAD DIST. NO.	STATE	FED. AID PROJ. NO.	FISCAL YEAR	SHEET NO.	TOTAL SHEETS
HAWAII	HAW.	I-H3-1(75). UNIT 1	1996	306	405

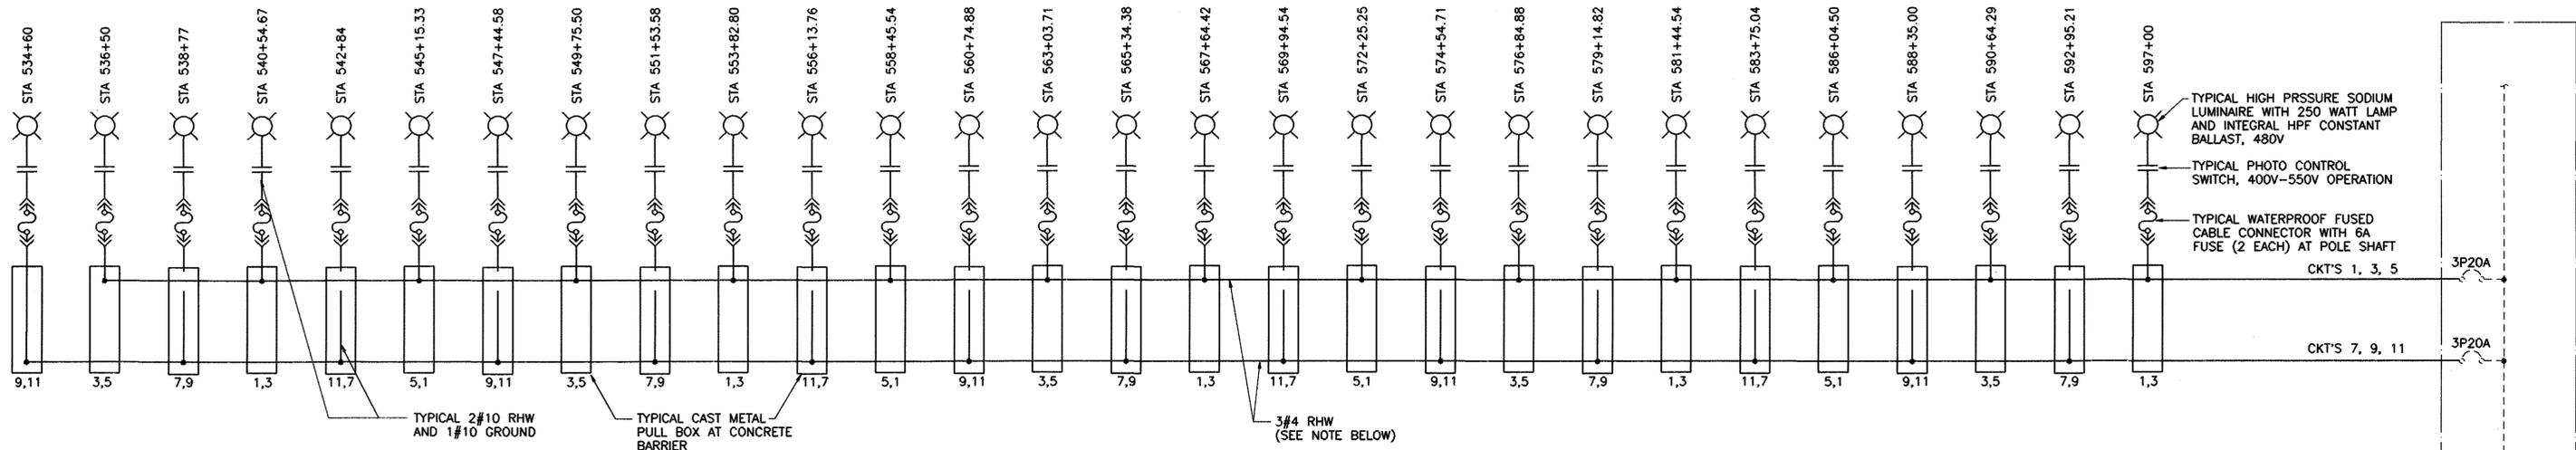

STREET LIGHTING ONE-LINE DIAGRAM
(INBOUND ROADWAY)

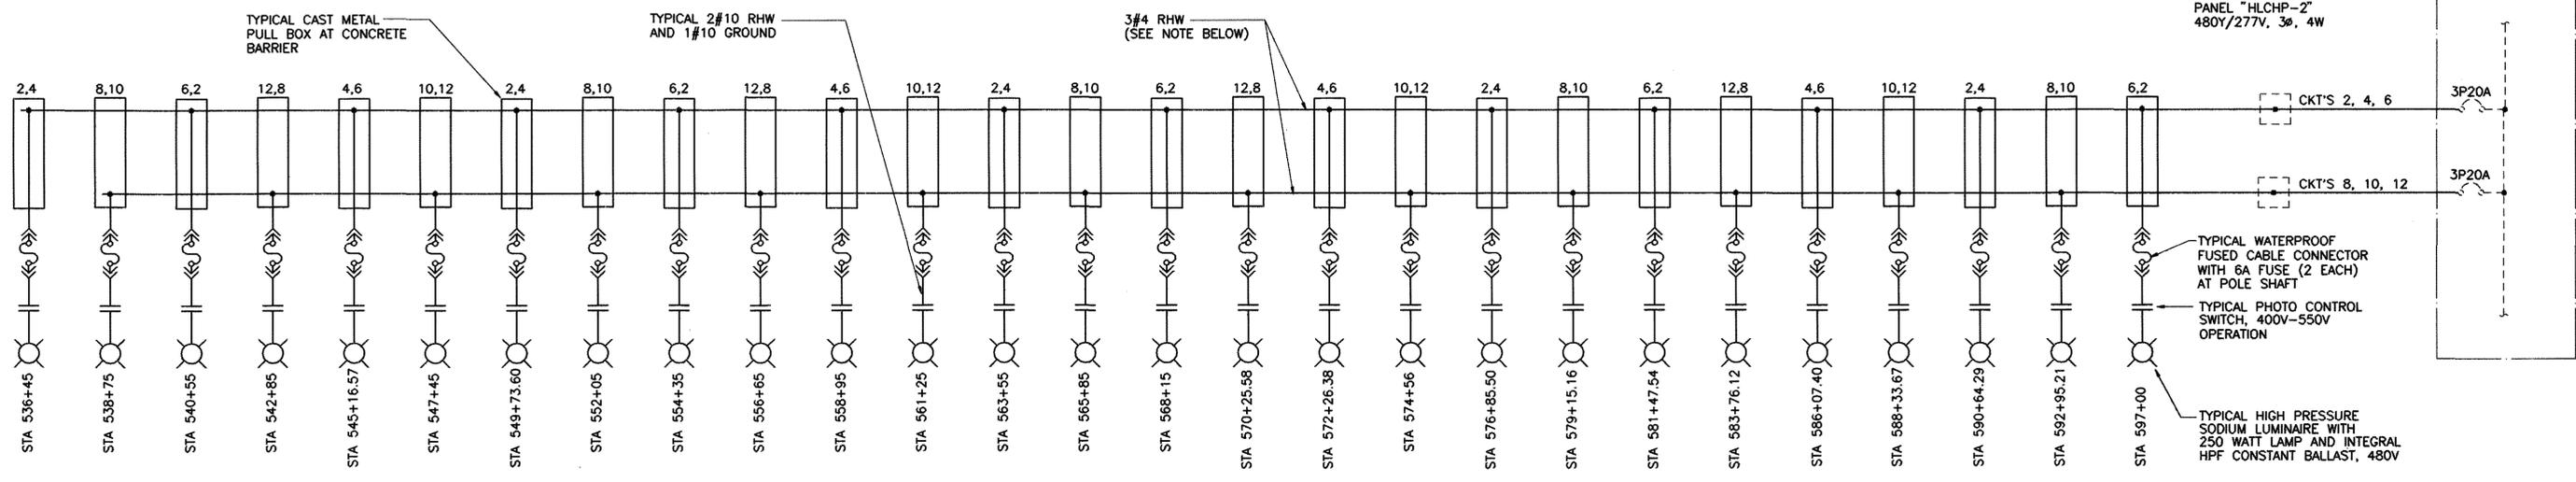


STREET LIGHTING ONE-LINE DIAGRAM
(OUTBOUND ROADWAY)

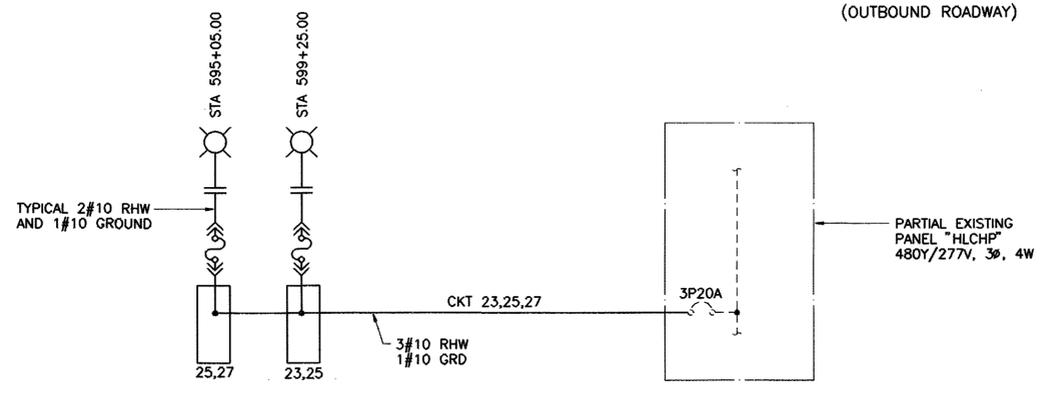

STREET LIGHTING ONE-LINE DIAGRAM
(INBOUND ROADWAY)

NOTE: STREET LIGHTING CIRCUITS WILL BE INSTALLED TOGETHER WITH COMMUNICATION POWER CIRCUITS IN ONE COMMON CONDUIT SYSTEM. PROVIDE #2 AWG COMMON GROUND WIRE PER NEC REQUIREMENT.

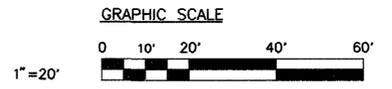


CLARENCE C. K. KIM
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No. 1765-E
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This work was prepared by me or under my supervision.
C. Kim
SIGNATURE

STATE OF HAWAII
DEPARTMENT OF TRANSPORTATION
HIGHWAYS DIVISION
STREET LIGHTING ONE-LINE DIAGRAM
INTERSTATE ROUTE H-3
F.A.I. PROJECT NO. I-H3-1 (75) UNIT 1
SCALE: 1" = 20' DATE: JAN. 1996
SHEET NO. EH-15 OF 32 SHEETS

DATE	REVISION


ORIGINAL PLAN
NO. _____
DATE _____
SURVEY PLOTTED BY _____
DRAWN BY _____
CHECKED BY _____
DESIGNED BY _____
QUANTITIES BY _____
NOTED BY _____

FED. ROAD DIST. NO.	STATE	FED. AID PROJ. NO.	FISCAL YEAR	SHEET NO.	TOTAL SHEETS
HAWAII	HAW.	I-H3-1(75), UNIT 1	1996	307	405

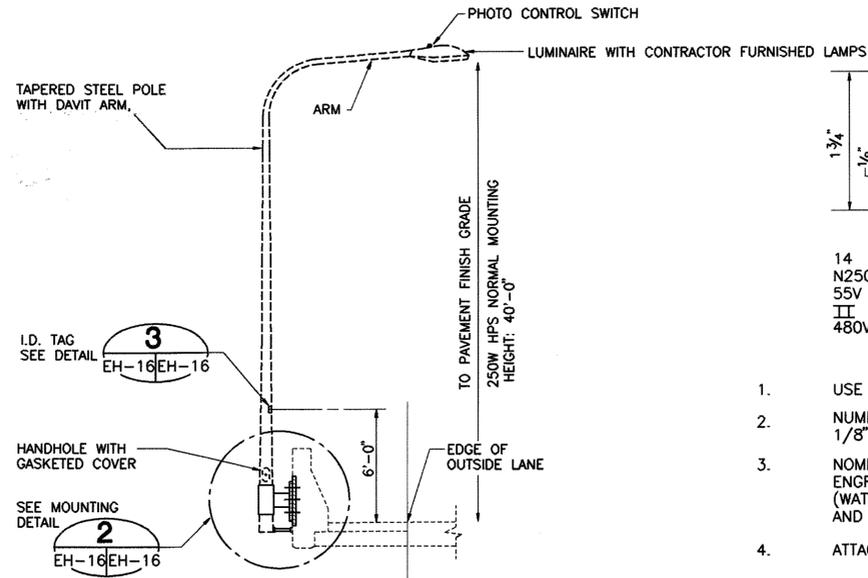

1 HIGHWAY LIGHTING STANDARD
EH-16/EH-16 NOT TO SCALE


EH-2, EH-3, EH-4, EH-5,
EH-6, EH-7, EH-8, EH-9,
EH-10, EH-11, EH-12, EH-13

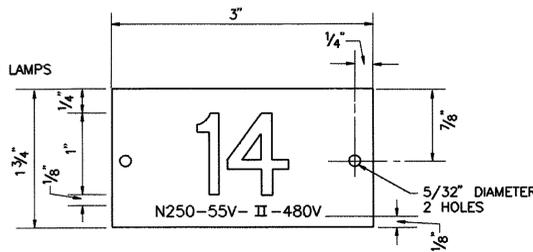


14 = POLE AND LIGHT NUMBER PER STATE'S REQUIREMENTS
N250 = LAMP TYPE AND WATTAGE, N = SODIUM
55V = LAMP VOLTAGE
II = IES TYPE DISTRIBUTION
480V = BALLAST VOLTAGE

- USE 3-PLY PLASTIC - BLACK, WHITE, BLACK.
- NUMBER SIZE SHALL BE 1" HIGH AND ENGRAVED 1/8" WIDE, WHITE IN COLOR (NO. AS REQUIRED).
- NOMENCLATURE SIZE SHALL BE 1/4" HIGH AND ENGRAVED 1/32" WIDE, WHITE IN COLOR (WATTAGE, LAMP VOLTAGES, IES DISTRIBUTION AND BALLAST VOLTAGE).
- ATTACH SECURELY TO POLE WITH NO. 7 STAINLESS STEEL SCREWS.
- "N" FOR SODIUM LAMPS.
- ATTACH TAG 6'-0" ABOVE FINISH GRADE ON STREET SIDE.

3 I.D. TAG DETAIL
EH-16/EH-16 NOT TO SCALE

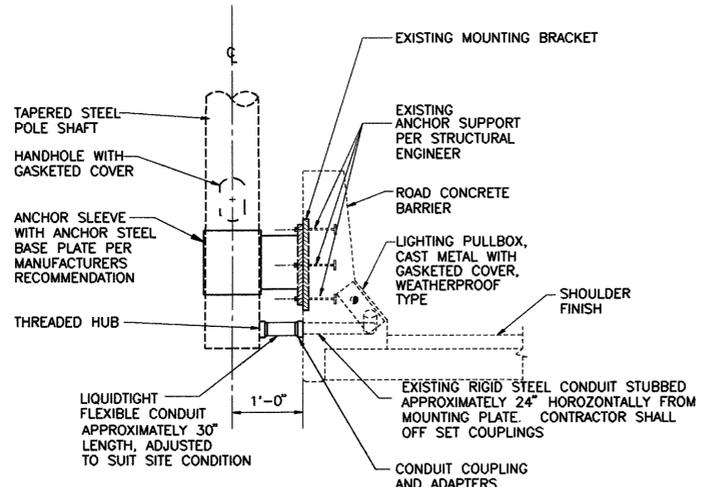


2 LIGHTING STANDARD MOUNTING DETAIL
EH-16/EH-16 NOT TO SCALE

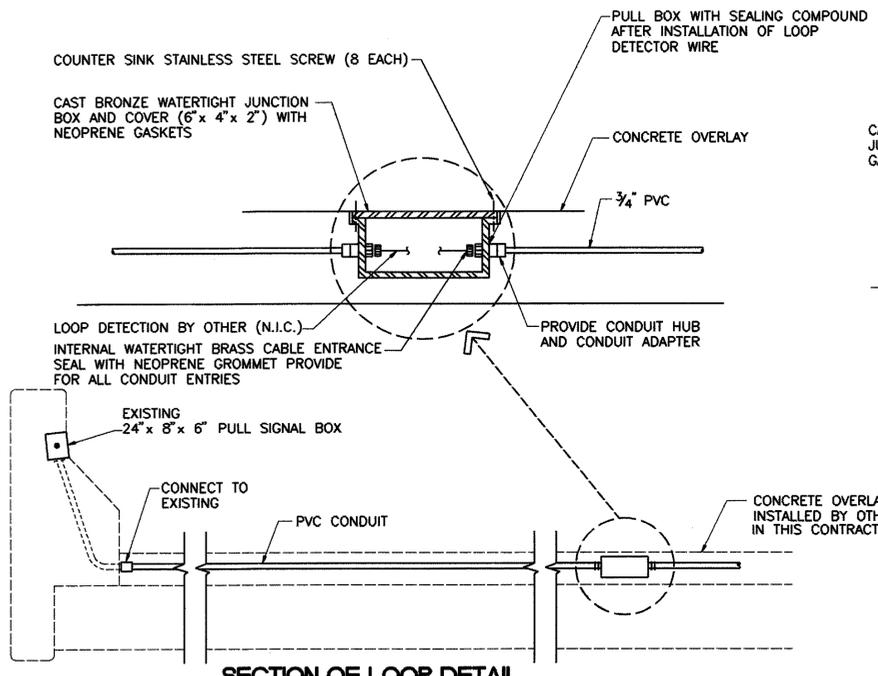

4 TYPICAL DETECTOR LOOP DETAIL
EH-2/EH-16 NOT TO SCALE

EH-10, EH-12,
EH-4, EH-6, EH-8.

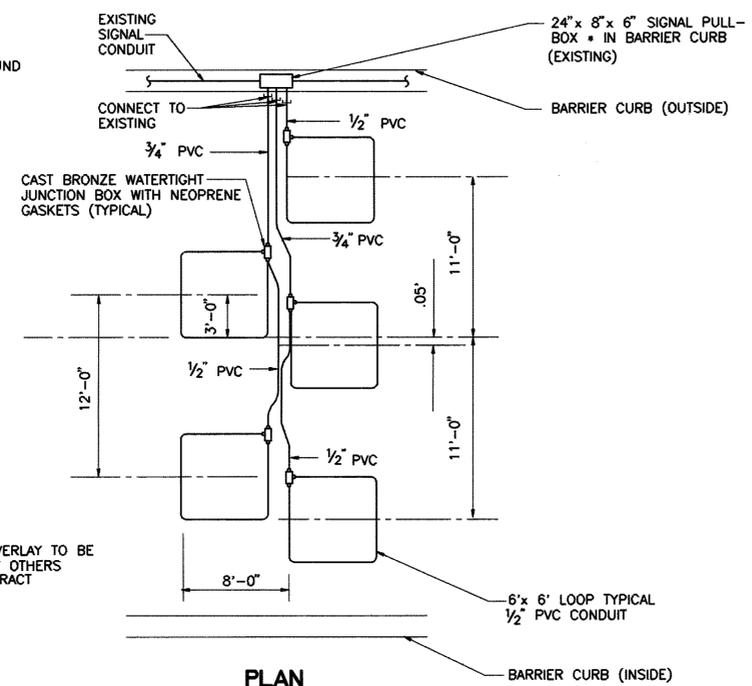

PLAN



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SIGNATURE


STATE OF HAWAII
DEPARTMENT OF TRANSPORTATION
HIGHWAYS DIVISION
**ELECTRICAL DETAILS-
EXTERIOR**
INTERSTATE ROUTE H-3
F.A.I. PROJECT NO. I-H3-1 (75) UNIT 1

SCALE: 1" = 1' DATE: JAN. 1996
SHEET NO. EH-16 OF 32 SHEETS

DESIGNED BY	DATE
DRAWN BY	
CHECKED BY	
QUANTITIES BY	
NOTED BY	
NO.	


DATE	REVISION

FED. ROAD DIST. NO.	STATE	FED. AID PROJ. NO.	FISCAL YEAR	SHEET NO.	TOTAL SHEETS
HAWAII	HAW.	1-H3-1(75), UNIT 1	1996	308	405

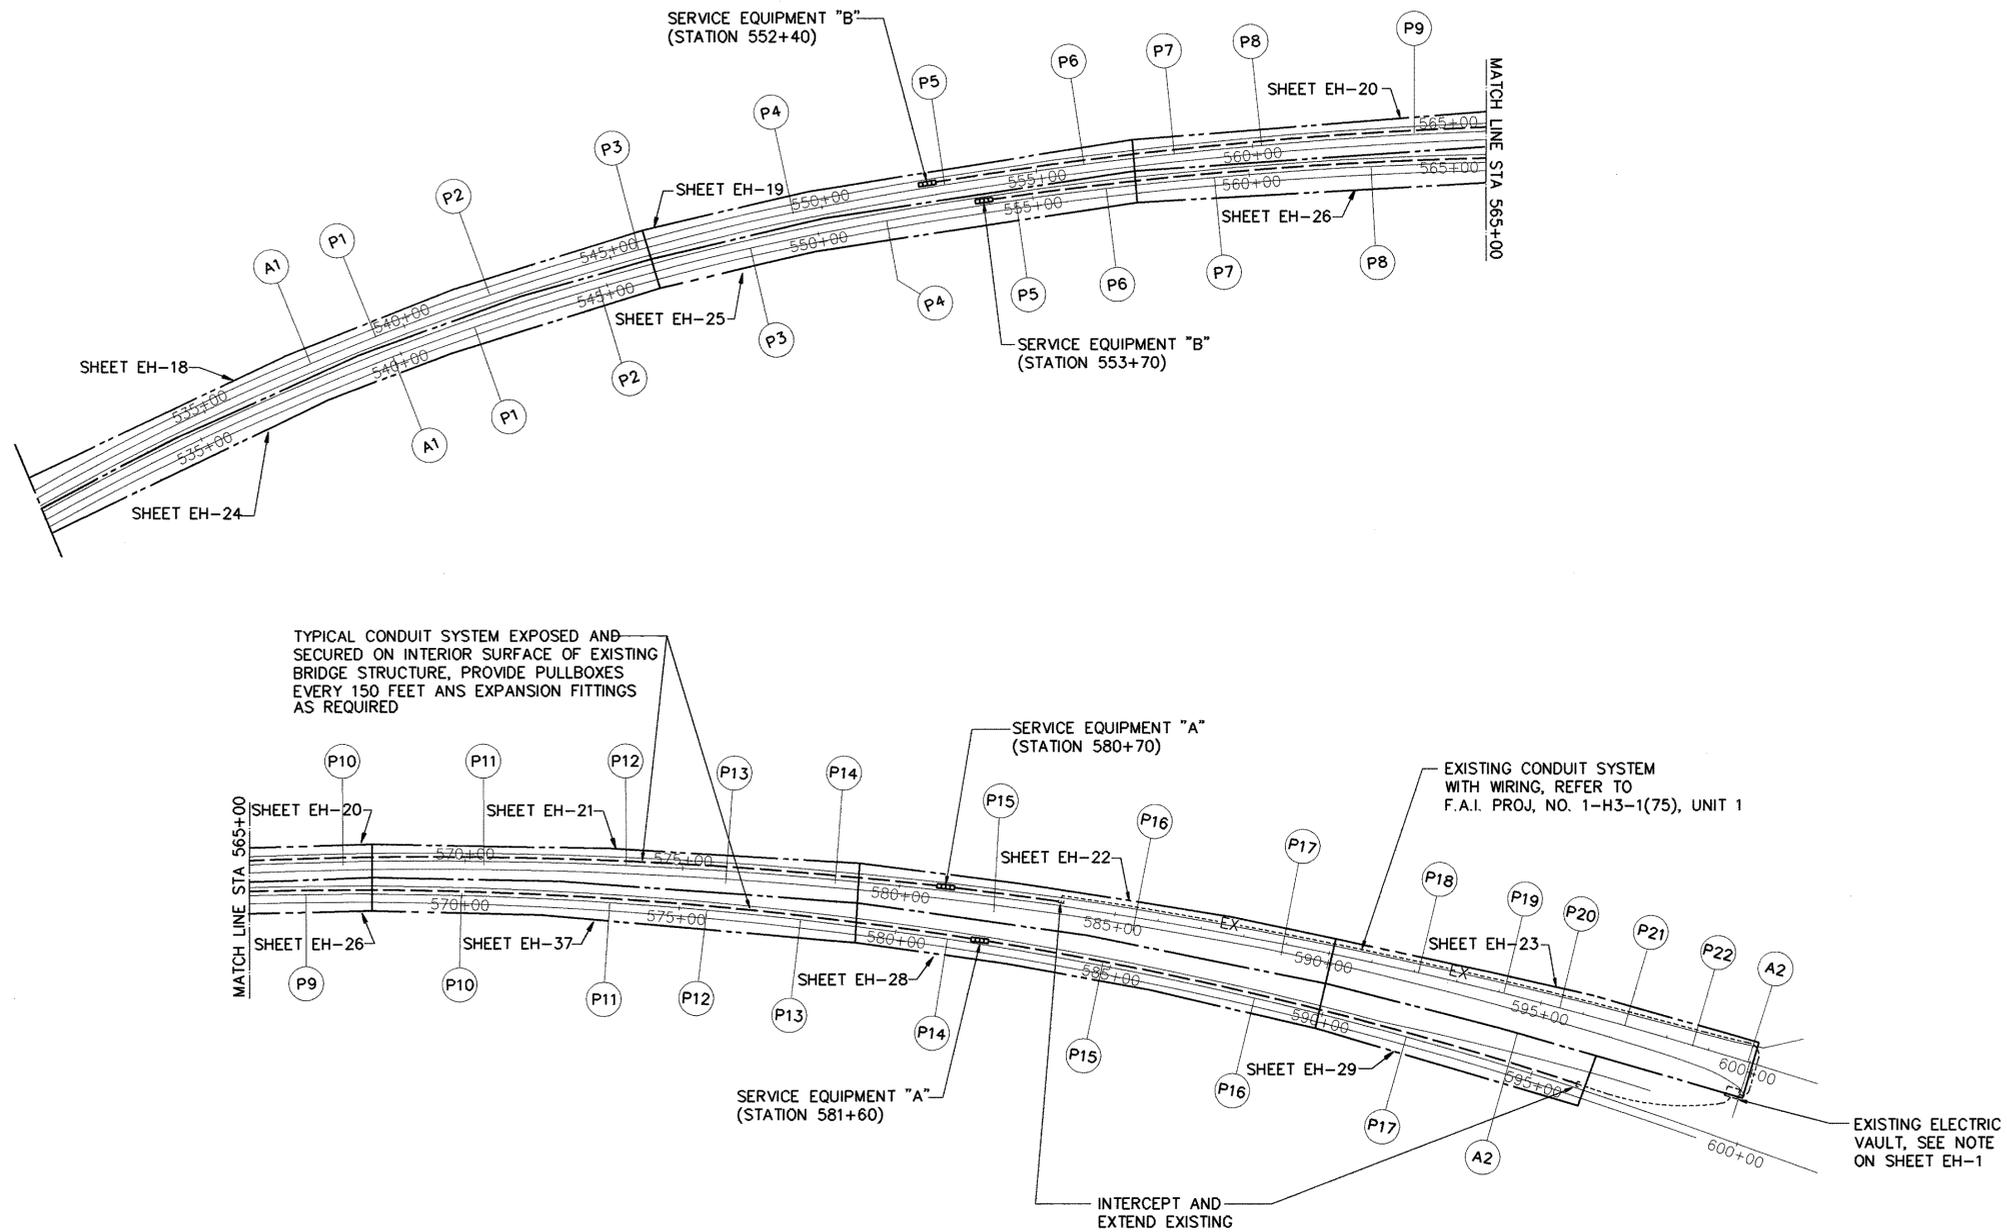

TYPICAL CONDUIT SYSTEM EXPOSED AND SECURED ON INTERIOR SURFACE OF EXISTING BRIDGE STRUCTURE, PROVIDE PULLBOXES EVERY 150 FEET AND EXPANSION FITTINGS AS REQUIRED

ELECTRICAL SYMBOLS AND LEGEND		
EXISTING	NEW	DESCRIPTION
		FLUORESCENT LIGHT FIXTURE
		ELECTRIC LINES, EXPOSED ON STRUCTURE INTERIOR
		CONDUIT STUB
		ELECTRIC SERVICE EQUIPMENT
		DUPLEX RECEPTACLE, NEMA 5-15R, MTG. HT. 3'-0"
		WEATHERPROOF
		CAST IRON JUNCTION BOX, WEATHER PROOF
		PULLBOX, STAINLESS STEEL 18" x 12" x 6" DEEP
		PIER NUMBER AND LOCATION INDICATOR
		ABUTMENT NUMBER AND LOCATION INDICATOR
		CONTROL STATION

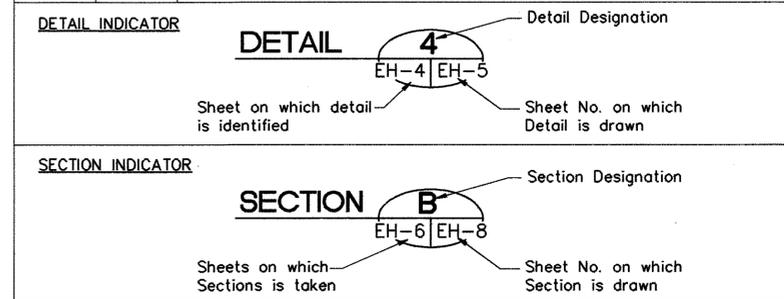

"AS-BUILT" NOTE

CHANGE THE CONTRACT SPECIFIED GALVANIZED RIGID STEEL CONDUITS AND STAINLESS STEEL BOXES TO PVC SCHED. 80 CONDUITS AND BOXES INSIDE THE SEGMENTAL BRIDGES OF THE WINDWARD VIADUCT AND THE NORTH HALAWA VALLEY VIADUCT.

GENERAL ELECTRICAL PLAN - INTERIOR
SCALE: 1" = 200'

N

GRAPHIC SCALE
0 100' 200' 400' 600'

1" = 200'


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SIGNATURE


DATE	
DESIGNED BY	
DRAWN BY	
CHECKED BY	
QUANTITIES BY	
NOTED BY	
ORIGINAL PLAN	

DATE	REVISION
STATE OF HAWAII DEPARTMENT OF TRANSPORTATION HIGHWAYS DIVISION GENERAL ELECTRICAL PLAN - INTERIOR NORTH HALAWA VALLEY VIADUCT INTERSTATE ROUTE H-3 F.A.I. PROJECT NO. 1-H3-1 (75) UNIT 1 SCALE: 1" = 20' DATE: JAN. 1996 SHEET NO. EH-17 OF 32 SHEETS	

FED. ROAD DIST. NO.	STATE	FED. AID PROJ. NO.	FISCAL YEAR	SHEET NO.	TOTAL SHEETS
HAWAII	HAW.	I-H3-1(75), UNIT 1	1996	309	405

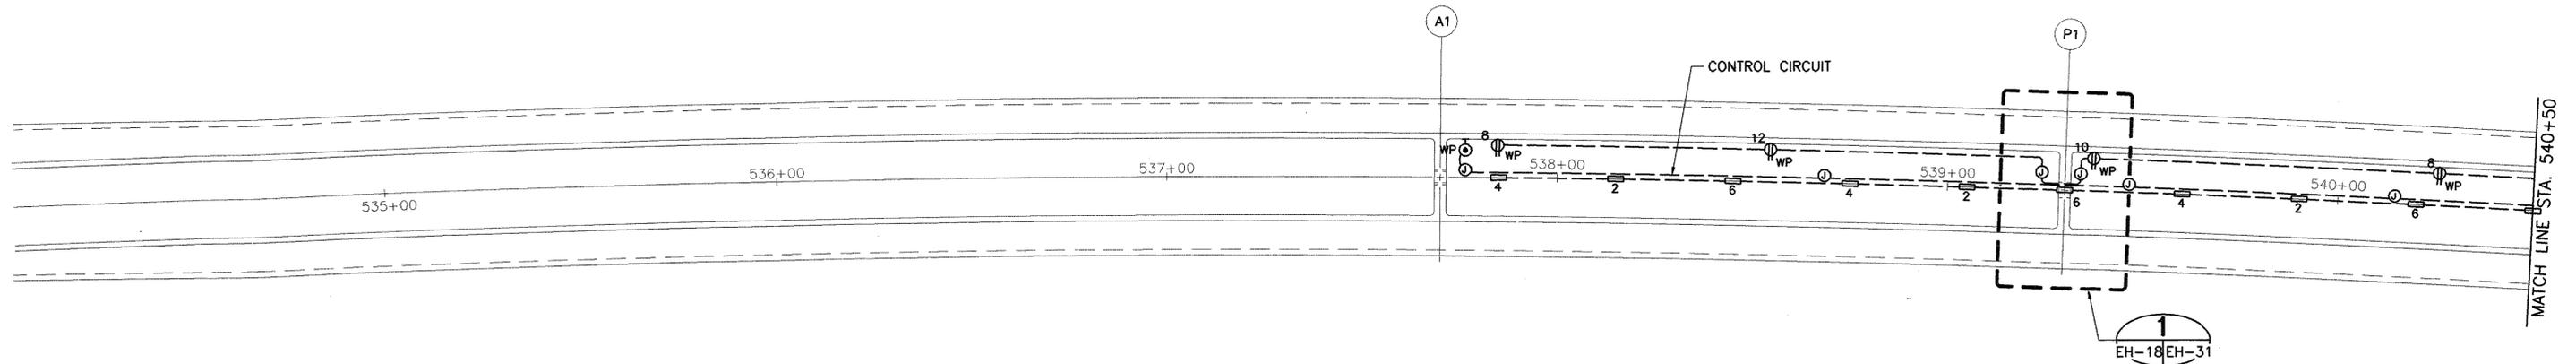


PARTIAL ELECTRICAL PLAN - INBOUND
SCALE: 1" = 20'

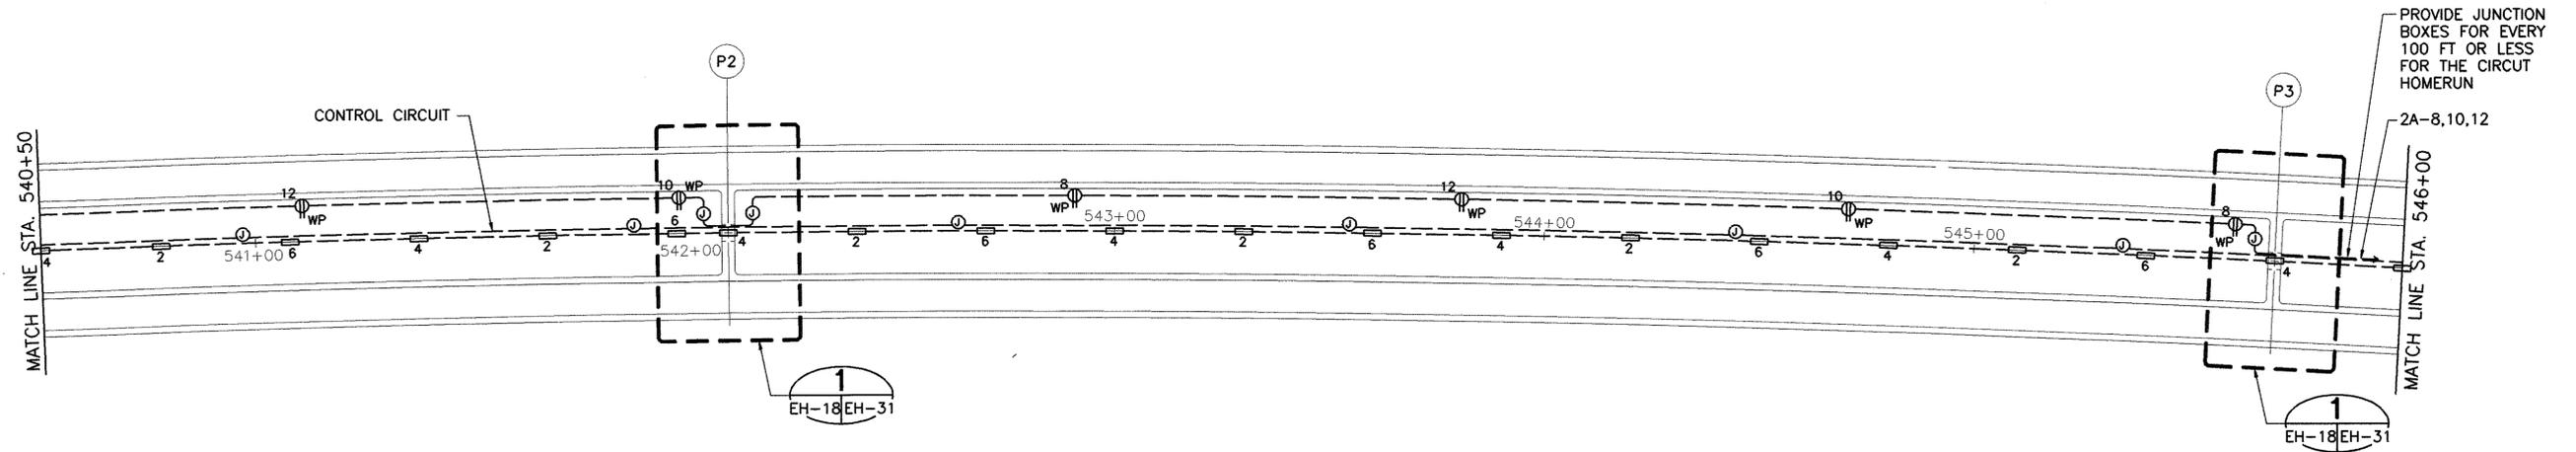

PARTIAL ELECTRICAL PLAN - INBOUND
SCALE: 1" = 20'

DATE	_____
SURVEY PLOTTED BY	_____
DRAWN BY	_____
DESIGNED BY	_____
QUANTITIES BY	_____
CHECKED BY	_____
ORIGINAL PLAN	_____
NOTEBOOK	_____
No.	_____

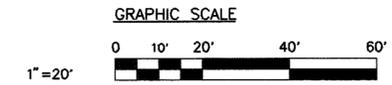

CLARENCE C. K. KAM
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No. 1765-E
HAWAII, U.S.A.

This work was prepared by me or under my supervision.

C. K. Kam
SIGNATURE


STATE OF HAWAII
DEPARTMENT OF TRANSPORTATION
HIGHWAYS DIVISION

PARTIAL ELECTRICAL PLAN - INBOUND INTERIOR
STA. 534+22.93 TO 546+00
INTERSTATE ROUTE H-3
F.A.I. PROJECT NO. I-H3-1 (75) UNIT 1


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SHEET NO. EH-18 OF 32 SHEETS

DATE	REVISION


FED. ROAD DIST. NO.	STATE	FED. AID PROJ. NO.	FISCAL YEAR	SHEET NO.	TOTAL SHEETS
HAWAII	HAW.	I-H3-1(75), UNIT I	1996	310	405

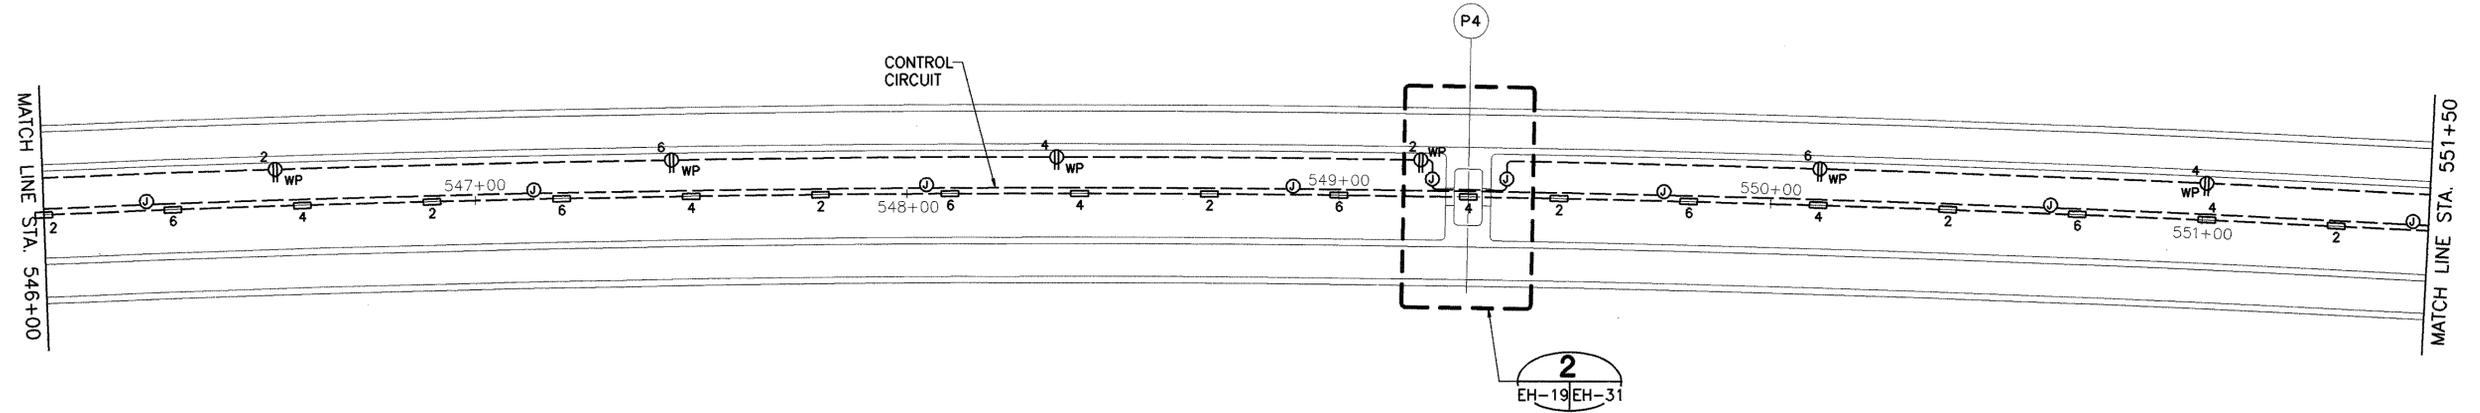

PARTIAL ELECTRICAL PLAN - INBOUND
SCALE: 1" = 20'

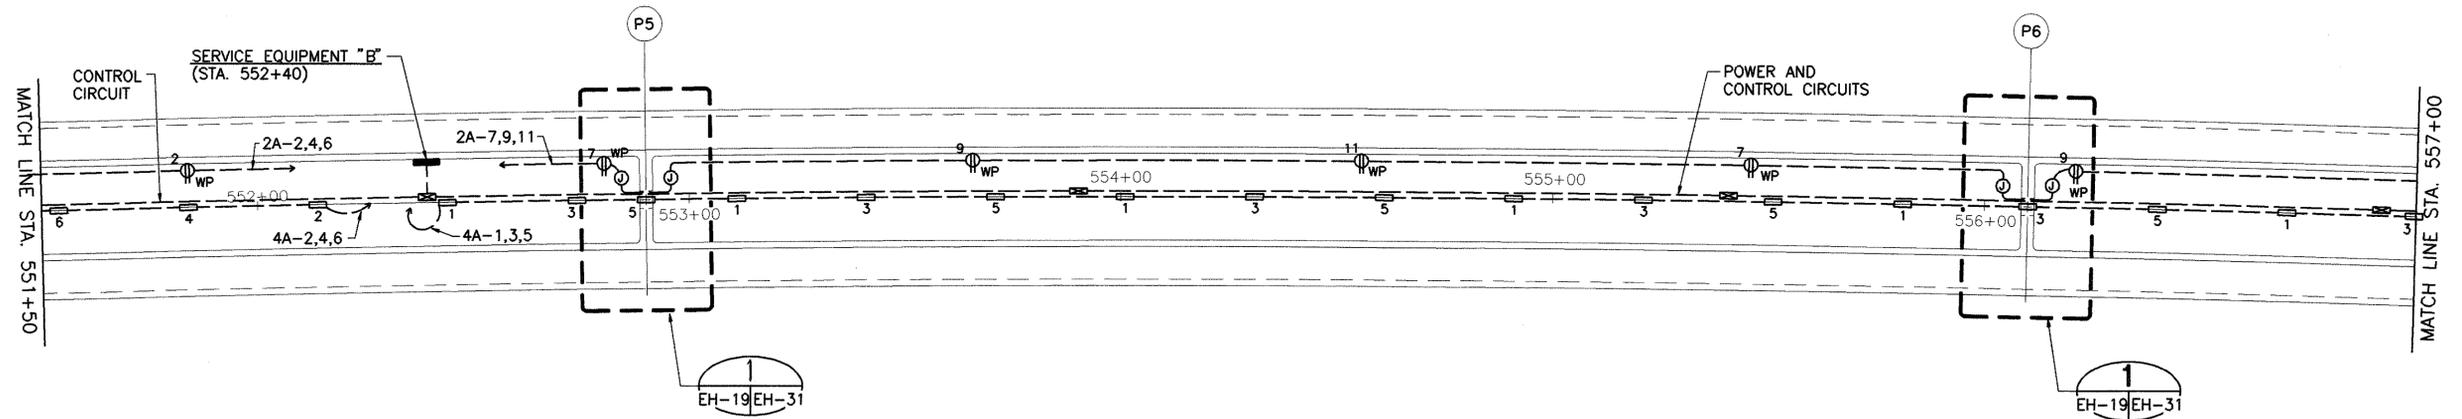

PARTIAL ELECTRICAL PLAN - INBOUND
SCALE: 1" = 20'

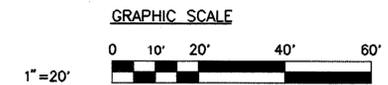

CLARENCE C. K. IMA
LICENSED PROFESSIONAL ENGINEER
No. 1765-E
HAWAII, U.S.A.

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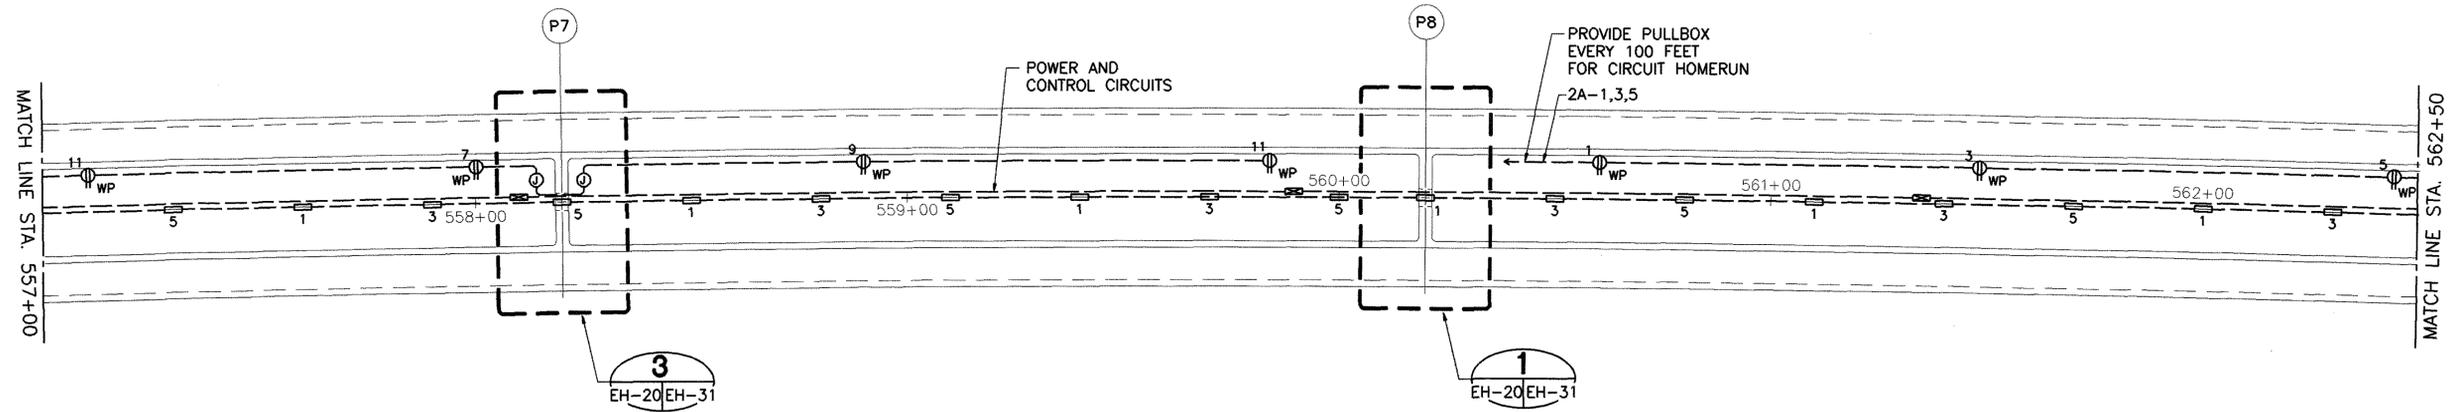
C. Ima
SIGNATURE

SURVEY PLOTTED BY	DATE
DRAWN BY	
TRACED BY	
DESIGNED BY	
QUANTITIES BY	
CHECKED BY	
ORIGINAL PLAN	
NOTEBOOK	
No.	


STATE OF HAWAII DEPARTMENT OF TRANSPORTATION HIGHWAYS DIVISION
PARTIAL ELECTRICAL PLAN— INBOUND INTERIOR
STA. 546+00 TO 557+00
INTERSTATE ROUTE H-3
F.A.I. PROJECT NO. I-H3-1 (75) UNIT 1
SCALE: 1" = 20' DATE: JAN. 1996
SHEET NO. EH-19 OF 32 SHEETS

DATE	REVISION


FED. ROAD DIST. NO.	STATE	FED. AID PROJ. NO.	FISCAL YEAR	SHEET NO.	TOTAL SHEETS
HAWAII	HAW.	I-H3-1(75), UNIT 1	1996	311	405



PARTIAL ELECTRICAL PLAN - INBOUND
SCALE: 1" = 20'

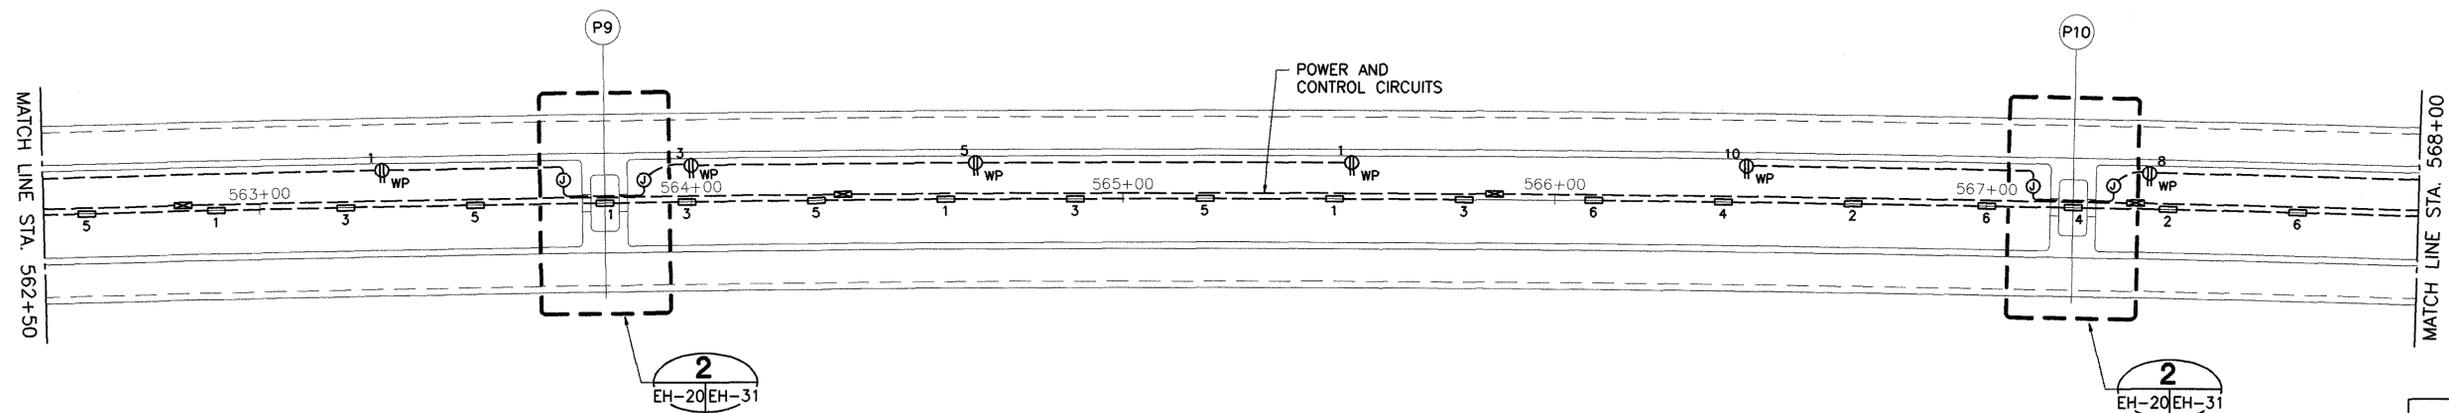

PARTIAL ELECTRICAL PLAN - INBOUND
SCALE: 1" = 20'

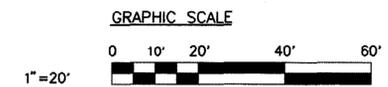

CLARENCE C. K. KAI
LICENSED PROFESSIONAL ENGINEER
No. 1785-E
HAWAII, U.S.A.

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C. Kai
SIGNATURE


SURVEY PLOTTED BY	DAVE
DRAWN BY	
DESIGNED BY	
QUANTITIES BY	
CHECKED BY	
ORIGINAL PLAN	
NOTEBOOK	
No.	

DATE	REVISION
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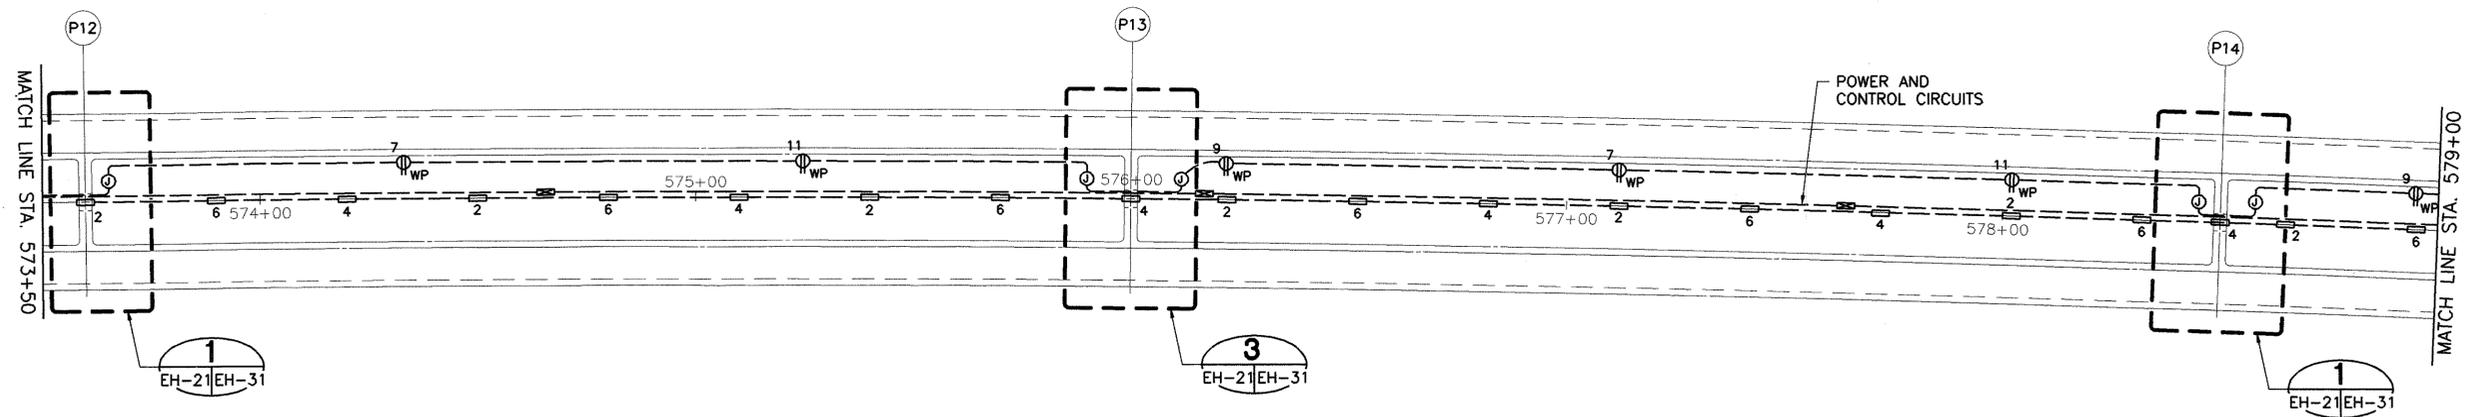
STATE OF HAWAII
DEPARTMENT OF TRANSPORTATION
HIGHWAYS DIVISION
PARTIAL ELECTRICAL PLAN - INBOUND INTERIOR
STA. 557+00 TO 568+00
INTERSTATE ROUTE H-3
F.A.I. PROJECT NO. I-H3-1 (75) UNIT 1

SCALE: 1" = 20' DATE: JAN. 1996
SHEET NO. EH-20 OF 32 SHEETS



FED. ROAD DIST. NO.	STATE	FED. AID PROJ. NO.	FISCAL YEAR	SHEET NO.	TOTAL SHEETS
HAWAII	HAW.	I-H3-1(75), UNIT 1	1996	312	405

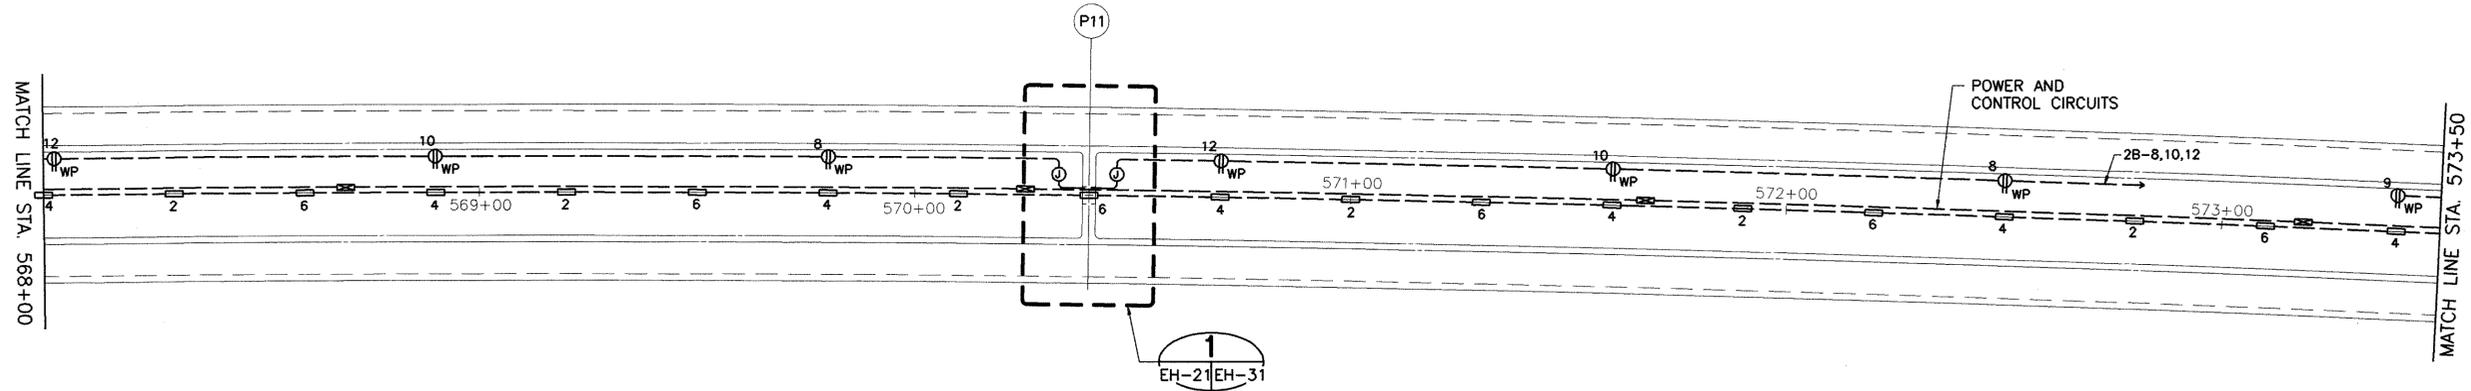

PARTIAL ELECTRICAL PLAN - INBOUND
SCALE: 1" = 20'



PARTIAL ELECTRICAL PLAN - INBOUND
SCALE: 1" = 20'

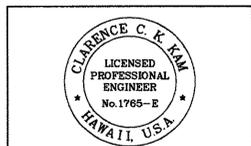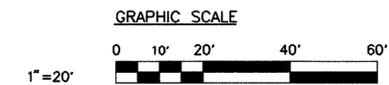

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C. Kam
SIGNATURE


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DESIGNED BY	_____
DRAWN BY	_____
CHECKED BY	_____
QUANTITIES BY	_____
REVISIONS	_____
ORIGINAL PLAN	_____
NOTEBOOK	_____
No.	_____

STATE OF HAWAII
DEPARTMENT OF TRANSPORTATION
HIGHWAYS DIVISION
PARTIAL ELECTRICAL PLAN - INBOUND INTERIOR
STA. 568+00 TO 579+00
INTERSTATE ROUTE H-3
F.A.I. PROJECT NO. I-H3-1 (75) UNIT 1

SCALE: 1" = 20' DATE: JAN. 1996
SHEET NO. EH-21 OF 32 SHEETS


DATE REVISION

FED. ROAD DIST. NO.	STATE	FED. AID PROJ. NO.	FISCAL YEAR	SHEET NO.	TOTAL SHEETS
HAWAII	HAW.	I-H3-1(75), UNIT 1	1996	313	405

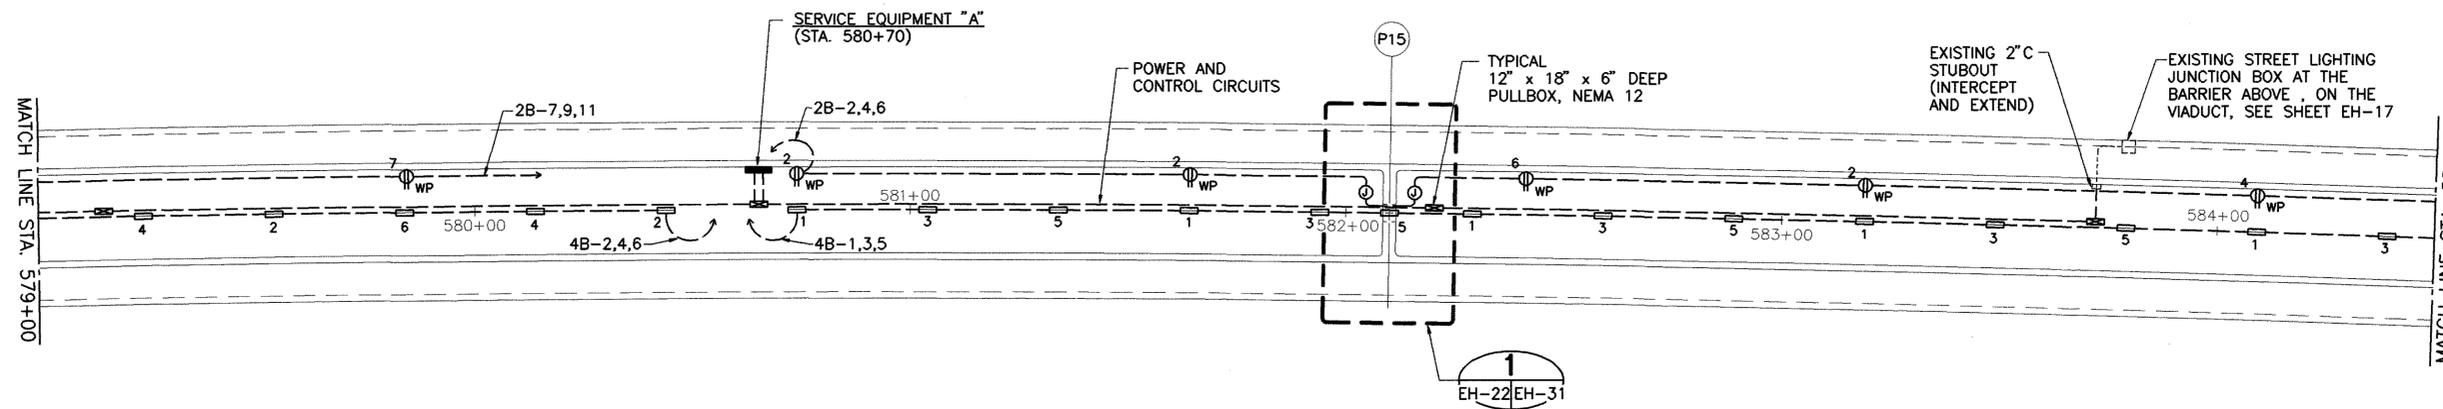



PARTIAL ELECTRICAL PLAN - INBOUND

SCALE: 1" = 20'

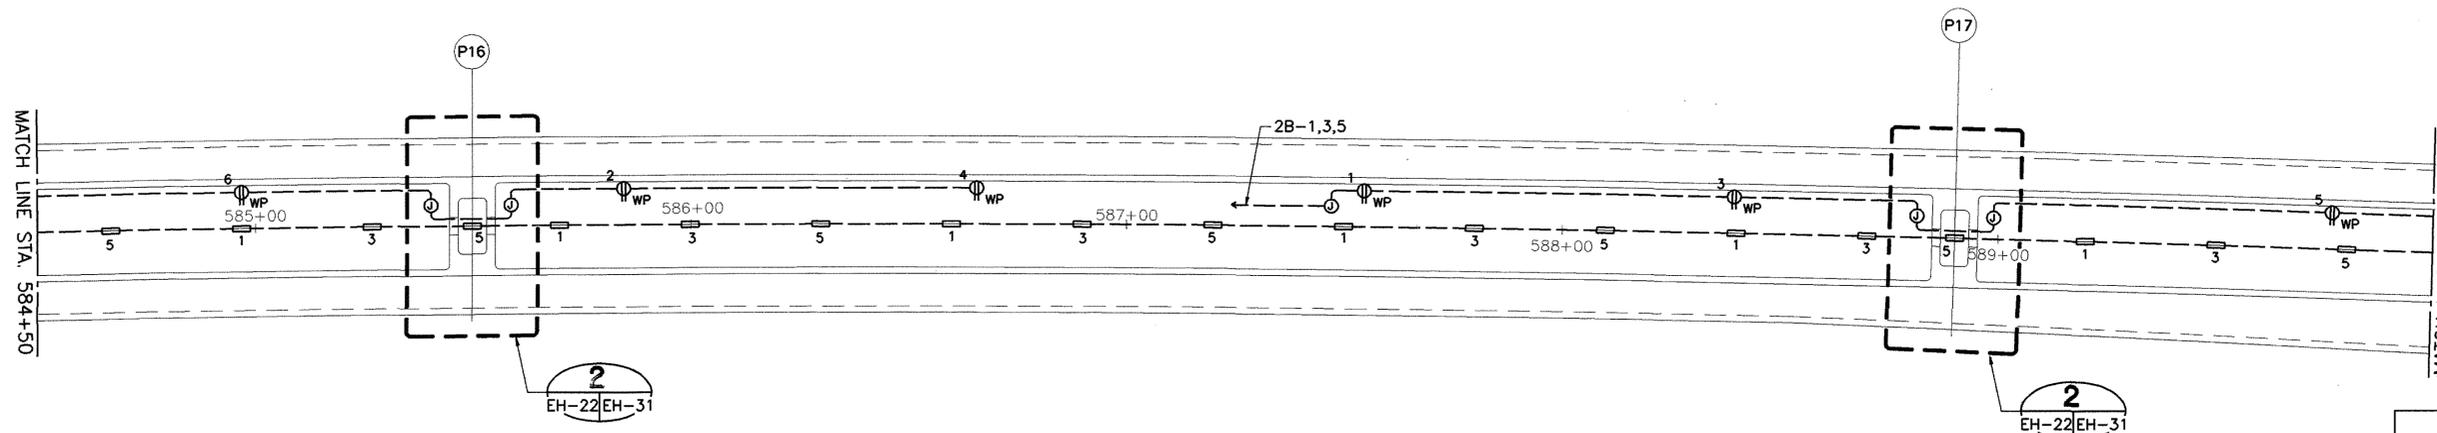

PARTIAL ELECTRICAL PLAN - INBOUND

SCALE: 1" = 20'

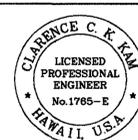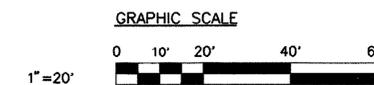


This work was prepared by me or under my supervision.

C. Kim
SIGNATURE

DATE	_____
SURVEY PLOTTED BY	_____
DRAWN BY	_____
TRACED BY	_____
DESIGNED BY	_____
QUANTITIES BY	_____
CHECKED BY	_____
ORIGINAL PLAN	_____
NOTEBOOK	_____
No.	_____



DATE	REVISION	STATE OF HAWAII DEPARTMENT OF TRANSPORTATION HIGHWAYS DIVISION PARTIAL ELECTRICAL PLAN - INBOUND INTERIOR STA. 579+00 TO 590+00 INTERSTATE ROUTE H-3 F.A.I. PROJECT NO. I-H3-1 (75) UNIT 1 SCALE: 1" = 20' DATE: JAN. 1996 SHEET NO. EH-22 OF 32 SHEETS
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FED. ROAD DIST. NO.	STATE	FED. AID PROJ. NO.	FISCAL YEAR	SHEET NO.	TOTAL SHEETS
HAWAII	HAW.	1-H3-1(75), UNIT 1	1996	314	405

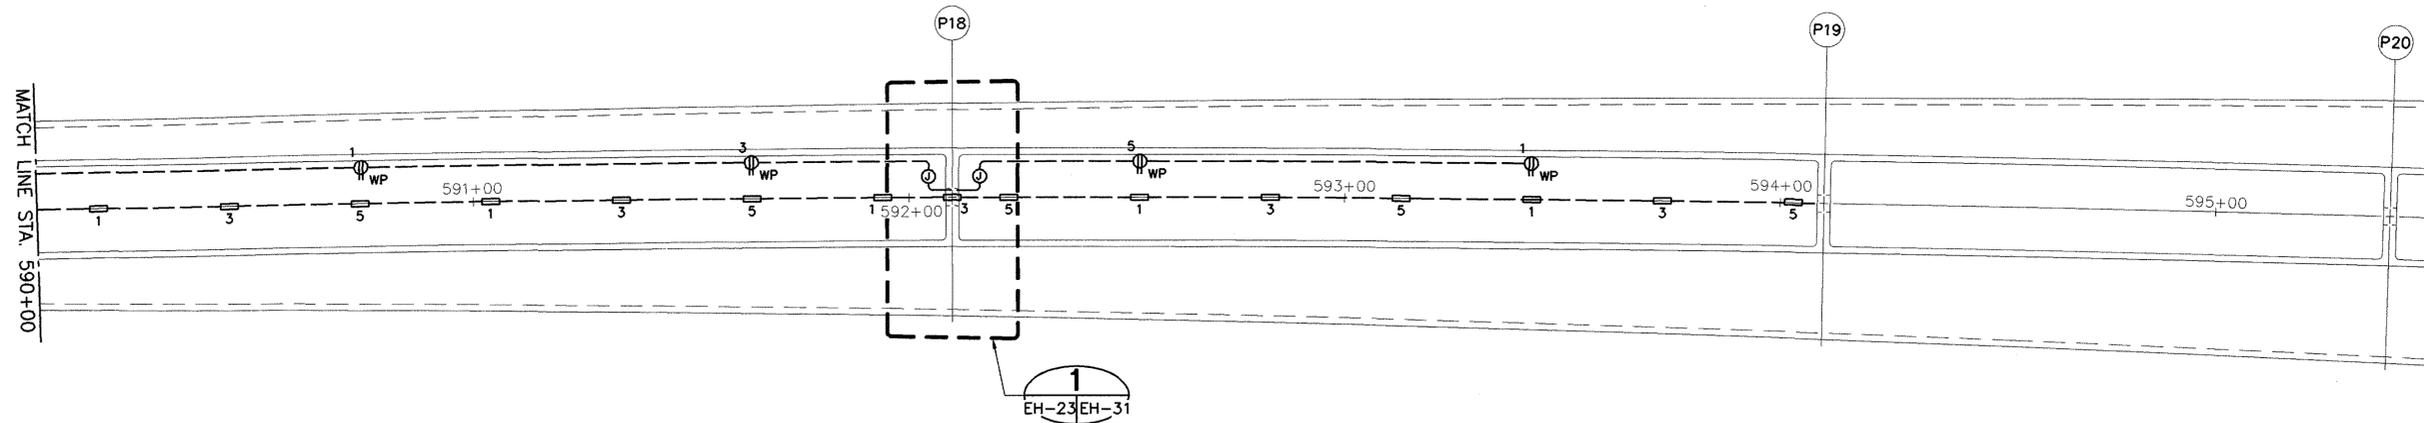

PARTIAL ELECTRICAL PLAN - INBOUND
SCALE: 1" = 20'

DATE	_____
DESIGNED BY	_____
CHECKED BY	_____
DATE	_____
DESIGNED BY	_____
CHECKED BY	_____
DATE	_____
DESIGNED BY	_____
CHECKED BY	_____

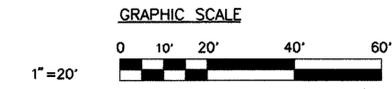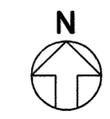

CLARENCE C. K. KIM
LICENSED PROFESSIONAL ENGINEER
No. 1765-E
HAWAII, U.S.A.

This work was prepared by me or under my supervision.

SIGNATURE


STATE OF HAWAII
DEPARTMENT OF TRANSPORTATION
HIGHWAYS DIVISION

PARTIAL ELECTRICAL PLAN - INBOUND INTERIOR
STA. 590+00 TO 599+00
INTERSTATE ROUTE H-3
F.A.I. PROJECT NO. 1-H3-1 (75) UNIT 1

SCALE: 1" = 20' DATE: JAN. 1996
SHEET NO. EH-23 OF 32 SHEETS


DATE	REVISION

FED. ROAD DIST. NO.	STATE	FED. AID PROJ. NO.	FISCAL YEAR	SHEET NO.	TOTAL SHEETS
HAWAII	HAW.	I-H3-1(75), UNIT 1	1996	315	405

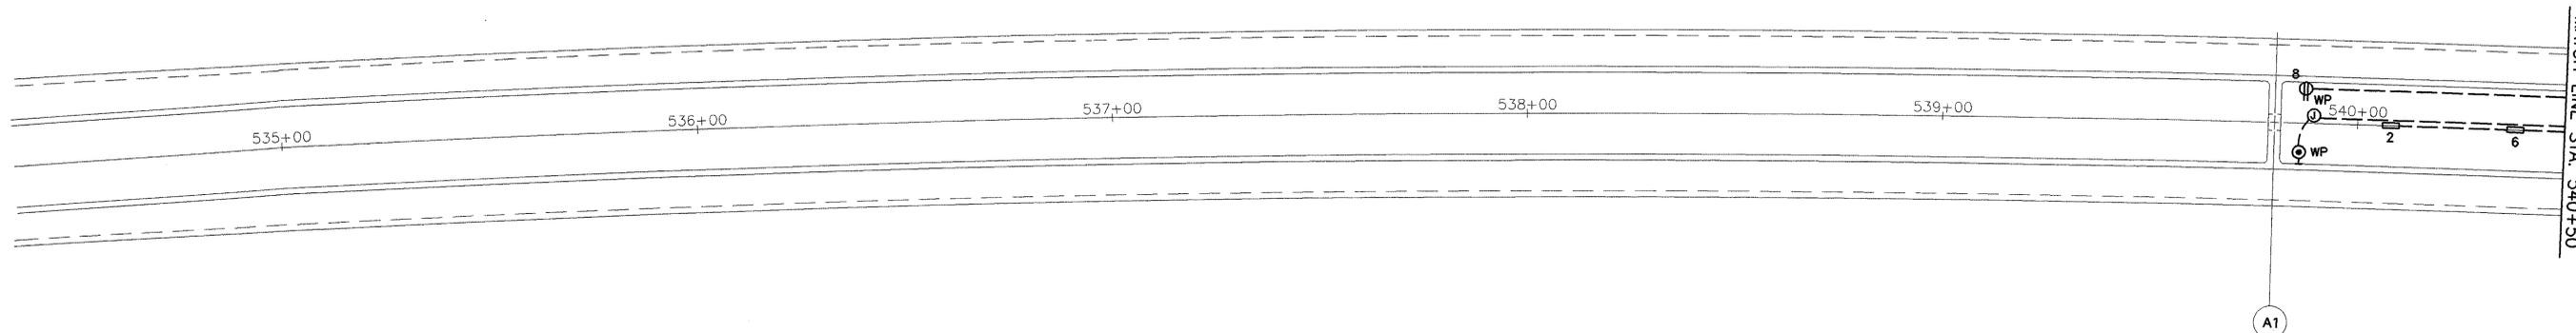

PARTIAL ELECTRICAL PLAN - OUTBOUND

SCALE: 1" = 20'


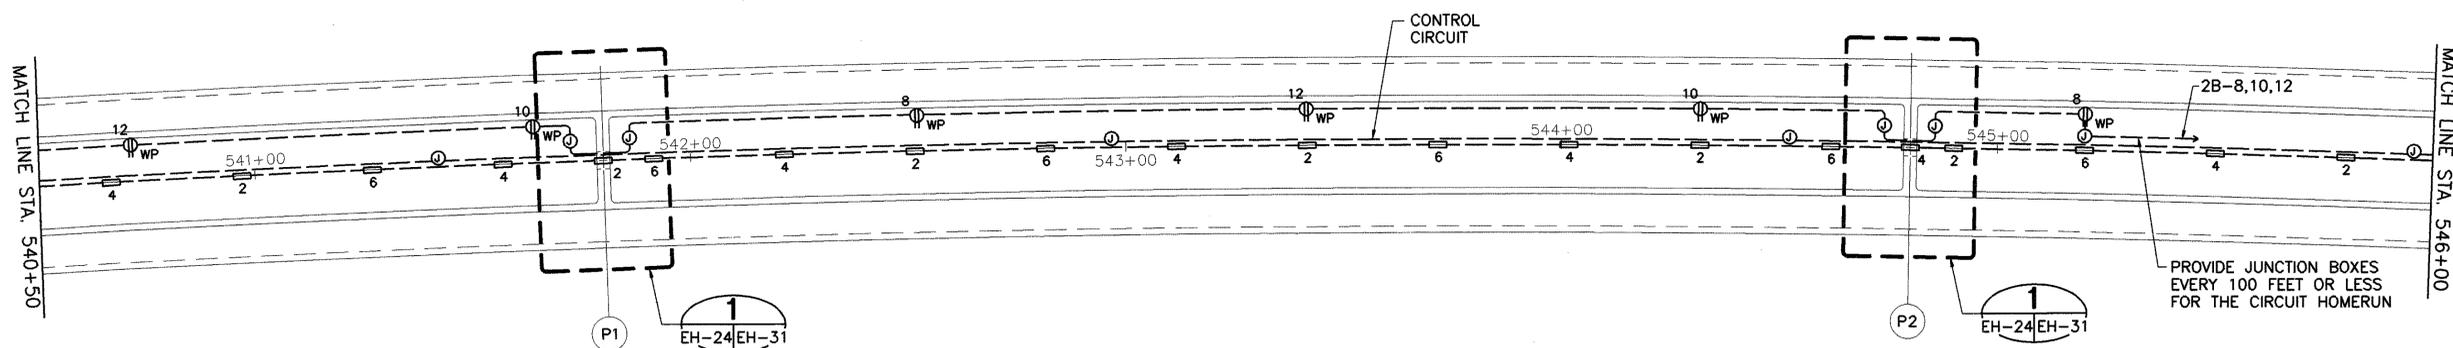


PARTIAL ELECTRICAL PLAN - OUTBOUND

SCALE: 1" = 20'

DATE	_____
SURVEY PLOTTED BY	_____
DRAWN BY	_____
TRACED BY	_____
DESIGNED BY	_____
QUANTITIES BY	_____
CHECKED BY	_____
ORIGINAL PLAN	_____
NOTEBOOK	_____
No.	_____

GRAPHIC SCALE

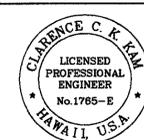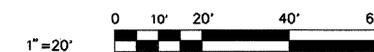

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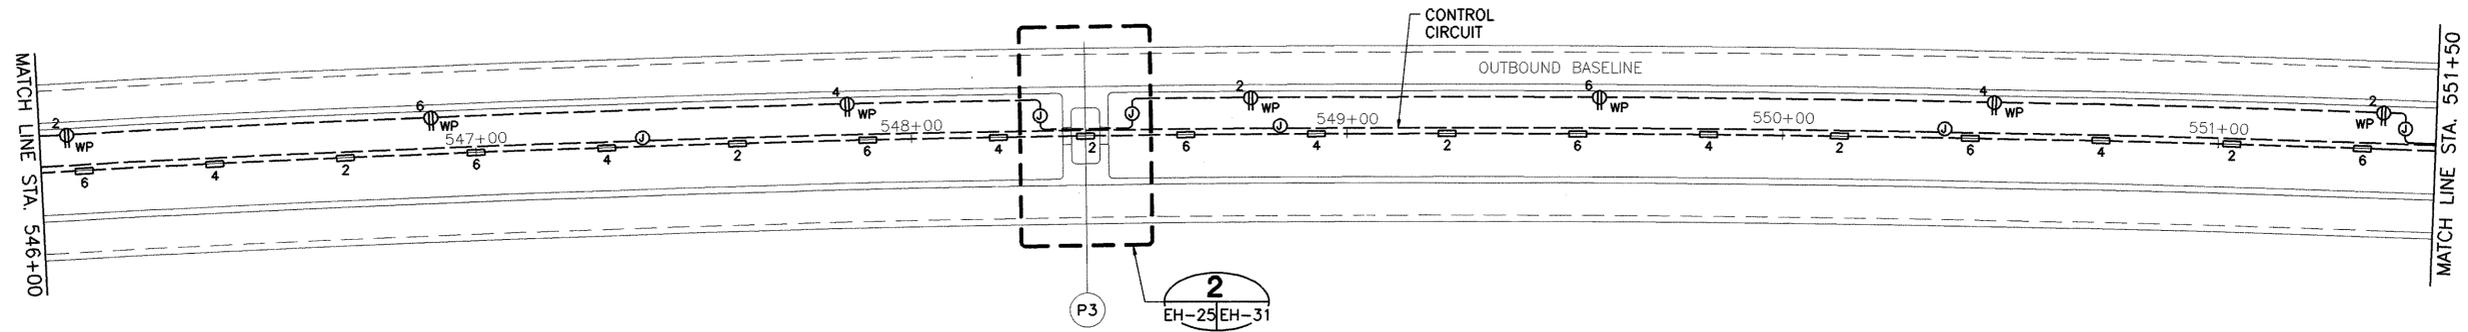
Clarence C. K. Kam
SIGNATURE

STATE OF HAWAII
DEPARTMENT OF TRANSPORTATION
HIGHWAYS DIVISION
**PARTIAL ELECTRICAL PLAN -
OUTBOUND INTERIOR**
STA. 534+58.24 TO 546+00
INTERSTATE ROUTE H-3
F.A.I. PROJECT NO. I-H3-1 (75) UNIT 1


SCALE: 1" = 20' DATE: JAN. 1996
SHEET NO. EH-24 OF 32 SHEETS

DATE REVISION

FED. ROAD DIST. NO.	STATE	FED. AID PROJ. NO.	FISCAL YEAR	SHEET NO.	TOTAL SHEETS
HAWAII	HAW.	1-H3-1(75), UNIT 1	1996	316	405




PARTIAL ELECTRICAL PLAN - OUTBOUND
SCALE: 1" = 20'

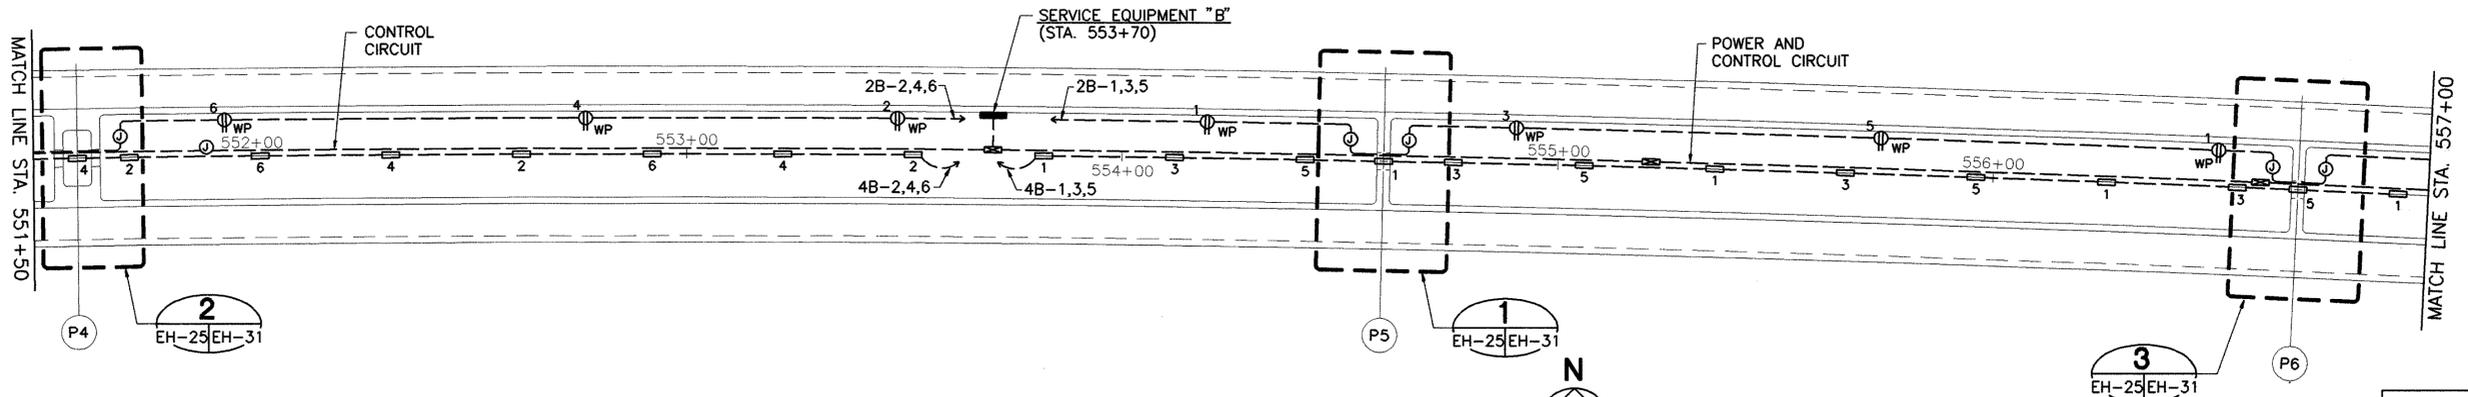

PARTIAL ELECTRICAL PLAN - OUTBOUND
SCALE: 1" = 20'

DESIGNED BY	DATE
DRAWN BY	
CHECKED BY	
NOTED BY	
QUANTITIES BY	
REVISIONS	

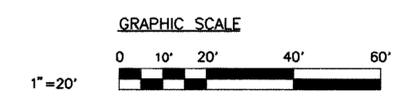


CLARENCE C. K. KIM
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No. 1785-E
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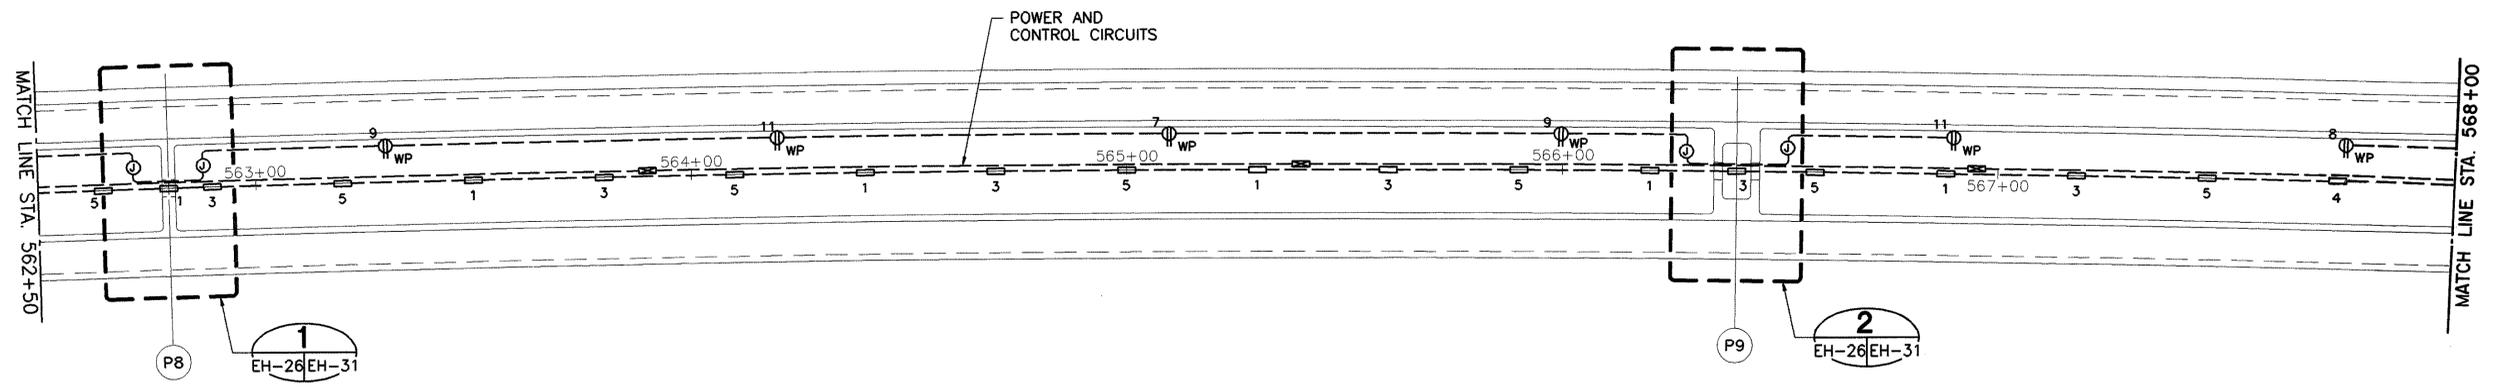
STATE OF HAWAII
DEPARTMENT OF TRANSPORTATION
HIGHWAYS DIVISION
**PARTIAL ELECTRICAL PLAN -
OUTBOUND INTERIOR**
STA. 546+00 TO 557+00
INTERSTATE ROUTE H-3
F.A.I. PROJECT NO. 1-H3-1 (75) UNIT 1
SCALE: 1" = 20' DATE: JAN. 1996
SHEET NO. EH-25 OF 32 SHEETS

DATE	REVISION


FED. ROAD DIST. NO.	STATE	FED. AID PROJ. NO.	FISCAL YEAR	SHEET NO.	TOTAL SHEETS
HAWAII	HAW.	I-H3-1(75), UNIT 1	1996	317	405

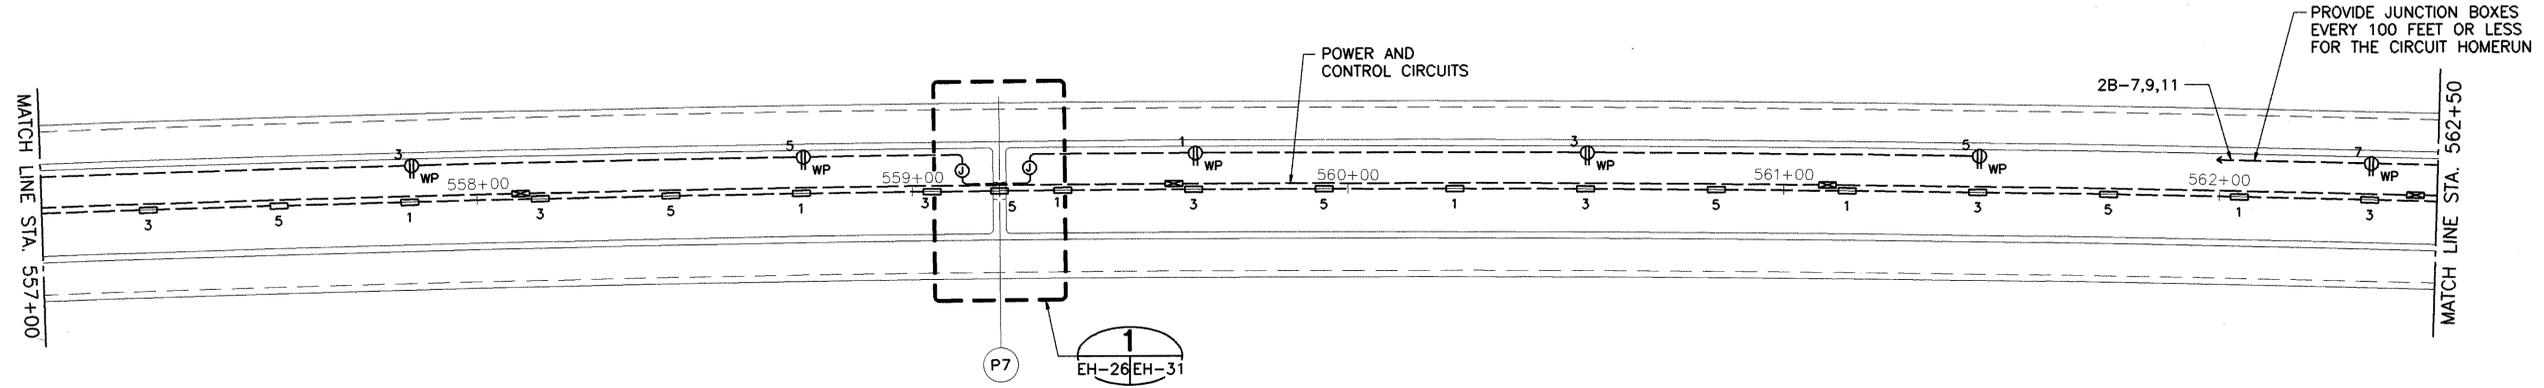

PARTIAL DECK ELEVATION PLAN - OUTBOUND
SCALE: 1" = 20'



PARTIAL DECK ELEVATION PLAN - OUTBOUND
SCALE: 1" = 20'

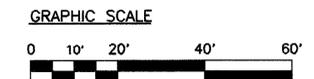



 LICENSED PROFESSIONAL ENGINEER
 No. 1785-E
 HAWAII, U.S.A.
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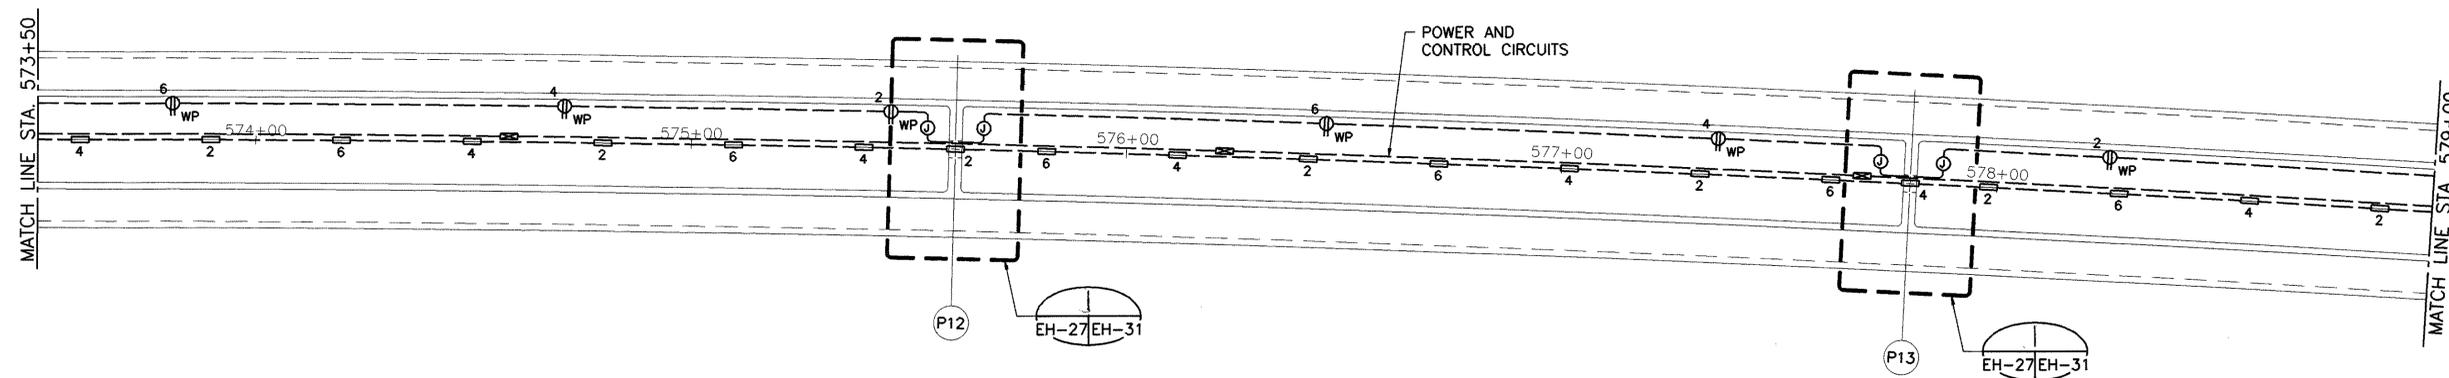
DESIGNED BY	DATE
DRAWN BY	
CHECKED BY	
NOTED BY	
NO.	

DATE	REVISION
STATE OF HAWAII DEPARTMENT OF TRANSPORTATION HIGHWAYS DIVISION PARTIAL ELECTRICAL PLAN - OUTBOUND INTERIOR STA. 557+00 TO 568+00 INTERSTATE ROUTE H-3 F.A.I. PROJECT NO. I-H3-1 (75) UNIT 1 SCALE: 1" = 20' DATE: JAN. 1996 SHEET NO. EH-26 OF 32 SHEETS	


FED. ROAD DIST. NO.	STATE	FED. AID PROJ. NO.	FISCAL YEAR	SHEET NO.	TOTAL SHEETS
HAWAII	HAW.	I-H3-1(75), UNIT 1	1996	318	405



PARTIAL ELECTRICAL PLAN - OUTBOUND
SCALE: 1" = 20'

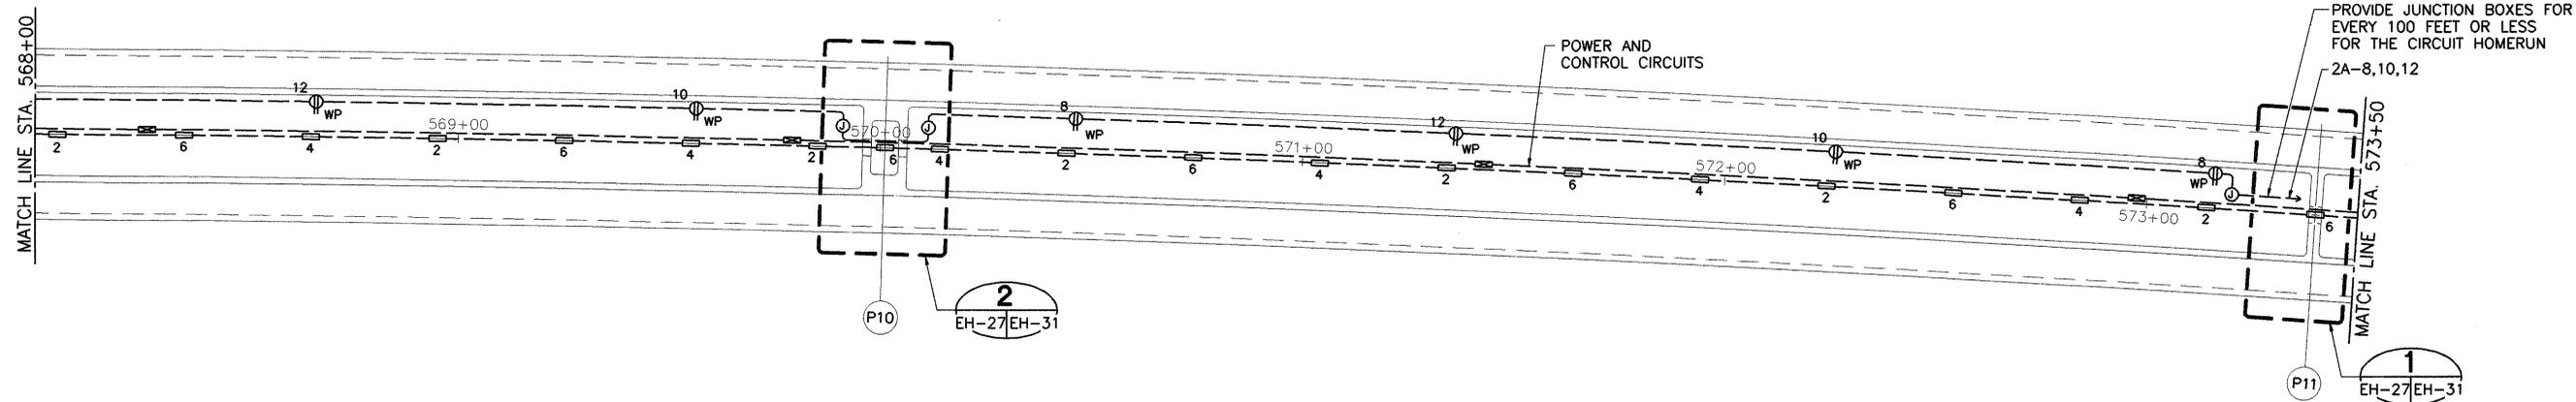

PARTIAL ELECTRICAL PLAN - OUTBOUND
SCALE: 1" = 20'

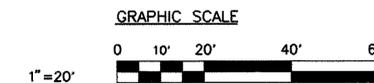


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Clarence C. K. Kik
SIGNATURE


DESIGNED BY	DATE
DRAWN BY	
CHECKED BY	
QUANTITIES BY	
CHECKED BY	
NOTED BY	
No.	

DATE	REVISION	STATE OF HAWAII DEPARTMENT OF TRANSPORTATION HIGHWAYS DIVISION PARTIAL ELECTRICAL PLAN- OUTBOUND INTERIOR STA. 568+00 TO 579+00 INTERSTATE ROUTE H-3 F.A.I. PROJECT NO. I-H3-1 (75) UNIT 1 SCALE: 1" = 20' DATE: JAN. 1996 SHEET NO. EH-27 OF 32 SHEETS
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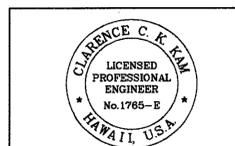
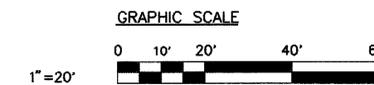
FED. ROAD DIST. NO.	STATE	FED. AID PROJ. NO.	FISCAL YEAR	SHEET NO.	TOTAL SHEETS
HAWAII	HAW.	I-H3-1(75), UNIT 1	1996	319	405



PARTIAL ELECTRICAL PLAN - OUTBOUND
SCALE: 1" = 20'

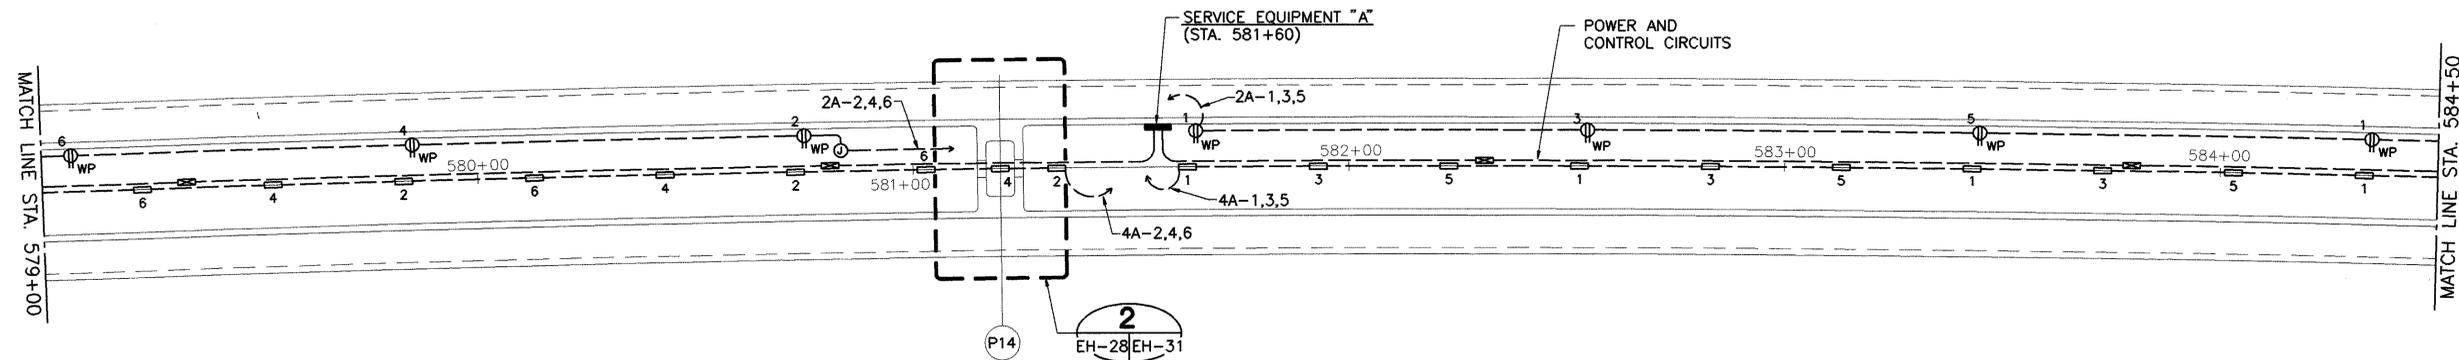

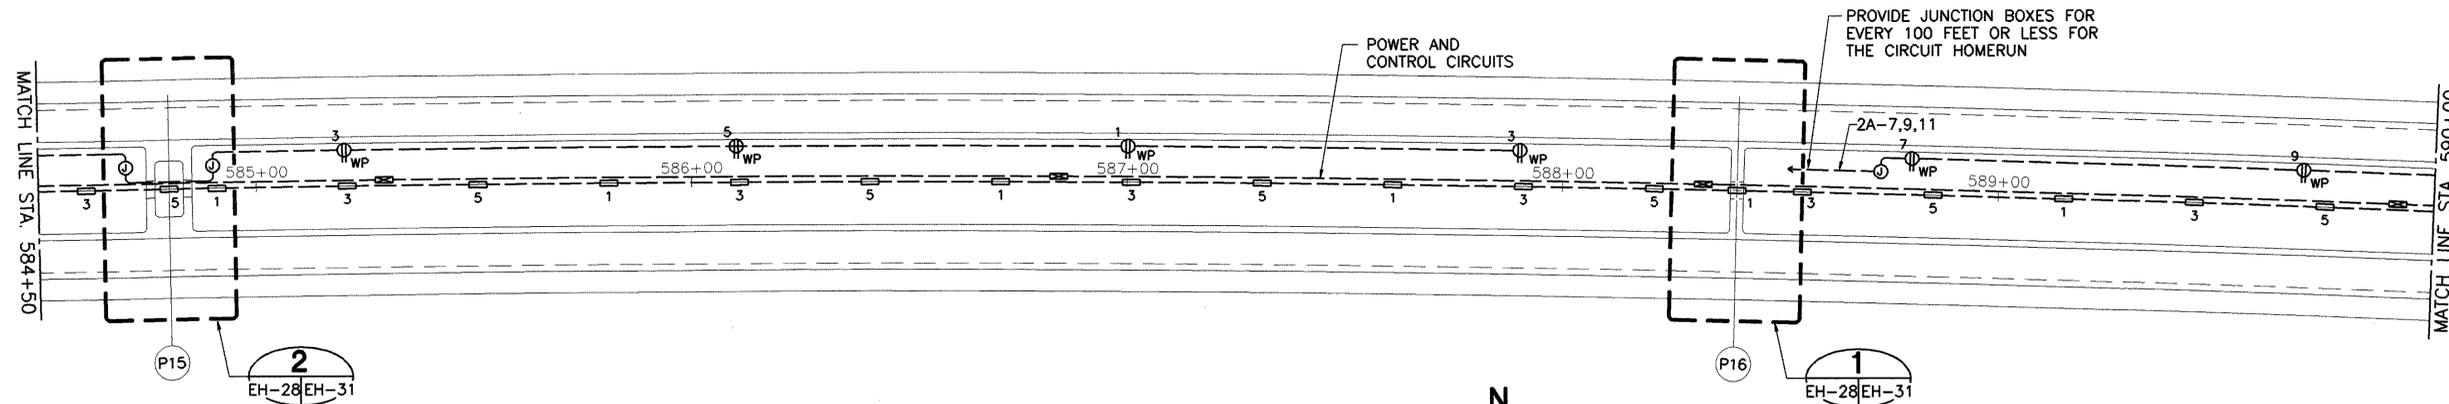PARTIAL ELECTRICAL PLAN - OUTBOUND
SCALE: 1" = 20'



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Clarence C. K. Kim
SIGNATURE


STATE OF HAWAII
DEPARTMENT OF TRANSPORTATION
HIGHWAYS DIVISION
**PARTIAL ELECTRICAL PLAN-
OUTBOUND INTERIOR**
STA. 579+00 TO 590+00
INTERSTATE ROUTE H-3
F.A.I. PROJECT NO. I-H3-1 (75) UNIT 1

SCALE: 1" = 20' DATE: JAN. 1996
SHEET NO. EH-28 OF 32 SHEETS

DATE	_____
DESIGNED BY	_____
TRACED BY	_____
QUANTITIES BY	_____
CHECKED BY	_____
ORIGINAL PLAN	_____
NOTEBOOK	_____
No.	_____

DATE	REVISION

FED. ROAD DIST. NO.	STATE	FED. AID PROJ. NO.	FISCAL YEAR	SHEET NO.	TOTAL SHEETS
HAWAII	HAW.	1-H3-1(75), UNIT 1	1996	320	405


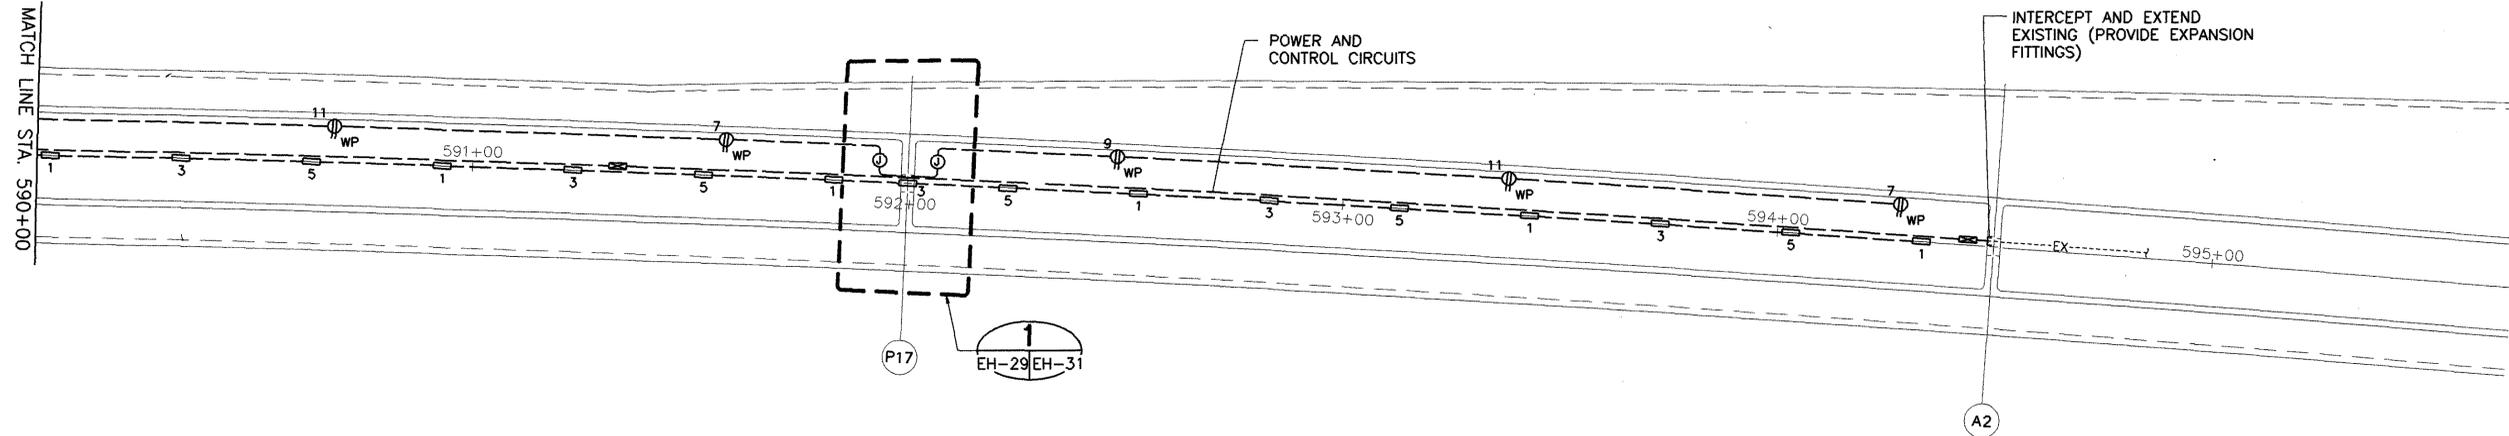


PARTIAL DECK ELEVATION PLAN - OUTBOUND
SCALE: 1" = 20'



ORIGINAL PLAN	DATE
SURVEY PLOTTED BY	
DRAWN BY	
DESIGNED BY	
NOTED BY	
QUANTITIES BY	
CHECKED BY	
No.	

GRAPHIC SCALE

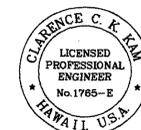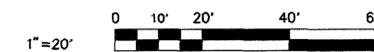

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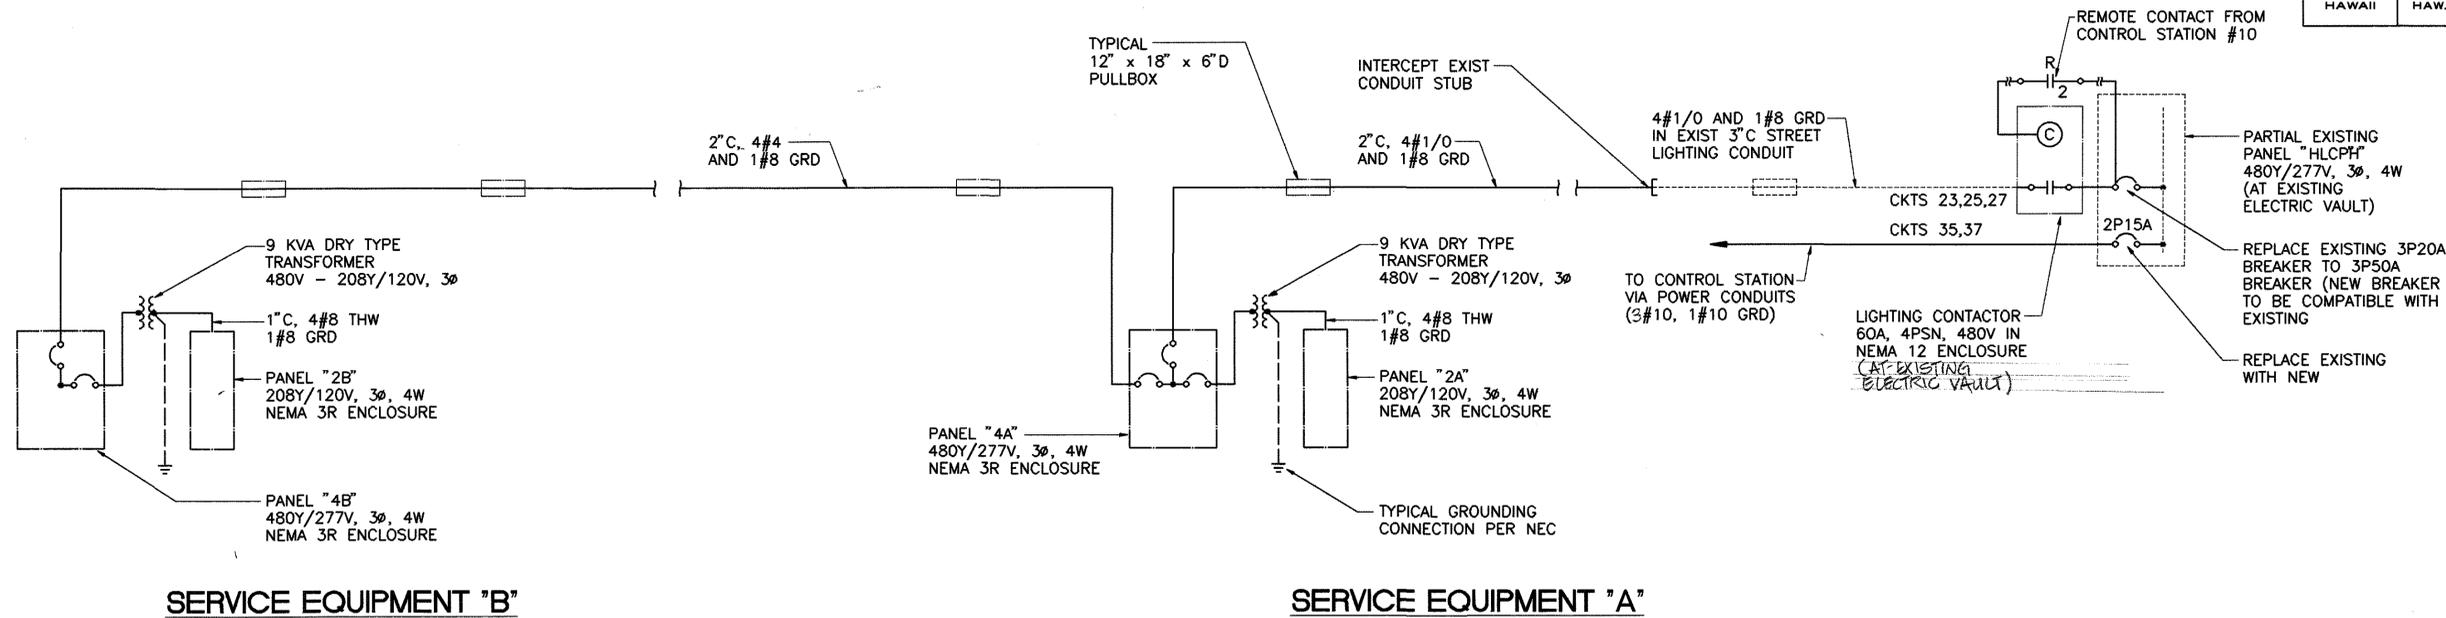
Clarence C. K. Kim
SIGNATURE

STATE OF HAWAII
DEPARTMENT OF TRANSPORTATION
HIGHWAYS DIVISION
**PARTIAL ELECTRICAL PLAN -
OUTBOUND INTERIOR**
STA. 590+00 TO 594+50
INTERSTATE ROUTE H-3
F.A.I. PROJECT NO. 1-H3-1 (75) UNIT 1


SCALE: 1" = 20' DATE: JAN. 1996
SHEET NO. EH-29 OF 32 SHEETS

DATE	REVISION

FED. ROAD DIST. NO.	STATE	FED. AID PROJ. NO.	FISCAL YEAR	SHEET NO.	TOTAL SHEETS
HAWAII	HAW.	I-H3-1(75), UNIT 1	1996	321	405



ONE-LINE DIAGRAM (INBOUND)

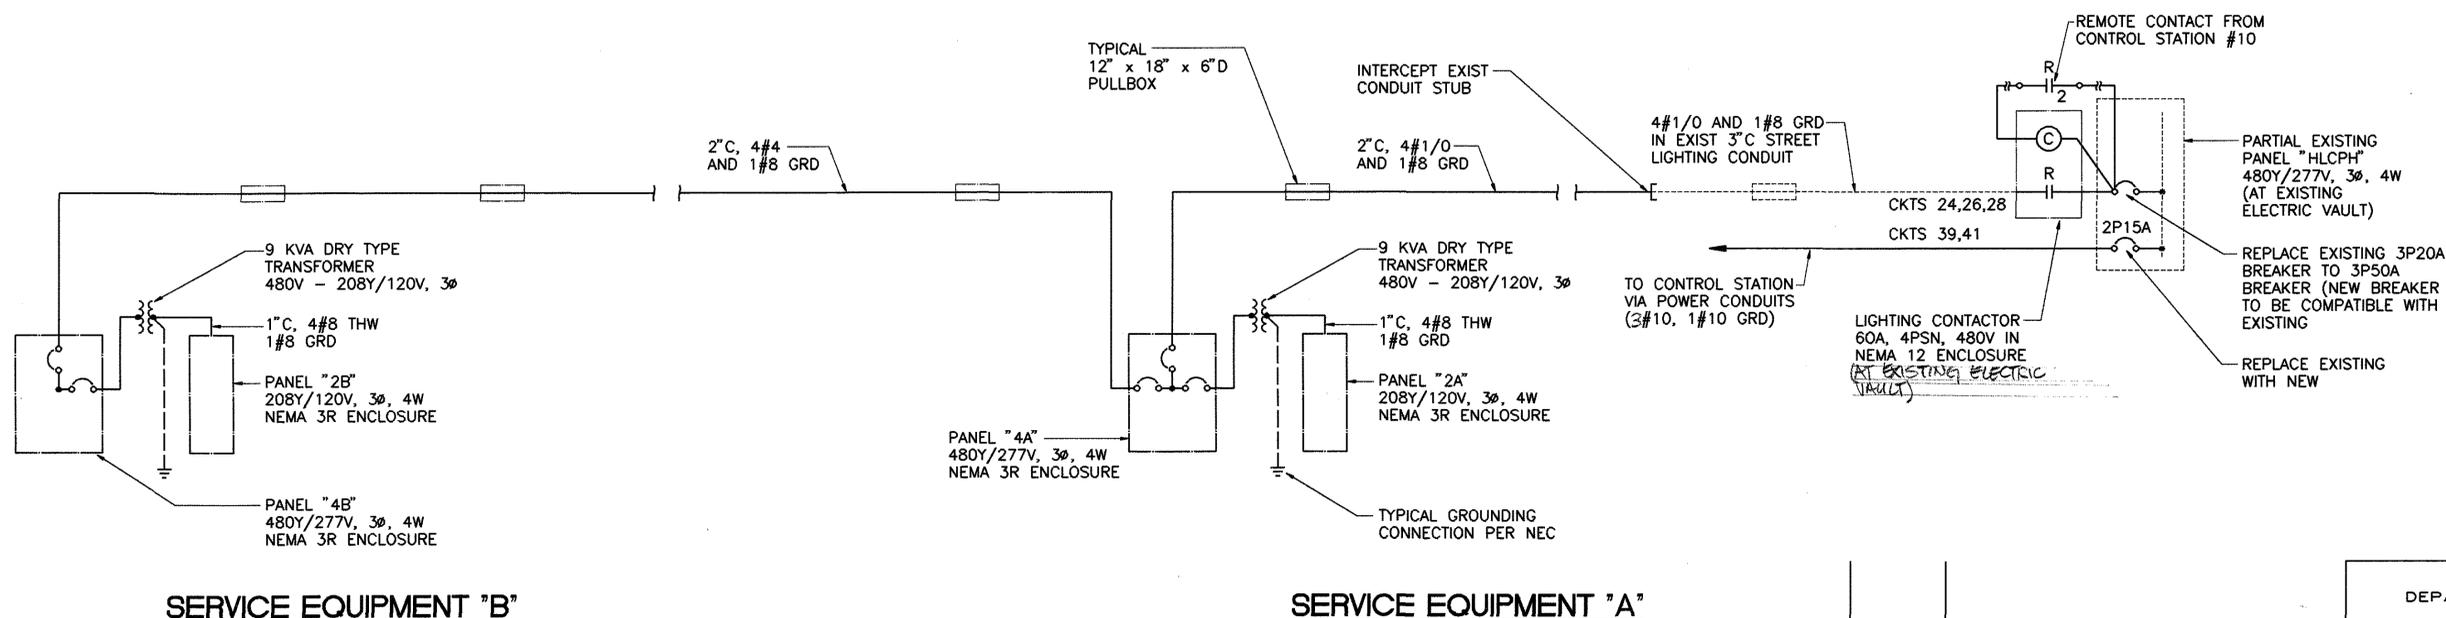

ONE-LINE DIAGRAM (OUTBOUND)

DATE	_____
DESIGNED BY	_____
DRAWN BY	_____
CHECKED BY	_____
QUANTITIES BY	_____
NOTED BY	_____
ORIGINAL PLAN	_____
NO.	_____



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Clarence C. K. Kama
SIGNATURE

STATE OF HAWAII
DEPARTMENT OF TRANSPORTATION
HIGHWAYS DIVISION


ONE-LINE DIAGRAM

INTERSTATE ROUTE H-3
F.A.I. PROJECT NO. I-H3-1 (75) UNIT 1

SCALE: 1" = 1' DATE: JAN. 1996
SHEET NO. EH-30 OF 32 SHEETS

DATE REVISION

FED. ROAD DIST. NO.	STATE	FED. AID PROJ. NO.	FISCAL YEAR	SHEET NO.	TOTAL SHEETS
HAWAII	HAW.	1-H3-1(75) UNIT 1	1996	322	405

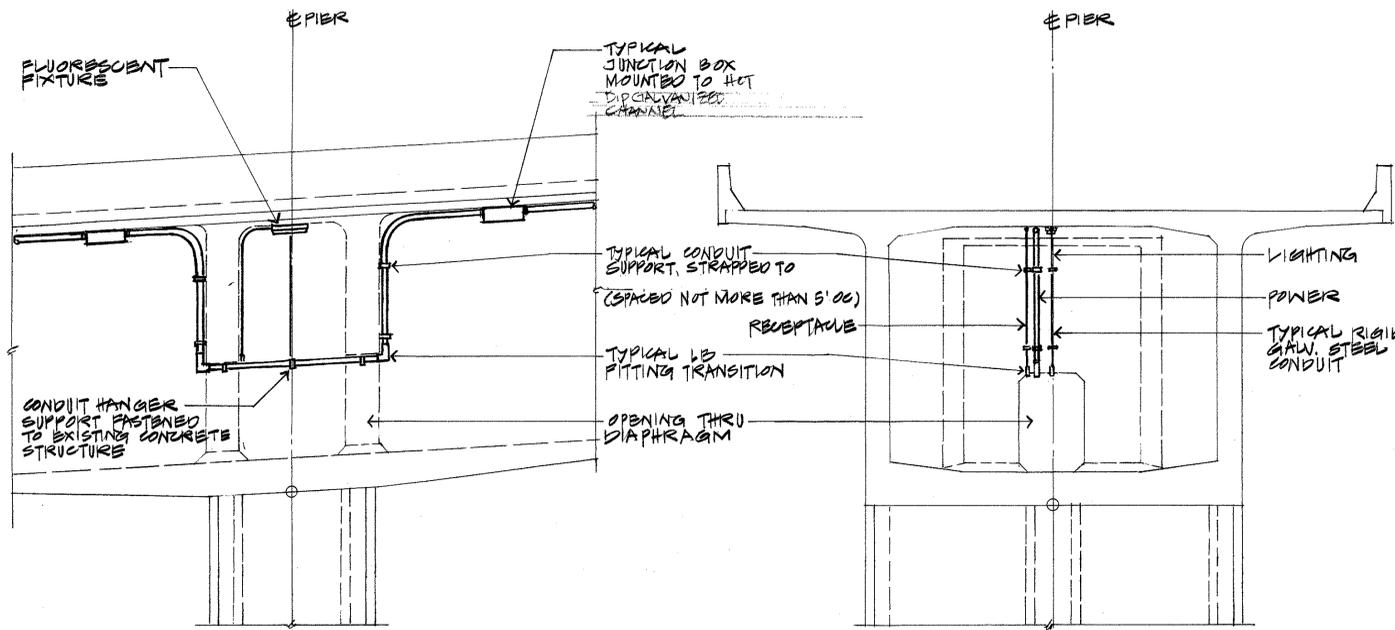


LONGITUDINAL SECTION

CROSS SECTION

(TYPICAL) TYPE I PIER DIAPHRAGM ELECTRICAL DETAIL

2 NOT TO SCALE
EH-19, EH-20, EH-21, EH-22, EH-23, EH-24, EH-25, EH-26, EH-27, EH-28

(AS MAY APPLY)

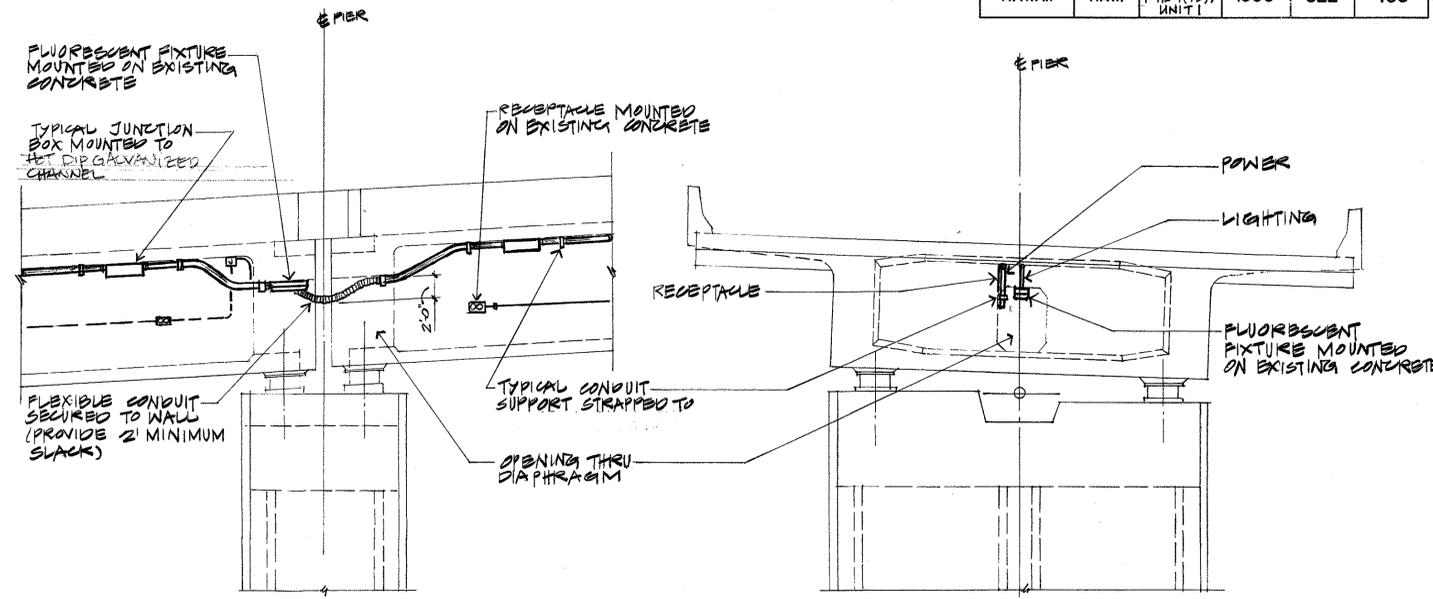


LONGITUDINAL SECTION

CROSS SECTION

(TYPICAL) END PIER DIAPHRAGM ELECTRICAL DETAIL

3 NOT TO SCALE
EH-21, EH-22, EH-23, EH-24, EH-25

(AS MAY APPLY)

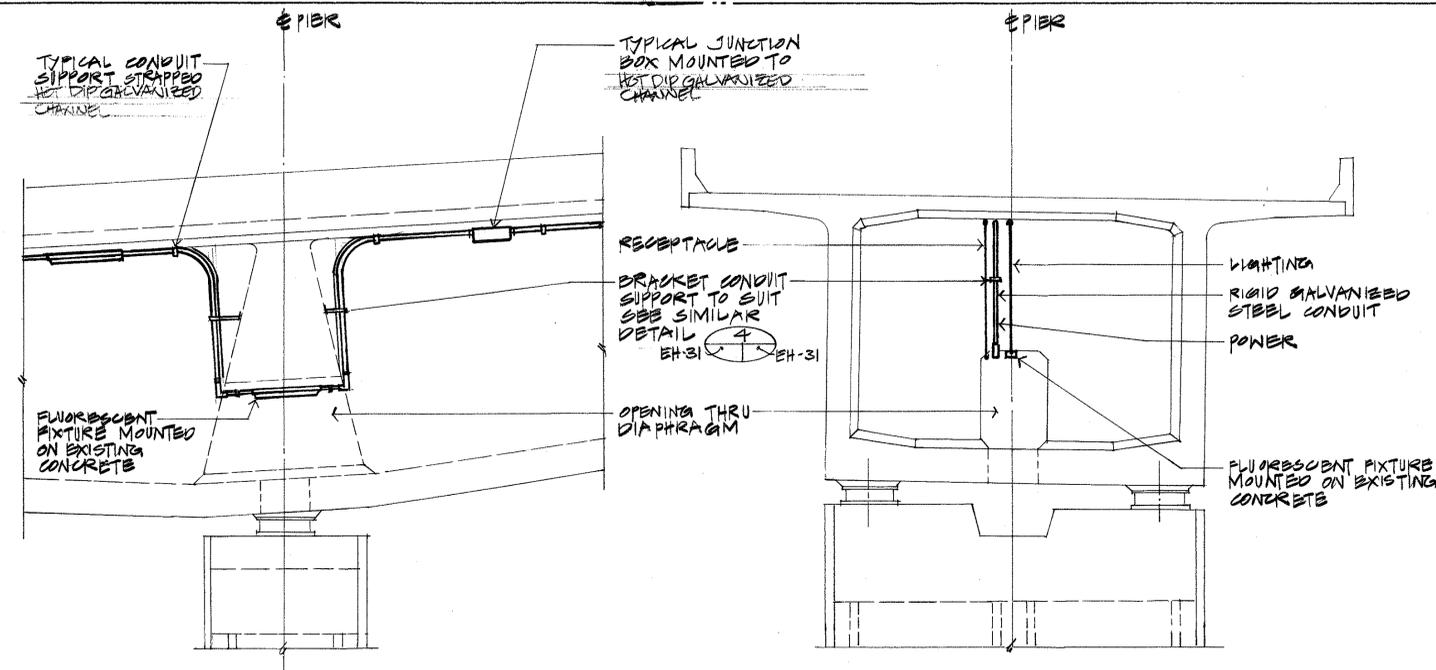


LONGITUDINAL SECTION

CROSS SECTION

(TYPICAL) TYPE II PIER DIAPHRAGM ELECTRICAL DETAIL

4 NOT TO SCALE
EH-19, EH-20, EH-21, EH-22, EH-23, EH-24, EH-25, EH-26, EH-27, EH-28, EH-29

(AS MAY APPLY)

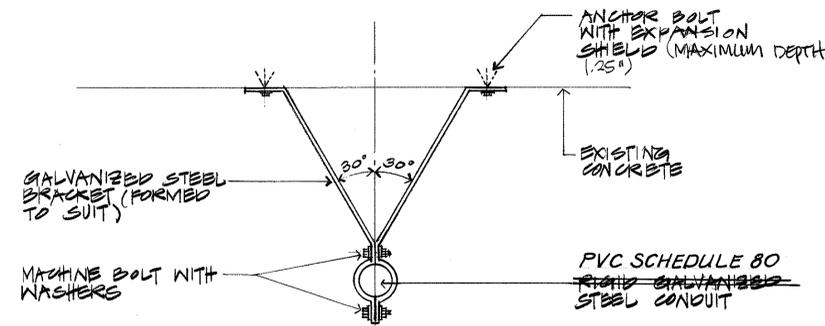

4 BRACKET CONDUIT SUPPORT DETAIL

NOT TO SCALE
EH-21, EH-22, EH-23, EH-24, EH-25

DATE	
SURVEY PLOTTED BY	
DESIGNED BY	
QUANTITIES BY	
CHECKED BY	
ORIGINAL PLAN	
NOTEBOOK	
No.	



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Signature

STATE OF HAWAII
DEPARTMENT OF TRANSPORTATION
HIGHWAYS DIVISION

PIER DIAPHRAGM
ELECTRICAL DETAIL

INTERSTATE ROUTE H-3
F.A.I. PROJECT NO. 1-H3-1 (75) UNIT 1


SCALE: DATE: JAN. 1996
SHEET NO. EH-31 OF 32 SHEETS

DATE REVISION


"AS-BUILT"

322

FED. ROAD DIST. NO.	STATE	FED. AID PROJ. NO.	FISCAL YEAR	SHEET NO.	TOTAL SHEETS
HAWAII	HAW.	I-H3-1(75), UNIT 1	1996	323	405

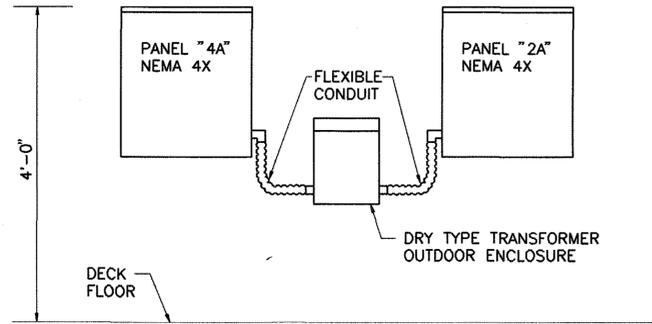

1 TYPICAL SERVICE EQUIPMENT DETAIL
EH-32/EH-32 NOT TO SCALE

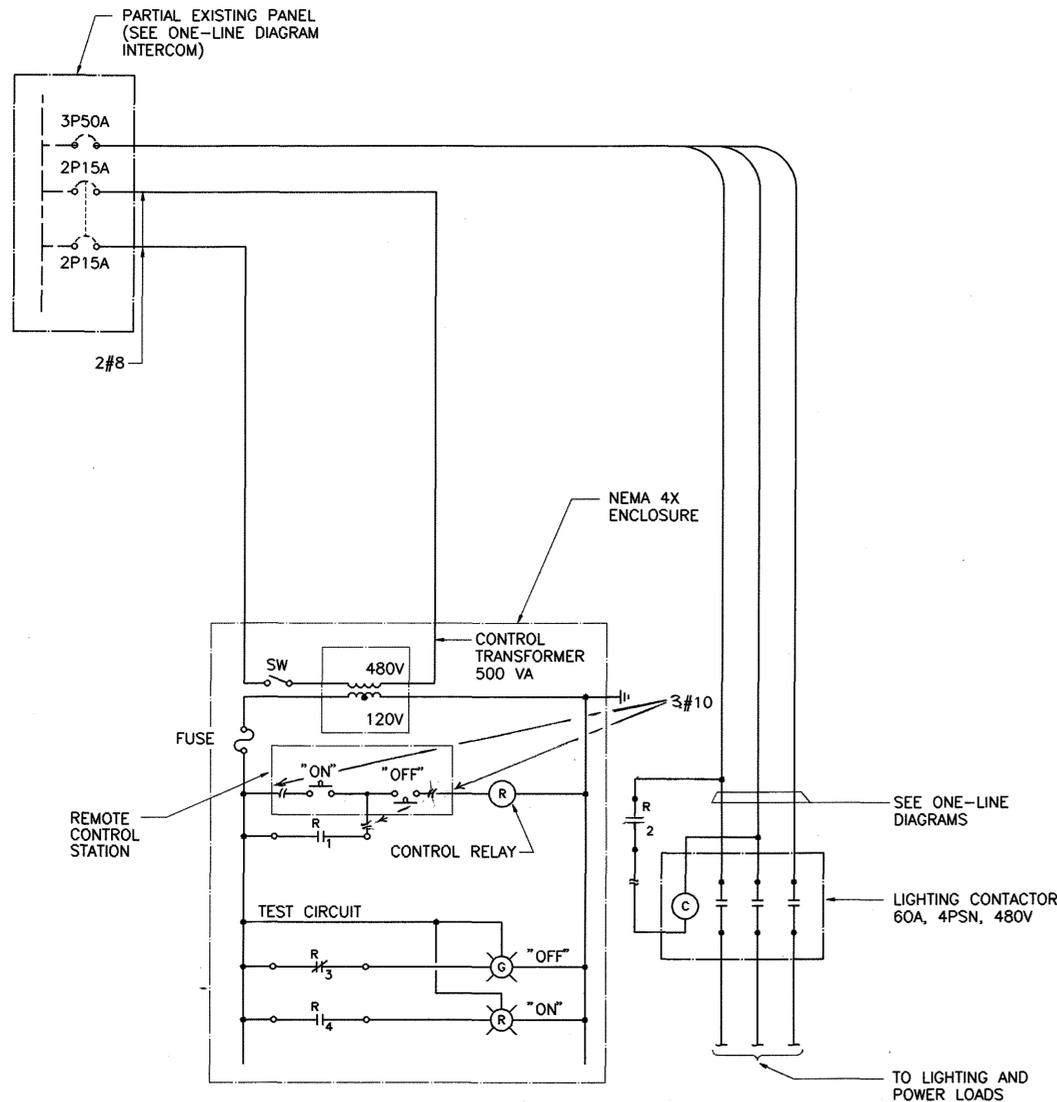

2 TYPICAL FULL WIRING CONTROL DIAGRAM
EH-32/EH-32 NOT TO SCALE

PANEL 2 A		208Y/120 VOLTS, 3 PHASE, 4 WIRES, 10,000 AIC MIN. 3P100A MAIN LUGS ONLY												
CIRCUIT DESCRIPTION	WIRE SIZE	BREAKER			CKT. NO.	LOAD (KVA)			CKT. NO.	BREAKER			WIRE SIZE	CIRCUIT DESCRIPTION
		POLE	AMPS	NOTE		A	B	C		NO.	POLE	AMPS		
R	12	1	20		1	0.6	/	0.6		2	1	20	12	R
R	12	1	20		3			0.6 / 0.6		4	1	20	12	R
R	12	1	20		5			0.6 / 0.6		6	1	20	12	R
R	12	1	20		7	0.6	/	0.6		8	1	20	12	R
R	12	1	20		9			0.6 / 0.6		10	1	20	12	R
R	12	1	20		11			0.6 / 0.6		12	1	20	12	R
S			1	20	13	1.0	/	1.0		14	1	20		S
S			1	20	15			1.0 / 1.0		16	1	20		S
S			1	20	17			1.0 / 1.0		18	1	20		S
CONNECTED KVA LOAD EACH BUS						4.4	4.4	4.4	SPECIAL INSTRUCTIONS:					
DEMAND FACTOR ALLOWED						0.7	0.7	0.7	MOUNTING:					
DEMAND KVA LOAD EACH BUS						3.1	3.1	3.1	LOCATION:					
MAXIMUM DESIGN AMPERES EACH BUS						25.7	25.7	25.7	TOTAL KVA LOAD: 9.2					

NOTES:
1. TYPICAL FOR INBOUND AND OUTBOUND
2. PANEL 2B SIMILAR
3.
4.

ABBREVIATION:
L - LIGHT
R - RECEPTACLE
S - SPARE BREAKER
PFB - PROVISIONS FOR BREAKER
IG - ISOLATED GROUND
GFCI - GROUND FAULT CIRCUIT INTERRUPTER
HACR - LISTED FOR HTG., A/C, REFRIG. EQUIP.

PANEL 4 A		480Y/277 VOLTS, 3 PHASE, 4 WIRES, 14,000 AIC MIN. 3P50A MAIN BREAKER												
CIRCUIT DESCRIPTION	WIRE SIZE	BREAKER			CKT. NO.	LOAD (KVA)			CKT. NO.	BREAKER			WIRE SIZE	CIRCUIT DESCRIPTION
		POLE	AMPS	NOTE		A	B	C		NO.	POLE	AMPS		
L	10	1	20		1	1.5	/	1.5		2	1	20	10	L
L	10	1	20		3			1.5 / 1.5		4	1	20	10	L
L	10	1	20		5			1.5 / 1.5		6	1	20	10	L
PANEL "2A" XFMR	12	3	20		7	3.0	/	4.0		8	3	30	4	PANEL "4B"
	12				9			3.0 / 4.0		10			4	
	12				11			3.0 / 4.0		12			4	
S			1	20	13	1.0	/	1.0		14	1	20		S
S			1	20	15			1.0 / 1.0		16	1	20		S
S			1	20	17			1.0 / 1.0		18	1	20		S
CONNECTED KVA LOAD EACH BUS						12.0	12.0	12.0	SPECIAL INSTRUCTIONS:					
DEMAND FACTOR ALLOWED						0.7	0.7	0.7	MOUNTING:					
DEMAND KVA LOAD EACH BUS						8.4	8.4	8.4	LOCATION:					
MAXIMUM DESIGN AMPERES EACH BUS						30.3	30.3	30.3	TOTAL KVA LOAD: 25.2					

NOTES:
1. TYPICAL FOR INBOUND AND OUTBOUND
2.
3.
4.

ABBREVIATION:
L - LIGHT
R - RECEPTACLE
S - SPARE BREAKER
PFB - PROVISIONS FOR BREAKER
IG - ISOLATED GROUND
GFCI - GROUND FAULT CIRCUIT INTERRUPTER
HACR - LISTED FOR HTG., A/C, REFRIG. EQUIP.

PANEL 4 B		480Y/277 VOLTS, 3 PHASE, 4 WIRES, 14,000 AIC MIN. 3P50A MAIN BREAKER												
CIRCUIT DESCRIPTION	WIRE SIZE	BREAKER			CKT. NO.	LOAD (KVA)			CKT. NO.	BREAKER			WIRE SIZE	CIRCUIT DESCRIPTION
		POLE	AMPS	NOTE		A	B	C		NO.	POLE	AMPS		
L	10	1	20		1	1.5	/	1.5		2	1	20	10	L
L	10	1	20		3			1.5 / 1.5		4	1	20	10	L
L	10	1	20		5			1.5 / 1.5		6	1	20	10	L
S			1	20	7	1.0	/	1.0		8	1	20		S
S			1	20	9			1.0 / 1.0		10	1	20		S
S			1	20	11			1.0 / 1.0		12	1	20		S
S			1	20	13	1.0	/	1.0		14	1	20		S
S			1	20	15			1.0 / 1.0		16	1	20		S
S			1	20	17			1.0 / 1.0		18	1	20		S
CONNECTED KVA LOAD EACH BUS						7.0	7.0	7.0	SPECIAL INSTRUCTIONS: NEMA 4X ENCLOSURE					
DEMAND FACTOR ALLOWED						0.7	0.7	0.7	MOUNTING: SURFACE					
DEMAND KVA LOAD EACH BUS						4.9	4.9	4.9	LOCATION:					
MAXIMUM DESIGN AMPERES EACH BUS						17.7	17.7	17.7	TOTAL KVA LOAD: 14.7					

NOTES:
1. TYPICAL FOR INBOUND AND OUTBOUND
2.
3.
4.

ABBREVIATION:
L - LIGHT
R - RECEPTACLE
S - SPARE BREAKER
PFB - PROVISIONS FOR BREAKER
IG - ISOLATED GROUND
GFCI - GROUND FAULT CIRCUIT INTERRUPTER
HACR - LISTED FOR HTG., A/C, REFRIG. EQUIP.

DATE	_____
DESIGNED BY	_____
TRACED BY	_____
DESIGNED BY	_____
NOTED BY	_____
CHECKED BY	_____
NO.	_____

CLARENCE C. K. KM
LICENSED PROFESSIONAL ENGINEER
No. 1765-B
HAWAII, U.S.A.

This work was prepared by me or under my supervision.

Clarence C. K. Km
SIGNATURE

STATE OF HAWAII
DEPARTMENT OF TRANSPORTATION
HIGHWAYS DIVISION

MISCELLANEOUS DIAGRAMS

INTERSTATE ROUTE H-3
F.A.I. PROJECT NO. I-H3-1 (75) UNIT 1

SCALE: 1" = 1' DATE: JAN. 1996
SHEET NO. EH-32 OF 32 SHEETS

DATE _____ REVISION _____

FED. ROAD DIST. NO.	STATE	FED. AID PROJ. NO.	FISCAL YEAR	SHEET NO.	TOTAL SHEETS
HAWAII	HAW.	I-H3-1(75)UNIT1	1996	324	405

EXST	NEW	DESCRIPTION
	□	FLUORESCENT VAPOR-TIGHT LIGHT, STEM ON SURFACE MTD, W.P. SEE LIGHTING FIXTURE DETAIL ON SHEET EW-14.
	⊕	RECEPTACLE, SURFACE MTD W/ CAST METAL W.P. OUTLET BOX, NEMA 5-15R. +24" A.F.F.
	⊠	LARGE JB W/ HINGE COVER, SURF. CEIL MTD., W.P., 24" SQ. X 12" D.
	⊠	LARGE JB W/ HINGE COVER, WALL MTD, W.P., 24" SQ X 12" D
	⊠	LARGE JB W/ HINGE COVER, SURF. CEIL MTD., W.P., 36" L X 24" W X 10" D OR AS INDIC.
	⊠	LARGE JB W/ HINGE COVER, WALL MTD, W.P., 36" L X 24" W X 10" D OR AS INDICATED.
	⊕	SMALL JB, SURFACE MTD, W.P., 4" SQ X 2" D.
	⊠	PUSH-BUTTON, +48" A.F.F.
	⊠	SERVICE EQUIPMENT, SEE PLANS & ELEVATION ON SHEET EW15.
	~	NON-METALLIC FLEX. COND. W/ WIRES, LIQUID-TIGHT & SUNLIGHT PROTECTED.
	---	EXPOSED GALVANIZED RIGID STEEL CONDUIT W/ WIRES.
	⊕	GROUNDING SYSTEM FOR DISTRIBUTION EQUIPMENT
	OB-01	DISTRIBUTION EQUIPMENT IDENTIFICATION, OUTBOUND #1 INDICATED
	OB-01-IR	RECEPTACLE CIRCUIT #1 SERVED BY OUTBOUND BRIDGE SEGMENT DIST. EQUIPMENT 01 INDICATED.
	OB-01-L	LIGHTING CIRCUIT #1 SERVED BY OUTBOUND BRIDGE SEGMENT DIST. EQUIPMENT 01 INDICATED.
	WP	WEATHER PROOF
	JB	JUNCTION BOX
	A.F.F.	ABOVE FINISH FLOOR
	S.S.	STAINLESS STEEL.
	XFMR	TRANSFORMER

GENERAL NOTES:

- ALL EQUIPMENT SHOWN ARE NEW UNLESS INDICATED OTHERWISE.
 - VERIFY LOCATIONS OF EXISTING REBARS AND TENDONS BEFORE CORING ANY EXISTING CONCRETE STRUCTURE. CONTRACT DRAWINGS FAIP 1-H3-1(57) & FAIP 1-H3-1(58) ARE AVAILABLE FOR REFERENCE.
 - STEEL STRUT CHANNEL SHALL BE HOT-DIP GALVANIZED AFTER FABRICATION.
 - ALL FASTENERS, STRAPS AND HARDWARE SHALL BE STAINLESS STEEL UNLESS NOTED OTHERWISE.
 - SEE TYPICAL BOX GIRDER LIGHTING PLAN ON SHEET EW-15 FOR ADDITIONAL LIGHTING REQUIREMENTS. NOT SHOWN ON PARTIAL ELECTRICAL PLANS.
- SEE ADDITIONAL NOTE ON SHEET 308




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Glenn D. Oyama

STATE OF HAWAII
 DEPARTMENT OF TRANSPORTATION
 HIGHWAYS DIVISION
 WINDWARD VIADUCT
 ELECTRICAL SYMBOLS AND DIAGRAMS

INTERSTATE ROUTE H-3
 F.A.I. PROJECT NO. I-H3-1 (75) UNIT 1

SCALE: AS NOTED DATE: JAN 1996
 SHEET No. EW1 OF 19 SHEETS

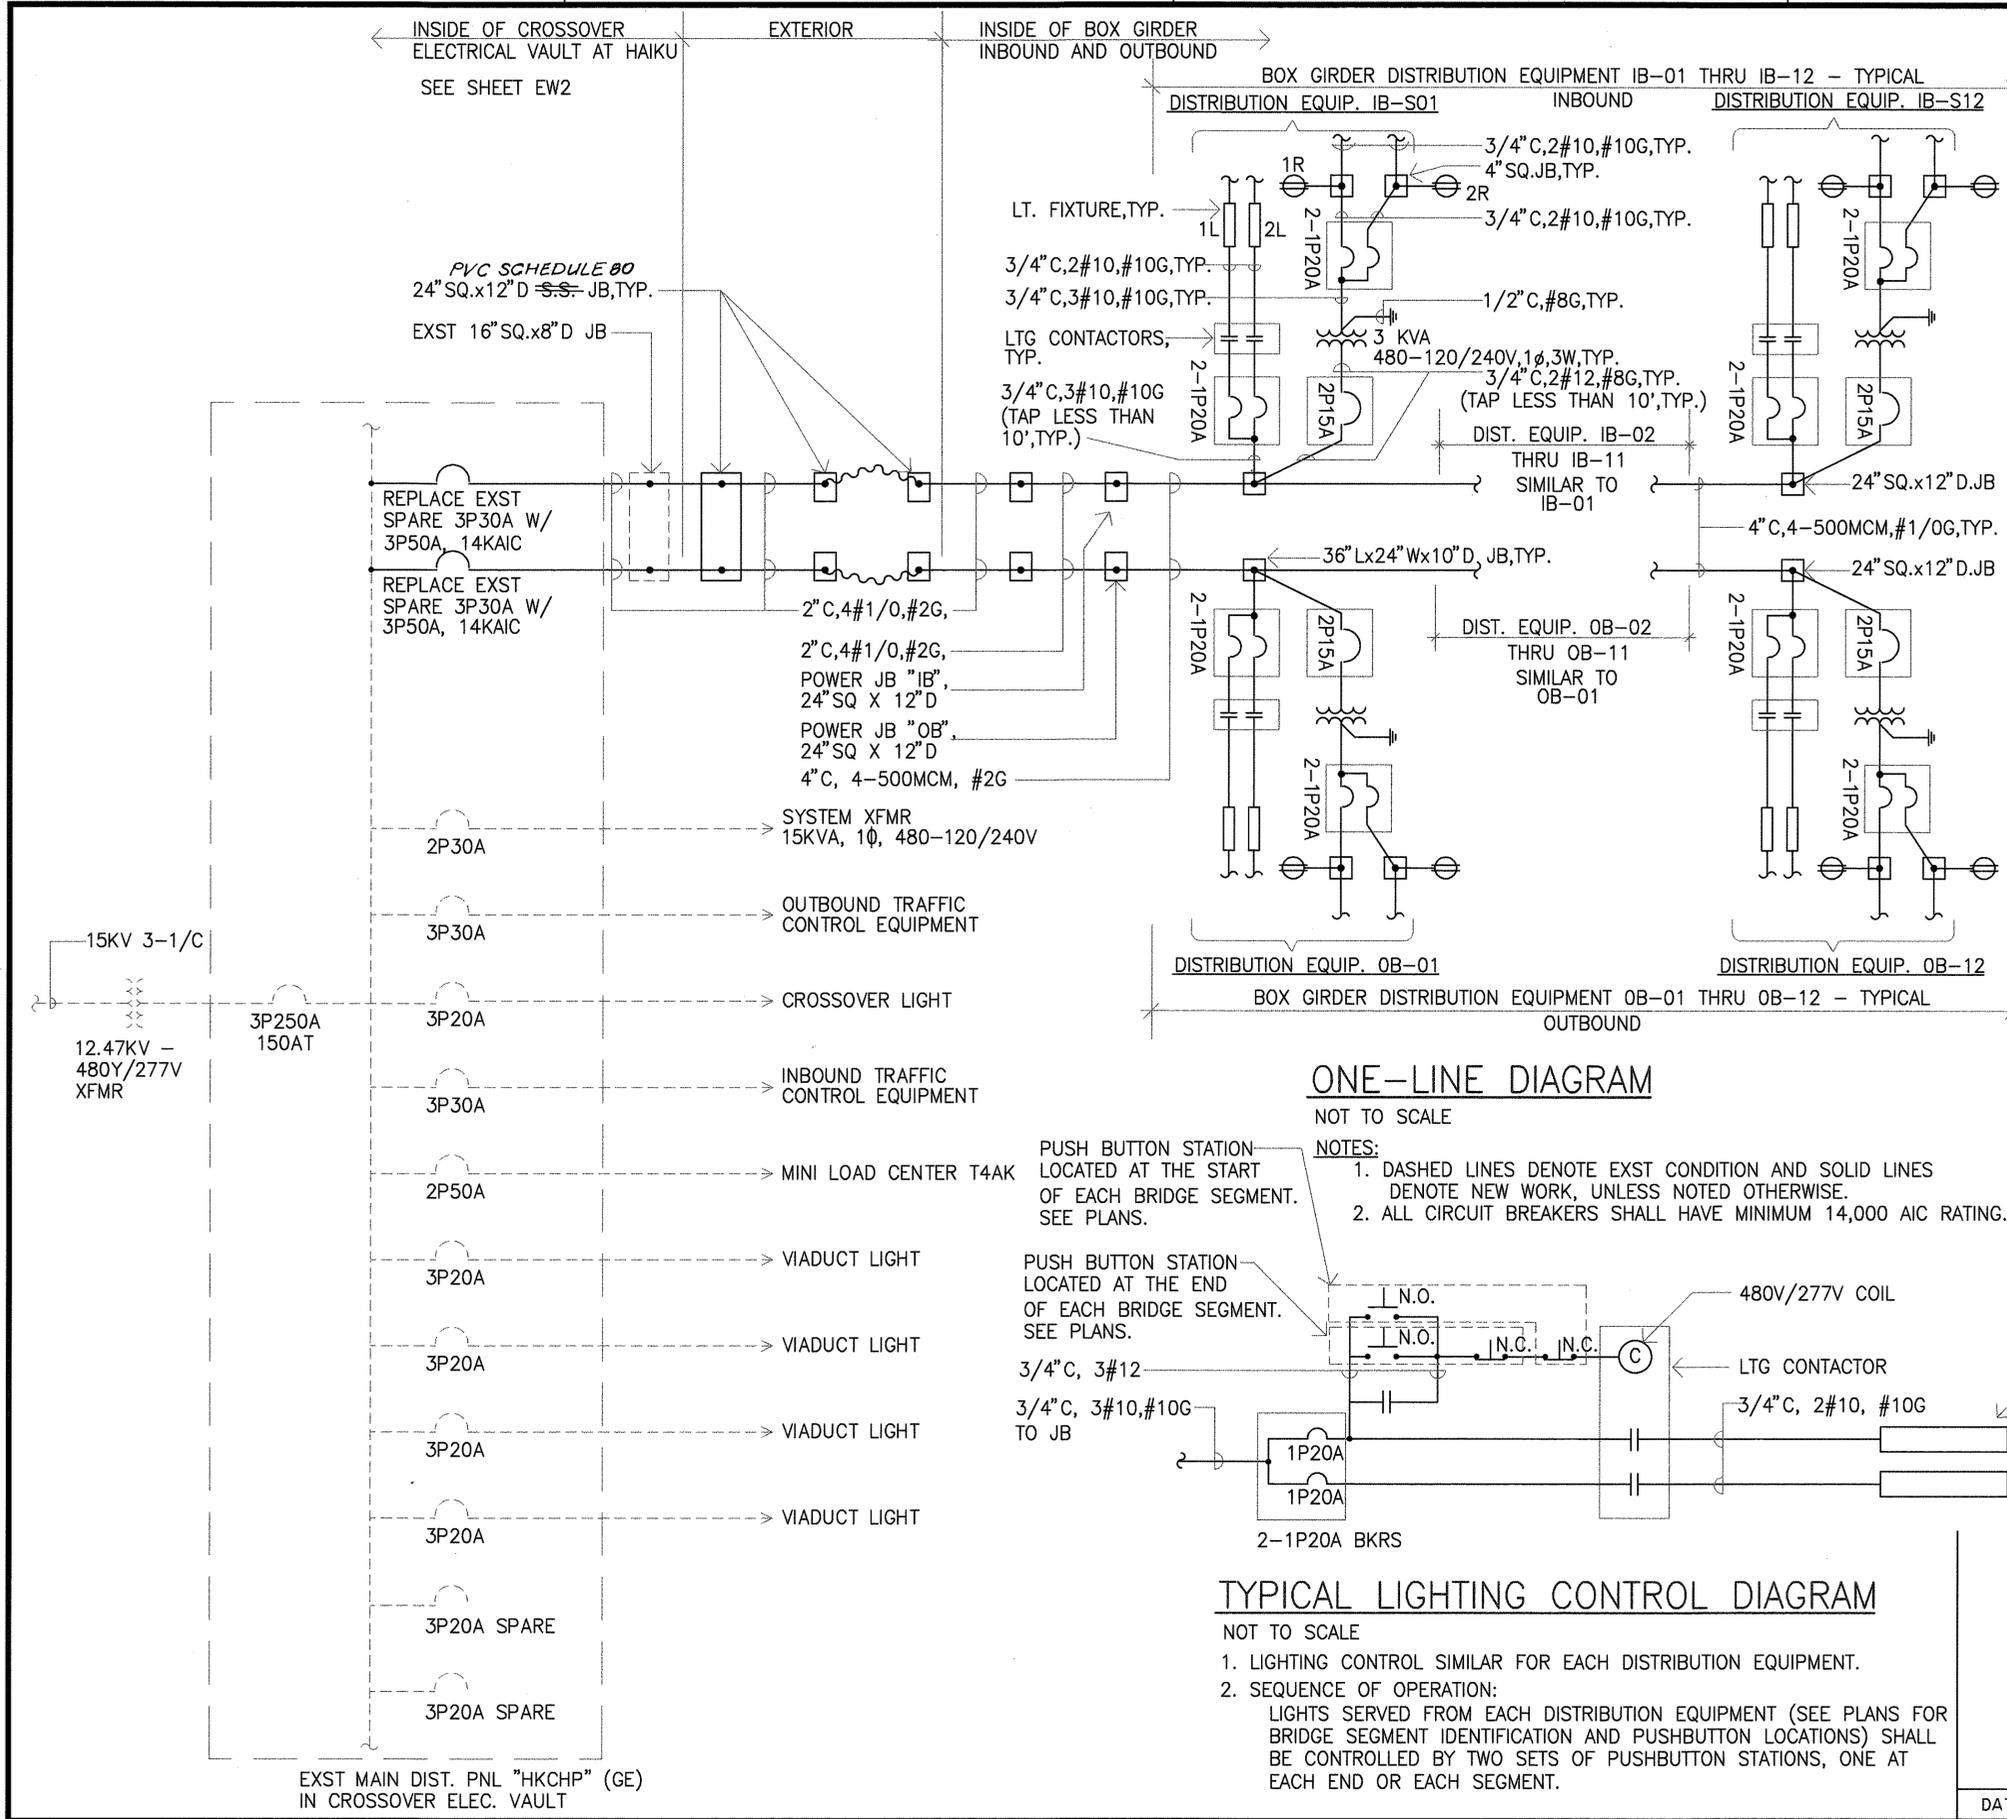

ONE-LINE DIAGRAM


NOT TO SCALE

NOTES:

- DASHED LINES DENOTE EXST CONDITION AND SOLID LINES DENOTE NEW WORK, UNLESS NOTED OTHERWISE.
- ALL CIRCUIT BREAKERS SHALL HAVE MINIMUM 14,000 AIC RATING.

PUSH BUTTON STATION LOCATED AT THE START OF EACH BRIDGE SEGMENT. SEE PLANS.

PUSH BUTTON STATION LOCATED AT THE END OF EACH BRIDGE SEGMENT. SEE PLANS.

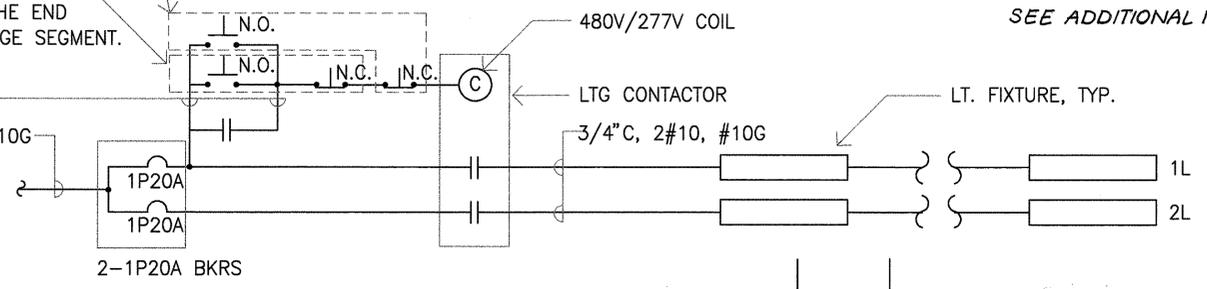

TYPICAL LIGHTING CONTROL DIAGRAM

NOT TO SCALE



- LIGHTING CONTROL SIMILAR FOR EACH DISTRIBUTION EQUIPMENT.
- SEQUENCE OF OPERATION:
 LIGHTS SERVED FROM EACH DISTRIBUTION EQUIPMENT (SEE PLANS FOR BRIDGE SEGMENT IDENTIFICATION AND PUSHBUTTON LOCATIONS) SHALL BE CONTROLLED BY TWO SETS OF PUSHBUTTON STATIONS, ONE AT EACH END OR EACH SEGMENT.

SURVEY PLOTTED BY	DATE
DRAWN BY	
TRACED BY	
DESIGNED BY	
QUANTITIES BY	
CHECKED BY	
ORIGINAL PLAN	
NOTED	
No.	


EXST MAIN DIST. PNL "HKCHP" (GE) IN CROSSOVER ELEC. VAULT

DATE	REVISION

FED. ROAD DIST. NO.	STATE	FED. AID PROJ. NO.	FISCAL YEAR	SHEET NO.	TOTAL SHEETS
HAWAII	HAW.	I-H3-1(75)UNIT1	1996	325	405

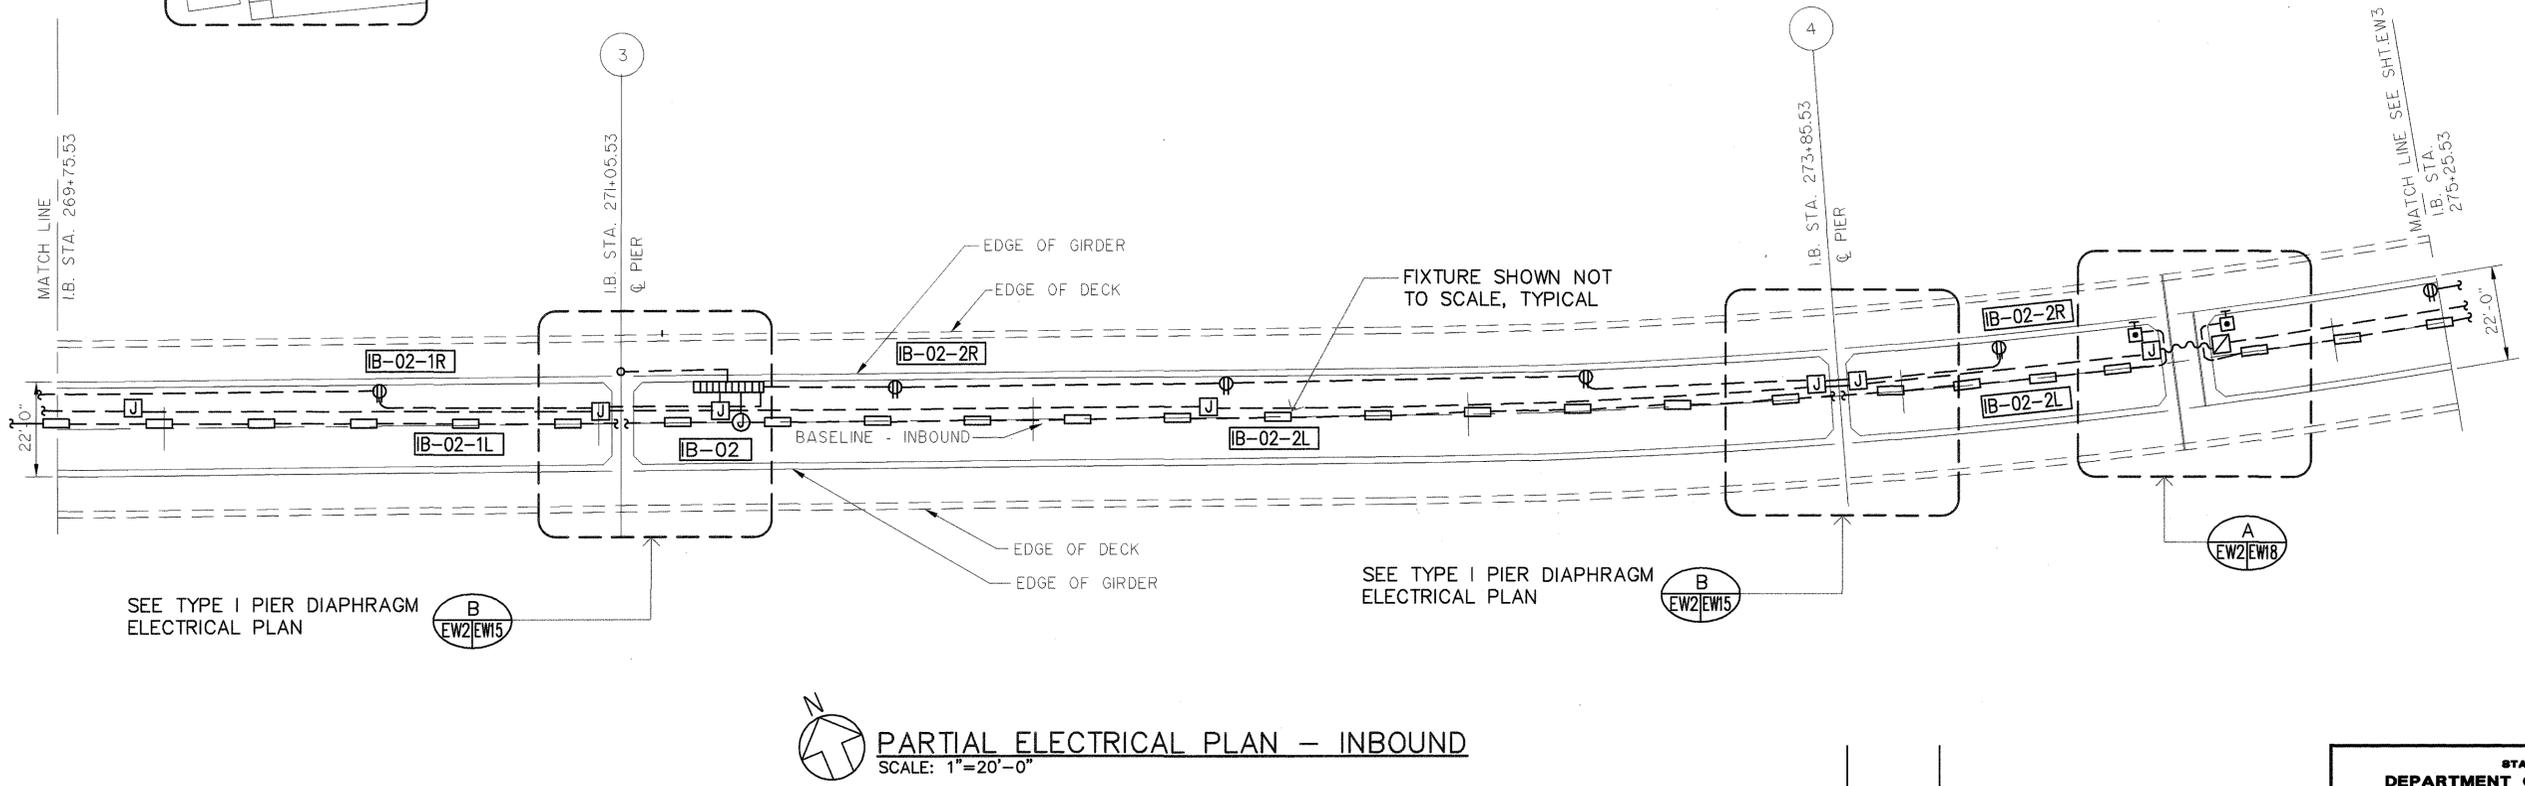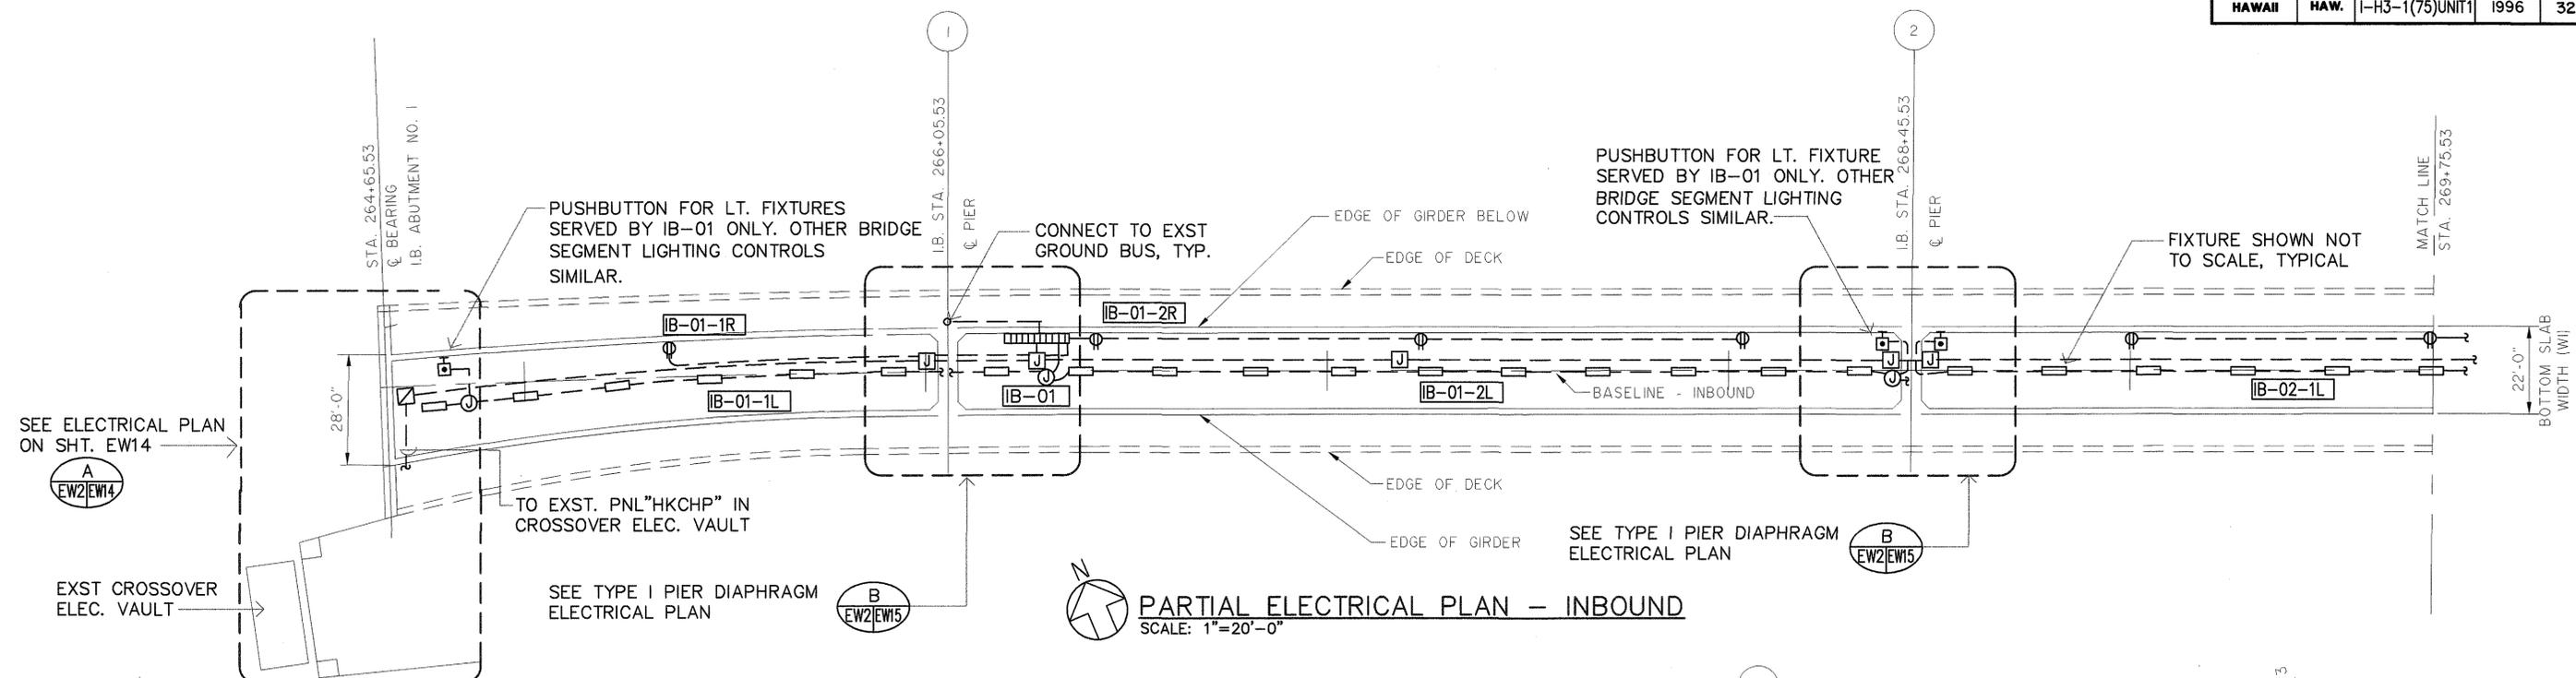

SURVEY PLOTTED BY	DATE
DRAWN BY	
TRACED BY	
DESIGNED BY	
QUANTITIES BY	
CHECKED BY	
NO.	

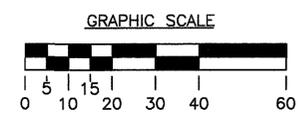

GLENN D. OYAMA
LICENSED PROFESSIONAL ENGINEER
NO. 4210-B
HAWAII, U.S.A.

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Glenn D. Oyama

STATE OF HAWAII
DEPARTMENT OF TRANSPORTATION
HIGHWAYS DIVISION

WINDWARD VIADUCT

PARTIAL ELEC PLANS - INBOUND


INTERSTATE ROUTE H-3
F.A.I. PROJECT NO. I-H3-1 (75) UNIT 1

SCALE: AS NOTED DATE: JAN 1996


SHEET No. EW2 OF 19 SHEETS

DATE	REVISION

FED. ROAD DIST. NO.	STATE	FED. AID PROJ. NO.	FISCAL YEAR	SHEET NO.	TOTAL SHEETS
HAWAII	HAW.	I-H3-1(75)UNIT1	1996	326	405

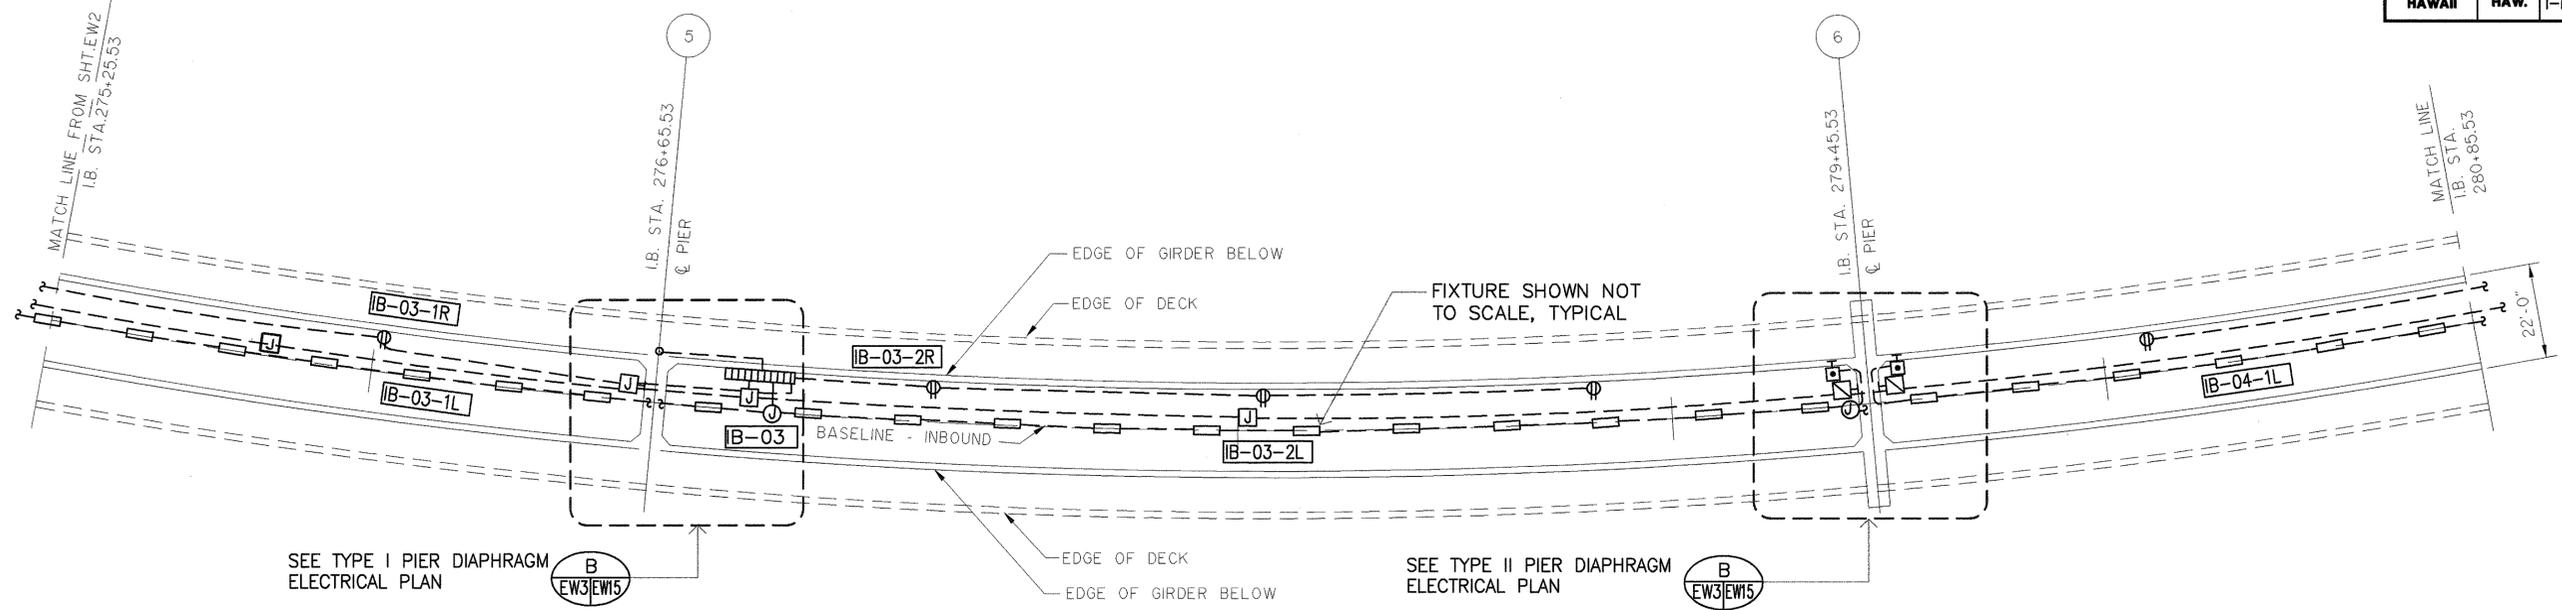


PARTIAL ELECTRICAL PLAN - INBOUND
SCALE: 1"=20'-0"

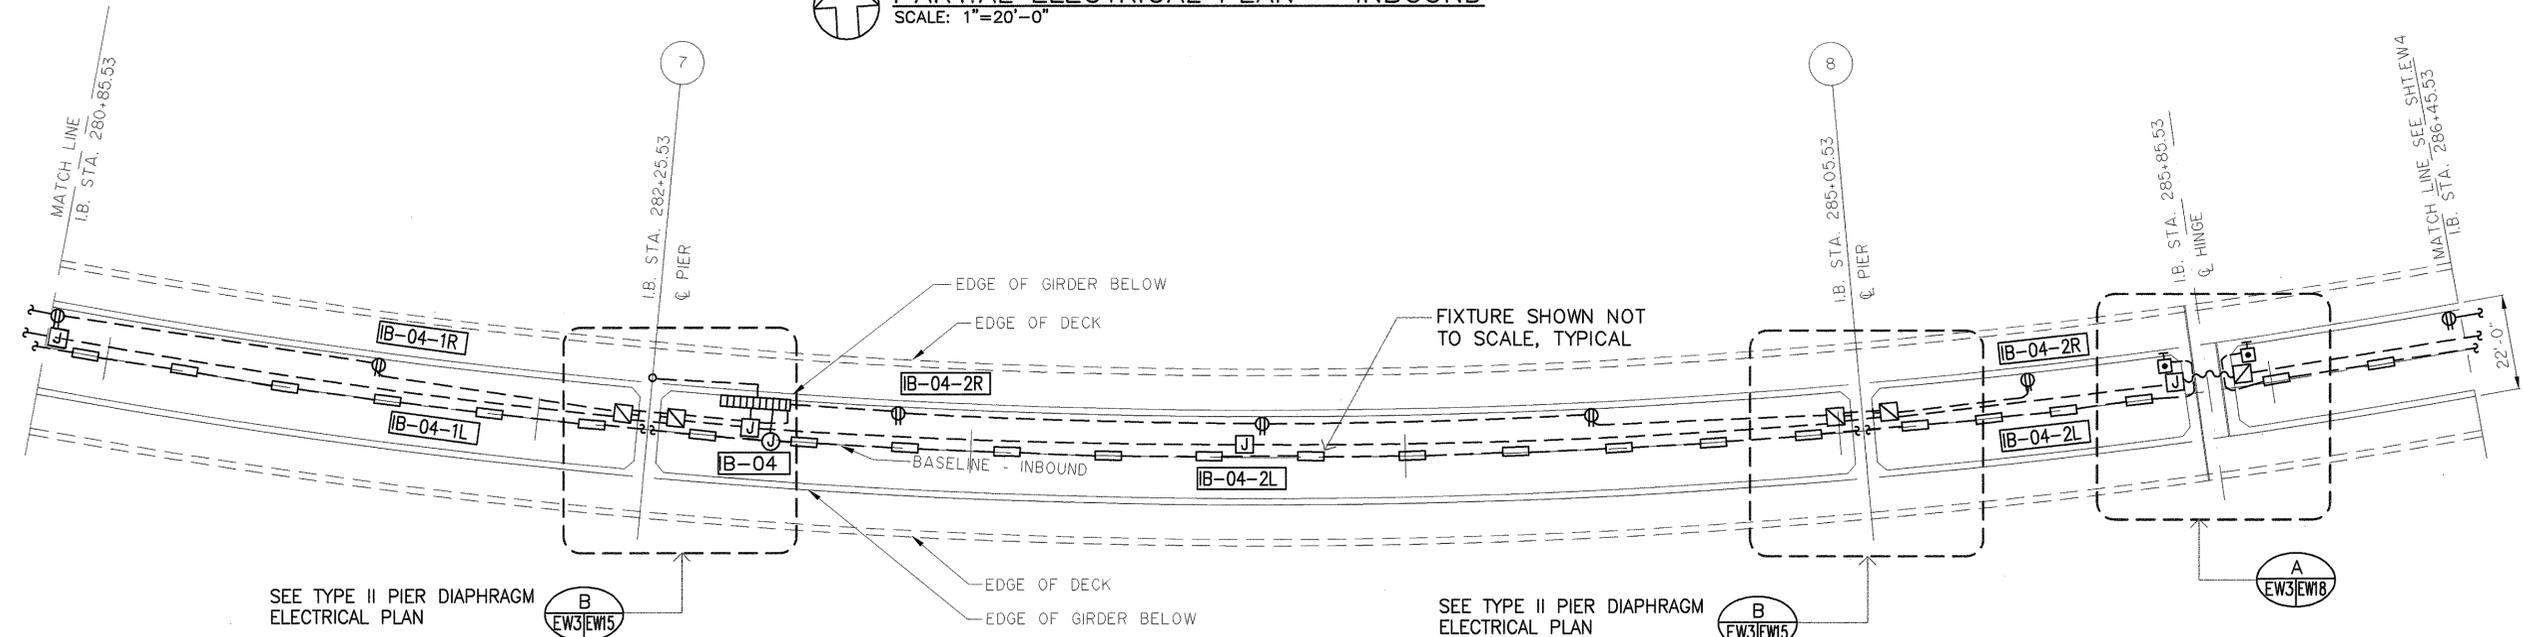

PARTIAL ELECTRICAL PLAN - INBOUND
SCALE: 1"=20'-0"

SURVEY PLOTTED BY	DATE
DRAWN BY	
DESIGNED BY	
QUANTITIES BY	
CHECKED BY	
ORIGINAL PLAN	
NO.	

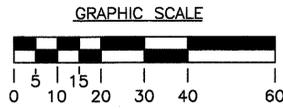

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HAWAII, U.S.A.

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STATE OF HAWAII
DEPARTMENT OF TRANSPORTATION
HIGHWAYS DIVISION


WINDWARD VIADUCT
PARTIAL ELEC PLANS-INBOUND
INTERSTATE ROUTE H-3
F.A.I. PROJECT NO. I-H3-1 (75) UNIT 1

SCALE: AS NOTED DATE: JAN 1996


SHEET No. EW3 OF 19 SHEETS

DATE	REVISION

FED. ROAD DIST. NO.	STATE	FED. AID PROJ. NO.	FISCAL YEAR	SHEET NO.	TOTAL SHEETS
HAWAII	HAW.	I-H3-1(75)UNIT1	1996	327	405

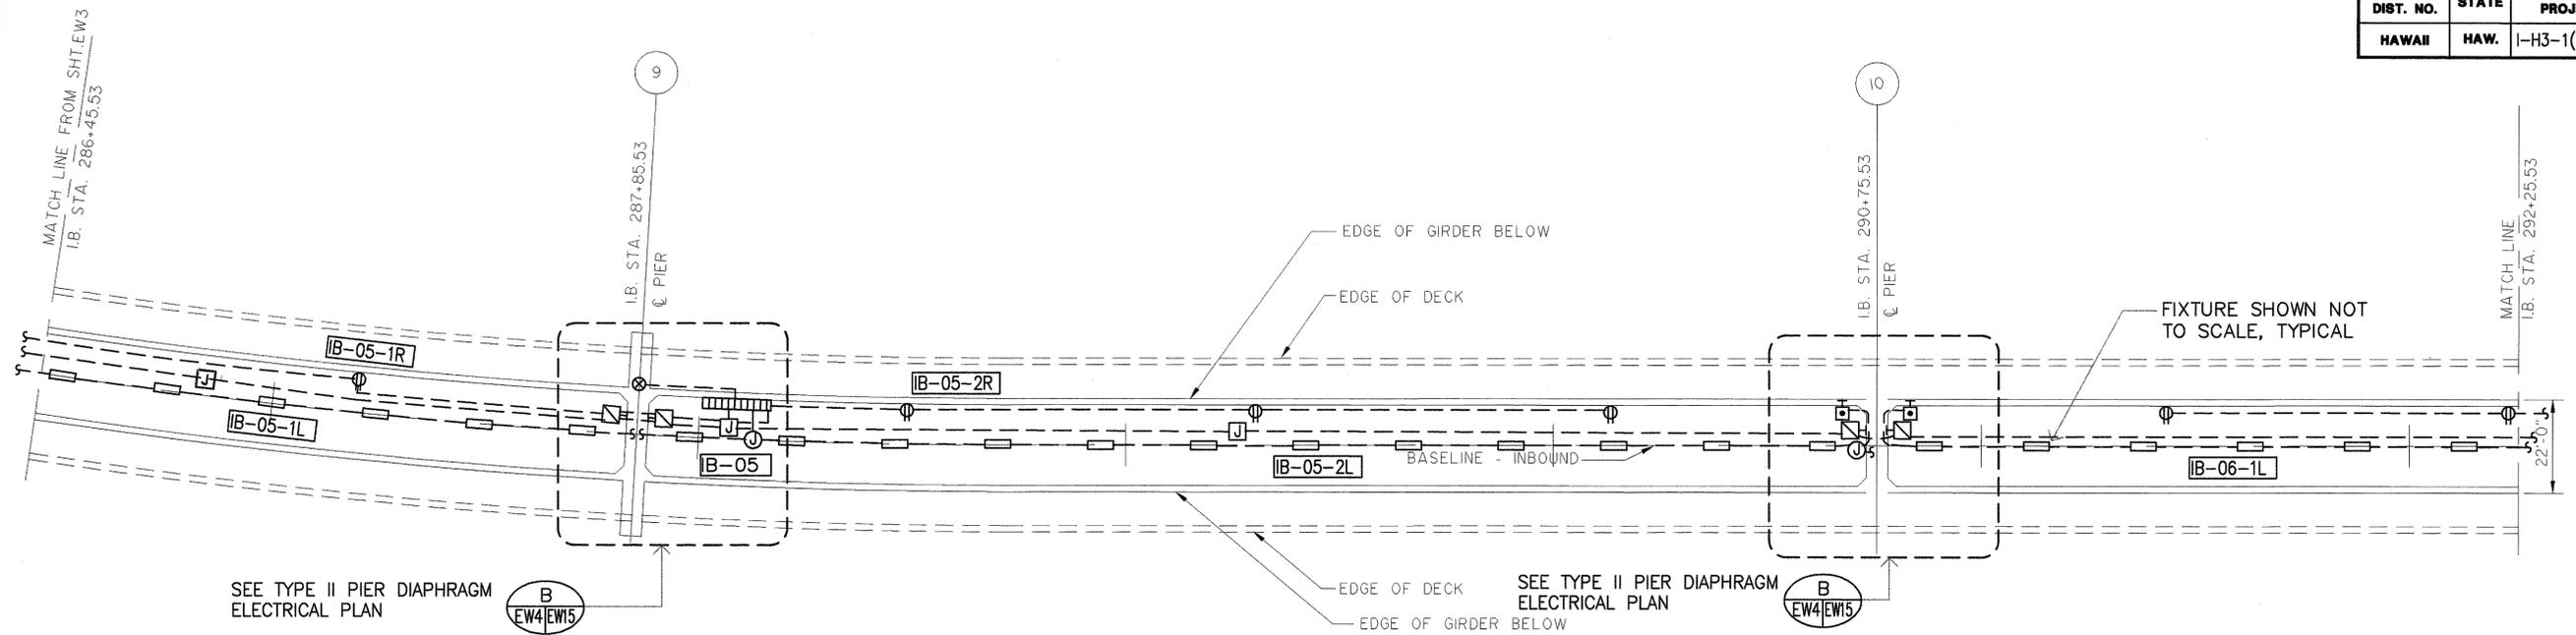


PARTIAL ELECTRICAL PLAN - INBOUND
SCALE: 1"=20'-0"

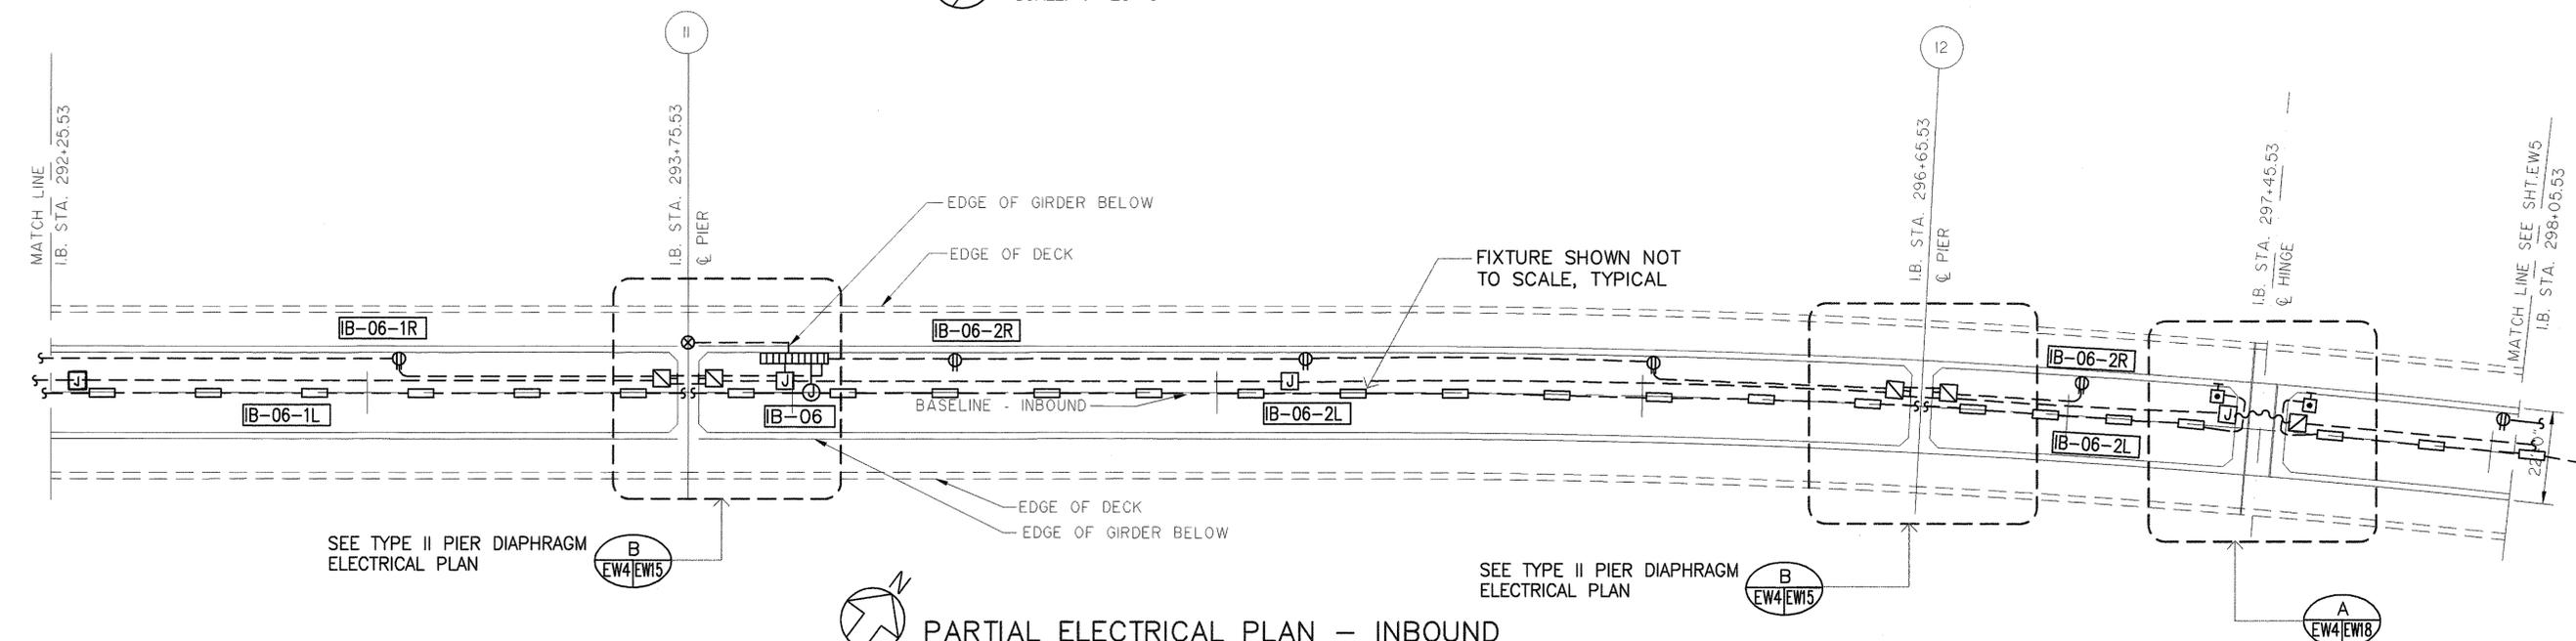

PARTIAL ELECTRICAL PLAN - INBOUND
SCALE: 1"=20'-0"


SURVEY PLOTTED BY	DATE
DRAWN BY	
DESIGNED BY	
QUANTITIES BY	
CHECKED BY	
ORIGINAL PLAN	
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No.	

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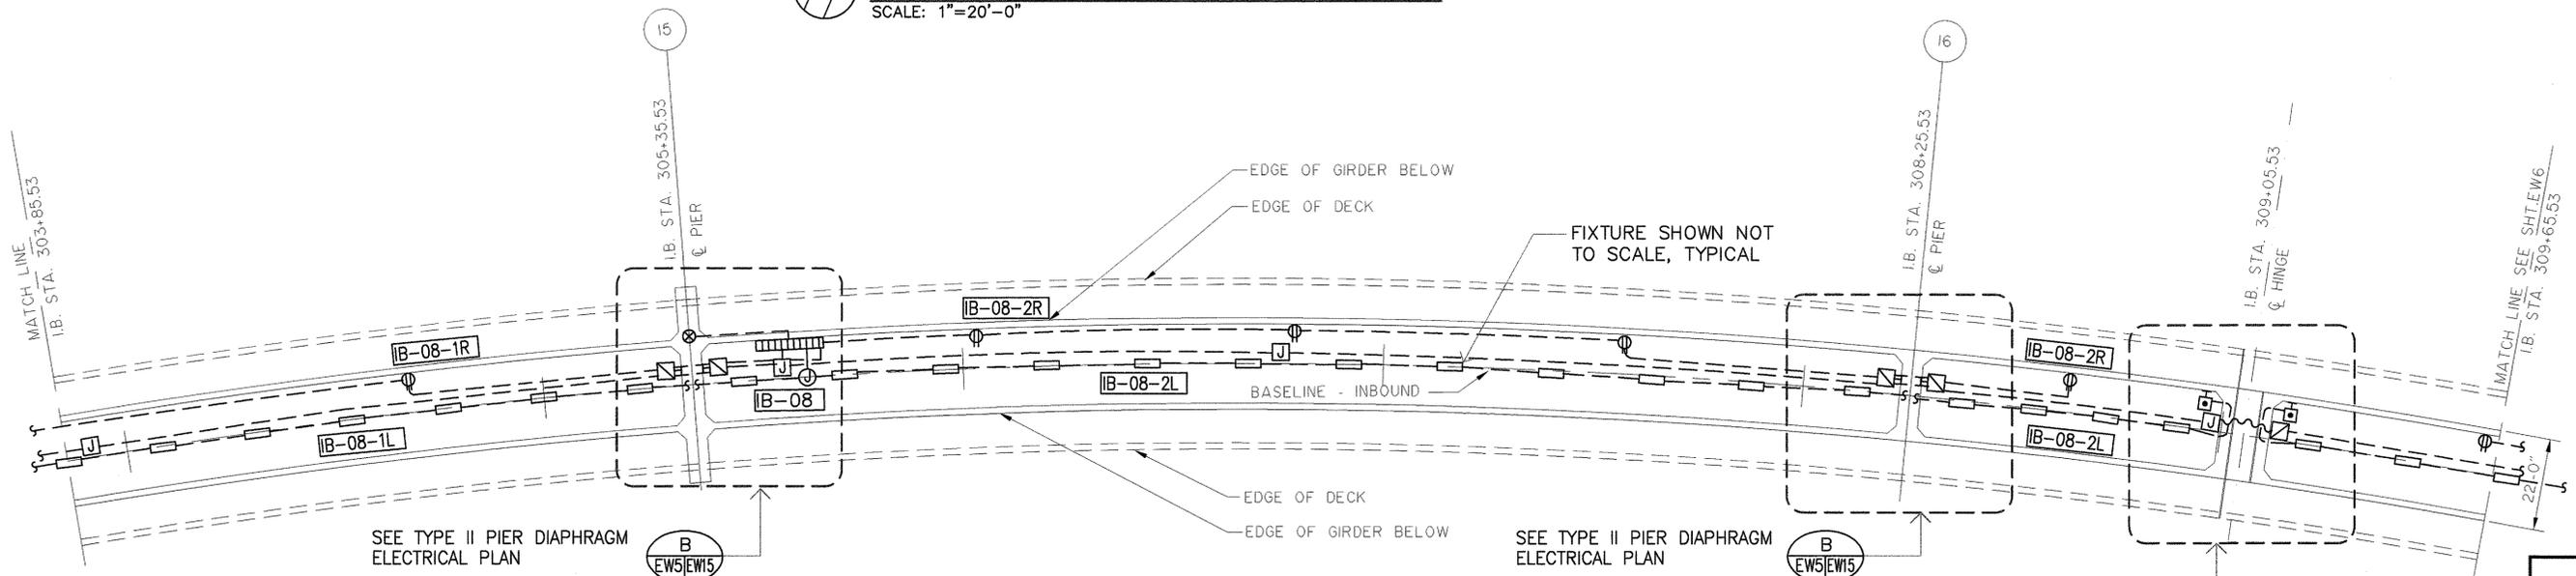


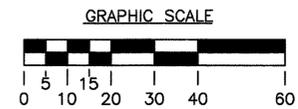STATE OF HAWAII
 DEPARTMENT OF TRANSPORTATION
 HIGHWAYS DIVISION
 WINDWARD VIADUCT
 PARTIAL ELEC PLANS-INBOUND
 INTERSTATE ROUTE H-3
 F.A.I. PROJECT NO. I-H3-1 (75) UNIT 1
 SCALE: AS NOTED DATE: JAN 1996
SHEET No. EW4 OF 19 SHEETS

FED. ROAD DIST. NO.	STATE	FED. AID PROJ. NO.	FISCAL YEAR	SHEET NO.	TOTAL SHEETS
HAWAII	HAW.	I-H3-1(75)UNIT1	1996	328	405

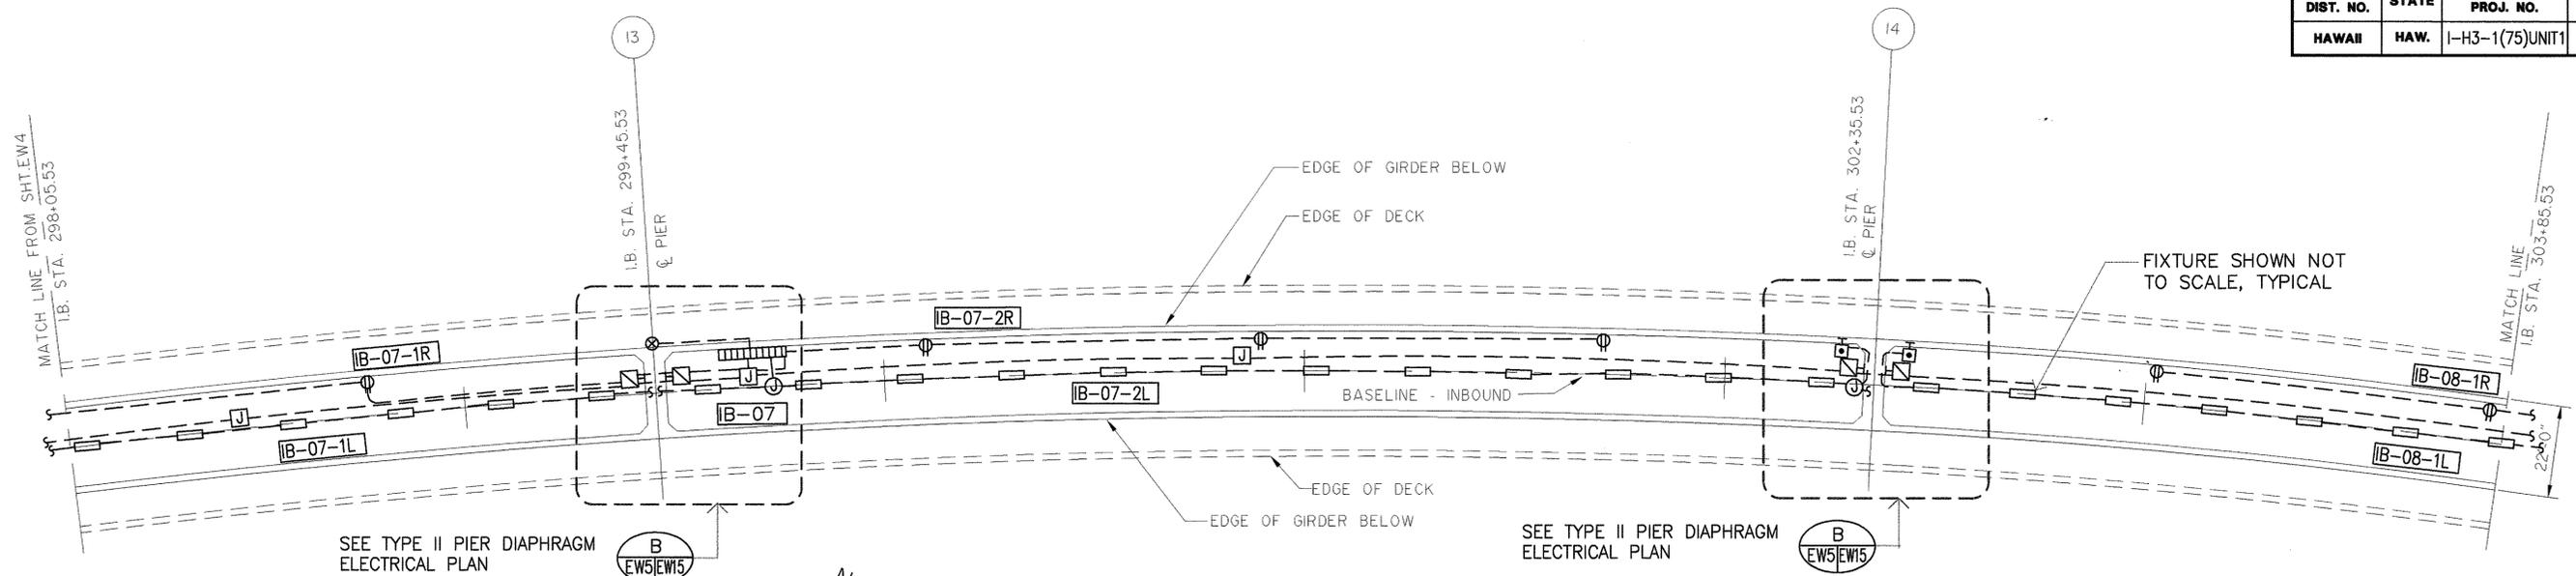


PARTIAL ELECTRICAL PLAN - INBOUND
SCALE: 1"=20'-0"



PARTIAL ELECTRICAL PLAN - INBOUND
SCALE: 1"=20'-0"

SURVEY PLOTTED BY	DATE
DRAWN BY	
DESIGNED BY	
QUANTITIES BY	
CHECKED BY	
ORIGINAL PLAN	No.
NOTEBOOK	

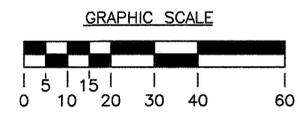

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HAWAII, U.S.A.

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STATE OF HAWAII
DEPARTMENT OF TRANSPORTATION
HIGHWAYS DIVISION

WINDWARD VIADUCT
PARTIAL ELEC PLANS-INBOUND


INTERSTATE ROUTE H-3
F.A.I. PROJECT NO. I-H3-1 (75) UNIT 1

SCALE: AS NOTED DATE: JAN 1996


SHEET No. EW5 OF 19 SHEETS

DATE	REVISION

FED. ROAD DIST. NO.	STATE	FED. AID PROJ. NO.	FISCAL YEAR	SHEET NO.	TOTAL SHEETS
HAWAII	HAW.	I-H3-1(75)UNIT1	1996	329	405

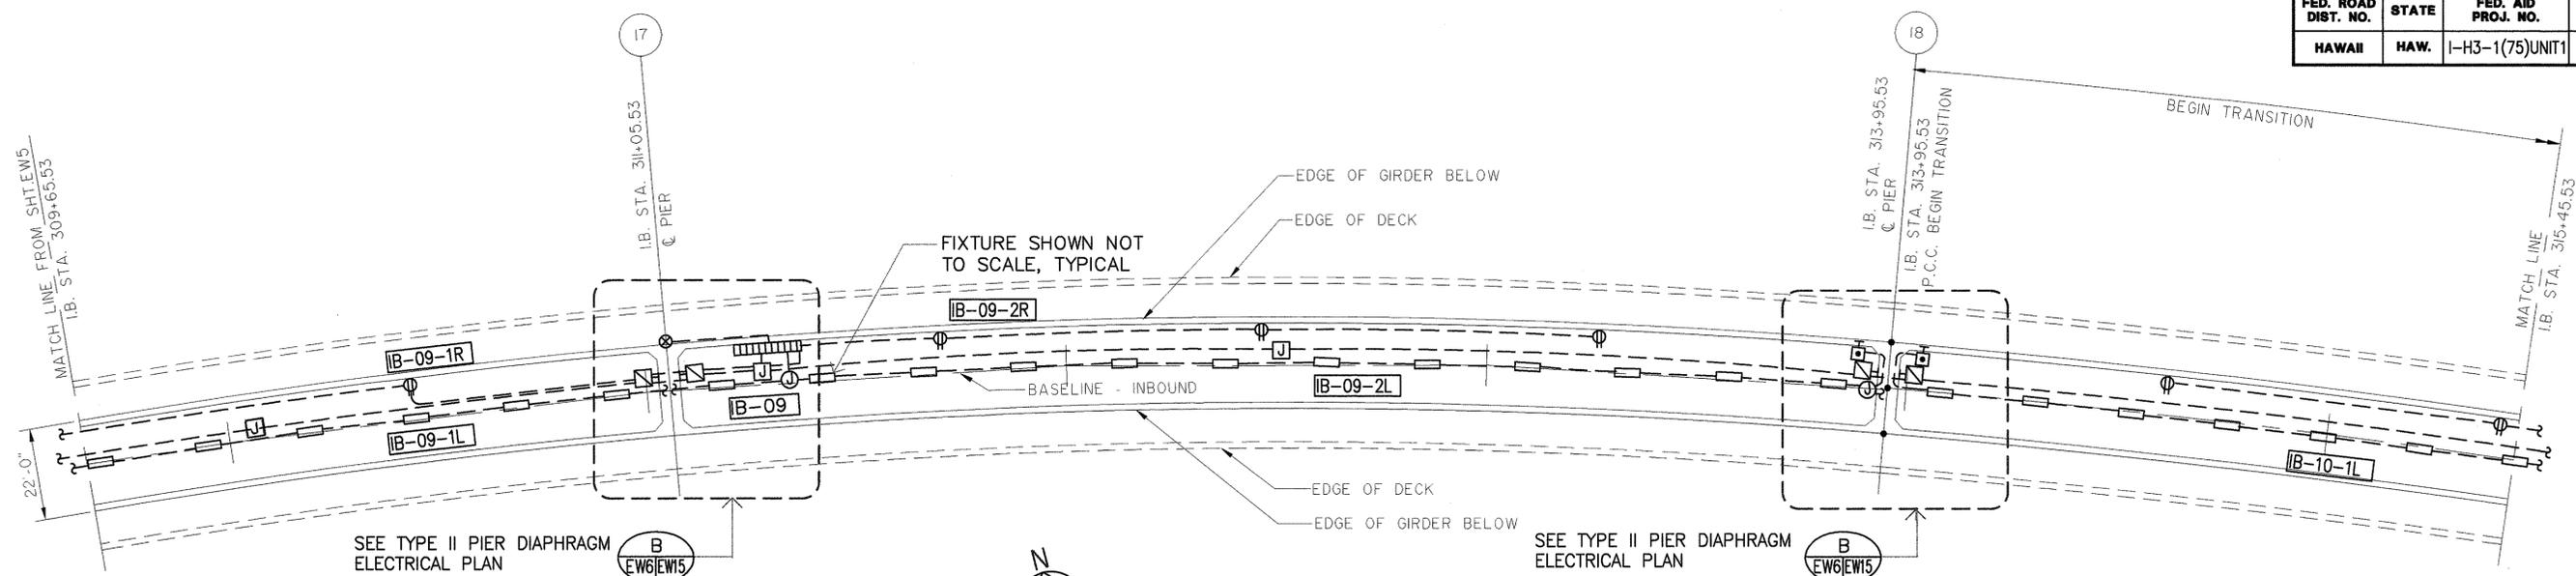

PARTIAL ELECTRICAL PLAN - INBOUND
SCALE: 1"=20'-0"

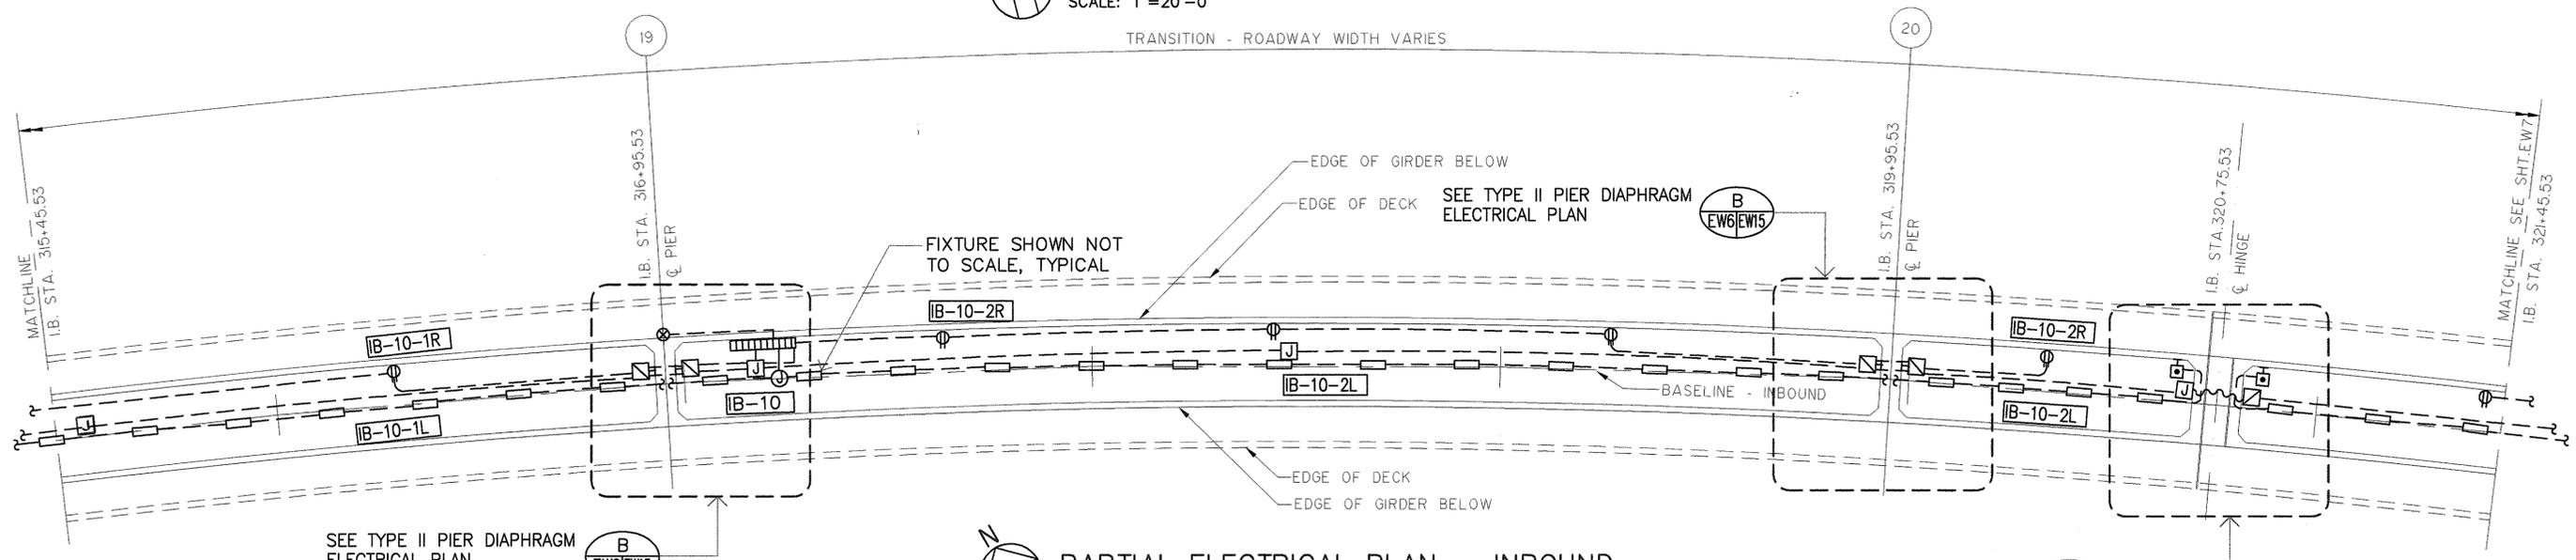


PARTIAL ELECTRICAL PLAN - INBOUND
SCALE: 1"=20'-0"

SURVEY PLOTTED BY	DATE
DRAWN BY	
TRACED BY	
QUANTITIES BY	
CHECKED BY	
ORIGINAL PLAN	
NO.	

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 NO. 4810-B
 HAWAII, U.S.A.

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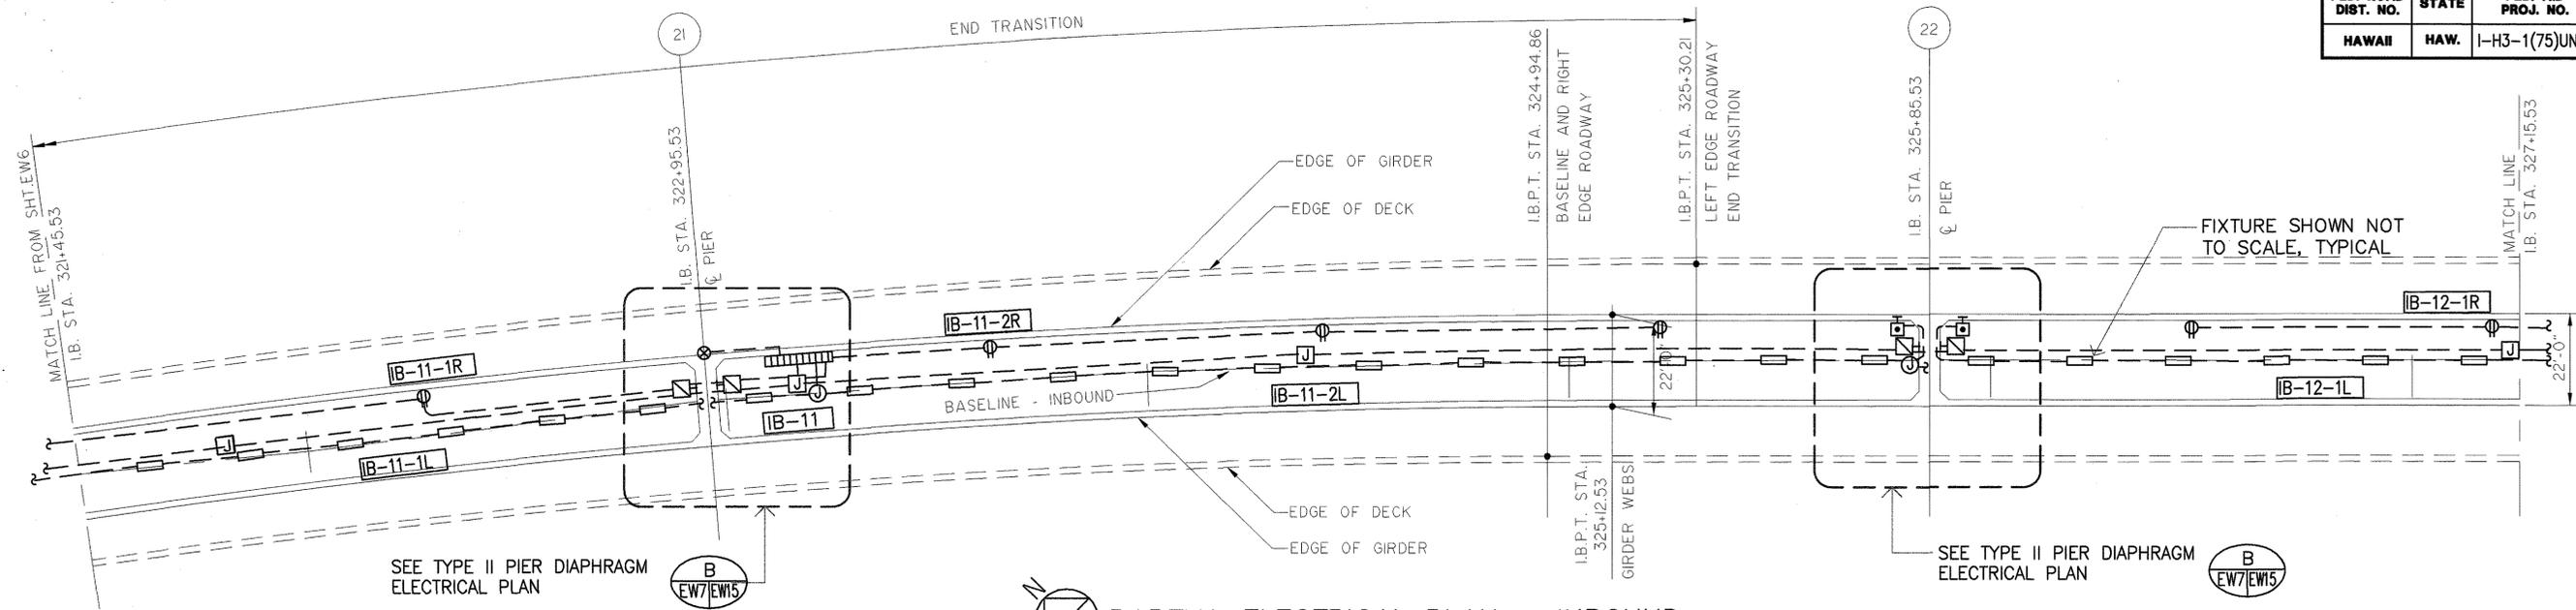
Glenn D. Oyam

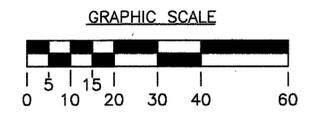


STATE OF HAWAII
 DEPARTMENT OF TRANSPORTATION
 HIGHWAYS DIVISION
 WINDWARD VIADUCT
PARTIAL ELEC PLANS-INBOUND
 INTERSTATE ROUTE H-3
 F.A.I. PROJECT NO. I-H3-1 (75) UNIT 1
 SCALE: AS NOTED DATE: JAN 1996
SHEET No. EW6 OF 19 SHEETS

DATE	REVISION
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FED. ROAD DIST. NO.	STATE	FED. AID PROJ. NO.	FISCAL YEAR	SHEET NO.	TOTAL SHEETS
HAWAII	HAW.	I-H3-1(75)UNIT1	1996	330	405




PARTIAL ELECTRICAL PLAN - INBOUND
SCALE: 1"=20'-0"

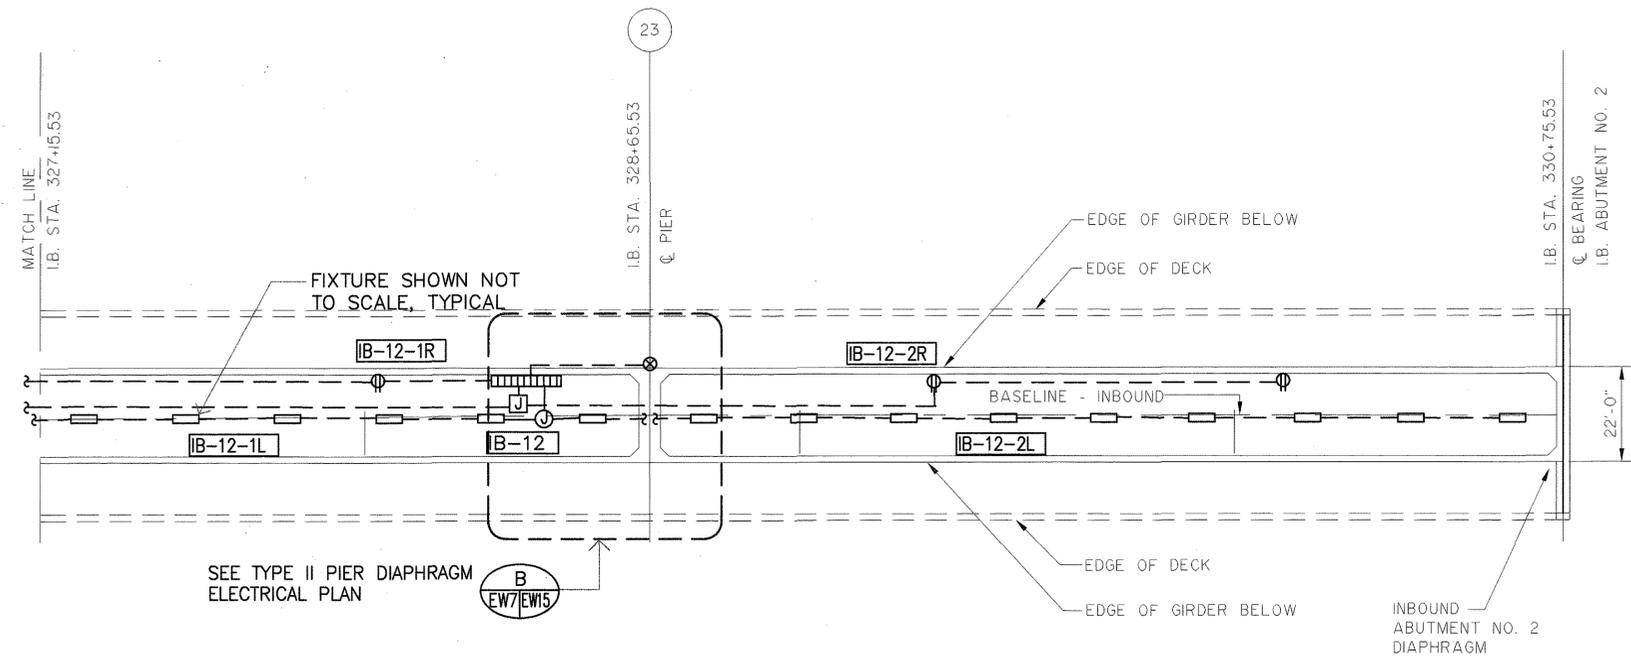

PARTIAL ELECTRICAL PLAN - INBOUND
SCALE: 1"=20'-0"

SURVEY PLOTTED BY	DATE
DRAWN BY	
DESIGNED BY	
QUANTITIES BY	
CHECKED BY	
ORIGINAL PLAN	No.
NOTEBOOK	

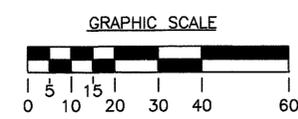

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NO. 4810-S
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STATE OF HAWAII
DEPARTMENT OF TRANSPORTATION
HIGHWAYS DIVISION

WINDWARD VIADUCT
PARTIAL ELEC PLANS-INBOUND


INTERSTATE ROUTE H-3
F.A.I. PROJECT NO. I-H3-1 (75) UNIT 1

SCALE: AS NOTED DATE: JAN 1996


SHEET No. EW 07 OF 19 SHEETS

DATE	REVISION

FED. ROAD DIST. NO.	STATE	FED. AID PROJ. NO.	FISCAL YEAR	SHEET NO.	TOTAL SHEETS
HAWAII	HAW.	I-H3-1(75)UNIT1	1996	331	405

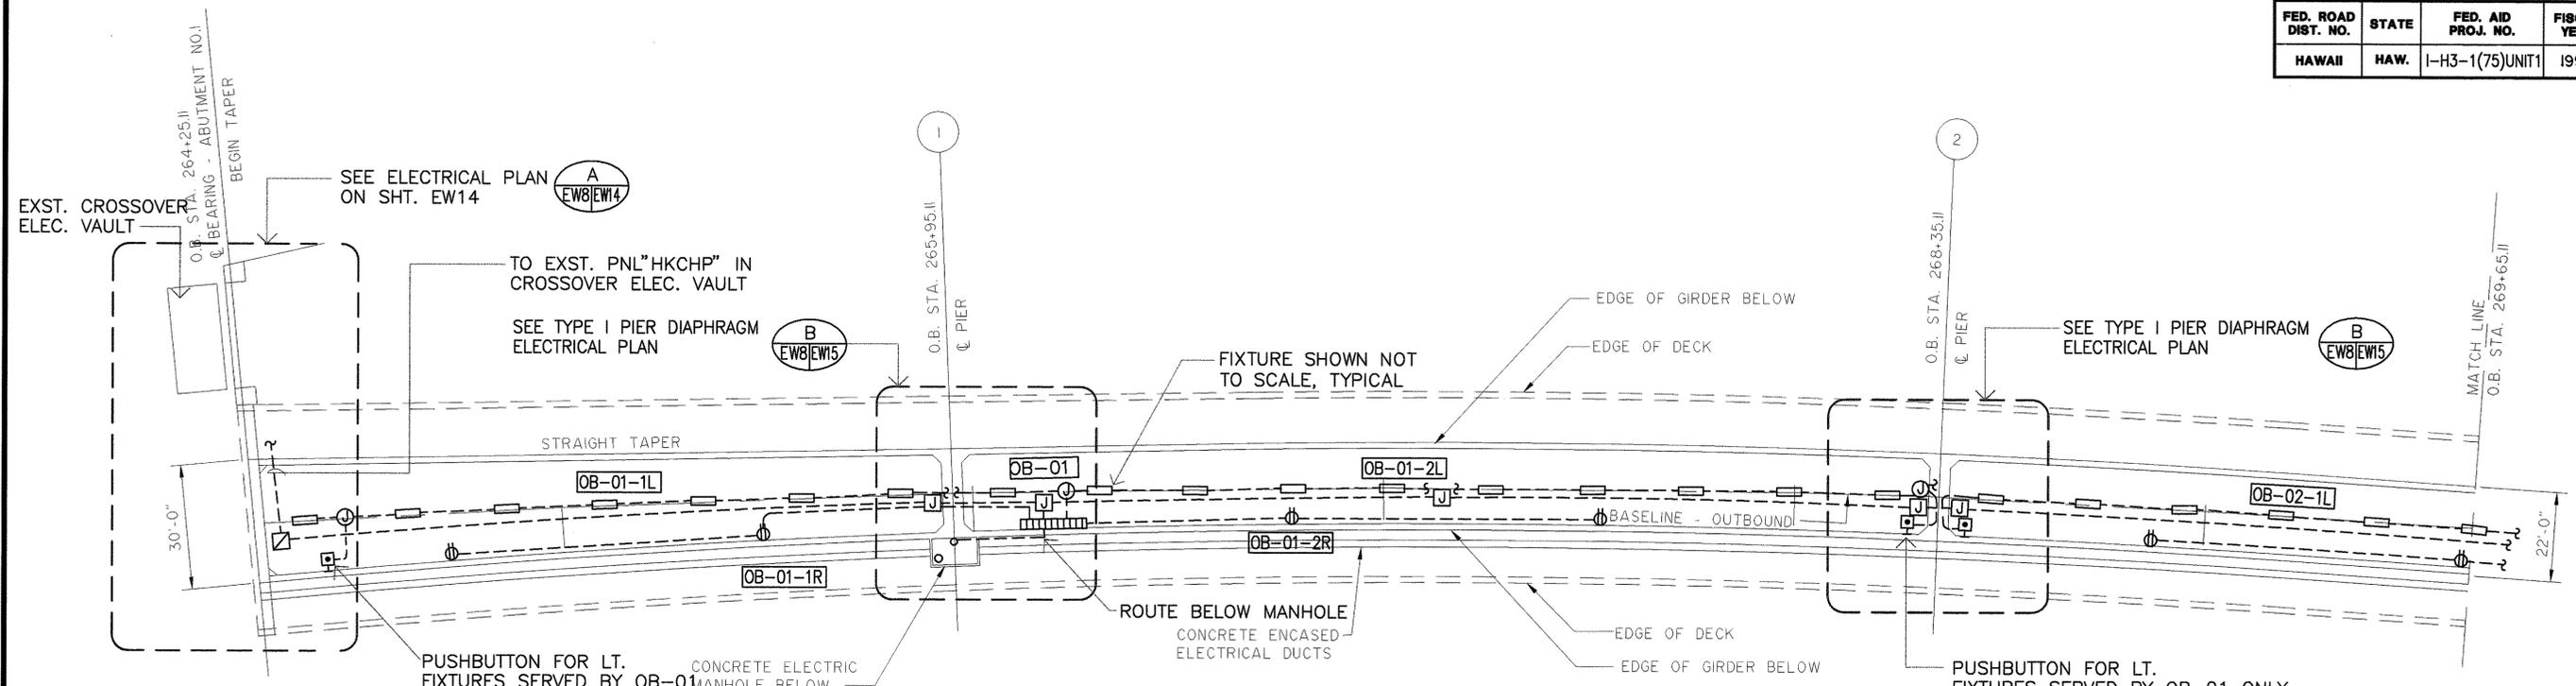


PARTIAL ELECTRICAL PLAN - OUTBOUND
SCALE: 1"=20'-0"

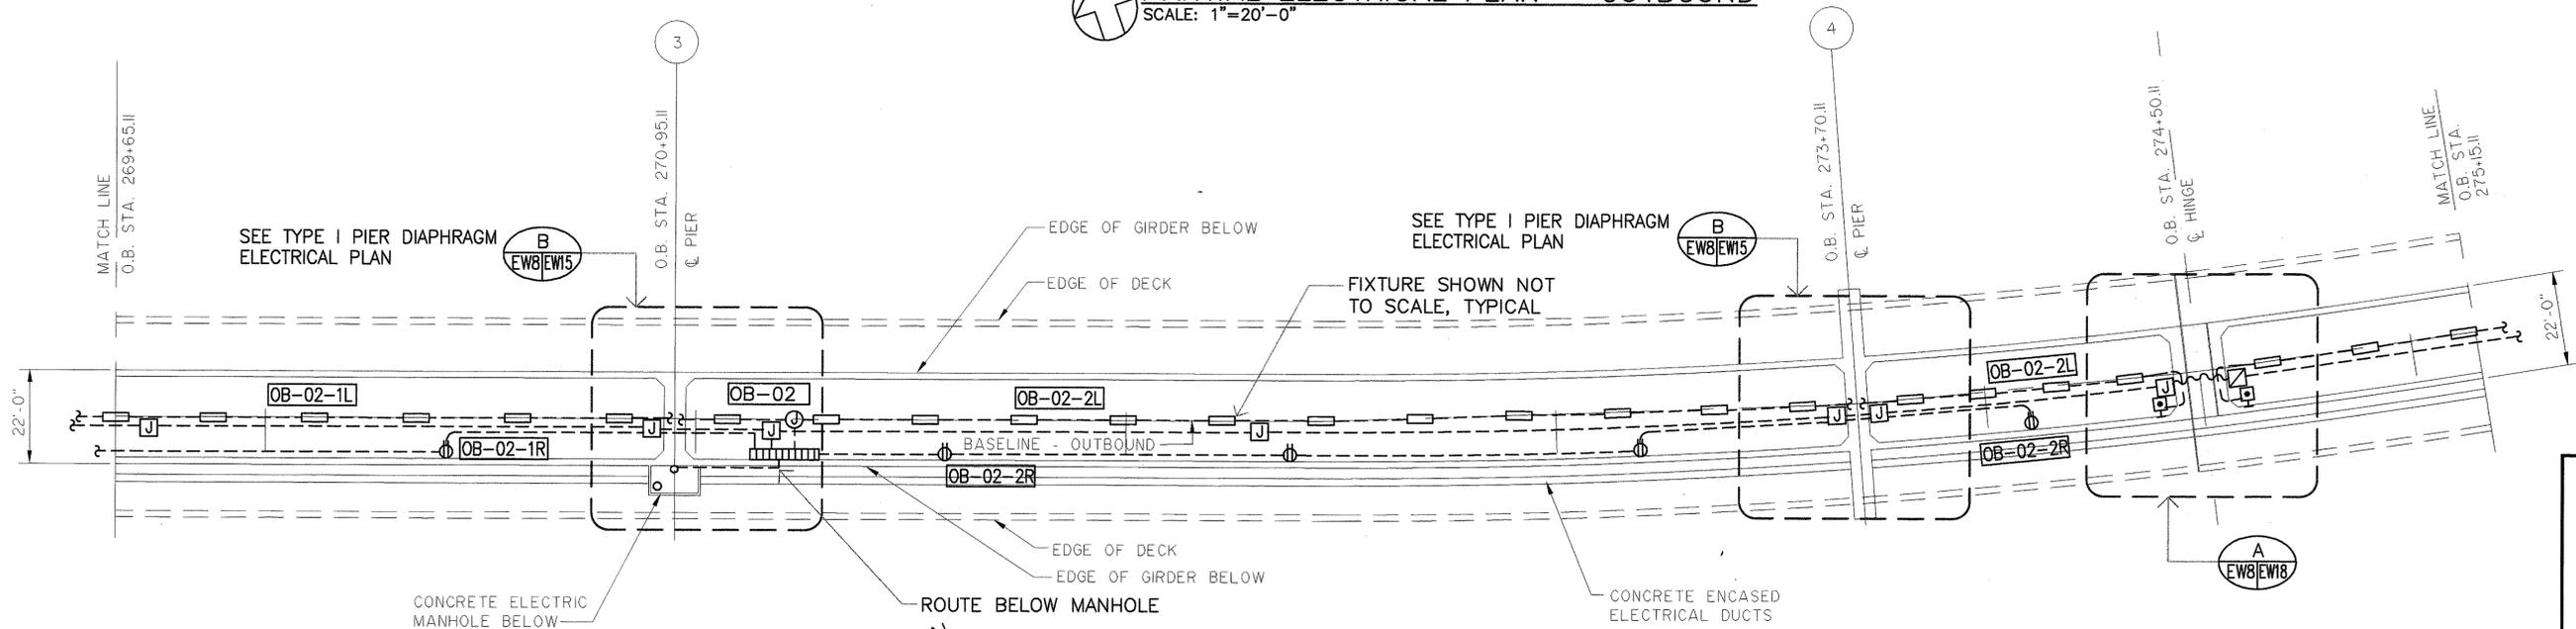

PARTIAL ELECTRICAL PLAN - OUTBOUND
SCALE: 1"=20'-0"

SURVEY PLOTTED BY	DATE
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DESIGNED BY	
QUANTITIES BY	
CHECKED BY	
ORIGINAL PLAN	
NOTED BY	
No.	

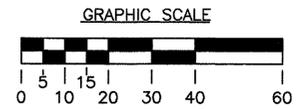

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NO. 4210-B
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Glenn D. Oyaki

STATE OF HAWAII
DEPARTMENT OF TRANSPORTATION
HIGHWAYS DIVISION

WINDWARD VIADUCT
PARTIAL ELEC PLANS-OUTBOUND


INTERSTATE ROUTE H-3
F.A.I. PROJECT NO. I-H3-1 (75) UNIT 1

SCALE: AS NOTED DATE: JAN 1996


SHEET No. EW8 OF 19 SHEETS

DATE	REVISION

FED. ROAD DIST. NO.	STATE	FED. AID PROJ. NO.	FISCAL YEAR	SHEET NO.	TOTAL SHEETS
HAWAII	HAW.	I-H3-1(75)UNIT1	1996	332	405

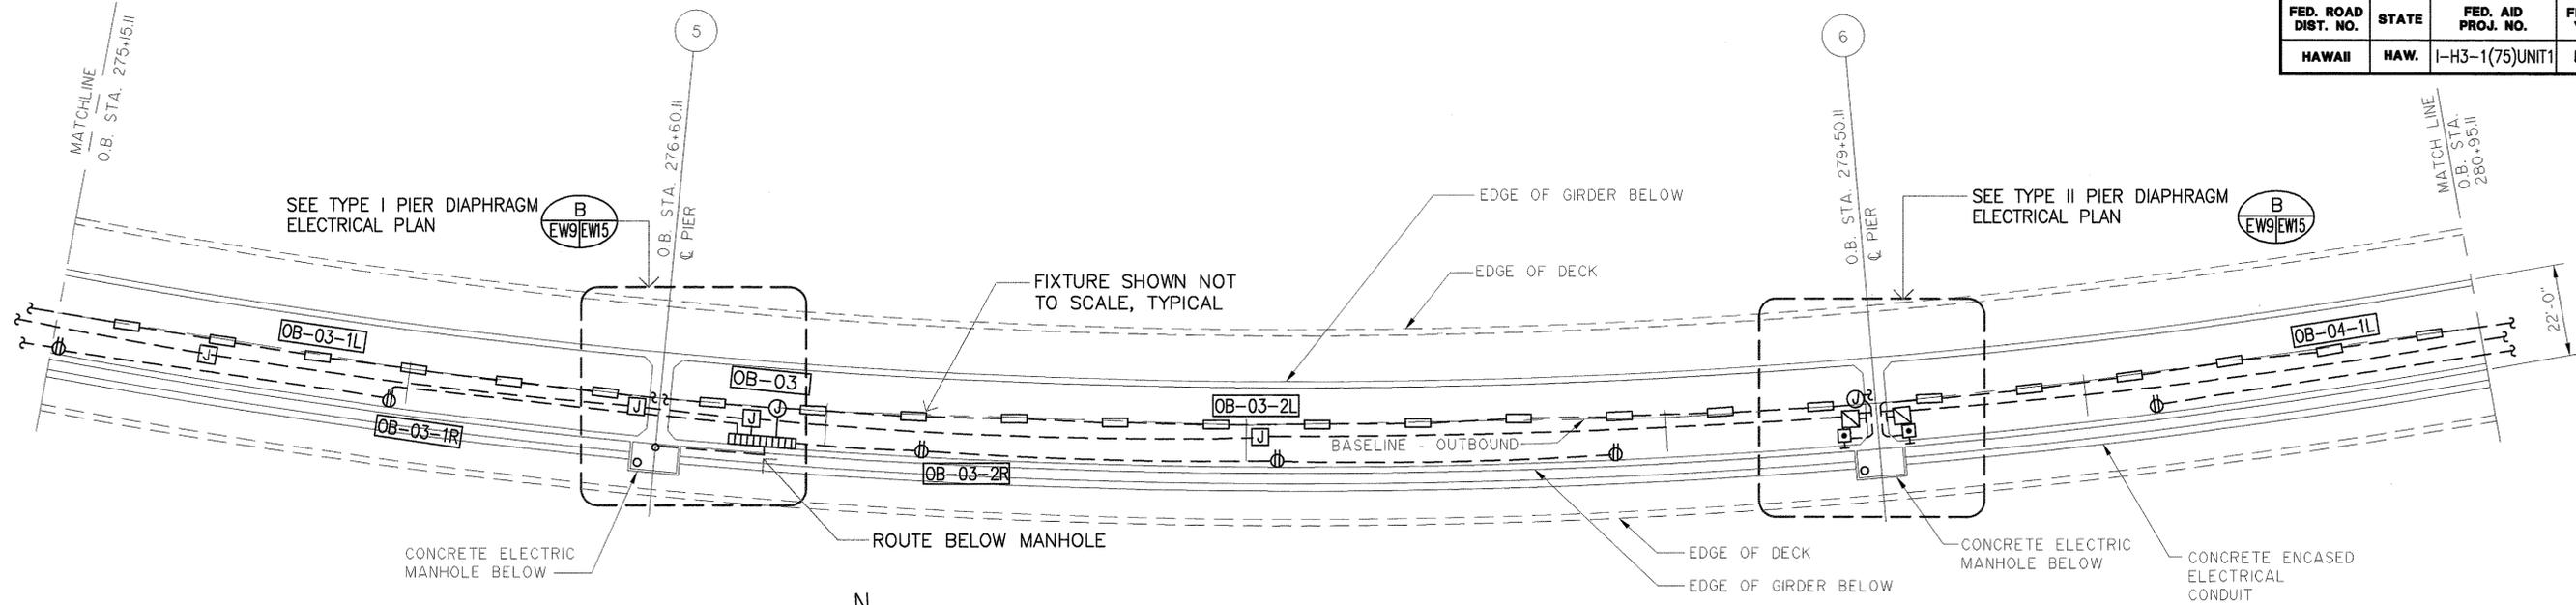


PARTIAL ELECTRICAL PLAN - OUTBOUND
SCALE: 1"=20'-0"

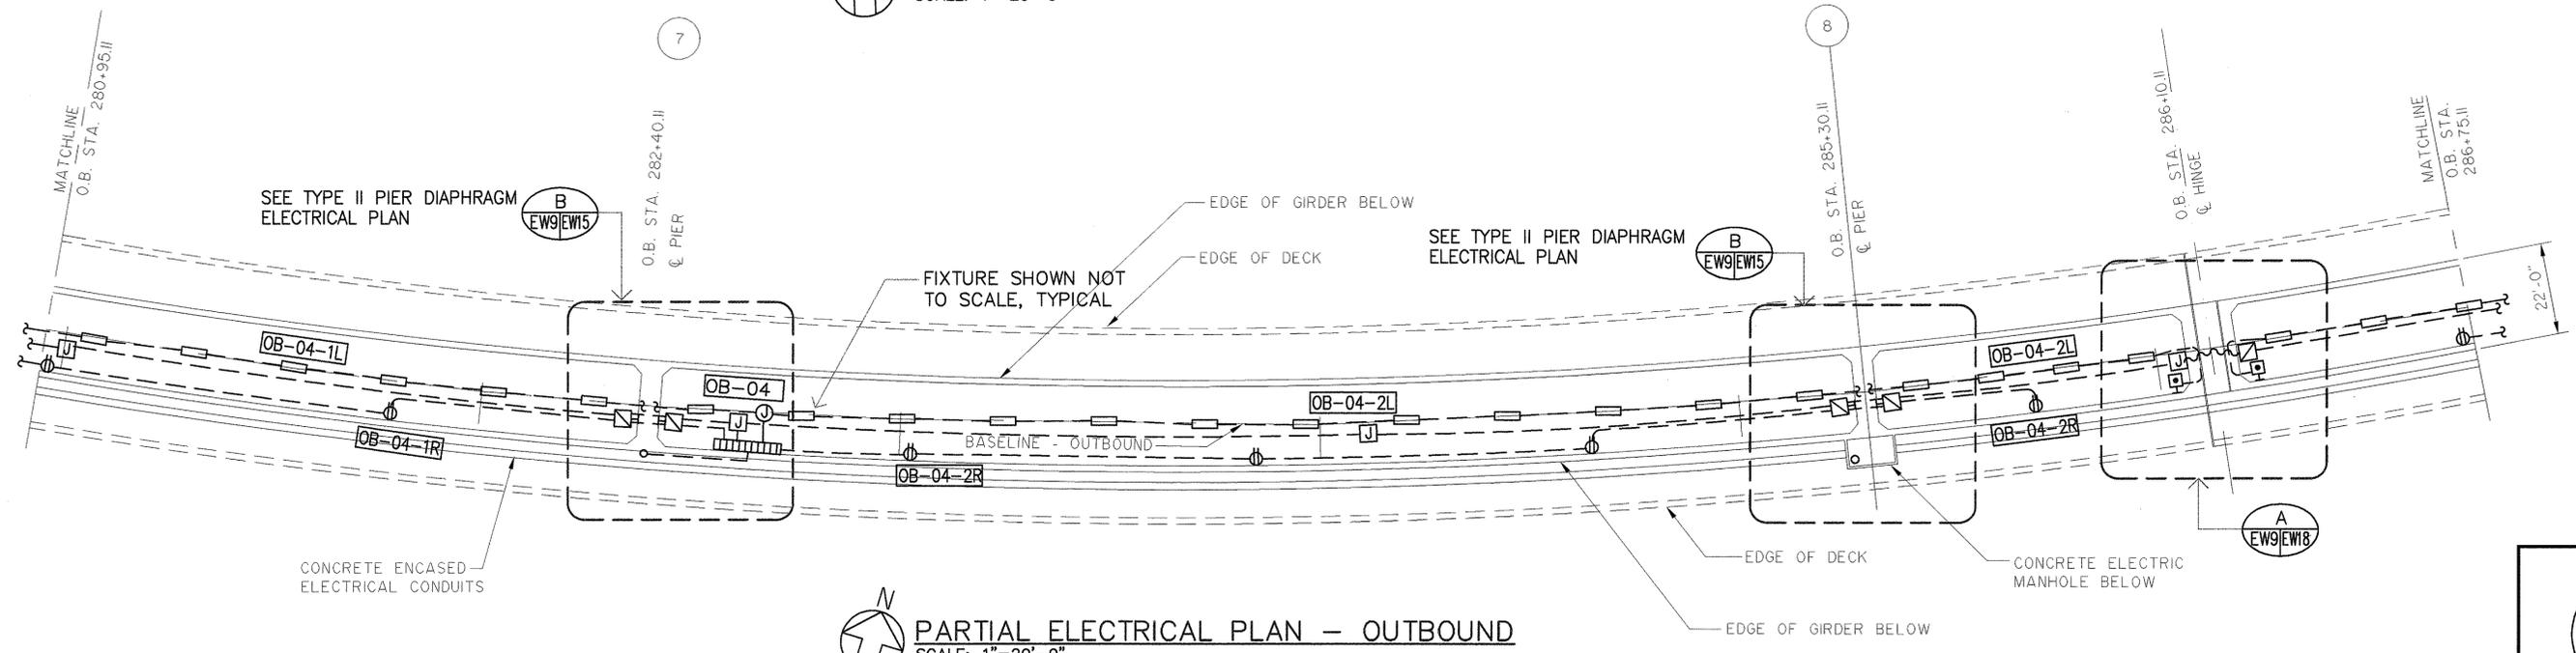

PARTIAL ELECTRICAL PLAN - OUTBOUND
SCALE: 1"=20'-0"

SURVEY PLOTTED BY	DATE
DRAWN BY	
DESIGNED BY	
QUANTITIES BY	
CHECKED BY	
ORIGINAL PLAN	
NO. _____	

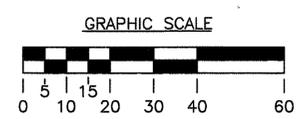

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HAWAII, U.S.A.

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STATE OF HAWAII
DEPARTMENT OF TRANSPORTATION
HIGHWAYS DIVISION

WINDWARD VIADUCT
PARTIAL ELEC PLANS-OUTBOUND


INTERSTATE ROUTE H-3
F.A.I. PROJECT NO. I-H3-1 (75) UNIT 1

SCALE: AS NOTED DATE: JAN 1996


SHEET No. EW9 OF 19 SHEETS

DATE	REVISION

FED. ROAD DIST. NO.	STATE	FED. AID PROJ. NO.	FISCAL YEAR	SHEET NO.	TOTAL SHEETS
HAWAII	HAW.	I-H3-1(75)UNIT1	1996	333	405

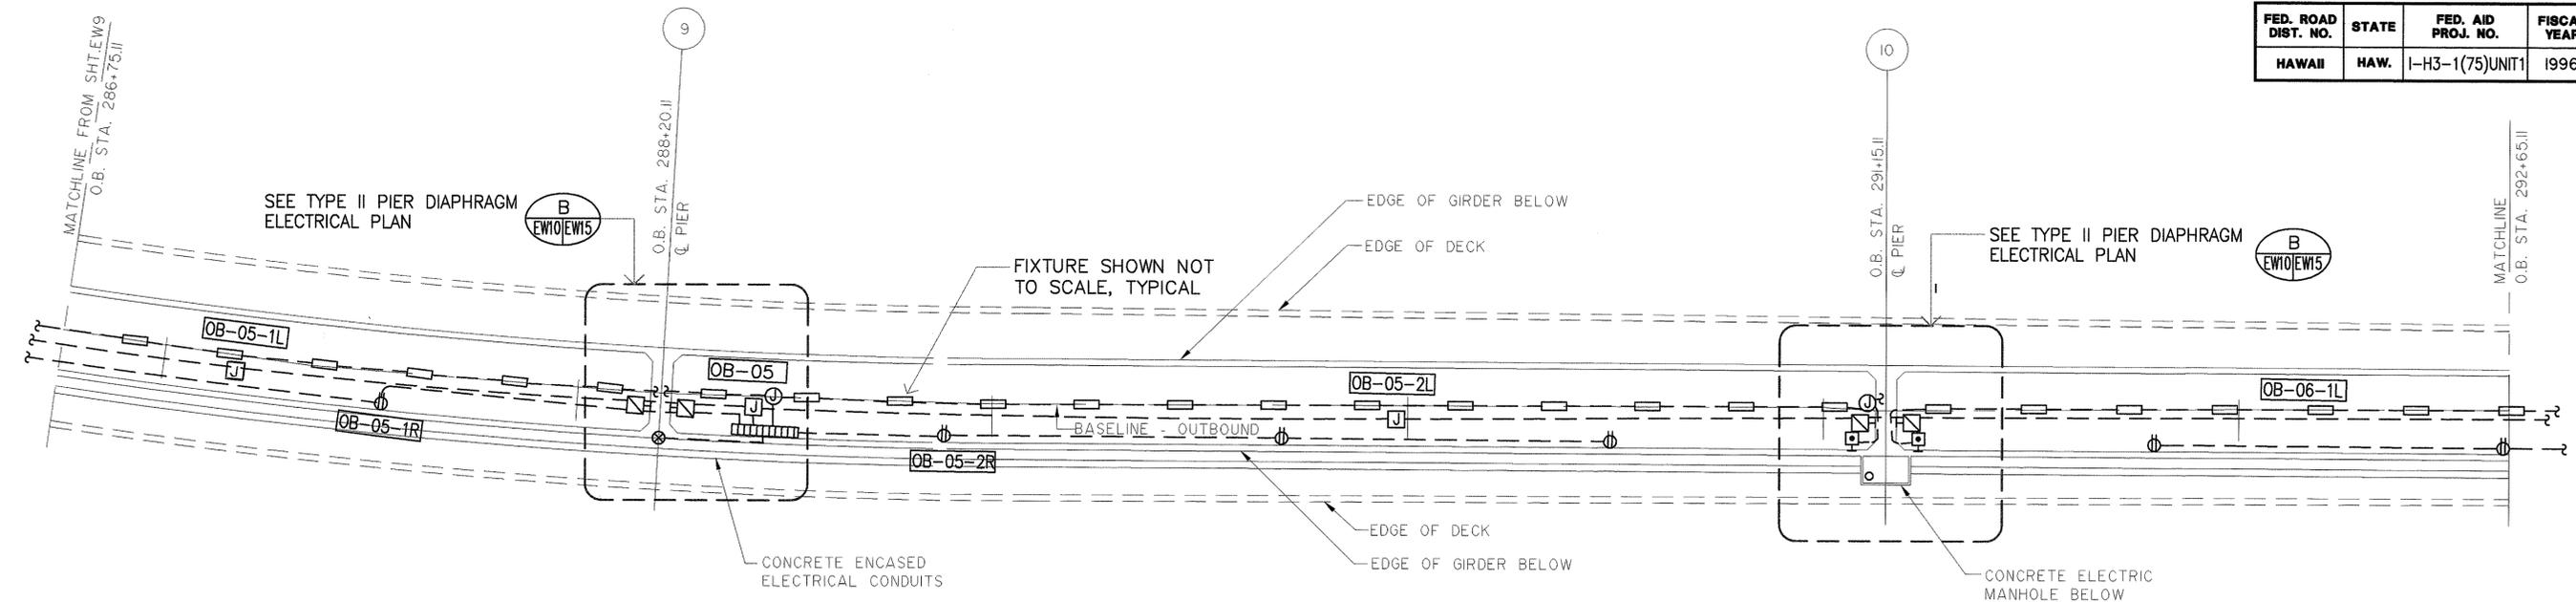


PARTIAL ELECTRICAL PLAN - OUTBOUND
SCALE: 1"=20'-0"

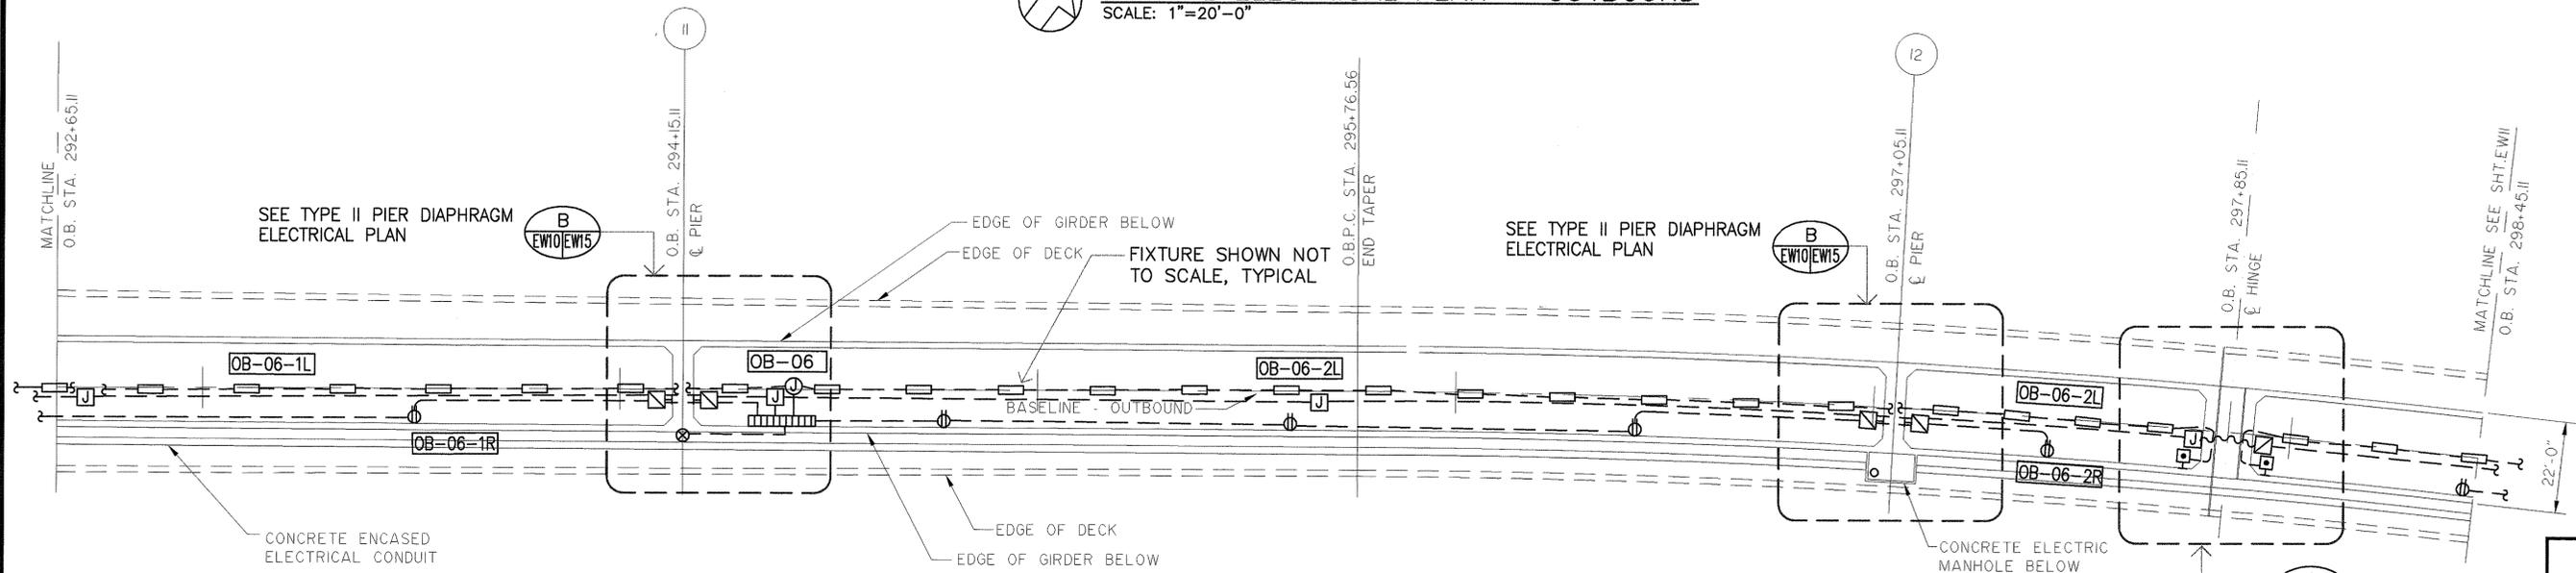

PARTIAL ELECTRICAL PLAN - OUTBOUND
SCALE: 1"=20'-0"

SURVEY PLOTTED BY	DATE
DRAWN BY	
DESIGNED BY	
QUANTITIES BY	
CHECKED BY	
ORIGINAL PLAN	
NOTEBOOK	
NO.	

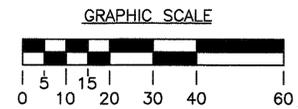

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STATE OF HAWAII
DEPARTMENT OF TRANSPORTATION
HIGHWAYS DIVISION

WINDWARD VIADUCT

PARTIAL ELEC PLANS-OUTBOUND


INTERSTATE ROUTE H-3
F.A.I. PROJECT NO. I-H3-1 (75) UNIT 1

SCALE: AS NOTED DATE: JAN 1996


SHEET No. EWO OF 19 SHEETS

DATE	REVISION

FED. ROAD DIST. NO.	STATE	FED. AID PROJ. NO.	FISCAL YEAR	SHEET NO.	TOTAL SHEETS
HAWAII	HAW.	I-H3-1(75)UNIT1	1996	334	405

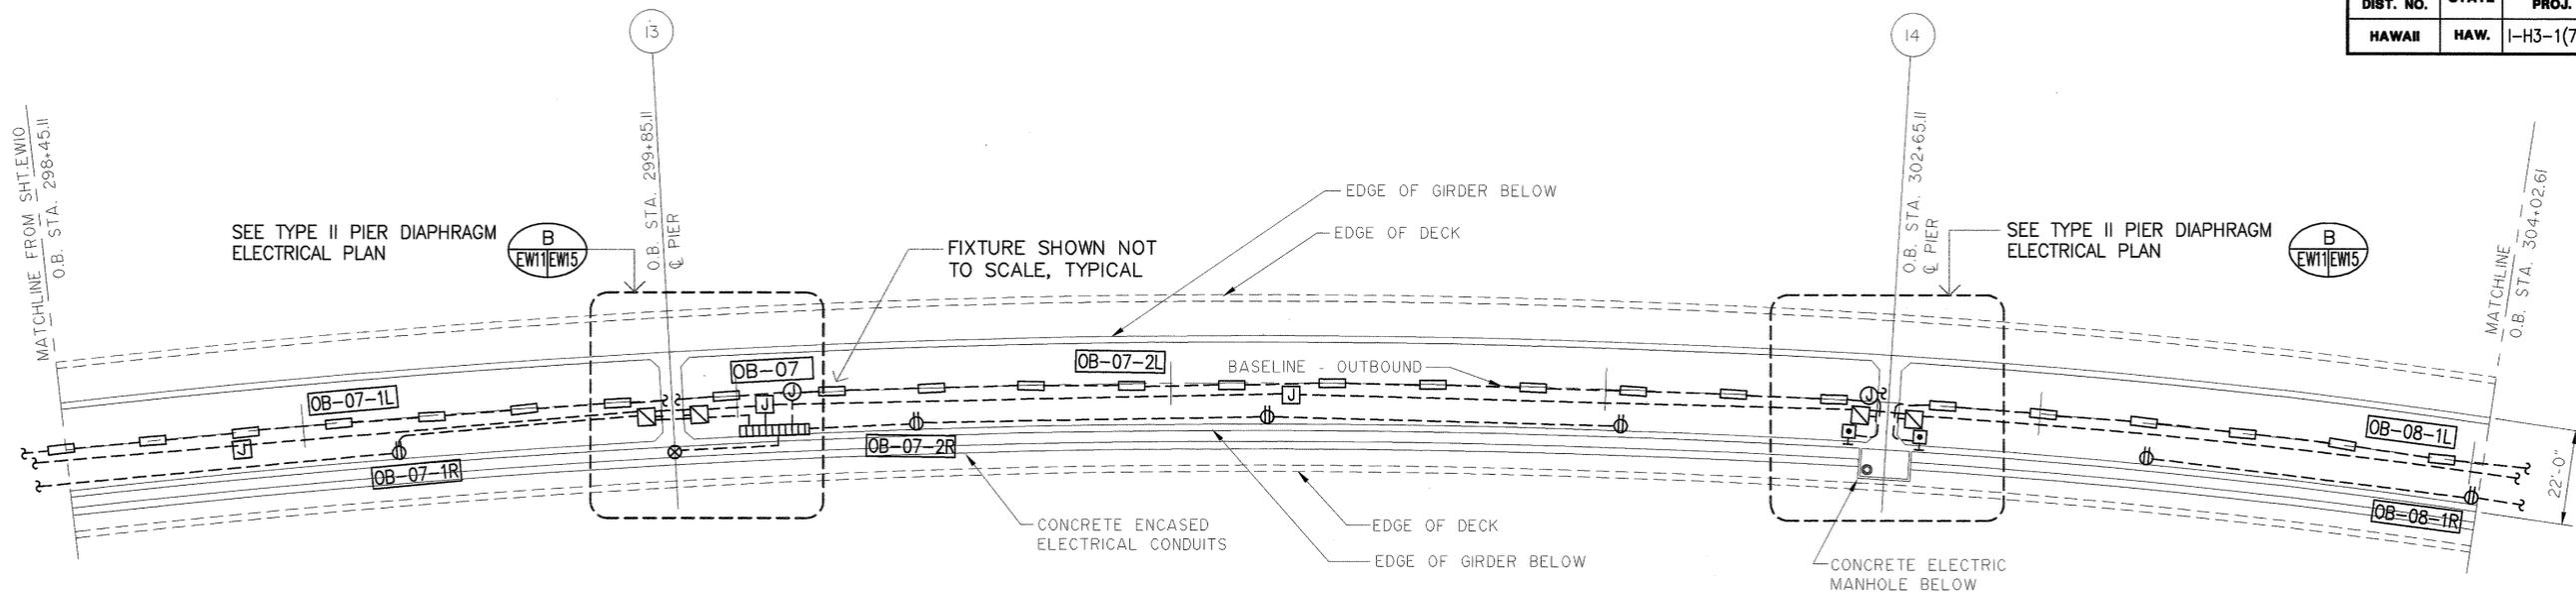


PARTIAL ELECTRICAL PLAN - OUTBOUND
SCALE: 1"=20'-0"

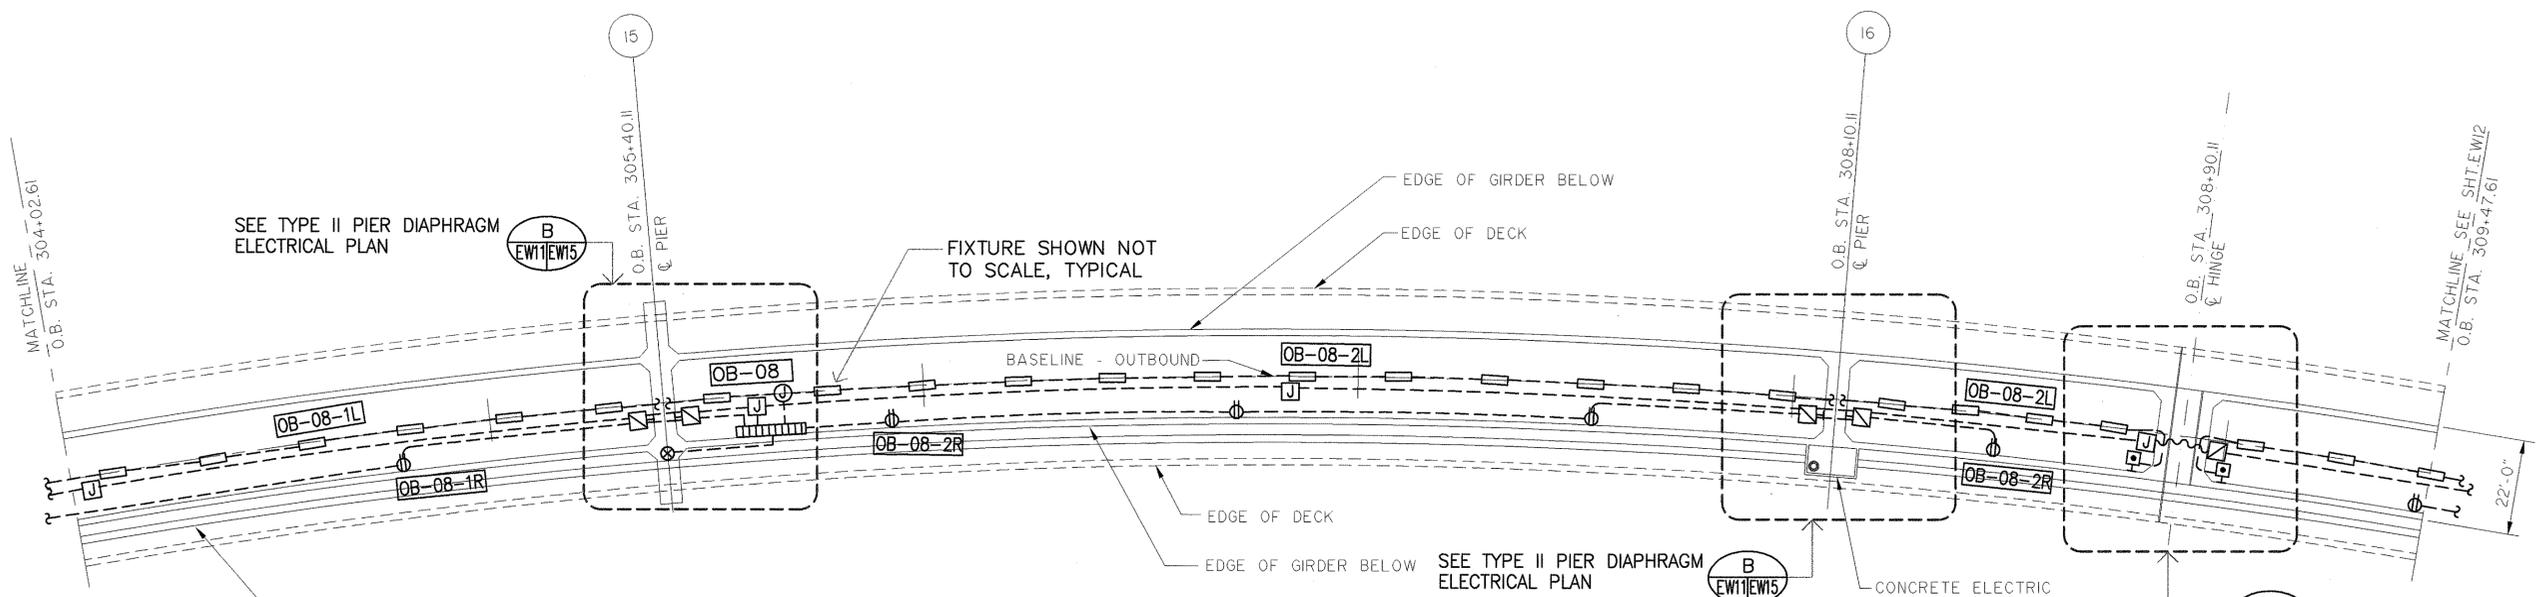

PARTIAL ELECTRICAL PLAN - OUTBOUND
SCALE: 1"=20'-0"

SURVEY PLOTTED BY	DATE
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QUANTITIES BY	
CHECKED BY	
ORIGINAL PLAN	
NOTEBOOK	
No.	

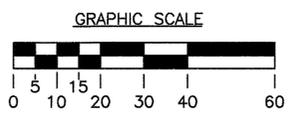

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HAWAII, U.S.A.

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Glen D. Oyaki

STATE OF HAWAII
DEPARTMENT OF TRANSPORTATION
HIGHWAYS DIVISION

WINDWARD VIADUCT
PARTIAL ELEC PLANS-OUTBOUND


INTERSTATE ROUTE H-3
F.A.I. PROJECT NO. I-H3-1 (75) UNIT 1

SCALE: AS NOTED DATE: JAN 1996


SHEET No. EW1 OF 19 SHEETS

DATE	REVISION

FED. ROAD DIST. NO.	STATE	FED. AID PROJ. NO.	FISCAL YEAR	SHEET NO.	TOTAL SHEETS
HAWAII	HAW.	I-H3-1(75)UNIT1	1996	335	405

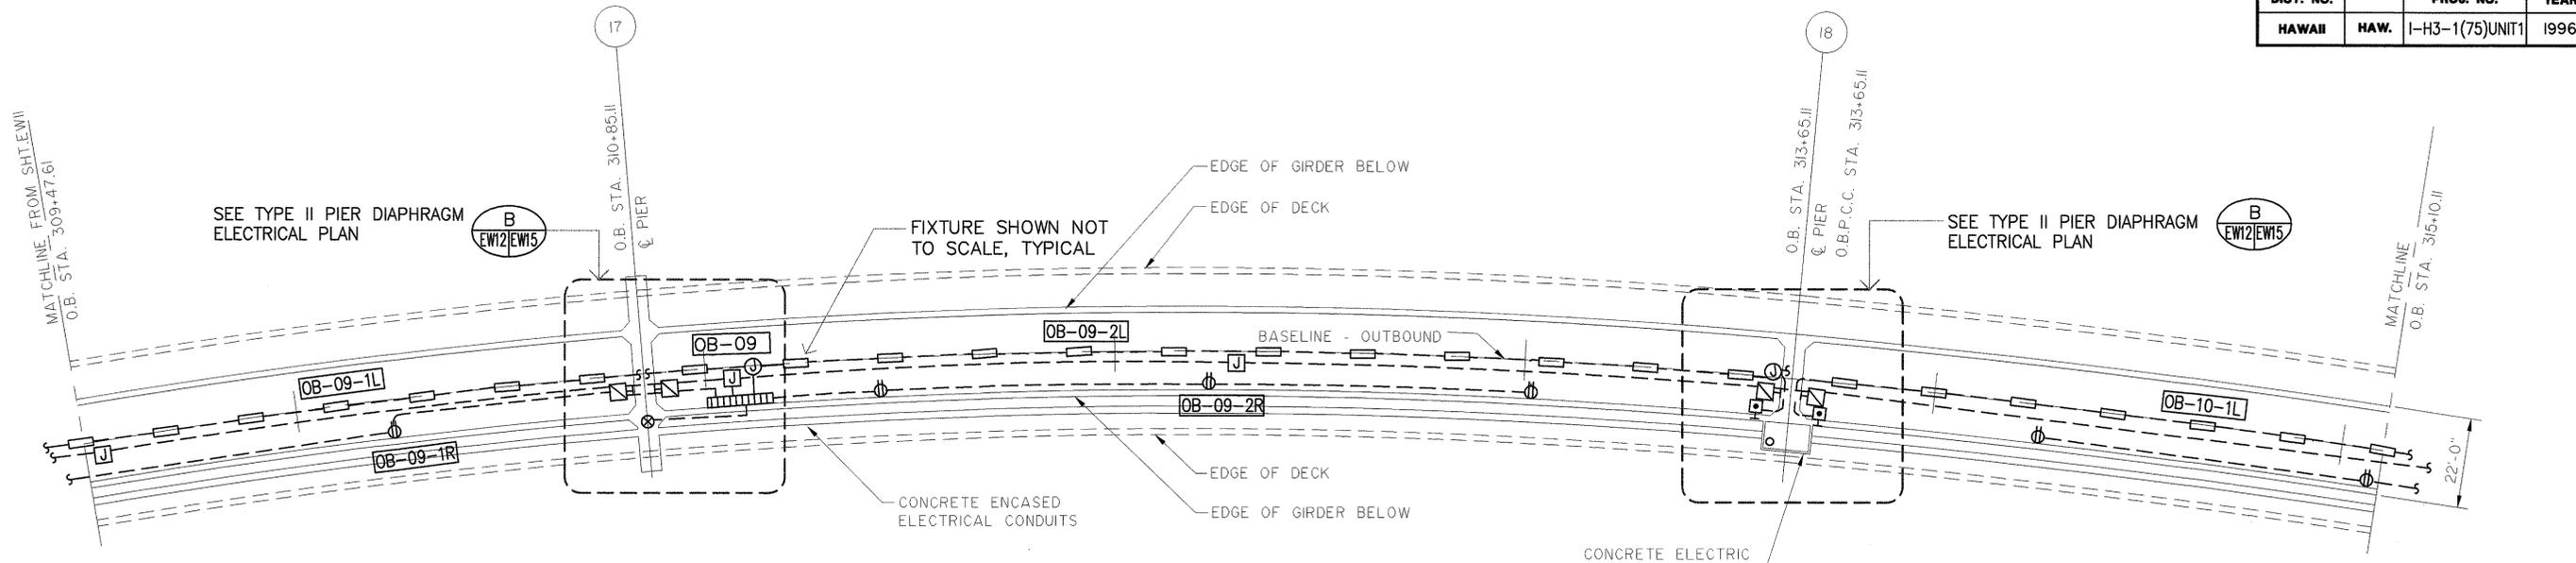


PARTIAL ELECTRICAL PLAN - OUTBOUND
SCALE: 1"=20'-0"

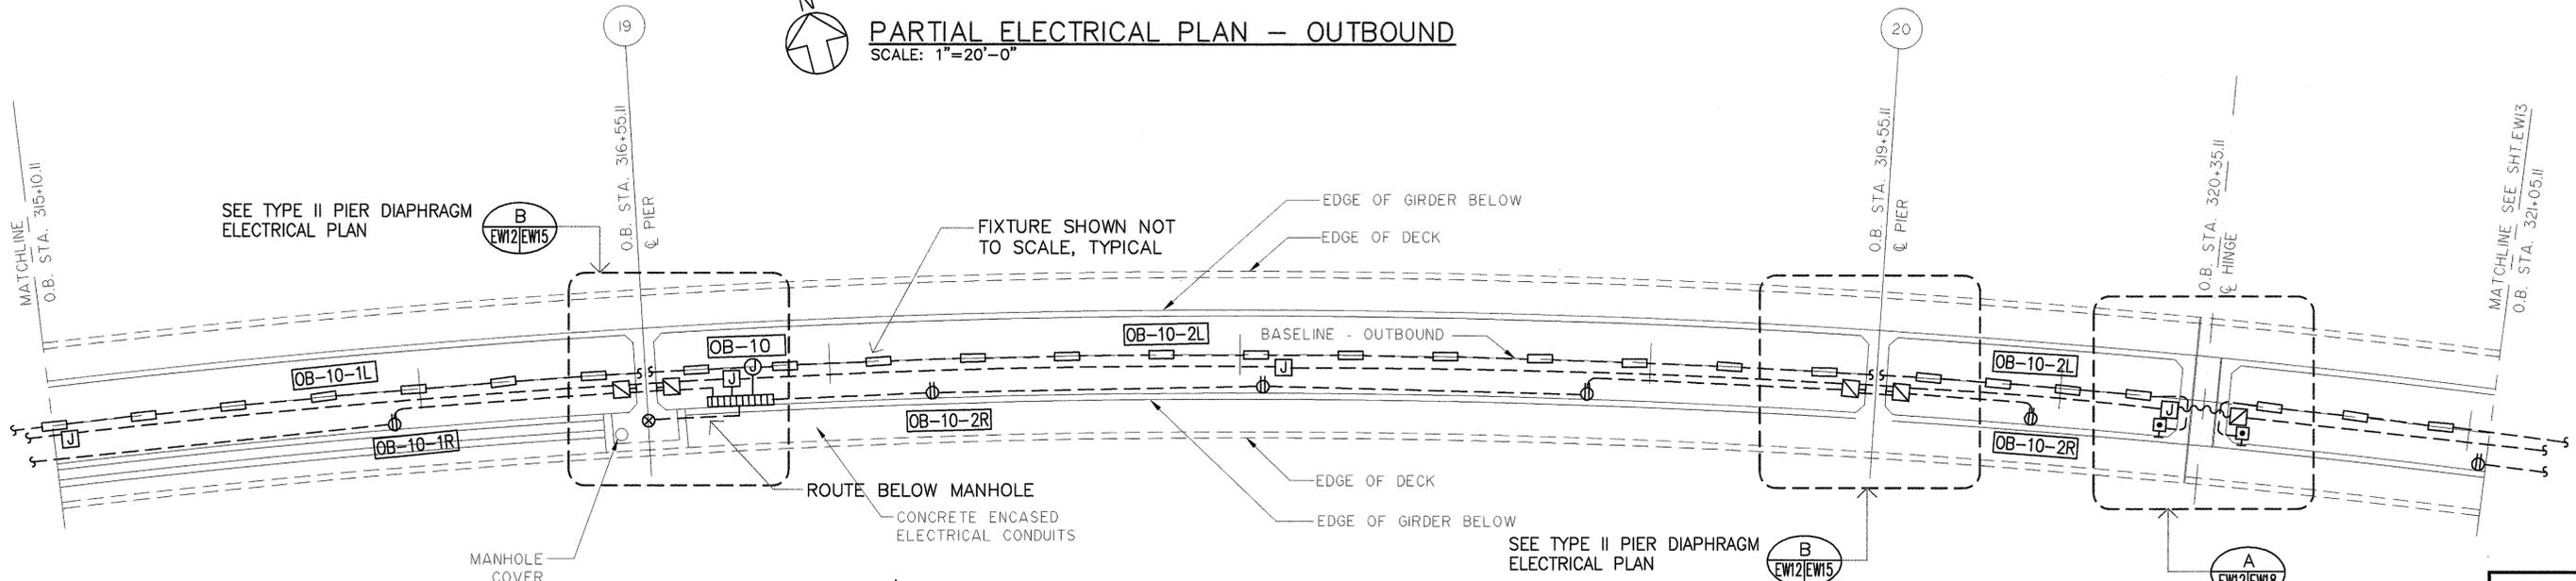

PARTIAL ELECTRICAL PLAN - OUTBOUND
SCALE: 1"=20'-0"

SURVEY PLOTTED BY	DATE
DRAWN BY	
DESIGNED BY	
QUANTITIES BY	
CHECKED BY	
ORIGINAL PLAN	
NOTEBOOK	
No.	

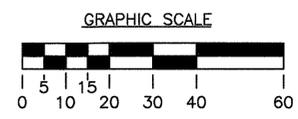

DATE	REVISION

GLENN D. OYAMA
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HAWAII, U.S.A.

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STATE OF HAWAII
DEPARTMENT OF TRANSPORTATION
HIGHWAYS DIVISION


WINDWARD VIADUCT
PARTIAL ELEC PLANS-OUTBOUND

INTERSTATE ROUTE H-3
F.A.I. PROJECT NO. I-H3-1 (75) UNIT 1


SCALE: AS NOTED DATE: JAN 1996

SHEET No. EW2 OF 19 SHEETS

FED. ROAD DIST. NO.	STATE	FED. AID PROJ. NO.	FISCAL YEAR	SHEET NO.	TOTAL SHEETS
HAWAII	HAW.	I-H3-1(75)UNIT1	1996	336	405

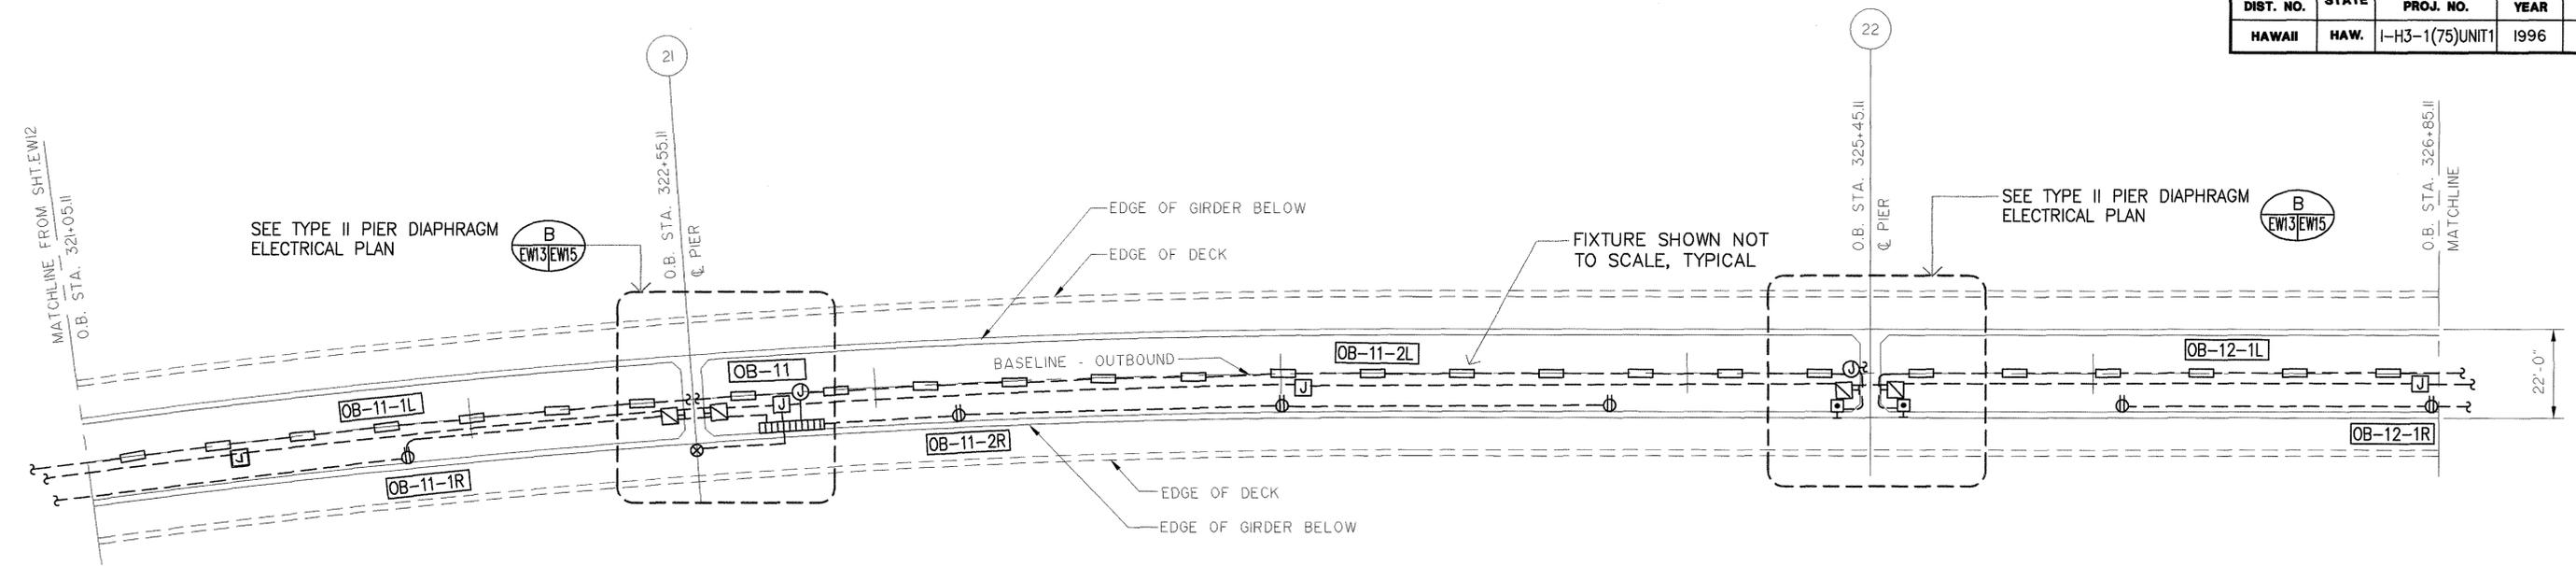

PARTIAL ELECTRICAL PLAN - OUTBOUND
SCALE: 1"=20'-0"

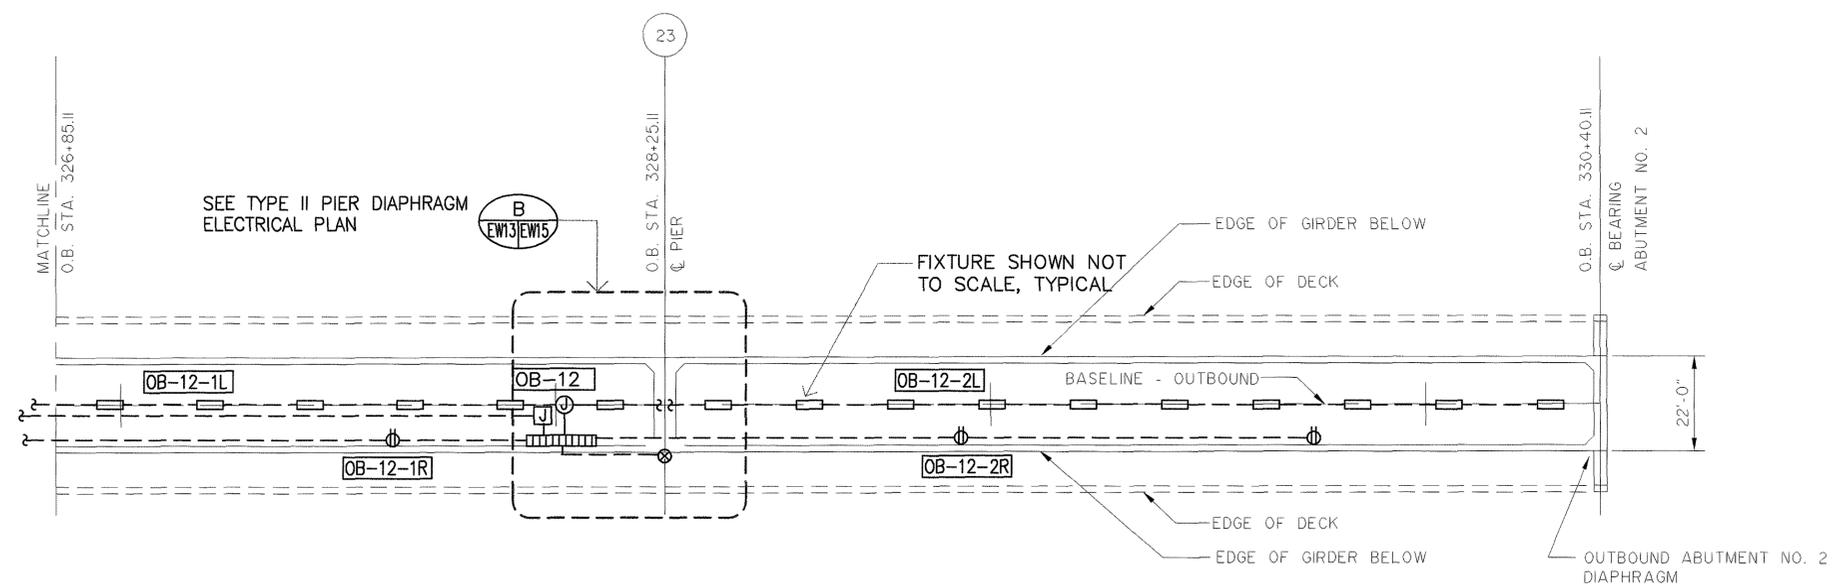

PARTIAL ELECTRICAL PLAN - OUTBOUND
SCALE: 1"=20'-0"

SURVEY PLOTTED BY	DATE
DRAWN BY	
DESIGNED BY	
QUANTITIES BY	
CHECKED BY	
ORIGINAL PLAN	No.
NOTEBOOK	

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NO. 4210-B
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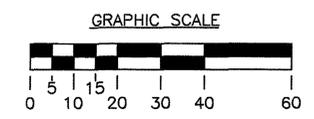
Glen D. Oyama

STATE OF HAWAII
DEPARTMENT OF TRANSPORTATION
HIGHWAYS DIVISION

WINDWARD VIADUCT
PARTIAL ELEC PLANS-OUTBOUND
INTERSTATE ROUTE H-3
F.A.I. PROJECT NO. I-H3-1 (75) UNIT 1


SCALE: AS NOTED DATE: JAN 1996

SHEET No. EW13 OF 19 SHEETS




DATE	REVISION


FED. ROAD DIST. NO.	STATE	FED. AID PROJ. NO.	FISCAL YEAR	SHEET NO.	TOTAL SHEETS
HAWAII	HAW.	1-H3-1(75)UNIT1	1996	337	405

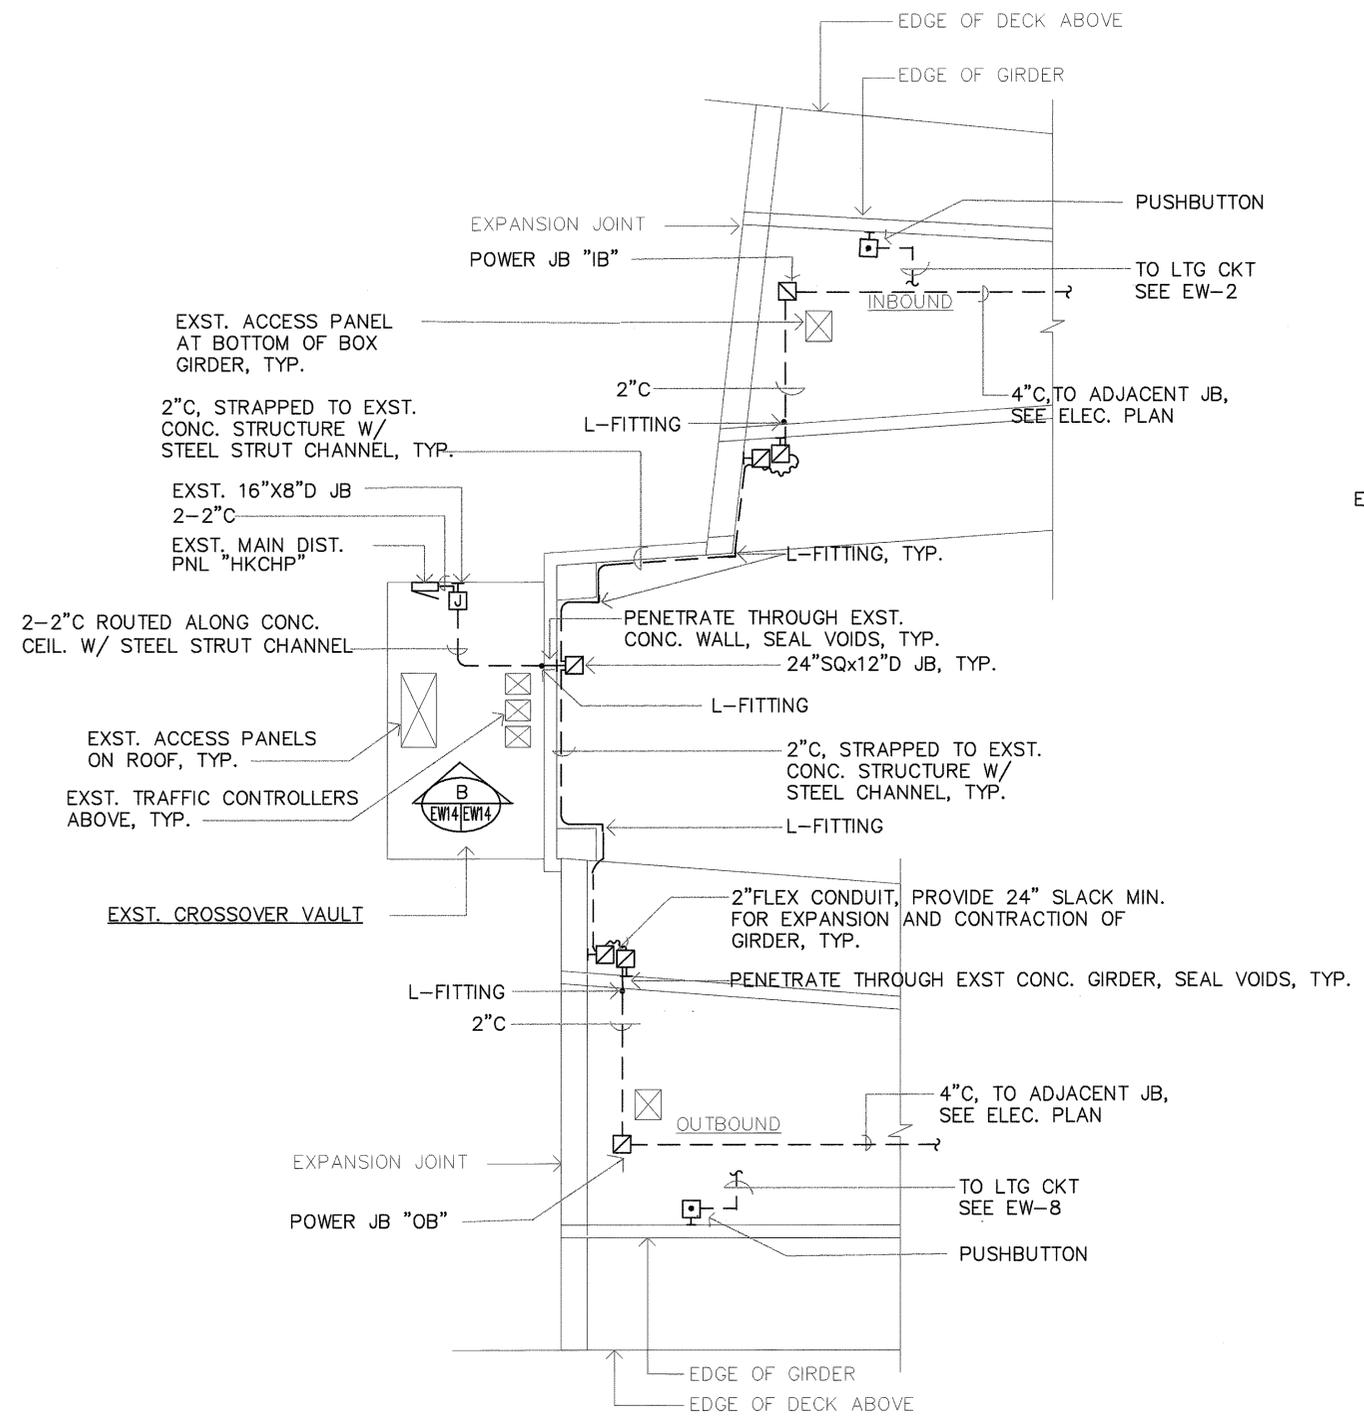

A
EW2/EW14
MAIN ELECTRICAL DISTRIBUTION PLAN
SCALE: 1"=10'-0"

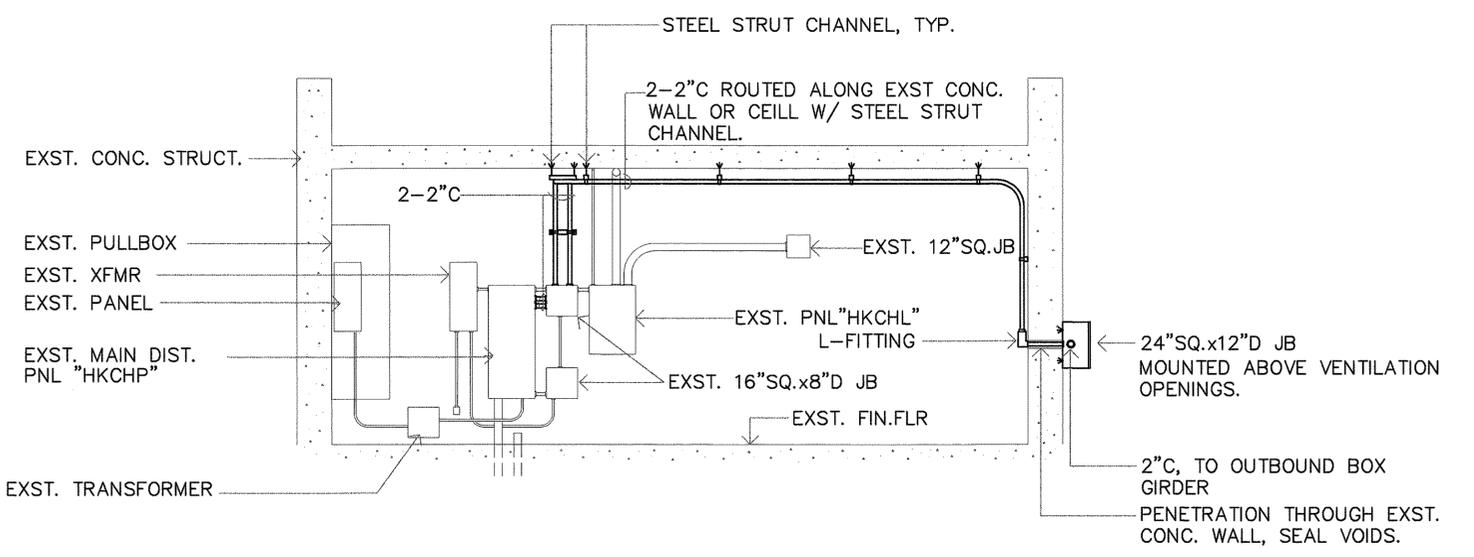


B
EW14/EW14
MAIN DISTRIBUTION EQUIPMENT ELEVATION
(AT CROSSOVER VAULT)
NOT TO SCALE

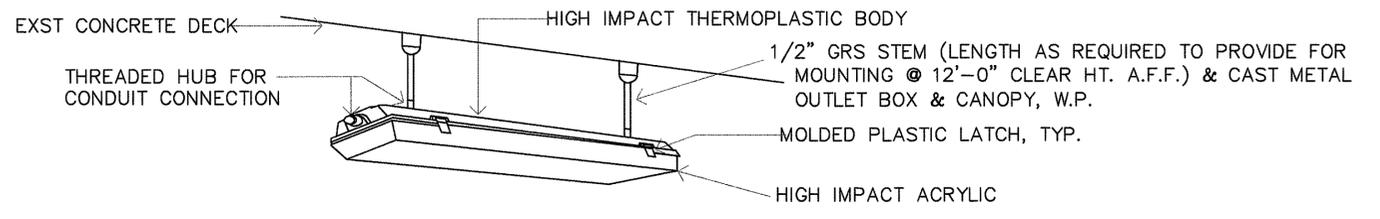

LAMP WATTS	DESCRIPTION	MFR OR APP'D EQ.
2-34W T-8 OCTRON	FLUORESCENT, SURFACE, 51"L X 7 1/4"W X 4 3/4"H, VAPOR-TIGHT, FULLY ENCLOSED, HIGH IMPACT THERMOPLASTIC BODY W/ HIGH IMPACT ACRYLIC ENCLOSURE. CONTINUOUS COMPRESSIBLE NEOPRENE GASKET TO SEAL ENCLOSURE TO BODY. HUBS FOR CONDUIT/STEM CONNECTIONS, UL LISTED DAMP AND WET LOCATIONS. SIX PLASTIC TAB LATCHES. INTERNAL STEEL WIRING COMPARTMENT FINISHED W/ WHITE POLYESTER POWDER COATING, ELECTRONIC BALLAST, 277 V. PROVIDE MOUNTING ACCESSORIES FOR STEM MOUNTING UNLESS SURFACE MOUNTING INDICATED.	DAY-BRITE VAPORLUME SERIES PRUDENTIAL LIGHTING P5360 SERIES METALUX VT2 SERIES

LIGHTING FIXTURE DETAIL
NOT TO SCALE

- LIGHTING PERFORMANCE CRITERIA:
1. MINIMUM 2 FOOT-CANDLE AVERAGE MAINTAINED.
 2. MINIMUM 3 TO 1 RATIO FOR AVERAGE/MINIMUM.
 3. SUBMIT COMPUTER PRINT-OUT OF POINT-TO-POINT FOOTCANDLE LEVEL WITH FIXTURES AT 23 FT O.C. FOR APPROVAL.

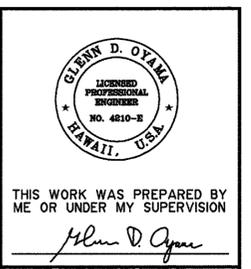



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Glenn D. Oyama

STATE OF HAWAII
DEPARTMENT OF TRANSPORTATION
HIGHWAYS DIVISION
WINDWARD VIADUCT
ELEC PLANS & ELEVATIONS
INTERSTATE ROUTE H-3
F.A.I. PROJECT NO. 1-H3-1 (75) UNIT 1
SCALE: AS NOTED DATE: JAN 1996
SHEET No. EW8 OF 19 SHEETS

SURVEY PLOTTED BY	DATE
DRAWN BY	
DESIGNED BY	
QUANTITIES BY	
CHECKED BY	
ORIGINAL PLAN	No.
NOTEBOOK	No.

DATE	REVISION


FED. ROAD DIST. NO.	STATE	FED. AID PROJ. NO.	FISCAL YEAR	SHEET NO.	TOTAL SHEETS
HAWAII	HAW.	I-H3-1(75)UNIT1	1996	338	405

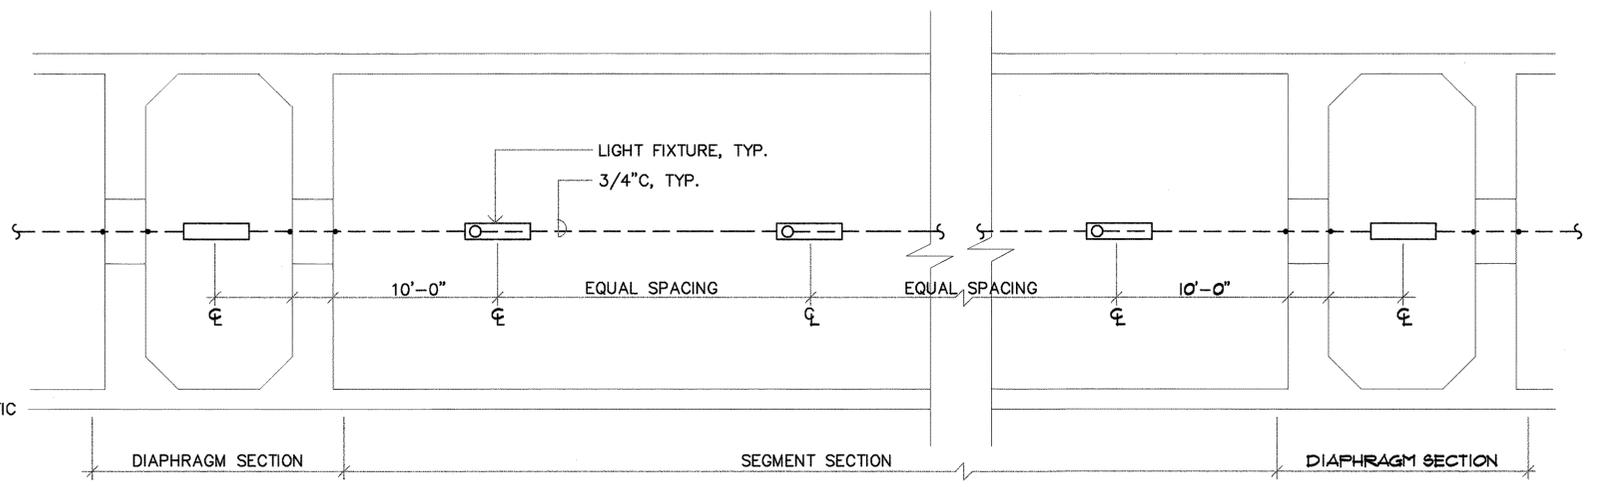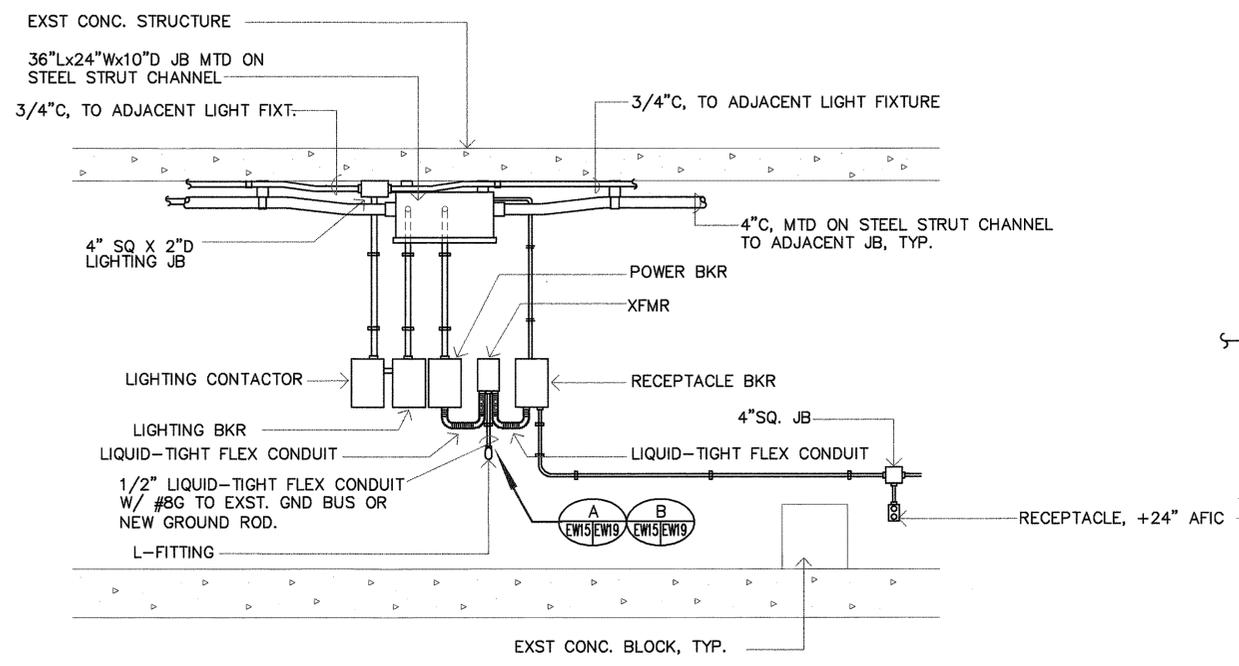

A TYPICAL BOX GIRDER ELECTRICAL DISTRIBUTION EQUIPMENT ELEVATION DETAIL
NOT TO SCALE

TYPICAL BOX GIRDER LIGHTING PLAN
NOT TO SCALE

- NOTES:
1. MOUNT FIXTURES AT 12'-0" CLEAR ABOVE FINISH FLOOR HEIGHT WHERE FEASIBLE W/ EXST BOX GIRDER CEIL HEIGHT FOR ALL LIGHTING FIXTURES EXCEPT FIXTURES INSIDE PIER DIAPHRAGMS, WHICH ARE TO BE MOUNTED ON CEILING. PROVIDE FIXTURE STEMS, SWIVEL BALL ALIGNERS FOR MOUNTING. SEE AS-BUILT STRUCTURAL PLANS FOR BOX GIRDER CEIL HEIGHTS.
 2. SPACING BETWEEN FIXTURES APPROXIMATELY 23 FT & VARIES FROM EACH SEGMENT.

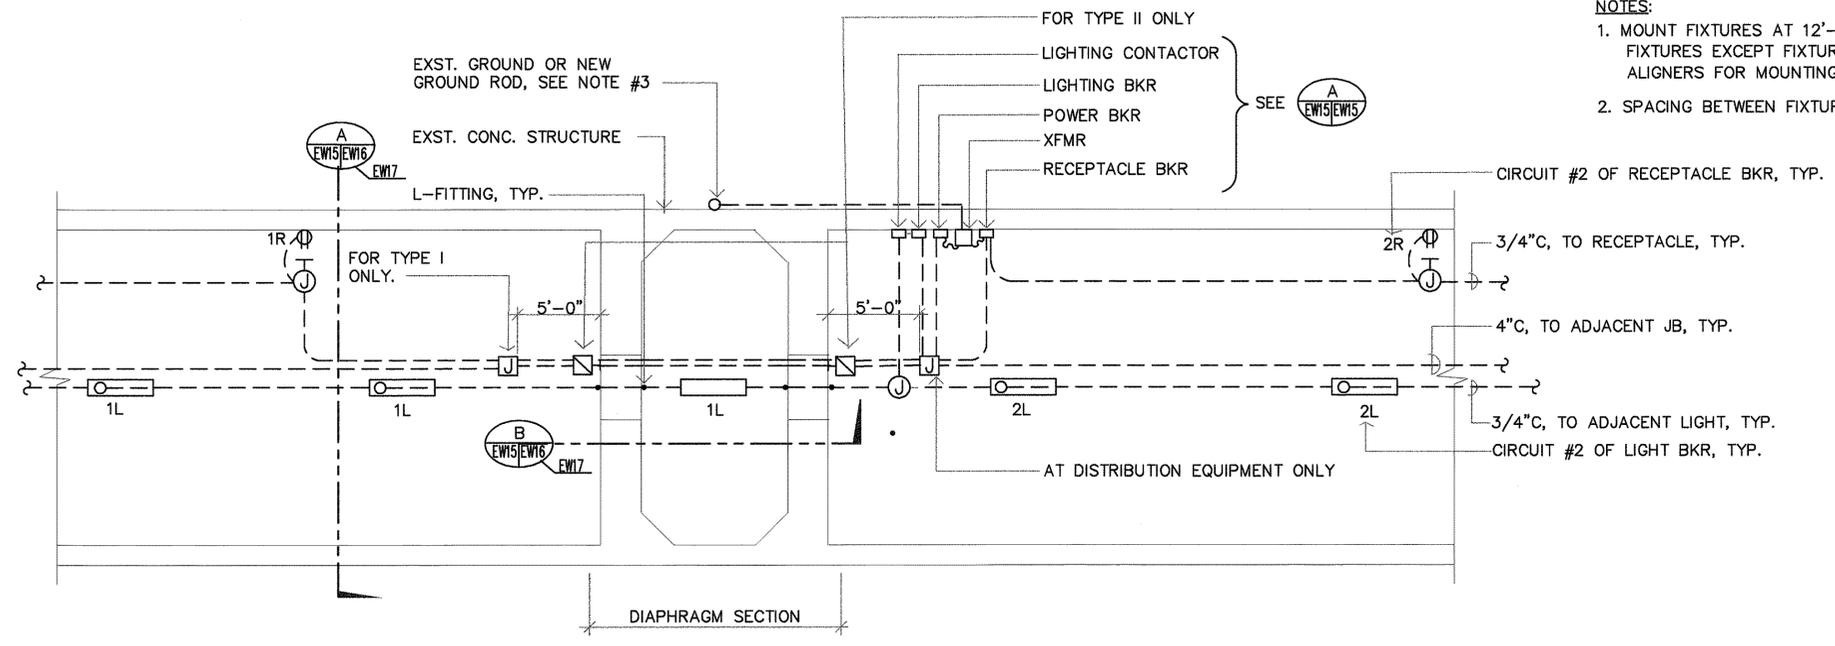

B TYPE I & II PIER DIAPHRAGM ELECTRICAL PLAN
NOT TO SCALE

- NOTES:
1. FOR TYPE I PIER DIAPHRAGM DETAILS, SEE SHEET EW16.
 2. FOR TYPE II PIER DIAPHRAGM DETAILS, SEE SHEET EW17.
 3. FOR GROUNDING AT DISTRIBUTION EQUIPMENT FOR IB-01 TO IB-07 & OB-01 TO OB-07, SEE DETAIL A/EW19; OTHERWISE SEE DETAIL B/EW19.

SURVEY PLOTTED BY	DATE
DESIGNED BY	
QUANTITIES BY	
CHECKED BY	
ORIGINAL PLAN	No.
NOTEBOOK	

GLENN D. OYAMA
LICENSED PROFESSIONAL ENGINEER
NO. 4810-B
HAWAII, U.S.A.

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Glenn D. Oyama


STATE OF HAWAII
DEPARTMENT OF TRANSPORTATION
HIGHWAYS DIVISION

WINDWARD VIADUCT
ELEC. PLANS AND DETAILS
INTERSTATE ROUTE H-3
F.A.I. PROJECT NO. I-H3-1 (75) UNIT 1

SCALE: AS NOTED DATE: JAN 1996
SHEET No. EW5 OF 19 SHEETS

DATE	REVISION

FED. ROAD DIST. NO.	STATE	FED. AID PROJ. NO.	FISCAL YEAR	SHEET NO.	TOTAL SHEETS
HAWAII	HAW.	I-H3-1(75)UNIT1	1996	339	405

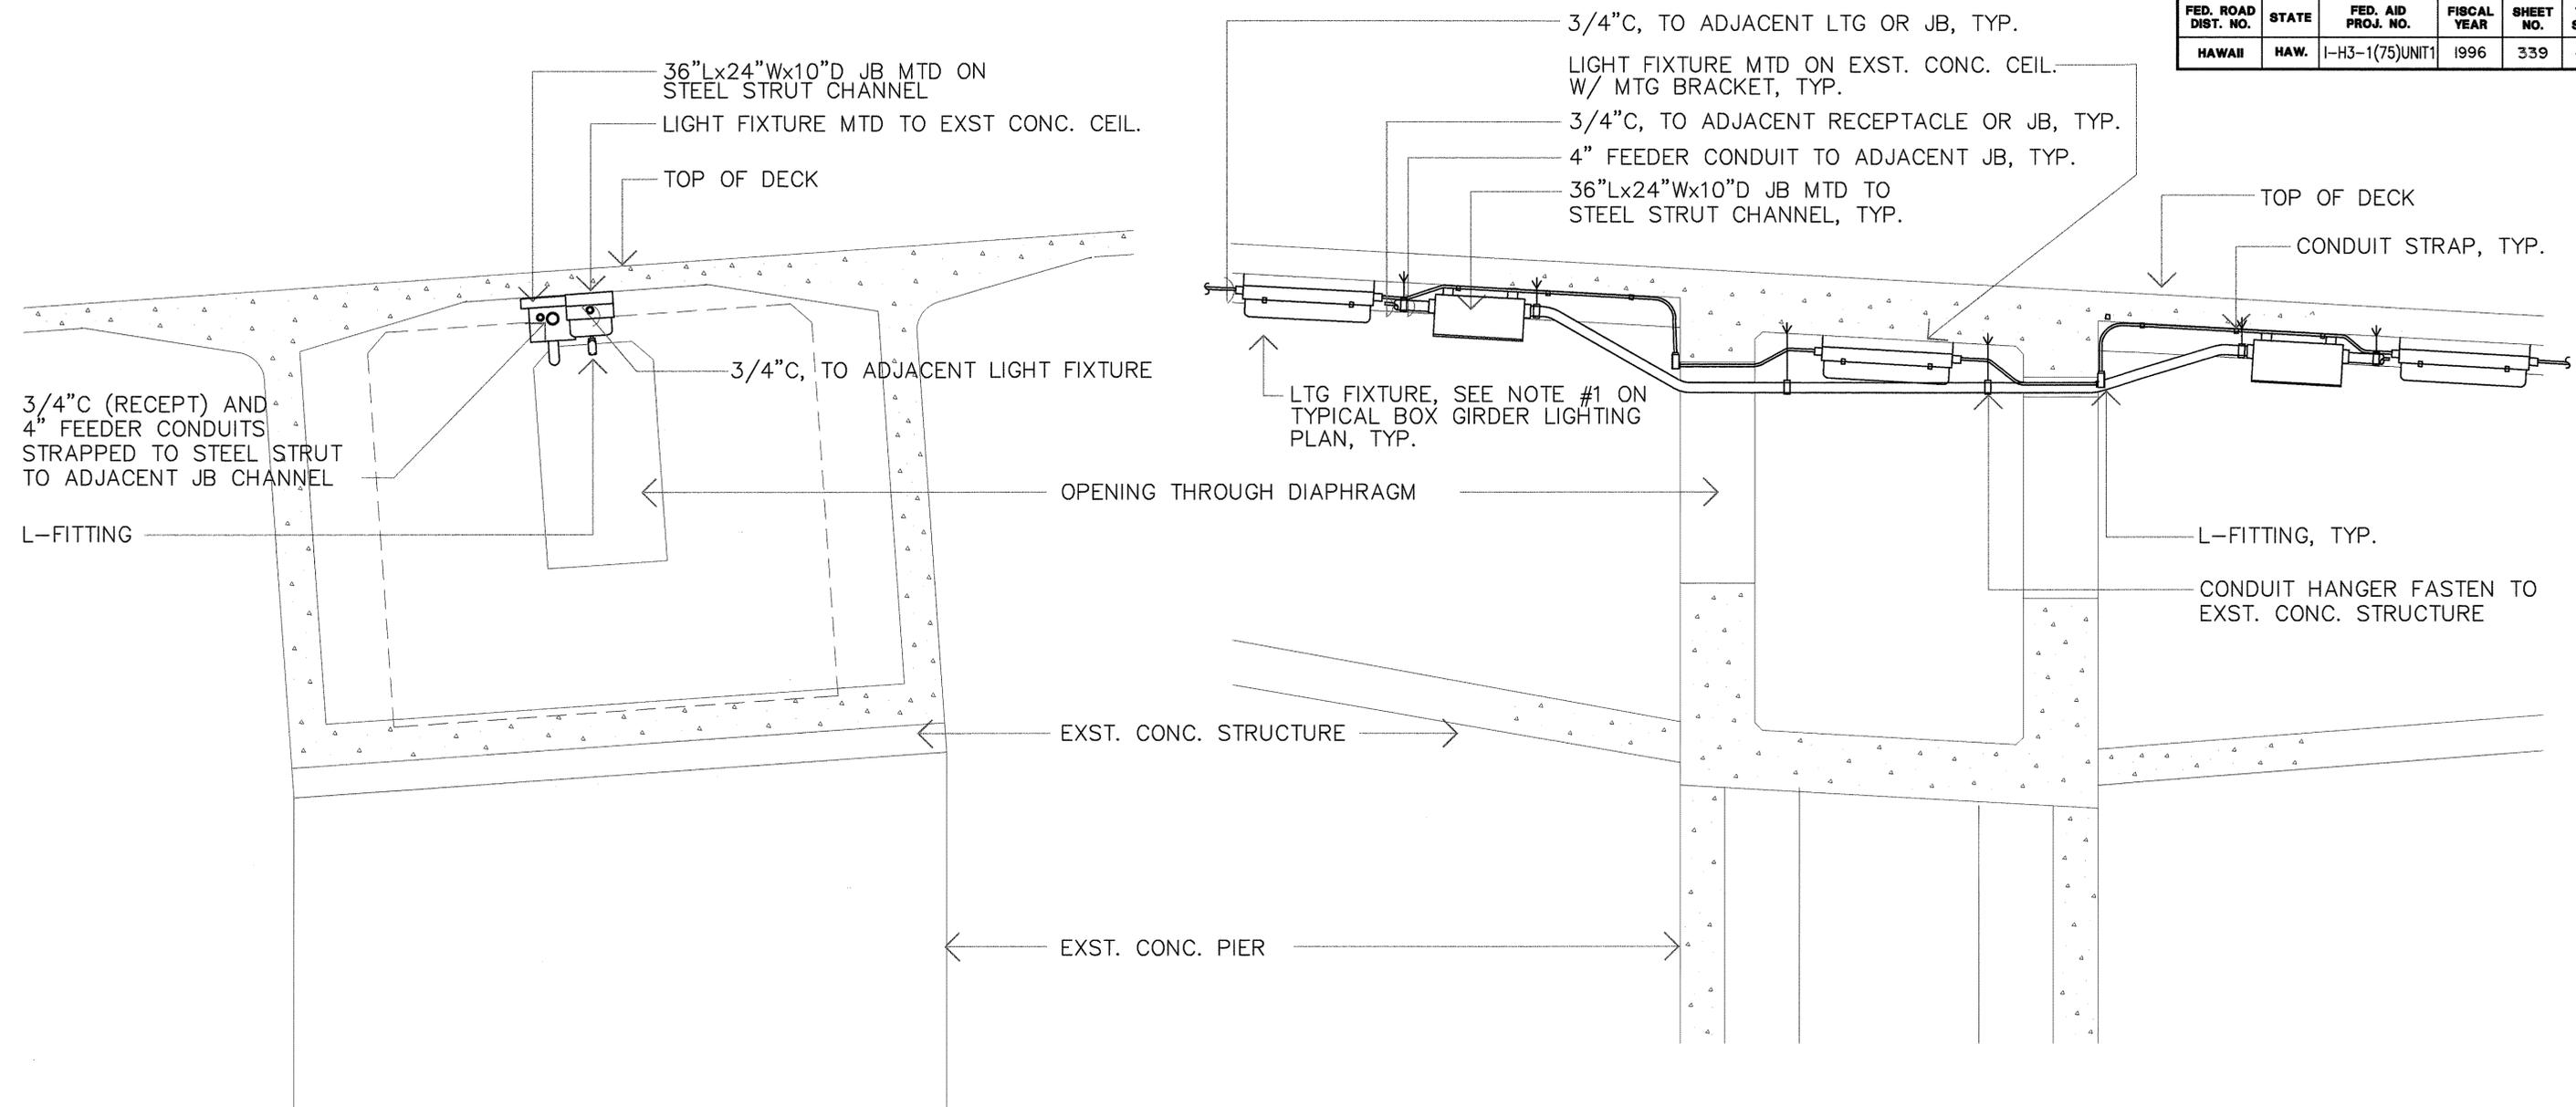

A CROSS SECTION
EW15EW16

B LONGITUDINAL SECTION
EW15EW16

TYPE I PIER DIAPHRAGM ELECTRICAL DETAIL
NOT TO SCALE

NOTES:

1. SEE SHEET EW15 FOR LOCATIONS OF LIGHT FIXTURES AND JB'S.


SURVEY PLOTTED BY	DATE
DESIGNED BY	
QUANTITIES BY	
CHECKED BY	
ORIGINAL PLAN	
NO.	


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STATE OF HAWAII
 DEPARTMENT OF TRANSPORTATION
 HIGHWAYS DIVISION
 WINDWARD VIADUCT
TYPE I PIER DIAPHRAGM ELEC DETAILS
 INTERSTATE ROUTE H-3
 F.A.I. PROJECT NO. I-H3-1 (75) UNIT 1
 SCALE: AS NOTED DATE: JAN 1996
SHEET No. EW16 OF 19 SHEETS

DATE	REVISION

FED. ROAD DIST. NO.	STATE	FED. AID PROJ. NO.	FISCAL YEAR	SHEET NO.	TOTAL SHEETS
HAWAII	HAW.	I-H3-1(75)UNIT1	1996	340	405

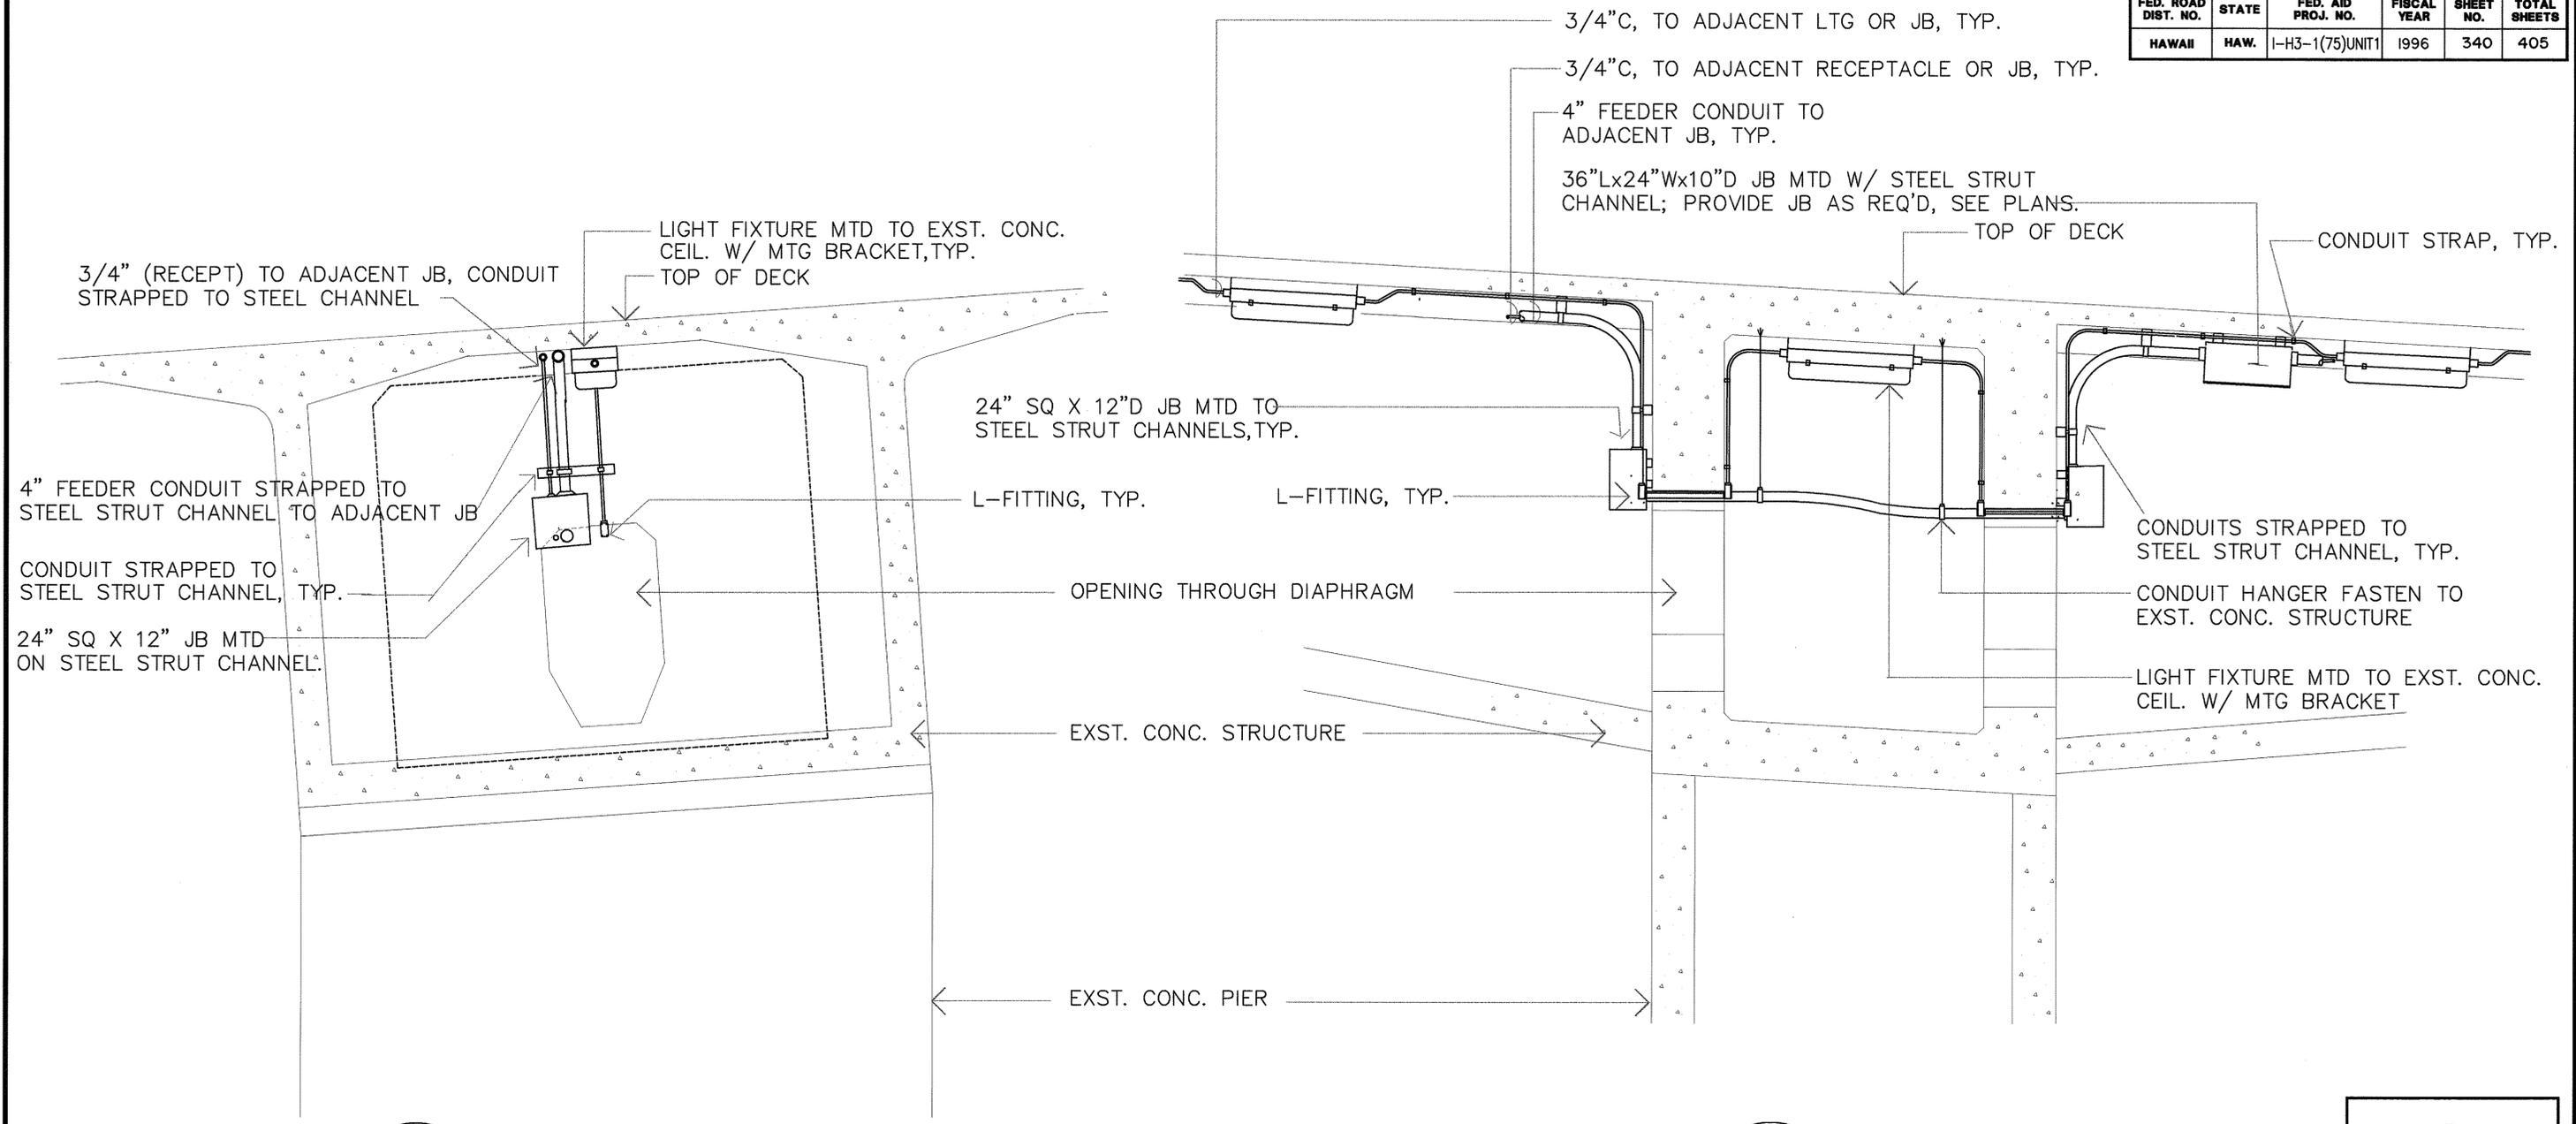

A CROSS SECTION
EW15|EW17

B LONGITUDINAL SECTION
EW15|EW17

TYPE II PIER DIAPHRAGM ELECTRICAL DETAIL
NOT TO SCALE

- NOTES:**
- SEE SHEET EW15 FOR LOCATIONS OF LIGHT FIXTURES AND JB'S.



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Glenn D. Oyama

STATE OF HAWAII
 DEPARTMENT OF TRANSPORTATION
 HIGHWAYS DIVISION
 WINDWARD VIADUCT
TYPE II PIER DIAPHRAGM ELEC DETAILS
 INTERSTATE ROUTE H-3
 F.A.I. PROJECT NO. I-H3-1 (75) UNIT 1
 SCALE: AS NOTED DATE: JAN 1996
SHEET No. EW17 OF 19 SHEETS


SURVEY PLOTTED BY	DATE
DRAWN BY	
DESIGNED BY	
CHECKED BY	
ORIGINAL PLAN	
NO. _____	

DATE	REVISION

FED. ROAD DIST. NO.	STATE	FED. AID PROJ. NO.	FISCAL YEAR	SHEET NO.	TOTAL SHEETS
HAWAII	HAW.	I-H3-1(75)UNIT1	1996	341	405

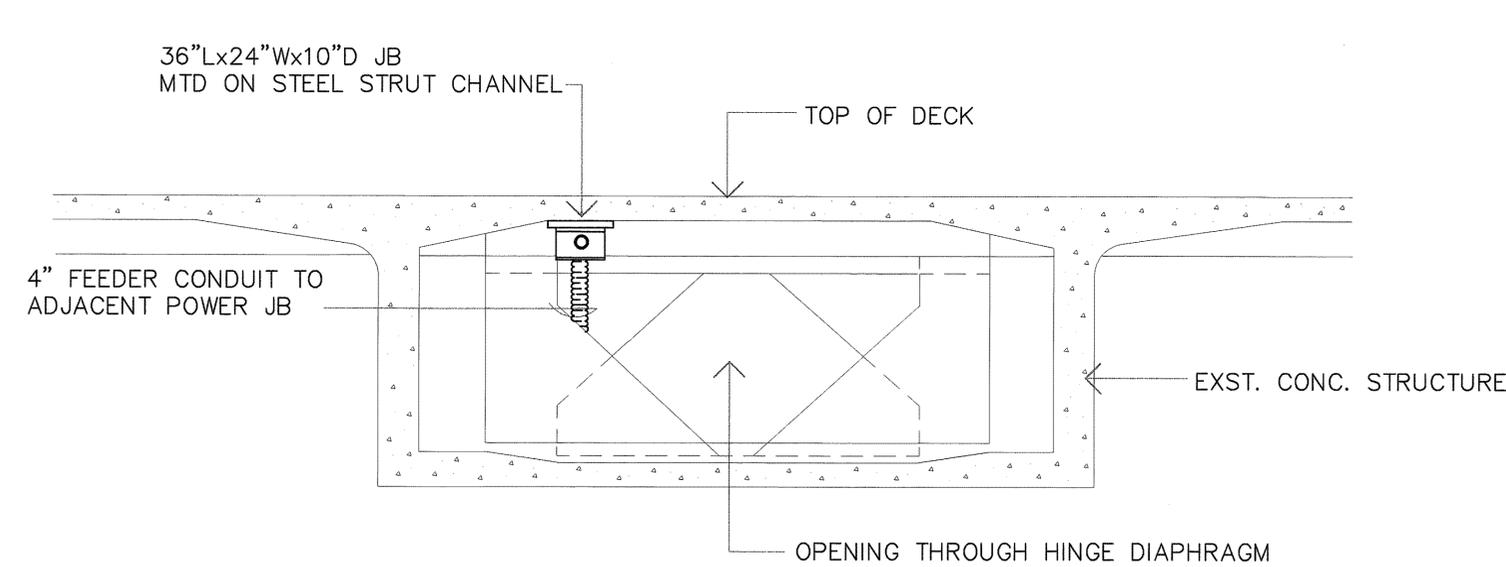

CROSS SECTION

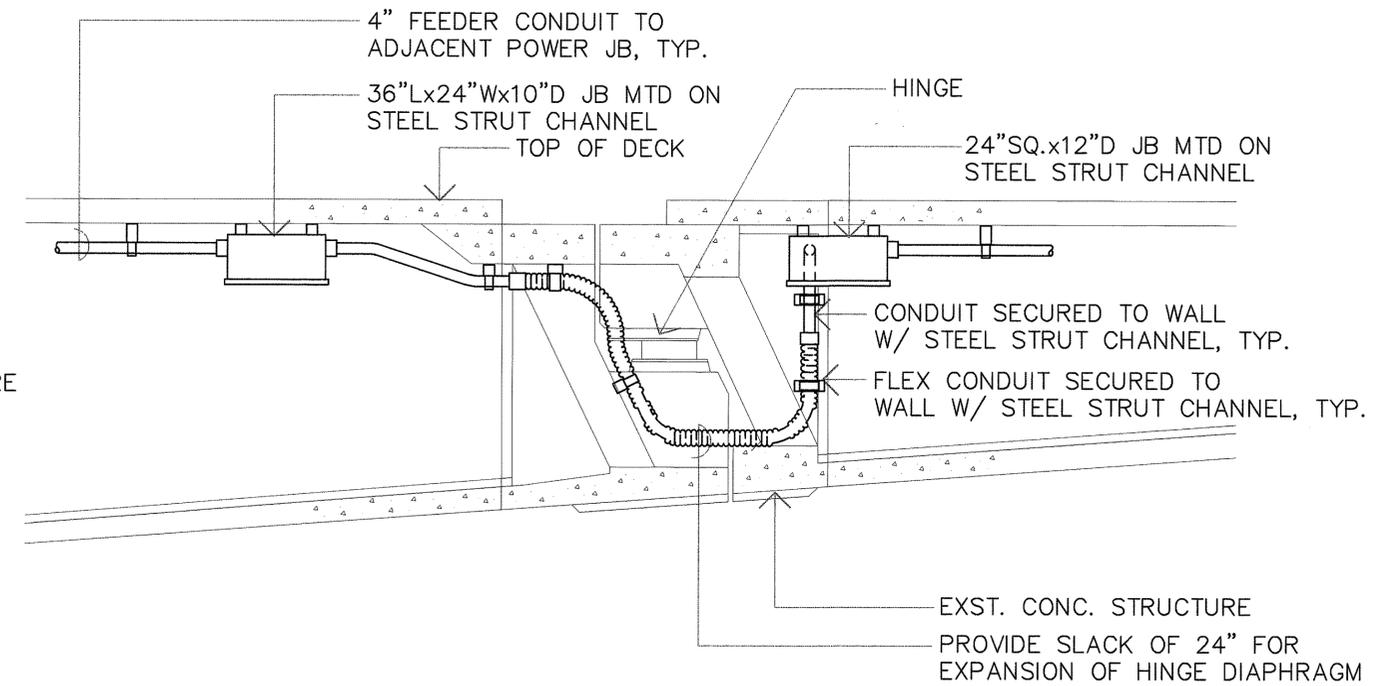

LONGITUDINAL SECTION

HINGE DIAPHRAGM ELECTRICAL DETAILS
 NOT TO SCALE

EW2,EW1,EW0,EW9,EW8,EW6,EW5,EW4,EW3



SURVEY PLOTTED BY	DATE
DRAWN BY	
DESIGNED BY	
QUANTITIES BY	
CHECKED BY	
ORIGINAL PLAN	
NOTEBOOK	
No.	

GLENN D. OYAM
 LICENSED PROFESSIONAL ENGINEER
 NO. 4810-B
 HAWAII, U.S.A.

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Glenn D. Oyam

STATE OF HAWAII
 DEPARTMENT OF TRANSPORTATION
 HIGHWAYS DIVISION

WINDWARD VIADUCT
HINGE DIAPHRAGM ELEC DETAILS


INTERSTATE ROUTE H-3
 F.A.I. PROJECT NO. I-H3-1 (75) UNIT 1

SCALE: AS NOTED DATE: JAN 1996


SHEET No. EW8 OF 19 SHEETS

DATE	REVISION

FED. ROAD DIST. NO.	STATE	FED. AID PROJ. NO.	FISCAL YEAR	SHEET NO.	TOTAL SHEETS
HAWAII	HAW.	I-H3-1(75)UNIT1	1996	342	405

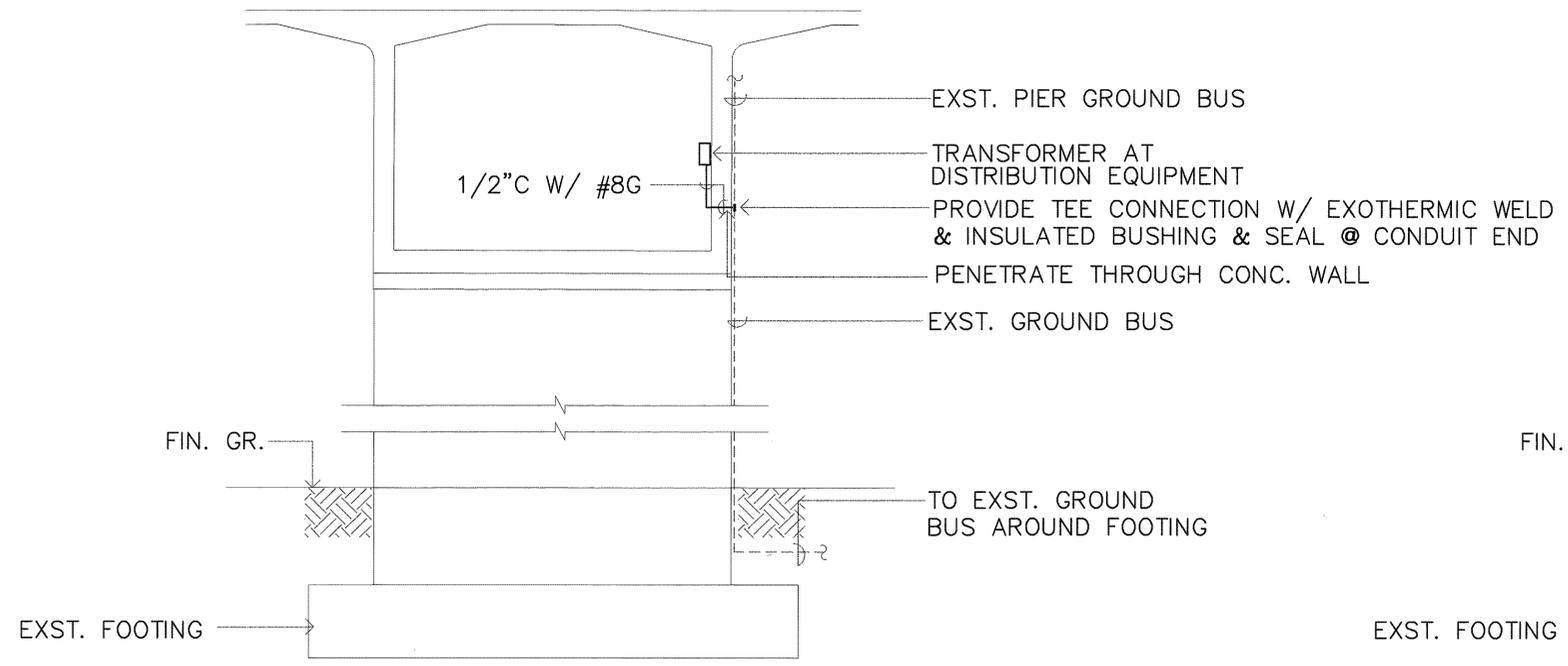

A SERVICE GROUND W/ EXISTING PIER GROUNDING

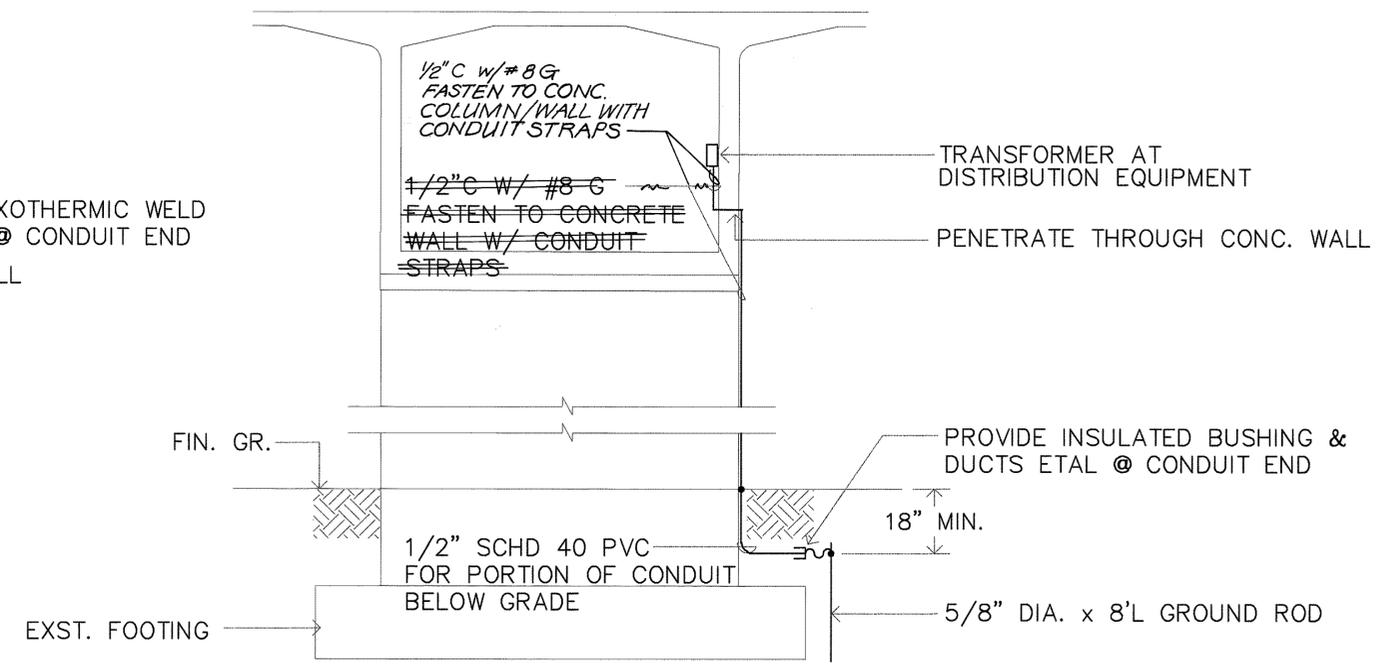

B SERVICE GROUND W/ NEW PIER GROUNDING

SERVICE GROUND DETAILS

NOT TO SCALE

NOTE
 PROVIDE FLEXIBLE CONDUIT CONNECTION WHERE SLIDING BEARINGS OCCUR. PROVIDE SLACK FOR MAX 8" MOVEMENT BY SLIDING BEARINGS AT 1B PIERS 5, 13, 17, 23 AND 0B PIERS 13, 17 AND 23.


SURVEY PLOTTED BY	DATE
DRAWN BY	
DESIGNED BY	
QUANTITIES BY	
CHECKED BY	
ORIGINAL PLAN	
NOTEBOOK	
No.	


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Glenn D. Oyama

STATE OF HAWAII
 DEPARTMENT OF TRANSPORTATION
 HIGHWAYS DIVISION
 WINDWARD VIADUCT
SERVICE GROUND DETAIL
 INTERSTATE ROUTE H-3
 F.A.I. PROJECT NO. I-H3-1 (75) UNIT 1
 SCALE: AS NOTED DATE: JAN 1996
SHEET No. 342 OF 19 SHEETS

DATE	REVISION

FED. ROAD DIST. NO.	STATE	FED. AID PROJ. NO.	FISCAL YEAR	SHEET NO.	TOTAL SHEETS
HAWAII	HAW.	I-H-3-1(75) UNIT I	1990	343	405

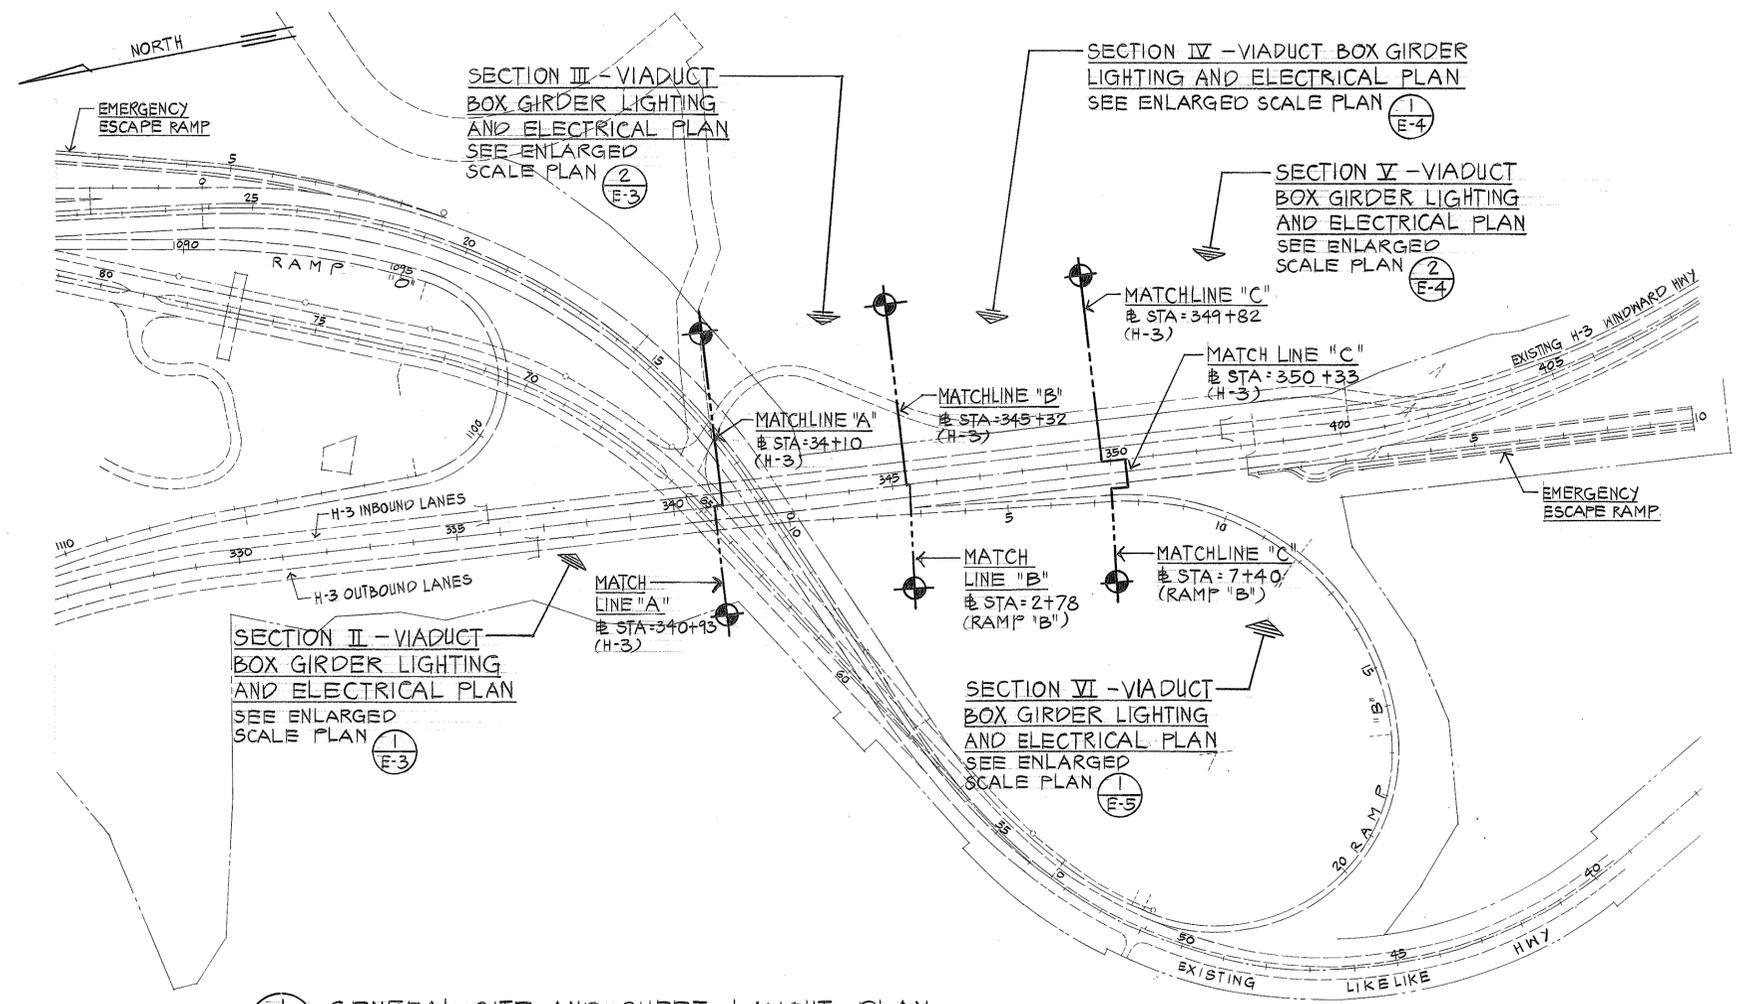

E-1 GENERAL SITE AND SHEET LAYOUT PLAN
SCALE = 1" = 200'

ELECTRICAL SYMBOL LIST

NEW	EXISTING	DESCRIPTION
	○	STREET LIGHT STANDARD
	□	LIGHT, FLUORESCENT, CEILING SURFACE MOUNTED (2-40" LAMPS)
	⊠	3'x5' ELECTRIC HANDHOLE
	⊞	2'x4' COMMUNICATION PULLBOX
	⊞	19" x 28" STREET LIGHT PULLBOX
\$		SWITCH, FLUSH TUMBLER, WALL MOUNTED
\$3		SWITCH, 3-WAY, FLUSH TUMBLER, WALL MOUNTED
"w"		INDICATES FIXTURE OR DEVICE CONTROLLED BY "w". OTHER LETTERS SAME.
⊞		RECEPTACLE, DUPLEX, WEATHERPROOF, WALL MOUNTED
⊞		JUNCTION BOX, 4' 5/8" x 2" D, PVC, WP, UL, MTD
⊞		JUNCTION BOX, 12' 5/8" x 6" D, PVC, WP, UL, MTD
⊞		ELECTRIC PANEL
-#-		RACEWAY, EXPOSED NUMBER OF WIRES WITHIN
→		ARROW, HOMERUN TO PANEL OR CABINET NO HASHMARKS 2 WIRES WITHIN
H		TRANSFORMER, DRY-TYPE, WALL MOUNTED
⊞		DETAIL INDICATOR UPPER HALF: DETAIL NUMBER LOWER HALF: SHEET NO. (DETAIL LOCATION)
A		FIXTURE INDICATOR UPPER HALF: FIXTURE TYPE LOWER HALF: NO. OF LAMPS & LENGTH
⊞		NOTE INDICATOR
H		JUNCTION BOX, WP, MTD ON CONC. BARRIER. "B" = ELECTRIC; "C" = COMMUNICATION; "SL" = STREET LIGHT.

GENERAL NOTES:

- DASHED LINES (---) INDICATE EXISTING CONDITION UNLESS OTHERWISE NOTED.
- SOLID LINES (—) INDICATE NEW WORK UNLESS OTHERWISE NOTED.

DATE	
SURVEY PLOTTED BY	
DRAWN BY	
DESIGNED BY	
QUANTITIES BY	
CHECKED BY	
NO.	




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R. Orita

STATE OF HAWAII
DEPARTMENT OF TRANSPORTATION
HIGHWAYS DIVISION
**GENERAL SITE AND SHEET LAYOUT PLAN,
ELECTRICAL SYMBOL LIST.**
KANEOHE INTERCHANGE
INTERSTATE ROUTE H-3
F.A.I. PROJECT No. I-H-3-1(75) UNIT I

SCALE: AS NOTED DATE: JAN. 1990
SHEET No. E1 OF 7 SHEETS

NORTH

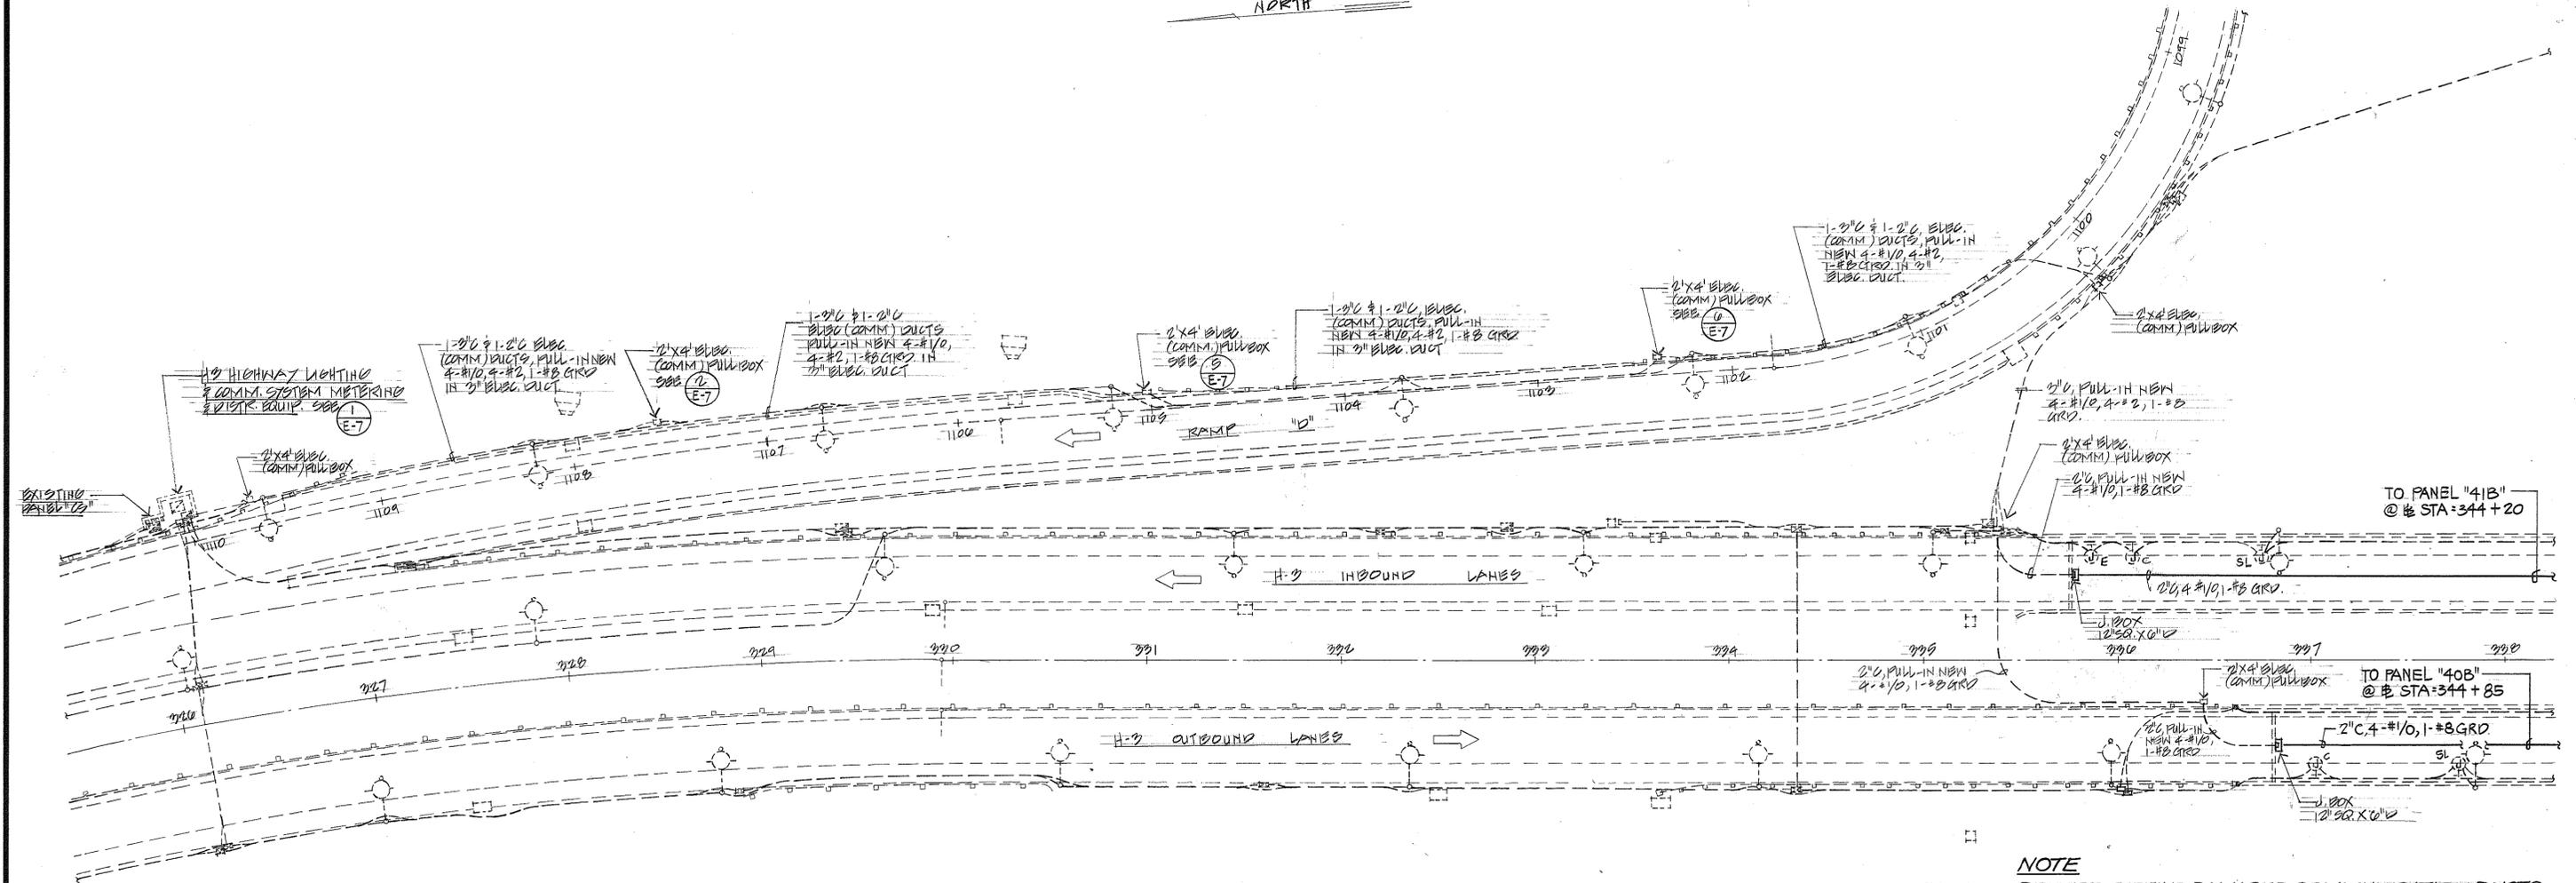

SECTION I ~ EXISTING SITE ELECTRICAL PLAN
SCALE: 1" = 20'

NOTE
 REPLACE EXISTING DAMAGED COMMUNICATION DUCTS AT WINDWARD HIGHWAY STA. 335+15 ± RT TO STA. 336+15 ± RT.
 A. REMOVE 100 L.F. ± OF EXIST. GUARDRAIL.
 B. EXPOSE 100 L.F. ± OF DAMAGED DUCTS.
 C. REPLACE 100 L.F. ± OF DAMAGED DUCTS.
 D. PLACE BASE COURSE FOR PIPE CUSHION AND BACKFILL W/3/4 C AND COMPACT.
 E. REDRIVE GUARDRAIL POSTS AND REINSTALL GUARDRAIL.

PANEL "41B" SCHED
 480Y/277 VOLTS, 3 PHASES, 4 WSN
 BREAKER MIN. A.I.C. 14,000
 SURFACE MTG. 50 A MAIN BKR

CKT. No.	USE	CIRCUIT BREAKER POLES/AMPS	CONNECTED LOAD (KVA)			WIRE SIZE
			A	B	C	
1	LIGHTS	20	1.0			10
2			1.2			
3				1.3		
4				1.3		
5					1.2	
6	SPARE		2.0			
7			2.0			
8				2.0		
9	PPB	50	2.0			
10				2.0		
11				2.0		
12	SUBFEEDER PANEL "210A"	2	6A	6A		6
13	SUBFEEDER PANEL "210B"	2	6A	6A	6A	6
14		30	6A			6
15	PPB	50	2.0	2.0	2.0	
16		3	2.0	2.0	2.0	
17		3	2.0	2.0	2.0	

TOTAL LOAD/PHASE
 TOTAL 22.0 19.0 13.0 KVA
 DEMAND FACTOR 0.85
 DEMAND LOAD 20.9 KVA

PANEL "210A" SCHED
 120/240 VOLTS, 1 PHASES, 3 WSN
 BREAKER MIN. A.I.C. 10,000
 SURFACE MTG. 30A MAIN BKR

(PANELS "210B", "200A" & "200B" SIMILAR)

CKT. No.	USE	CIRCUIT BREAKER POLES/AMPS	CONNECTED LOAD (KVA)			WIRE SIZE
			A	B	C	
1	RECEP.	20				10
2			1.2			
3				1.2		
4				1.2		
5	SPARE		1.0			
6			1.0			
7				1.0		
8				1.0		

TOTAL LOAD/PHASE
 TOTAL 4.0 4.0 4.0 KVA
 DEMAND FACTOR 0.35
 DEMAND LOAD 2.4 KVA

PANEL "40B" SCHED
 480Y/277 VOLTS, 3 PHASES, 4 WSN
 BREAKER MIN. A.I.C. 14,000
 SURFACE MTG. 50 A MAIN BKR

CKT. No.	USE	CIRCUIT BREAKER POLES/AMPS	CONNECTED LOAD (KVA)			WIRE SIZE
			A	B	C	
1	LIGHTS	20	0.9			10
2			1.2			
3				1.0		
4				1.2		
5					1.3	
6				1.3		
7	SPARE		2.0			
8	LIGHTS		1.1			10
9	SPARE			2.0		
10	LIGHTS			1.2		10
11	SPARE				2.0	
12	LIGHTS				1.9	10
13	SUBFEEDER PANEL "200A"	2	6A	6A		6
14	SUBFEEDER PANEL "200B"	2	6A		6A	6
15	SUBFEEDER PANEL "200C"	2	6A	6A	6A	6
16	PPB	3	60	1.0	1.0	1.0
17	PPB	3	60	1.0	1.0	1.0


TOTAL LOAD/PHASE
 TOTAL 22.0 20.6 21.7 KVA
 DEMAND FACTOR 0.5
 DEMAND LOAD 21.2 KVA

PANEL "200C" SCHED
 120/240 VOLTS, 1 PHASES, 3 WSN
 BREAKER MIN. A.I.C. 10,000
 SURFACE MTG. 30A MAIN BREAKER

CKT. No.	USE	CIRCUIT BREAKER POLES/AMPS	CONNECTED LOAD (KVA)			WIRE SIZE
			A	B	C	
1	RECEP.	20				10
2			1.2			
3				1.2		
4				1.2		
5					1.2	
6				1.2		
7	SPARE		1.0			
8	SPARE		1.0			
9	PPB	50	1.0			
10			1.0			
11				1.0		
12				1.0		

TOTAL LOAD/PHASE
 TOTAL 6.0 6.4 6.4 KVA
 DEMAND FACTOR 0.85
 DEMAND LOAD 3.9 KVA

DATE: _____
 SURVEY PLOTTED BY: _____
 DRAWN BY: _____
 TRACED BY: _____
 DESIGNED BY: _____
 CHECKED BY: _____
 ORIGINAL PLAN NO. _____
 NOTE BOOK NO. _____

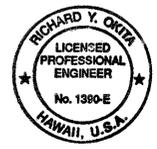

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STATE OF HAWAII
 DEPARTMENT OF TRANSPORTATION
 HIGHWAYS DIVISION


SECTION I ~ EXISTING SITE ELECTRICAL PLAN

KANOEHI INTERCHANGE
 INTERSTATE ROUTE H-3
 E.A. I. PROJECT No. 1-H3-1(75) UNIT I


SCALE: AS NOTED DATE: JAN. 1996

SHEET NO. E2 OF 7 SHEETS

FED. ROAD DIST. NO.	STATE	FED. AID PROJ. NO.	FISCAL YEAR	SHEET NO.	TOTAL SHEETS
HAWAII	HAW.	I-192-1(79) UNIT 1	1996	345	405

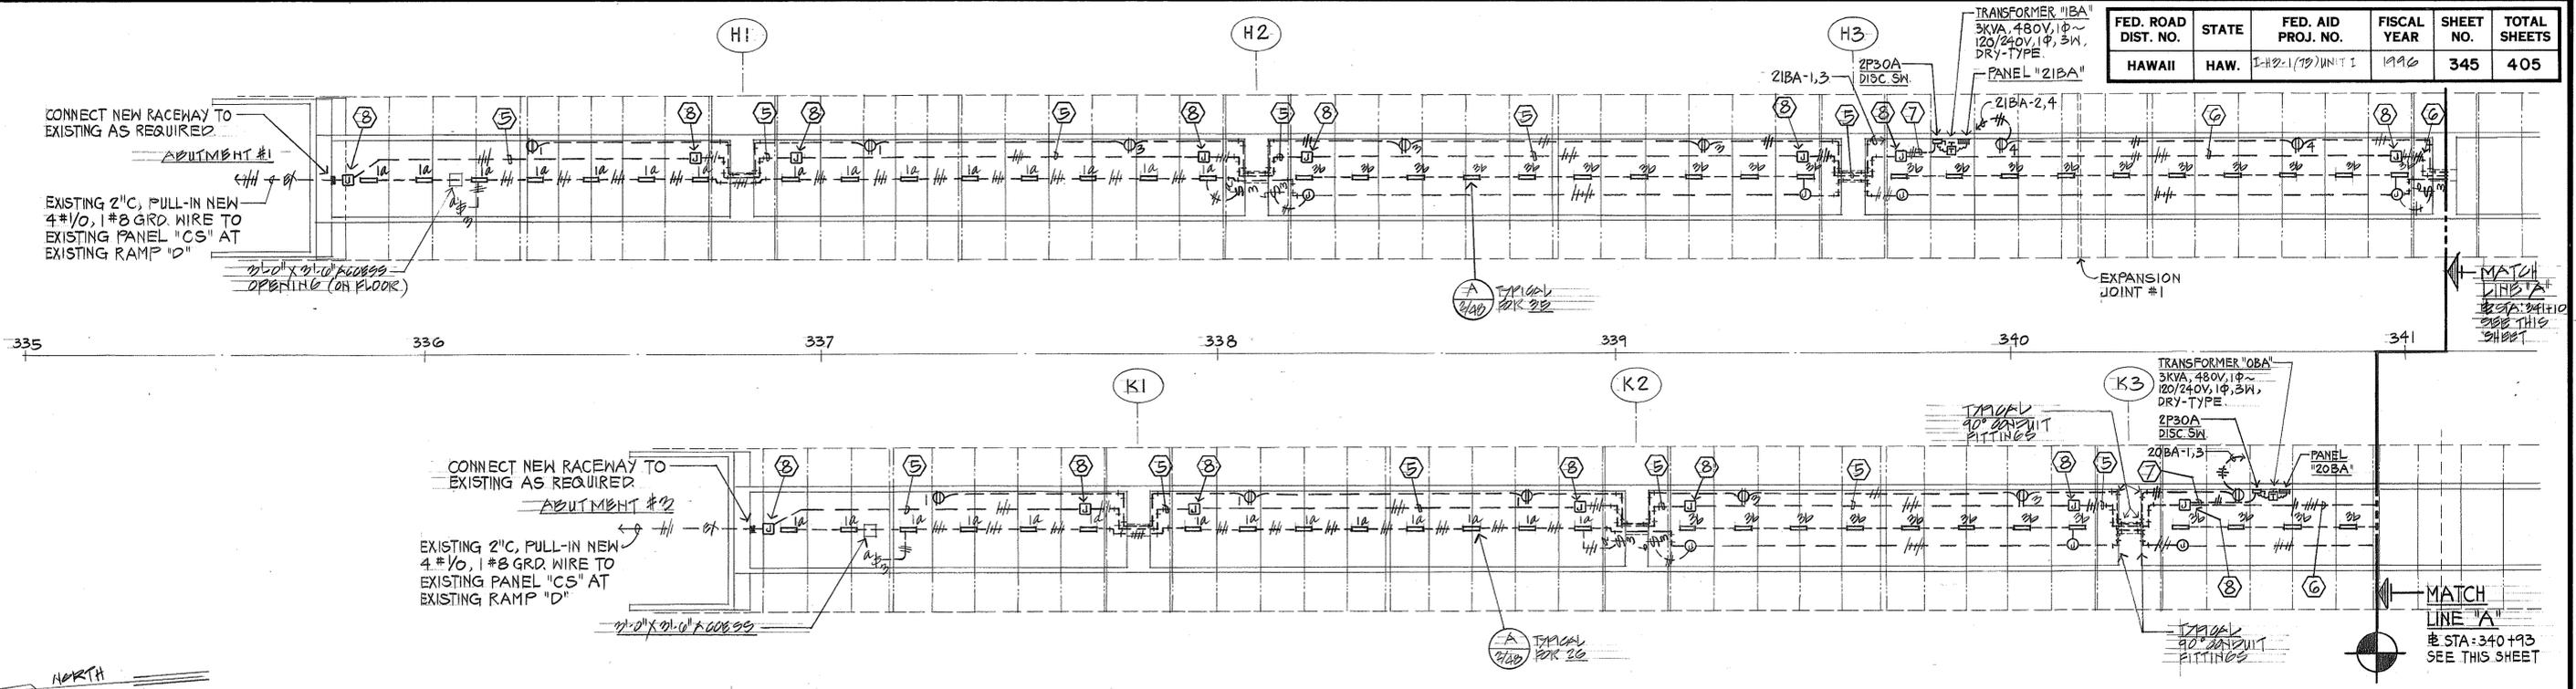

SECTION I - VIADUCT BOX GIRDER LIGHTING and ELECTRICAL PLAN
 SCALE: 1" = 20'

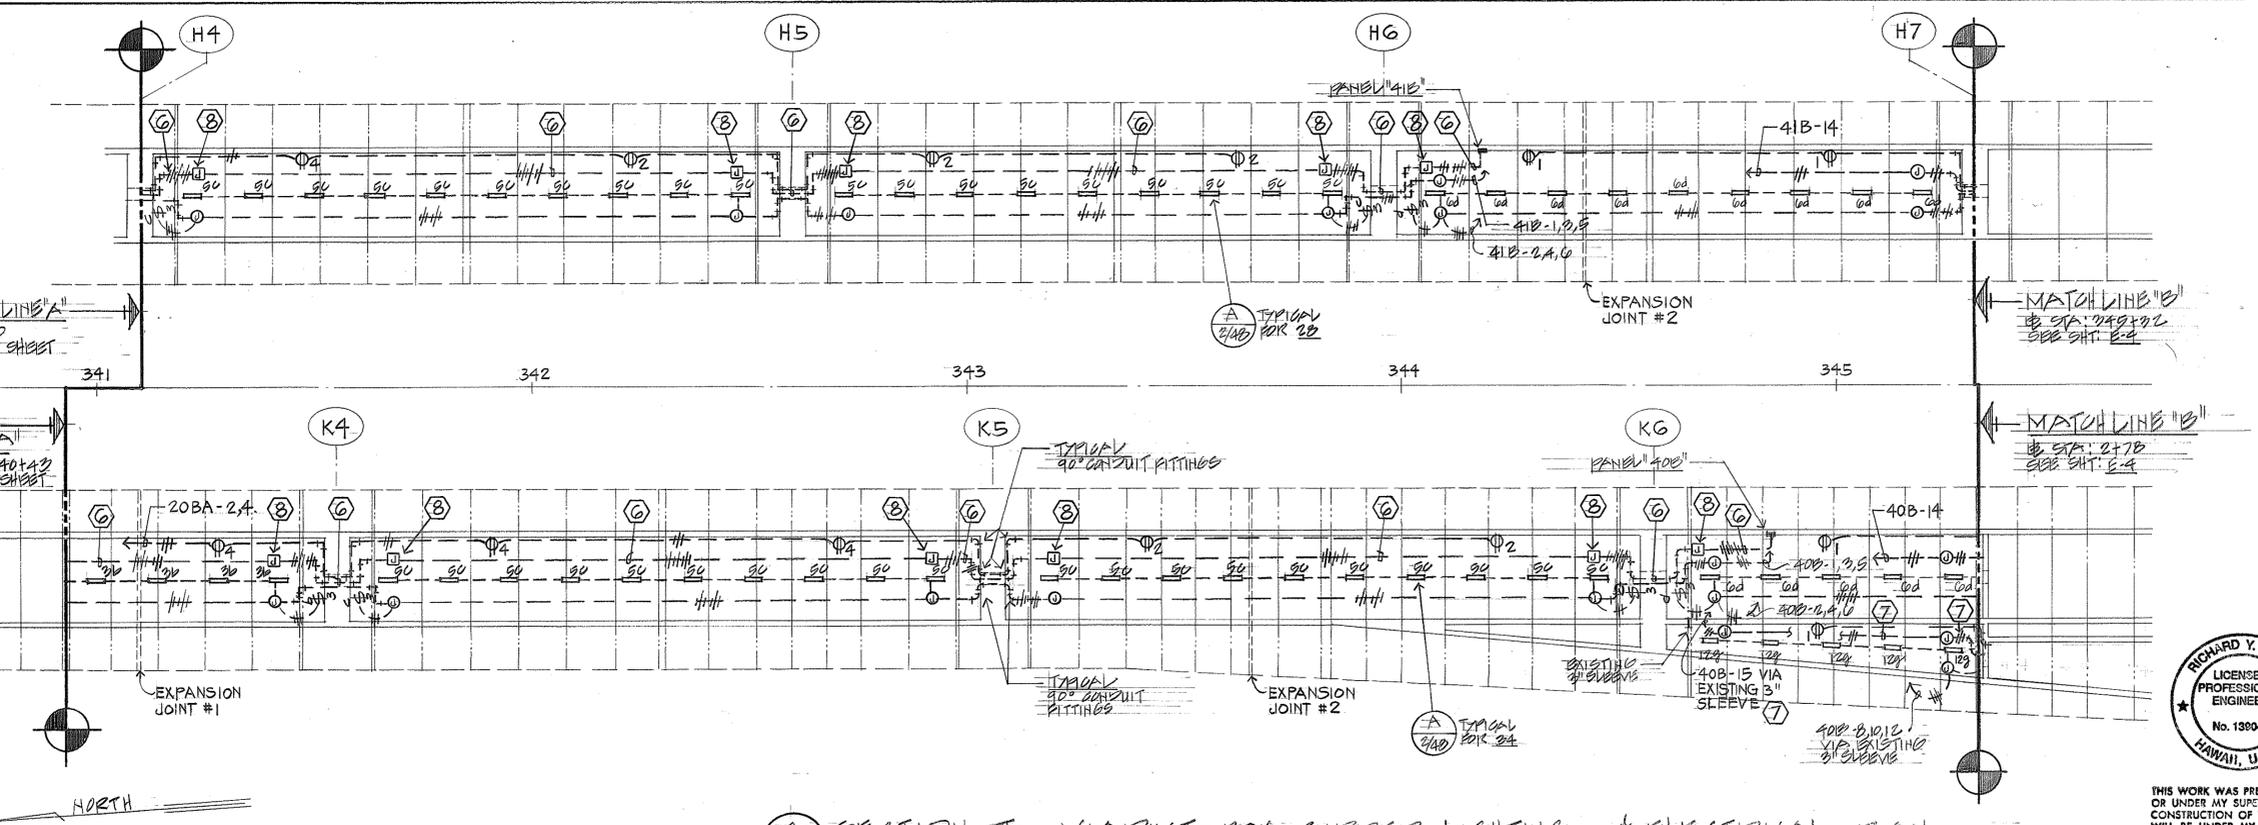

SECTION II - VIADUCT BOX GIRDER LIGHTING and ELECTRICAL PLAN
 SCALE: AS NOTED

- GENERAL NOTES:
- ALL RACEWAYS SHALL BE POLYVINYL OR LOKING (PVC) SCHEDULE 40.
 - ALL OUTLET BOXES SHALL BE MOUNTED PVC, RULF GASKETED WITH MATCHING WEATHERCODE COVERES.
 - ALL JUNCTION BOXES AND PANELS SHALL BE PVC OR FIBERGLASS AND RATED NEMA 4X.
 - PROVIDE #10 GROUND WIRE MIN. THROUGHOUT ENTIRE RACEWAY SYSTEM UNLESS OTHERWISE NOTED.
 - 2" C, 4 #10, 1 #8 GROUND STRAPPED TO CEILING AT 5'-0" ON CENTER MINIMUM.
 - 2" C, 4 #10, 1 #8 GROUND & 34" C, 2 #6, 1 #10 GRD (CKT-13) STRAPPED TO CEILING AT 5'-0" OC. MIN.
 - 34" C, 2 #6, 1 #10 GRD (CKT-13) STRAPPED TO CEILING AT 5'-0" ON CENTER MINIMUM.
 - 12" X 12" X 6" D JUNCTION BOX, CEILING MTD., BOTTOM ACCESS.

DATE: _____
 SURVEY PLOTTED BY: _____
 DRAWN BY: _____
 DESIGNED BY: _____
 QUANTITIES BY: _____
 CHECKED BY: _____
 ORIGINAL PLAN NO. _____
 NOTE BOOK NO. _____

RICHARD Y. OHTA
 LICENSED PROFESSIONAL ENGINEER
 No. 1300-E
 HAWAII, U.S.A.
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 R. Ohta


STATE OF HAWAII
 DEPARTMENT OF TRANSPORTATION
 HIGHWAYS DIVISION

SECTION I & II - VIADUCT BOX GIRDER LIGHTING and ELECTRICAL PLAN
 KANAOHE INTERCHANGE
 INTERSTATE ROUTE H-2
 E.A.T. PROJECT NO. I-192-1 (79) UNIT 1


SCALE: AS NOTED DATE: JAN. 1996

SHEET No. E3 OF 7 SHEETS

FED. ROAD DIST. NO.	STATE	FED. AID PROJ. NO.	FISCAL YEAR	SHEET NO.	TOTAL SHEETS
HAWAII	HAW.	I-182-1(79) UNIT I	1990	346	405

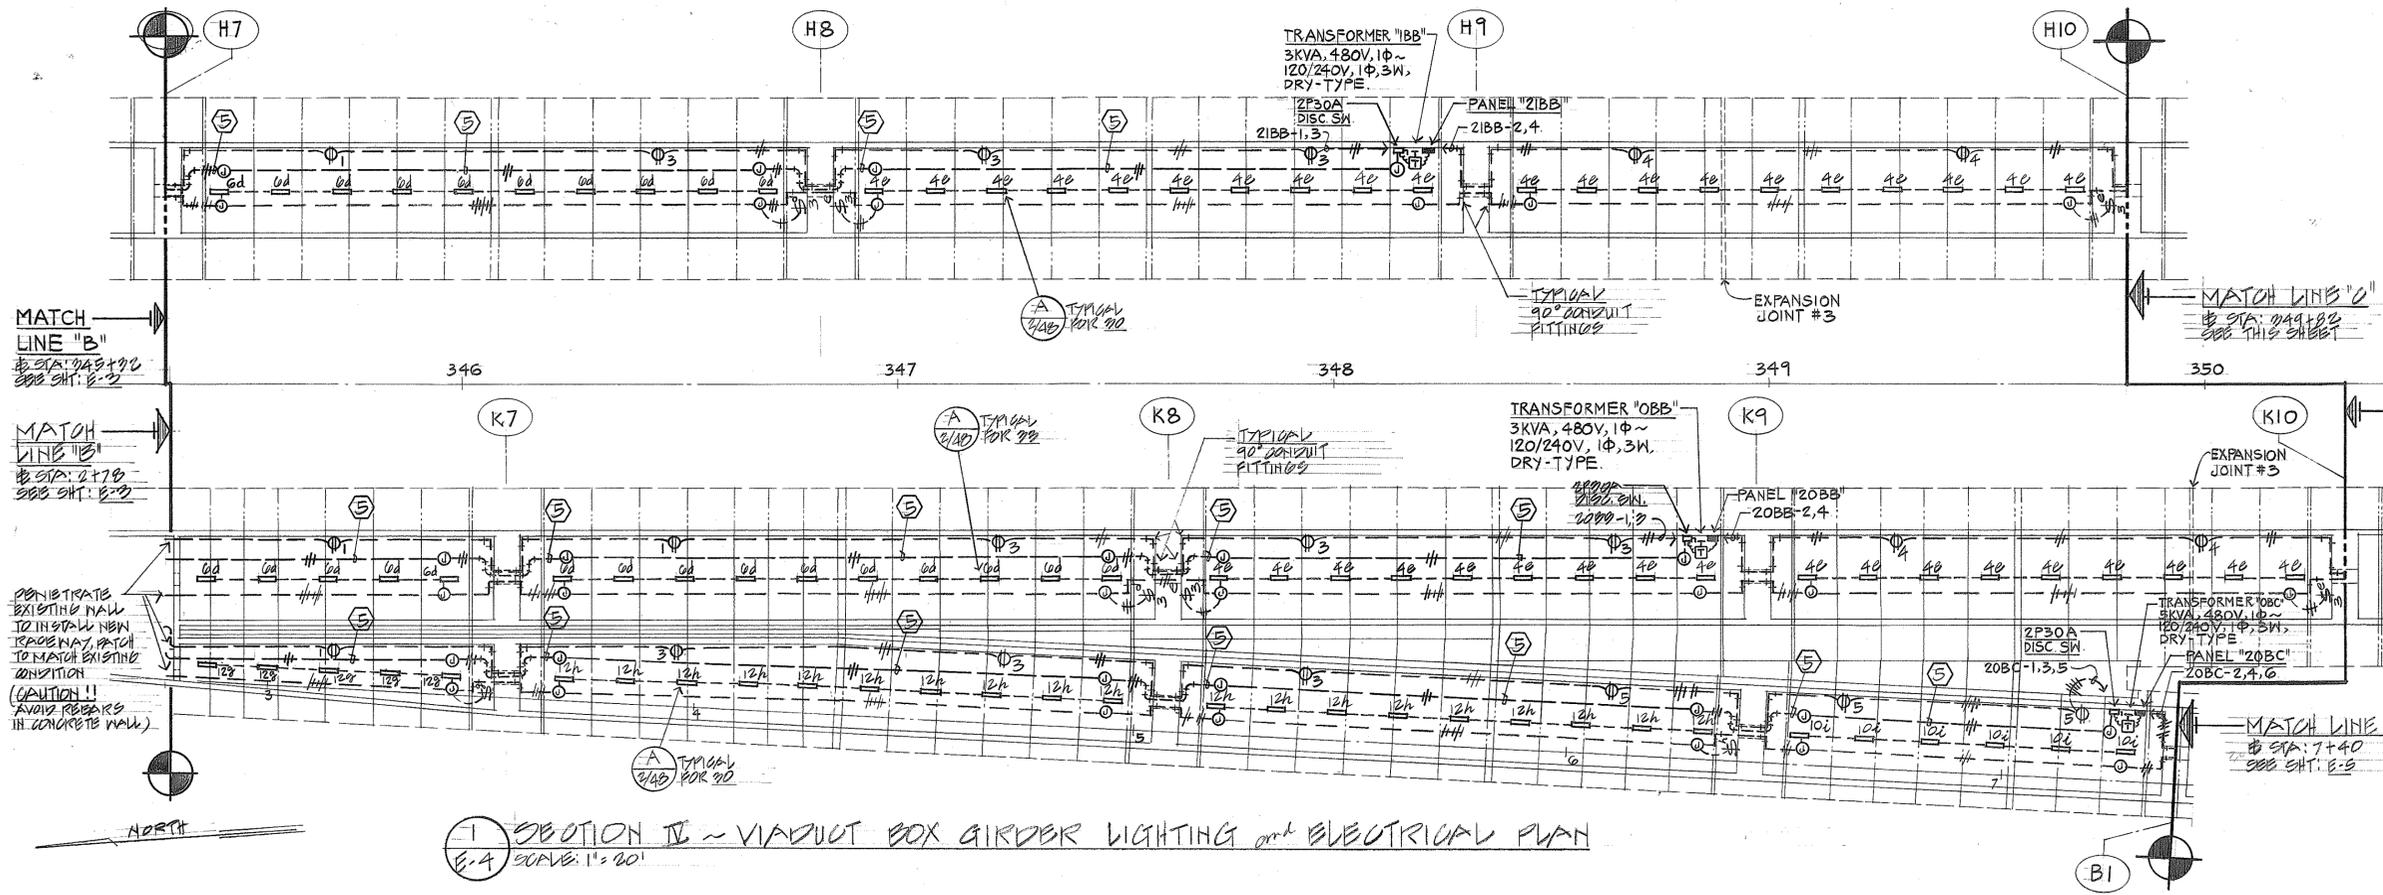

SECTION II - VIADUCT BOX GIRDER LIGHTING and ELECTRICAL PLAN
E-4 SCALE: 1"=20'

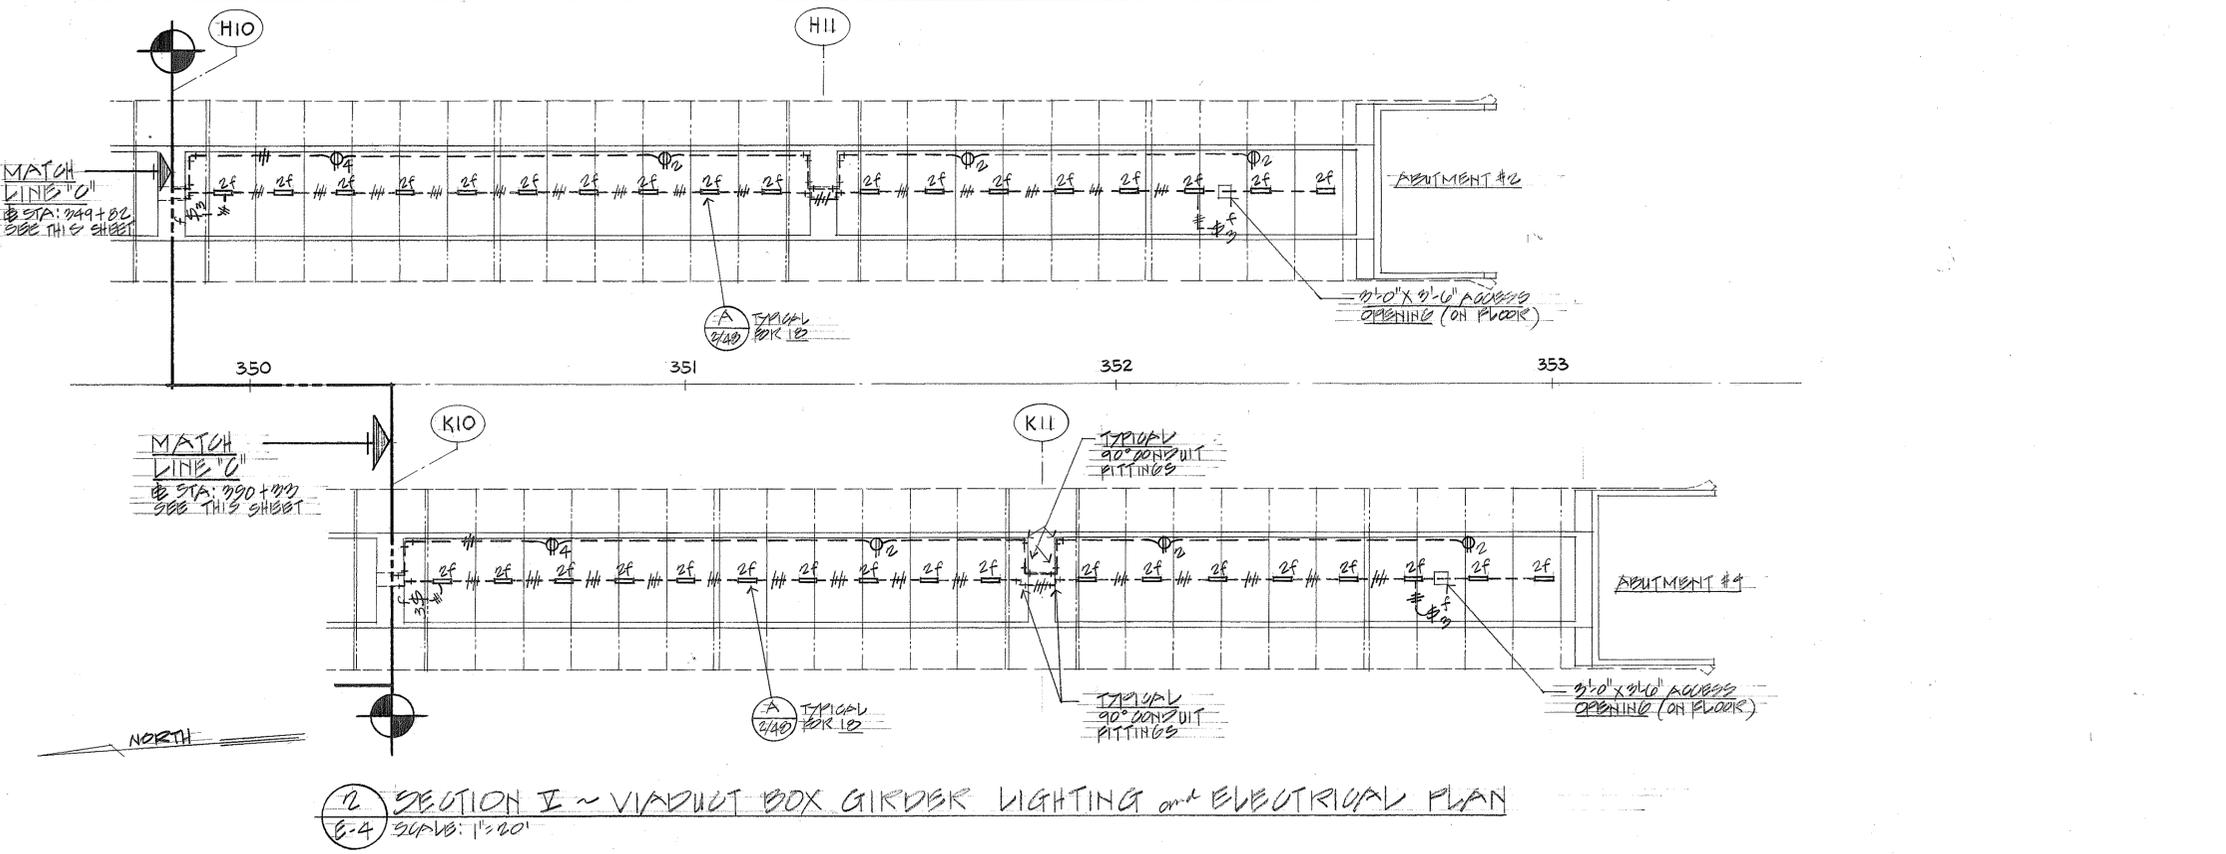

SECTION II - VIADUCT BOX GIRDER LIGHTING and ELECTRICAL PLAN
E-4 SCALE: 1"=20'

- GENERAL NOTES:**
1. ALL RACEWAYS SHALL BE POLYVINYL CHLORIDE (PVC) 30HSDULB 40.
 2. ALL OUTLET BOXES SHALL BE MOLDED PVC FULLY BASKETED WITH MATCHING WEATHERPROOF COVERS.
 3. ALL JUNCTION BOXES AND PANELS SHALL BE PVC OR FIBERGLASS AND RATED NEMA 4X.
 4. PROVIDE #10 GROUND WIRE MIN. THROUGH OUT ENTIRE RACEWAY SYSTEM UNLESS OTHERWISE NOTED.
 5. 3/4" C, 2 #6, #10 GROUND STRAPPED TO CEILING AT 5'-0" ON CENTER MINIMUM.

DATE: _____
 SURVEY PLOTTED BY: _____
 DRAWN BY: _____
 CHECKED BY: _____
 NOTE BOOK: _____



THIS WORK WAS PREPARED BY ME OR UNDER MY SUPERVISION AND CONSTRUCTION OF THIS PROJECT WILL BE UNDER MY SUPERVISION.

R. Ohta


STATE OF HAWAII
 DEPARTMENT OF TRANSPORTATION
 HIGHWAYS DIVISION

SECTION II & III - VIADUCT BOX GIRDER LIGHTING and ELECTRICAL PLAN
 KANEHOE INTERCHANGE
 INTERSTATE ROUTE H-3
 P.A.I. PROJECT NO. I-182-1 (79) UNIT I

SCALE: AS NOTED DATE: JAN. 1990

SHEET NO. 64 OF 7 SHEETS

FED. ROAD DIST. NO.	STATE	FED. AID PROJ. NO.	FISCAL YEAR	SHEET NO.	TOTAL SHEETS
HAWAII	HAW.	I-18-1(79) UNIT I	1990	347	405

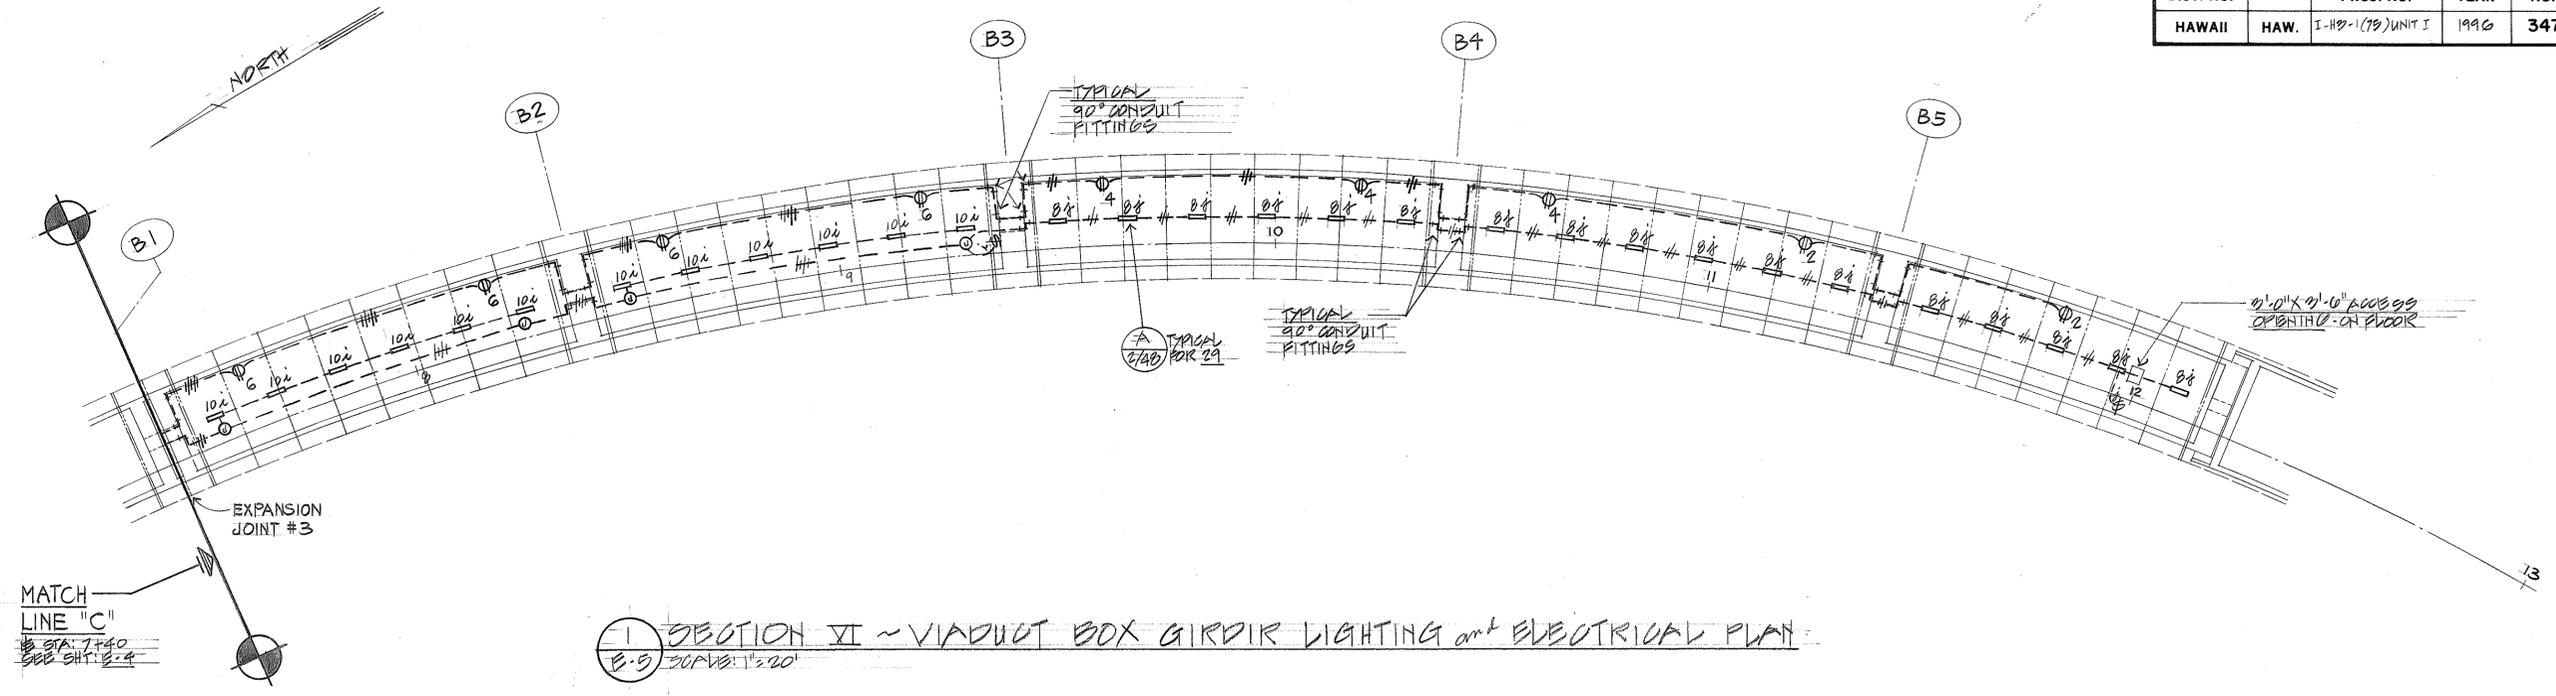

SECTION II - VIADUCT BOX GIRDER LIGHTING and ELECTRICAL PLAN
 E-9 SCALE: 1/8" = 1'-0"

- GENERAL NOTES:**
1. ALL RACEWAYS SHALL BE POLYVINYL CHLORIDE (PVC) SCHEDULE 40.
 2. ALL OUTLET BOXES SHALL BE MOLDED PVC FULLY OFFSET WITH MATCHING WEATHERPROOF COVERS.
 3. ALL JUNCTION BOXES AND PANELS SHALL BE PVC OR FIBERGLASS AND RATED NEMA 4X.
 4. PROVIDE #10 GROUND WIRE MIN. THROUGH OUT ENTIRE RACEWAY SYSTEM UNLESS OTHERWISE NOTED.

LAMP/WATTAGE	DESCRIPTION	MANUFACTURER
2-DRAW 120	FLUORESCENT, SURFACE, 8 1/2" x 7 1/8" x 2 3/4" H. VAPOR-TIGHT, FULLY ENCLOSED, HIGH IMPACT THERMO-PLASTIC BODY IN HIGH IMPACT ACRYLIC ENCLOSURE. CONTINUOUS COMPRESSIBLE NEOPRENE GASKET TO SEAL ENCLOSURE TO BODY. UL LISTED, DAMP AND WET LOCATIONS. SIX PLASTIC TAB LATCHES. INTERNAL STEEL HIKING COMPARTMENT FINISHED BY WHITE POLYESTER POWDER COATING. ESD NUMBER: 2774.	WEST-BRITTO VAPORLIGHT SERIES PERCENTUAL LIGHTING PRODUCTS SERIES OR APPROVED EQUAL.

LIGHT FIXTURE TYPE "A"
 E-9 NOT TO SCALE

RICHARD Y. OKITA
 LICENSED PROFESSIONAL ENGINEER
 No. 1300-E
 HAWAII, U.S.A.

THIS WORK WAS PREPARED BY ME OR UNDER MY SUPERVISION AND CONSTRUCTION OF THIS PROJECT WILL BE UNDER MY SUPERVISION

R. Okita

STATE OF HAWAII
 DEPARTMENT OF TRANSPORTATION
 HIGHWAYS DIVISION

SECTION II - VIADUCT BOX
 GIRDER LIGHTING and ELECTRICAL PLAN
 KANEHOE INTERCHANGE
 INTERSTATE ROUTE H-2
 P.A.1. PROJOB NO. I-18-1(79) UNIT I.

SCALE: AS SHOWN DATE: JAN. 1990
 SHEET No. 347 OF 7 SHEETS

SURVEY PLOTTED BY	DATE
DESIGNED BY	
DESIGNED BY	
QUANTITIES BY	
CHECKED BY	
ORIGINAL PLAN	
NOTE BOOK	
NO.	



TRANSFORMER SCHEDULE

TRANSFORMER	KVA	PRIMARY VOLTAGE AND PHASE	PRIMARY FEEDER	SECONDARY VOLTAGE AND PHASE	SECONDARY FEEDER
T-1	3.0	480V, 1Φ	3/4" C, 2-#6, 1-#10 GRD.	120/240V, 1Φ	3/4" C, 3-#10 1-#10 GRD.
T-2	5.0	480V, 1Φ	3/4" C, 2-#6, 1-#10 GRD.	120/240V, 1Φ	3/4" C, 3-#10 1-#10

EXISTING 480Y/277 VOLTS, 3Φ, 4 WIRE
BREAKER MIN. A.I.G. 14,000
SCHEDULE
SCHEDULE MTR 100A MAIN WBS ONLY

CKT. NO.	USE	CIRCUIT BREAKER	CONNECTION WBS (KVA)		MTR
			A	B	
1	PLUGS	2	30	4.2	2
2	VIA DUCT	3	50	13.9	1/0
3	PPB	1	50		2.0
4	VIA DUCT	1	50		13.9
5	TU 30, 39 & 40	3	2.0	2.0	2.0
6	FUTURE TU	3	2.0	2.0	2.0
* PROVIDE NEW 2P30A DISC. BREAKER IN EXISTING SPACE.			TOTAL LOAD/PHASE	29.1	22.2
** PROVIDE NEW WIRES			TOTAL	70.0	KVA
			DEMAND FACTOR	0.8	
			DEMAND LOAD	56.0	KVA

NOTES:
1. CONTRACTOR TO VERIFY PANEL MANUFACTURER & PROVIDE NEW MATCHING CIRCUIT BREAKER.

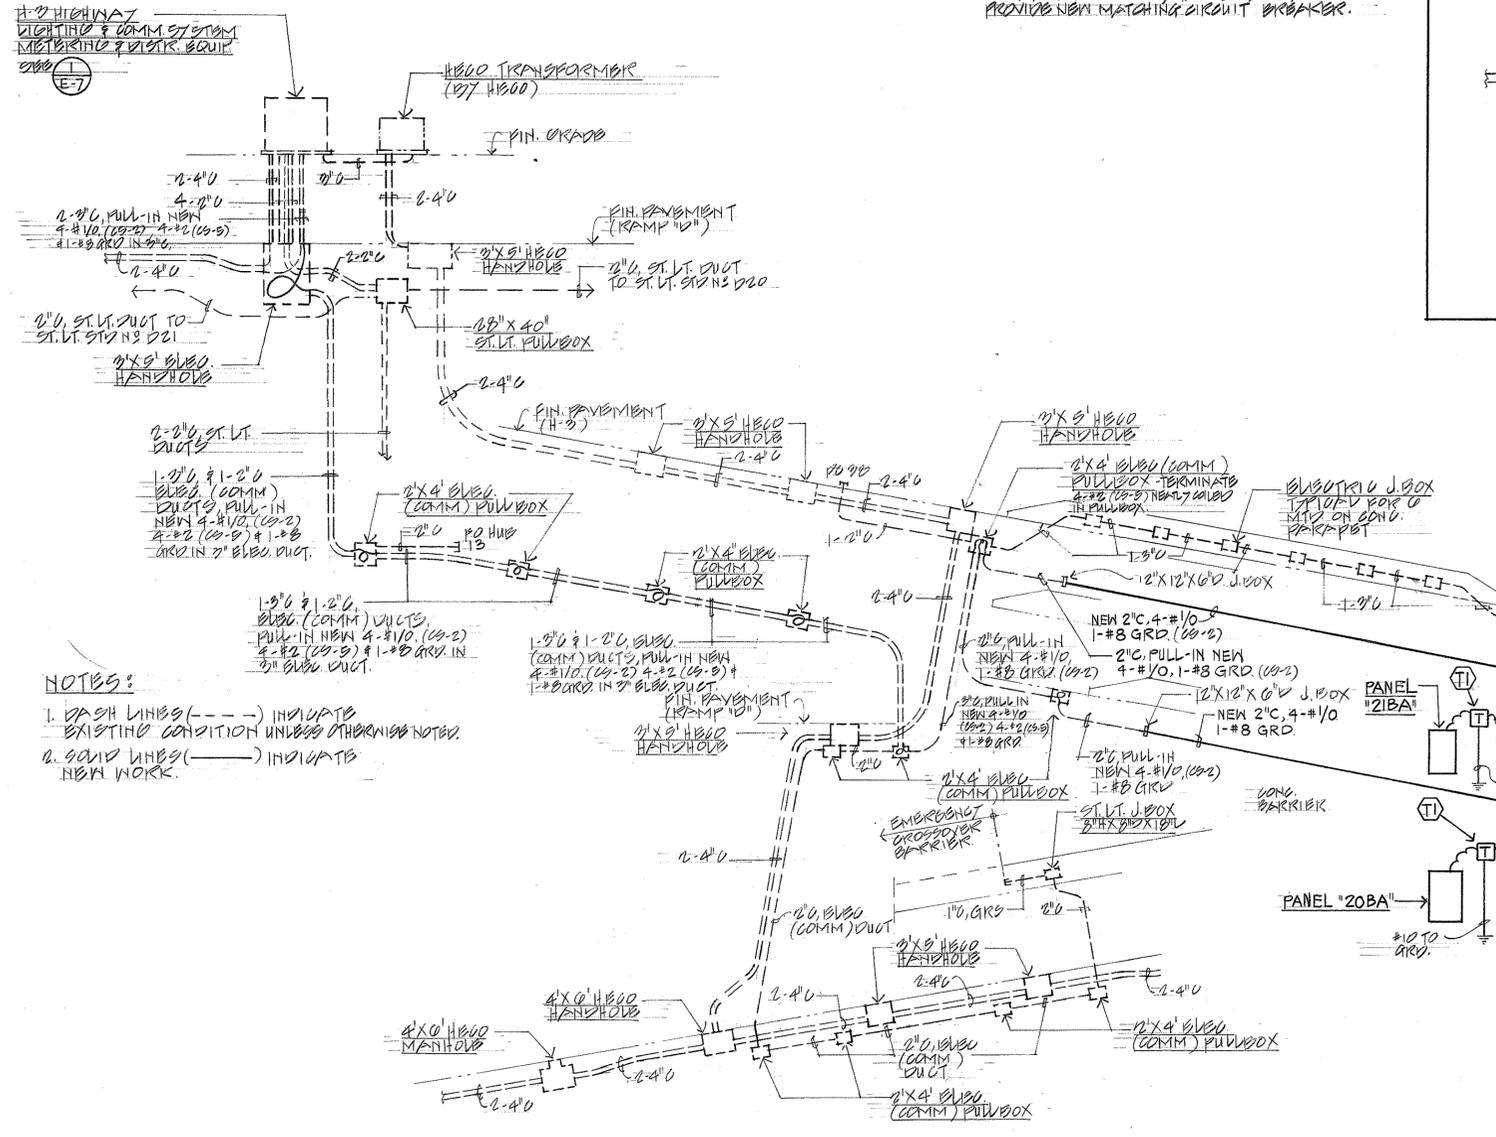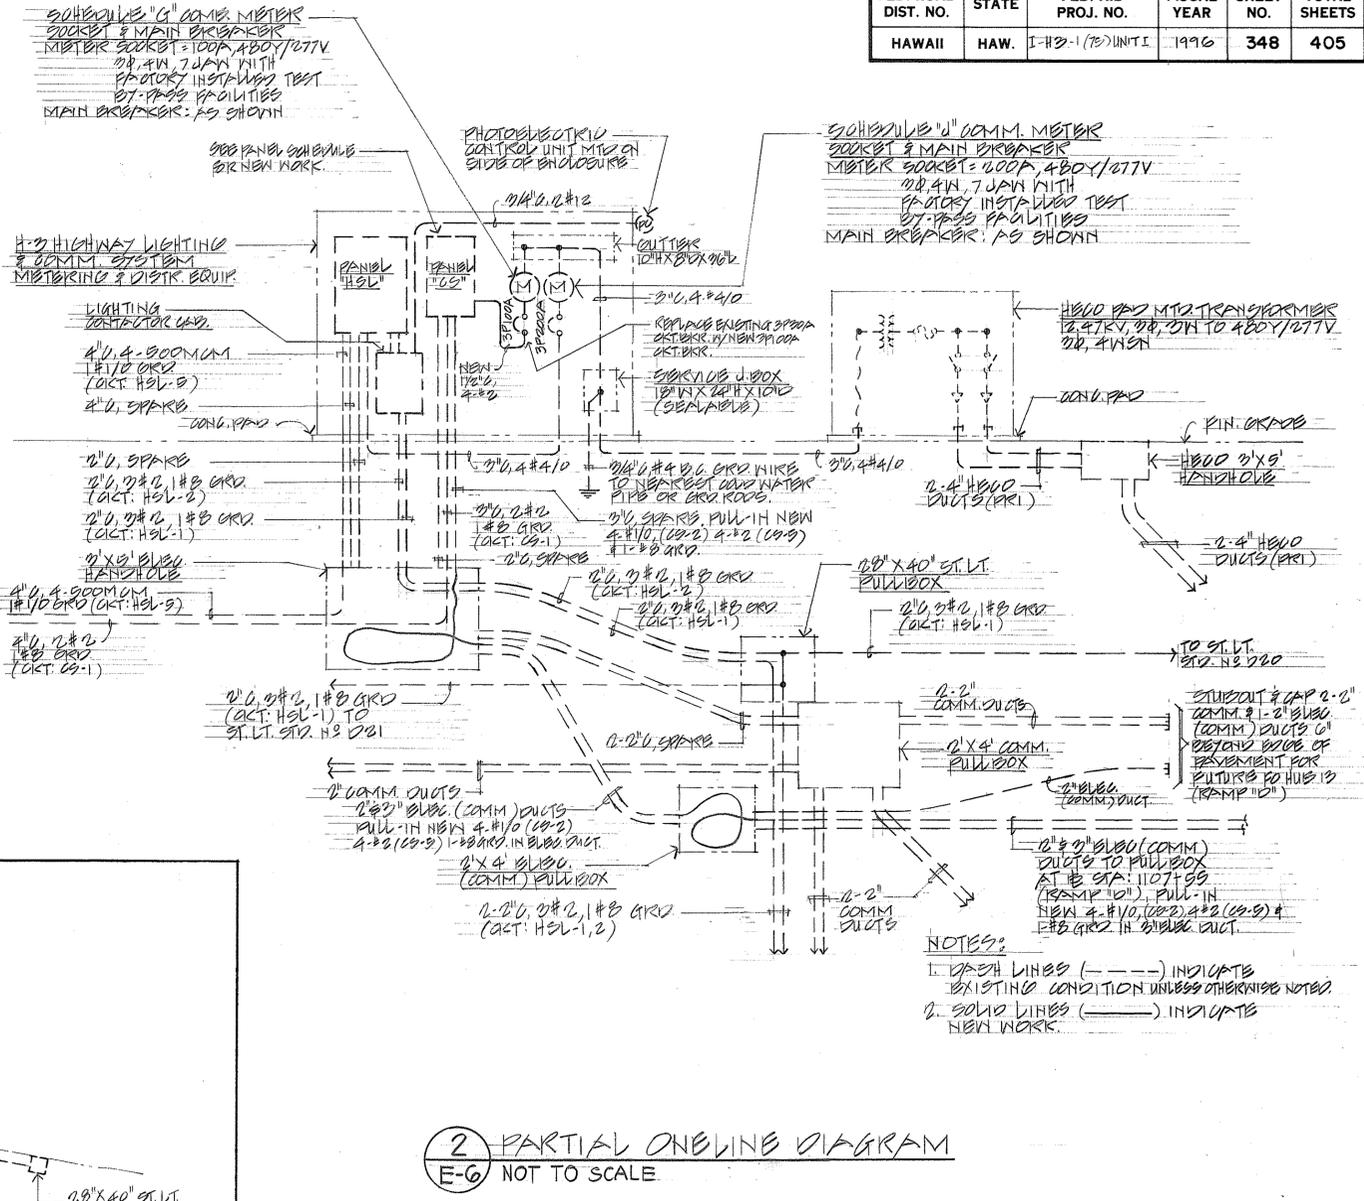

NOTES:
1. DASH LINES (---) INDICATE EXISTING CONDITION UNLESS OTHERWISE NOTED.
2. SOLID LINES (—) INDICATE NEW WORK.

FED. ROAD DIST. NO.	STATE	FED. AID PROJ. NO.	FISCAL YEAR	SHEET NO.	TOTAL SHEETS
HAWAII	HAW.	I-13-1 (75) UNIT I	1996	348	405

DATE	_____
SURVEY PLOTTED BY	_____
DRAWN BY	_____
DESIGNED BY	_____
QUANTITIES BY	_____
CHECKED BY	_____
NOTE BOOK	_____
NO.	_____




STATE OF HAWAII
DEPARTMENT OF TRANSPORTATION
HIGHWAYS DIVISION
ELECTRICAL DISTRIBUTION ONE-LINE DIAGRAM AND ONE-LINE DIAGRAM
KANOHU INTERCHANGE
INTERSTATE ROUTE H-3
F.A.I. PROJECT NO. I-13-1 (75) UNIT I
SCALE = AS NOTED DATE = JAN. 1996
SHEET No. EG OF 7 SHEETS

THIS WORK WAS PREPARED BY ME OR UNDER MY SUPERVISION AND CONSTRUCTION OF THIS PROJECT WILL BE UNDER MY SUPERVISION
R. Ohta

FED. ROAD DIST. NO.	STATE	FED. AID PROJ. NO.	FISCAL YEAR	SHEET NO.	TOTAL SHEETS
HAWAII	HAW.	I-H3-1(75), UNIT I	1996	C.O.349 S-1	405

ELECTRICAL SYMBOLS



EXISTING	NEW	DESCRIPTION
		HIGHWAY LIGHTING PULLBOX
		HIGHWAY LIGHTING STANDARD
		UNDERGROUND HIGHWAY LIGHTING DUCTLINE
		EXPOSED GALVANIZED RIGID STEEL CONDUIT AND CONDUCTORS
		TEMPORARY OVERHEAD SECONDARY CONDUCTORS
		POLE GUY AND ANCHOR

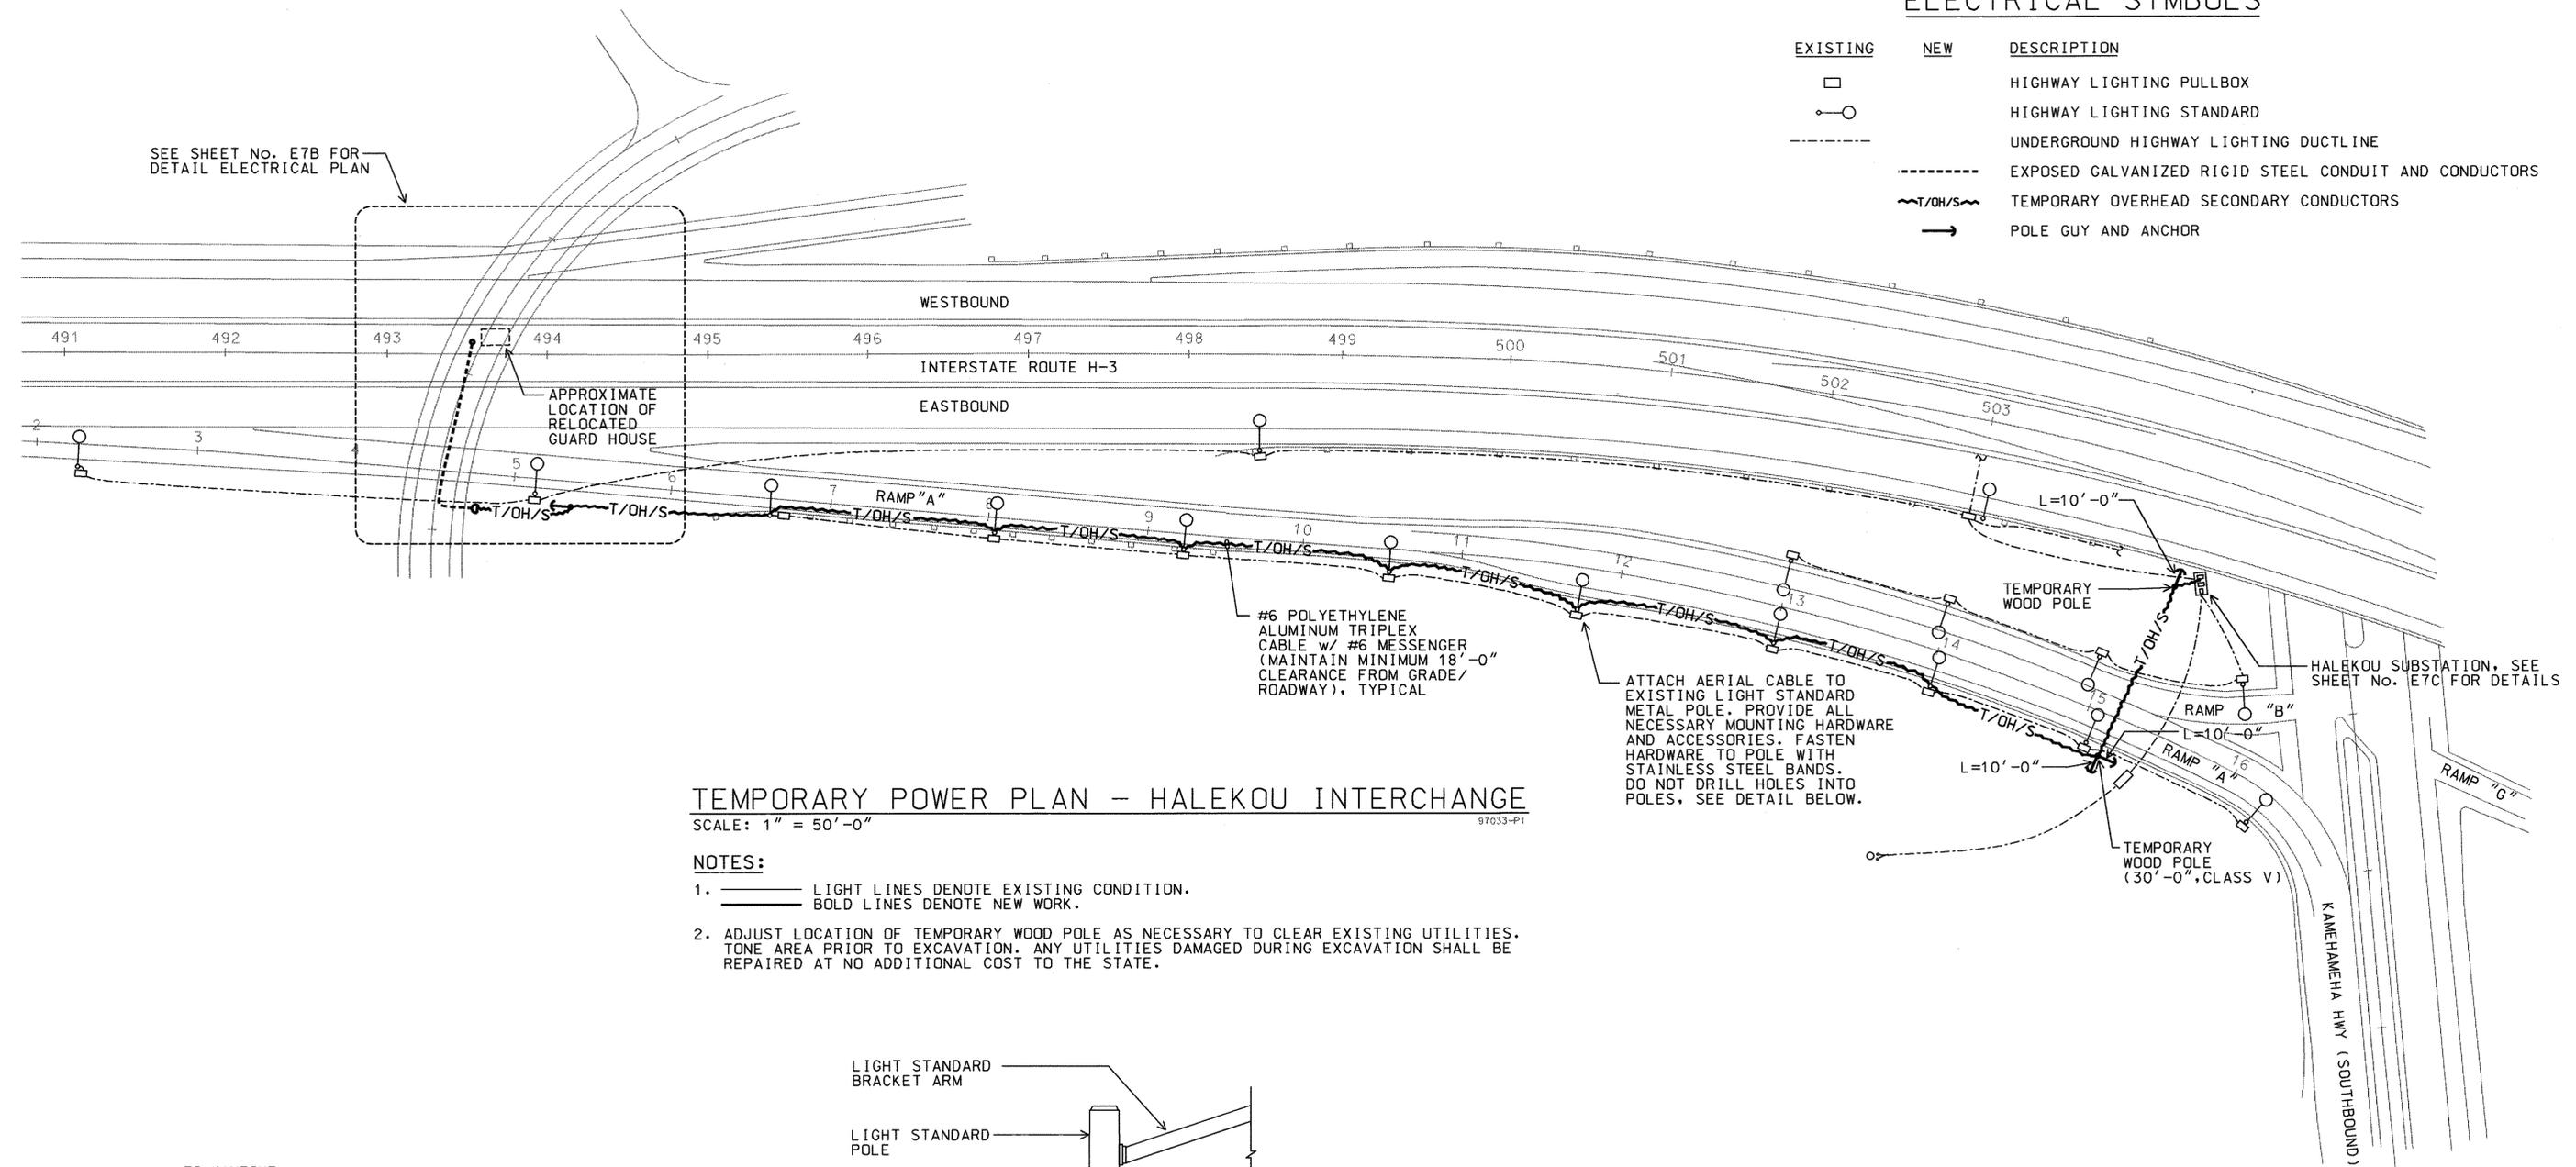


TEMPORARY POWER PLAN - HALEKOU INTERCHANGE

SCALE: 1" = 50'-0"

- NOTES:**
1. LIGHT LINES DENOTE EXISTING CONDITION. BOLD LINES DENOTE NEW WORK.
 2. ADJUST LOCATION OF TEMPORARY WOOD POLE AS NECESSARY TO CLEAR EXISTING UTILITIES. TONE AREA PRIOR TO EXCAVATION. ANY UTILITIES DAMAGED DURING EXCAVATION SHALL BE REPAIRED AT NO ADDITIONAL COST TO THE STATE.

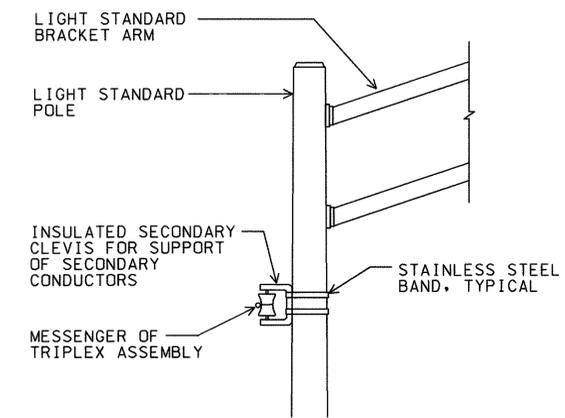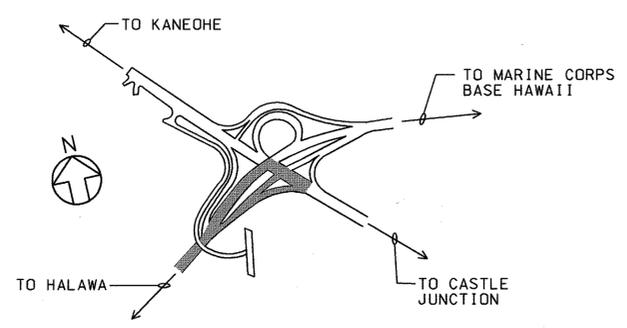

SECONDARY CLEVIS MOUNTING DETAIL
NTS 97033-06

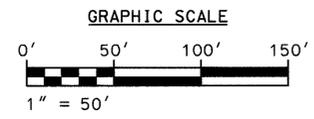


THIS WORK WAS PREPARED BY ME OR UNDER MY SUPERVISION.
R.C. Katahara 3/4/97
MK ENGINEERS, LTD.

ADDED THIS SHEET	
DATE	REVISION
STATE OF HAWAII DEPARTMENT OF TRANSPORTATION HIGHWAYS DIVISION SECURITY GUARD HOUSE AT HALEKOU INTERCHANGE	
INTERSTATE ROUTE H-3 FAIP NO. I-H3-1(75), UNIT I	
SCALE: AS NOTED	DATE:
SHEET NO. E7A OF 7 SHEETS	

C.O. 349 S-1


SURVEY PLOTTED BY: _____ DATE: _____
 ORIGINAL DRAWN BY: _____
 NOTE BOOK DESIGNED BY: _____
 CHECKED BY: _____
 No. _____

FED. ROAD DIST. NO.	STATE	FED. AID PROJ. NO.	FISCAL YEAR	SHEET NO.	TOTAL SHEETS
HAWAII	HAW.	I-H3-1(75), UNIT I	1996	C.O.349 S-2	405

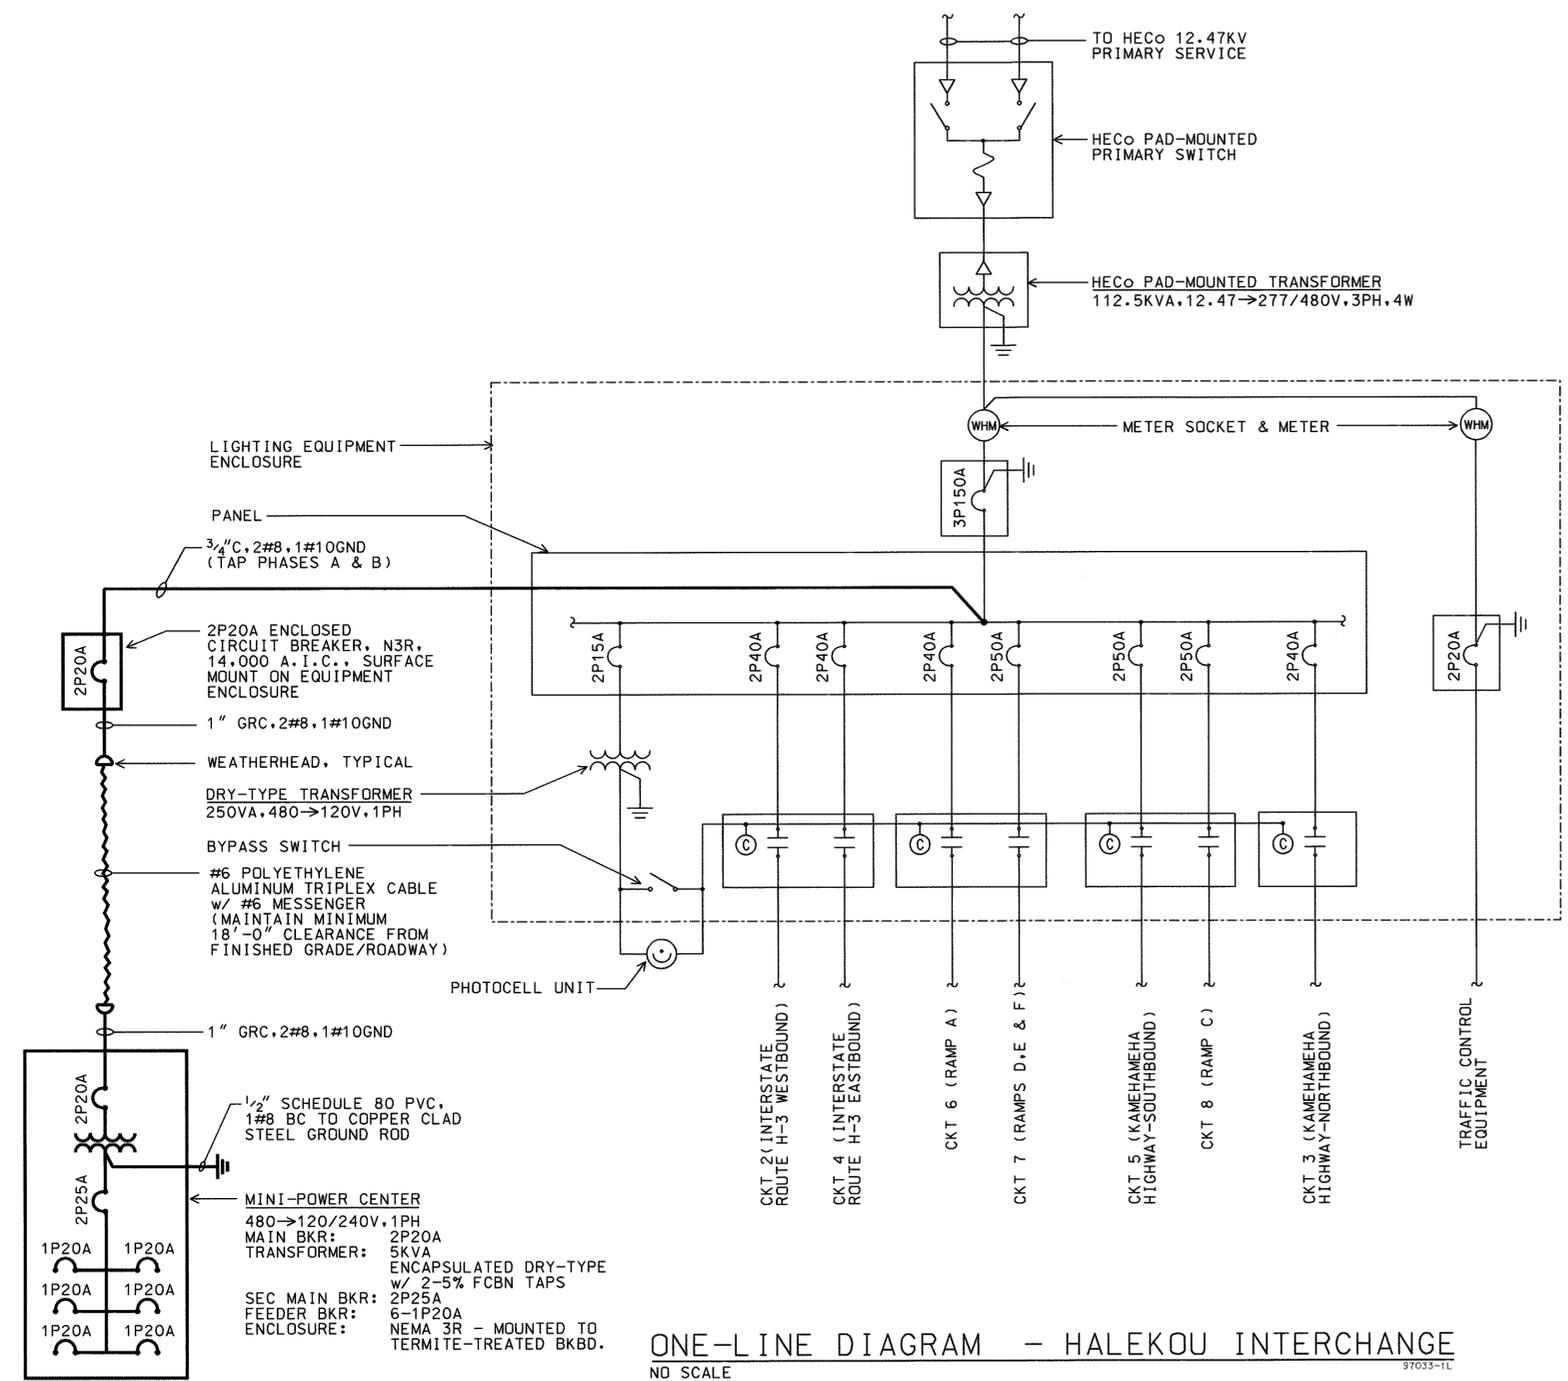



ONE-LINE DIAGRAM - HALEKOU INTERCHANGE
NO SCALE 97033-1L

- NOTES:**
1. LIGHT LINES DENOTE EXISTING CONDITION.
 BOLD LINES DENOTE NEW WORK.

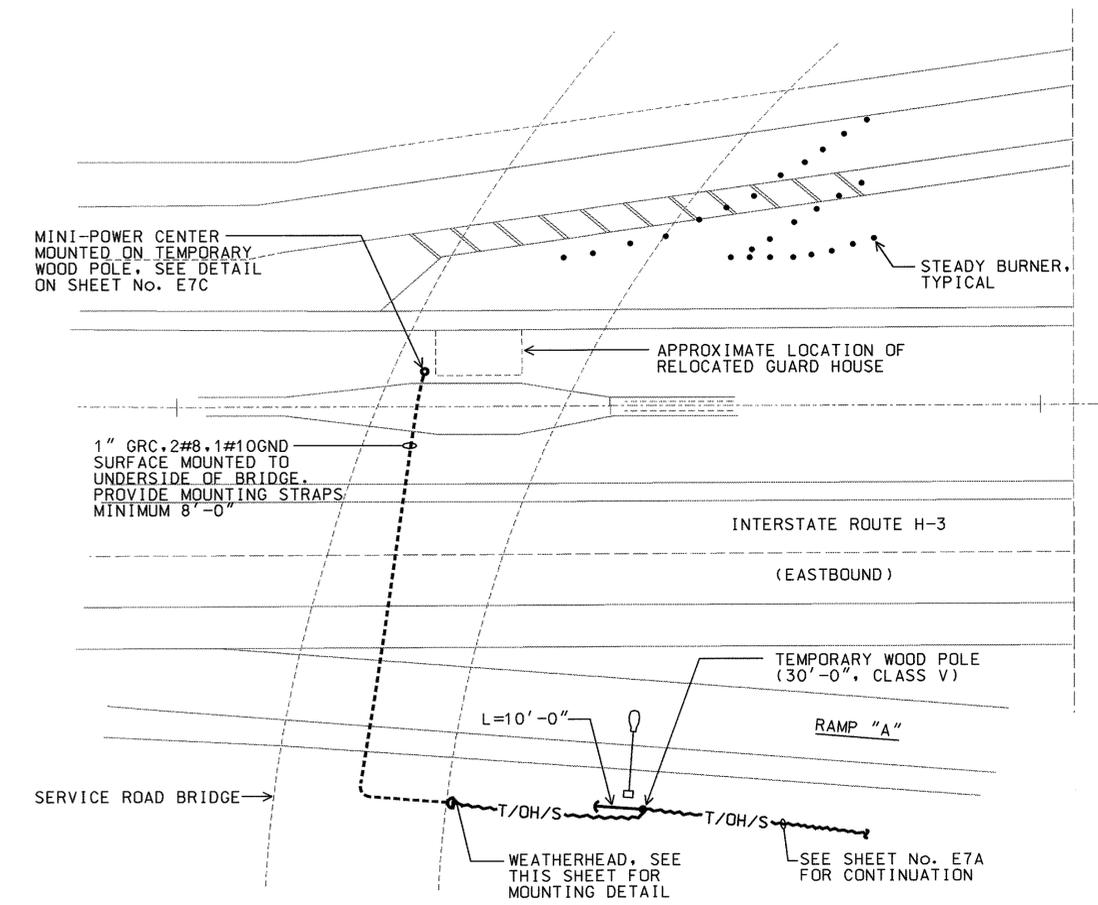

DETAIL ELECTRICAL PLAN - RELOCATED GUARD HOUSE
SCALE: 1" = 20'-0" 97033-01

- NOTES:**
1. LIGHT LINES DENOTE EXISTING CONDITION.
 BOLD LINES DENOTE NEW WORK.

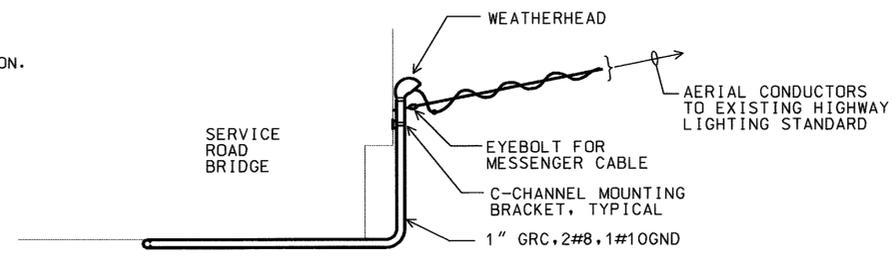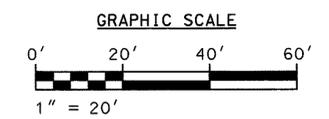

WEATHERHEAD DETAIL @ SERVICE ROAD BRIDGE
NTS 97033-02

SURVEY PLOTTED BY _____ DATE _____
 ORIGINAL PLAN DRAWN BY _____
 NOTE BOOK NO. _____
 CHECKED BY _____
 No. _____



THIS WORK WAS PREPARED BY ME OR UNDER MY SUPERVISION.
R.C. KATAHARA 3/4/97
MK ENGINEERS, LTD.

ADDED THIS SHEET	
DATE	REVISION
STATE OF HAWAII DEPARTMENT OF TRANSPORTATION HIGHWAYS DIVISION SECURITY GUARD HOUSE AT HALEKOU INTERCHANGE	
INTERSTATE ROUTE H-3 FAIP NO. I-H3-1(75), UNIT I	
SCALE: AS NOTED	DATE:
SHEET NO. E7B OF 7 SHEETS	

C.O. 349 S-2

