
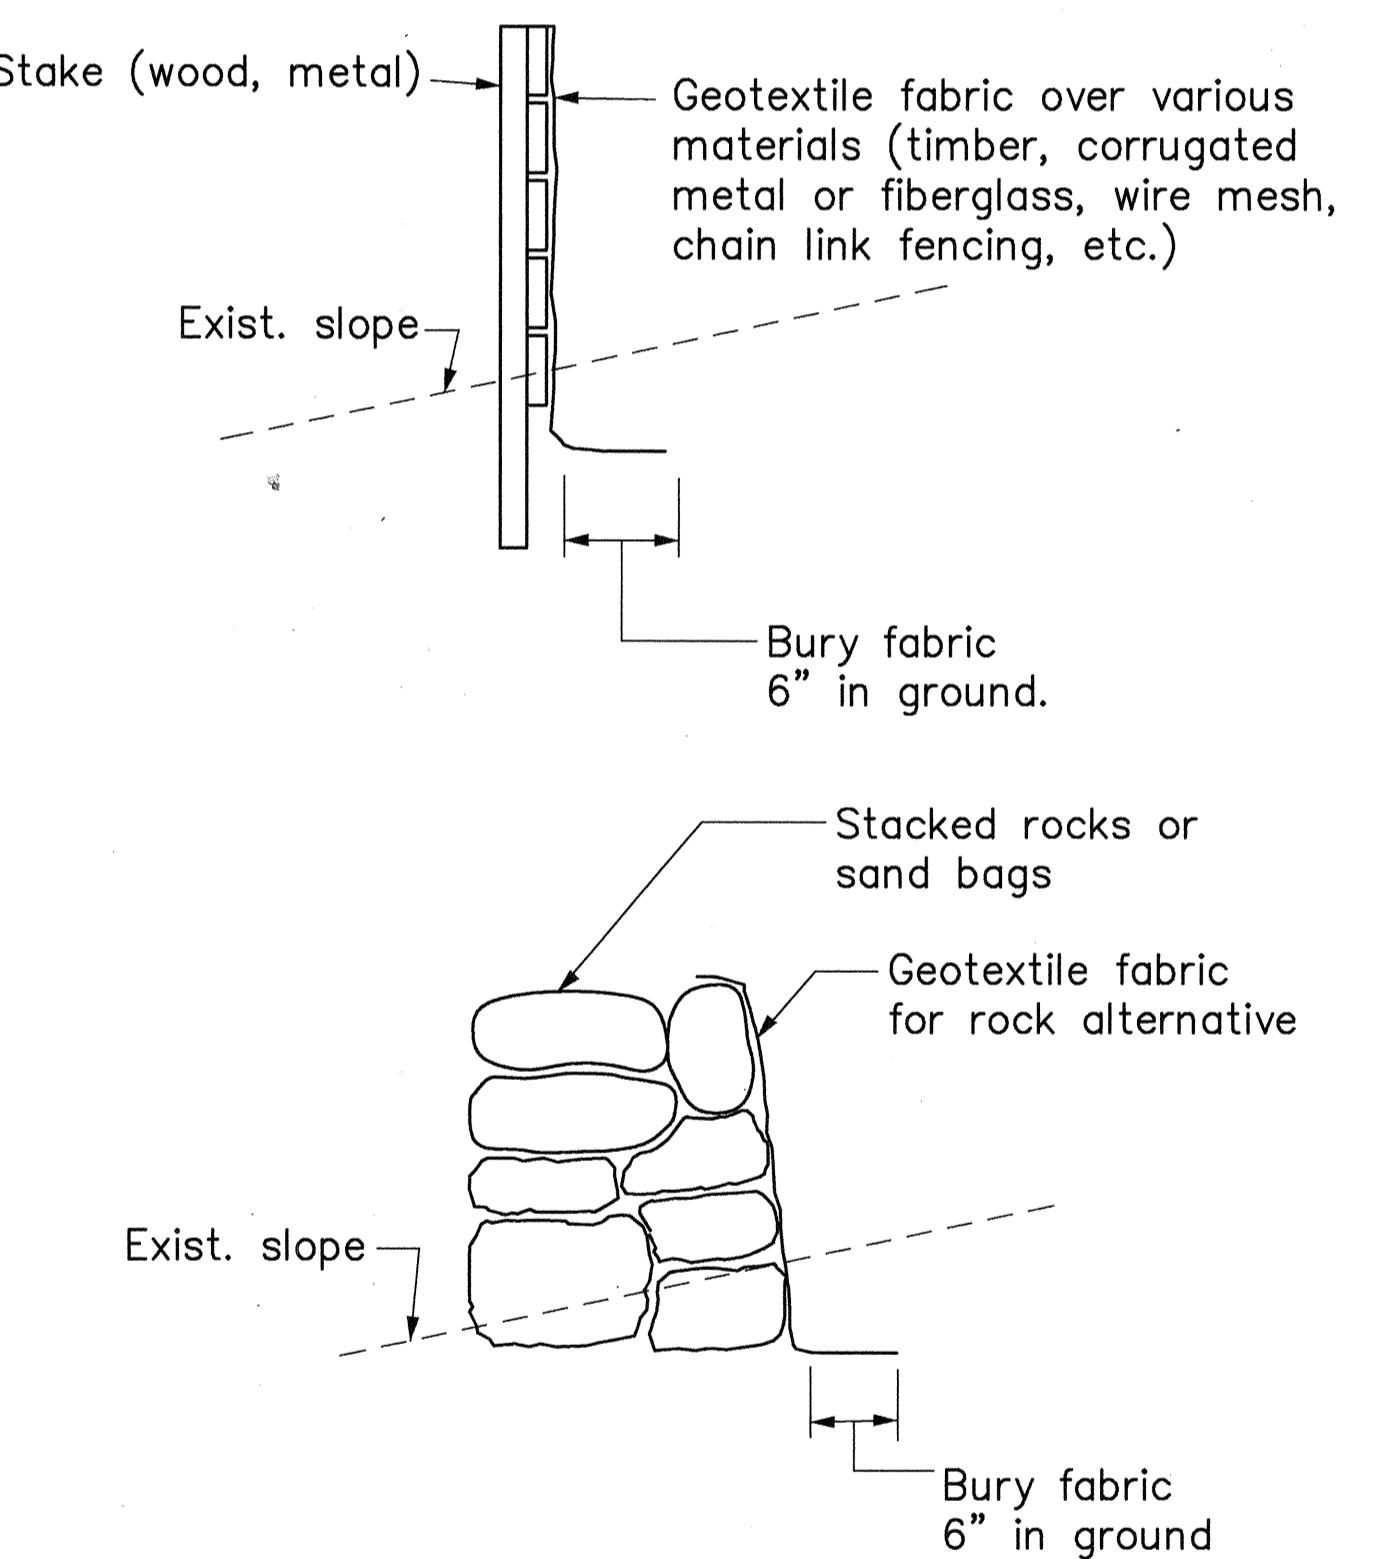
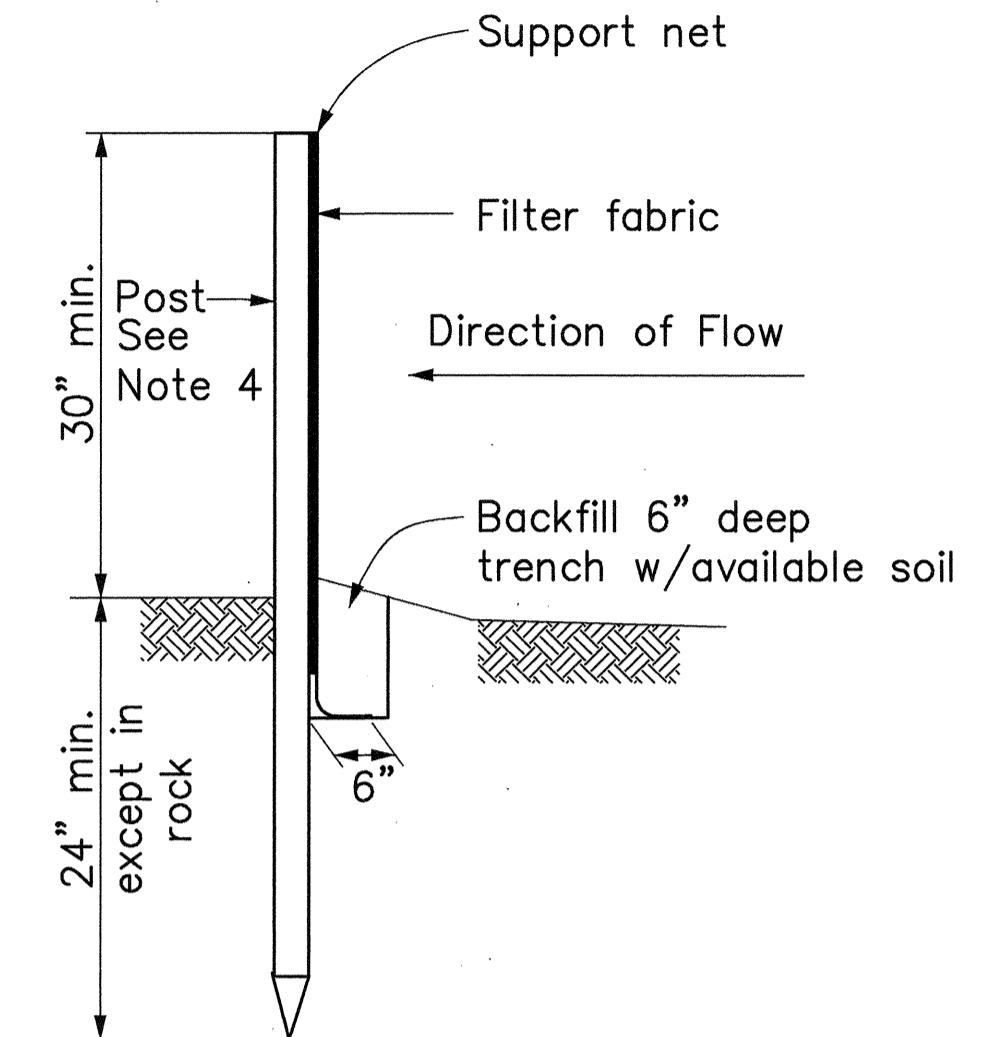


FED. ROAD DIST. NO.	STATE	FED. AID PROJ. NO.	FISCAL YEAR	SHEET NO.	TOTAL SHEETS
HAWAII	HAW.	I-H3-1(74)	1993	123	325

GRADING NOTES

- All grading work shall be done in accordance with Chapter 23, Grading, Soil Erosion and Sediment Control of the Revised Ordinances of Honolulu, 1978, as amended (Ordinance Nos. 81-13 and 90-71).
- The Contractor shall remove all silt and debris resulting from his work and deposited in drainage facilities, roadways and other areas. The costs incurred for any necessary remedial action by the Chief Engineer shall be payable by the Contractor.
- The Contractor, at his own expense, shall keep the project area and surrounding area free from dust and other nuisance. The work shall be in conformance with the air pollution standards and regulations of the State Department of Health.
- All slopes and exposed areas shall be hydro-mulch seeded as soon as final grades have been established in accordance with the Specification and Grading Plan. Planting shall not be delayed until all grading work has been completed. Grading to final grade shall be continuous, and any area within which work has been interrupted or delayed shall be planted.
- Fills on slopes steeper than 5:1 shall be keyed.
- No grading work shall be done on Saturdays, Sundays and Holidays at any time without prior written notice to the Chief Engineer or District Engineer, State of Hawaii.
- The limits of the area to be graded shall be flagged by the Contractor before the commencement of the grading work.
- The City shall be informed of the location of the borrow/disposal site for the project when the application for a grading permit is made. The borrow/disposal site must also fulfill the requirements of the grading ordinance.
- All grading operations shall be performed in conformance with the applicable provisions of Chapter 54, Water Quality Standards, and Chapter 55, Water Pollution Control, of Title 11, Administrative Rules of the State Department of Health.
- Temporary Erosion Control Plan and procedures shall be submitted by the Contractor for approval prior to the start of actual grading operations.
- Excavated material on site which will be exposed for more than 7 days shall be covered with plastic sheets within 2 days of placement or as directed by the Engineer.
- Silt fence shall be installed along the edges of open channels & ditches in order to filter sediment from runoff, before water enters the channel.
- Temporary erosion controls shall not be removed before permanent erosion controls are in-place and established.
- Temporary erosion and pollution control measures, excluding silt fence and hydro-mulch, will be performed on a force account basis and paid for under Item No. 639.0100, Temporary Project Water Pollution Control.

ORIGINAL SURVEY PLOTTED BY _____ DATE _____
DRAWN BY _____ TRACED BY _____ DESIGNED BY _____ QUANTITIES BY _____ CHECKED BY _____
NOTE BOOK No. _____ CAD by E. LEBSACK, 85-52

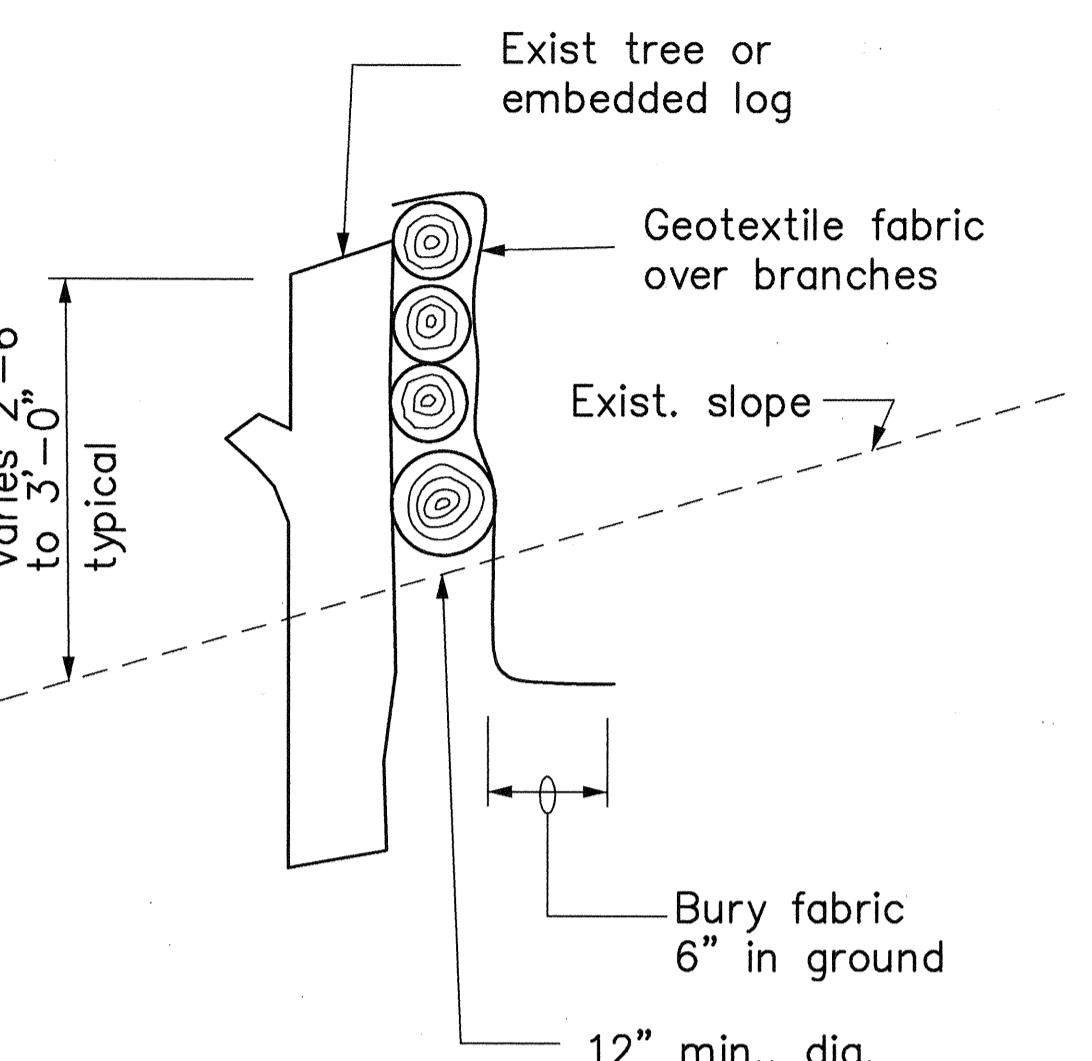

SEDIMENT CONTROL DEVICES AND/OR ENERGY DISSIPATOR

N.T.S.




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Randall M. Uramaki

STATE OF HAWAII DEPARTMENT OF TRANSPORTATION HIGHWAYS DIVISION	
GRADING NOTES	
EROSION & SEDIMENT	
CONTROL MEASURES	
H-3 - HALAWA INTERCHANGE INTERSTATE ROUTE H-3 FAIP NO. I-H3-1(74)	
SCALE: AS SHOWN	DATE: AUGUST 1994
SHEET NO. F-1 OF 9 SHEETS	

FED. ROAD DIST. NO.	STATE	FED. AID PROJ. NO.	FISCAL YEAR	SHEET NO.	TOTAL SHEETS
HAWAII	HAW.	I-H3-1(74)	1993	124	325

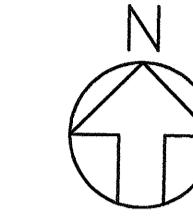

FED. ROAD DIST. NO. **STATE** **FED. AID PROJ. NO.** **FISCAL YEAR** **HEET NO.** **TOTAL SHEETS**

HAWAII	HAW.	I-H3-1(74)	1993	124	325
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MATCH LINE
INTERSTATE ROUTE H-3
STA. 262+00
SEE SHT. NO. F-3

LEGEND:

- Silt Fence

RANDALL M. URASAKI
LICENSED PROFESSIONAL ENGINEER
No. 7269-C
HAWAII, U.S.A.

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Randall M. Urasaki

STATE OF HAWAII
DEPARTMENT OF TRANSPORTATION
HIGHWAYS DIVISION

EROSION CONTROL PLAN
INTERSTATE ROUTE H-3


H-3 – HALAWA INTERCHANGE
INTERSTATE ROUTE H-3
FAIP NO. I-H3-1(74)

SCALE: 1" = 40'
DATE: AUGUST 1994

HEET NO. F-2 OF 9 SHEETS

LEGEND

Silt F

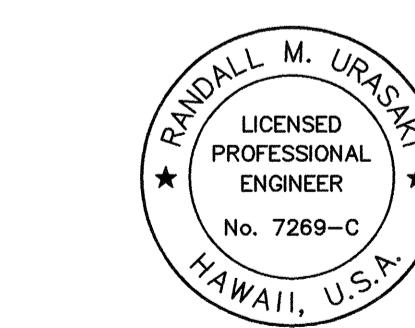

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**STATE OF HAWAII
DEPARTMENT OF TRANSPORTATION
HIGHWAYS DIVISION**

EROSION CONTROL PLAN

INTERSTATE ROUTE H-3

H-3 - HALAWA INTERCHANGE
INTERSTATE ROUTE H-3
FAIP NO. I-H3-1(74)

SCALE: 1" = 40' DATE: AUGUST 1994
SHEET NO. F-2 OF 9 SHEETS

FED. ROAD DIST. NO.	STATE	FED. AID PROJ. NO.	FISCAL YEAR	HEET NO.	TOTAL SHEETS
HAWAII	HAW.	I-H3-1(74)	1993	125	325

N

MATCH LINE H-3
STA. 262+00
SEE SHT. NO. F-2

10+00
RAMP K B

Limit of Grading


Silt Fence

ORIGINAL SURVEY PLOTTED BY:	DATE
DRAWN BY	
TRACED BY	
DESIGNED BY	
NOTE BOOK QUANTITIES BY	
CHECKED BY	
No.	

CAD by S. Chang 85-52

LEGEND:

Silt Fence

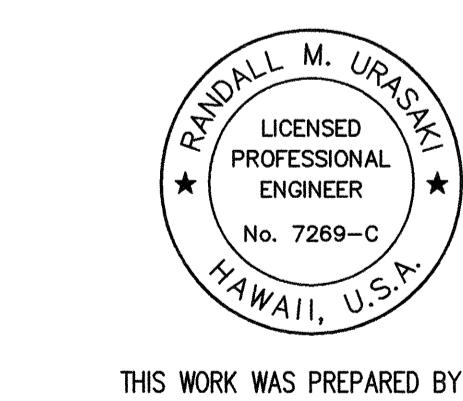


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STATE OF HAWAII
DEPARTMENT OF TRANSPORTATION
HIGHWAYS DIVISION



EROSION CONTROL PLAN INTERSTATE ROUTE H-3

H-3 - HALAWA INTERCHANGE
INTERSTATE ROUTE H-3
FAIP NO. I-H3-1(74)

SCALE: 1" = 40'
DATE: AUGUST 1994
SHEET NO. F-3 OF 9 SHEETS

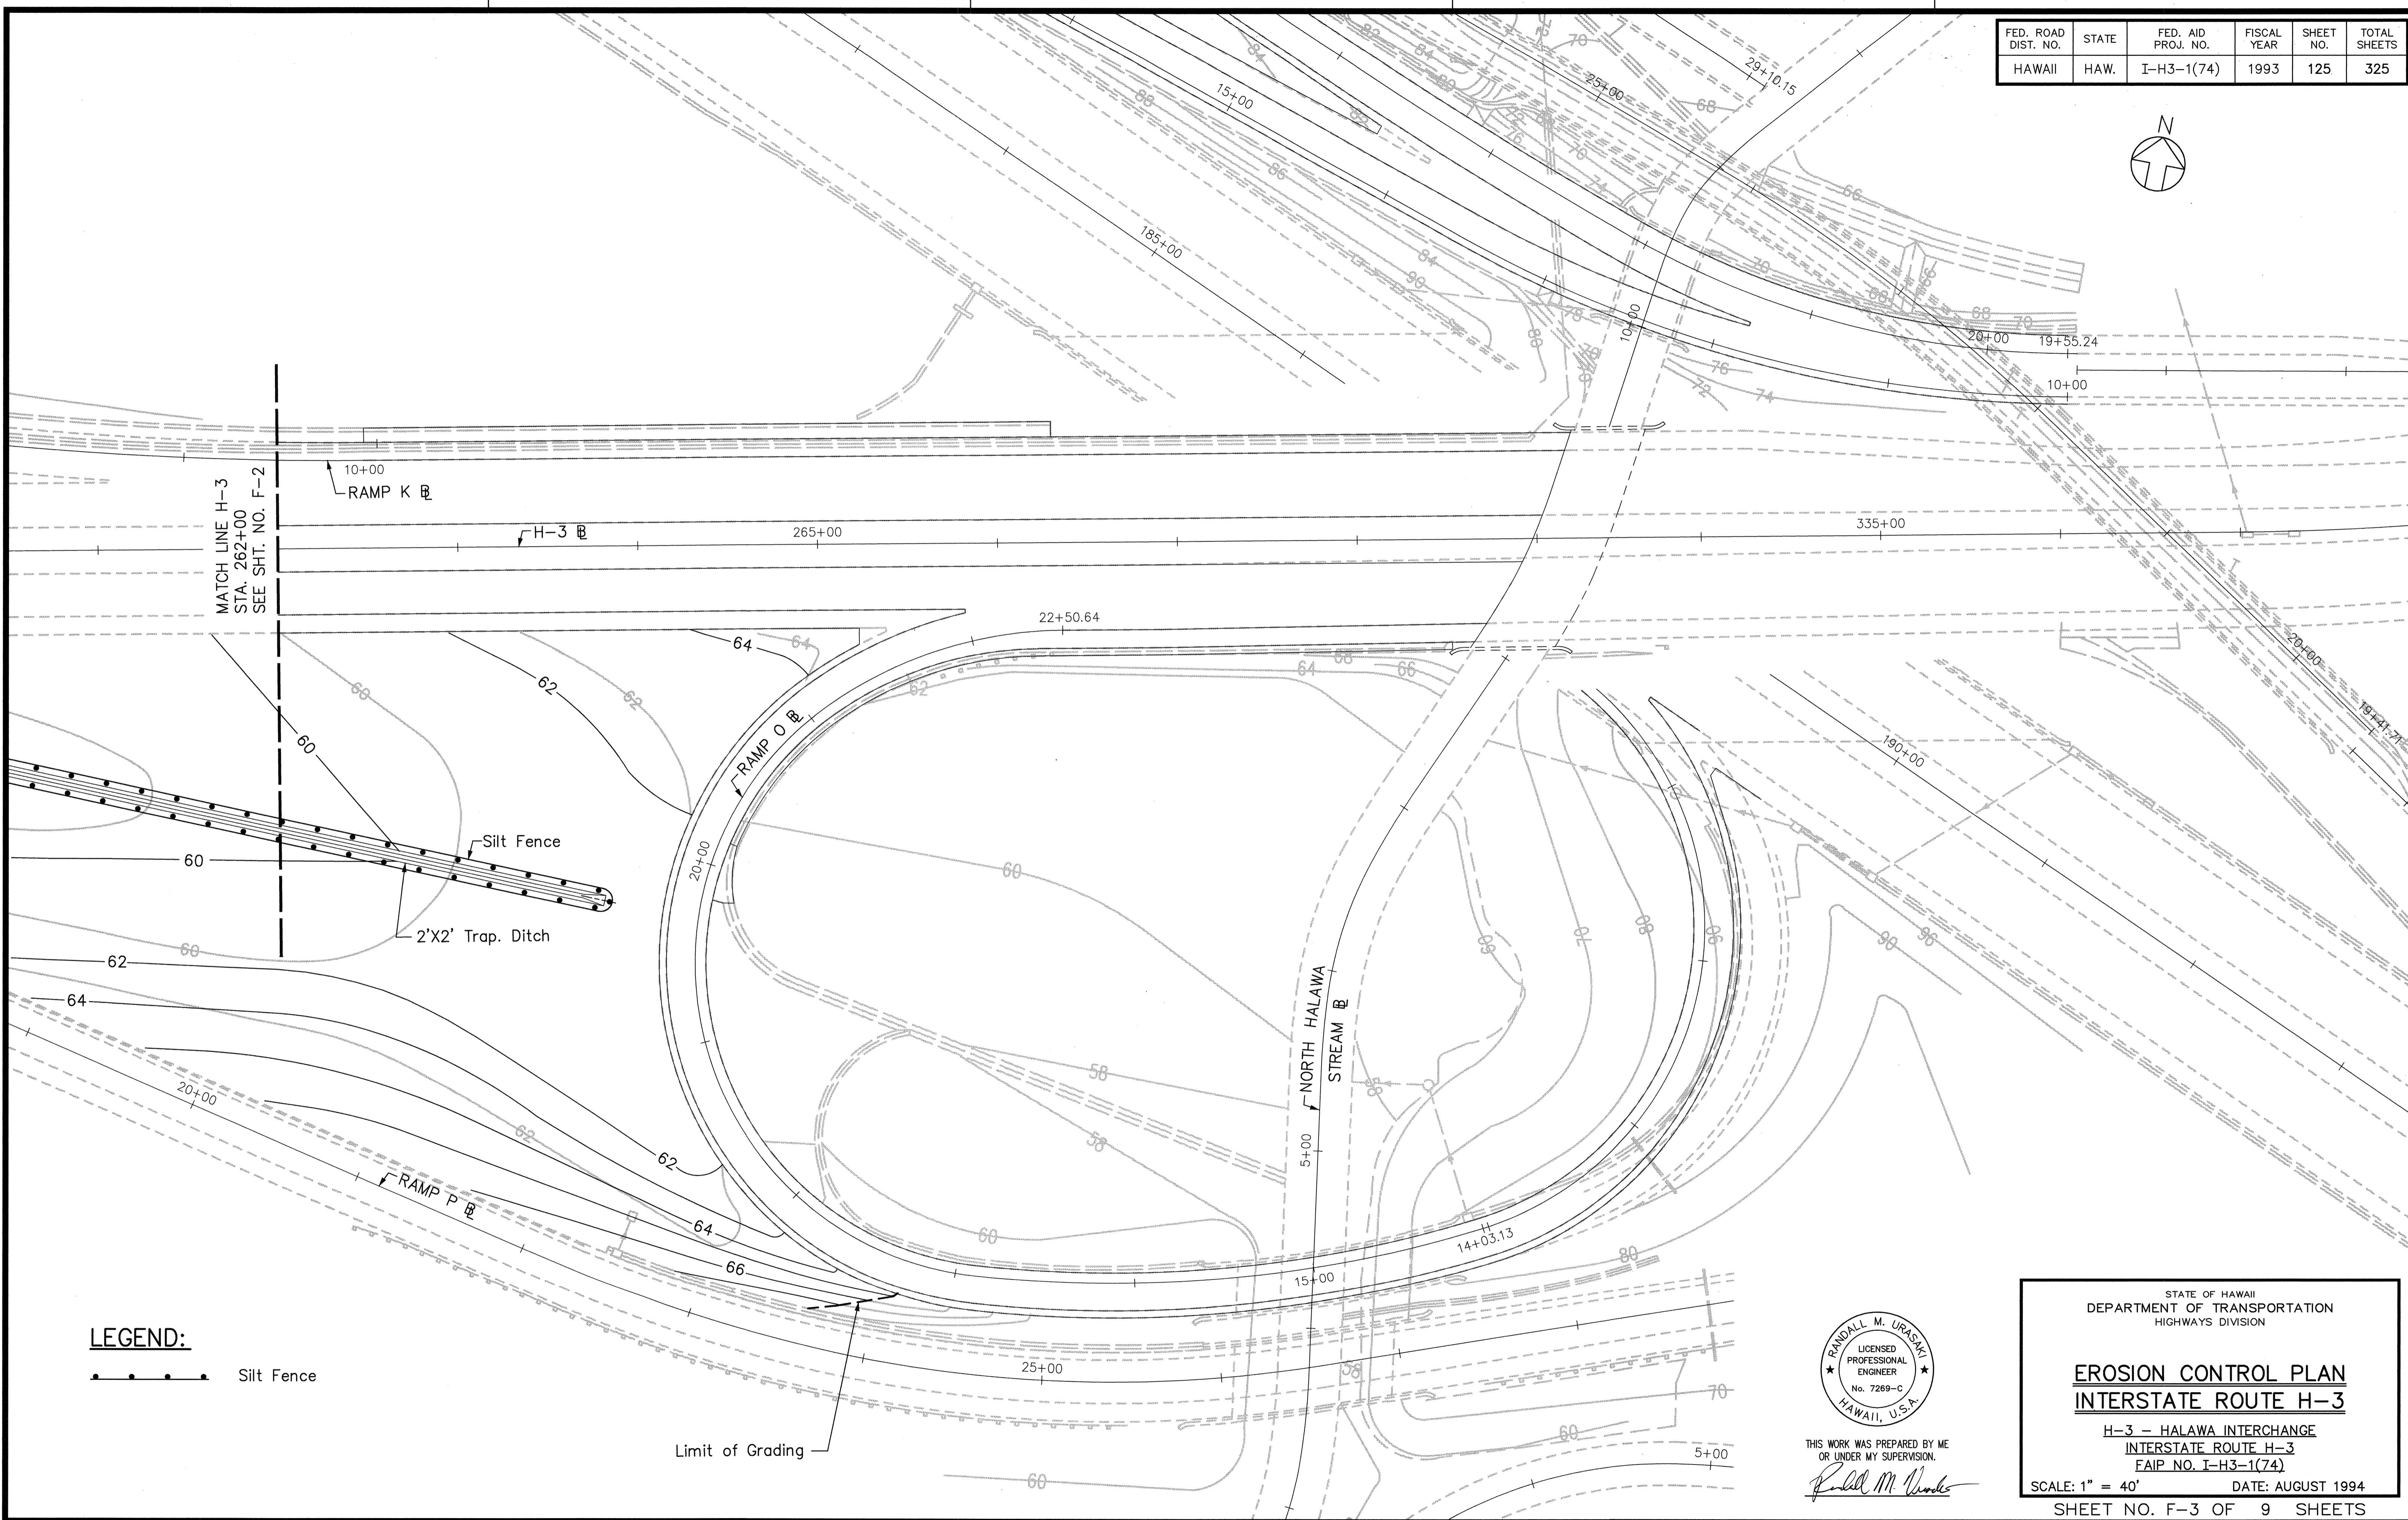

FED. ROAD DIST. NO.	STATE	FED. AID PROJ. NO.	FISCAL YEAR	SHEET NO.	TOTAL SHEETS
HAWAII	HAW.	I-H3-1(74)	1993	126	325

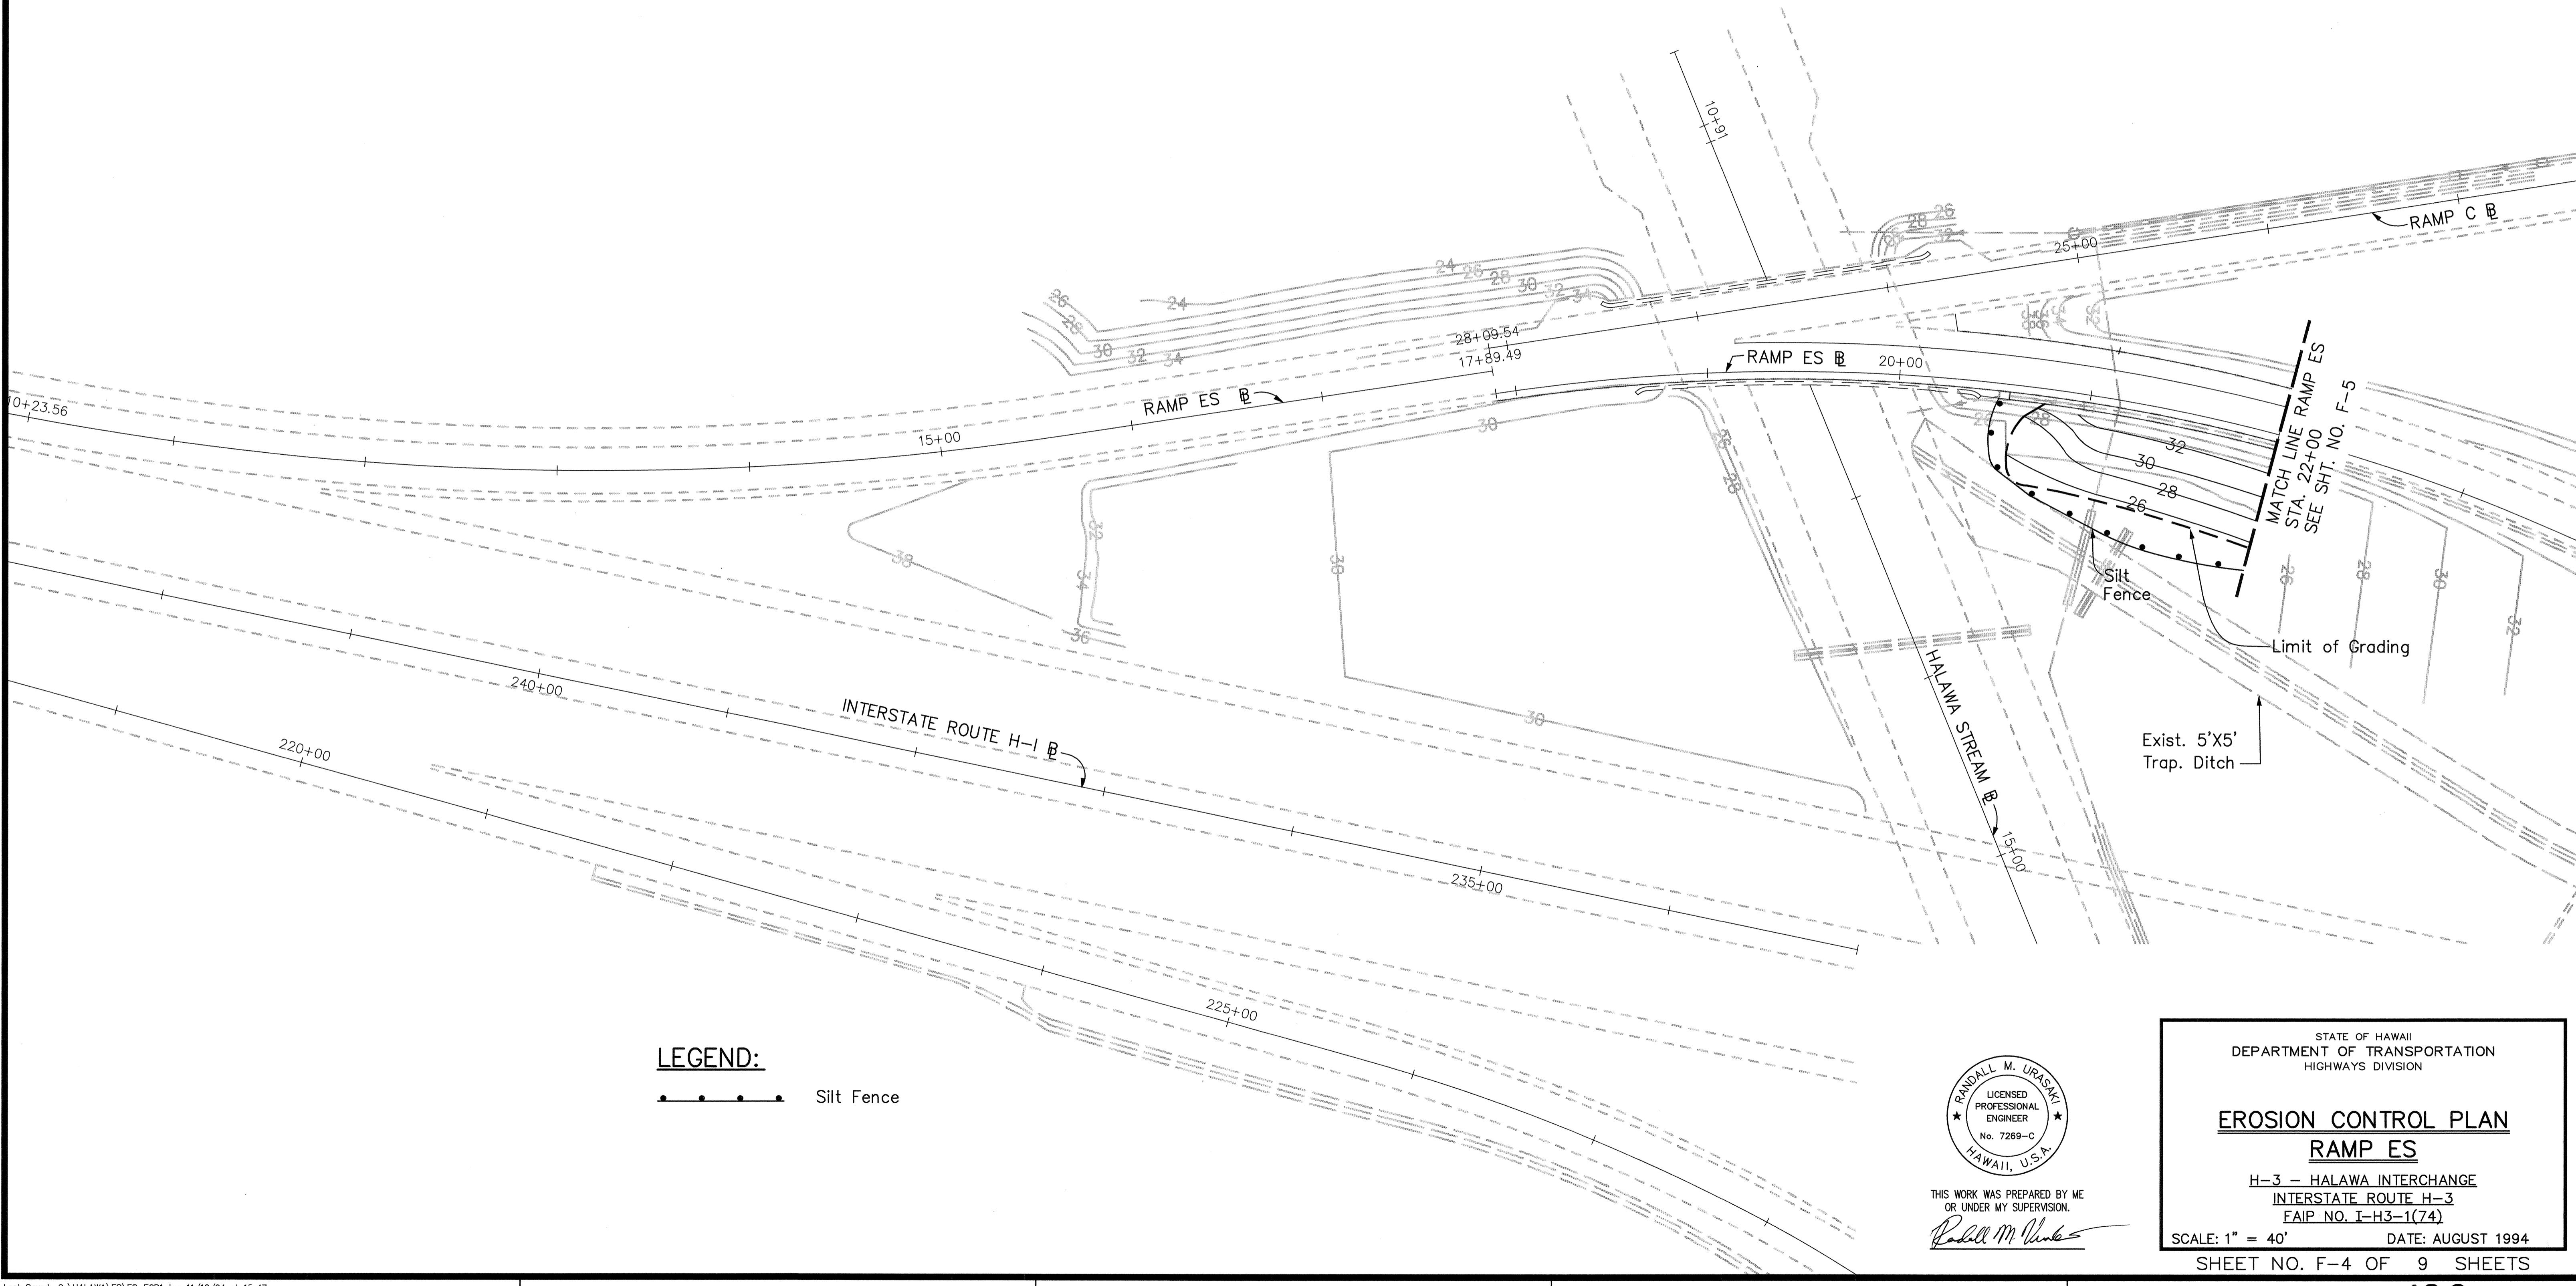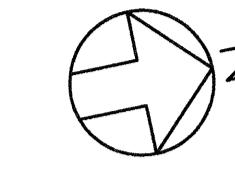


ORIGINAL PLAN	SURVEY PLOTTED BY _____	DATE _____
	DRAWN BY _____	" _____
	TRACED BY _____	" _____
NOTE BOOK	DESIGNED BY _____	" _____
No. _____	QUANTITIES BY _____	" _____
	CHECKED BY _____	" _____

CAD by S. Chong,

LEGEND

 Silt Fence

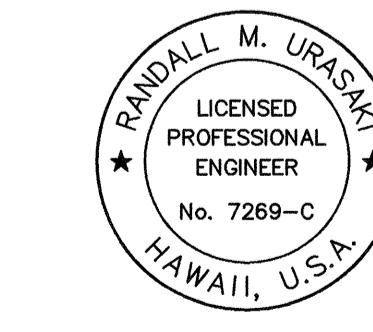

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**STATE OF HAWAII
DEPARTMENT OF TRANSPORTATION
HIGHWAYS DIVISION**


EROSION CONTROL PLAN

RAMP ES




H-3 - HALAWA INTERCHANGE
INTERSTATE ROUTE H-3
FAIP NO. I-H3-1(74)

SCALE: 1" = 40' DATE: AUGUST 1994
SHEET NO. F-4 OF 9 SHEETS

FED. ROAD DIST. NO.	STATE	FED. AID PROJ. NO.	FISCAL YEAR	SHEET NO.	TOTAL SHEETS
HAWAII	HAW.	I-H3-1(74)	1993	127	325

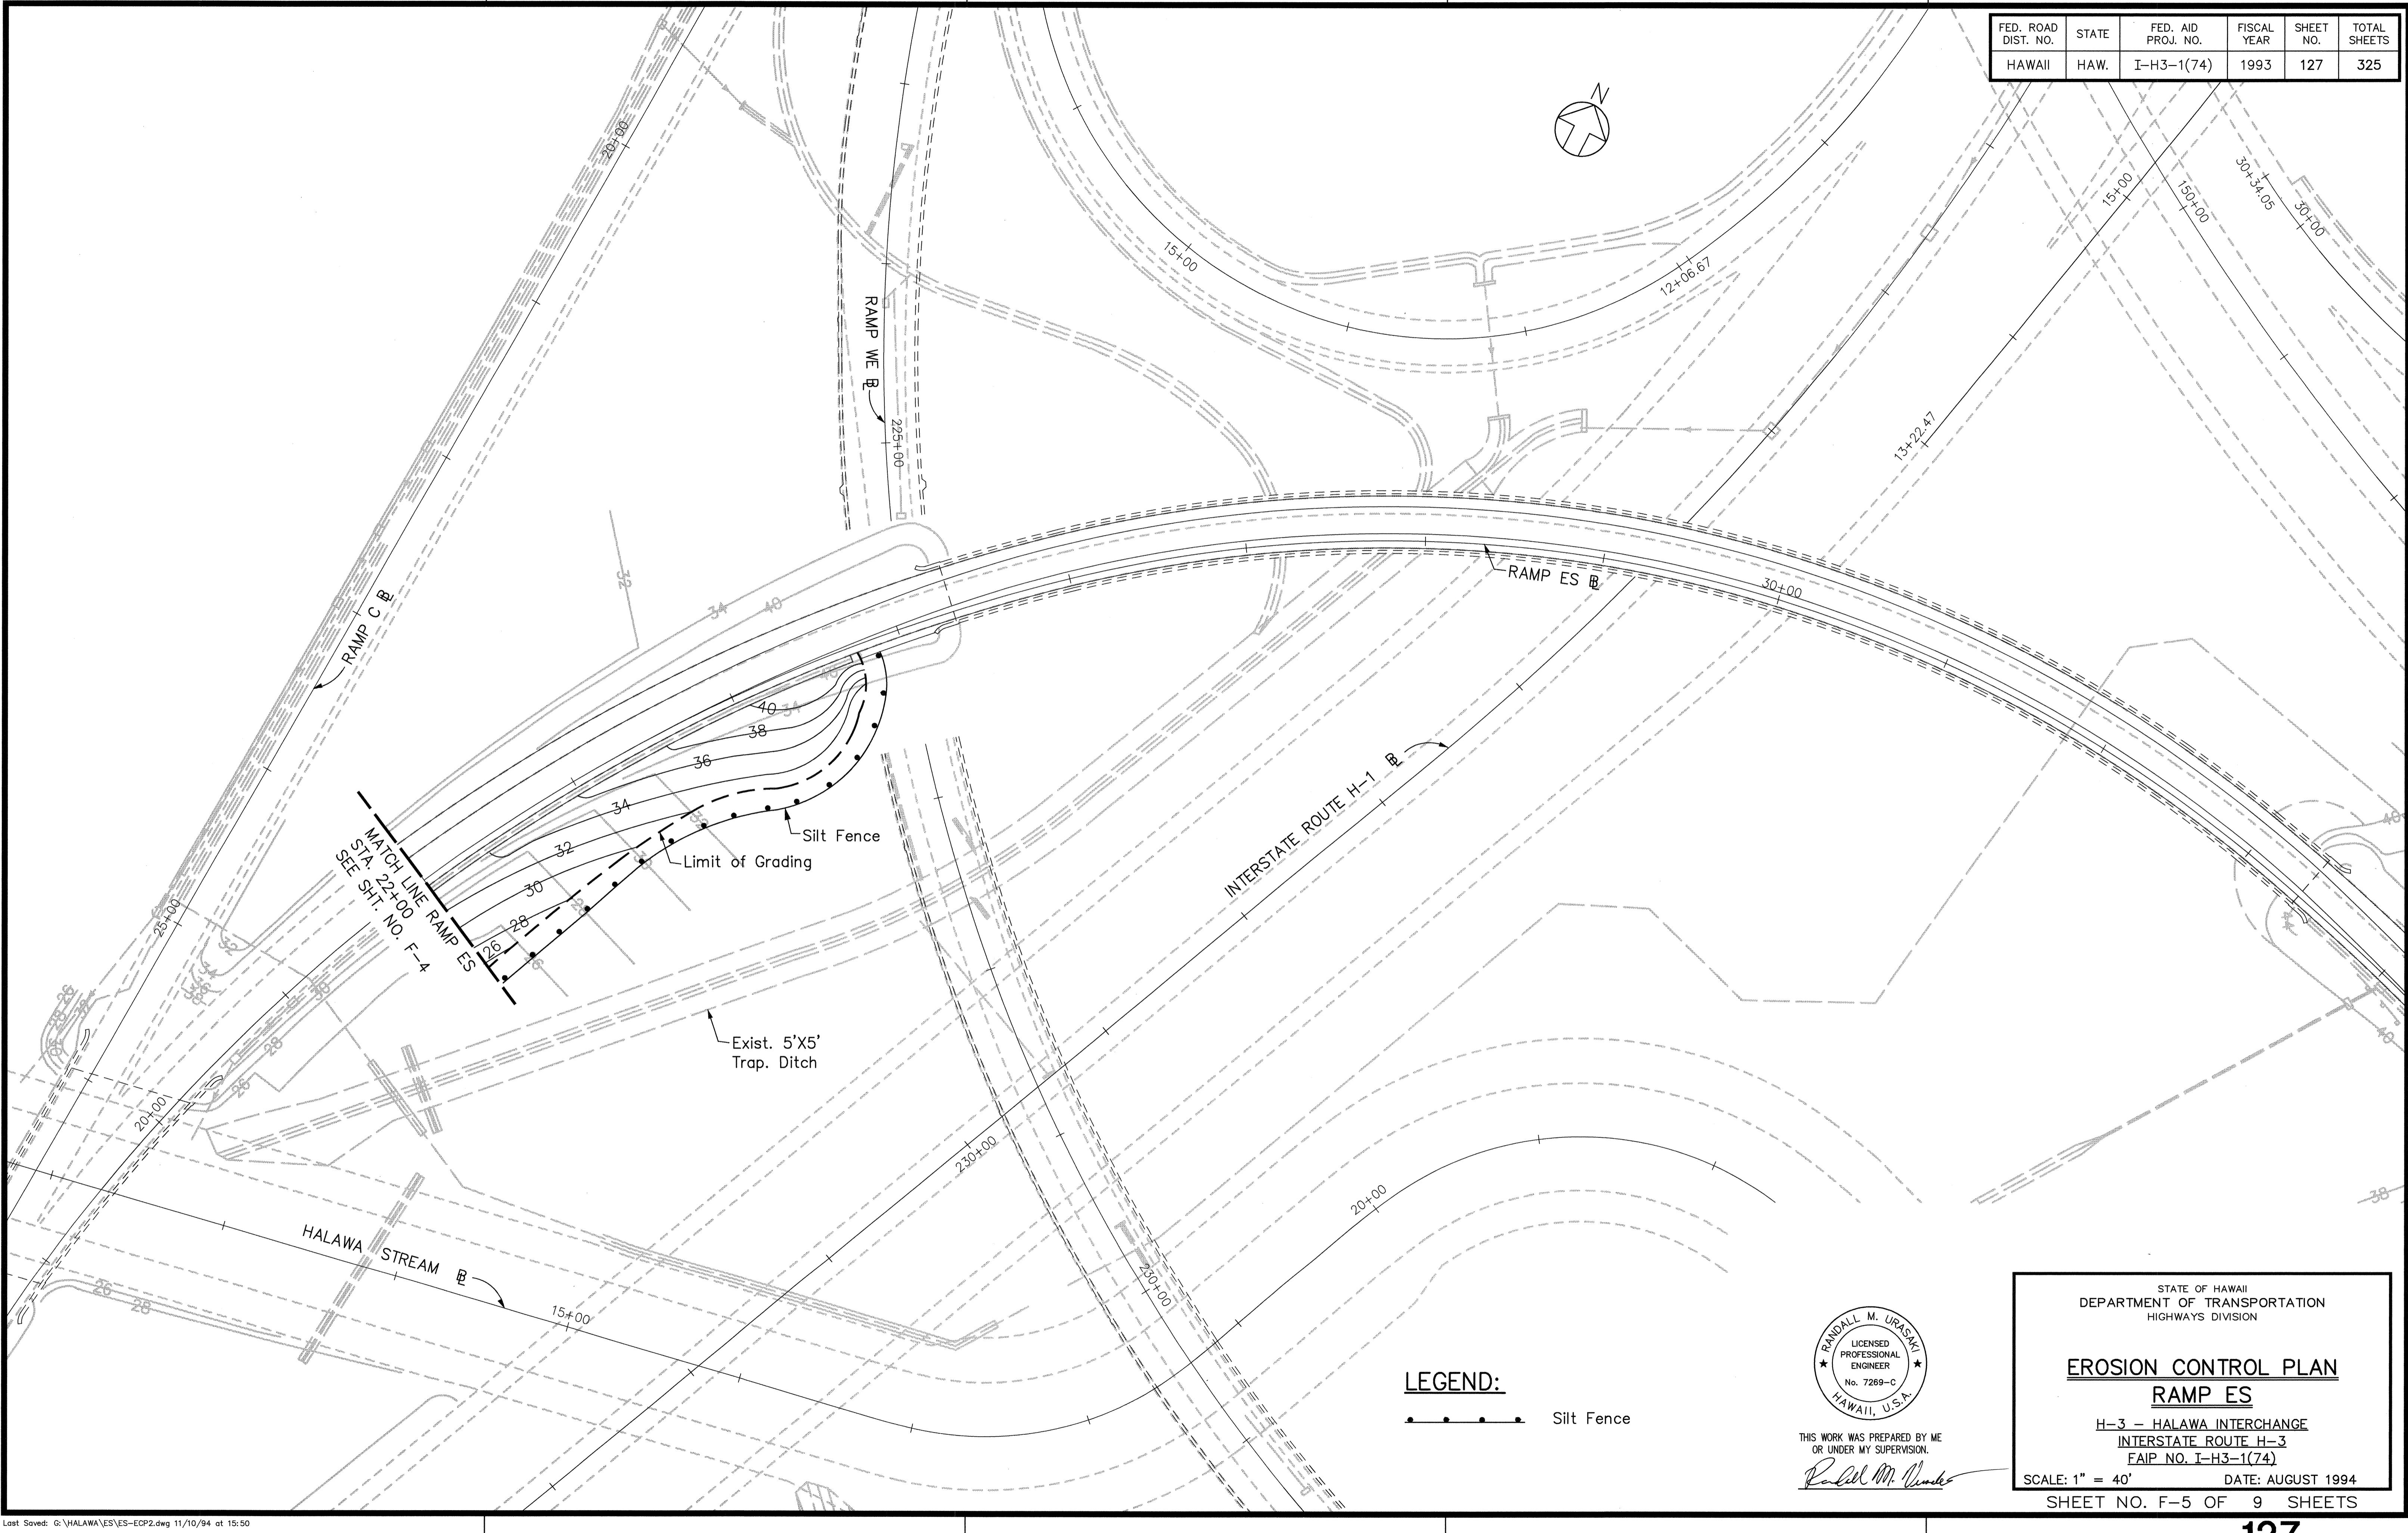

FED. ROAD DIST. NO.	STATE	FED. AID PROJ. NO.	FISCAL YEAR	SHEET NO.	TOTAL SHEETS
HAWAII	HAW.	I-H3-1(74)	1993	128	325

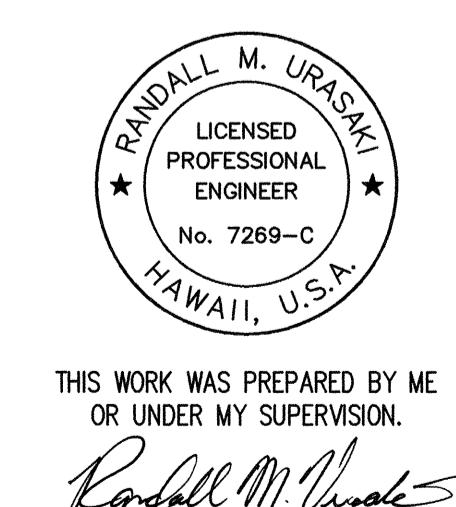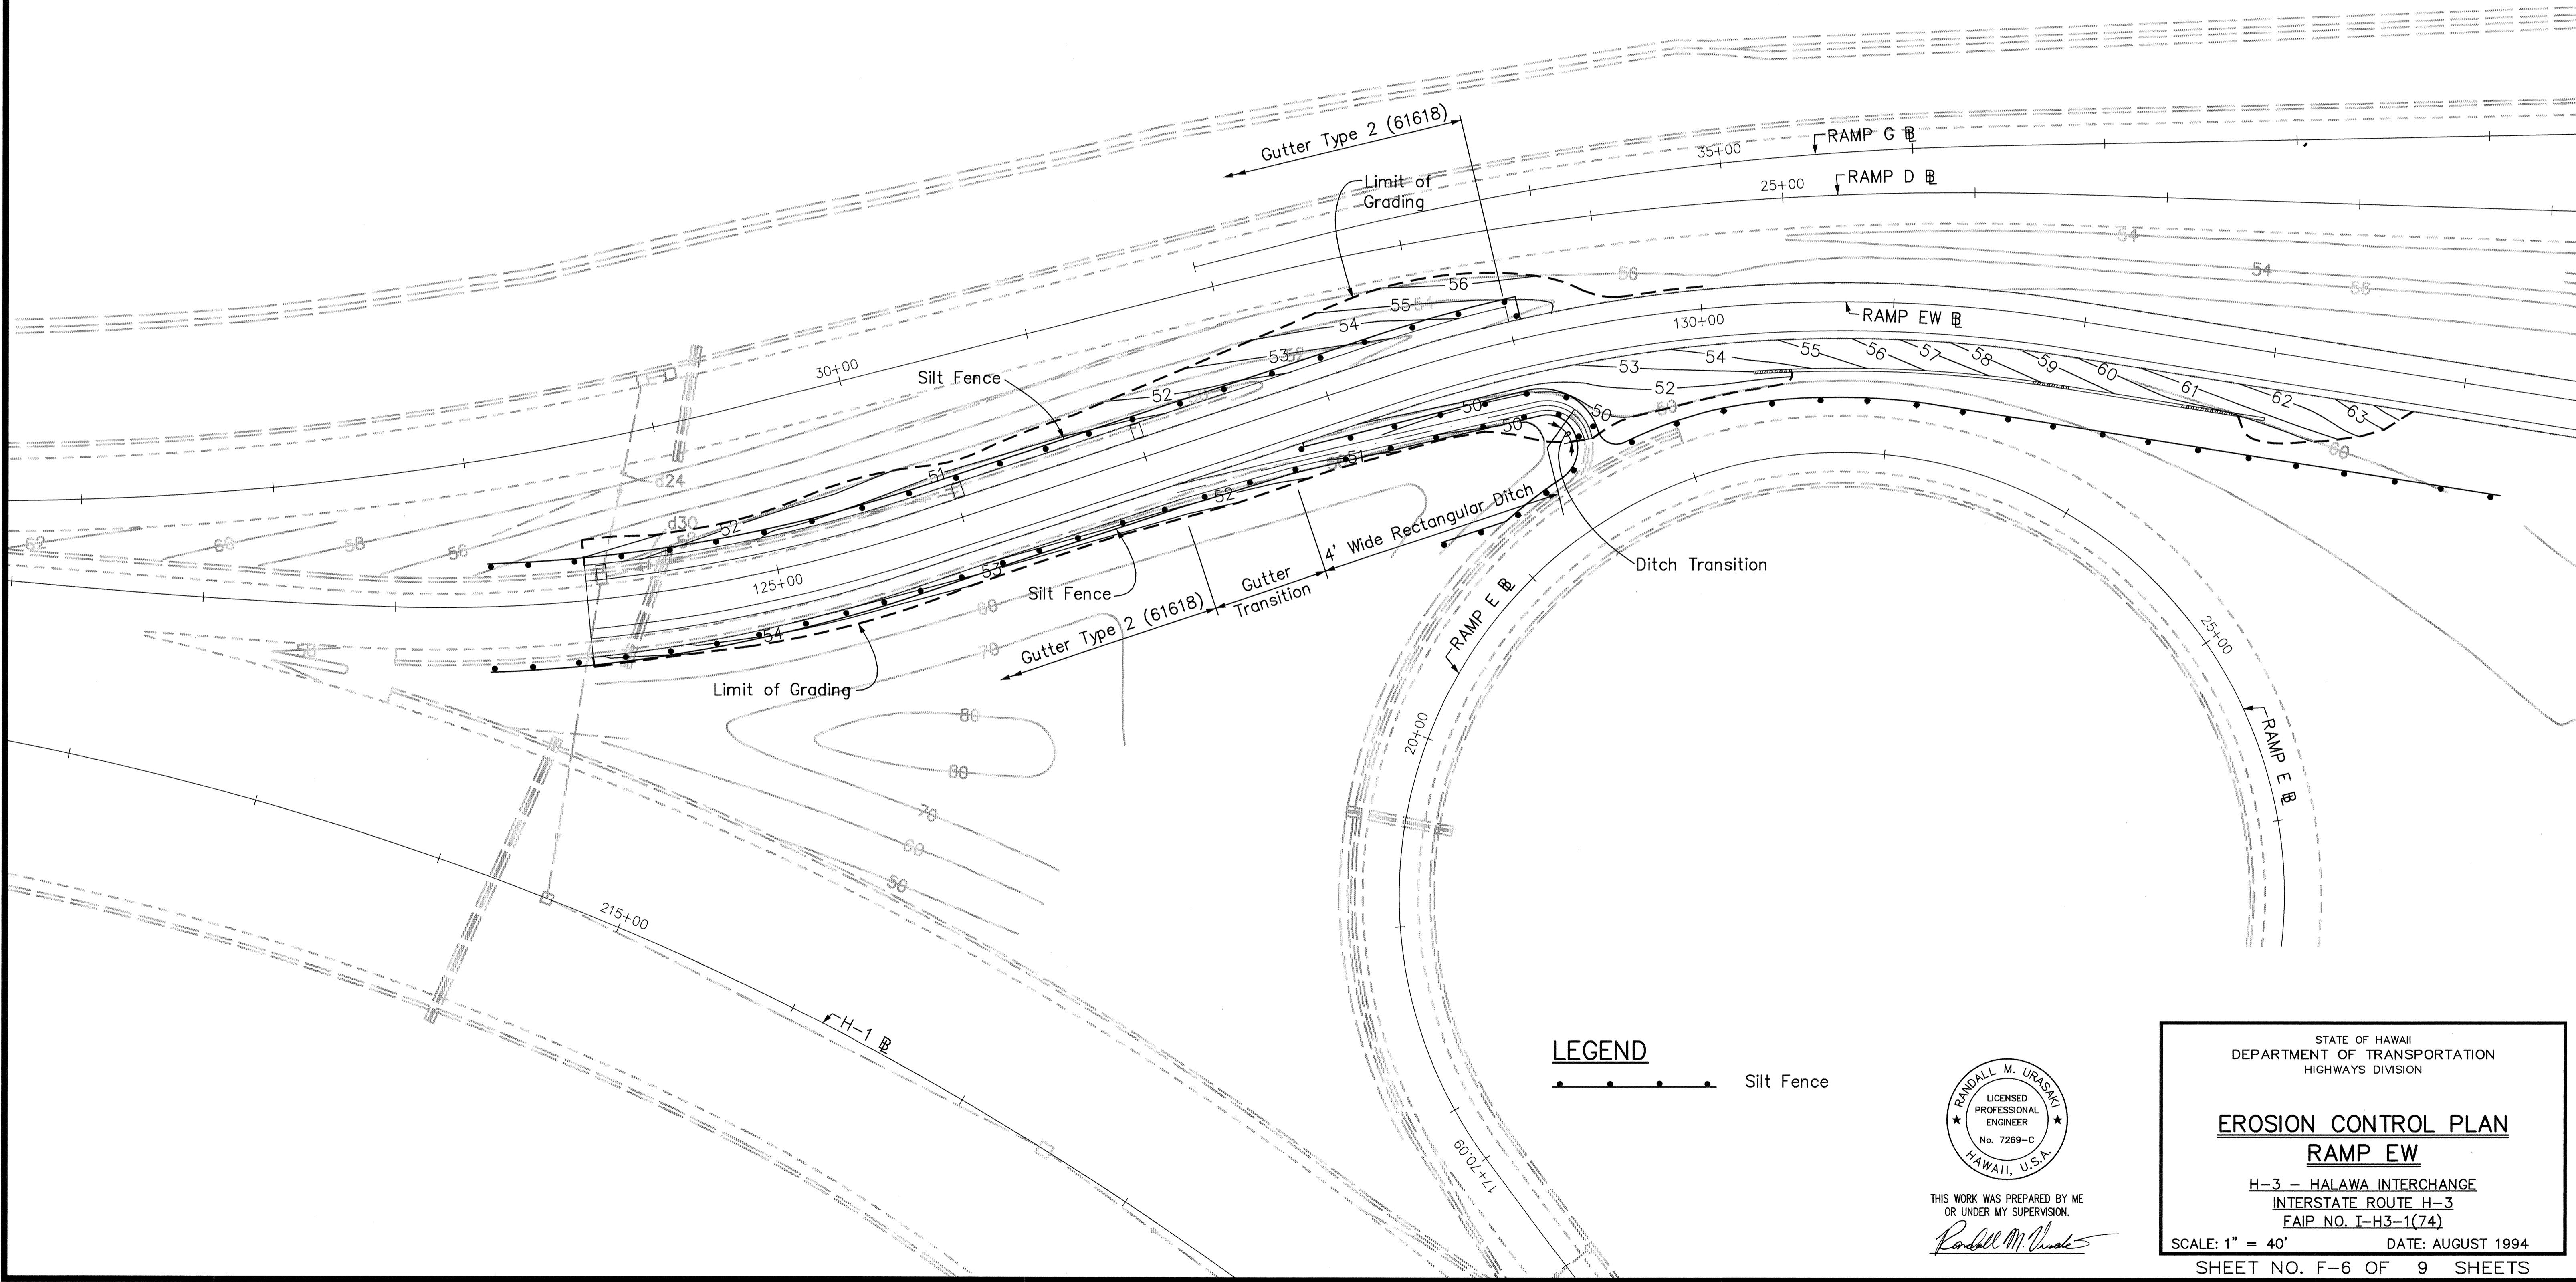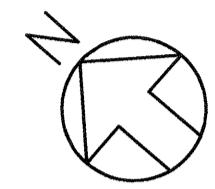

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STATE OF HAWAII
DEPARTMENT OF TRANSPORTATION
HIGHWAYS DIVISION


EROSION CONTROL PLAN
RAMP EW

H-3 - HALAWA INTERCHANGE
INTERSTATE ROUTE H-3
FAIP NO. I-H3-1(74)

SCALE: 1" = 40' DATE: AUGUST 1994
SHEET NO. F-6 OF 9 SHEETS

ORIGINAL SURVEY PLOTTED BY	DATE
PLAN DRAWN BY	
TRACED BY	
NOTE BOOK DESIGNED BY	
QUANTITIES BY	
CHECKED BY	
No. 55-52	


FED. ROAD DIST. NO.	STATE	FED. AID PROJ. NO.	FISCAL YEAR	SHEET NO.	TOTAL SHEETS
HAWAII	HAW.	I-H3-1(74)	1993	129	325

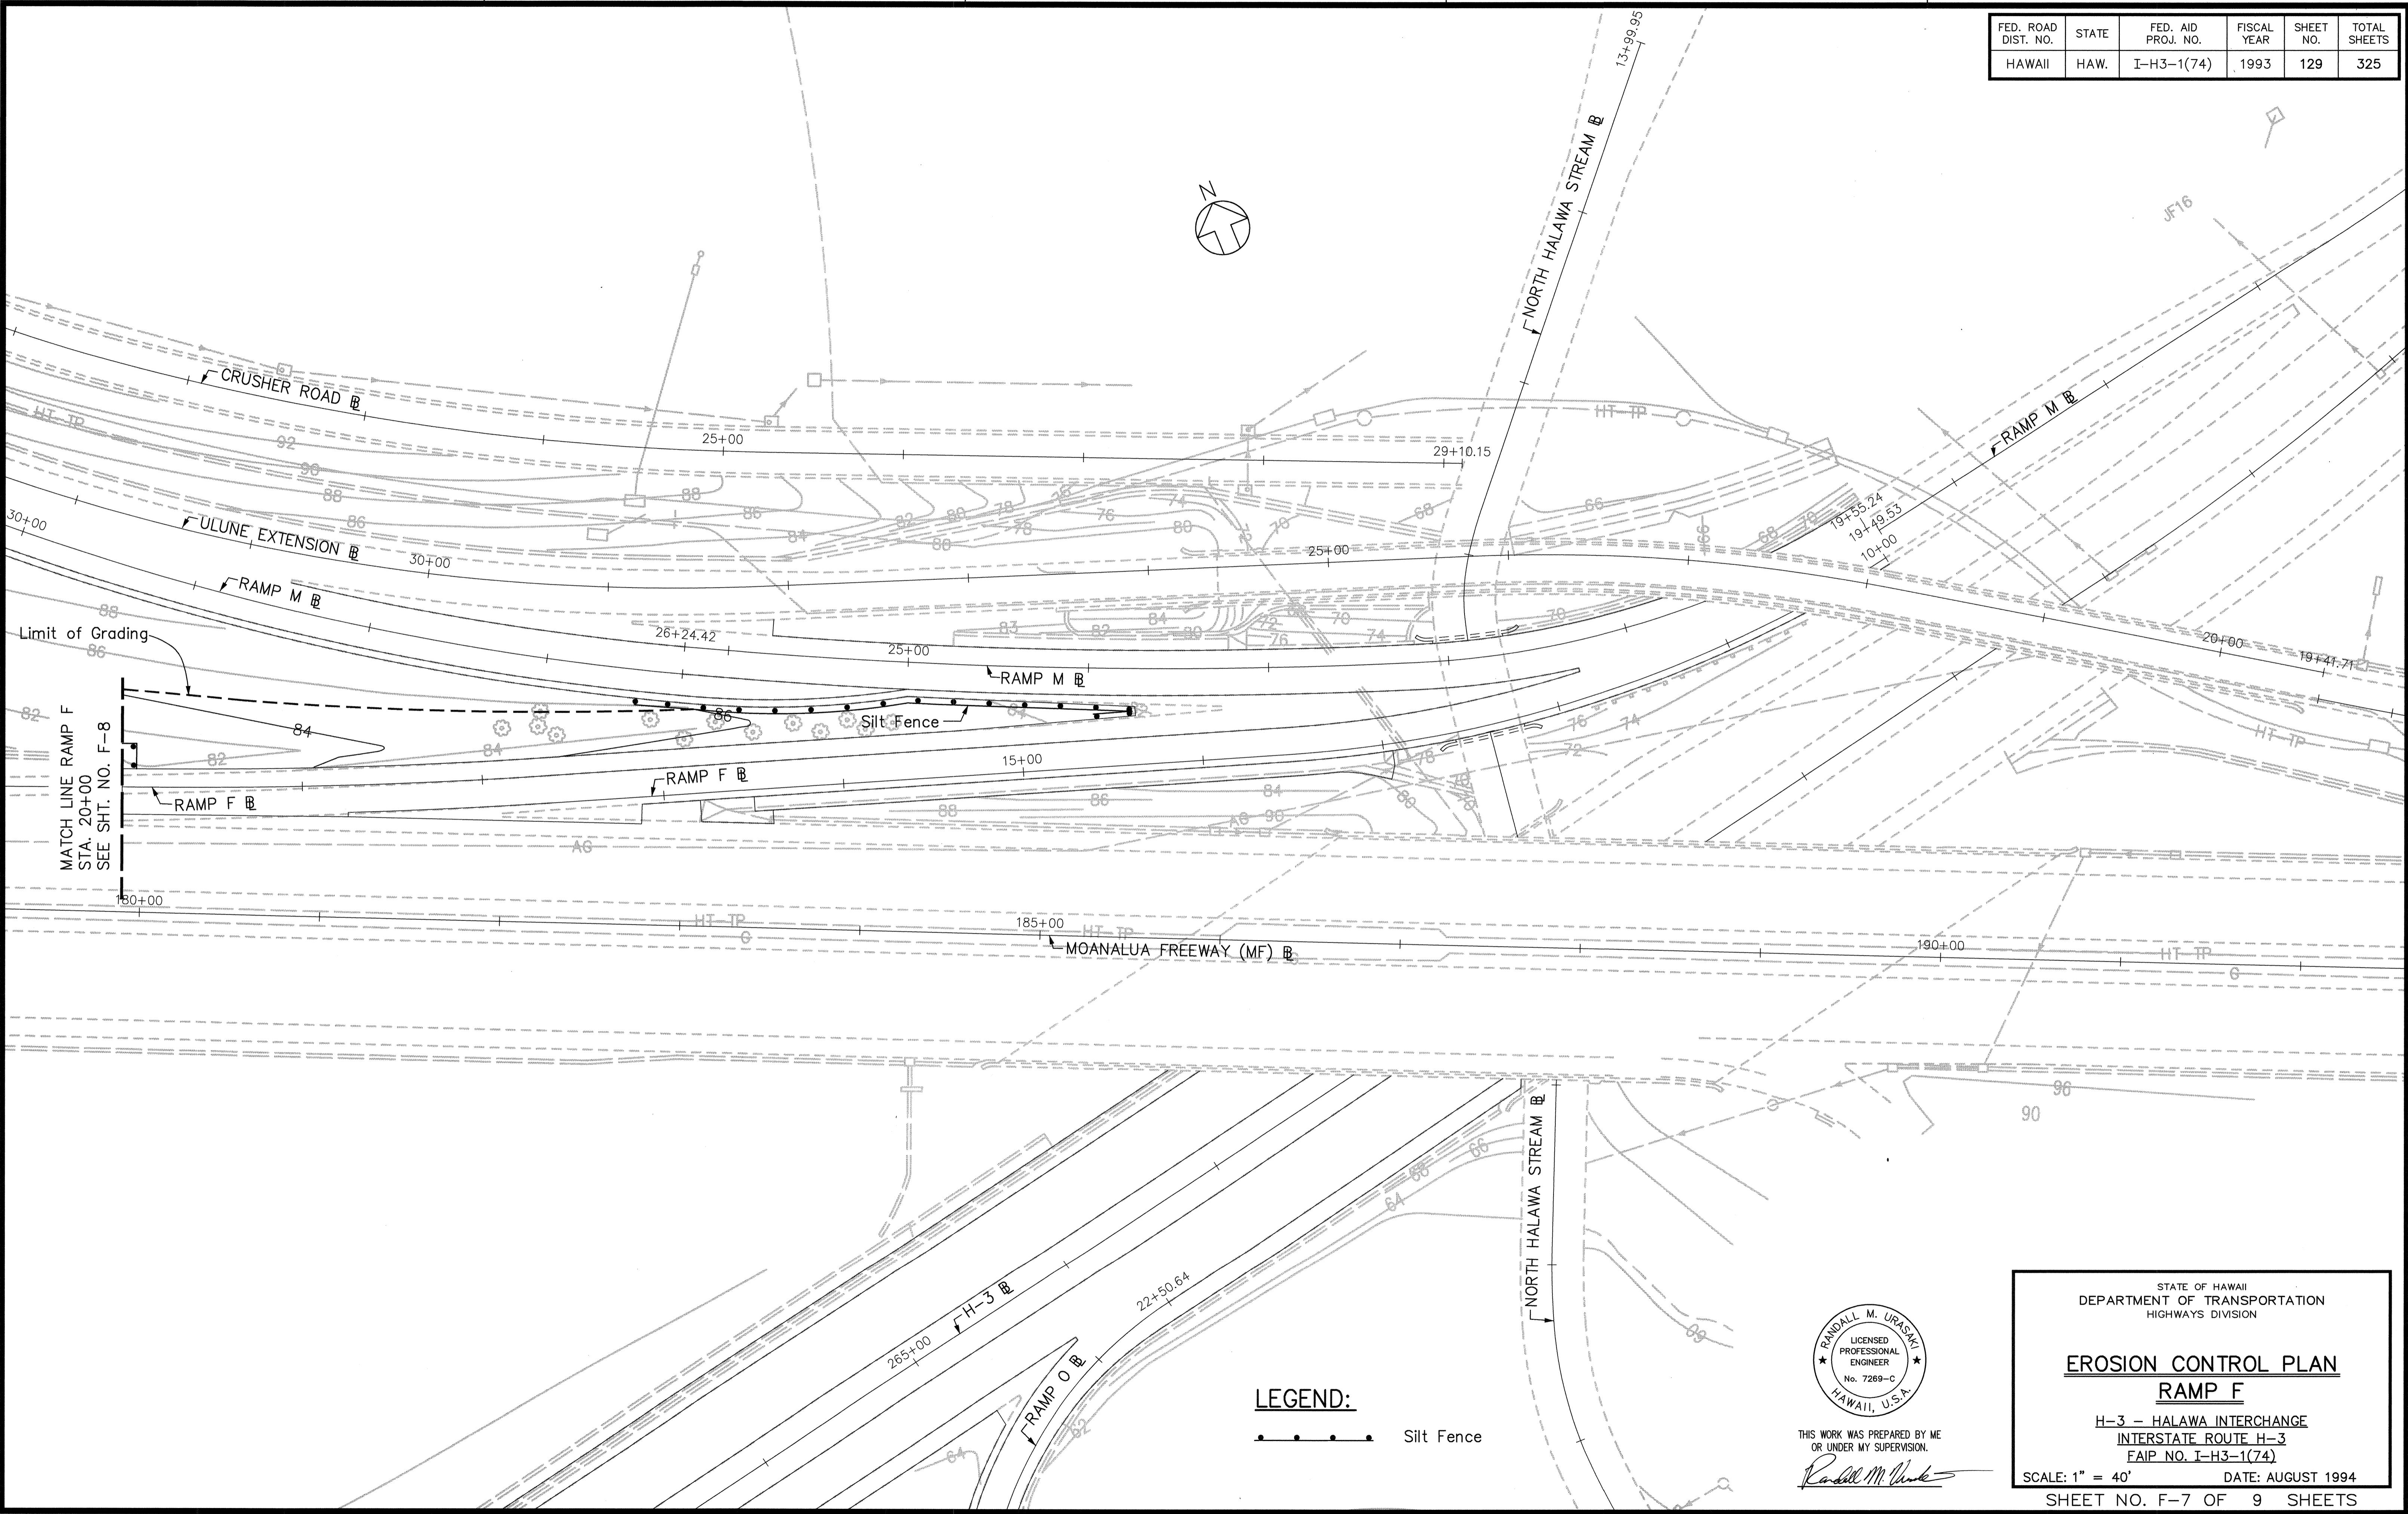

ORIGINAL PLAN	SURVEY PLOTTED BY _____ DRAWN BY _____ TRACED BY _____ DESIGNED BY _____ QUANTITIES BY _____ CHECKED BY _____	DATE _____ " _____ " _____ " _____ " _____ " _____
NOTE BOOK No. _____		

CAD by S. Chong,

Last Saved: G:\HALAWA\F\F-ECP2.dwg 11/10/94 at 15:57

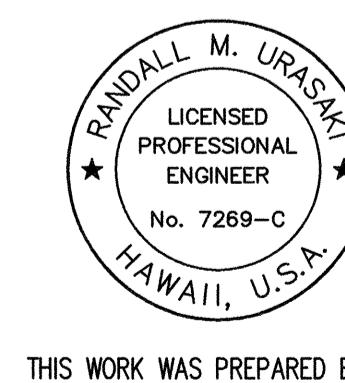

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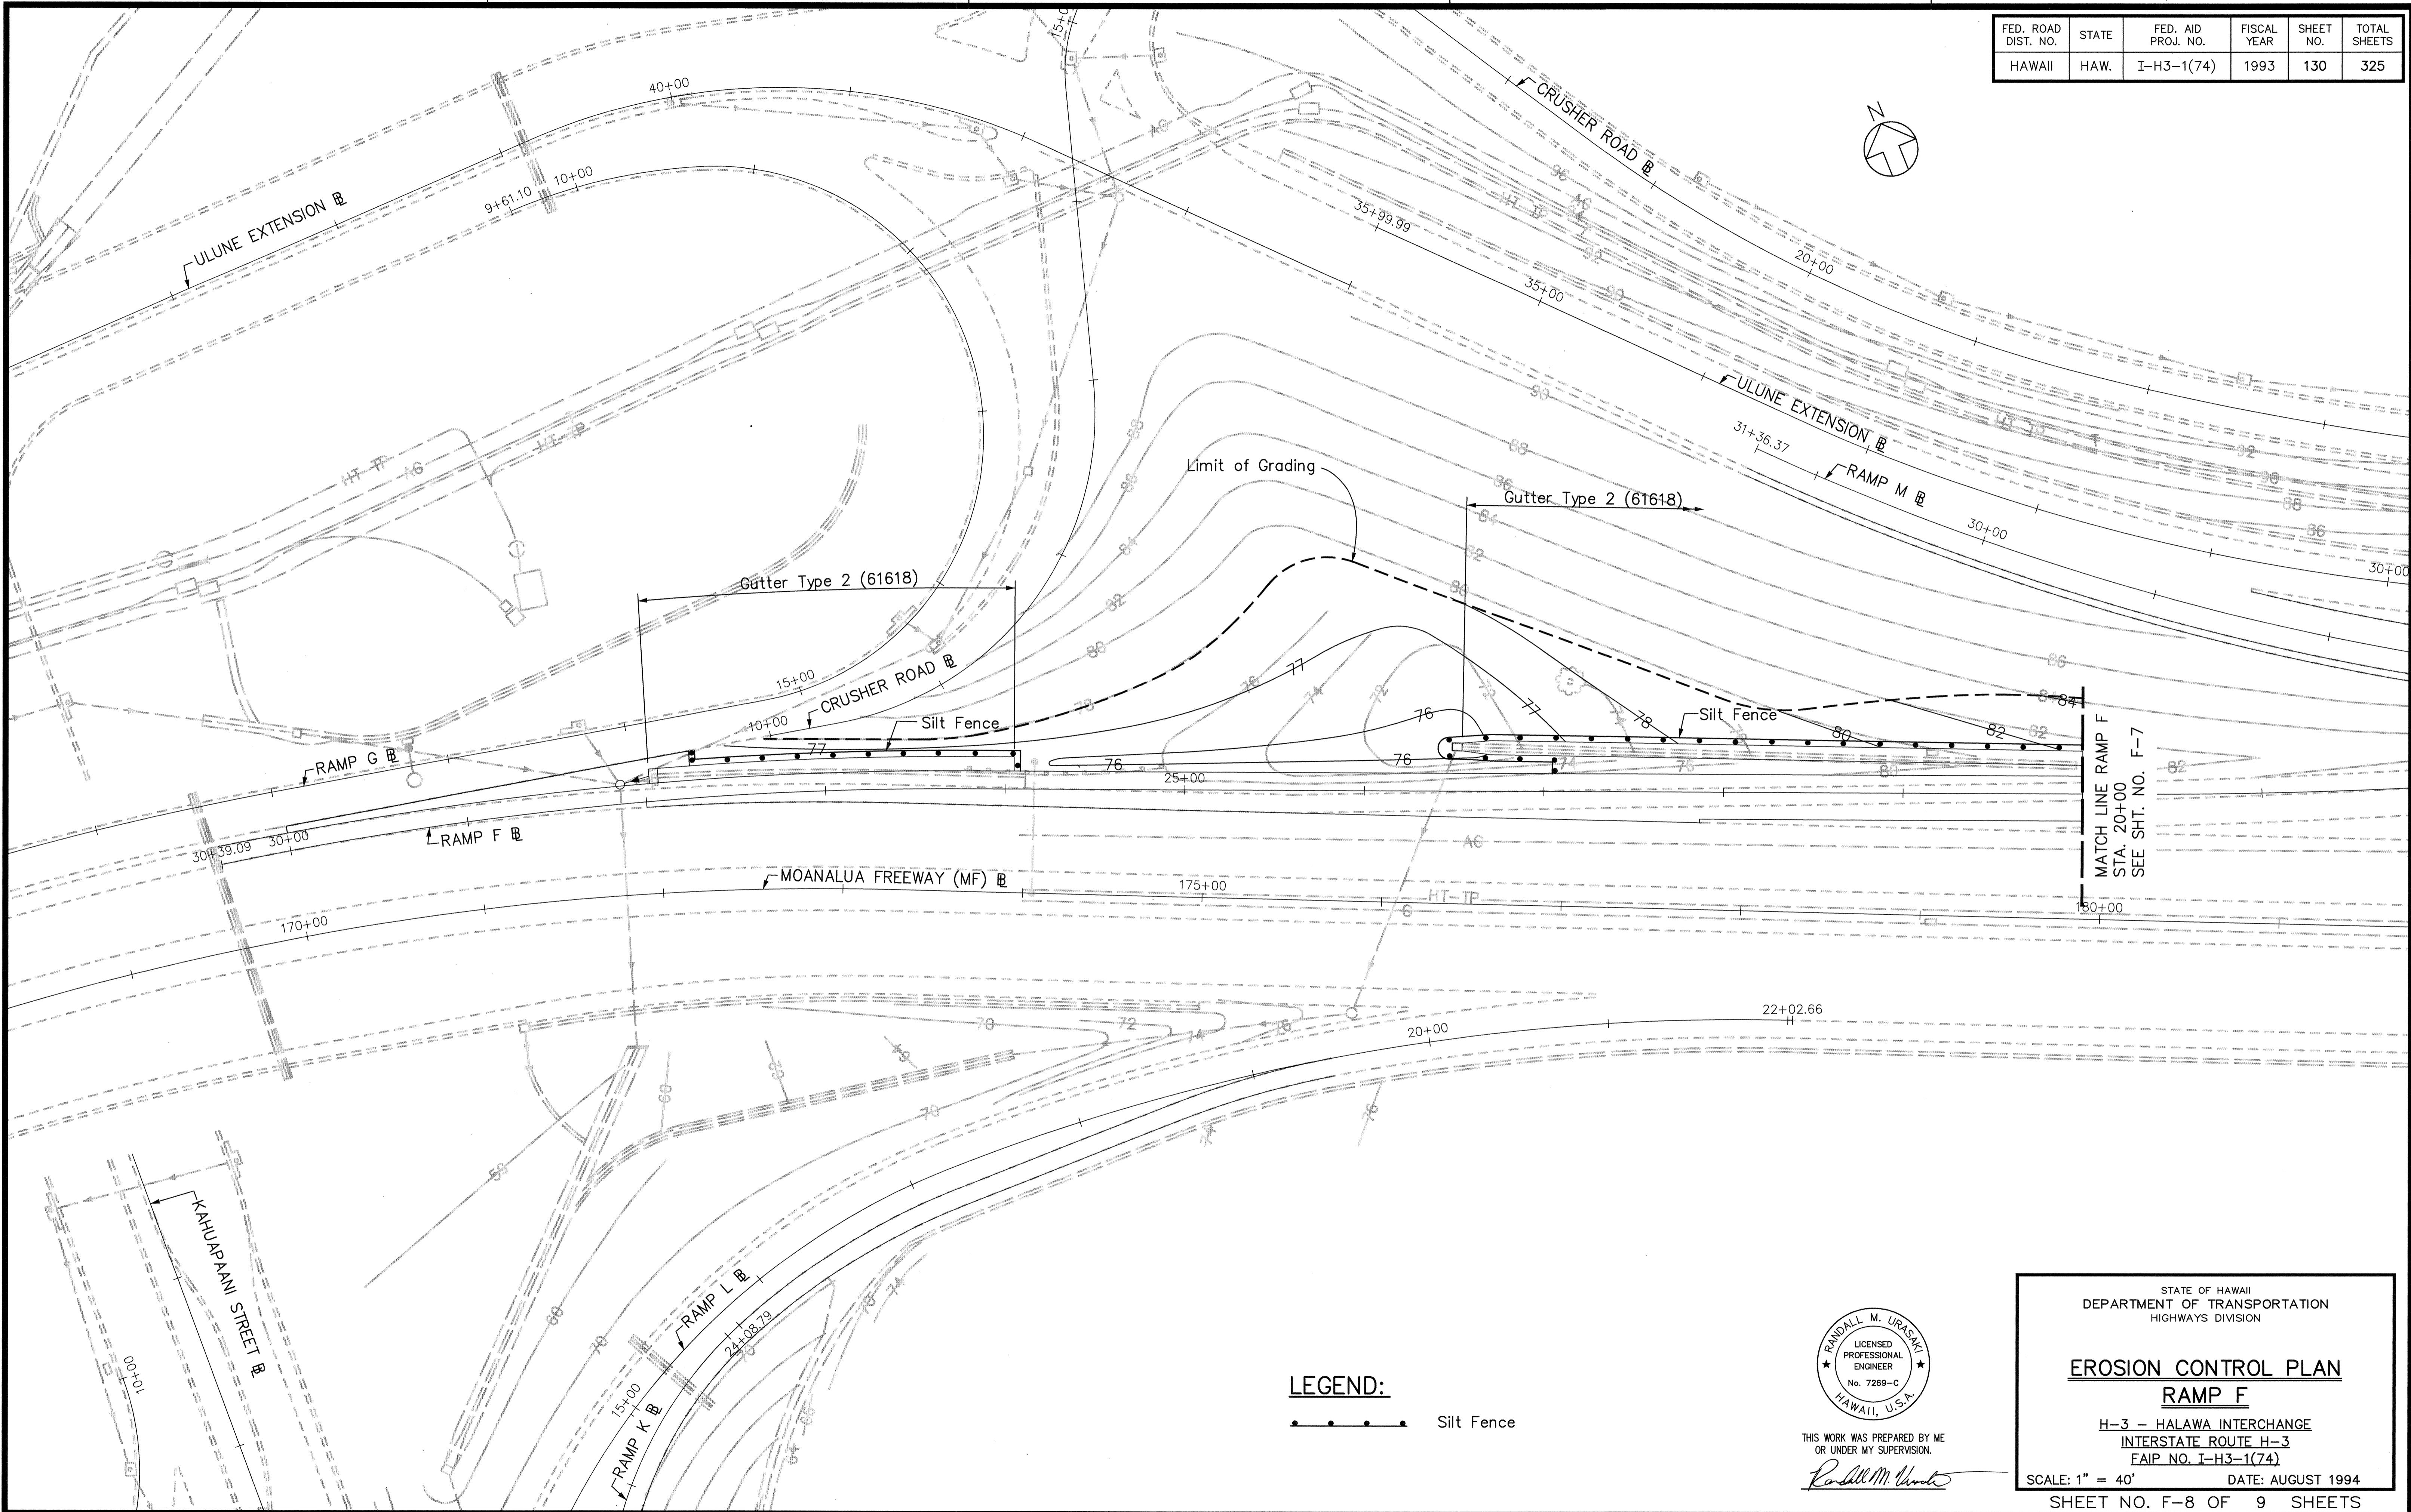
**STATE OF HAWAII
DEPARTMENT OF TRANSPORTATION
HIGHWAYS DIVISION**

HIGHWAYS DIVISION

H-3 - HALAWA INTERCHANGE
INTERSTATE ROUTE H-3
FAIR NO. T H3 1(74)

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FED. ROAD DIST. NO.	STATE	FED. AID PROJ. NO.	FISCAL YEAR	SHEET NO.	TOTAL SHEETS
HAWAII	HAW.	I-H3-1(74)	1993	130	325



FED. ROAD DIST. NO.	STATE	FED. AID PROJ. NO.	FISCAL YEAR	SHEET NO.	TOTAL SHEETS
HAWAII	HAW.	I-H3-1(74)	1993	131	325

