

#8 Solid Copper Ground Radials
#4/0 7 Strand Grounding Bus
Grounding to Faraday Shield Pole. See Note 6 PIER FOOTING Max.
#4/0 7 Strand Bus around Pier Footing
DE TAIL OM-I OM-I

TYPICAL GROUND SYSTEM CONFIGURATION

AROUND PIER FOOTING

N.T.S.

S FOR OMEGA STATION WORK					
	UNIT	QUANTITY			
OMEGA System	Lump Sum	See below			
vire		(3,400 L.F.)			

ESTIMATED QUANTITIES FOR OMEGA STATION WORK					
ITEM NO.	ITEMS	UNIT	QUANTITY		
685.01	Modifications to OMEGA Radial Ground System	Lump Sum	See below		
	#4/0 7 Strand wire		(3,400 L.F.)		
	#8 Solid Copper Wire		(4,600 L.F.)		
	#I/O Solid Copper Wire	-	(500 L.F.)		
	Ground Rods		(70 EA.)		
206.85	Structure Excavation for Ground Radials & Buses	C.Y.	400 C.Y.		

GENERAL NOTES

- I. All ground system wire, cables and ground rods shall be connected by exothermic welding.
- 2. Change in direction of copper cables or wires shall be accomplished by using a smooth radius bend.
- 3. See Sheet <u>OM-3</u> for overall Site Plan of Omega Transmitter Facility Ground Radial System.
- 4. The location of the Haiku Access Road as shown on Plan, is approximate only.
- 5. Existing ground wires in Area A will be removed by Others.
- 6. The Contractor shall connect all Faraday Shield Supports located on the North side of the Inbound lanes & the South side of the Outbound lanes to a Pier Grounding Bus. For at-grade Faraday Shield Supports, the Contractor shall connect the support base to a driven ground rod w/a #4/O -7 strand copper wire.

STATE OF HAWAII DEPARTMENT OF TRANSPORTATION

GROUND SYSTEM MODIFICATION PLAN


HAIKU OMEGA TRANSMITTER FACILITY


INTERSTATE ROUTE H-3
HAIKU VALLEY BRIDGES
F.A.I. PROJECT NO. I-H3-I(52)


SCALE: AS SHOWN

SHEET No.OM-IOF 3 SHEETS


DATE: JULY 1988

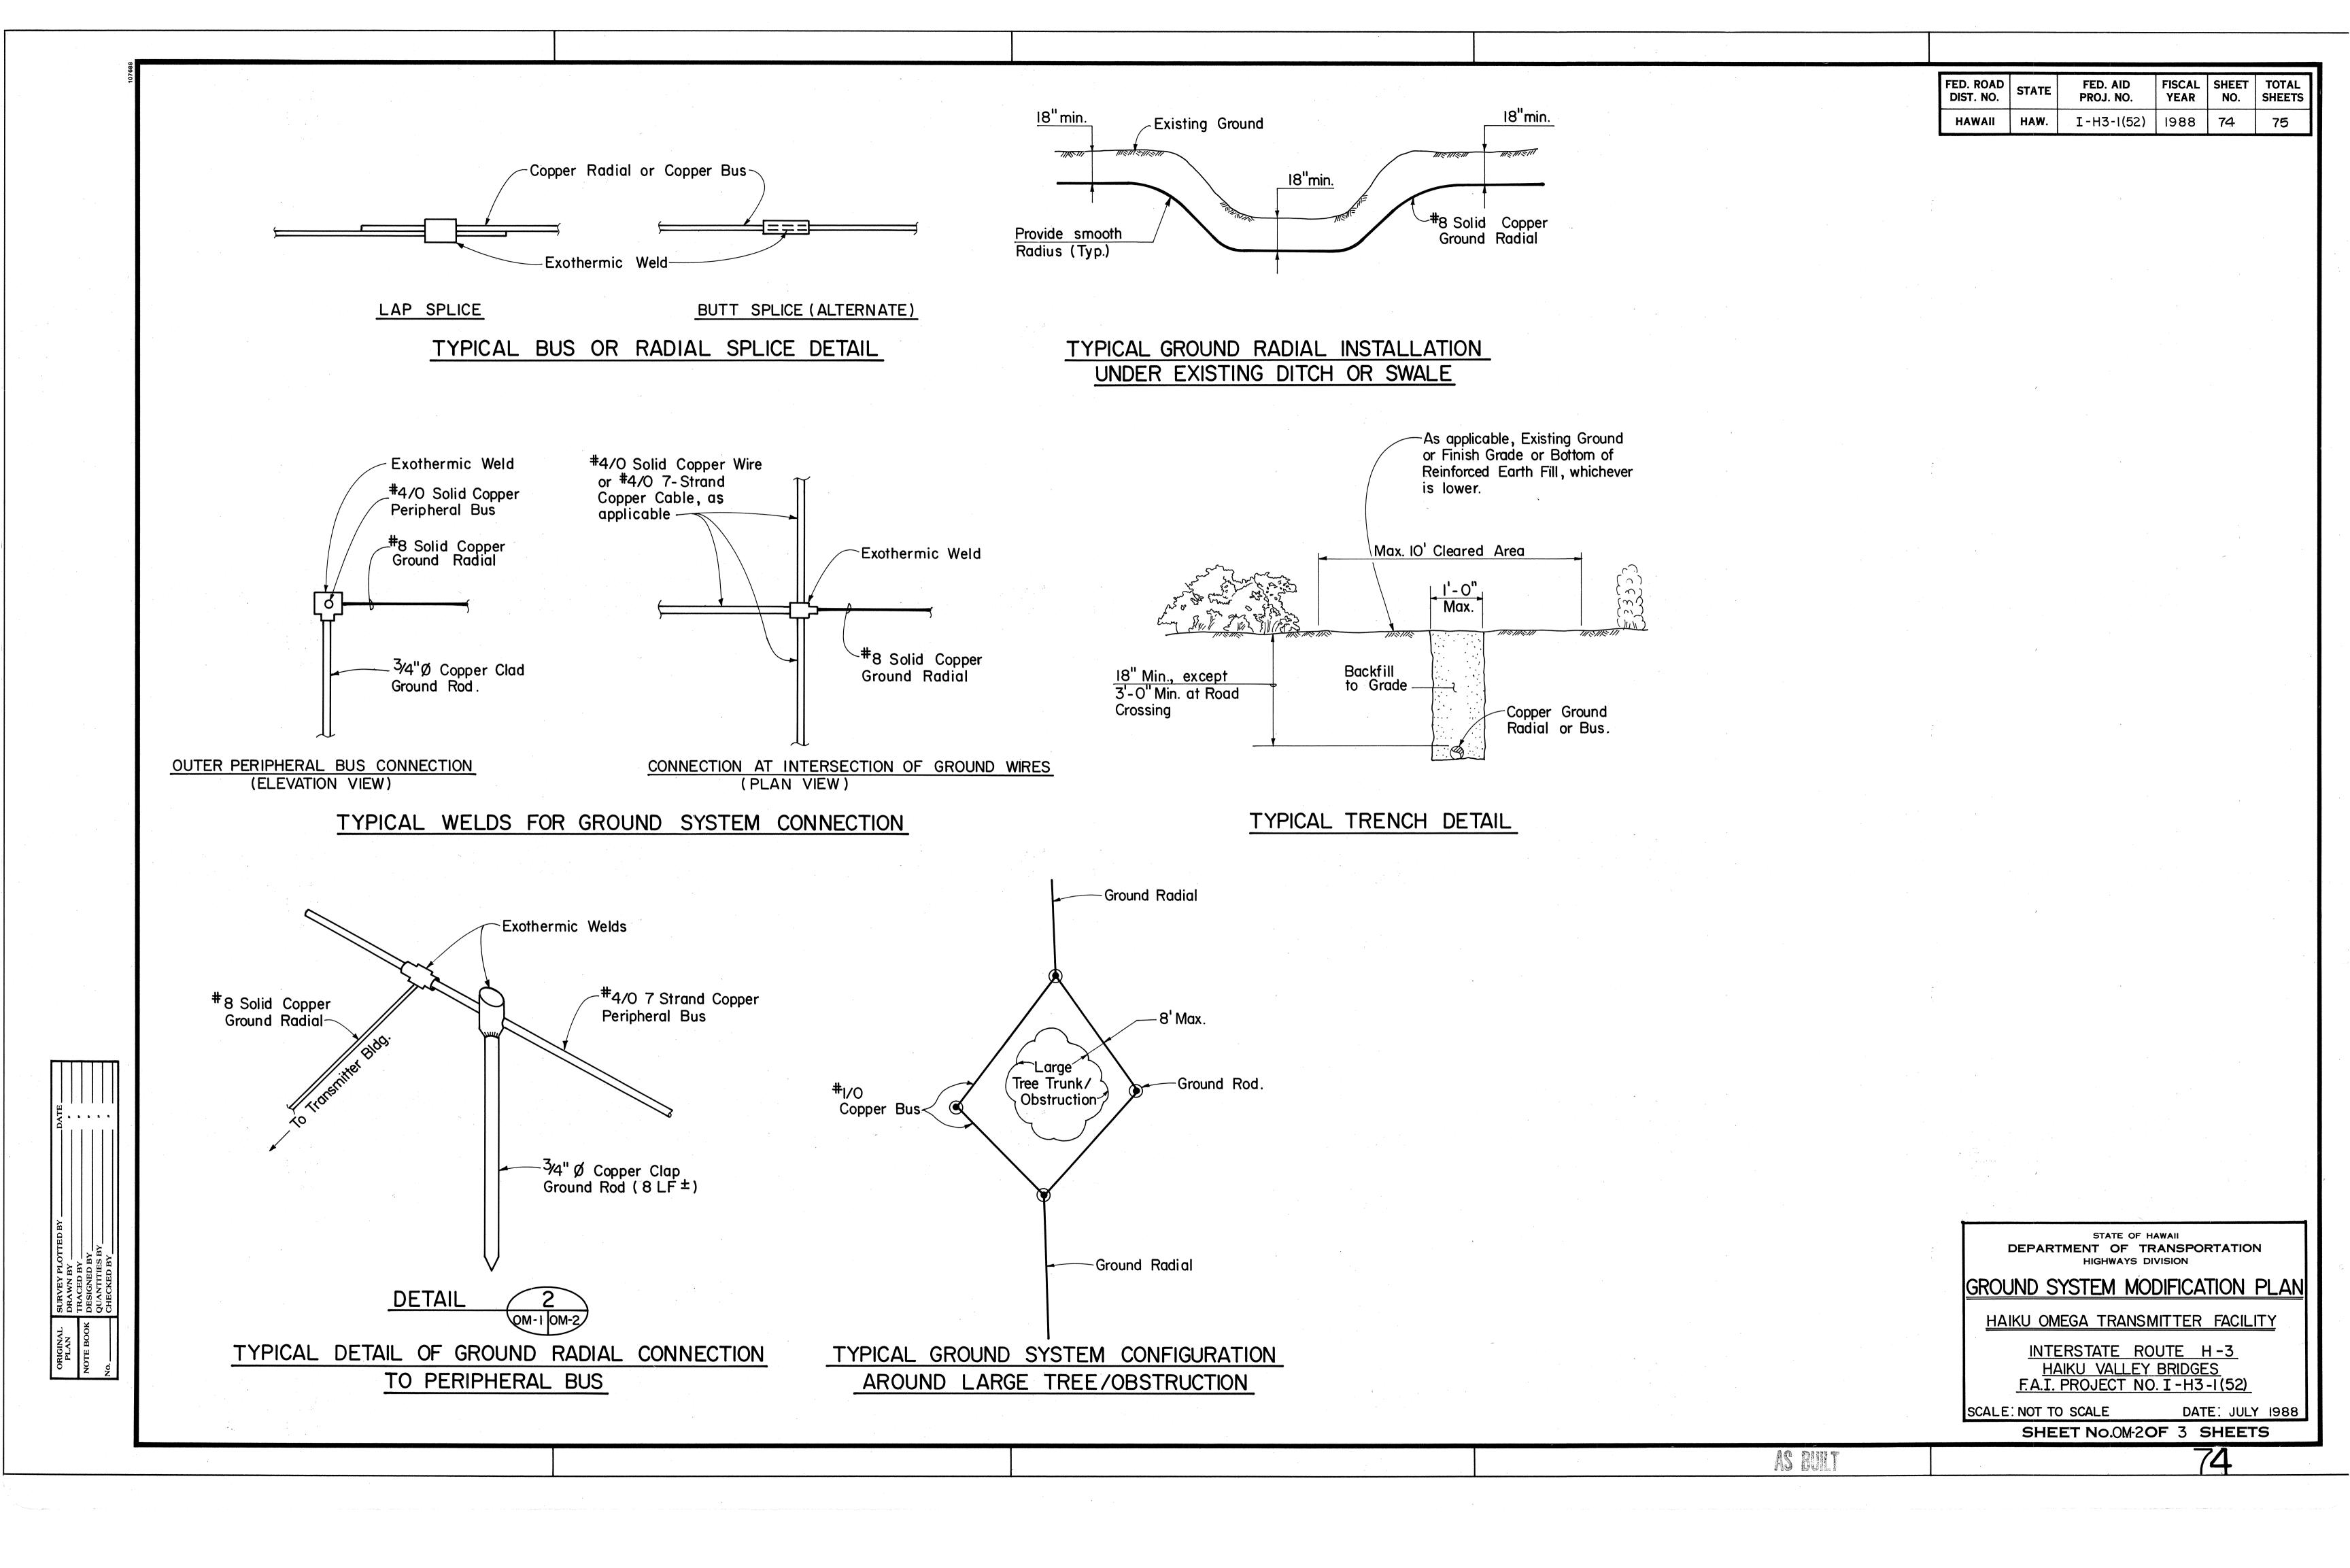


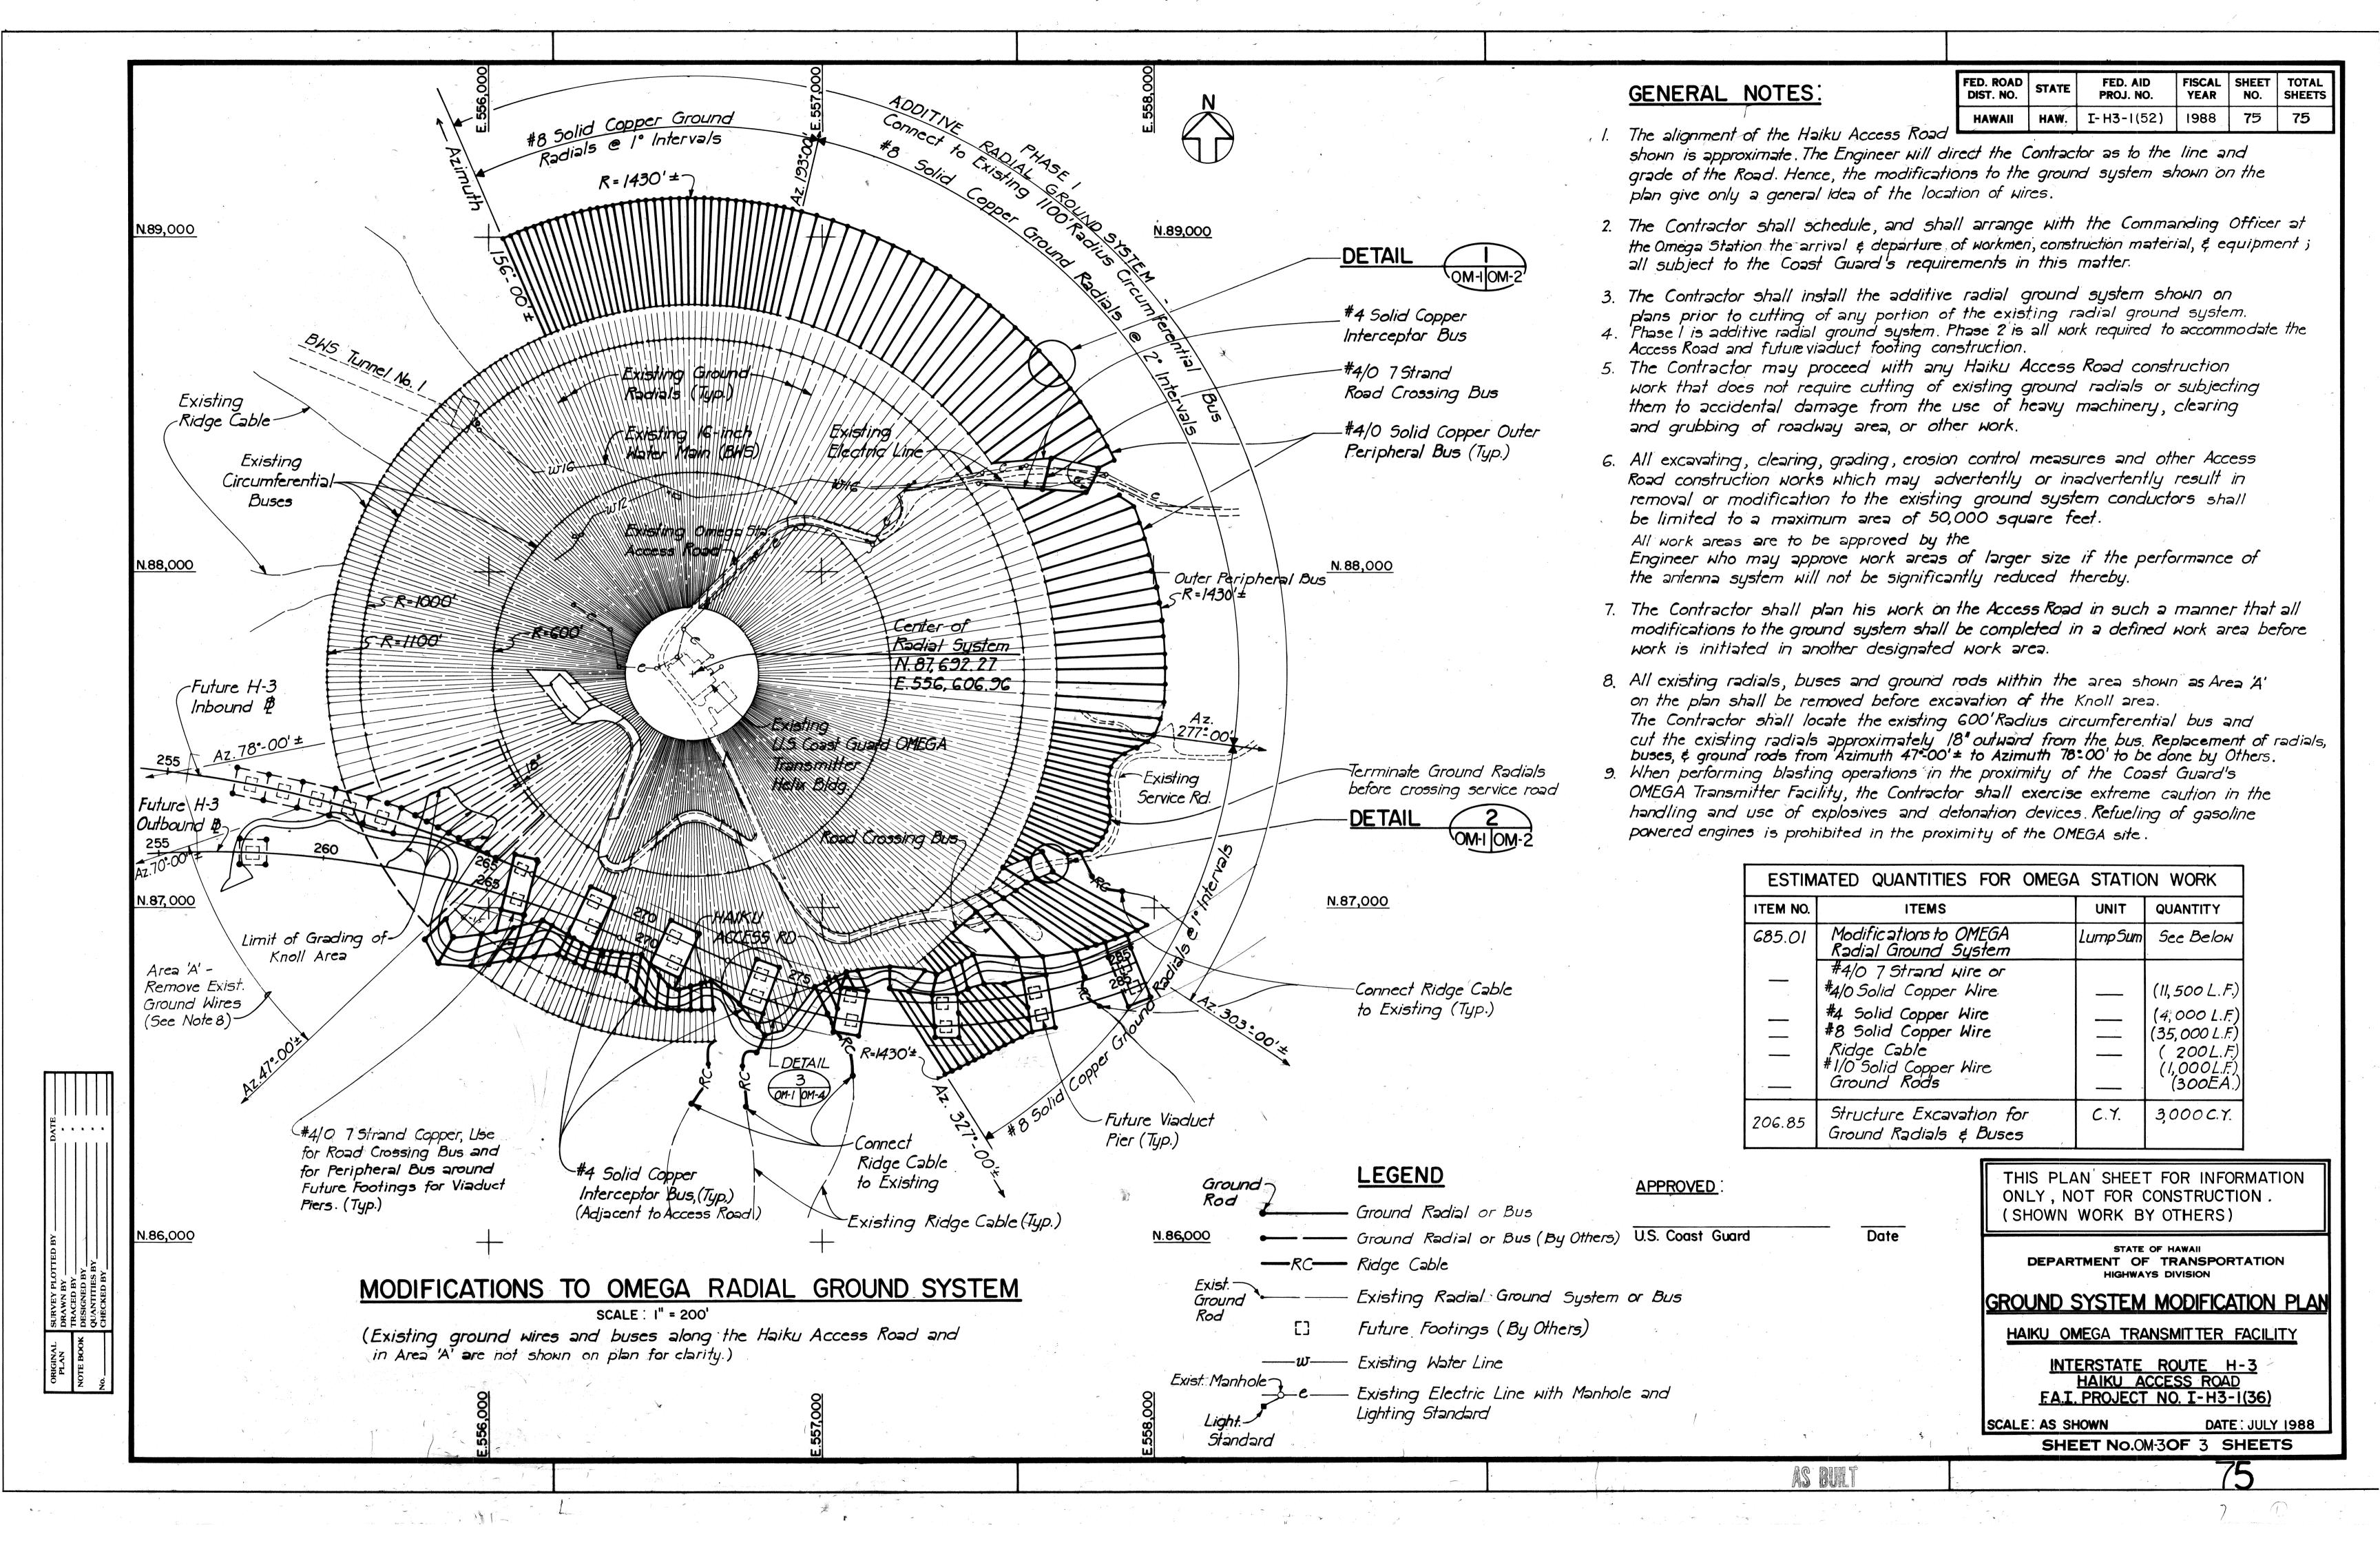


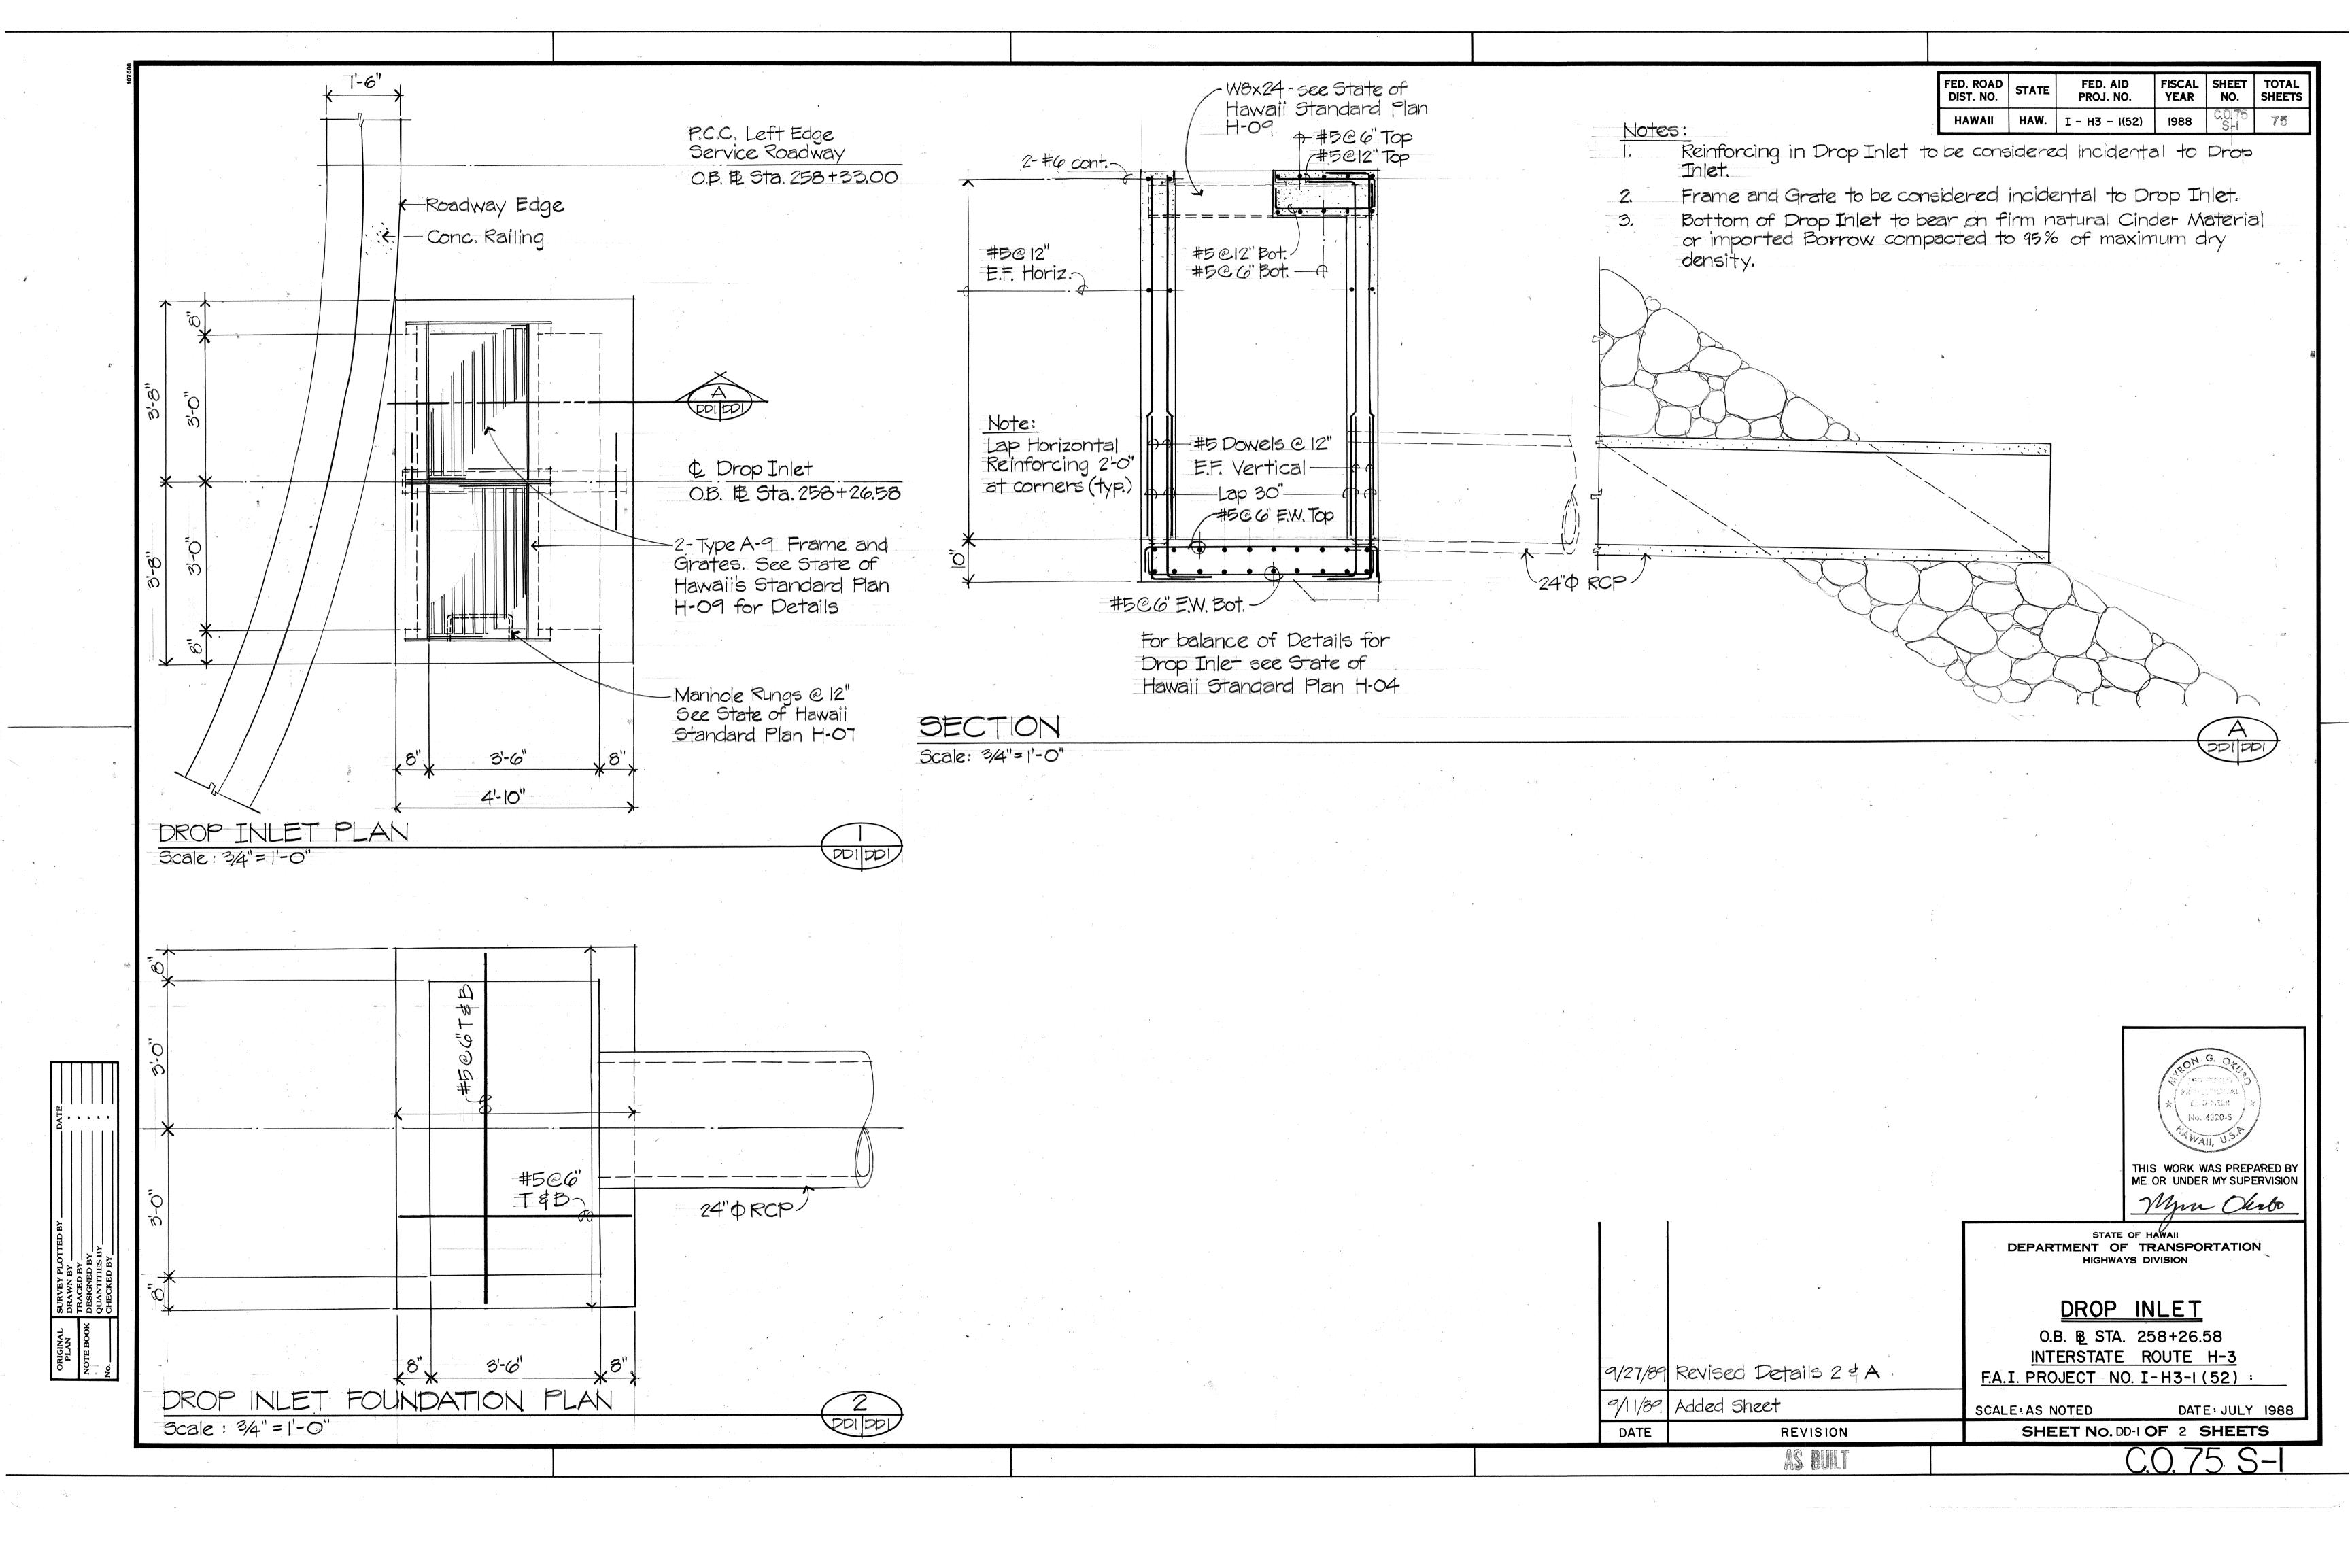


FED. ROAD DIST. NO.	STATE	FED. AID PROJ. NO.	FISCAL YEAR	SHEET NO.	TOTAL SHEETS
HAWAII	HAW.	I-H3-I (52)	1988	C.O.75 S-2	75

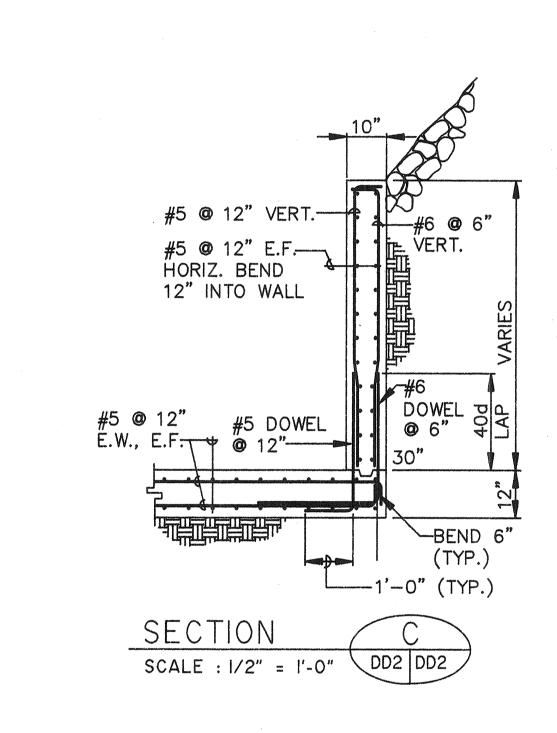

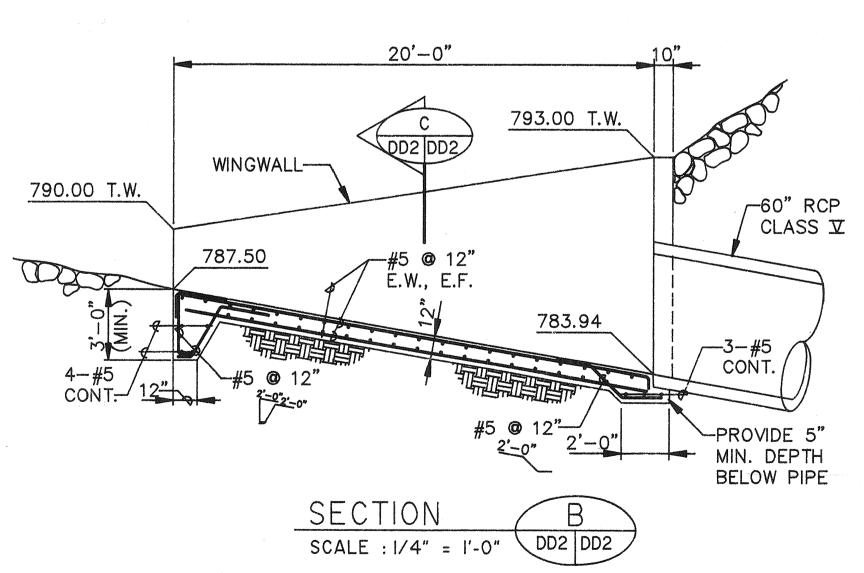

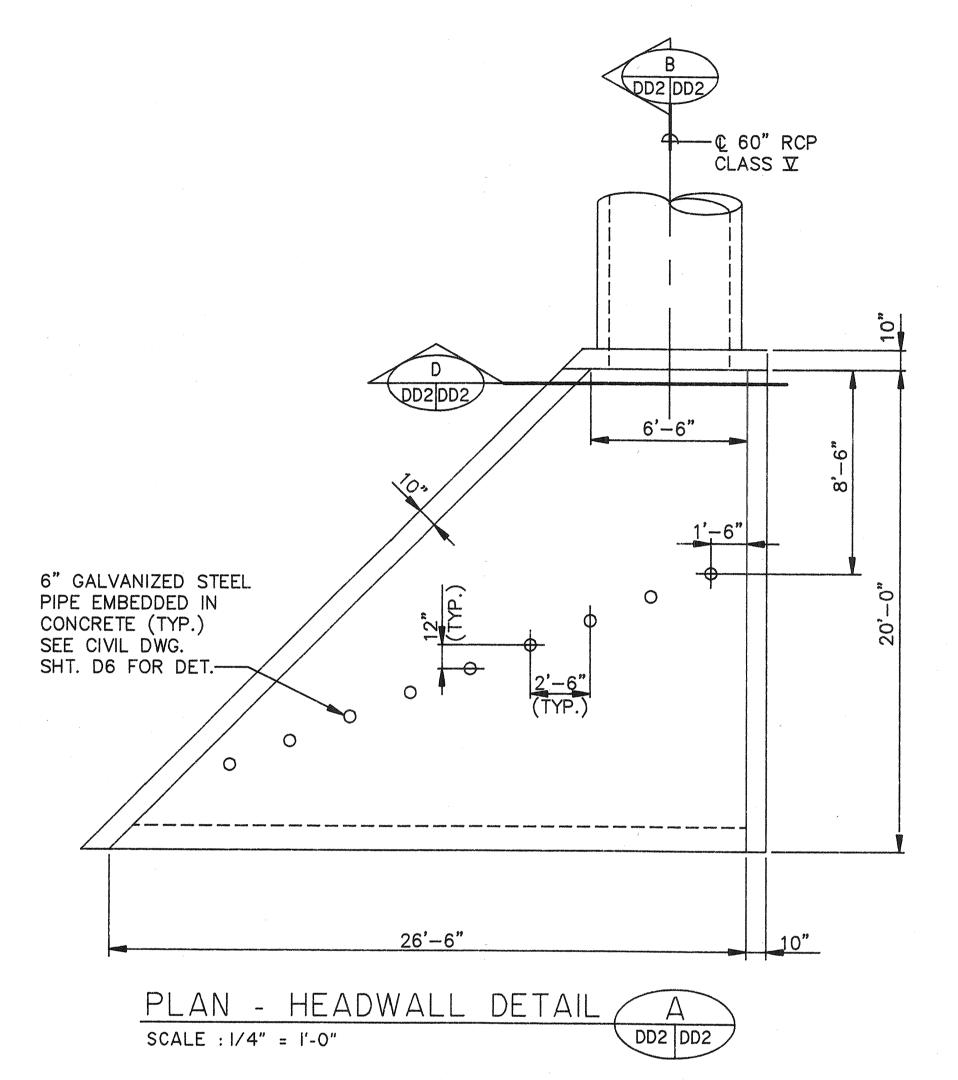

NOTE: SEE STANDARD PLAN SHEET H-04 FOR BALANCE OF REINFORCING DETAILS.

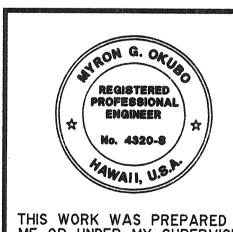

THIS WORK WAS PREPARED BY ME OR UNDER MY SUPERVISION Myen Okuso

STATE OF HAWAII
DEPARTMENT OF TRANSPORTATION
HIGHWAYS DIVISION

HEADWALL O.B. STA. 258+26.58

INTERSTATE ROUTE H-3 F.A.I. PROJECT NO. I-H3-I (52):

SCALE: AS NOTED


DATE: JULY 1988 SHEET No. DD2 OF 2 SHEETS

AS BUILT

REVISION

9/27/89 ADDED SHEET

DATE

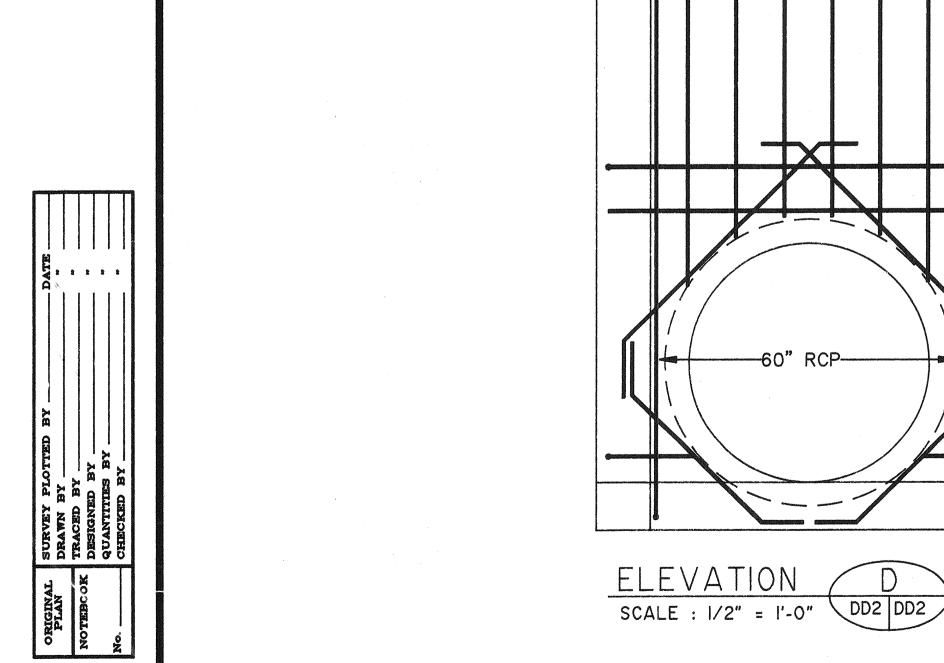

-#5U @ 12"

-2-#6 ADDED

__2-#5 ADDED TYP.

- 2 #5 ADDED BARS

-- #5 @ 12" HORIZ. EA. FACE