
				FED. ROAD DIST. NO. STATE FED. AID PROJ. NO. SHEET TOTAL SHEET SHEETS AND. SHE
GENERAL NOTES:	<u>EL</u>	ECTRICAL SYN	<u> 1BOLS:</u>	
CONTRACTOR TO PROVIDE NEW LED BASED LIGHTING SYSTEM THAT MEETS THE LATEST AASHTO ROADWAY LIGHTING DESIGN STANDARD AND AS SPECIFIED BY THIS CONTRACT.	EXISTING	REMOVE	NEW	
EXISTING CONDITION BASED ON LIMITED FIELD OBSERVATION AND REFERENCE DRAWINGS. CONTRACTOR TO VERIFY EXISTING CONDITION AND REPORT DISCREPANCY TO ENGINEER PRIOR TO CONSTRUCTION.				STREET LIGHTING ASSEMBLY - SINGLE 132 WATT LED LUMINAIRE
ALL ELECTRICAL WORK SHALL COMPLY WITH THE REQUIREMENTS OF THE DEPARTMENT OF TRANSPORTATION, NEC AND LOCAL CODES AND AMENDMENTS, STATE OF HAWAII RULES AND REGULATIONS, NEC (ANSI C2), UTILITY APPLICABLE COMPANY STANDARDS AND REQUIREMENTS.		1		STREET LIGHTING ASSEMBLY - DOUBLE 132 WATT LED LUMINAIRES
COORDINATE ALL WORK WITH UTILITY COMPANIES.				PULLBOX-TYPE AS SPECIFIED ON DRAWING
DRAWINGS ARE DIAGRAMMATIC AND SYMBOLIC AND MAY NOT SHOW ALL COMPONENTS AND DETAILS. INSTALL ALL WORK IN A NEAT AND LOGICAL MANNER AND PROVIDE ALL COMPONENTS FOR A COMPLETE AND OPERABLE SYSTEM WITHIN INTENT INDICATED ON DRAWINGS AND SPECIFICATIONS.				UNDERGROUND DUCTLINES, EXPOSED RACEWAYS OR CONCEALED RACEWAYS WITHIN STRUCTURE, WITH WIRES 1 QUANTITY AND SIZE AS SPECIFIED ON DRAWING
SEE EROSION CONTROL, TRAFFIC CONTROL, AND STRUCTURAL PLANS AND DETAILS, AND PROVIDE ELECTRICAL WORK AS APPROPRIATE.			_·	UNDERGROUND DUCTLINE STUB-OUT, 5'-0" FROM EDGE OF PAVEMENT OR AS INDICATED ON PLAN. PROVIDE CONCRETE STUB-OUT MARKER.
COORDINATE ALL WORK WITH OTHER TRADES TO AVOID CONFLICTS. ADJUST LOCATION OF THE NEW ELECTRICAL EQUIPMENT AND WIRING AS REQUIRED TO CLEAR OBSTRUCTIONS AND EQUIPMENT. PROVIDE THE REQUIRED MOUNTING ACCESSORIES NEEDED TO PROPERLY INSTALL THE ELECTRICAL EQUIPMENT AND WIRING.			JWP	WEATHER PROOF JUNCTION BOX, WALL MOUNTED, NEMA 4X S/S SIZE PER NEC 1
ALL WIRES SHALL BE INSULATED COPPER CONDUCTORS AND INSTALLED IN RACEWAYS UNLESS INDICATED OTHERWISE.			WP	WEATHER PROOF 1
ALL RACEWAYS SHALL BE PVC COATED GRS WHERE EXPOSED AND CONCRETE ENCASED SCHEDULE 40 PVC FOR UNDERGROUND USE.				LED CANOPY-SOFFIT LIGHT FIXTURE CREE CPY250 , CPY250-A-DM-D-A-UL-BZ-40K-PML 1
TONE AREA OF TRENCHES PRIOR TO NEW UNDERGROUND WORK.				
REPAIR ANY DAMAGE MADE TO STRUCTURES AND UTILITIES CAUSED BY CONSTRUCTION.				
EXPOSED JUNCTION BOXES SHALL BE CAST METAL TYPE OR NEMA 4X S/S				

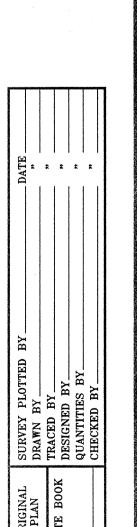

WITH NO UNUSED FACTORY KNOCK-OUTS.

FINISH TO MATCH SURROUNDING SURFACES.

DEFICIENCIES.

SHOULDER AREAS.

TRANSPORTATION AS DIRECTED.

13. PAINT ALL EXPOSED METAL RACEWAYS AND BOXES WITH TWO COATS

14. PROVIDE GROUND WIRES FOR ALL STREET LIGHT CIRCUITS.

15. TEST COMPLETE STREET LIGHTING SYSTEM AND CORRECT ANY

SHALL REMAIN. CUT ANCHOR BOLTS FLUSH W/ SURFACE.

/1 19. SALVAGE ALL LUMINAIRES AND RETURN TO DEPARTMENT OF

17. REMOVE STREET LIGHTING ASSEMBLY WHERE INDICATED ON PLANS,

INCLUDING THE ASSOCIATED WIRES. REMOVE EXPOSED CONDUIT ♦
HANDHOLES. ABANDON IN PLACE UNDERGROUND DUCTLINES AND /


18. RESTORE LANDSCAPING TO MATCH EXISTING CONDITION IN PLANTER \$

INACCESSIBLE HANDHOLES. FIELD VERIFY EXISTING CONDITION. /1

TWO-PART EPOXY BASED PRIMER AND TWO COATS POLYURETHANE ENAMEL

16. EXISTING HIGHWAY LIGHTING SYSTEM SHALL REMAIN IN OPERATION AT ALL TIMES. REMOVE LIGHT POLES AND CONDUCTORS ONLY AFTER THE NEW LIGHTING SYSTEM IS IN OPERATION. REMOVE LIGHT POLE CONCRETE FOUNDATION 12" BELOW FINISH GRADE. LIGHT POLE FOUNDATIONS

INTEGRATED INTO EXISTING RETAINING WALL AND CONCRETE BARRIERS

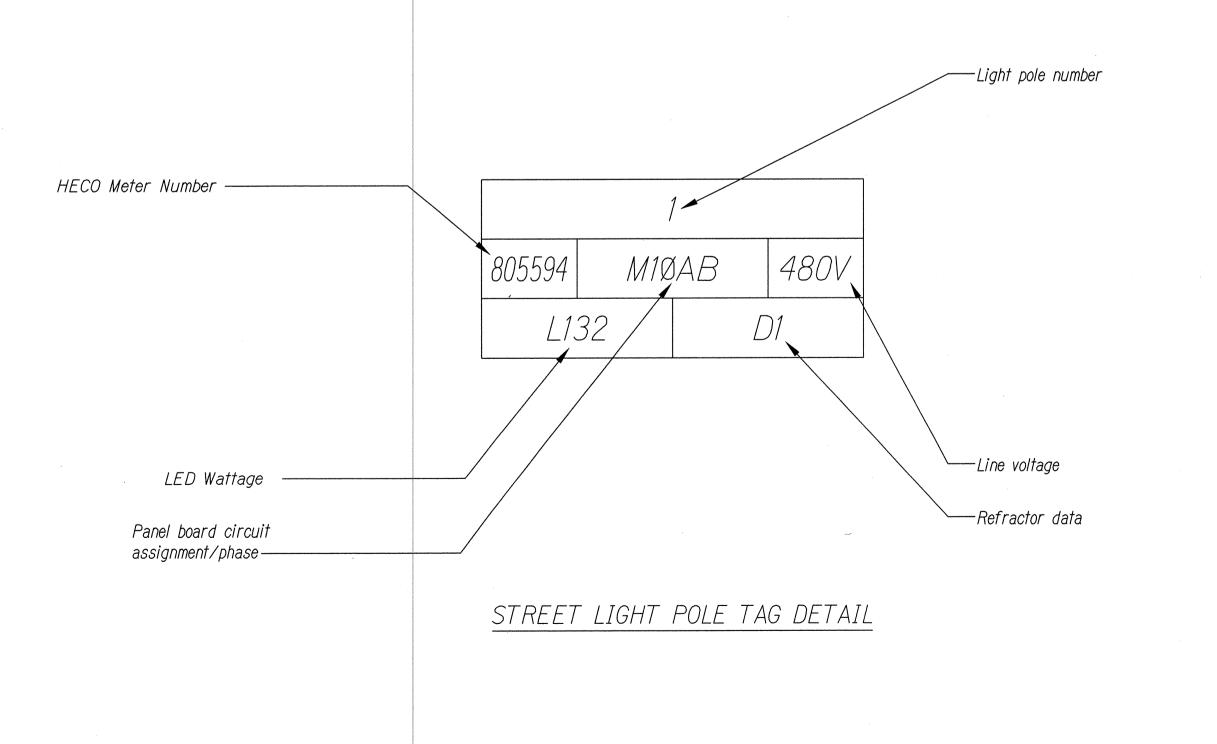

9/13/17 Added Note 19, Revised Symbol List, Added New Light Fixture

DATE REVISION

STATE OF HAWAII

STATE OF HAWAI'I

DEPARTMENT OF TRANSPORTATION

HIGHWAYS DIVISION

GENERAL ELECTRICAL NOTES,

SYMBOLS

LICENSED
PROFESSIONAL
ENGINEER
NO. 4210-E

EXPIRATION DATE OF THE LICENSE 4/30/2018

THIS WORK WAS PREPARED BY ME OR UNDER MY SUPERVISION

MOANALUA FREEWAY, HIGHWAY LIGHTING IMPROVEMENTS

Halawa Heights Off-ramp to Middle St Overpass

Halawa Heights Off-ramp to Middle St. Overpass

FAP NO. NH-H201(005)

Scale: NTS Date: August 2017

SHEET No. E-1 OF 53 SHEETS

ADD. 119

CONSTRUCTION NOTES \$ MATERIAL LIST:

- Description of Lighting Service Conduits to the HECo Service Point. Notify HECo Prior to Removal of Lighting Conductors. Abandon Conduit in Place.
- Aighway Lighting Conduit 1-2".
- ③ Highway Lighting Type "A" Pullbox. See HDOT Standard Plans TE-37A.
- Communication Type Pullbox. See HDOT Standard Plans TE-37B.
- \diamondsuit Junction Box NEMA 4X Stainless Steel 2 each, 1 Highway Lighting and 1 Communication. $frac{1}{2}$
- 6 Communication Conduits 2-2".
- ♦ Conduit in Concrete Glare Screen. 🗥
- ⊗ Not Used. ✓1
- PVC coated GRS Conduit Mounted on Side of Bridge, Overpass Structure, or above grade.
 See E-49 for details.
- (D) Conduit Under Roadway, Shoulder Area, or Grass Area.
- (1) Conduit in Microtunnel.
- 42 Highway Lighting Standard on Top of New Median Wall. See $\frac{1}{51.4}$ $\frac{1}{51.5}$
- (3) Highway Lighting Standard on Grade. See
- 4 Highway Lighting Standard in Planter. See $\frac{S}{S1.7}$ $\frac{S}{S1.7}$
- 45 Highway Lighting Standard Mounted on Side of Barrier Wall or Bridge. See $\frac{1}{S3.1}$ $\frac{2}{S3.1}$ $\frac{2}{S3.1}$ $\frac{2}{S3.1}$ $\frac{2}{S3.1}$
- 6 Highway Lighting Standard Mounted on Retaining Wall. See
- $\widehat{\psi}$ Electrical/Communication Pullbox Insert in Median, Barrier, or Retaining Wall. See $\frac{5}{54.1}$ S4.1
- 48 Highway Lighting Conduit 1-2" with Spare 1-2" (2-2" Total).
- ♦ Communication Conduits 2-2" and Power Conduit 1-2" (3-2" Total).
- Electrical/Communication Pullbox. Minimum Sized per NEC for Power and TIA 569-B for Communication in Bridge Wall. See 53.1 | S3.3

FED. ROAD DIST. NO. FISCAL SHEET YEAR NO. STATE PROJ. NO.

9/13/17 Revised Construction Note List


REVISION

STATE OF HAWAI'I
DEPARTMENT OF TRANSPORTATION HIGHWAYS DIVISION

MOANALUA FREEWAY, HIGHWAY LIGHTING IMPROVEMENTS


Halawa Heights Off-ramp to Middle St. Overpass FAP NO. NH-H201(005)


> Date: August 2017 SHEET No. E-3 OF 53 SHEETS

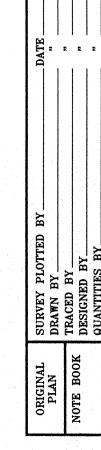


EXPIRATION DATE OF THE LIGENSE 4/30/2018


THIS WORK WAS PREPARED BY
ME OR UNDER MY SUPERVISION

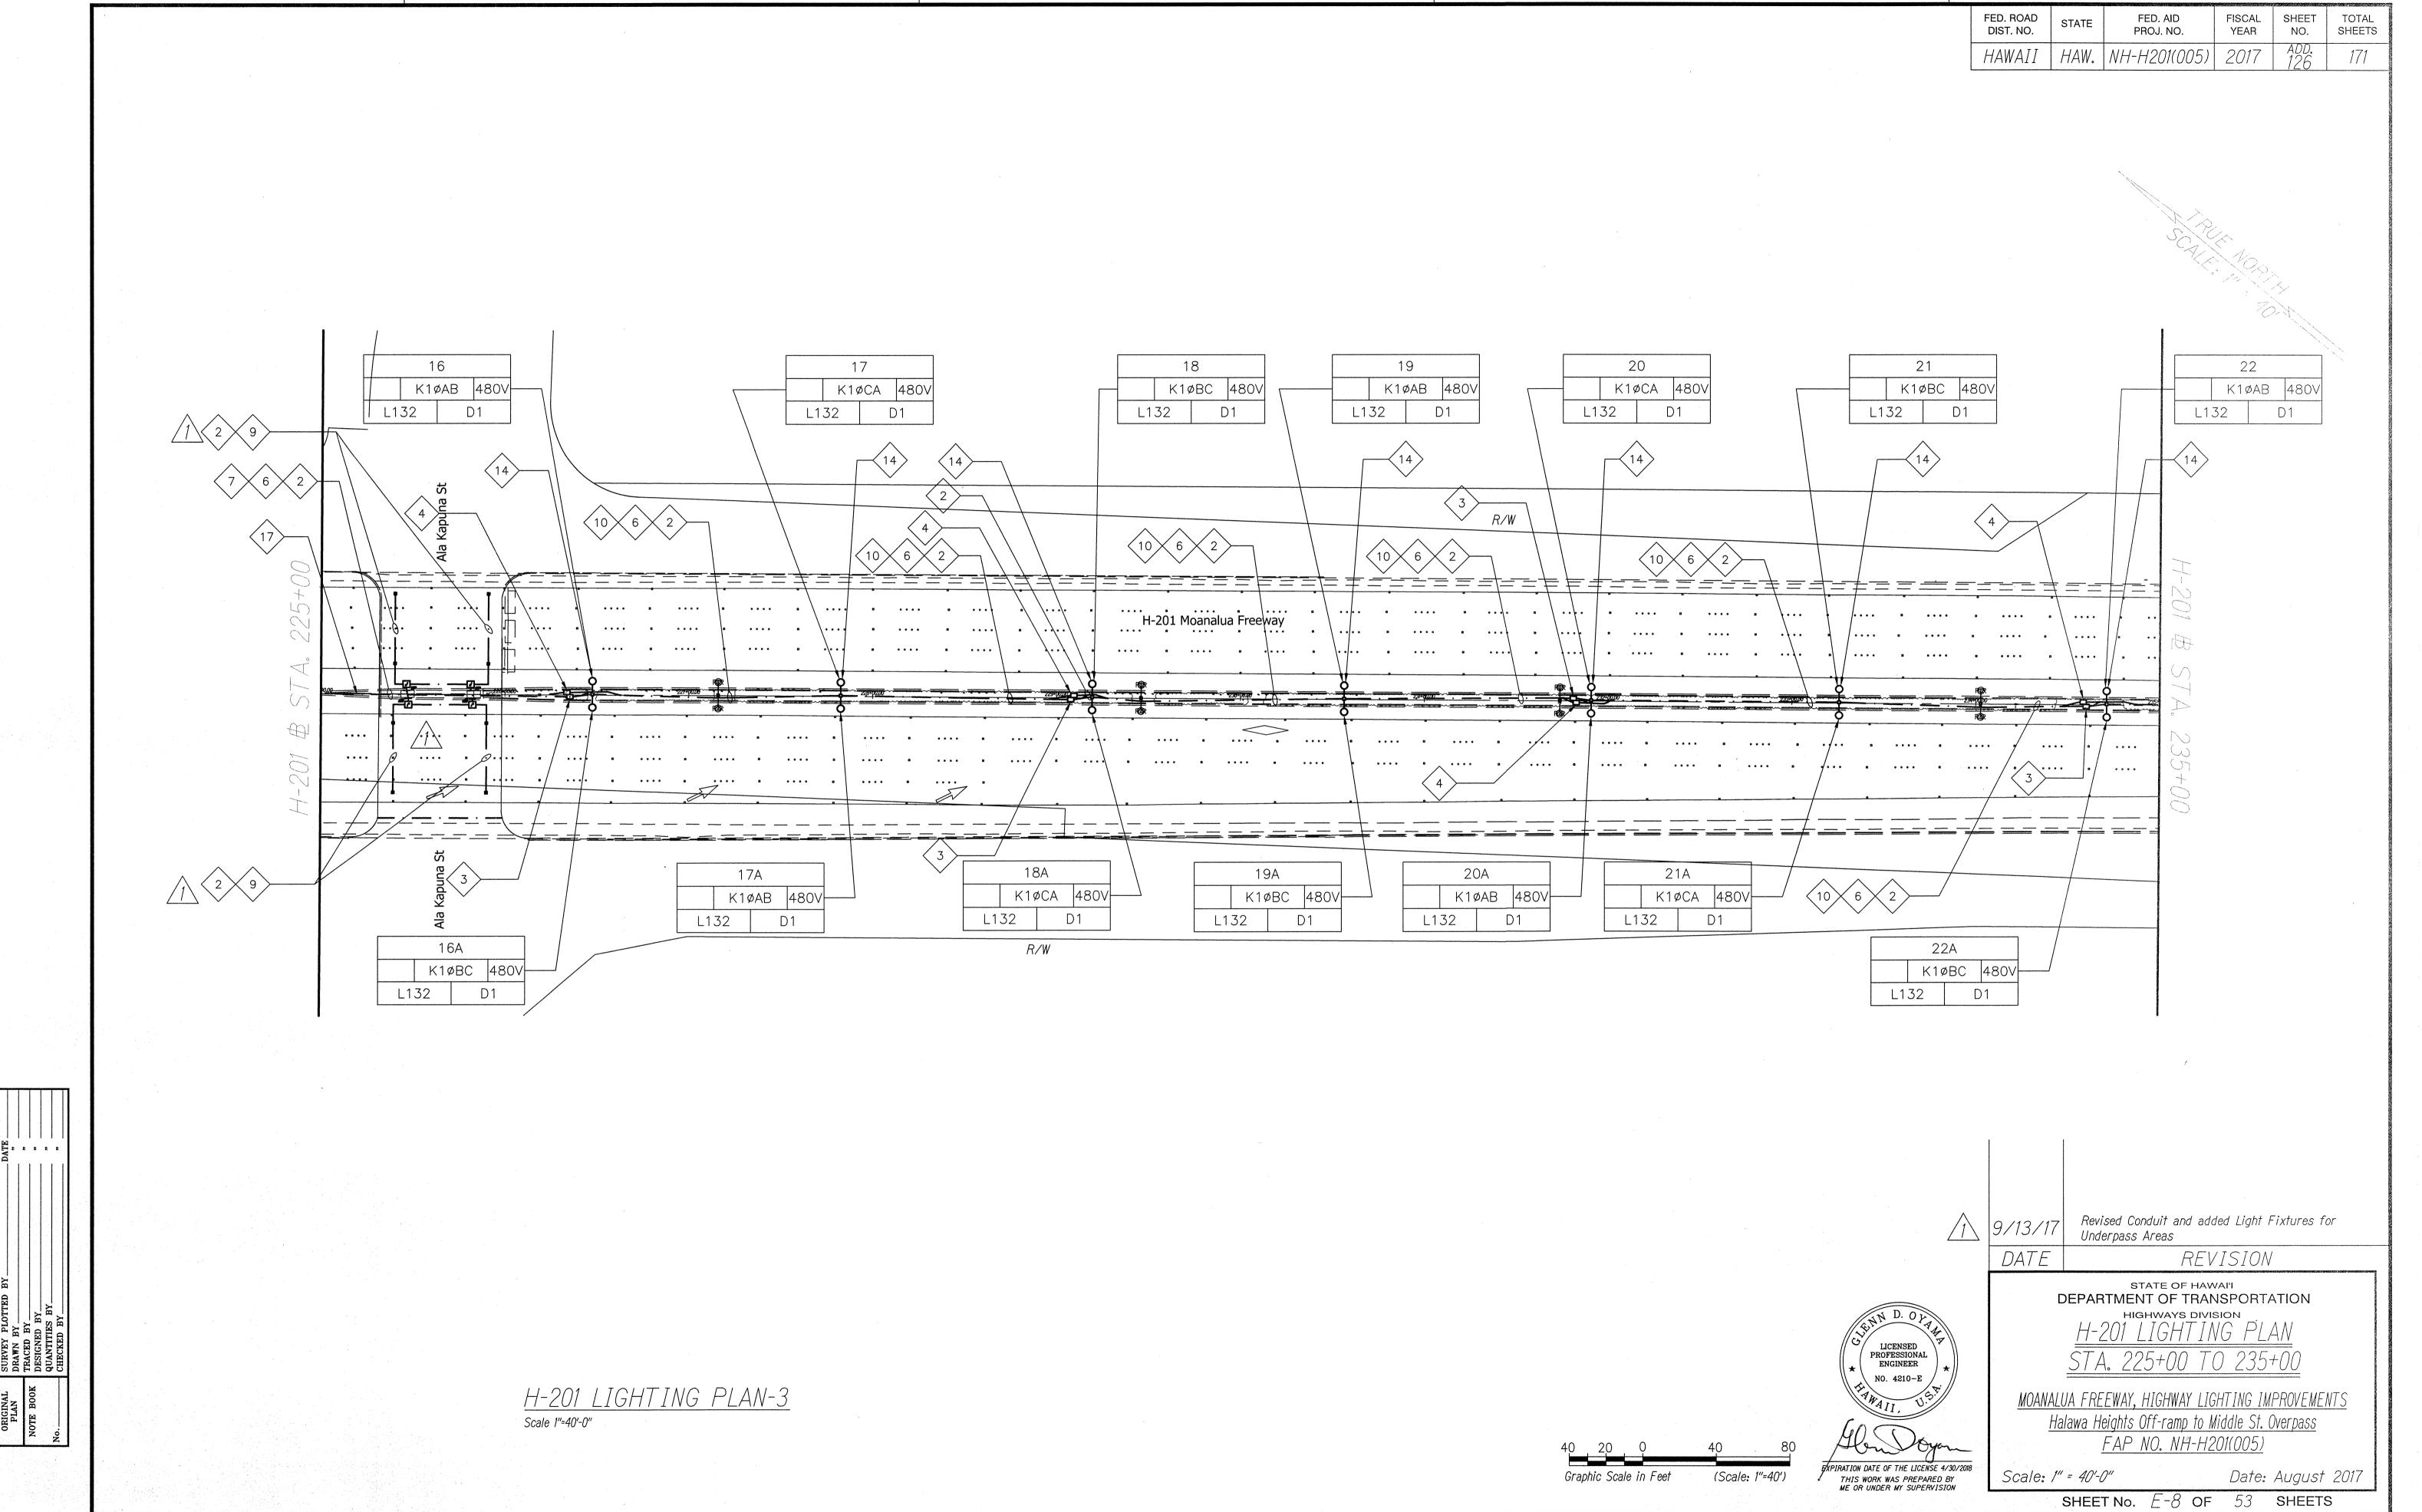


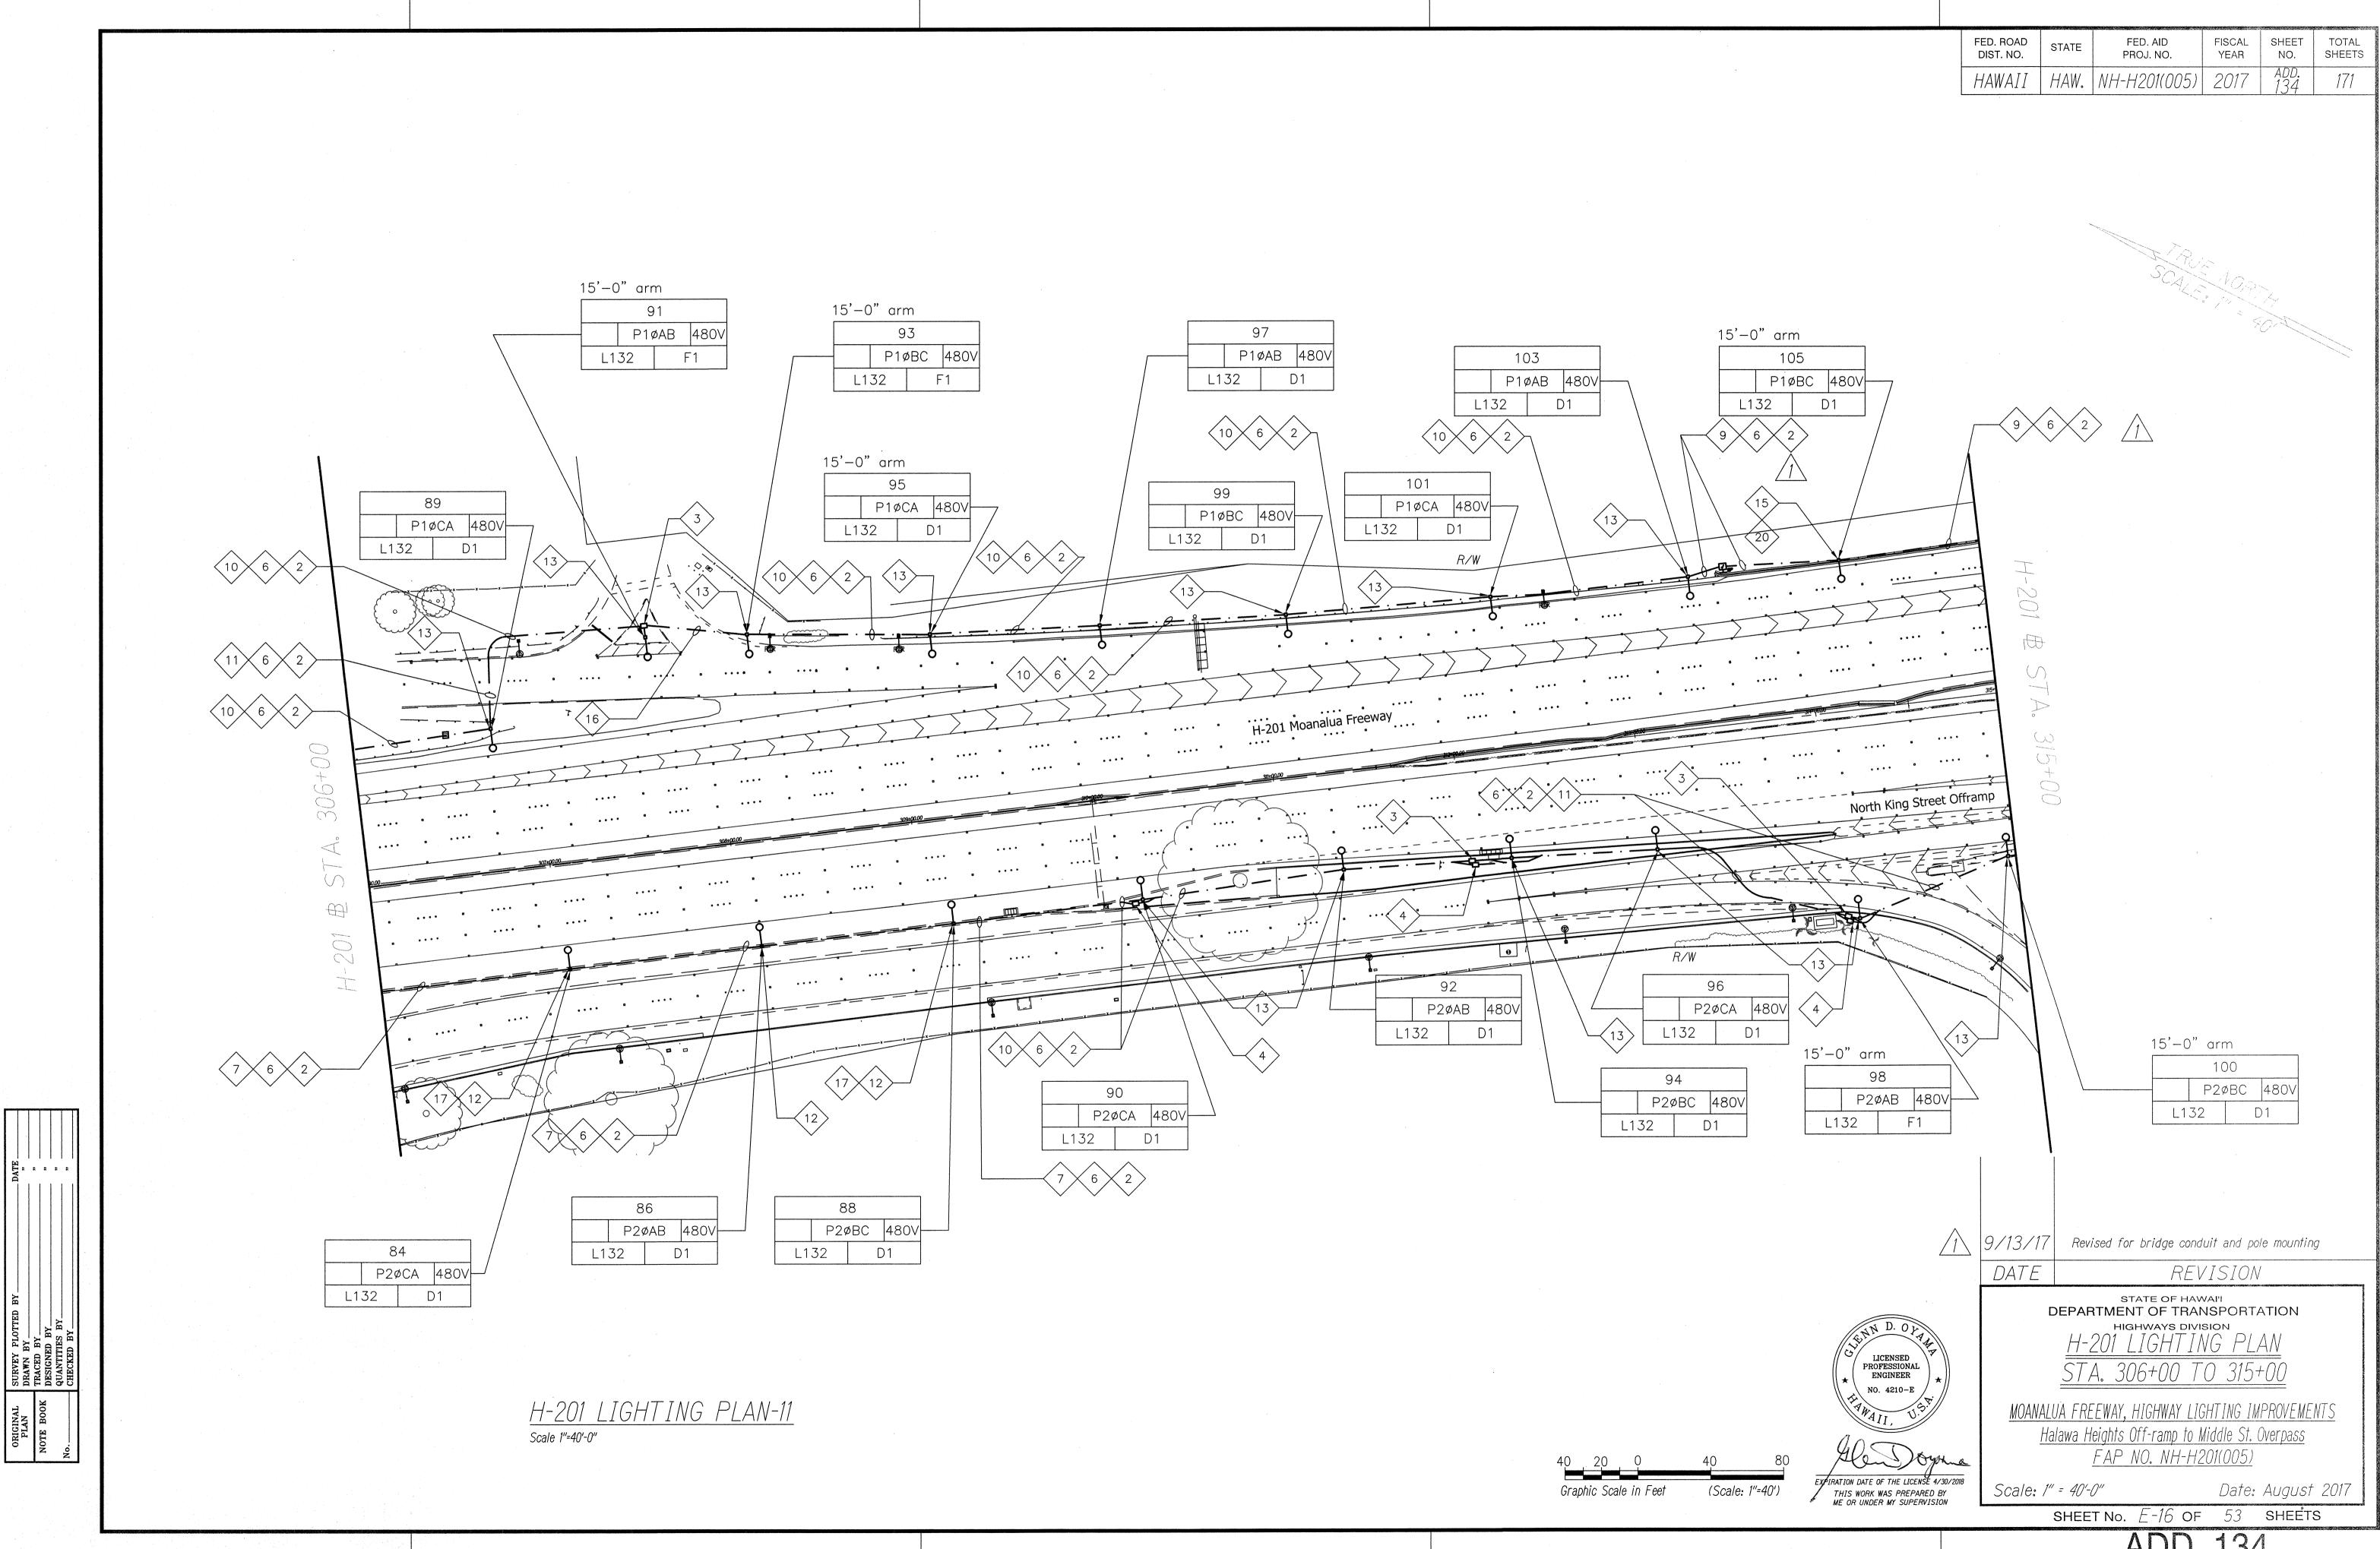


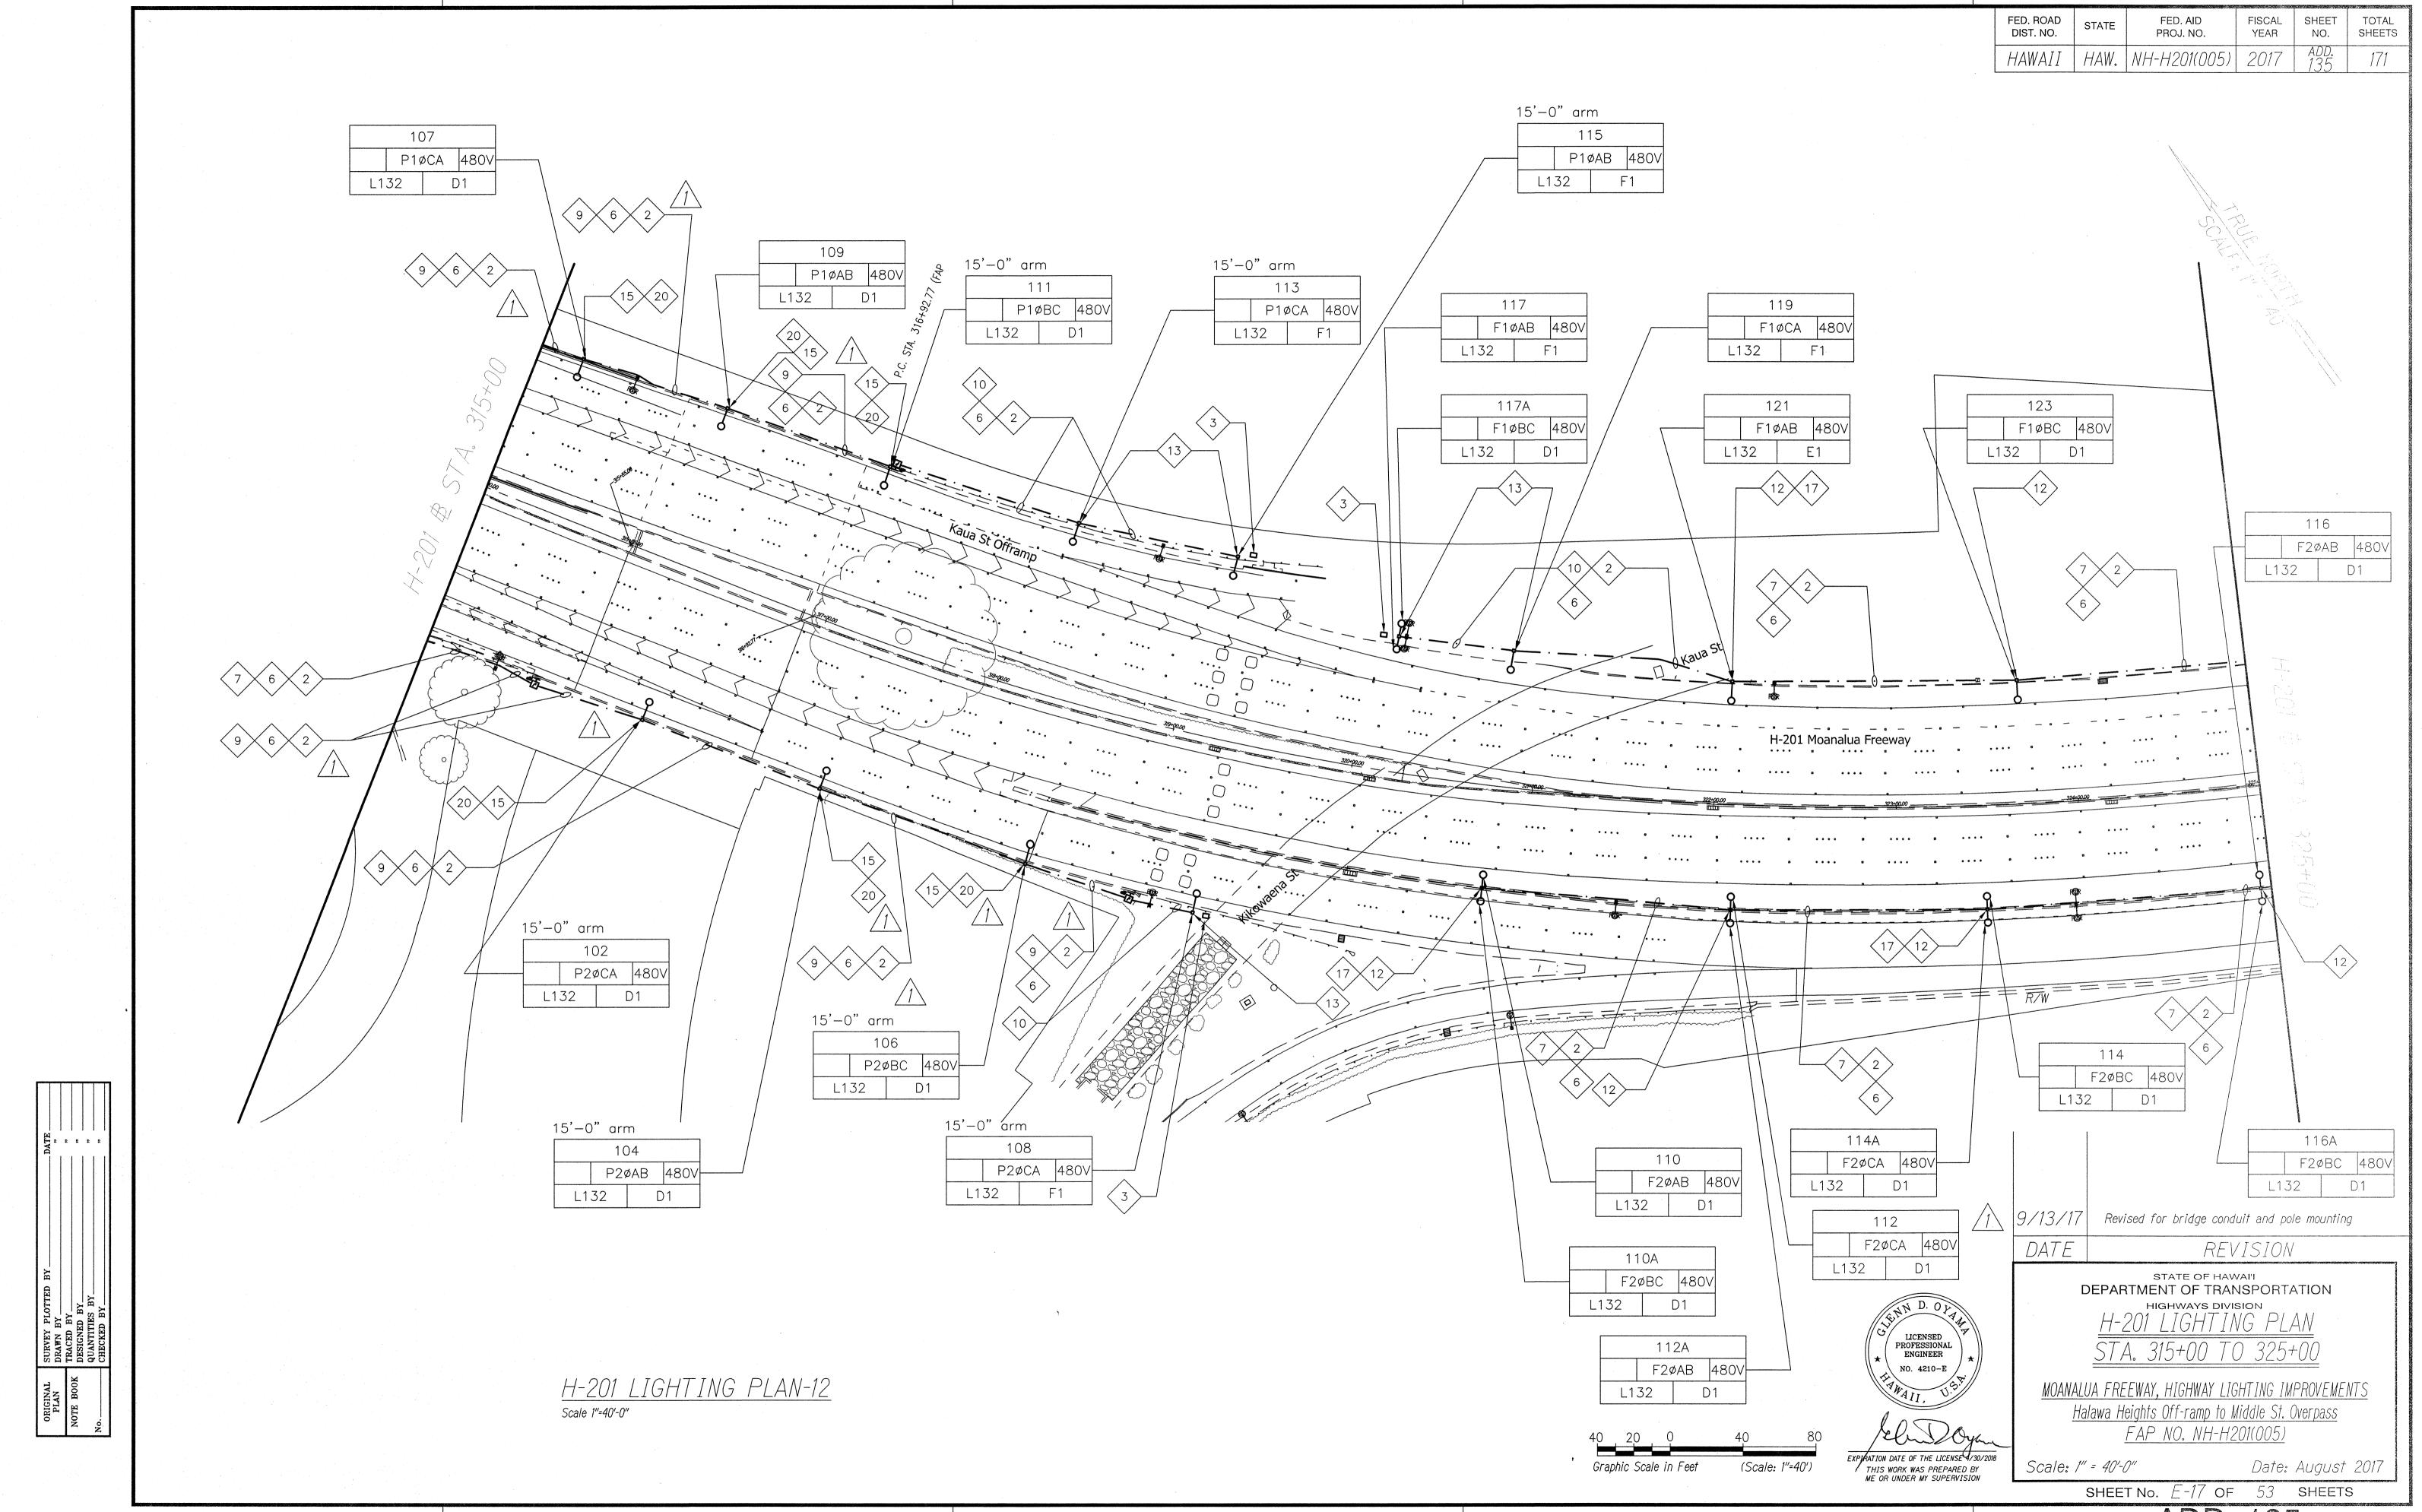


ADD, 135

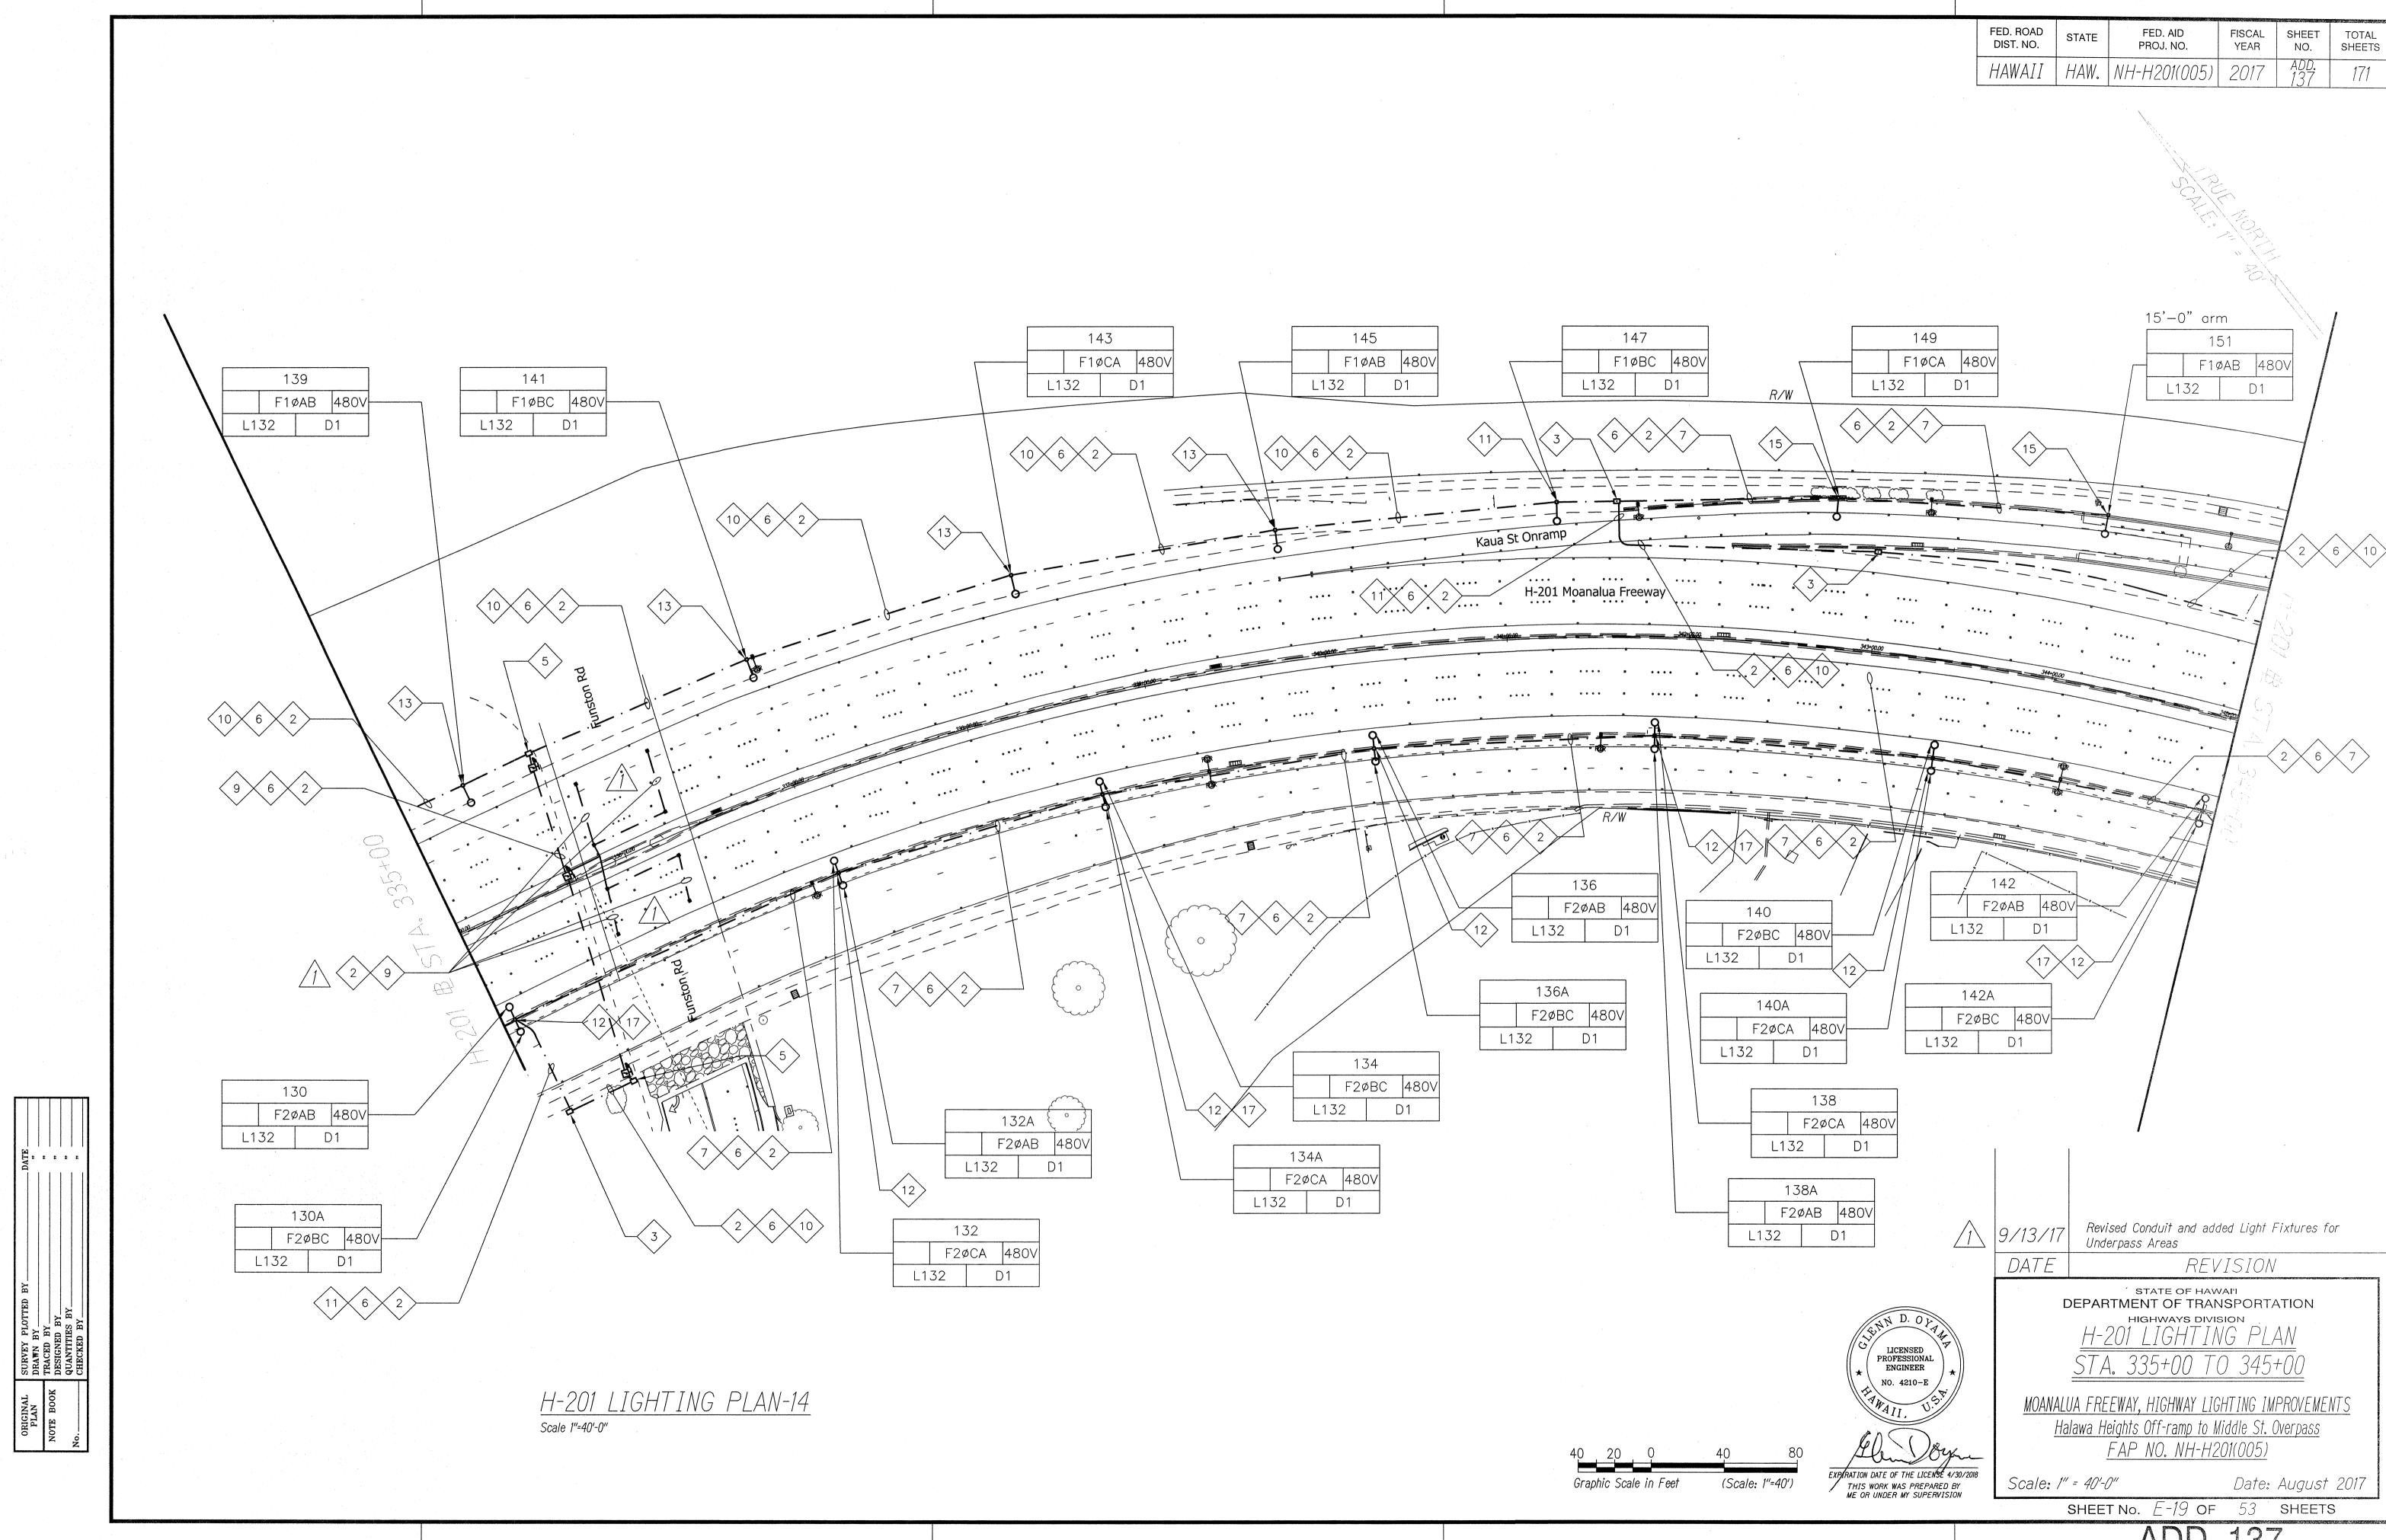

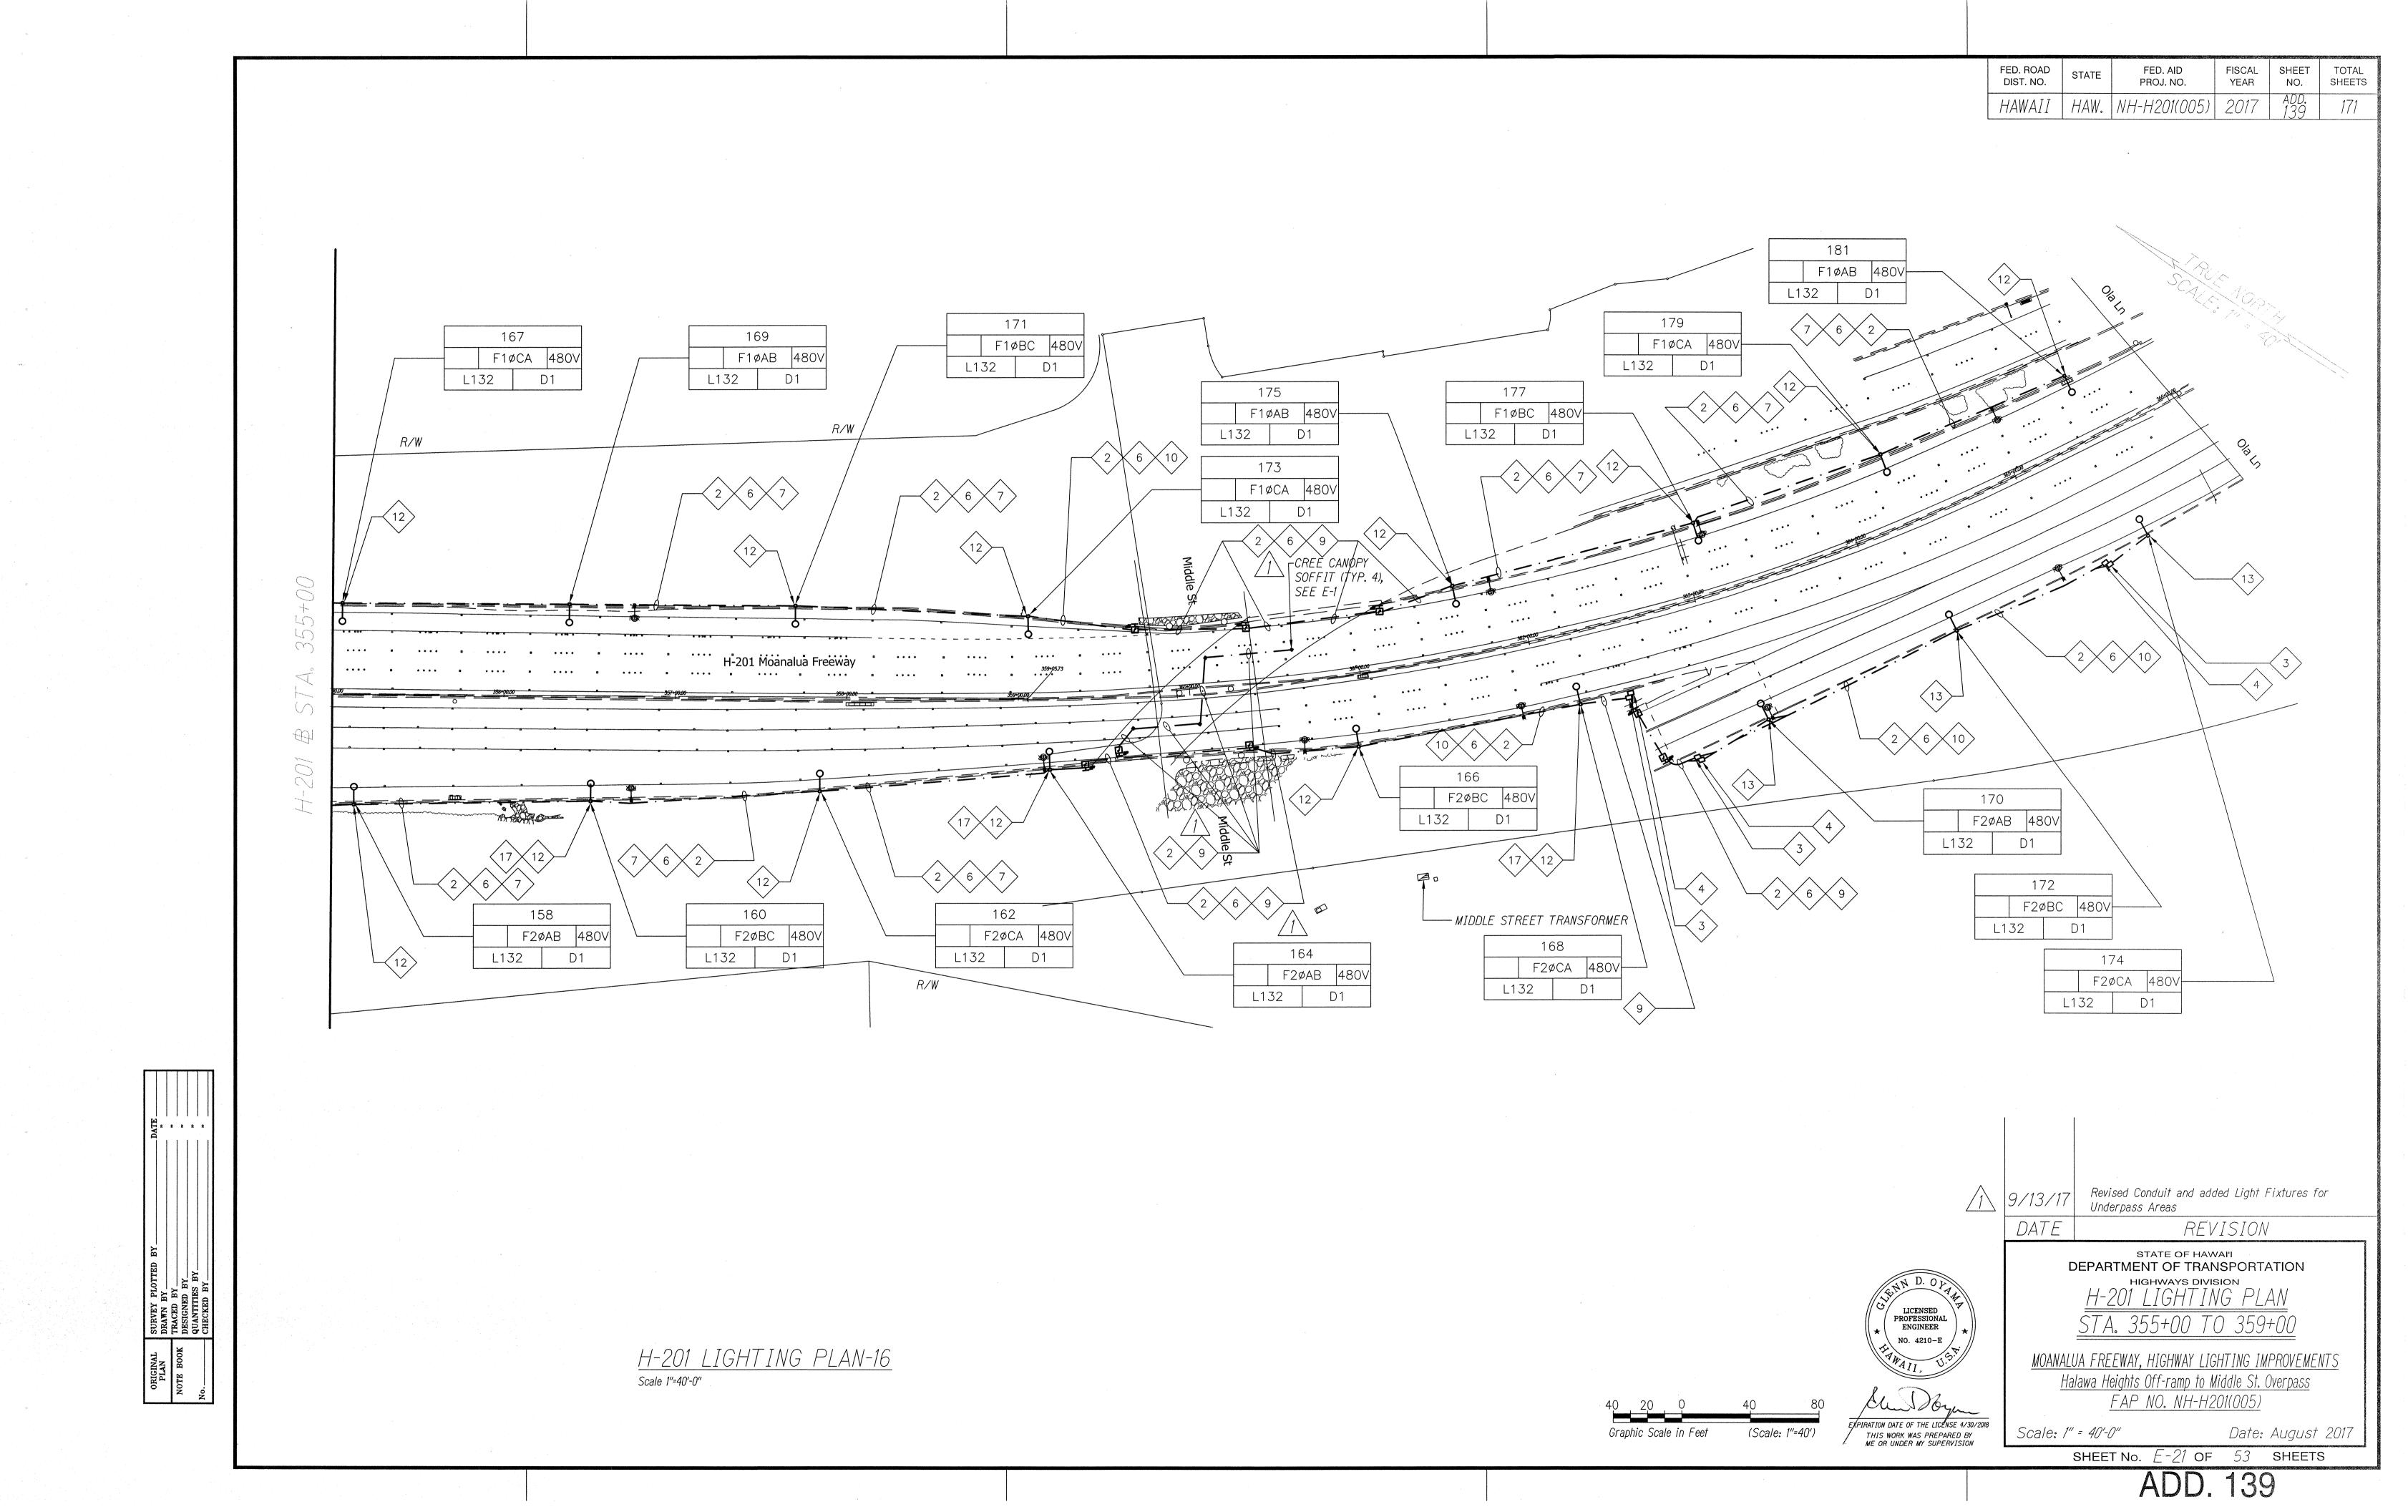

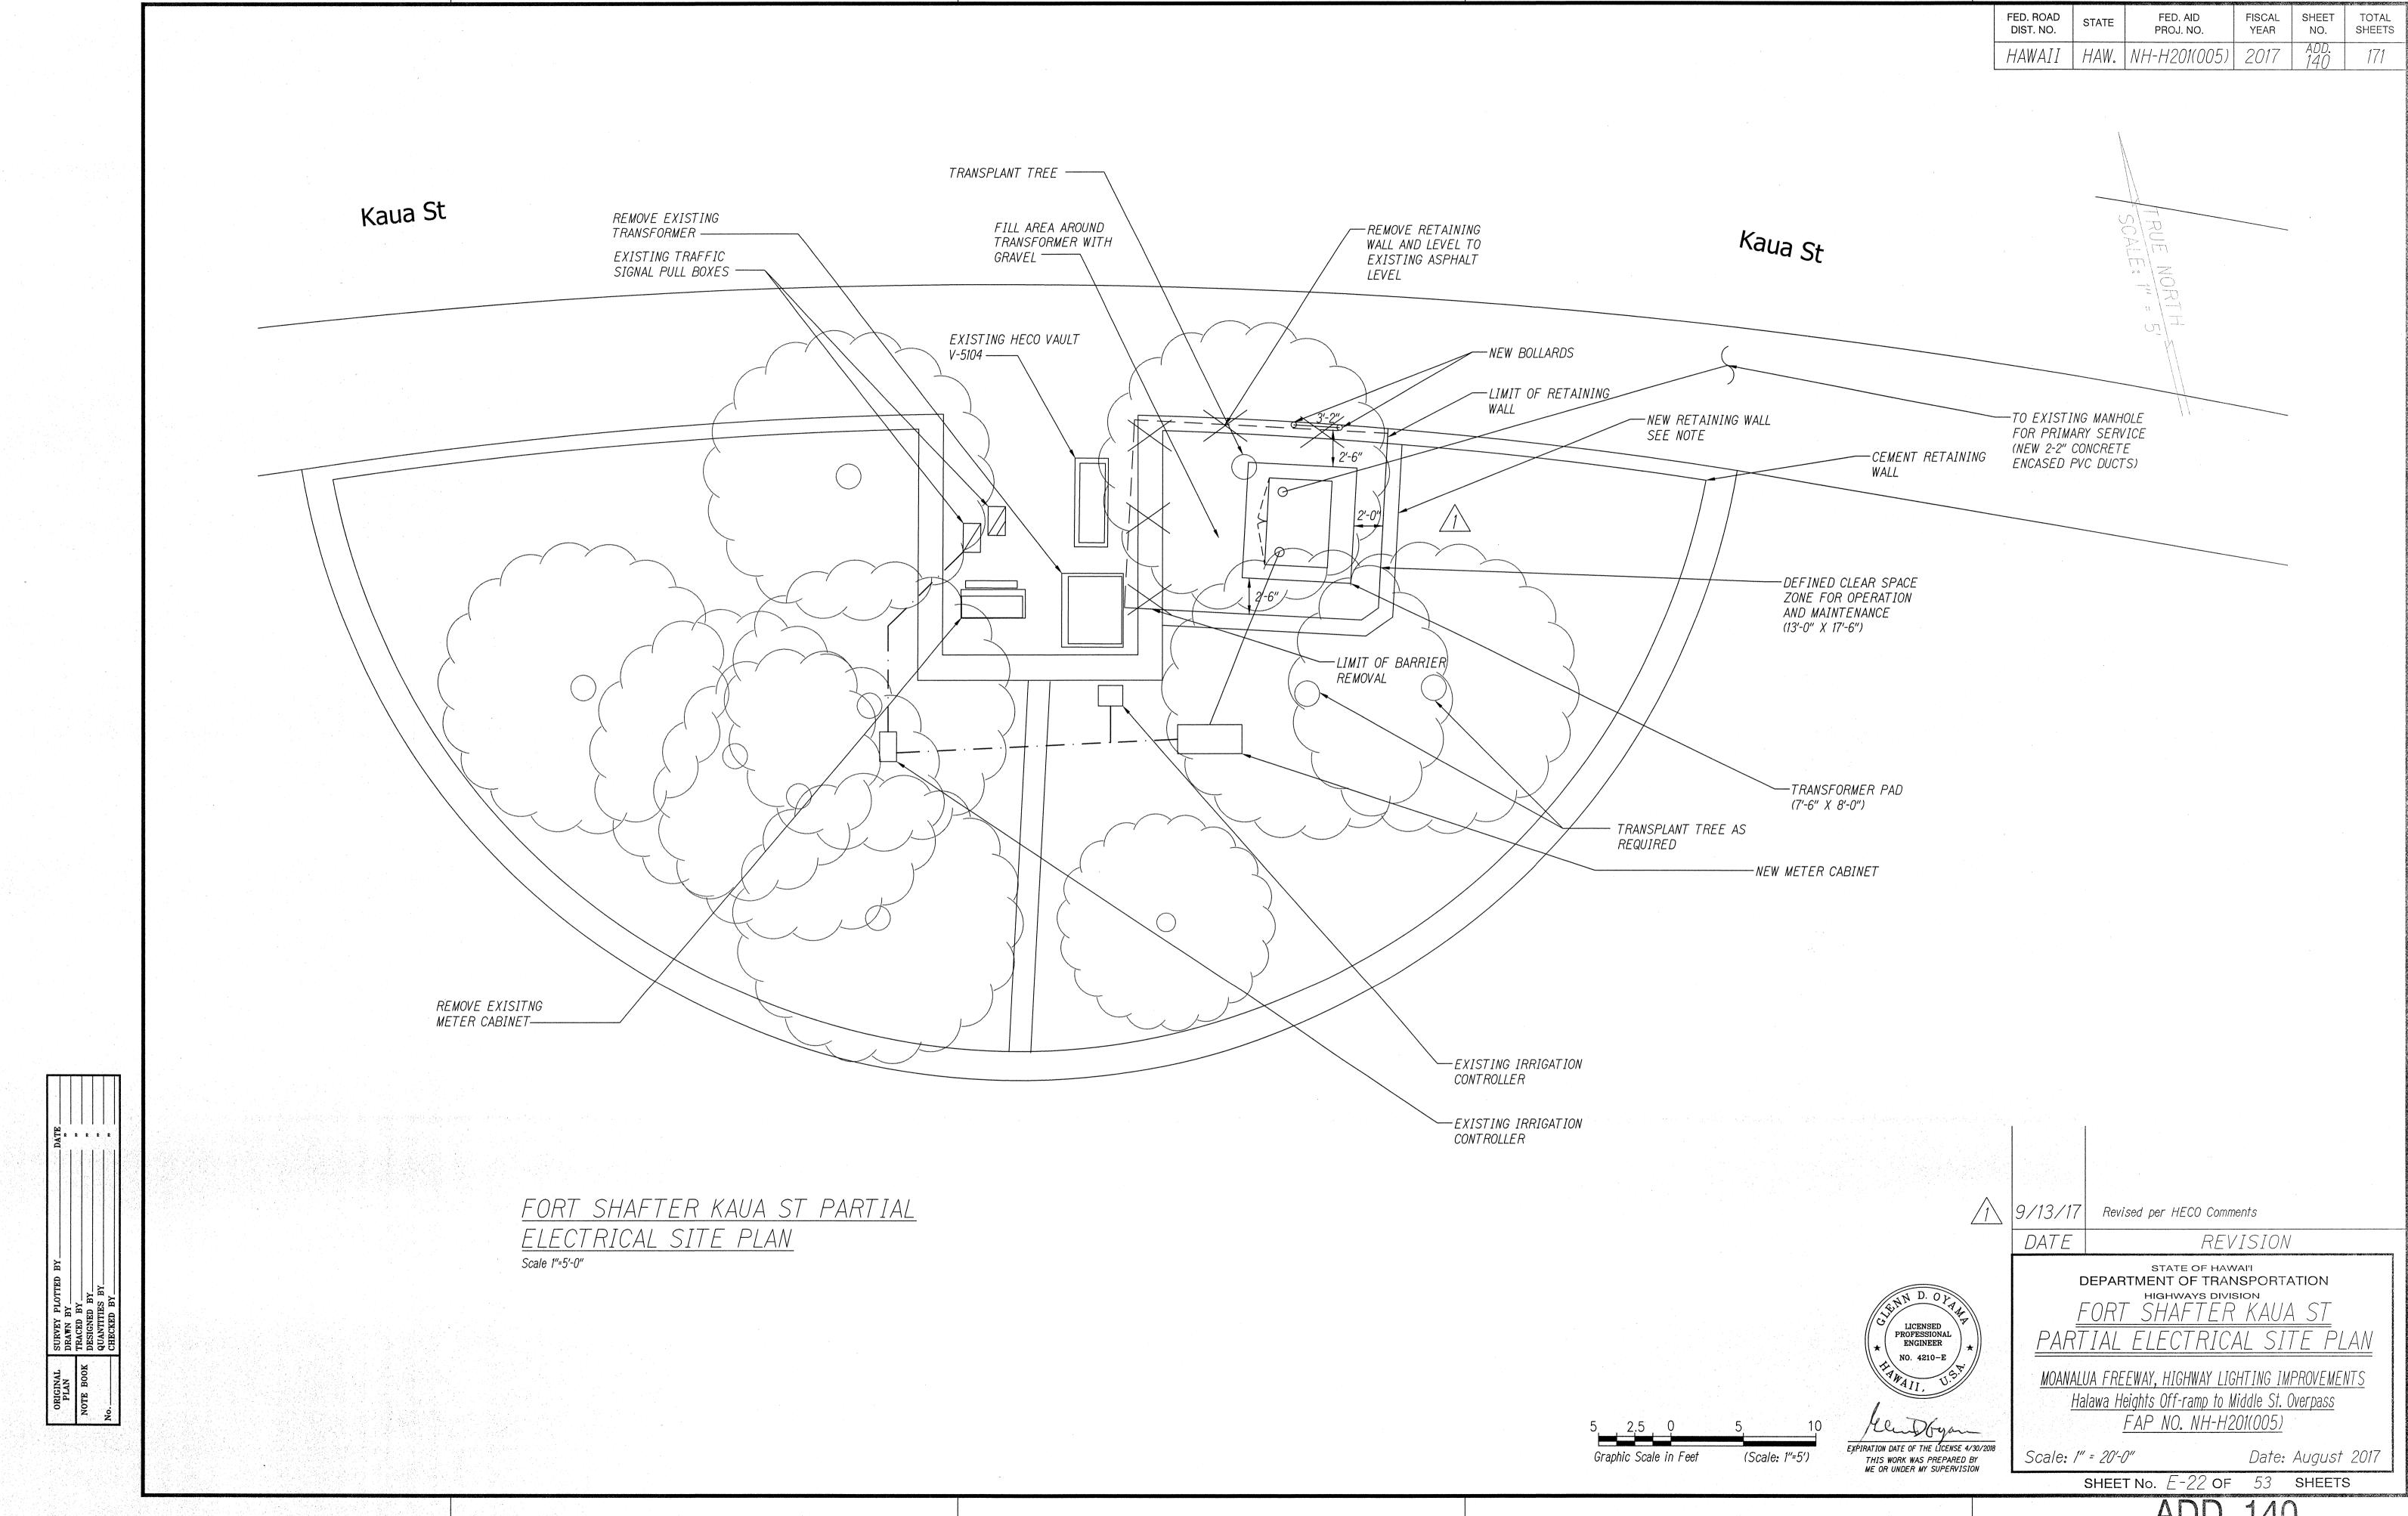

FED. ROAD	STATE	FED. AID	FISCAL	SHEET	TOTAL
DIST. NO.		PROJ. NO.	YEAR	NO.	SHEETS
HAWAII	HAW.	NH-H201(005)	2017	add. 169	171

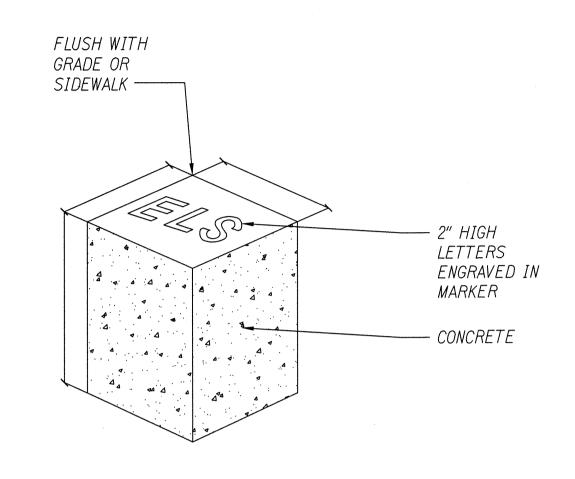


CONDUIT STUB-OUT MARKER

SCALE: NTS

<u>NOTES:</u>

1. "E"=Electric "L"=Light "S"=Traffic Signal

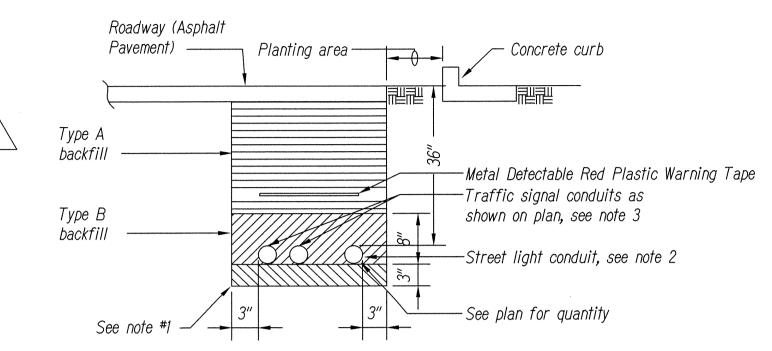

TRENCHING DETAIL


TYPE "A": Beach sand, earth or earth & gravel. If earth & gravel used, max. rock size shall be 1" \(\pi \) mixture shall contain not more than 50% by volume or rock particles. 95% compaction

TYPE "B": Same as Type "A" except that if earth \$\psi\$ gravel used, the mixture must pass a 1/2" mesh screen ¢ contain not more than 20% by volume of rock particles. 95% compaction

NOTES: 1. If the normal material in the bottom of trench is not Type "B" an additional 3" shall be excavated \$ Type "B" backfill shall be provided.

> 2. All roadway crossing street light conduits shall be PVC schedule 40 with 3" concrete jacket. 2800 PSI @ 28 days compressive strength.


3. All traffic signal conduits shall be PVC schedule 40 with 3" concrete jacket. 2800 PSI @ 28 days compressive strength.

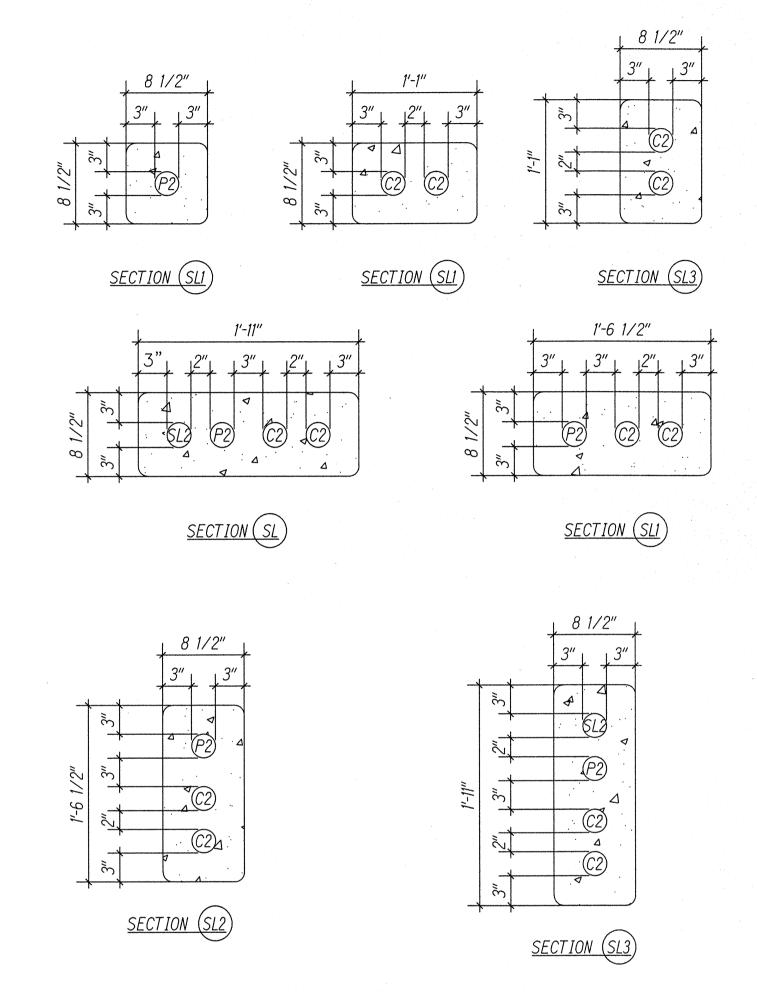


DUCT DETAILS

NOTES:

Contractor to determine applicability of duct section based on the duct complement noted on the plans.

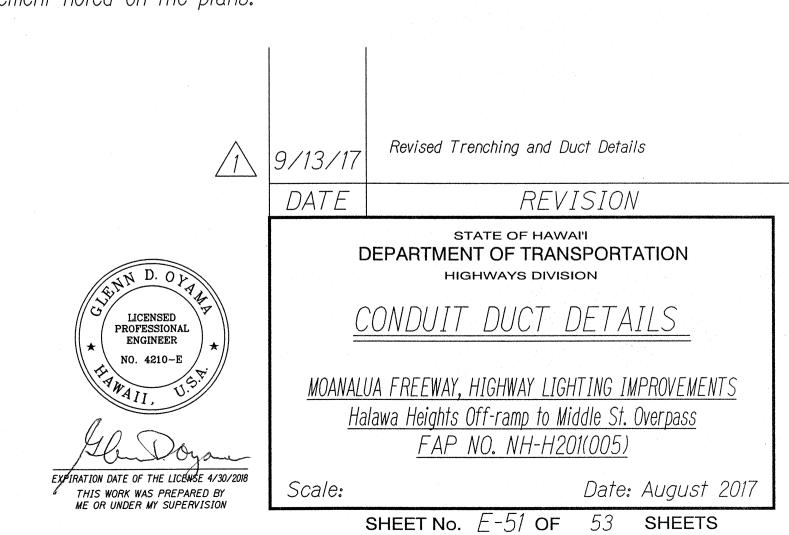

T.

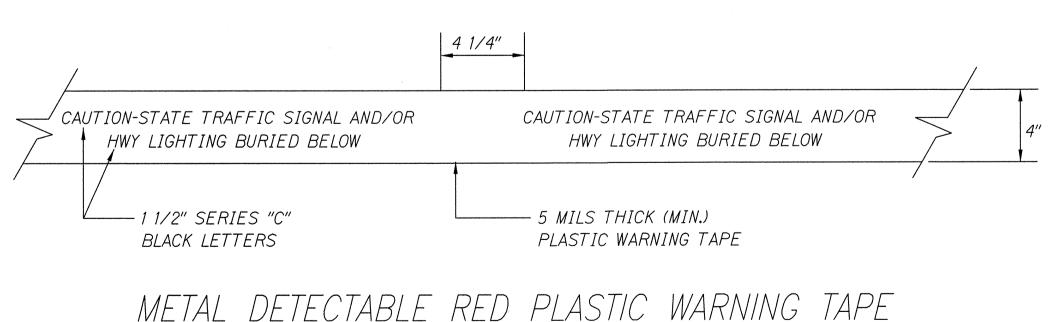

METAL DETECTABLE RED PLASTIC WARNING TAPE SCALE: NTS