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2	STANDARD PLANS SUMMARY
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STATE OF HAWAII

DEPARTMENT OF TRANSPORTATION

HIGHWAYS DIVISION HONOLULU, HAWAII


PLANS FOR


COMMERCIAL DRIVER'S LICENSE AND MOTORCYCLE LICENSE TESTING FACILITY EXAMINATION SITE AND OFFICE RENOVATION

BENEATH INTERSTATE ROUTE H-1 PEARL CITY VIADUCT

PROJECT NO. HWY-0-08-14

DISTRICT OF EWA ISLAND OF OAHU

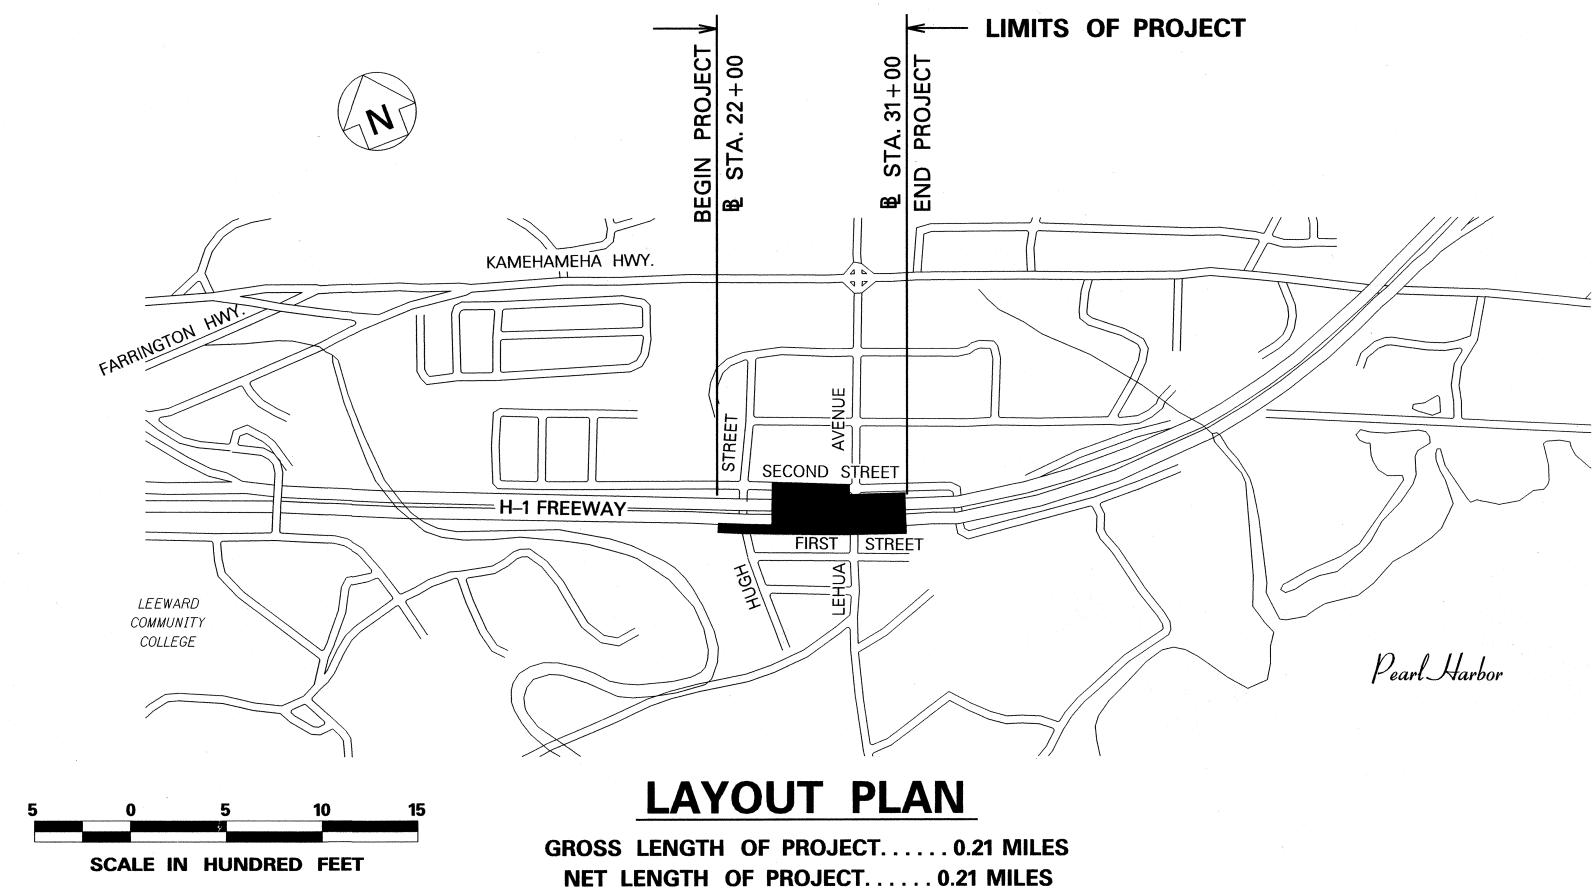

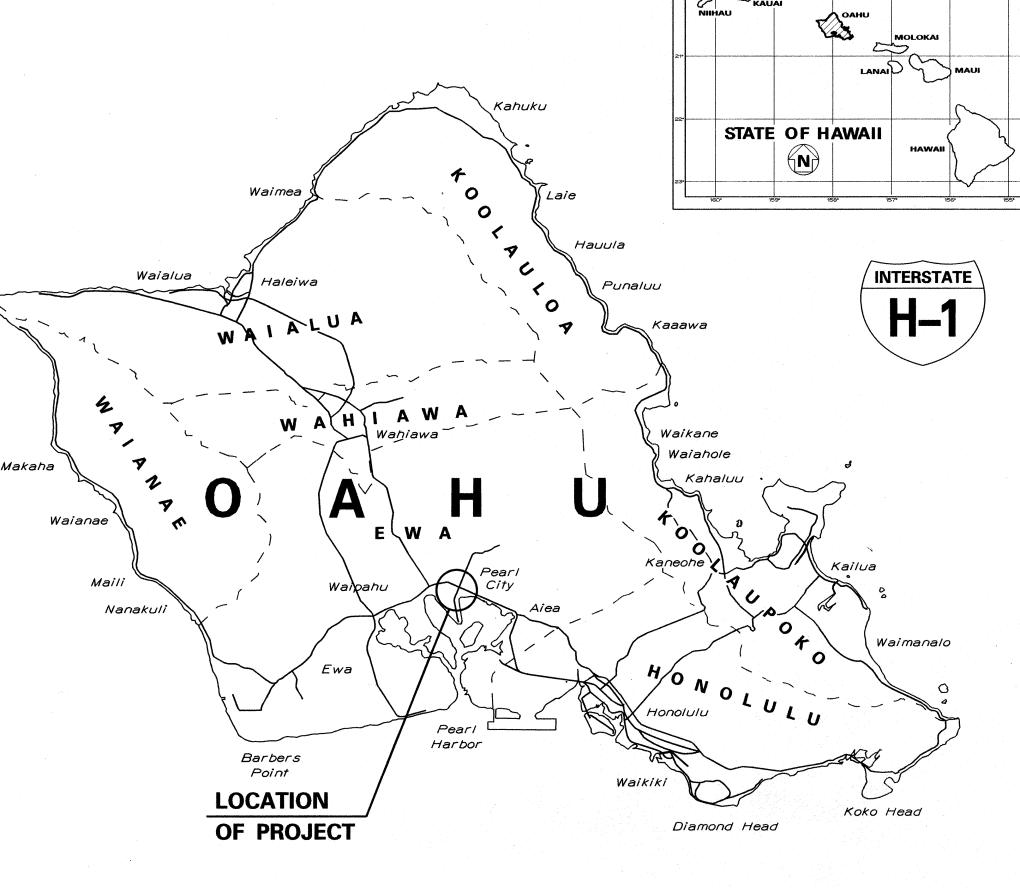

MILE POST 9.56 TO MILE POST 9.80

SCALE IN MILES

HWY-O-08-14 2016 APP. 1

APPROVED:

DIRECTOR, DEPT. OF PLANNING & PERMITTING DATE (For work in City R/W only)

State of the state		DEPARTMENT OF TRANSPORTATION STATE OF HAWAII				
5/25/16	Dent of Planning and	APPROVED:				
0123110	Dept. of Planning and Permitting Approval Signature	202hl	5-9-14			
DATE	REVISION	DIR. OF TRANSPORTATION	DATE			

CONSTRUCTION NOTES FOR WORK WITHIN CITY R/W

- 1. All applicable construction work shall be done in accordance with the Standard Specifications for Public Works Construction, September 1986 and Standard Details for Public Works Construction, September 1984, as amended, of the Department of Public Works, City and County of Honolulu and the Counties of Kauai, Maui, and Hawaii.
- 2. The underground pipes, cables or ductlines known to exist by the Engineer from his search of records are indicated on the plans. The Contractor shall verify the locations and depths of the facilities and exercise proper care in excavating the area. Wherever connections of new utilities to existing utilities are shown on the plans, the Contractor shall expose the existing lines at the proposed connections to verify their locations and depths prior to excavation for the new lines.
- 3. No Contractor shall perform any construction operation so as to cause falling rocks, soil or debris in any form to fall, slide or flow into existing City drainage systems, or adjoining properties, streets or natural watercourses. Should such violations occur, the Contractor may be cited and the Contractor shall immediately make all remedial actions necessary.
- 4. The Contractor shall be responsible for conformance with applicable provisions of the Hawaii Administrative Rules, Title 11, Chapter 54, "Water Quality Standards," and Title 11, Chapter 55, "Water Pollution Control", as well as Chapter 14 of the Revised Ordinances of Honolulu, as amended. Best Management Practices shall be employed at all times during construction.

The Contractor shall obtain National Pollutant Discharge Elimination System (NPDES) Permit coverage(s) for the following:

- 1. Storm water discharges associated with construction activities that disturb one (1) acre or more, and
- 2. Discharges of hydrotesting effluent, dewatering effluent, and well drilling effluent to state waters.

In accordance with State law, all discharges related to project construction or operations are required to comply with State Water Quality Standards (Hawaii Administrative Rules, Chapter 11-54). Best Management Practices shall be used to minimize or preventthe discharge of sediment, debris, and other pollutants to State waters. Permit coverage is available from the Department of Health, Clean Water Branch at http://health.hawaii.gov/cwb. The Contractor is responsible for obtaining other Federal, State, or local authorizations as required by law.

5. The Contractor shall notify the Civil Engineering Branch, D.P.P. at 768-8084 to arrange for inspectional services and submit two (2) sets of approved Construction Plans seven (7) days prior to commencement of construction work.

<i>6</i> .	The Contractor may submit a substitution request to precast any City owned and/or maintained drainage structure (ex., catch basins, drain manholes, drain inlets, culverts, etc). However, prior to construction and installation of any precast structure, the Contractor shall a) submit six (6) sets of shop drawings to the Civil Engineering Branch, Department of Planning and Permitting at 768-8084 to arrange for inspectional
	services. Non-compliance with any of these requirements shall mean
	immediate suspension of all precast construction work and rejection of
	all precast structures already constructed.

7. Confined Space

For entry by City personnel, including inspectors, into a permit required confined space as defined in 29 CFR Part 1910.146(b), the Contractor shall be responsible for providing:

- All safety equipment required by the confined space regulations applicable to all parties other than the construction industry, to include, but not limited to, the following:
 - a. Full body harnesses for up to two personnel.
 - b. Lifeline and associated clips.
 - c. Ingress/egress and fall protection equipment.
 - d. Two-way radios (walkie-talkies) if out of line-of-sight.
 - e. Emergency (escape) respirator (10 minute duration).
 - f. Cellular telephone to call for emergency assistance.
 - g. Continuous gas detector (calibrated) to measure oxygen, hydrogen sulfide, carbon monoxide and flammables (capable of monitoring at a distance at least 20-feet away).
 - h. Personal multi-gas detector to be carried by inspector.
- II. Continuous forced air ventilation adequate to provide safe entry conditions.
- III. One attendant/rescue personnel topside (two, if conditions warrant it).
- Pursuant to Chapter 6E, HRS, in the event any artificats or human remains are uncovered during construction operations, the Contractor shall immediately suspend work and notify the Honolulu Police Department, the State Department of Land and Natural Resources Historic Preservation Division (692-8015). In addition, the Contractor shall inform the Civil Engineering Branch, Department of Planning and Permitting (768-8084).
- 9. For projects abutting State Highways' rights-of way, the owner or his authorized representative shall notify the State Department of Transportation, Highways Division, Oahu District, Drainage Discharge Unit at 831-6793 for an assessment of State highways permit requirements.
- 10. For Bench Mark, see Plan Sheet No. 13.

EROSION CONTROL AND BEST

MANAGEMENT PRACTICES FOR WORK

WITHIN CITY R/W:

FED. ROAD DIST. NO. STATE

1. Provide grass stabilization of all pervious disturbed areas within the City and County of Honolulu right of way. Follow the requirements of HAR 11-55 for deadlines to initiate and complete stabilization. Grassing of these areas shall not be paid for separately, but shall be considered incidental to the contract items.

PROJ. NO.

HAWAII HAW. HWY-0-08-14 2016 ADD. 5 88

FISCAL SHEET TOTAL YEAR NO. SHEETS

2. There shall be no stockpiling of materials on impervious surfaces within the City and County of Honolulu right of way.

APPROVED:

on Melini Jatahur

CHIEF, CIVIL ENGINEERING BRANCH, DPP Date (For work within City R/W only)

6/3/16

Added Notes for Erosion Control and Best Management Practices for work within City R/W.

DATE

REVISION


STATE OF HAWAII DEPARTMENT OF TRANSPORTATION HIGHWAYS DIVISION


GENERAL NOTES & LEGEND


COMMERCIAL DRIVER'S LICENSE AND MOTORCYCLE LICENSE TESTING FACILITY EXAMINATION SITE AND OFFICE RENOVATION


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Project No. HWY-0-08-14
Scale: N.T.S. Date: May 2016


SHEET No. 3 OF 3 SHEETS

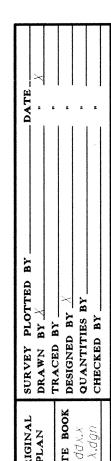


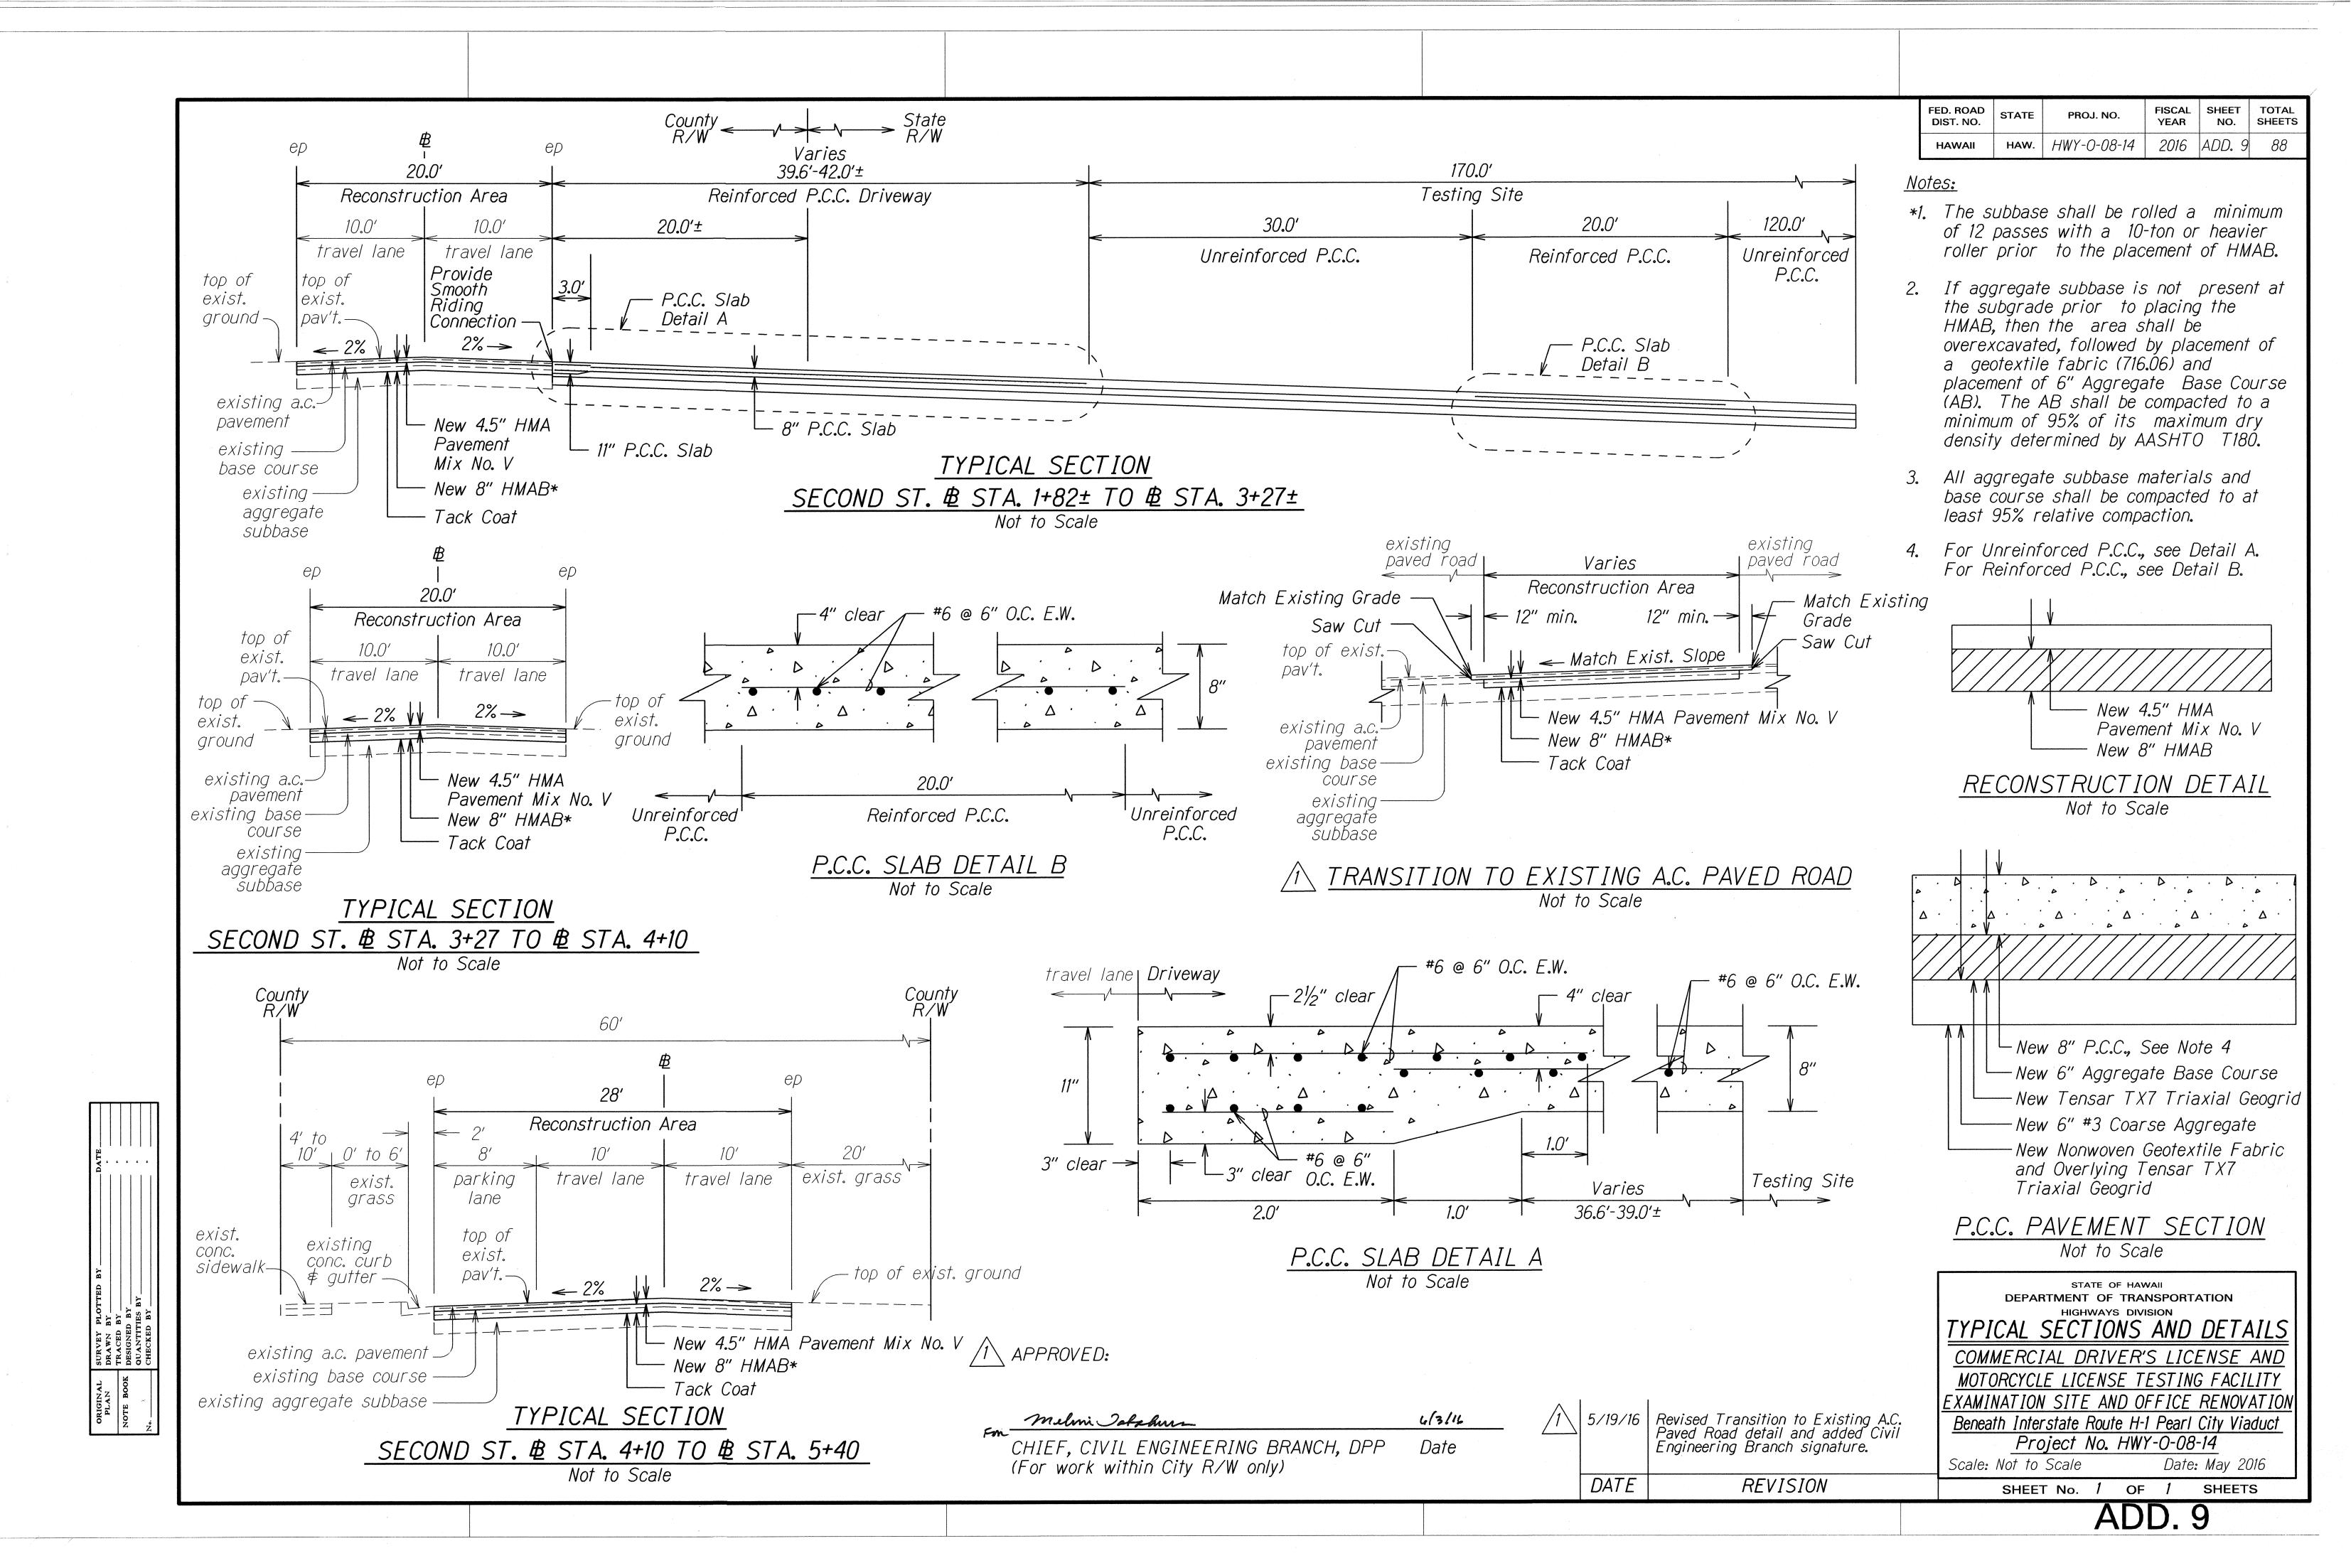


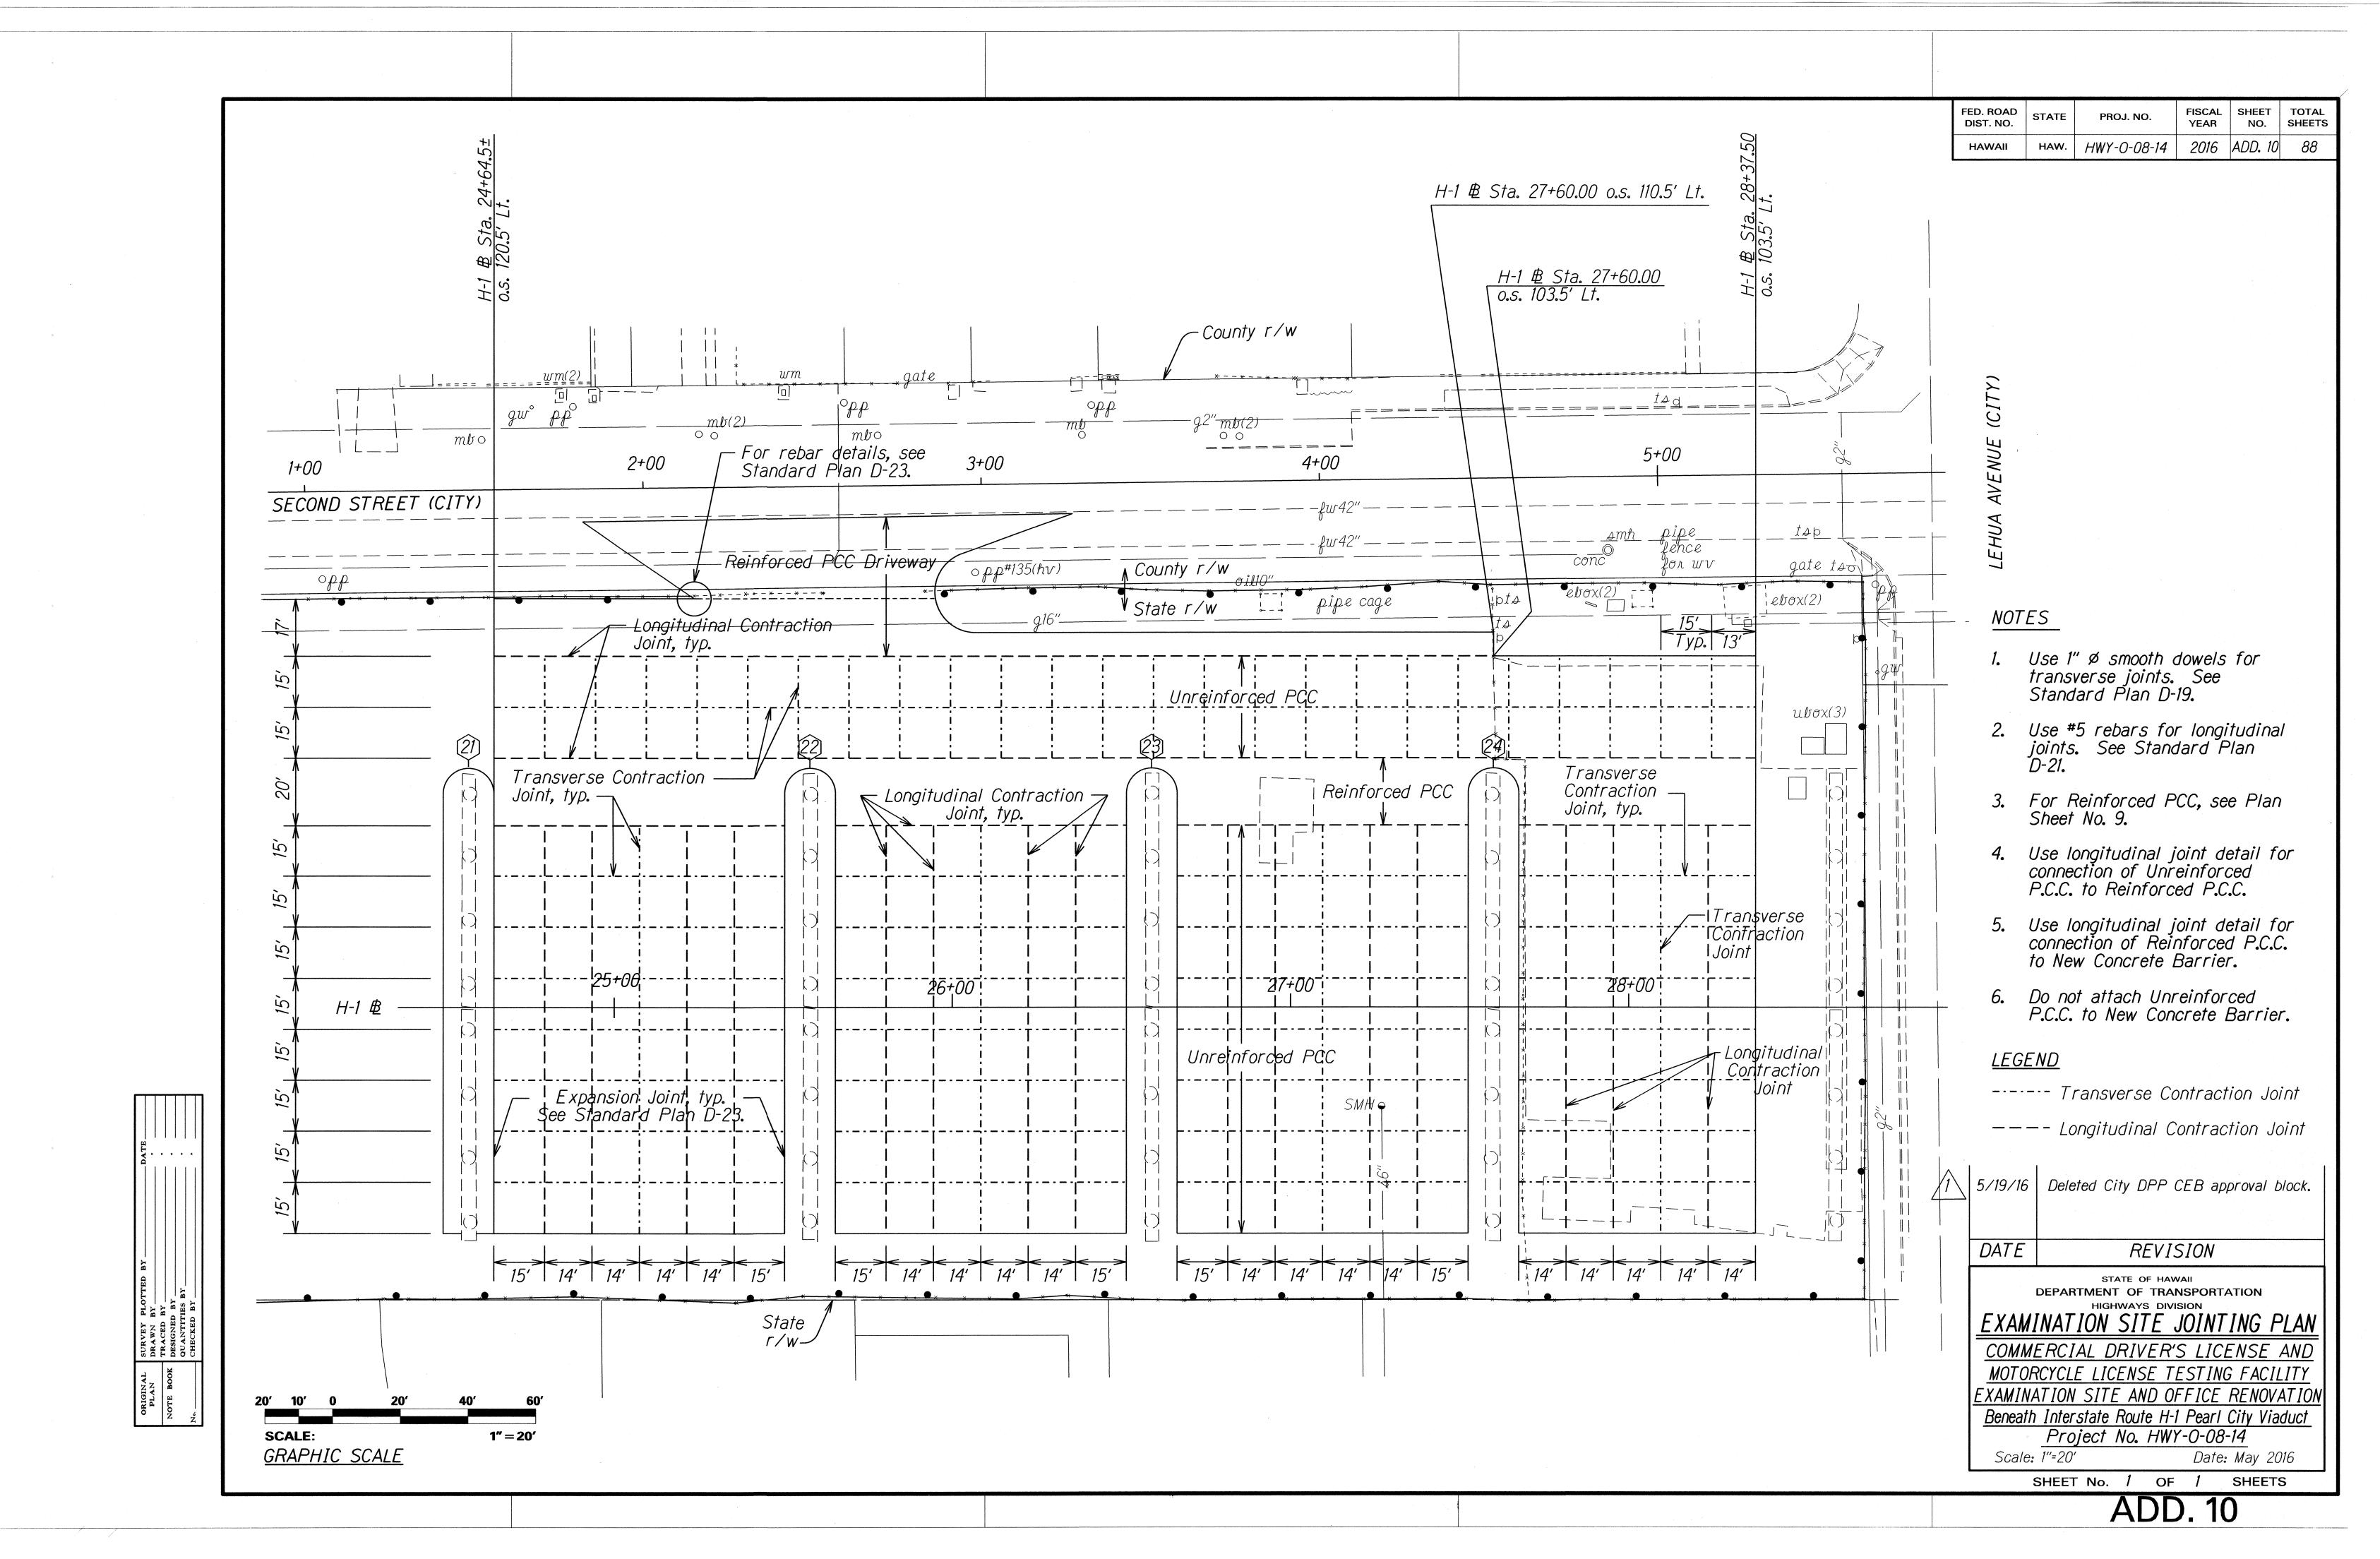


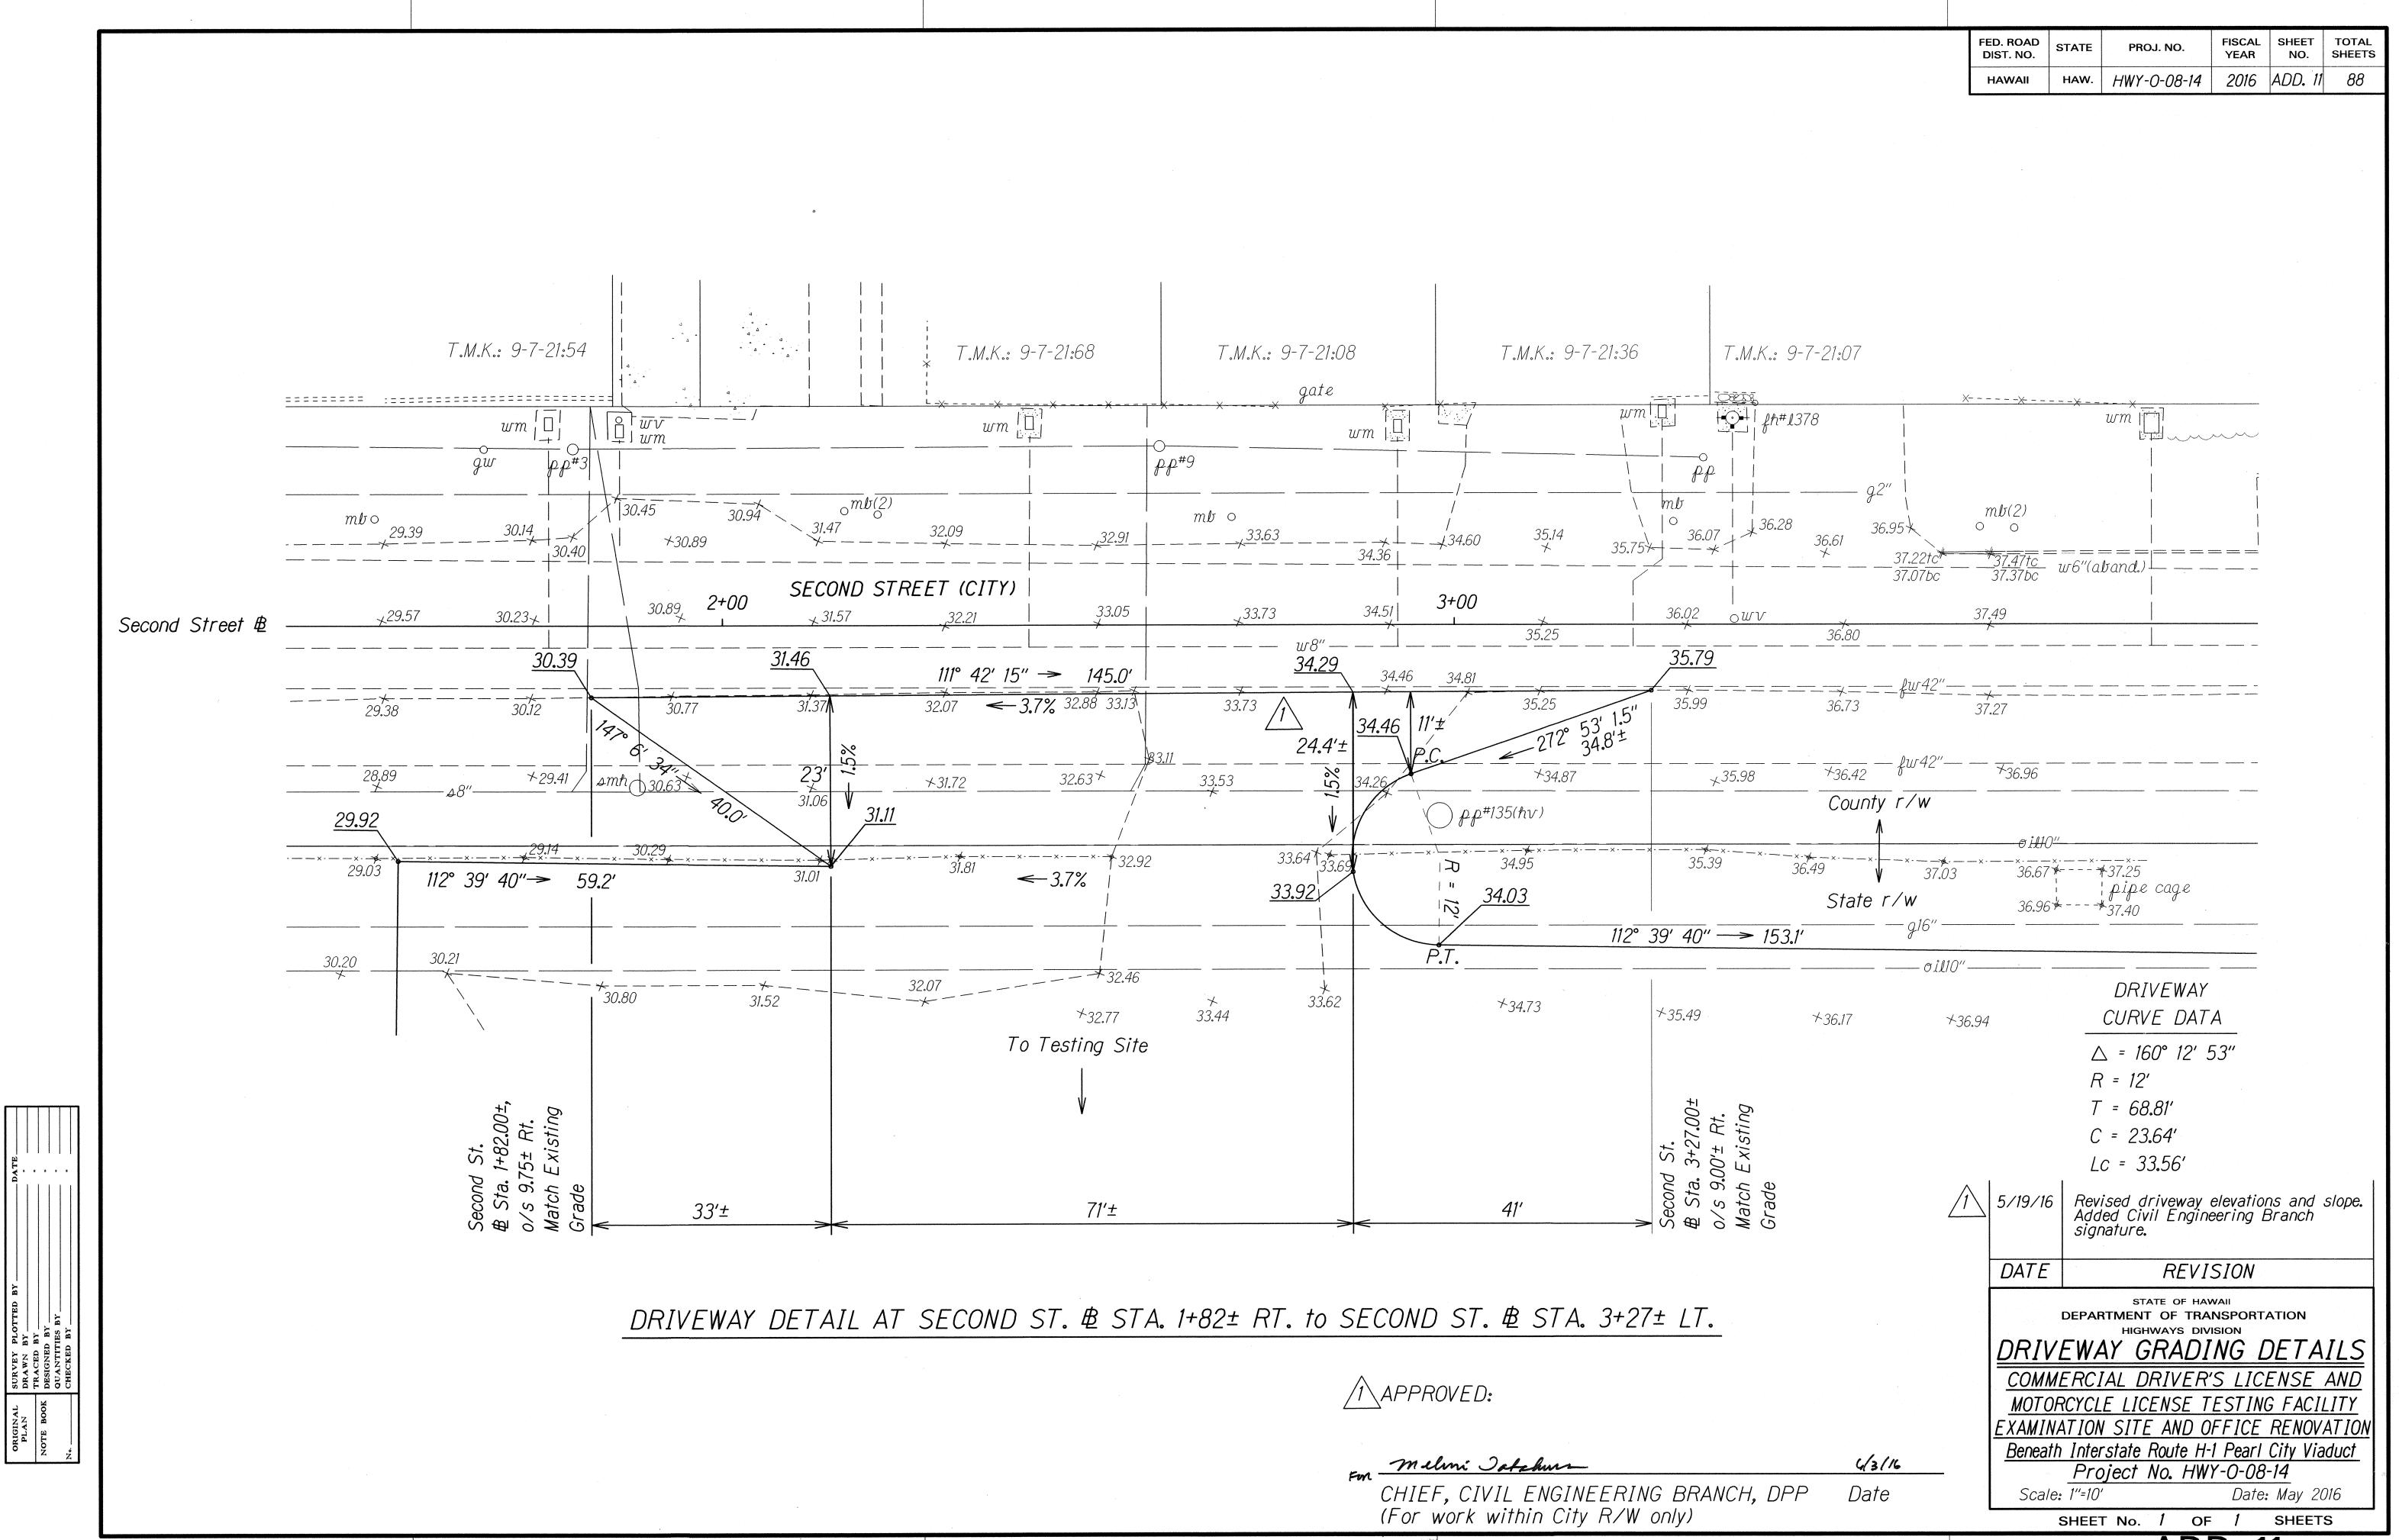

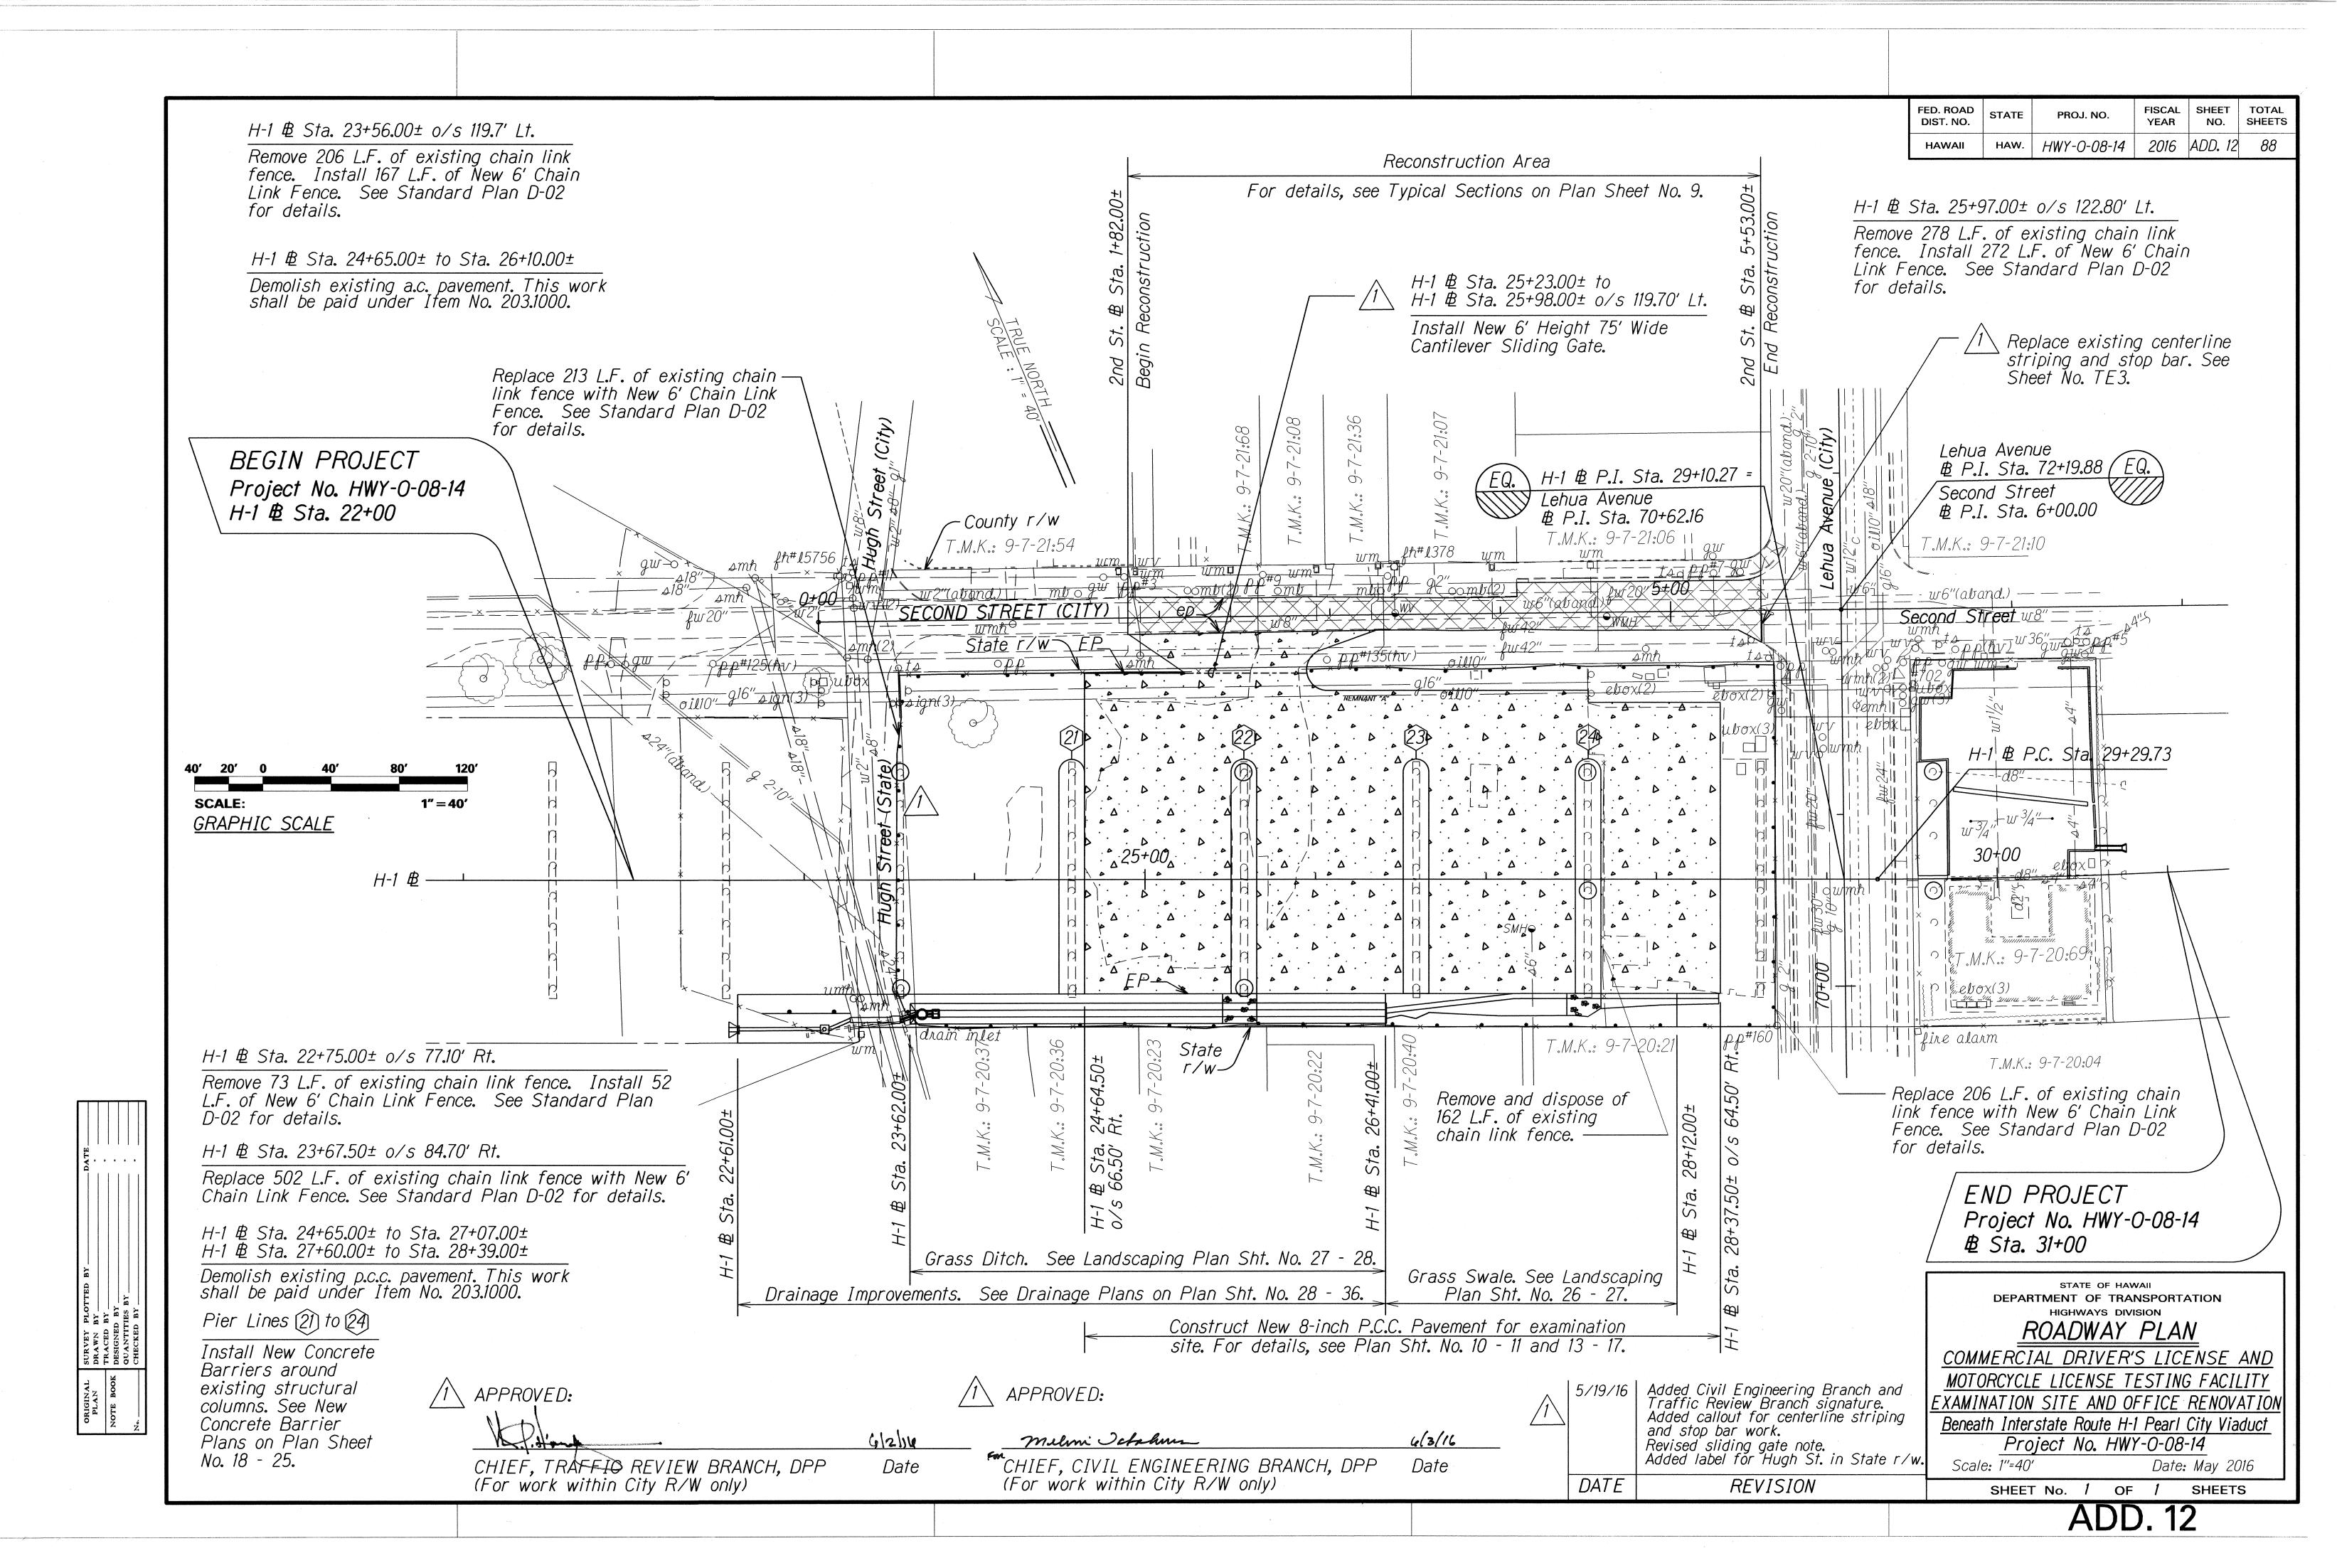


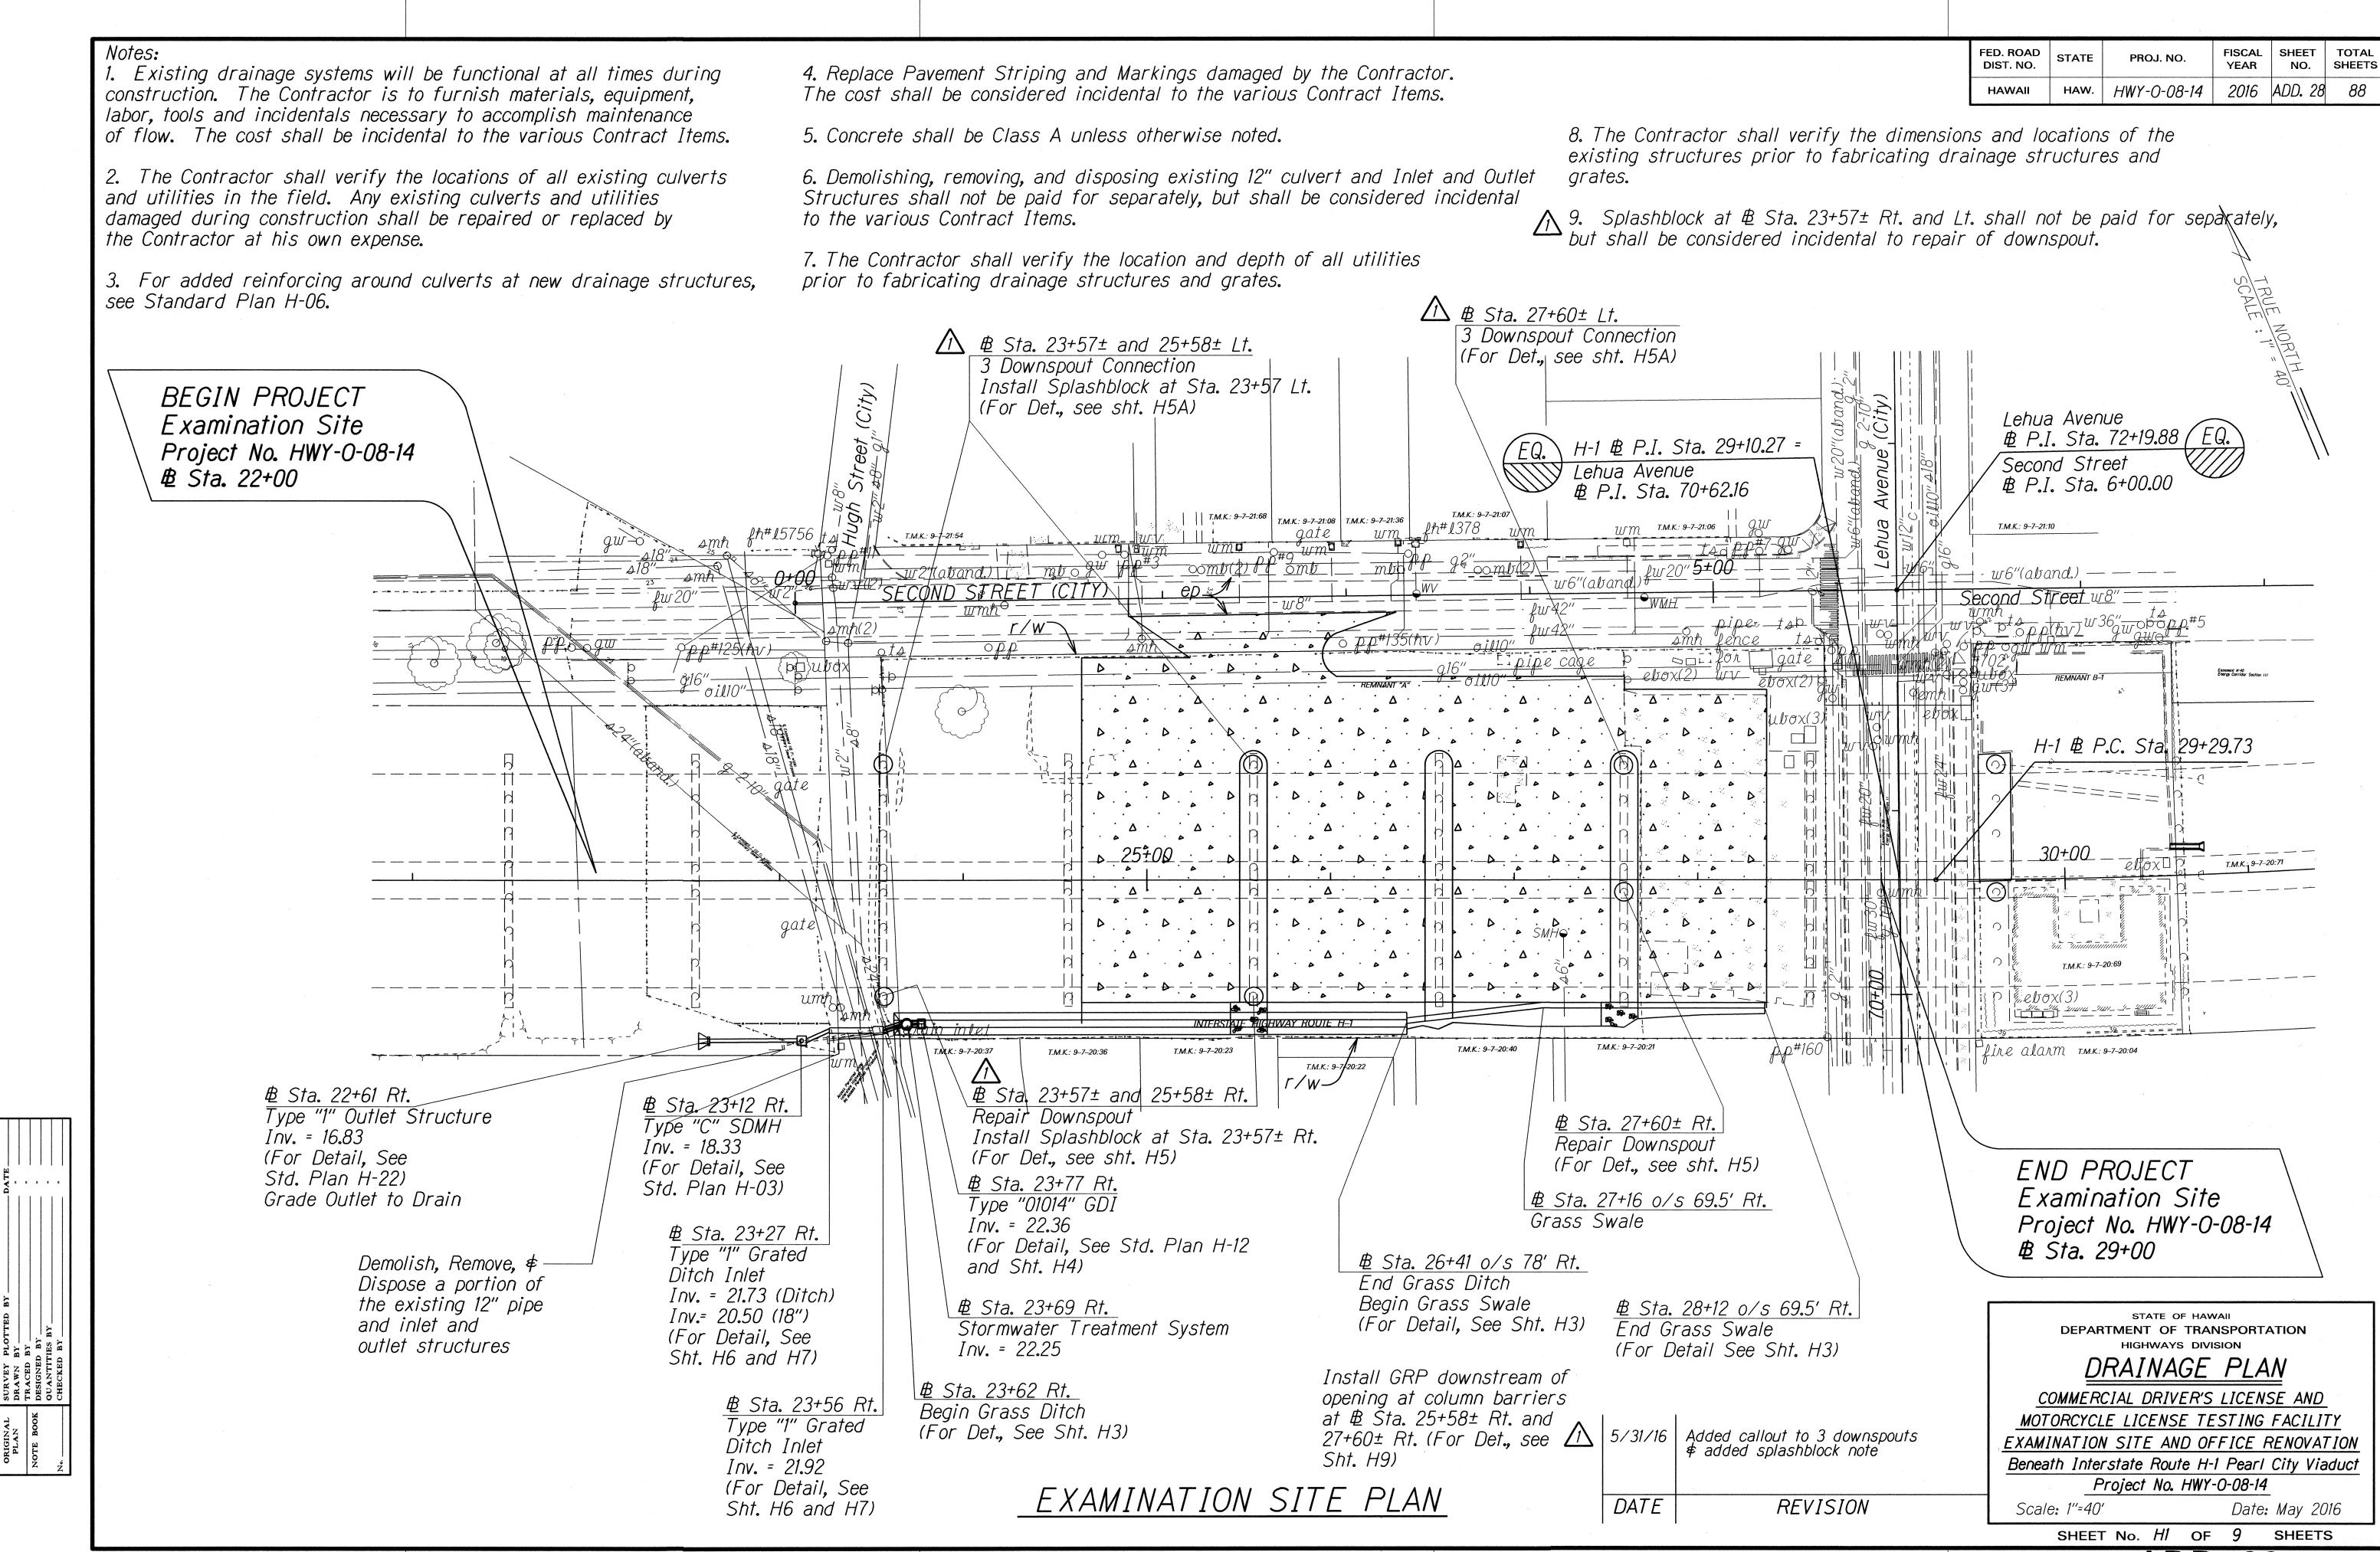


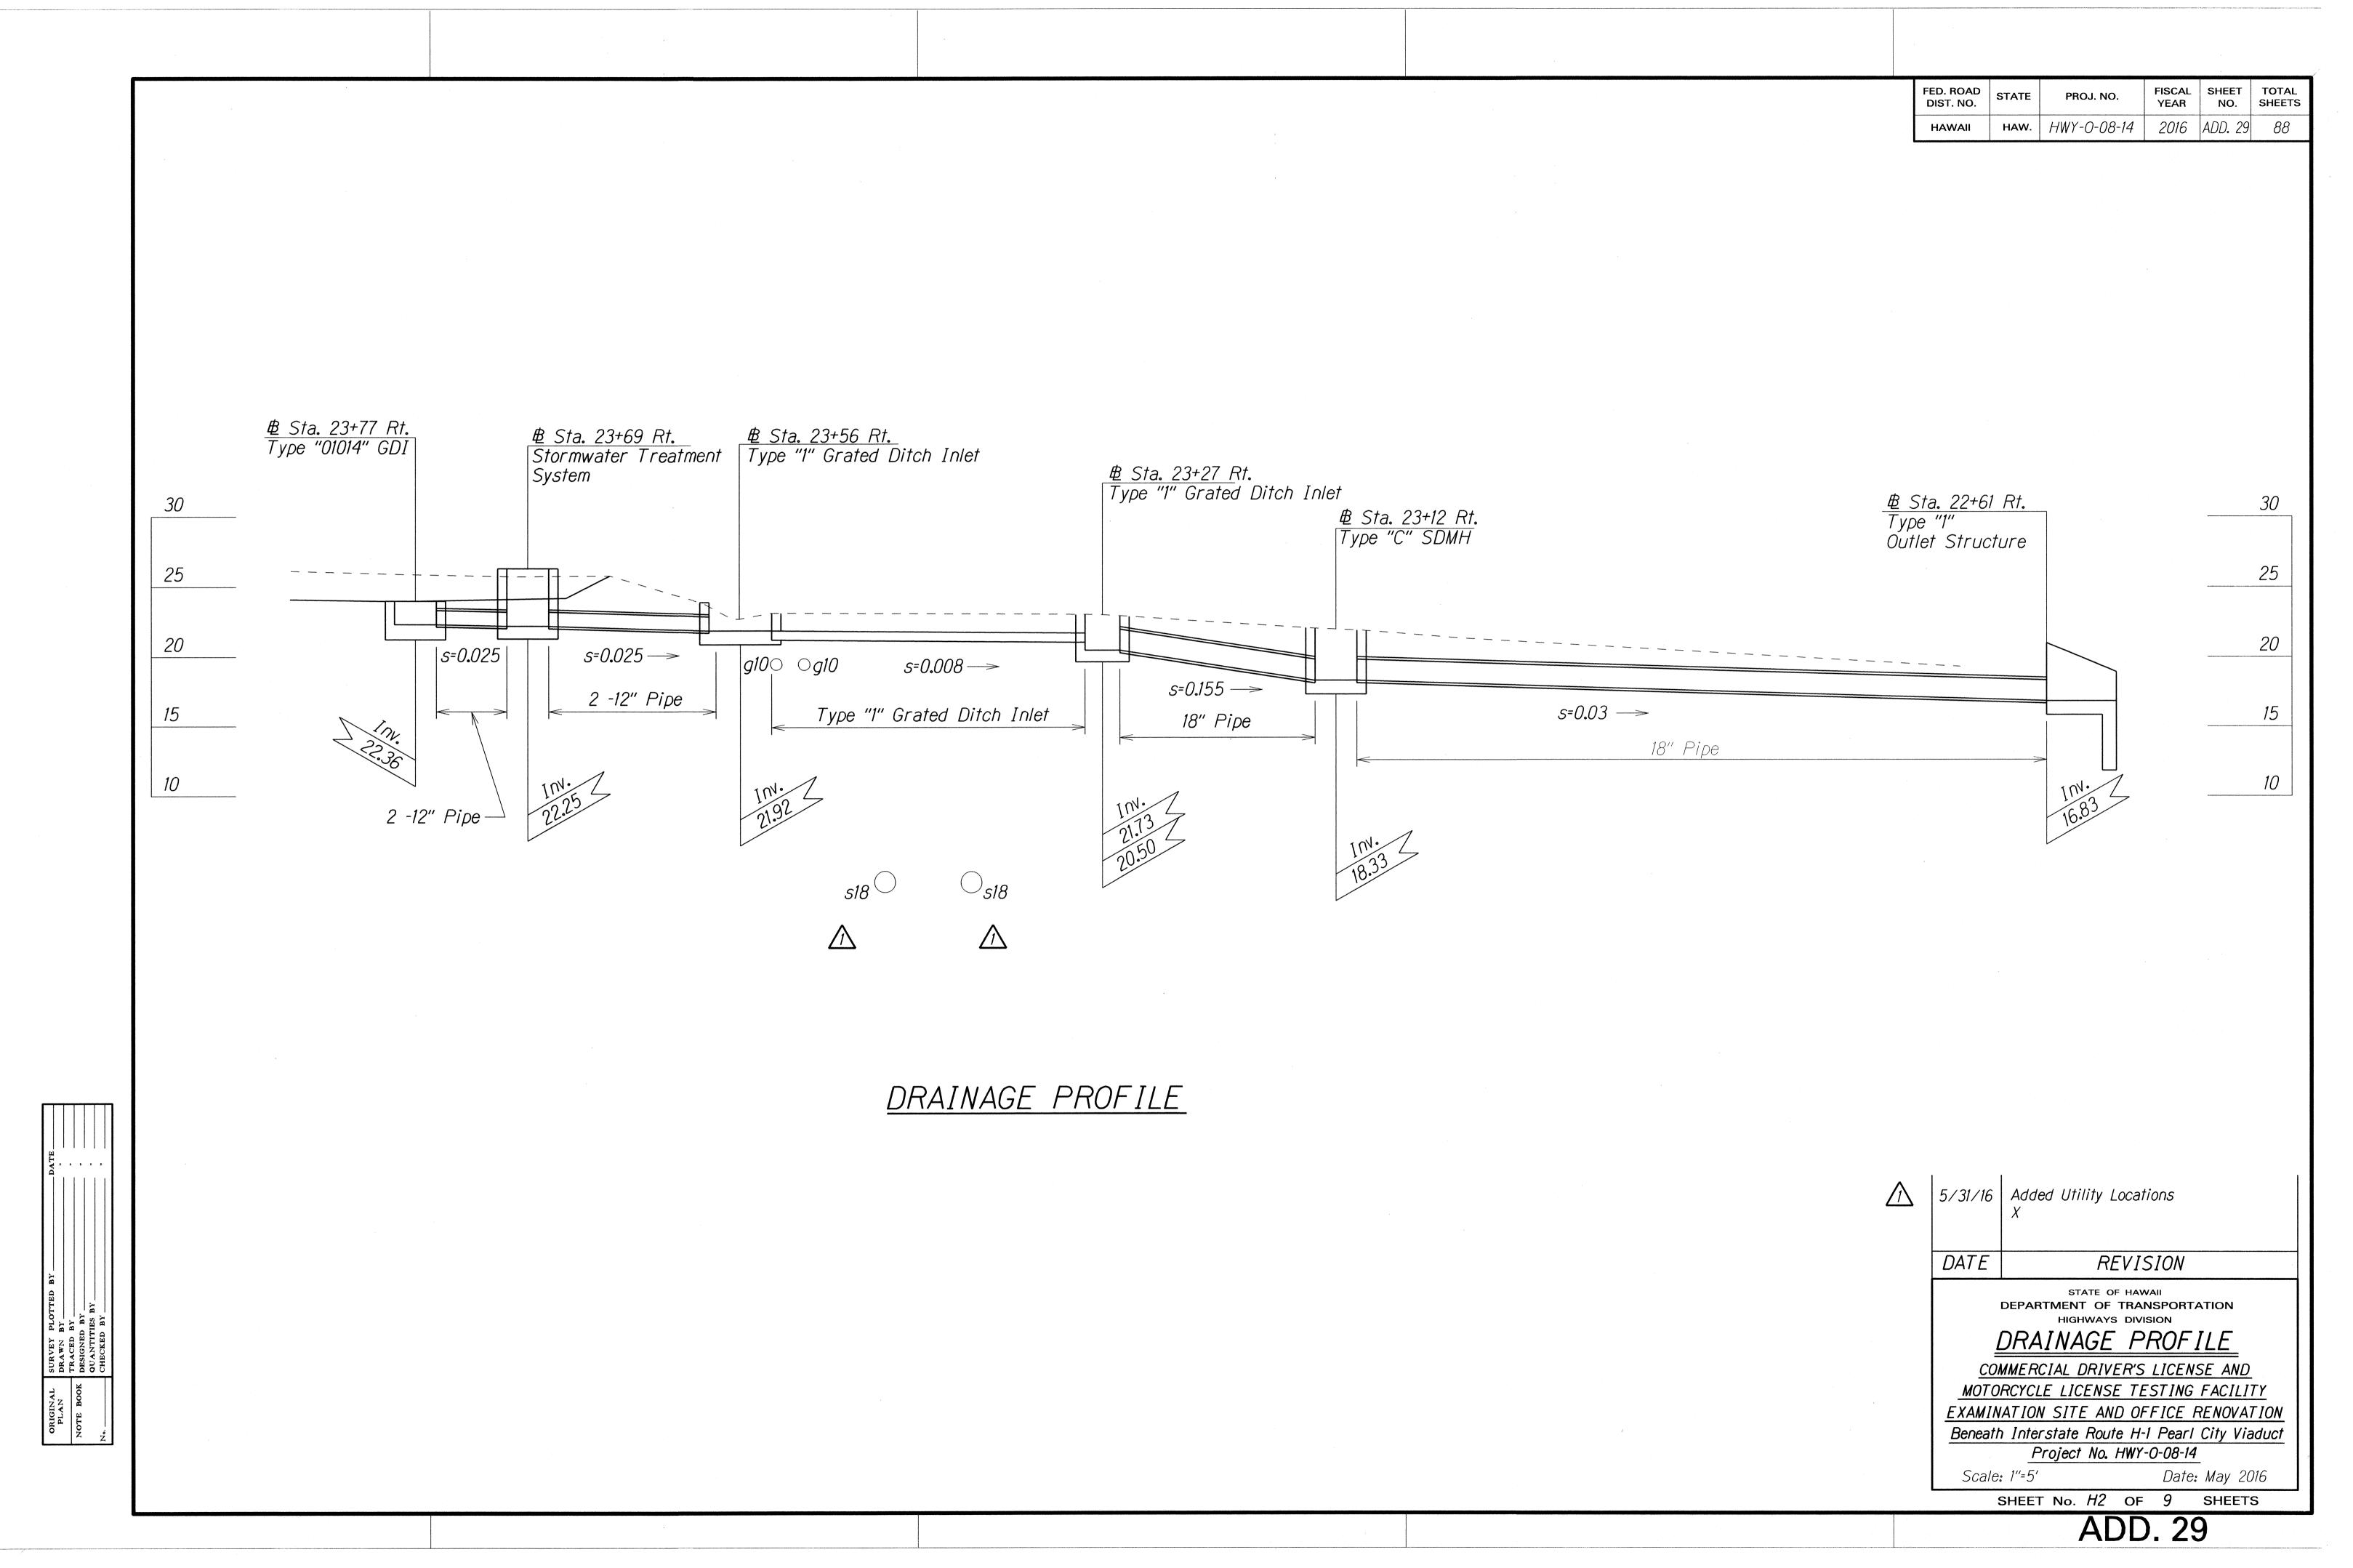

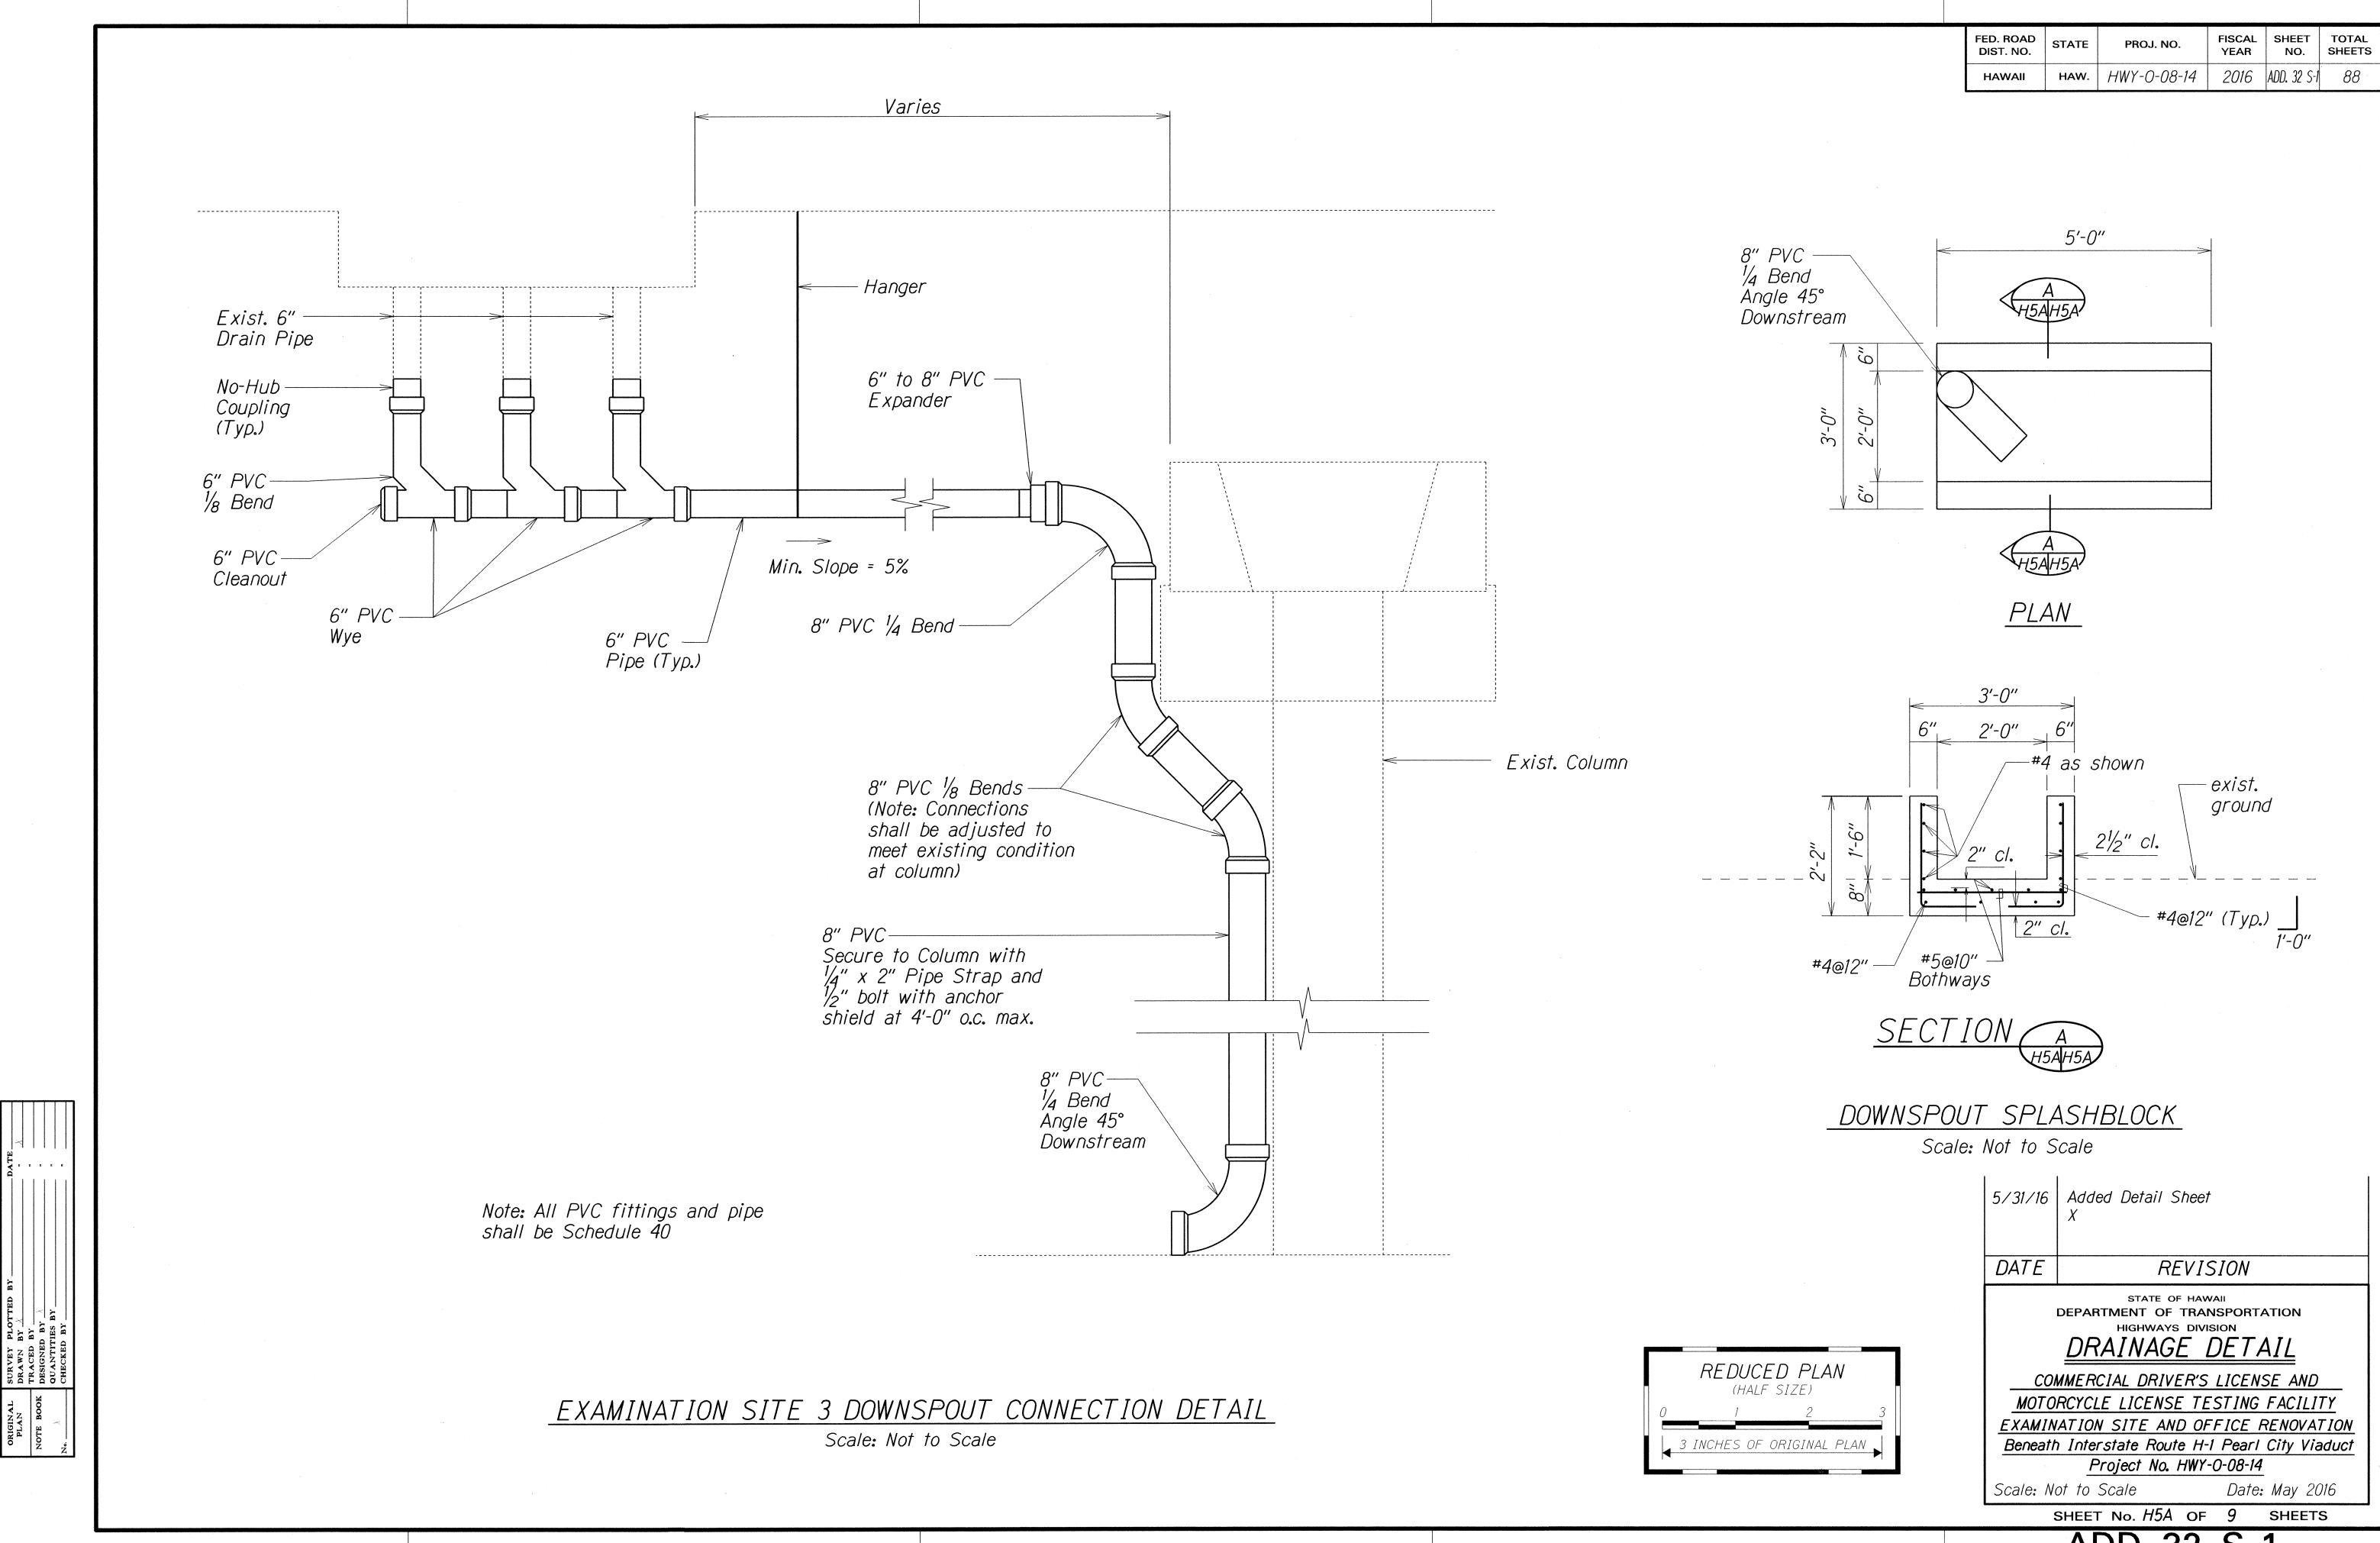


ADD. 32 S-1

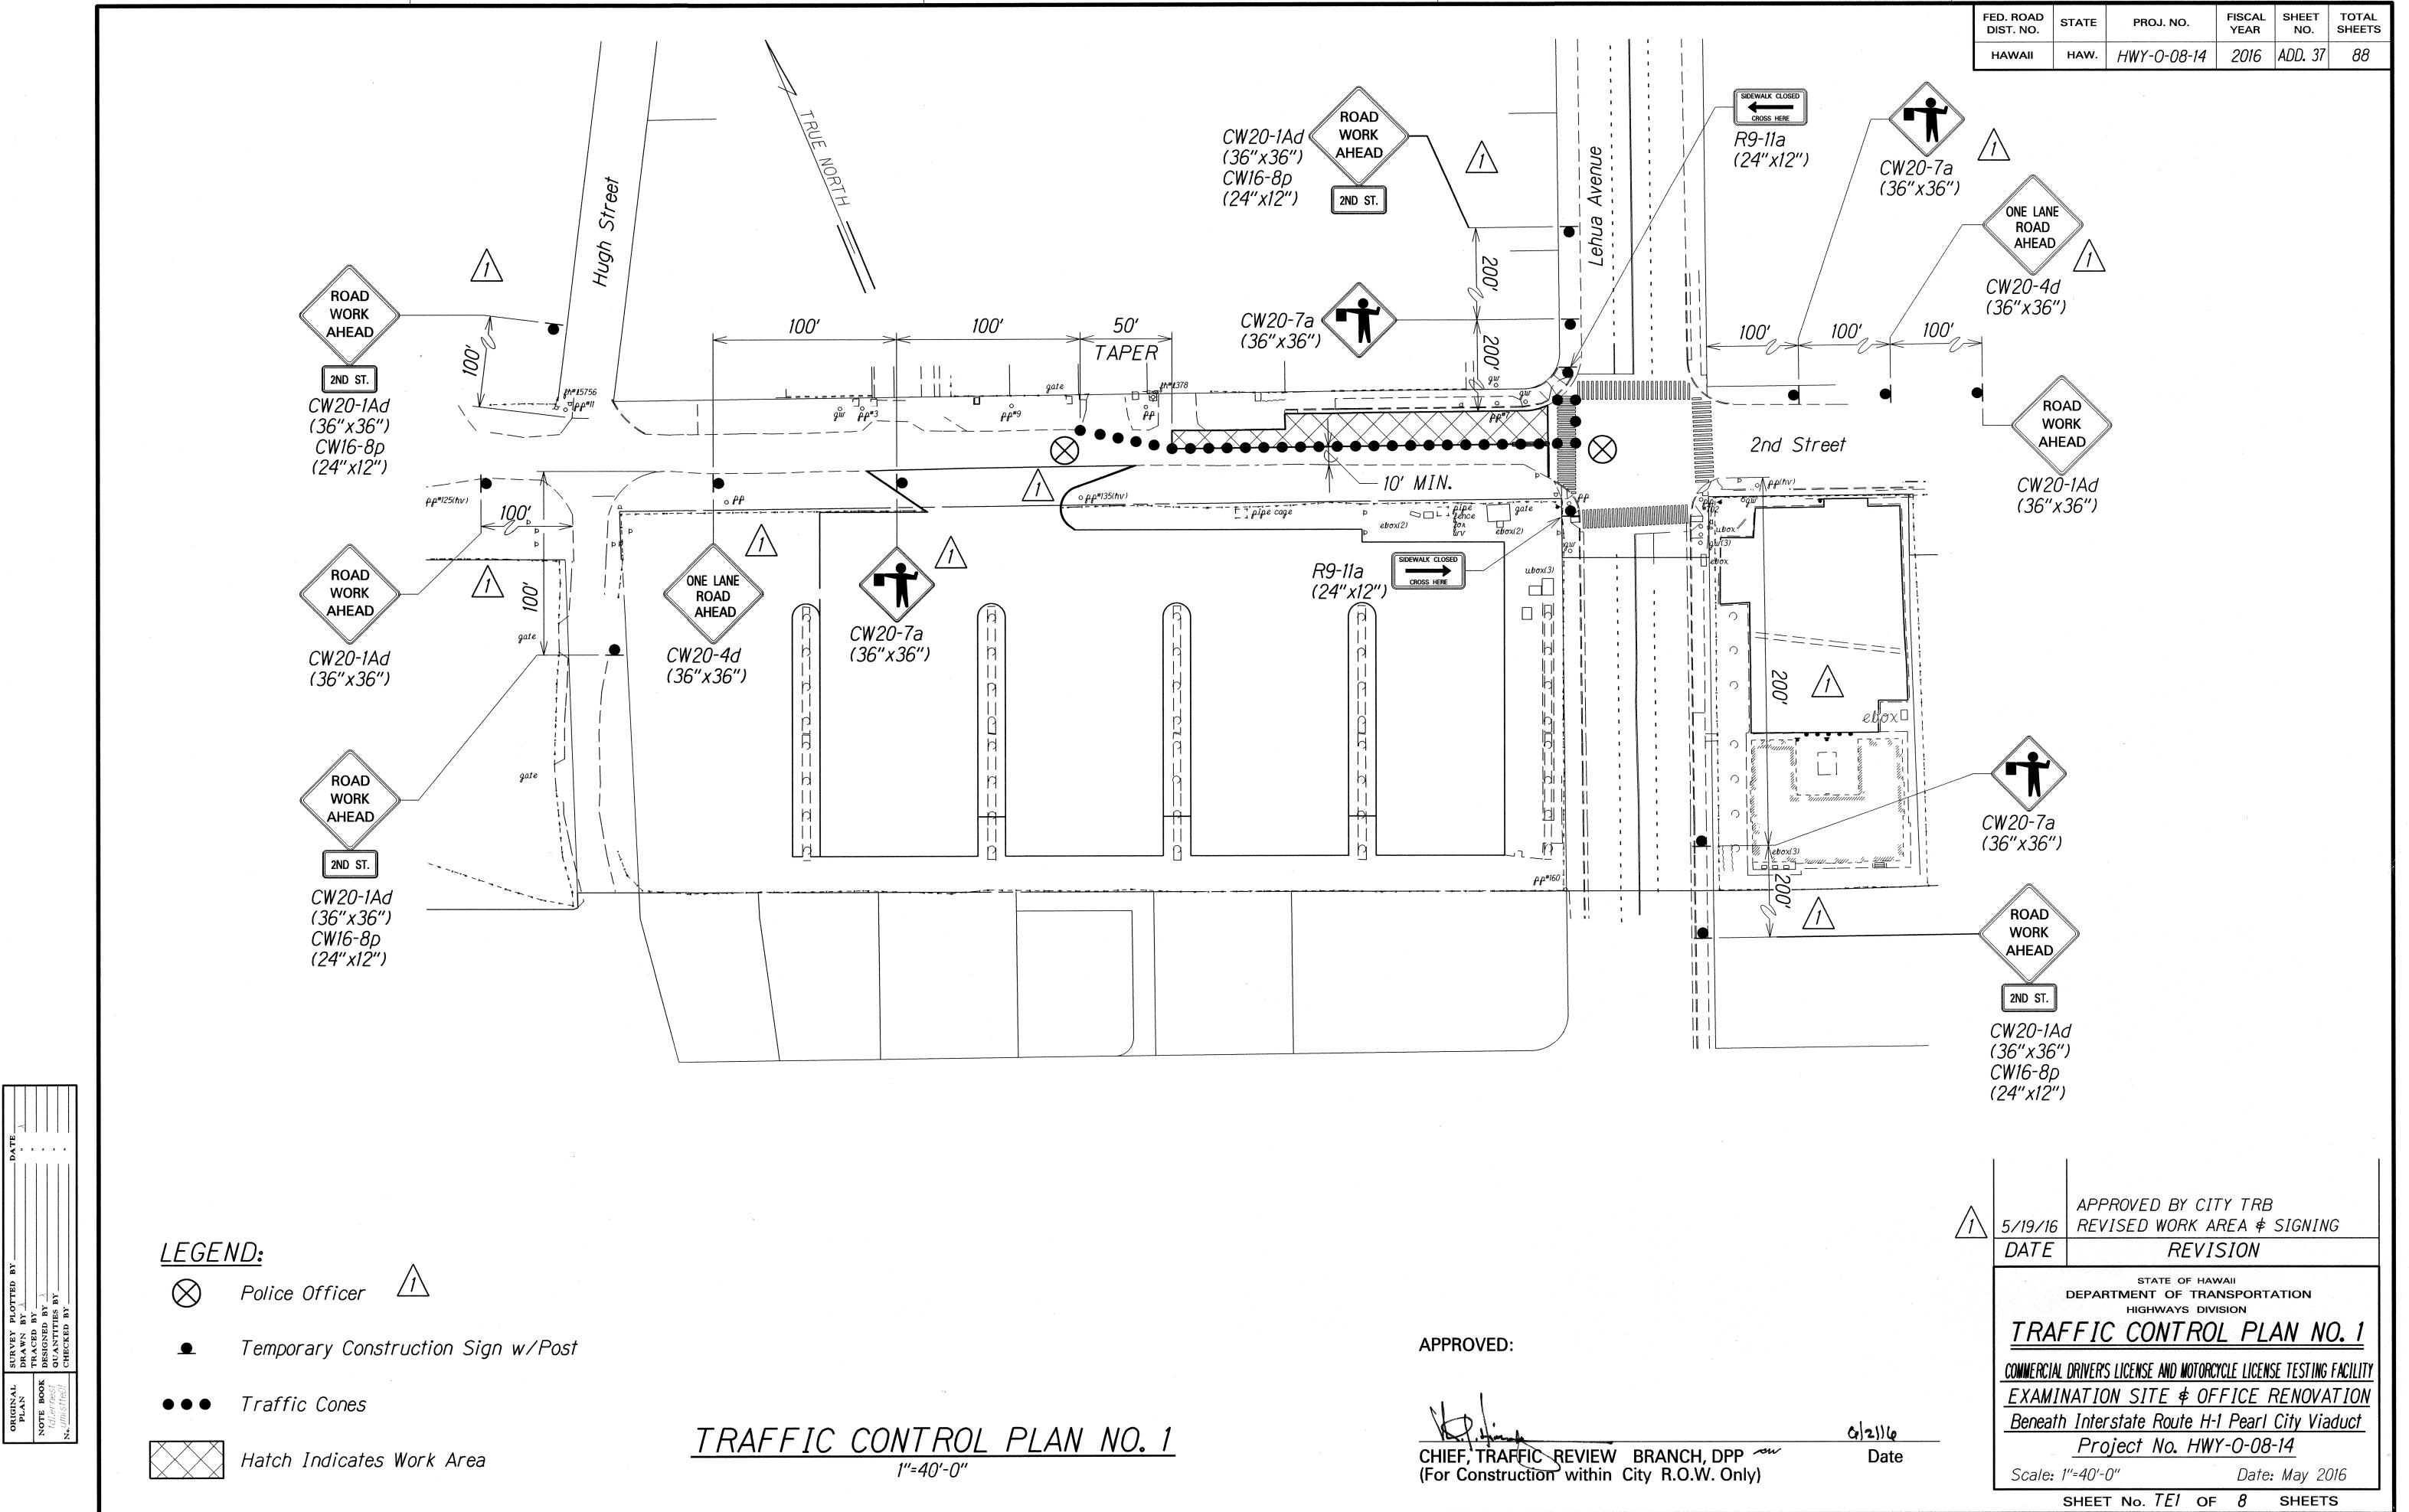


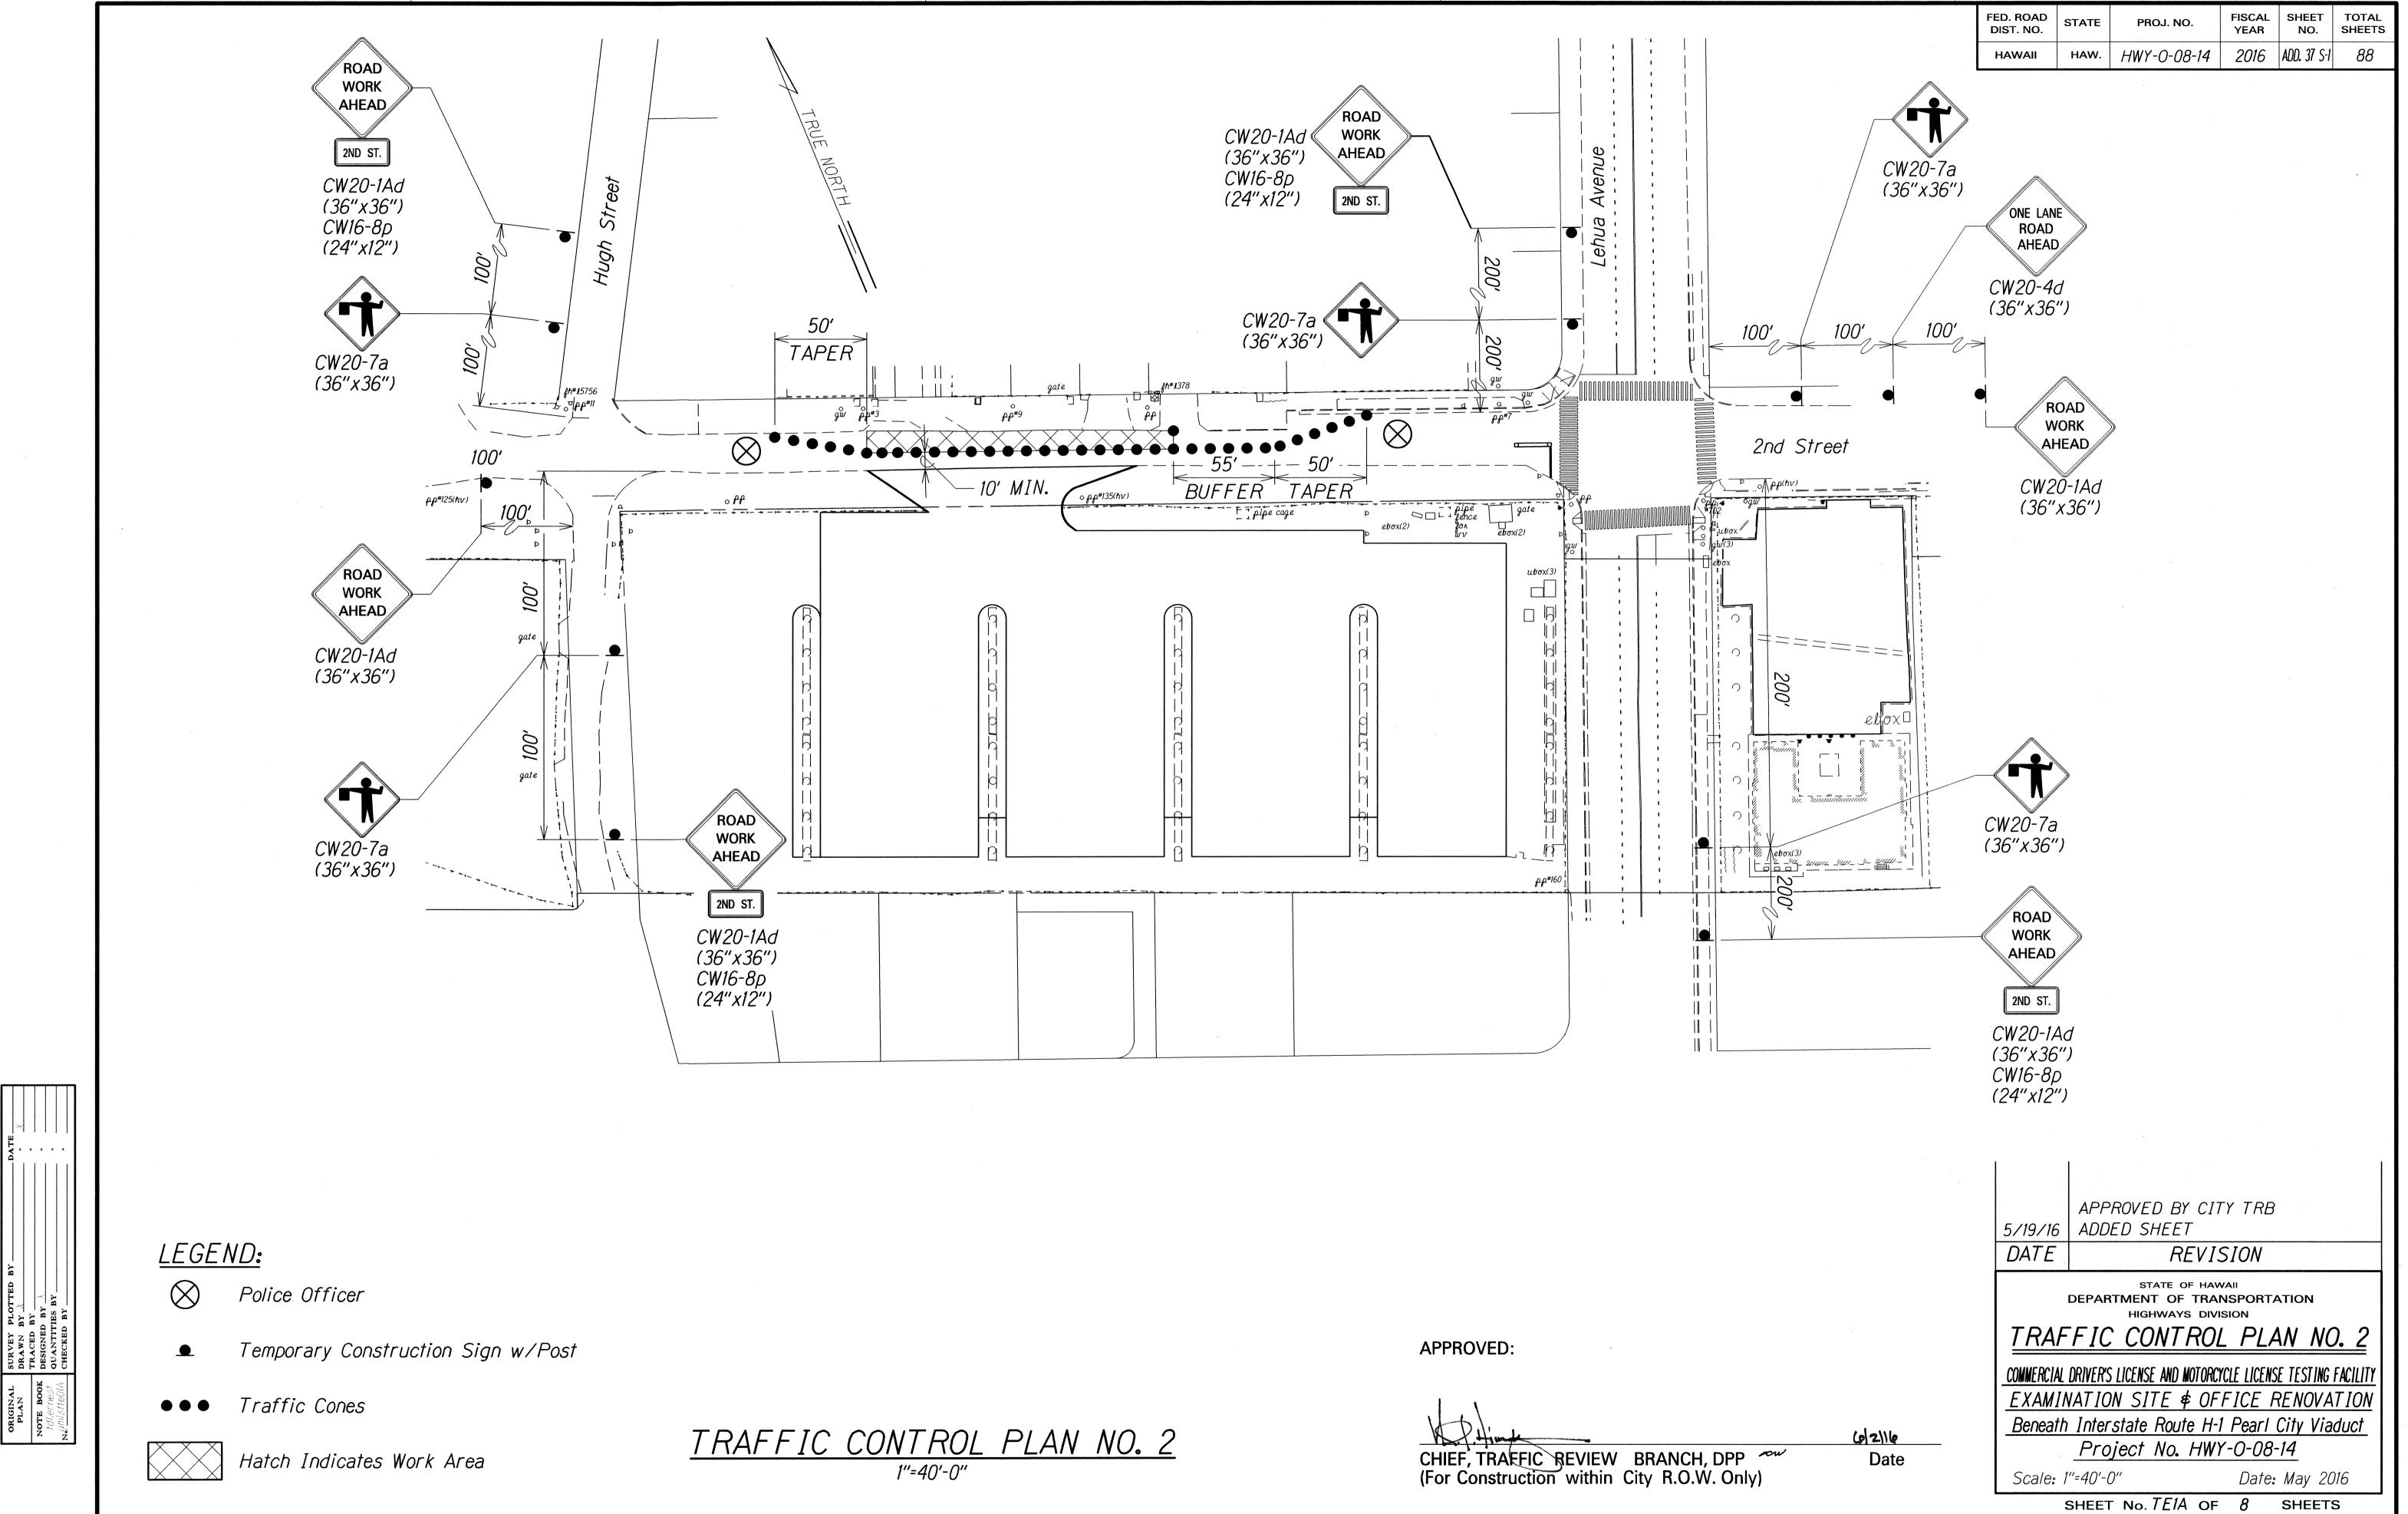

ADD. 37 S-1

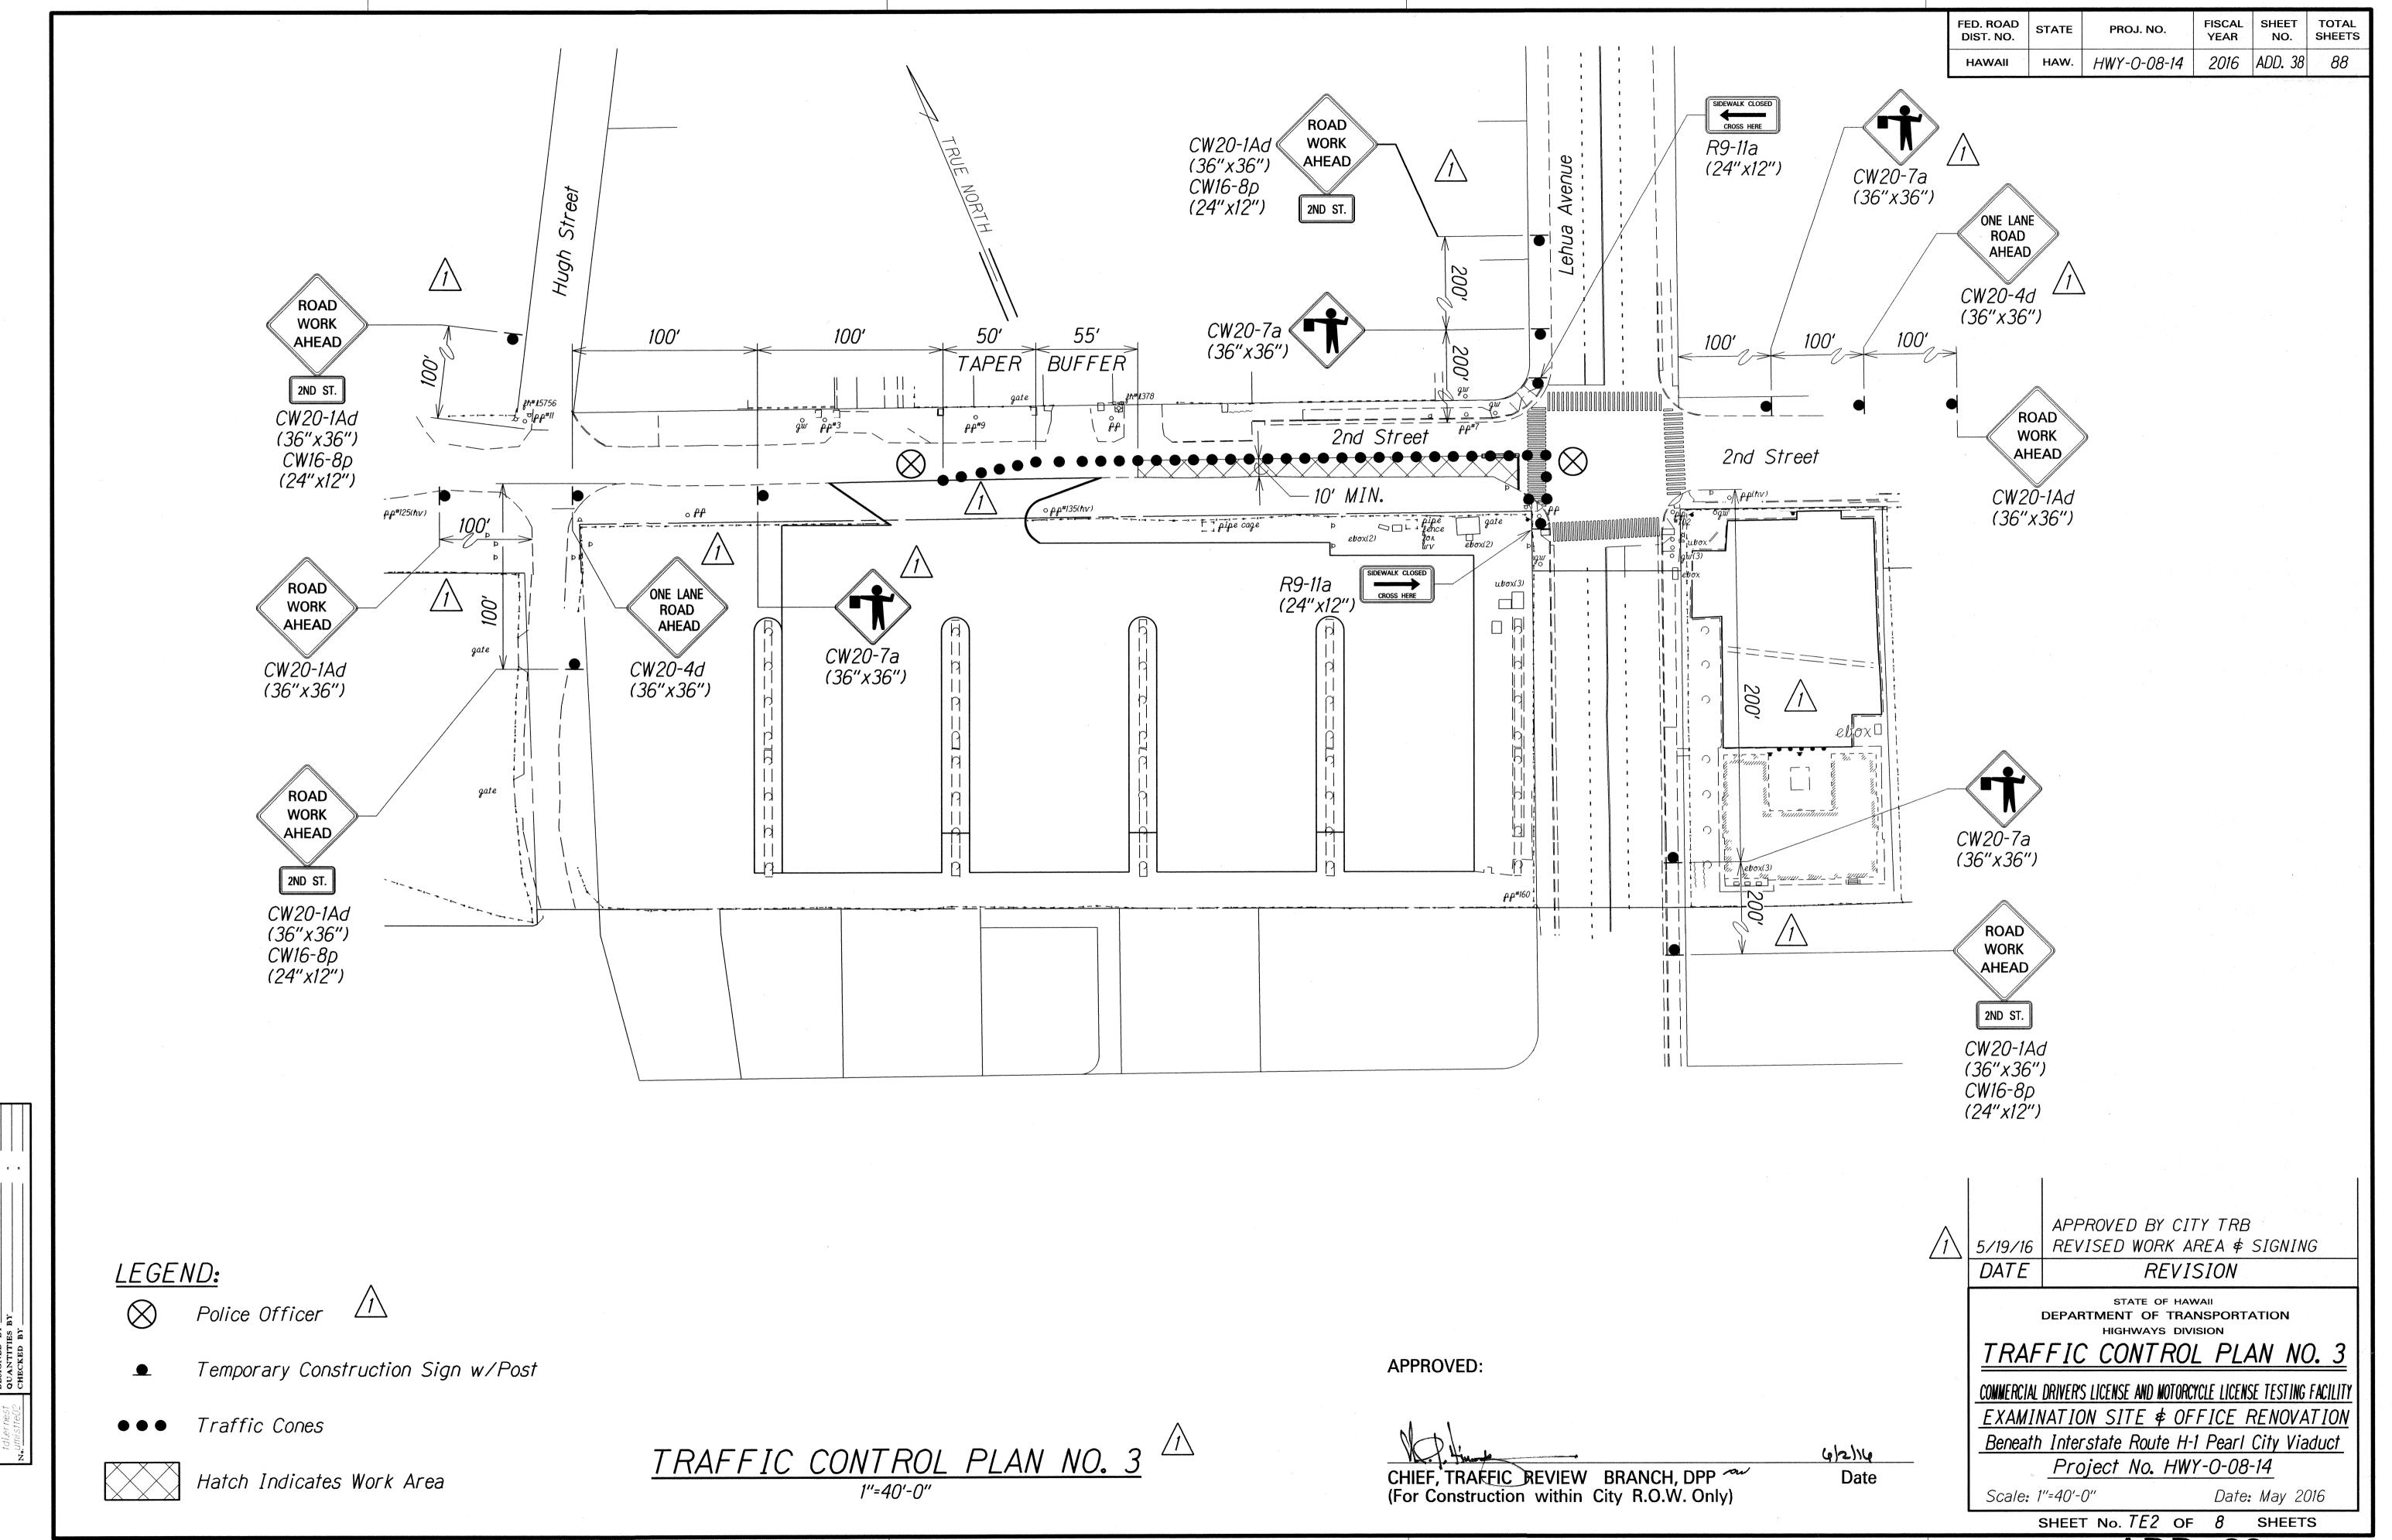

ADD 38

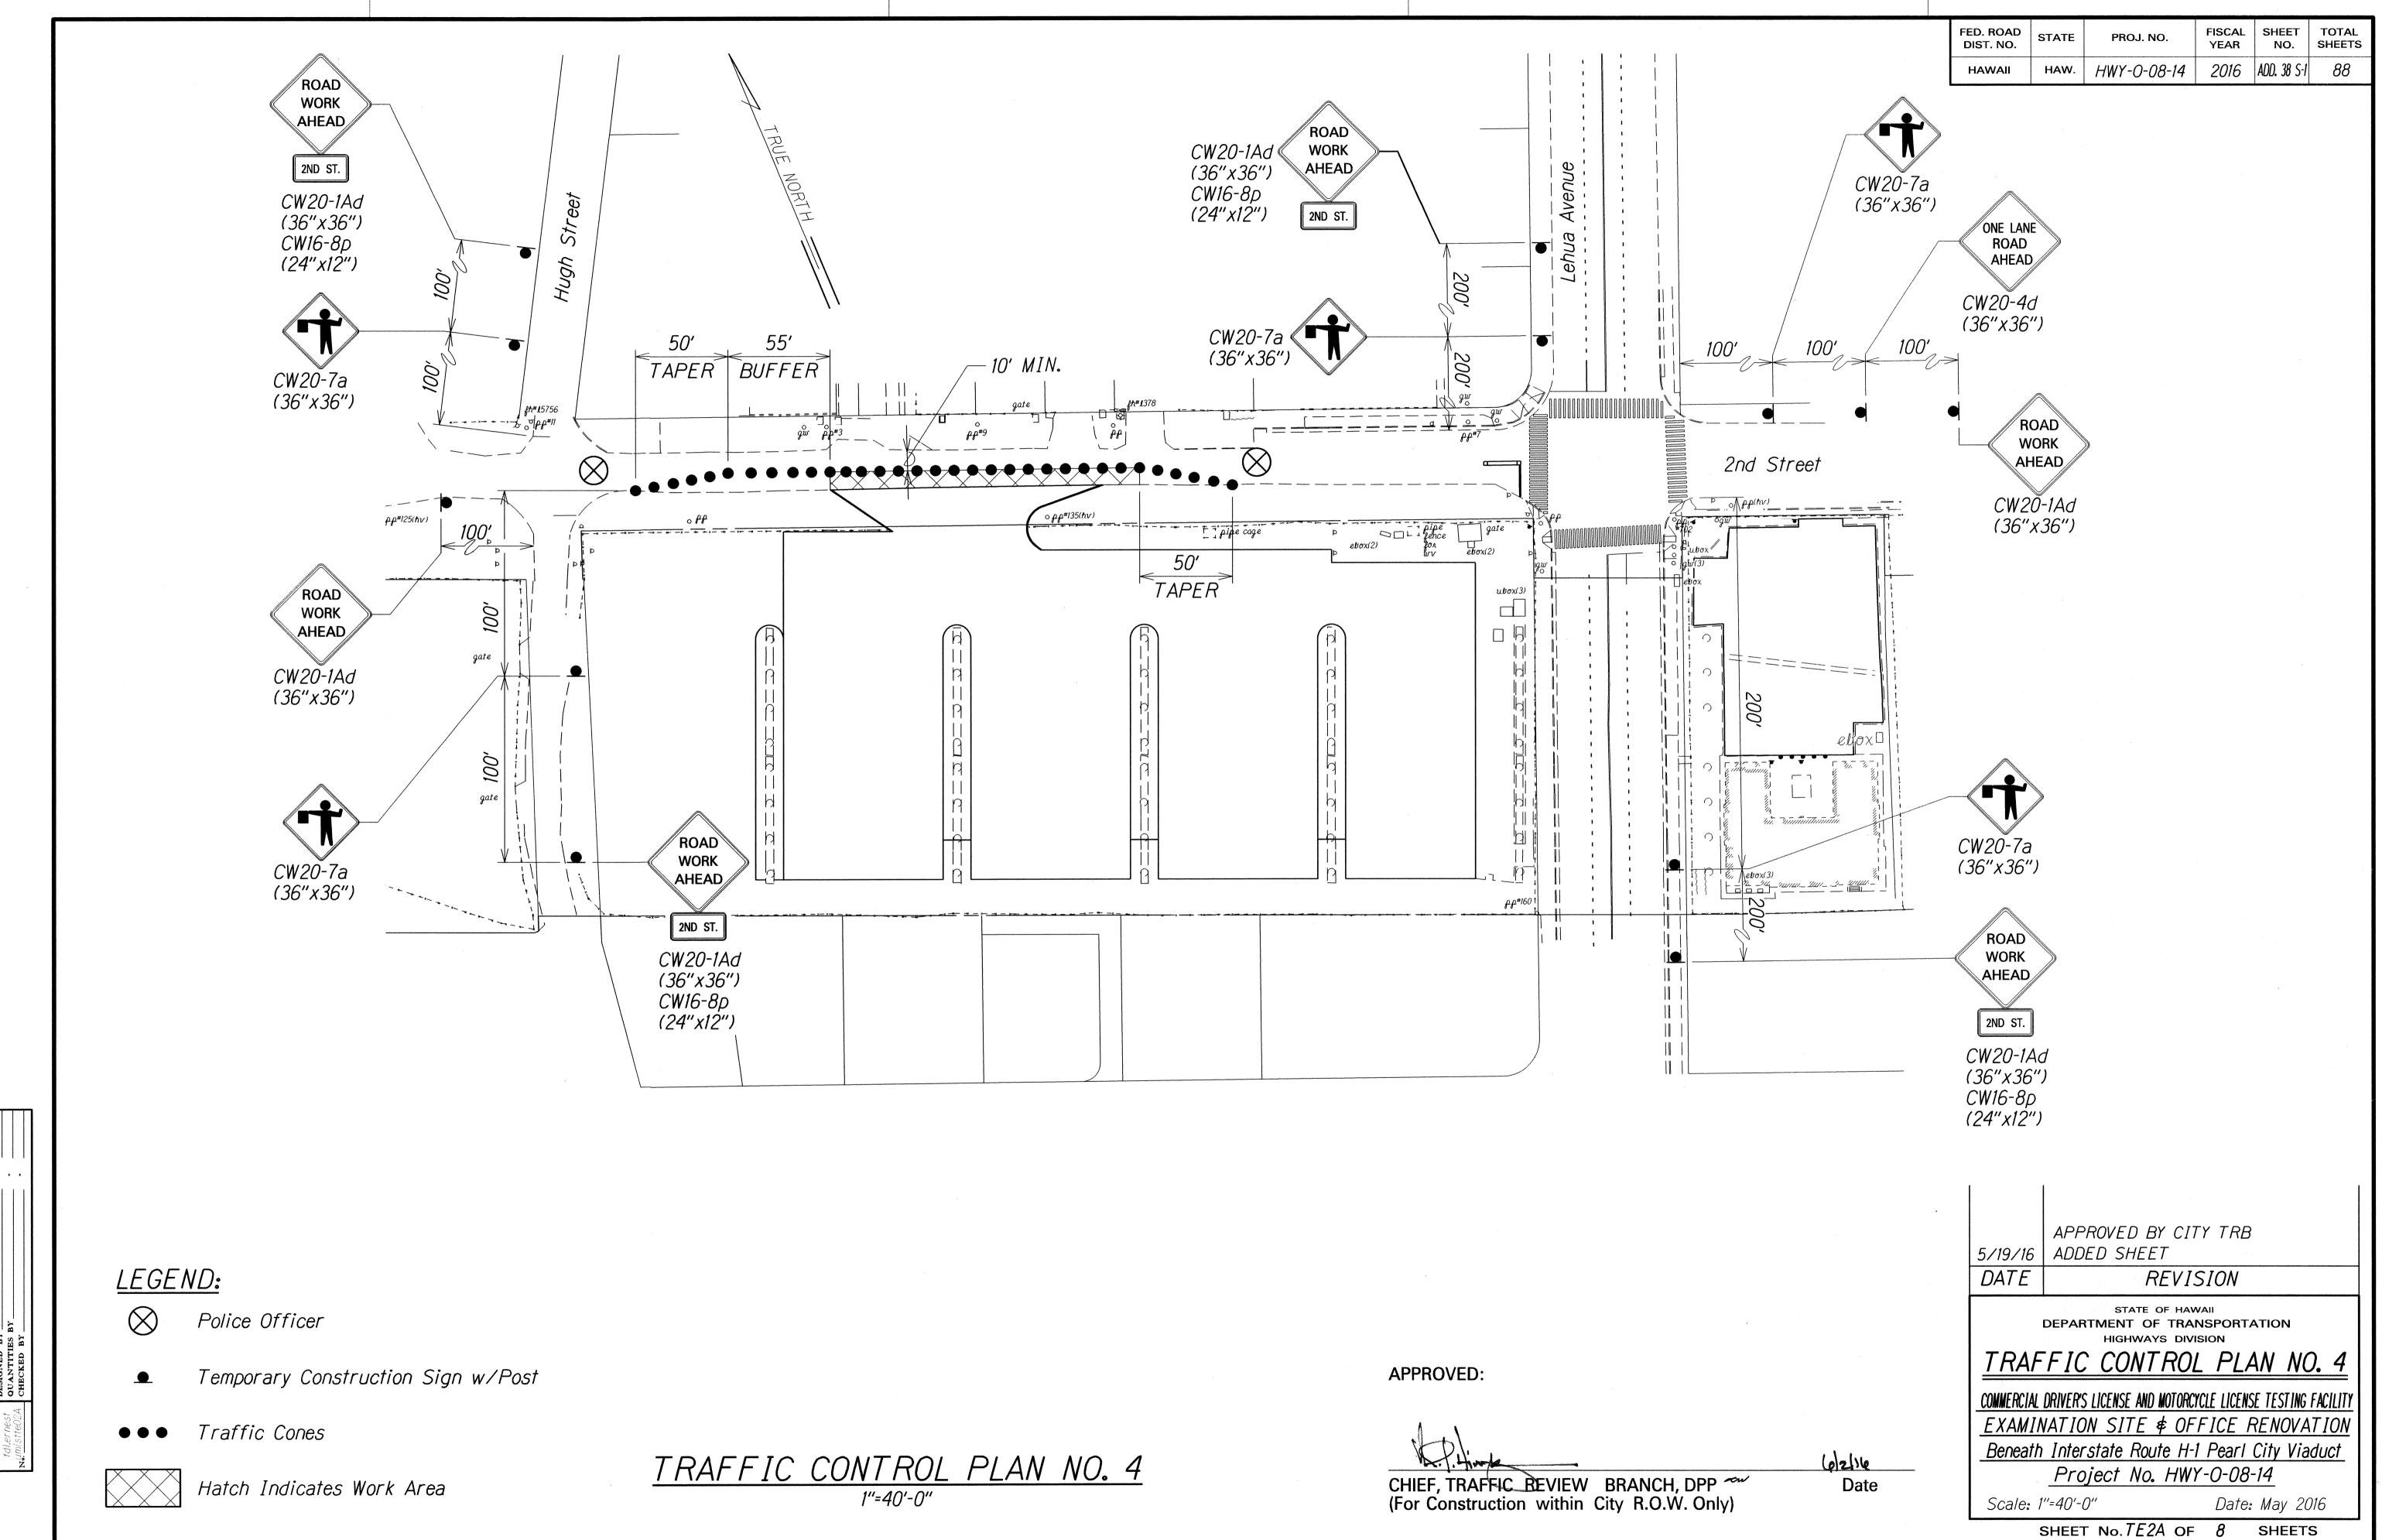

ADD. 38 S-1

FED. ROAD DIST. NO.	STATE	PROJ. NO.	FISCAL YEAR	SHEET NO.	TOTAL SHEETS
HAWAII	HAW.	HWY-0-08-14	2016	ADD. 38 S-2	88

TRAFFIC NOTES FOR WORK ON CITY & COUNTY STREETS

- 1. The permit shall be obtained from the Department of Transportation Services before work on any portion of a public street or highway may begin. Construction traffic control plans approved by the Department of Transportation Services and/or the Department of Planning and Permitting must be provided when applying for the permit.
- 2. The Contractor shall provide, install, and maintain all necessary signs and other protective facilities, which shall conform with the "Hawaii Administration Rules Governing Highways" adopted by the Director of Transportation, and the current U.S. Federal Highways Administration's "Manual on Uniform Traffic Control Devices for Street and Highways, Part VI Traffic Controls for Street and Highway Construction and Maintenance Operations."
- 3. Work on any city street area may be performed only between the hours of 8:30 A.M. to 3:30 P.M., Monday through Friday, unless otherwise permitted by the Department of Transportation Services.
- 4. During working hours, the Contractor shall provide for through traffic. During non-working hours, all trenches shall be covered with a safe non-skid bridging material and all lanes shall be open to traffic.
- 5. As required by the Department of Transportation Services, the Contractor shall provide off-duty police officers to control the flow of traffic.
- 6. Where pedestrian walkways exist, they shall be maintained in passable condition or other facilities for pedestrians shall be provided. Passage between walkways at intersections shall likewise be provided.
- 7. Driveways shall be kept open unless the owners of the property using these Rights-of-Way are otherwise provided for satisfactorily.
- 8. Contractor shall reference to the approval of the Department of Transportation Services and the Department of Planning and Permitting, all existing traffic signs, posts and pavement markings prior to the commencement of construction. The Contractor shall replace or repair all traffic signs, posts and pavement markings disturbed by his activities.
- 9. The Contractor shall notify the Department of Planning and Permitting at 768-8084 one (1) week prior to any work to be done on signs, posts and pavement markings.
- 10. No equipment shall be stored within street Rights-of-Way except at locations designated in writing and approved by the Department of Transportation Services.
- 11. HDOT shall ensure that the Contractor installs the construction traffic control devices in accordance with the MUTCD and the Hawaii Administration Rules as specified in traffic note #2.

SIGNS & MARKINGS NOTES

- 1. All traffic sign and pavement marking installations shall be done in accordance with "Manual on Uniform Traffic Control Devices for Streets and Highways," 2009 Edition, as amended, the latest specifications from the Traffic Review Branch, Department of Planning and Permitting, and as shown on the plans.
- 2. Contractor shall notify and coordinate work with the Civil Engineering Branch, Department of Planning and Permitting, one (1) week in advance of commencing work at 768-8084.
- 3. Contractor shall submit material brochures for all signs and paint materials to the Civil Engineering Branch, Department of Planning and Permitting.
- 4. The signing and/or striping contractor shall keep one (1) set of approved plans at the project site at all times during construction work.
- Contractor shall paint temporary guidelines and outline of arrows, legends and crosswalks with a two-inch (2") wide brushed line on the day the roadway is opened to traffic. These markings must be approved by the inspector from the Civil Engineering Branch, Department of Planning and Permitting.
- . Contractor shall notify the Civil Engineering Branch, Department of Planning and Permitting at 768-8084, three (3) days in advance of final inspection.
- Contractor shall meet with the inspector from the Civil Engineering Branch, Department of Planning and Permitting during the final inspection.
- 8. Within ten (10) days following notification of award of contract, the Contractor shall submit to the Department of Planning and Permitting (phone: 768-8084) for approval, a list of any signing and pavement marking material, which he proposes to install. The list shall be complete as to the name of manufacturer, catalog number, and shall be supplemented with material brochures.
- 9. Upon final inspection of the project, the Contractor shall submit a letter of certification for all traffic signing and pavement marking materials installed.
- 10. Sign shall be attached to brackets with $\frac{5}{16}$ " zinc plated steel bolts, buts and washers. Signs 48" wide or larger than 10 sq. ft. in area shall be mounted on two 2" galv. pipe posts. The sign shall be installed with at least one (1) foot clearance from the sign edge to the curb face.
- 11. All traffic signs shall be reflectorized.
- 2. Raised pavement markers shall be installed in accordance with the Department of Planning and Permitting standards.

SIGNS \$ MARKINGS NOTES (Cont.)

- 13. Location of "STOP" sign:
 - A. Install "STOP" sign at curb tangent point.
 - B. Install "STOP" sign on metal street light standard if a standard is located within 10 feet of curb return.
 - C. Install "STOP" sign in front of utility pole if pole is located within 10 feet of curb return.
- 14. Pavement work and symbol markings shall be in accordance with the Department of Planning and Permitting standards.
- The Contractor shall use thermoplastic material, approved by the Civil Engineering Branch, Department of Planning and Permitting, for all crosswalks, stop cars, pavement arrows, center lines, lane lines, arc lines, channelized traffic islands and legends.

CHIEF, TRAFFIC BEVIEW BRANCH, DPP (For Construction within City R.O.W. Only)

(s/2/1/e Date C&C TRAFFIC & SIGN/MARKING NOTES

COMMERCIAL DRIVER'S LICENSE AND MOTORCYCLE LICENSE TESTING FACILITY

EXAMINATION SITE & OFFICE RENOVATION

Beneath Interstate Route H-1 Pearl City Viaduct

5/19/16 | ADDED SHEET

DATE

Project No. HWY-0-08-14


REVISION

STATE OF HAWAII


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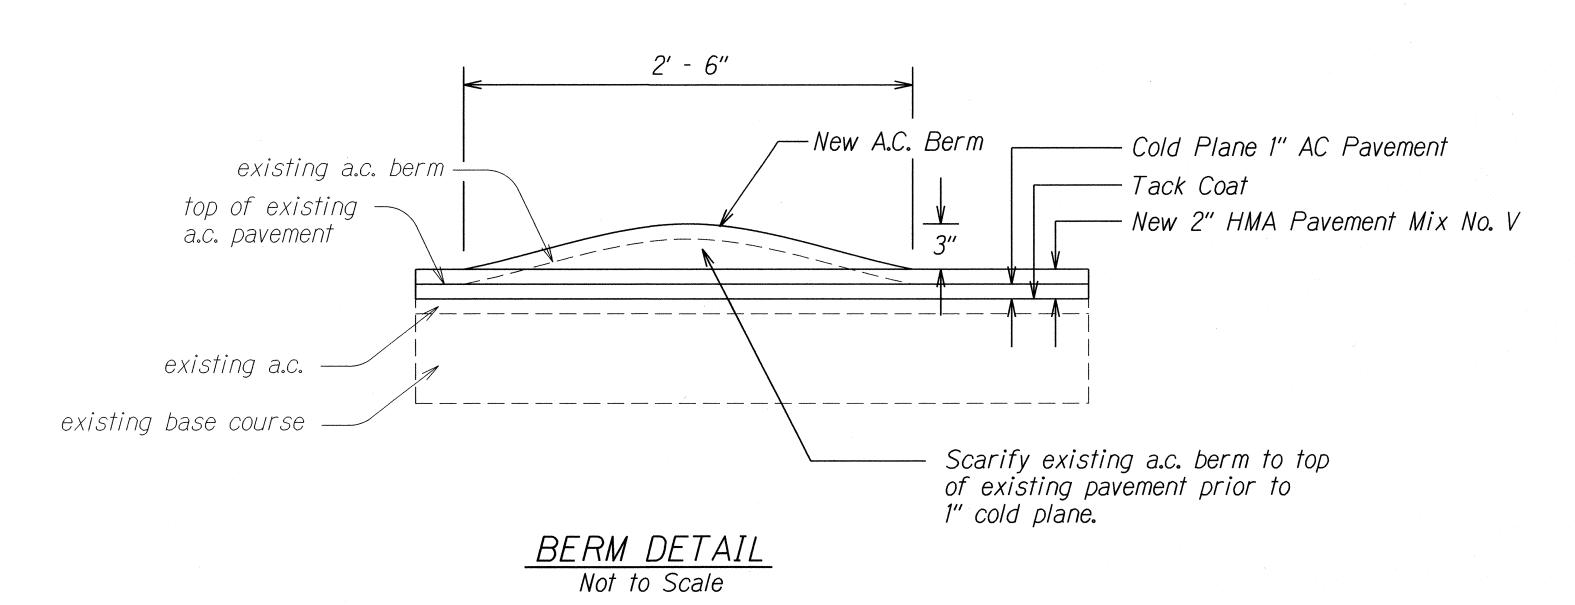
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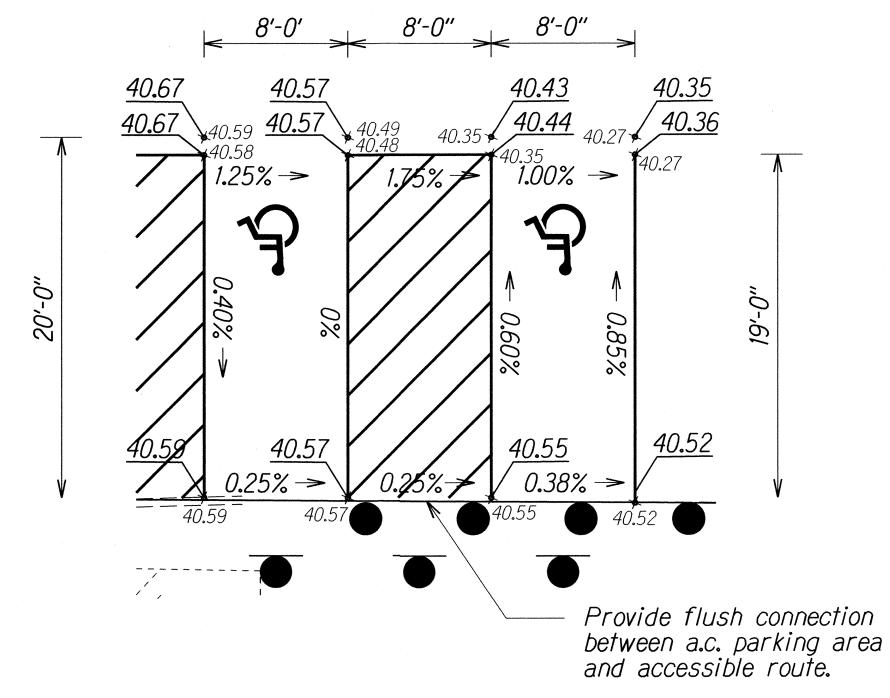
Date: May 2016





FED. ROAD DIST. NO.	STATE	PROJ. NO.	FISCAL YEAR	SHEET NO.	TOTAL SHEETS
HAWAII	HAW.	HWY-0-08-14	2016	ADD. 46	88

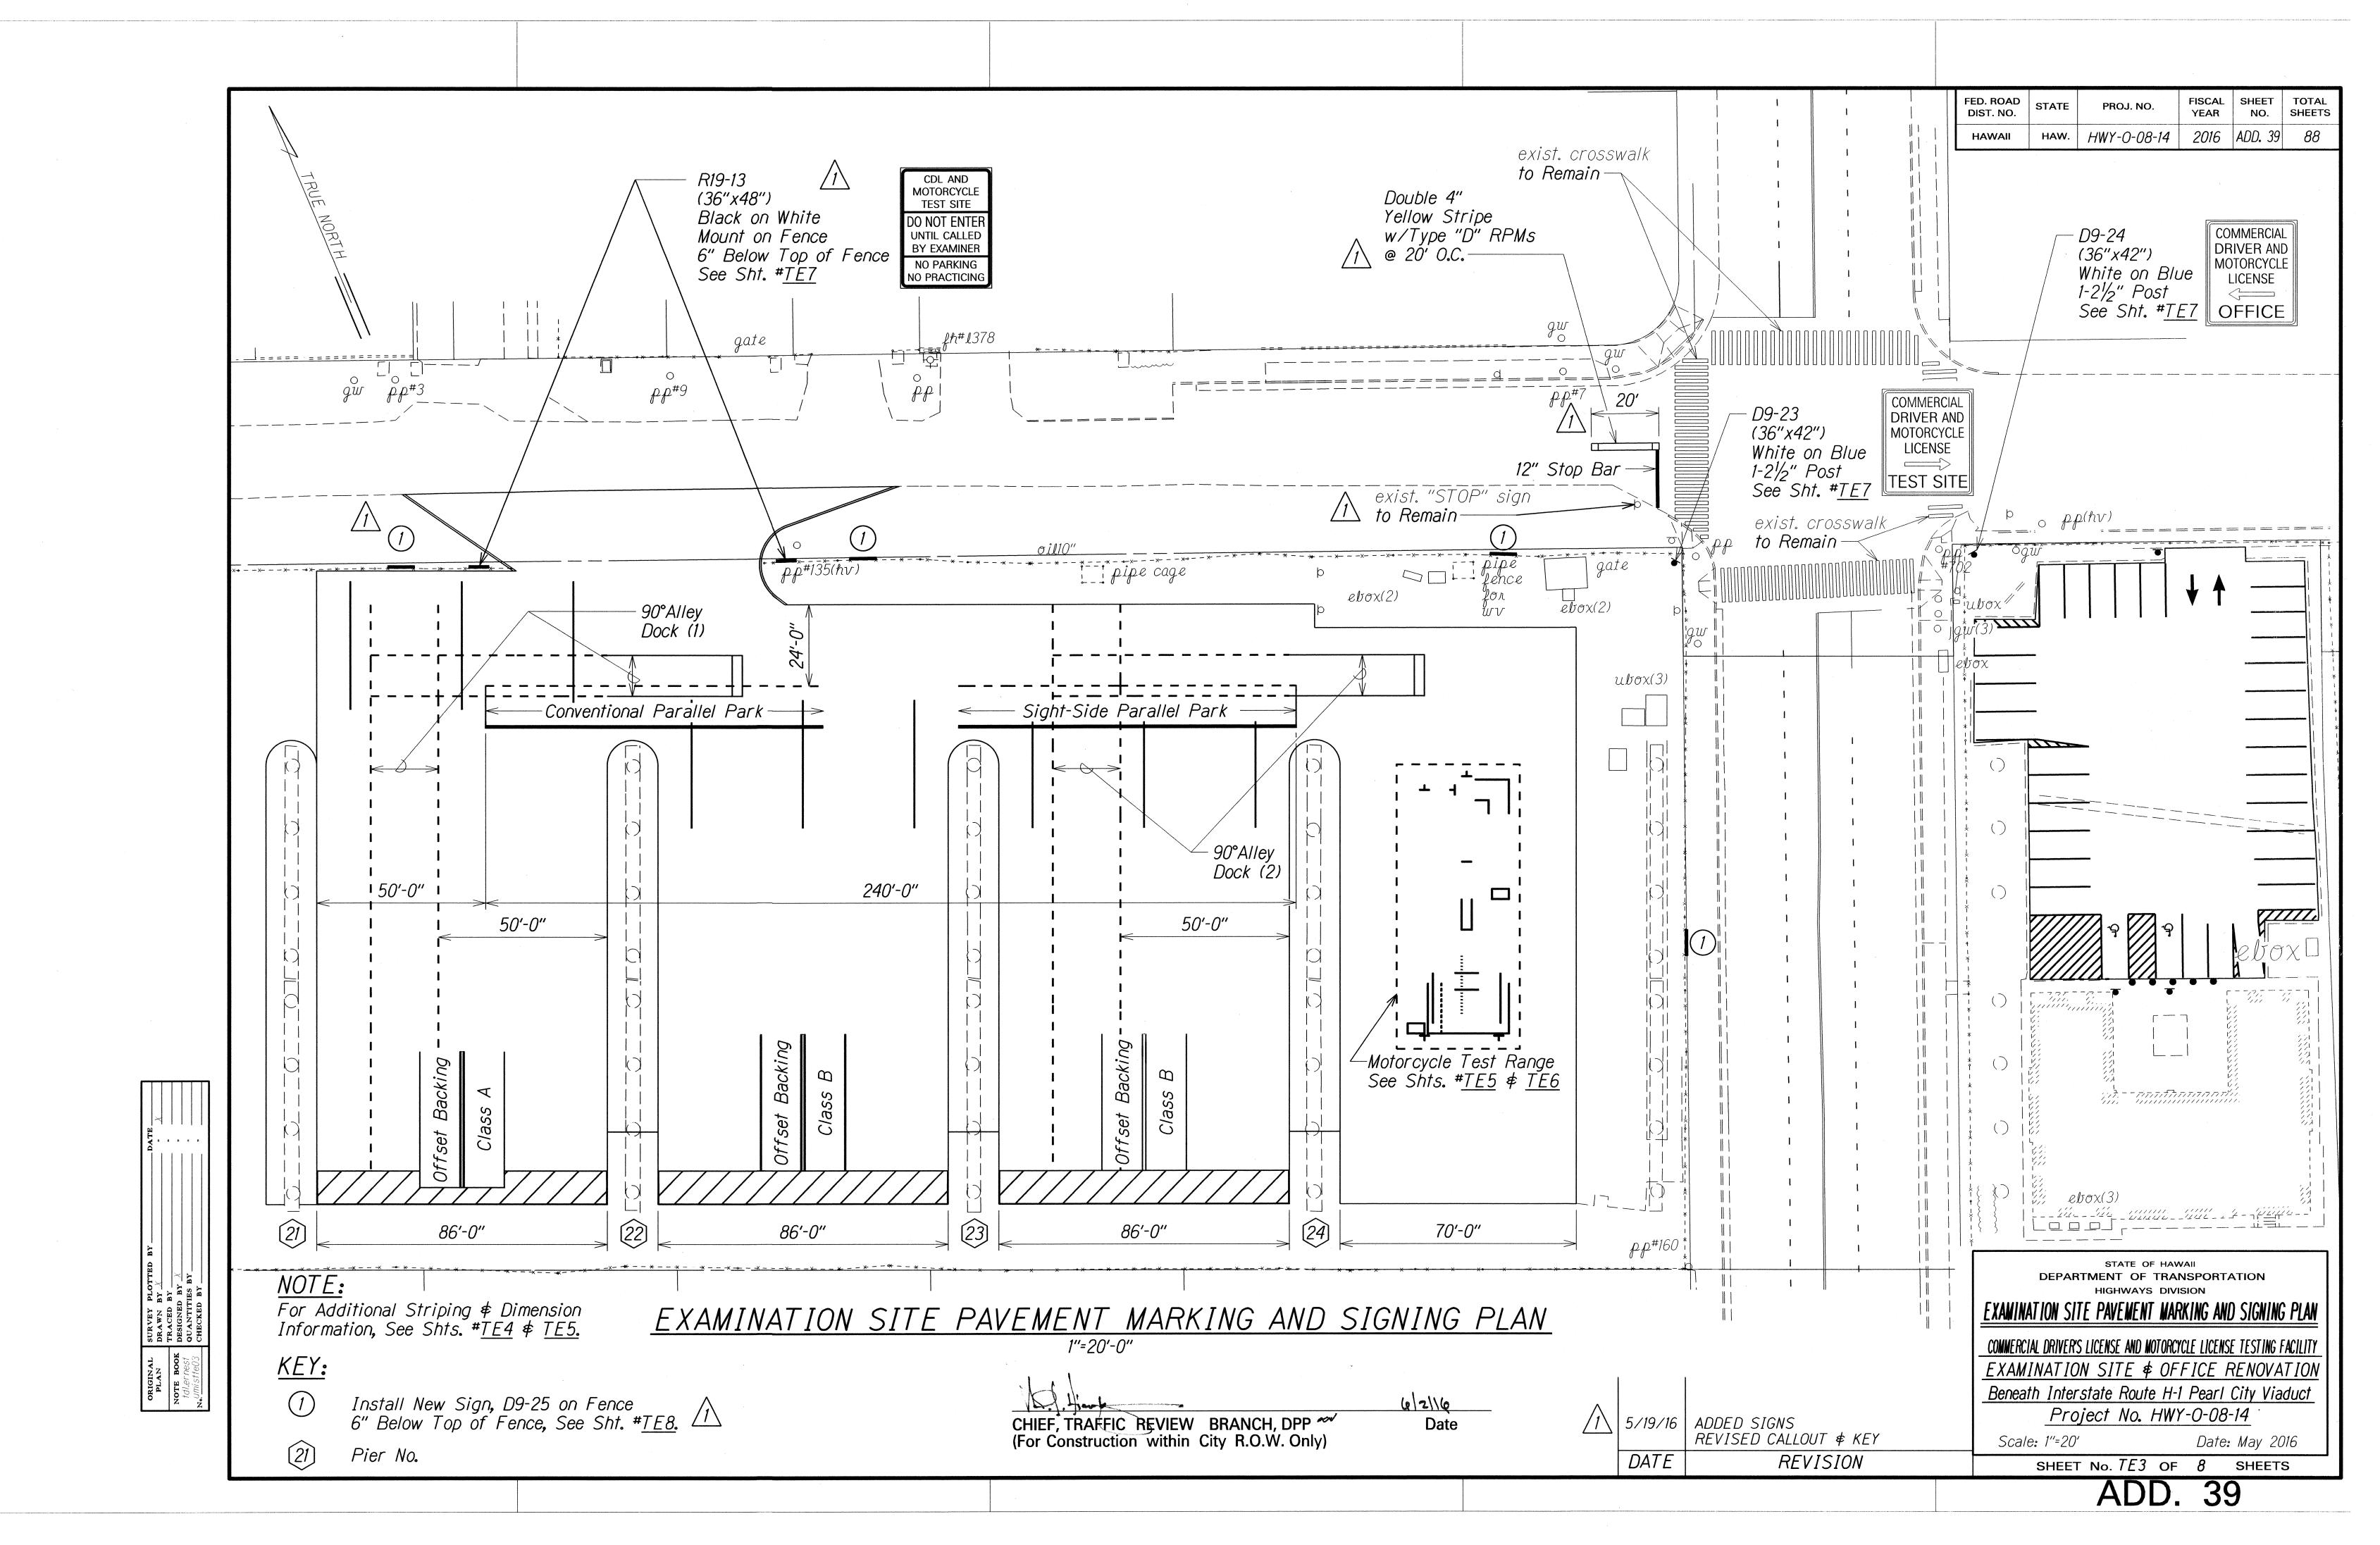



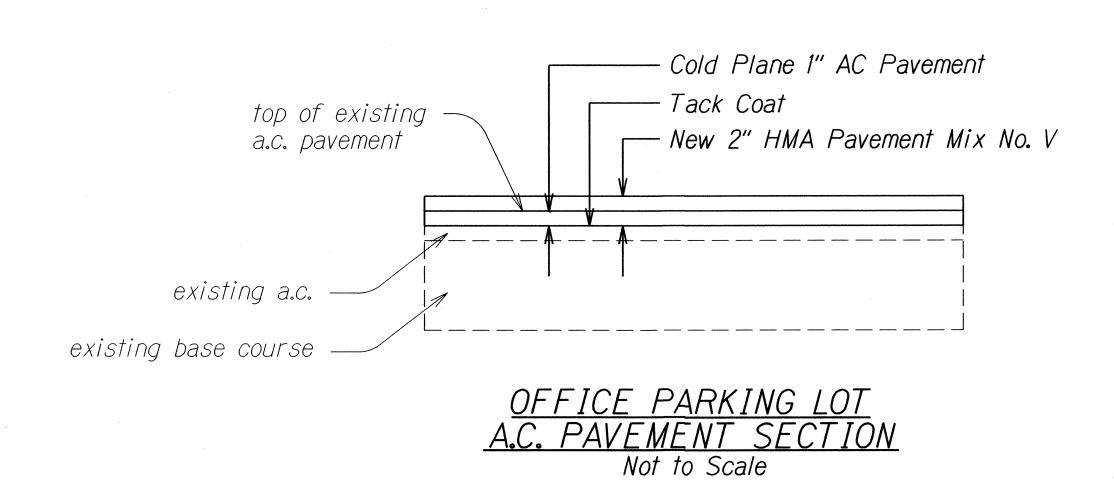

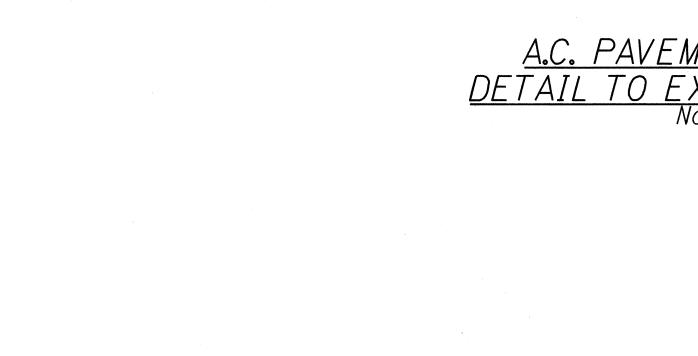

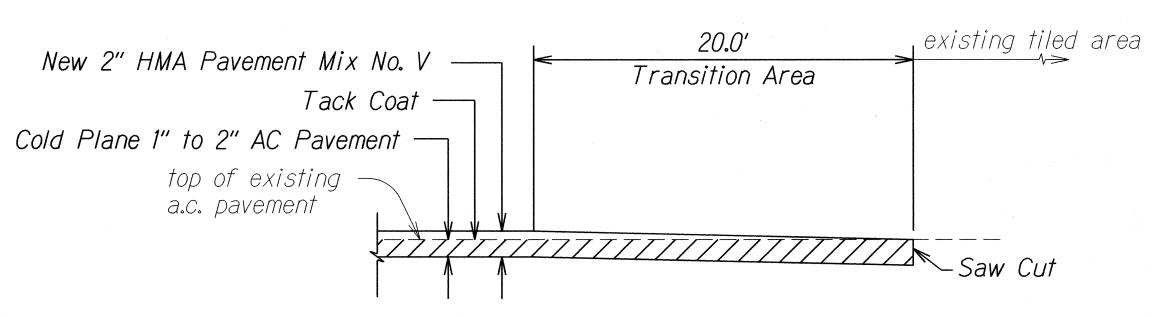

A.C. PAVEMENT TRANSITION DETAIL TO EXISTING TILED AREA

Not to Scale

ACCESSIBLE PARKING STALLS AND ACCESS AISLE GRADING DETAILS

Not to Scale

5/31/16 | Added Accessible Parking Stalls and Access Aisle Grading Details.

DATE

REVISION STATE OF HAWAII


DEPARTMENT OF TRANSPORTATION HIGHWAYS DIVISION


OFFICE RENOVATION SITE TYPICAL DETAILS


COMMERCIAL DRIVER'S LICENSE AND MOTORCYCLE LICENSE TESTING FACILITY EXAMINATION SITE AND OFFICE RENOVATION Beneath Interstate Route H-1 Pearl City Viaduct Project No. HWY-0-08-14 Date: May 2016

Scale: Not to Scale

OF 1 SHEET No. 1 SHEETS

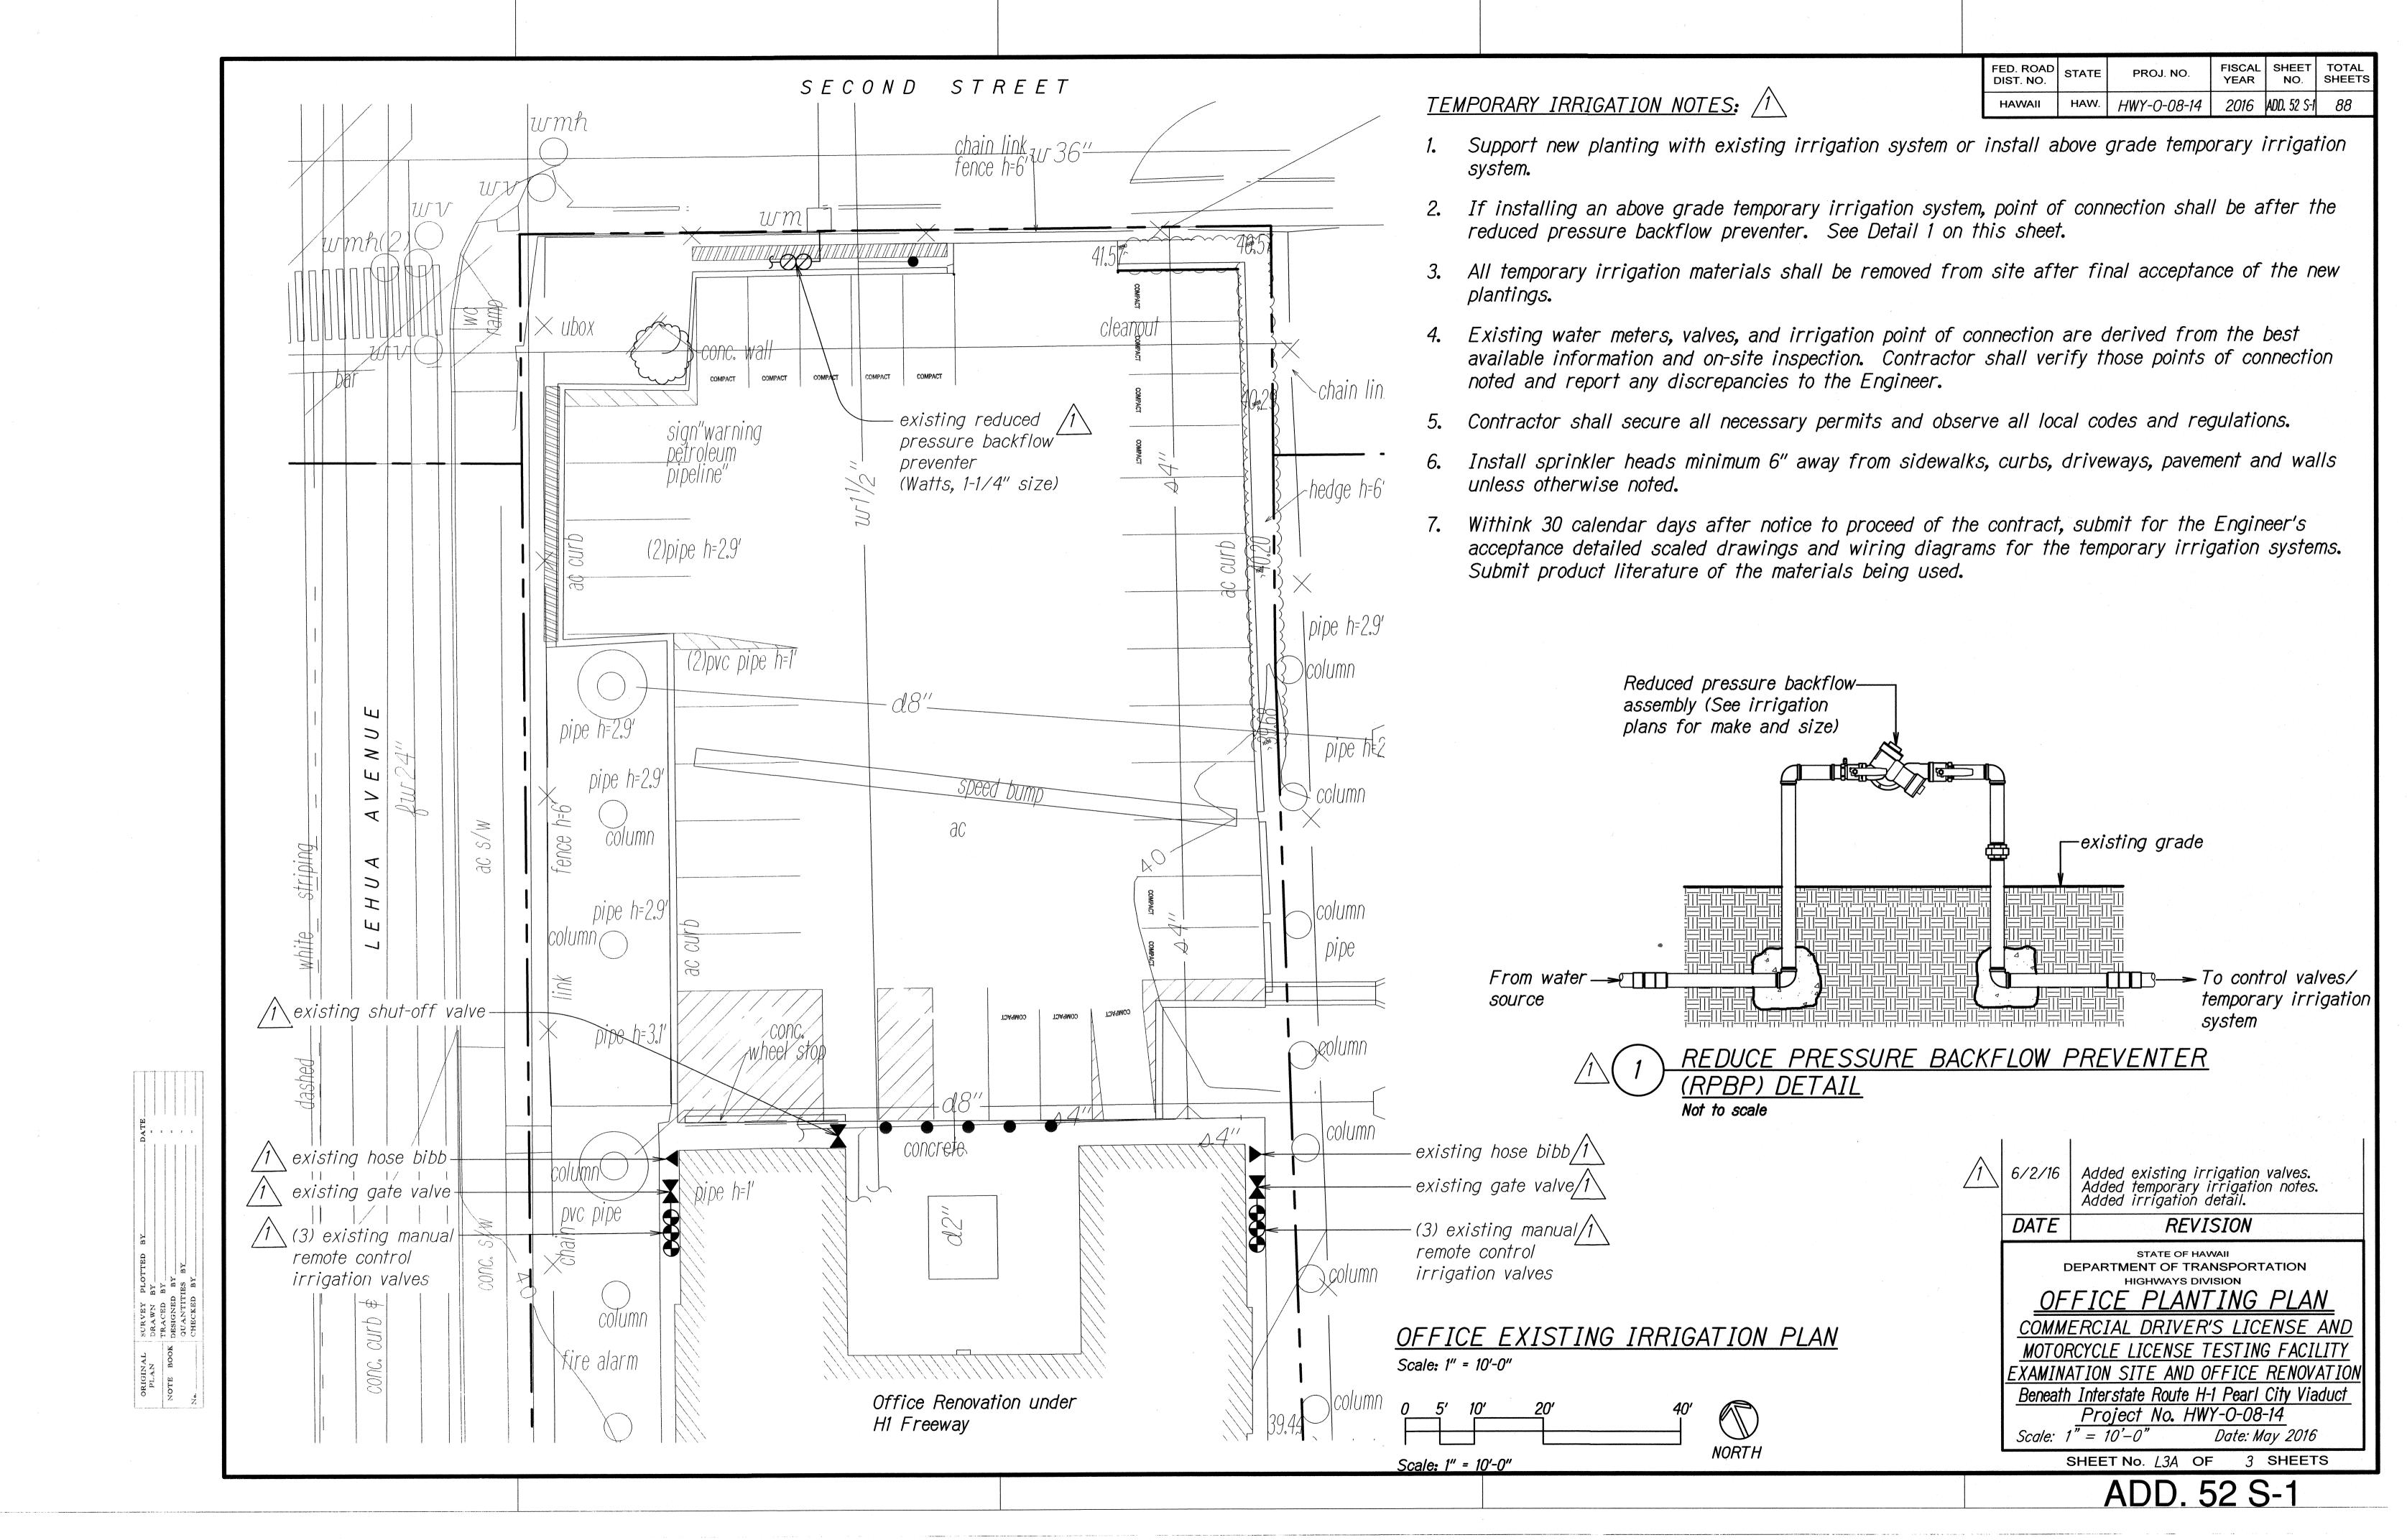

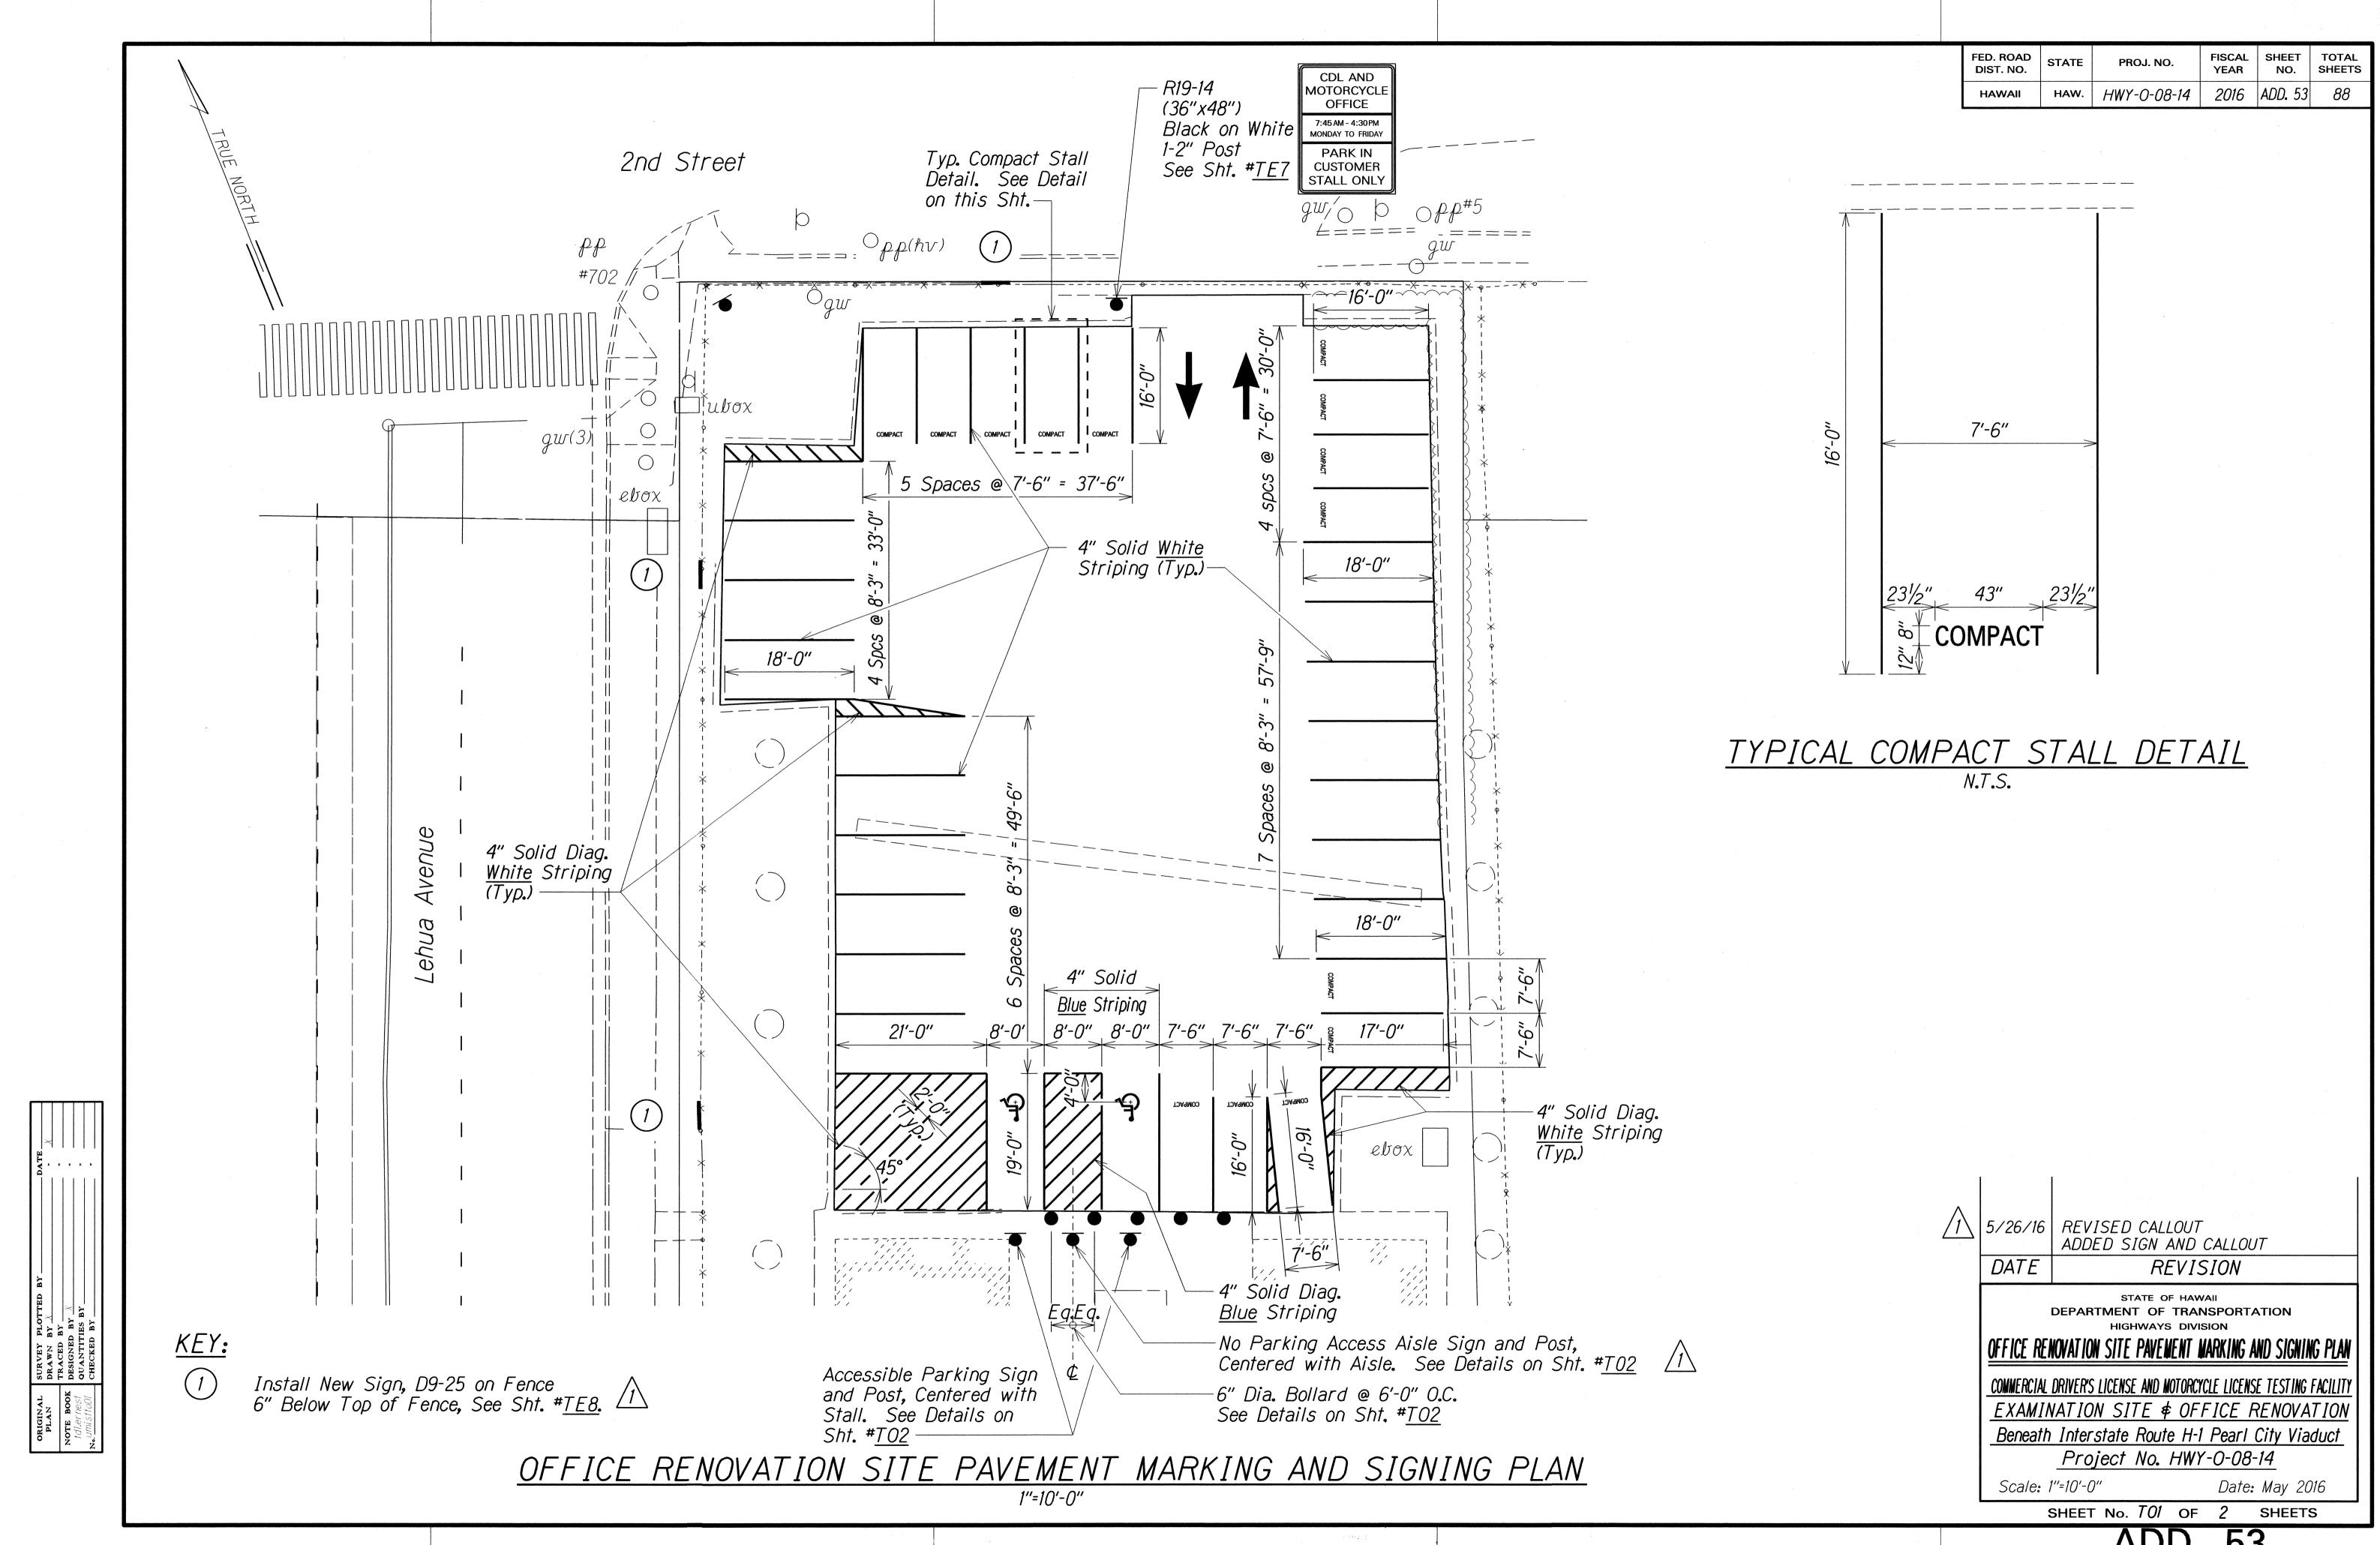

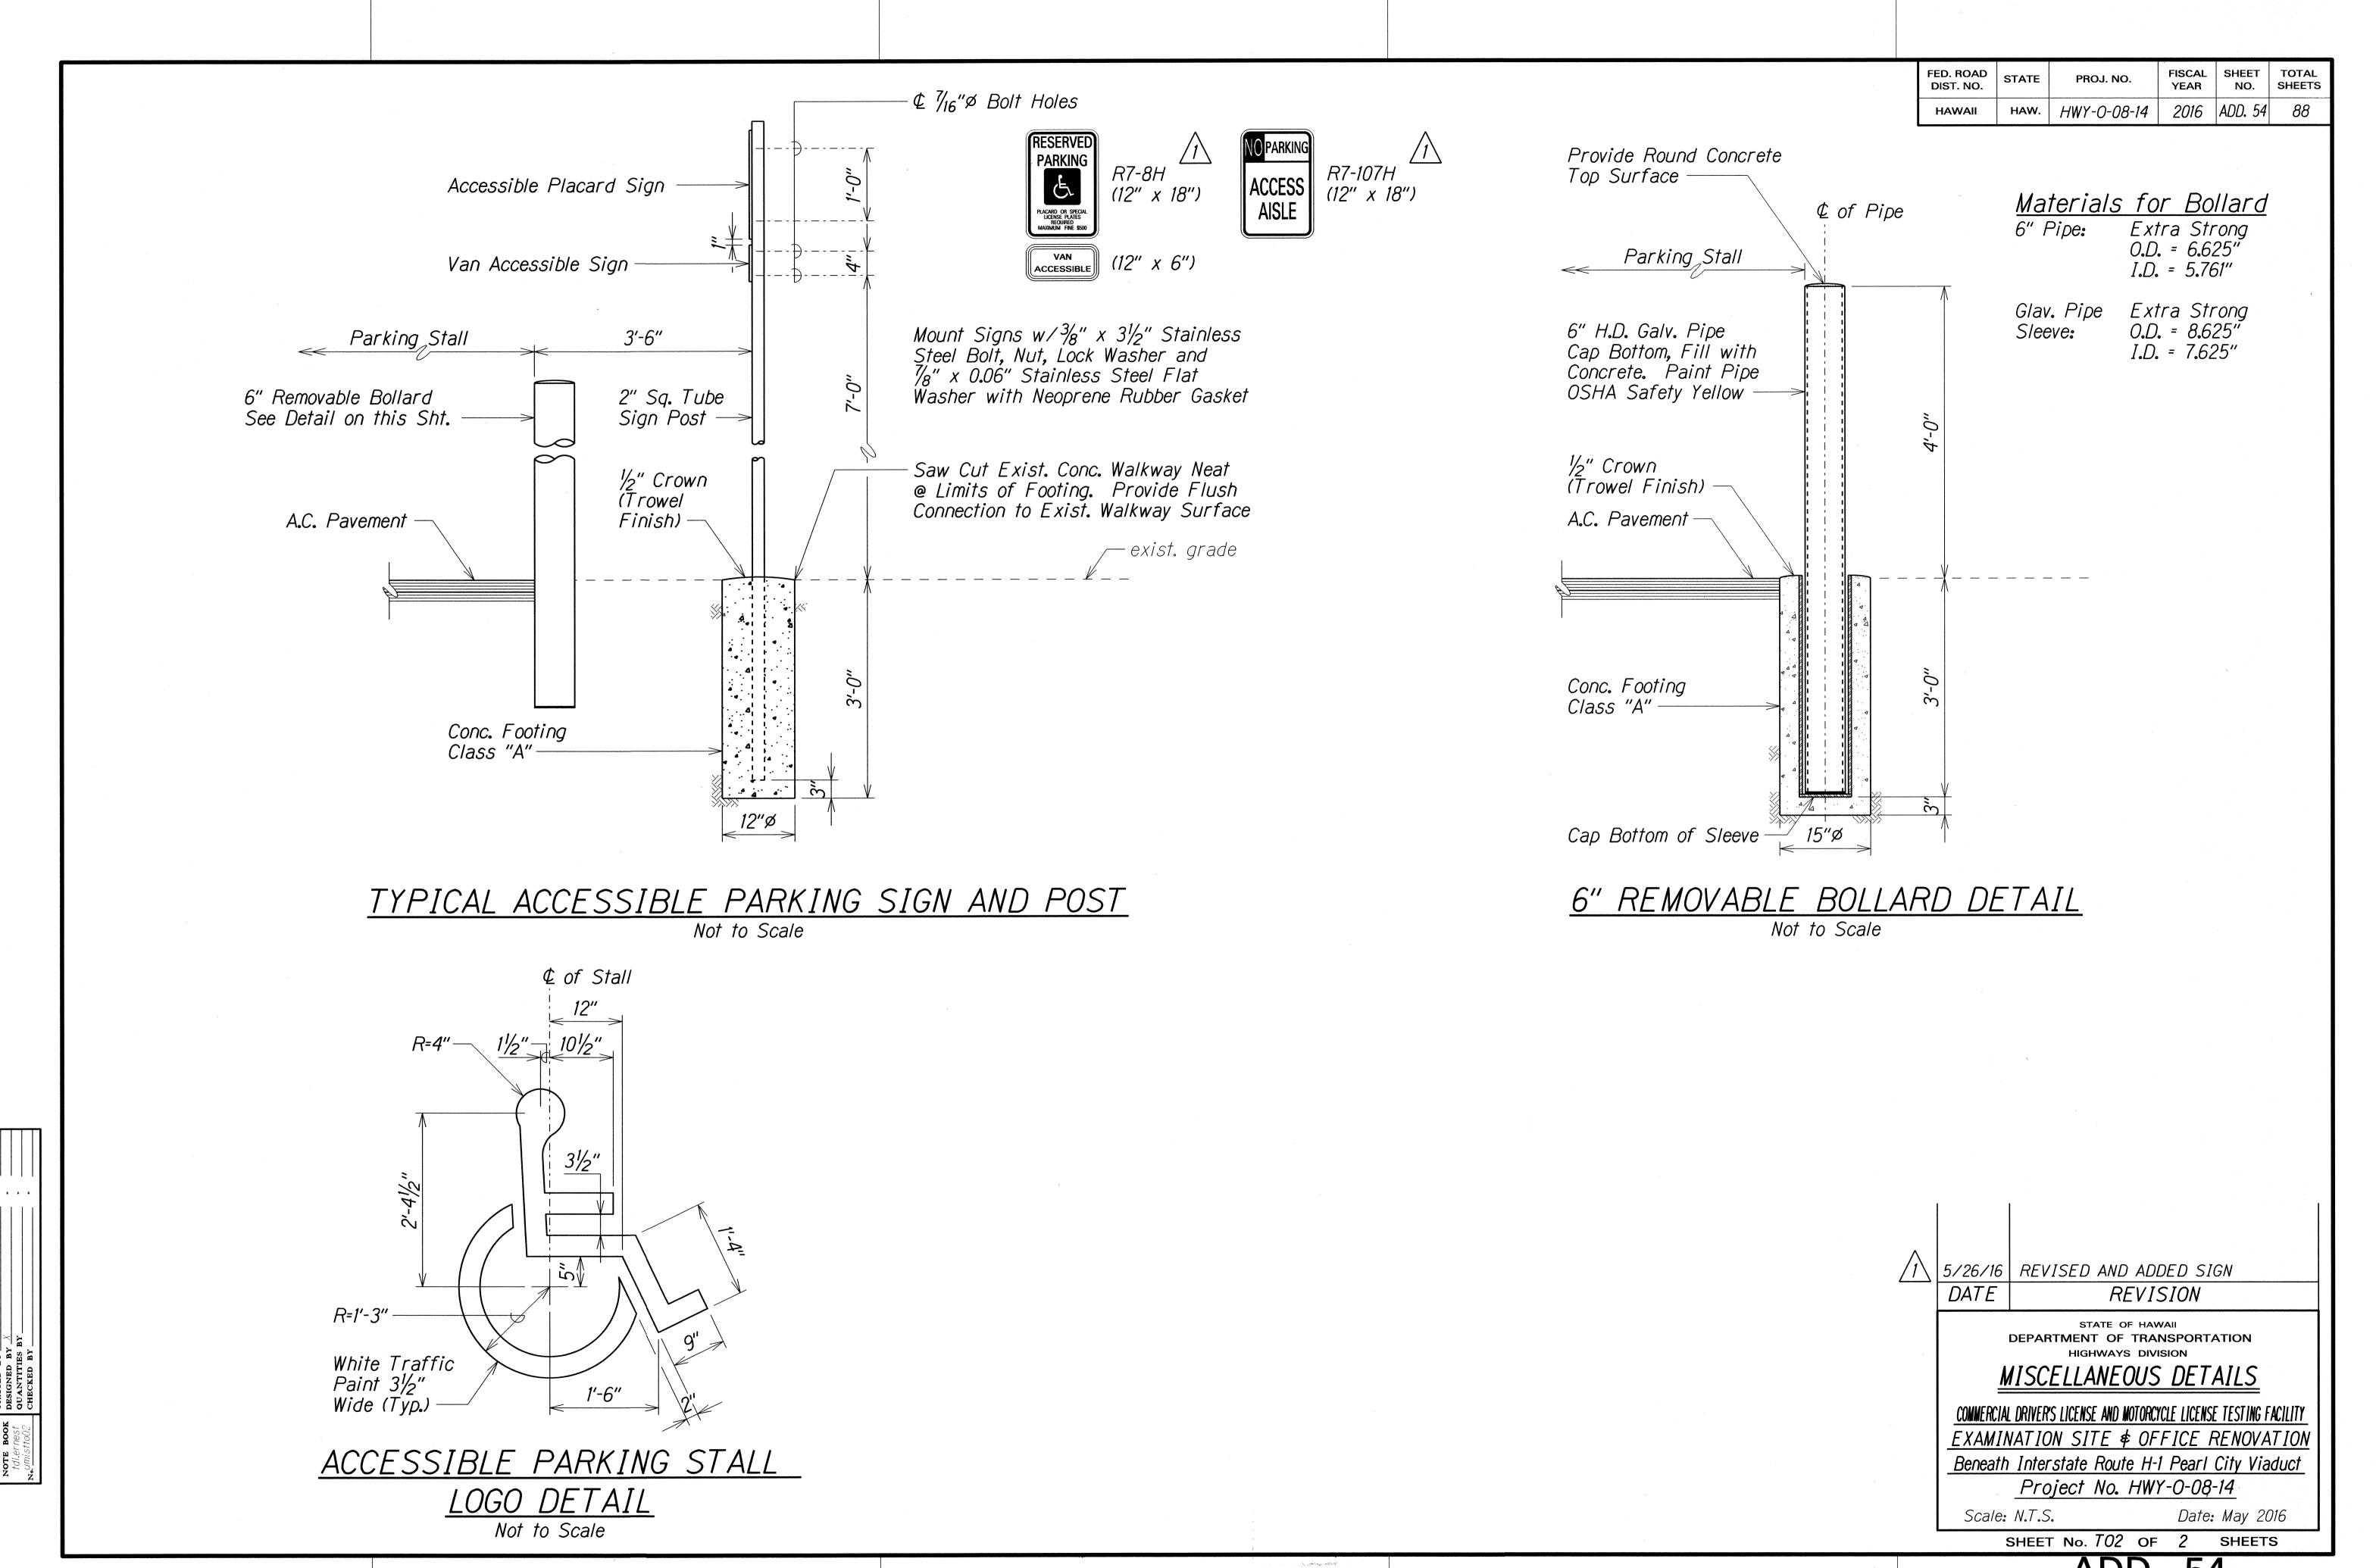

- 1. Laws and ordinances: as used herein shall mean all county, state and national codes, ordinances, standards, rules and regulations of any nature which are pertinent to, or regulatory over, the work covered by the contract documents of this project. All contractors shall comply fully with all applicable laws and ordinances. All construction shall conform to the current edition of the international building code and the latest city and county of honolulu/state of hawaii amendments, or the respective amendments by each county having jurisdiction of the project. The project shall conform to ADA accessibility requirements.
- 2. Conflict: In the case of any conflict wherein the methods, or standards of installation, or the specified materials are not equal to, or exceed the requirements of the laws or ordinances, the laws or ordinances shall govern. In the case of a discrepancy in the drawings or specifications, but not directly related to the provisions of codes, or ordinances, the contractor shall 1) provide the better quality, or greater quantity of work, or 2) comply with the more stringent requirement in accordance with the owner's/architect's interpretation. The contractor shall notify the owner and architect of all conflicts.
- 3. Conditions of the work: The information indicated on the drawings are based on limited field investigations and on the available resources at the time of document preparation. As a result, the accuracy and completeness of the information is not guaranteed. The contractor shall, therefore, verify the dimensions shown on the drawings with actual field measurements, examine the jobsite, verify all field conditions and provide the labor and materials required to complete the intended work. All work shall be performed in a professional manner that is of acceptable workmanship of the respective trades. The contractor shall notify the owner, or architect, prior to the commencement of work, if there are any dimensional discrepancies, or if there are any conditions that exist which may prevent the contractor's performance of work, and/or of any and all additional work that may be required as a result of the observed condition.
- 4. Intent of the drawings: The drawings are intended to define and establish the physical requirements of the project, i.e., the design, location and dimensions of the work, based on recognized standards, even if not actually shown, but reasonably inferred. All work shown is "new" unless otherwise noted as "existing." the contractor shall review and verify the information on all drawings before performing the work and notify the owner, or architect, of any discrepancies. The contractor shall coordinate the work of all subcontractors/trades to achieve the design intent and specified requirements and is responsible to complete any and all work associated with such coordination.
- 5. Completion of the work: The contractor shall in the work of all trades, perform any and all cutting, patching, repairing, restoring and the like necessary to complete the work and restore any damaged or affected surfaces resulting from the work of this contract to their original condition to the satisfaction of the architect and the owner, or his agent. Where walls, equipment, or any item is removed, exposed surfaces shall be patched and finished to match existing adjacent conditions. All exposed electrical wiring and plumbing pipes shall be re-routed into new or existing walls and meet all applicable code requirements and standard construction practices. The contractor is solely responsible for all means, methods, techniques, sequences and proceedures of construction, including, but not limited to safety precaution.
- 6. Clean up: The contractor shall clean and remove any trash, dirt, debris and spillage arising from the work daily to the satisfaction of the owner and the architect, including: cleaning of dirt, putty, paint, dust, etc. from areas counter tops, door and window faces and frames.

- 7. All existing surfaces shall be inspected and all necessary preparatory work shall be done in order to receive new finishes
- 8. Each subcontractor shall be responsible to verify adequate surface conditions that exist for their work. If adequate surface conditions do not exist the subcontractor shall not commence work until the condition is corrected.
- 9. Provide stiffeners, bracing, back-up plates, etc. as required at stud walls for support of fixtures and other equipment.
- 10. Warranty and guarantee: If within one (1) year after the date of substantial completion, any of the work is found to be defective or not in accordance with the contract documents, the contractor shall correct it properly after receipt of written notice from the owner.
- 11. Dimensions: Unless otherwise noted in the construction documents, all dimensions are taken to the face of stud
- 12. The contractor shall protect all existing electrical and utility lines which are to remain, free from damage during the progress of the work.
- 13. Execute all work in an orderly and careful manner with due consideration of existing structure or surfaces which are to remain.
- 14. Any damage done to the existing structure and finishes which are to remain, including all areas or surfaces where demolition occurs, shall be the contractor's responsibility to repair and refinish at no cost to the owner. At a minimum, the level of finish and materials shall match pre-existing conditions.
- 15. The contractor shall provide wall reinforcing as required for all plumbing fixtures, grab bars and accessories at existing walls, the contractor shall remove existing wall finishes as required to install new reinforcement and finish wall to its condition as shown on the plans.
- 16. The contractor shall verify all dimensions, conditions, types, and quantities prior to starting all work.
- 17. All dimensions for plumbing fixtures, grab bars and plumbing accessories are taken from finish wall.
- 18. The contractor shall clean and prepare all new and existing surfaces as required to receive new work or as otherwise required for a neat and finished appearance.
- 19. The contractor shall visit the job site and verify the existing condition before proceeding with the described and specified work.
- 20. Inform the contracting officer of any and all discrepancies or deviations from the contract documents before proceeding with the work.
- All work shall conform to the requirements of the international building code 2006 edition, the latest amendments of the city and county of honolulu, land use ordinance 2003 edition and the 2010 ADA Standards for Accessible Design.

FED. ROAD DIST. NO.	STATE	PROJ. NO.	FISCAL YEAR	SHEET NO.	TOTAL SHEETS
HAWAII	HAW.	HWY-0-08-14	2016	ADD. 55	88

Land Use and Building Code Data

Address:

897 Second St. Pearl City, HI 96782

Tax Map Key:

9-7-020:069

Zoning: Lot Area:

23,605 S.F. total area

Scope of Work:

Re-roofing \$ interior renovations to

existing building.

Building Code Analysis:

Occupancy:

Type of Construction: Type VB
Allowable Area: 9.000 S.F

9,000 S.F. 4,200 S.F.

Actual Area: Maximum Height Allowed:

2 Stories

Actual Height: 1 S

1 Story

 ORIGINAL
 SURVEY PLOTTED BY
 DATE


 PLAN
 DRAWN BY
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 NOTE BOOK
 DESIGNED BY
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 QUANTITIES BY
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 CHECKED BY
 "

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DEPARTMENT OF TRANSPORTATION
HIGHWAYS DIVISION

LAND USE BUILDING CODE DATA


COMMERCIAL DRIVER'S LICENSE AND
MOTORCYCLE LICENSE TESTING FACILITY
EXAMINATION SITE AND OFFICE RENOVATION


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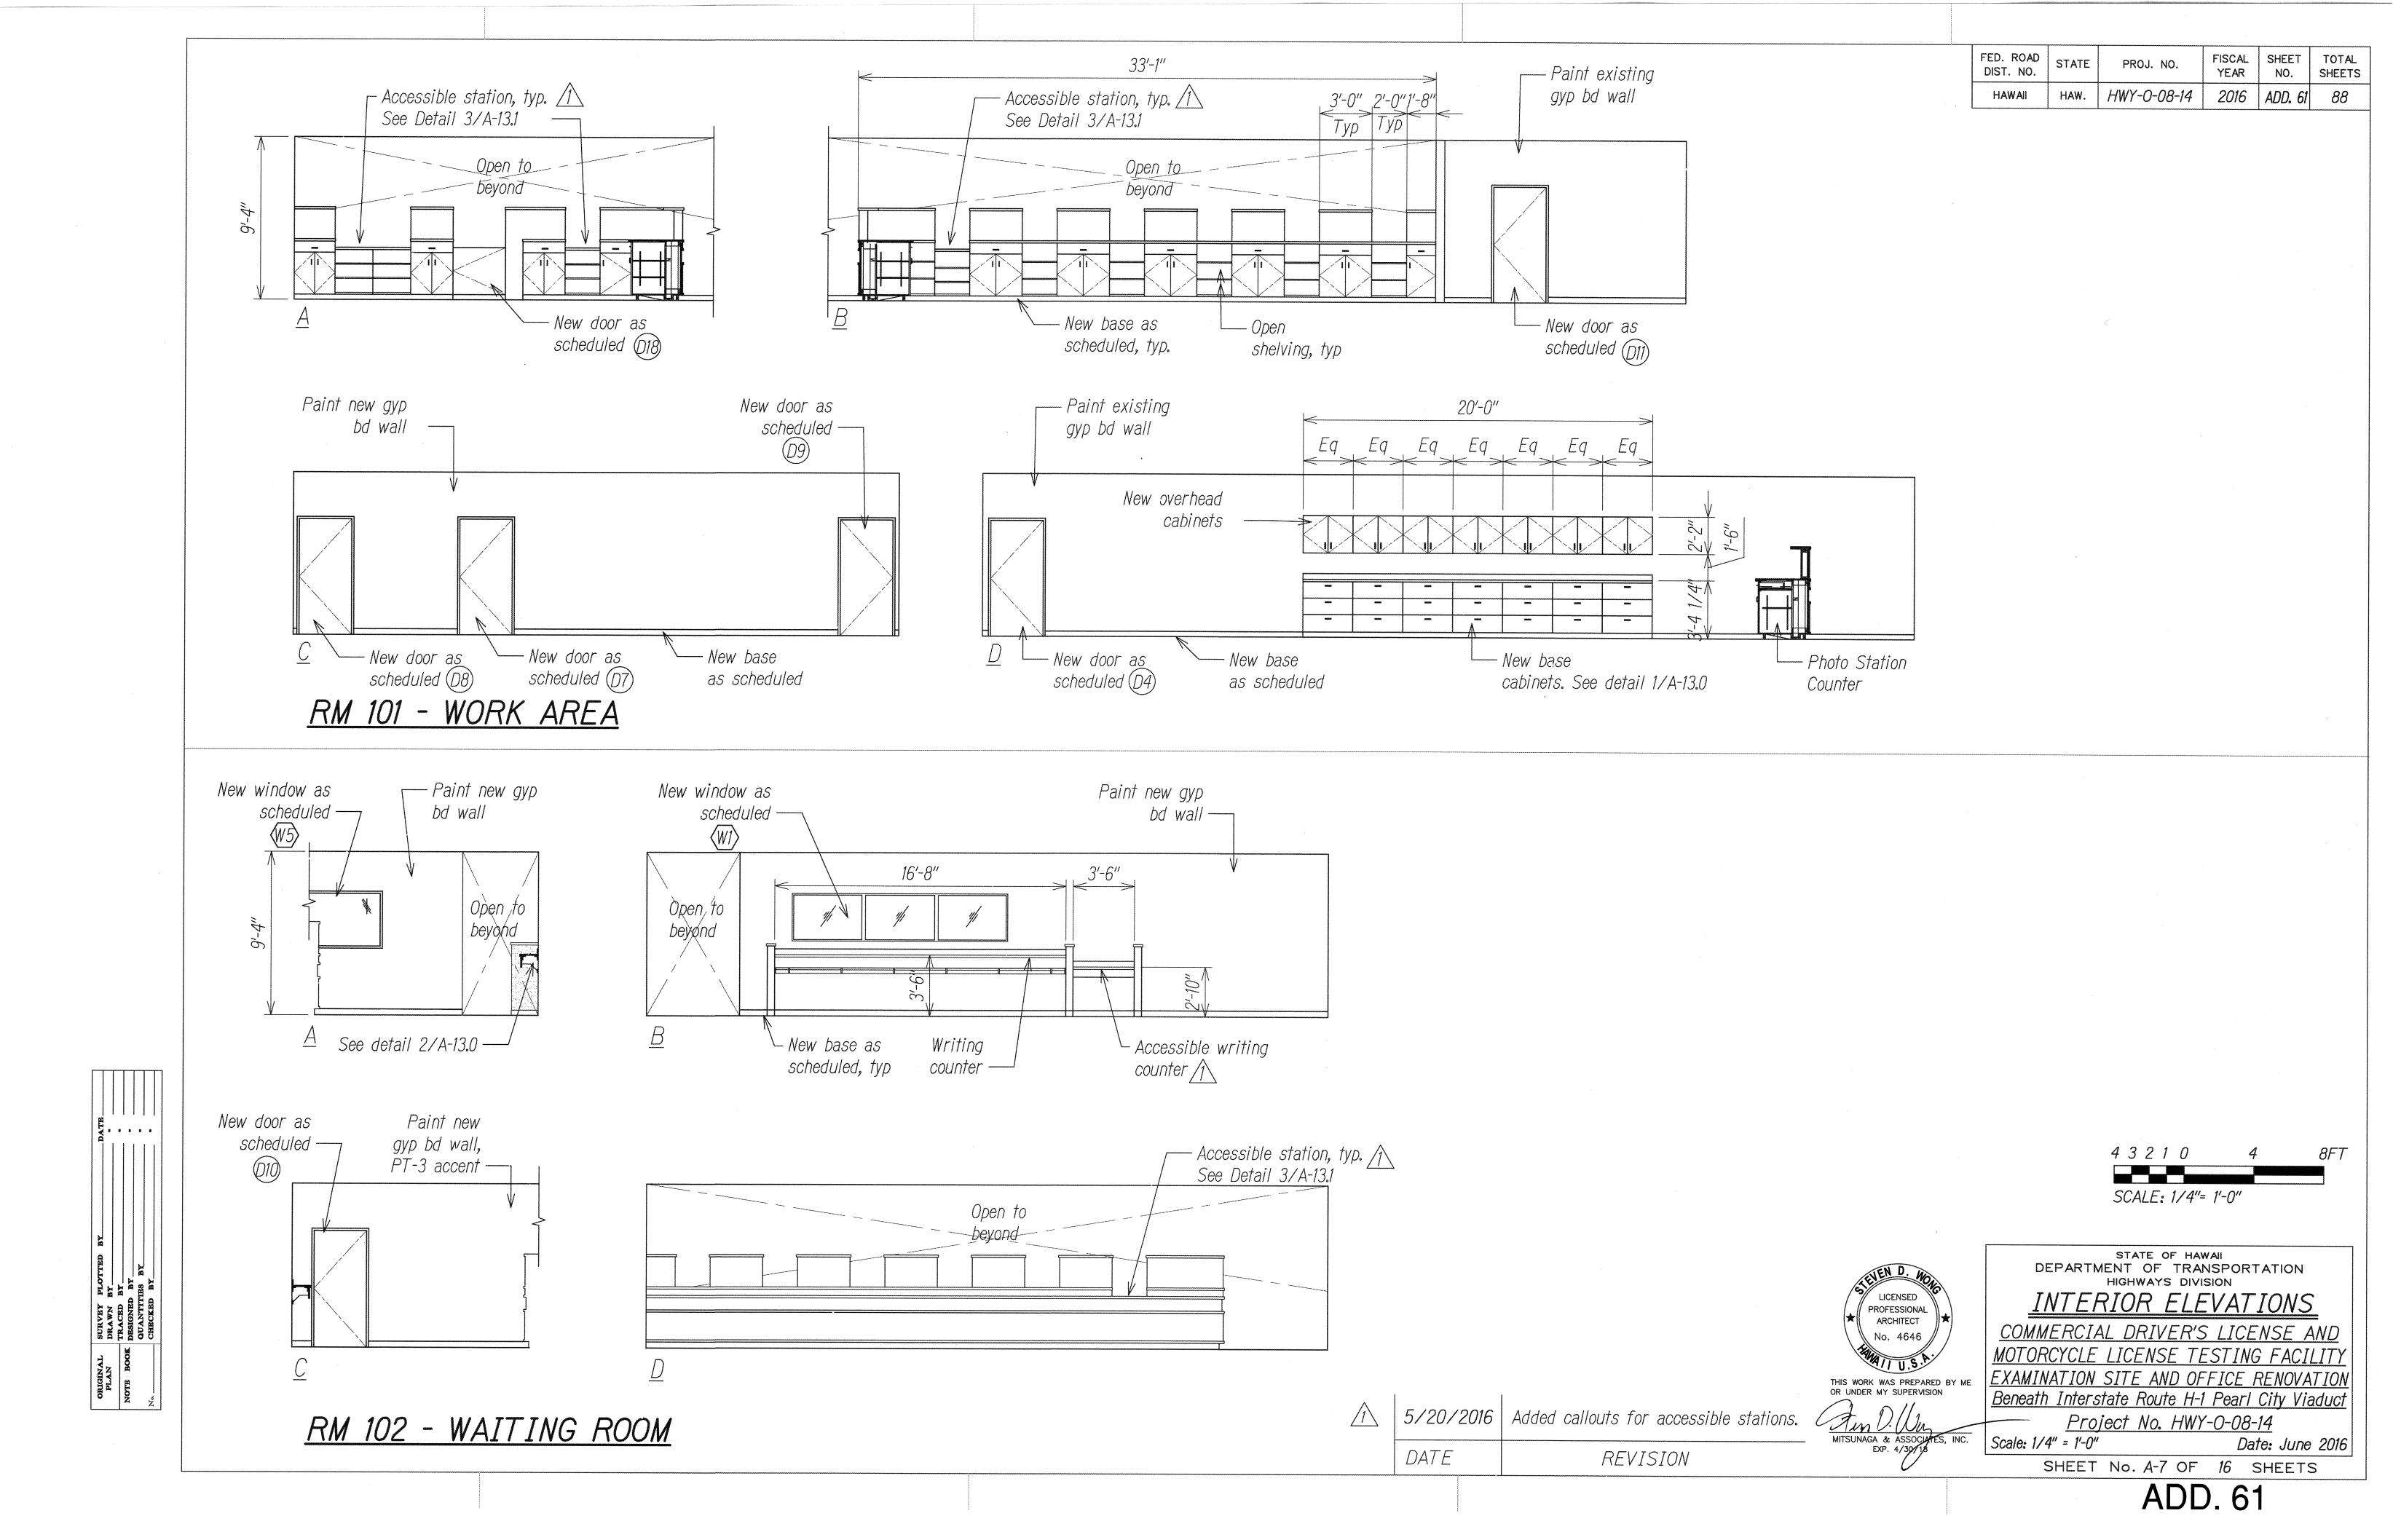
Beneath Interstate Route H-1 Pearl City Viaduct

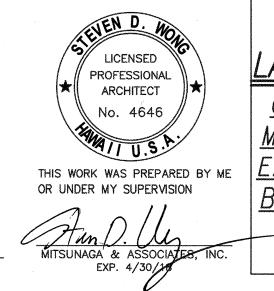
Project No. HWY-0-08-14


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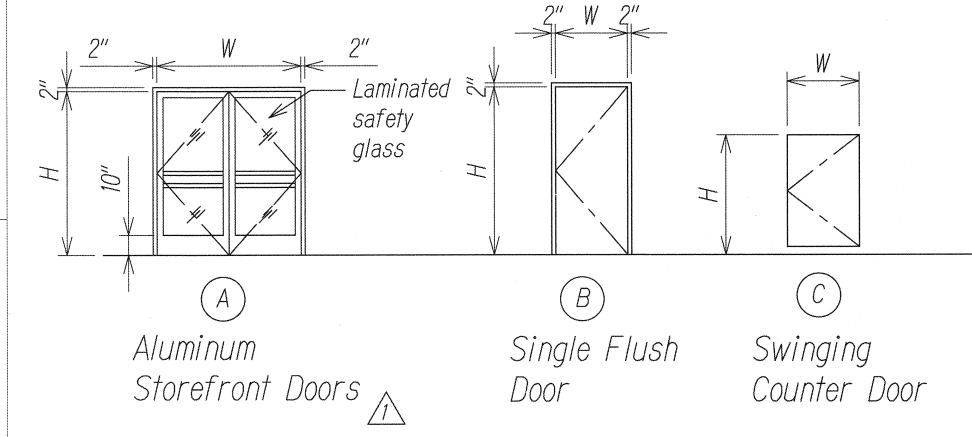
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FED. ROAD DIST. NO.	STATE	PROJ. NO.	FISCAL YEAR	SHEET NO.	TOTAL SHEETS
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nc	7	<i>N</i> 0.			Size		Doc	or	Frame		Det	ails		are D	ks
Location	Room Name	Door 1	Type	Width	Height	Thk	Core	Material	Materia/	Head	Jamb	Meeting Stiles	Threshold	Hardware Group	Remarks
	Entry Lobby	1	Α	6'-0"	6'-8"	1 3/4			Alum	1/A-10	1/A-10	2/A-10	3/A-10	9	
	Break Area	2	В	3'-0"	7'-0"	1 3/4	Hollow	Metal	Metal	5/A-10	5/A-X	ww wa-	6/A-X	1	
	Break Area	3	В	3'-0"	7'-0"	1 3/4	Hollow	Metal	Metal	5/A-10	5/A-10	• • • • • • • • • • • • • • • • • • •	6/A-10	1	*
У	Work Area	4	В	3'-0"	6'-8"	1 3/4	Hollow	Metal	Metal	5/A-10	5/A-10	****	6/A-10	2	
Facility	Storage 2	5	В	3'-0"	6'-8"	1 3/4	Solid	Wood	Metal	7/A-10	7/A-10	***	8/A-10	4	
	Conference Room	6	В	3'-0"	6'-8"	1 3/4	Solid	Wood	Metal	7/A-10	7/A-10	wo w	8/A-10	4	
Testing	Office	7	В	3'-0"	7'-0"	1 3/4	Solid	Wood	Metal	7/A-10	7/A-10	***	8/A-10	4	
)ffice	Storage 1	8	В	3'-0"	7'-0"	1 3/4	Solid	Wood	Metal	7/A-10	7/A-X	***	8/A-X	4	
9	Electrical Room	9	В	3'-0"	7'-0"	1 3/4	Solid	Wood	Metal	7/A-10	7/A-10		8/A-10	4	
Safety	Waiting Room	10	В	3'-0"	7'-0"	1 3/4	Solid	Wood	Metal	7/A-10	7/A-10		8/A-10	3	
₹ 1	Break Area	11	В	3'-0"	7'-0"	1 3/4	Solid	Wood	Metal	1/A-10	1/A-10	***	X/A-10	3	
Vehicle	Bath	12	В	3'-0"	7'-0"	1 3/4	Solid	Wood	Metal	7/A-10	7/A-10	******	8/A-10	6	· · · · · · · · · · · · · · · · · · ·
Motor	Closet	13	В	3'-0"	7'-0"	1 3/4	Solid	Wood	Metal	7/A-10	7/A-10		8/A-10	4	
_	Test Room	14	В	3'-0"	7'-9"	1 3/4	Solid	Wood	Metal	**************************************		***************************************	w w	5	See Note 1
	Men	15	В	3'-0"	6'-8"	1 3/4	Solid	Wood	Metal					7	See Note 1
XXXX	Jan	16	В	3'-0"	6'-8"	1 3/4	Solid	Wood	Metal	····	***			4	See Note 1
	Women	17	В	3'-0"	7'-0"	1 3/4	Solid	Wood	Metal				www. st	7	See Note 1
	Work Area	18	C	3'-0"	3'-0"	1 3/4	Hollow	Wood	Metal	: ••••••••	4/A-10	4/A-10		8	

Notes:

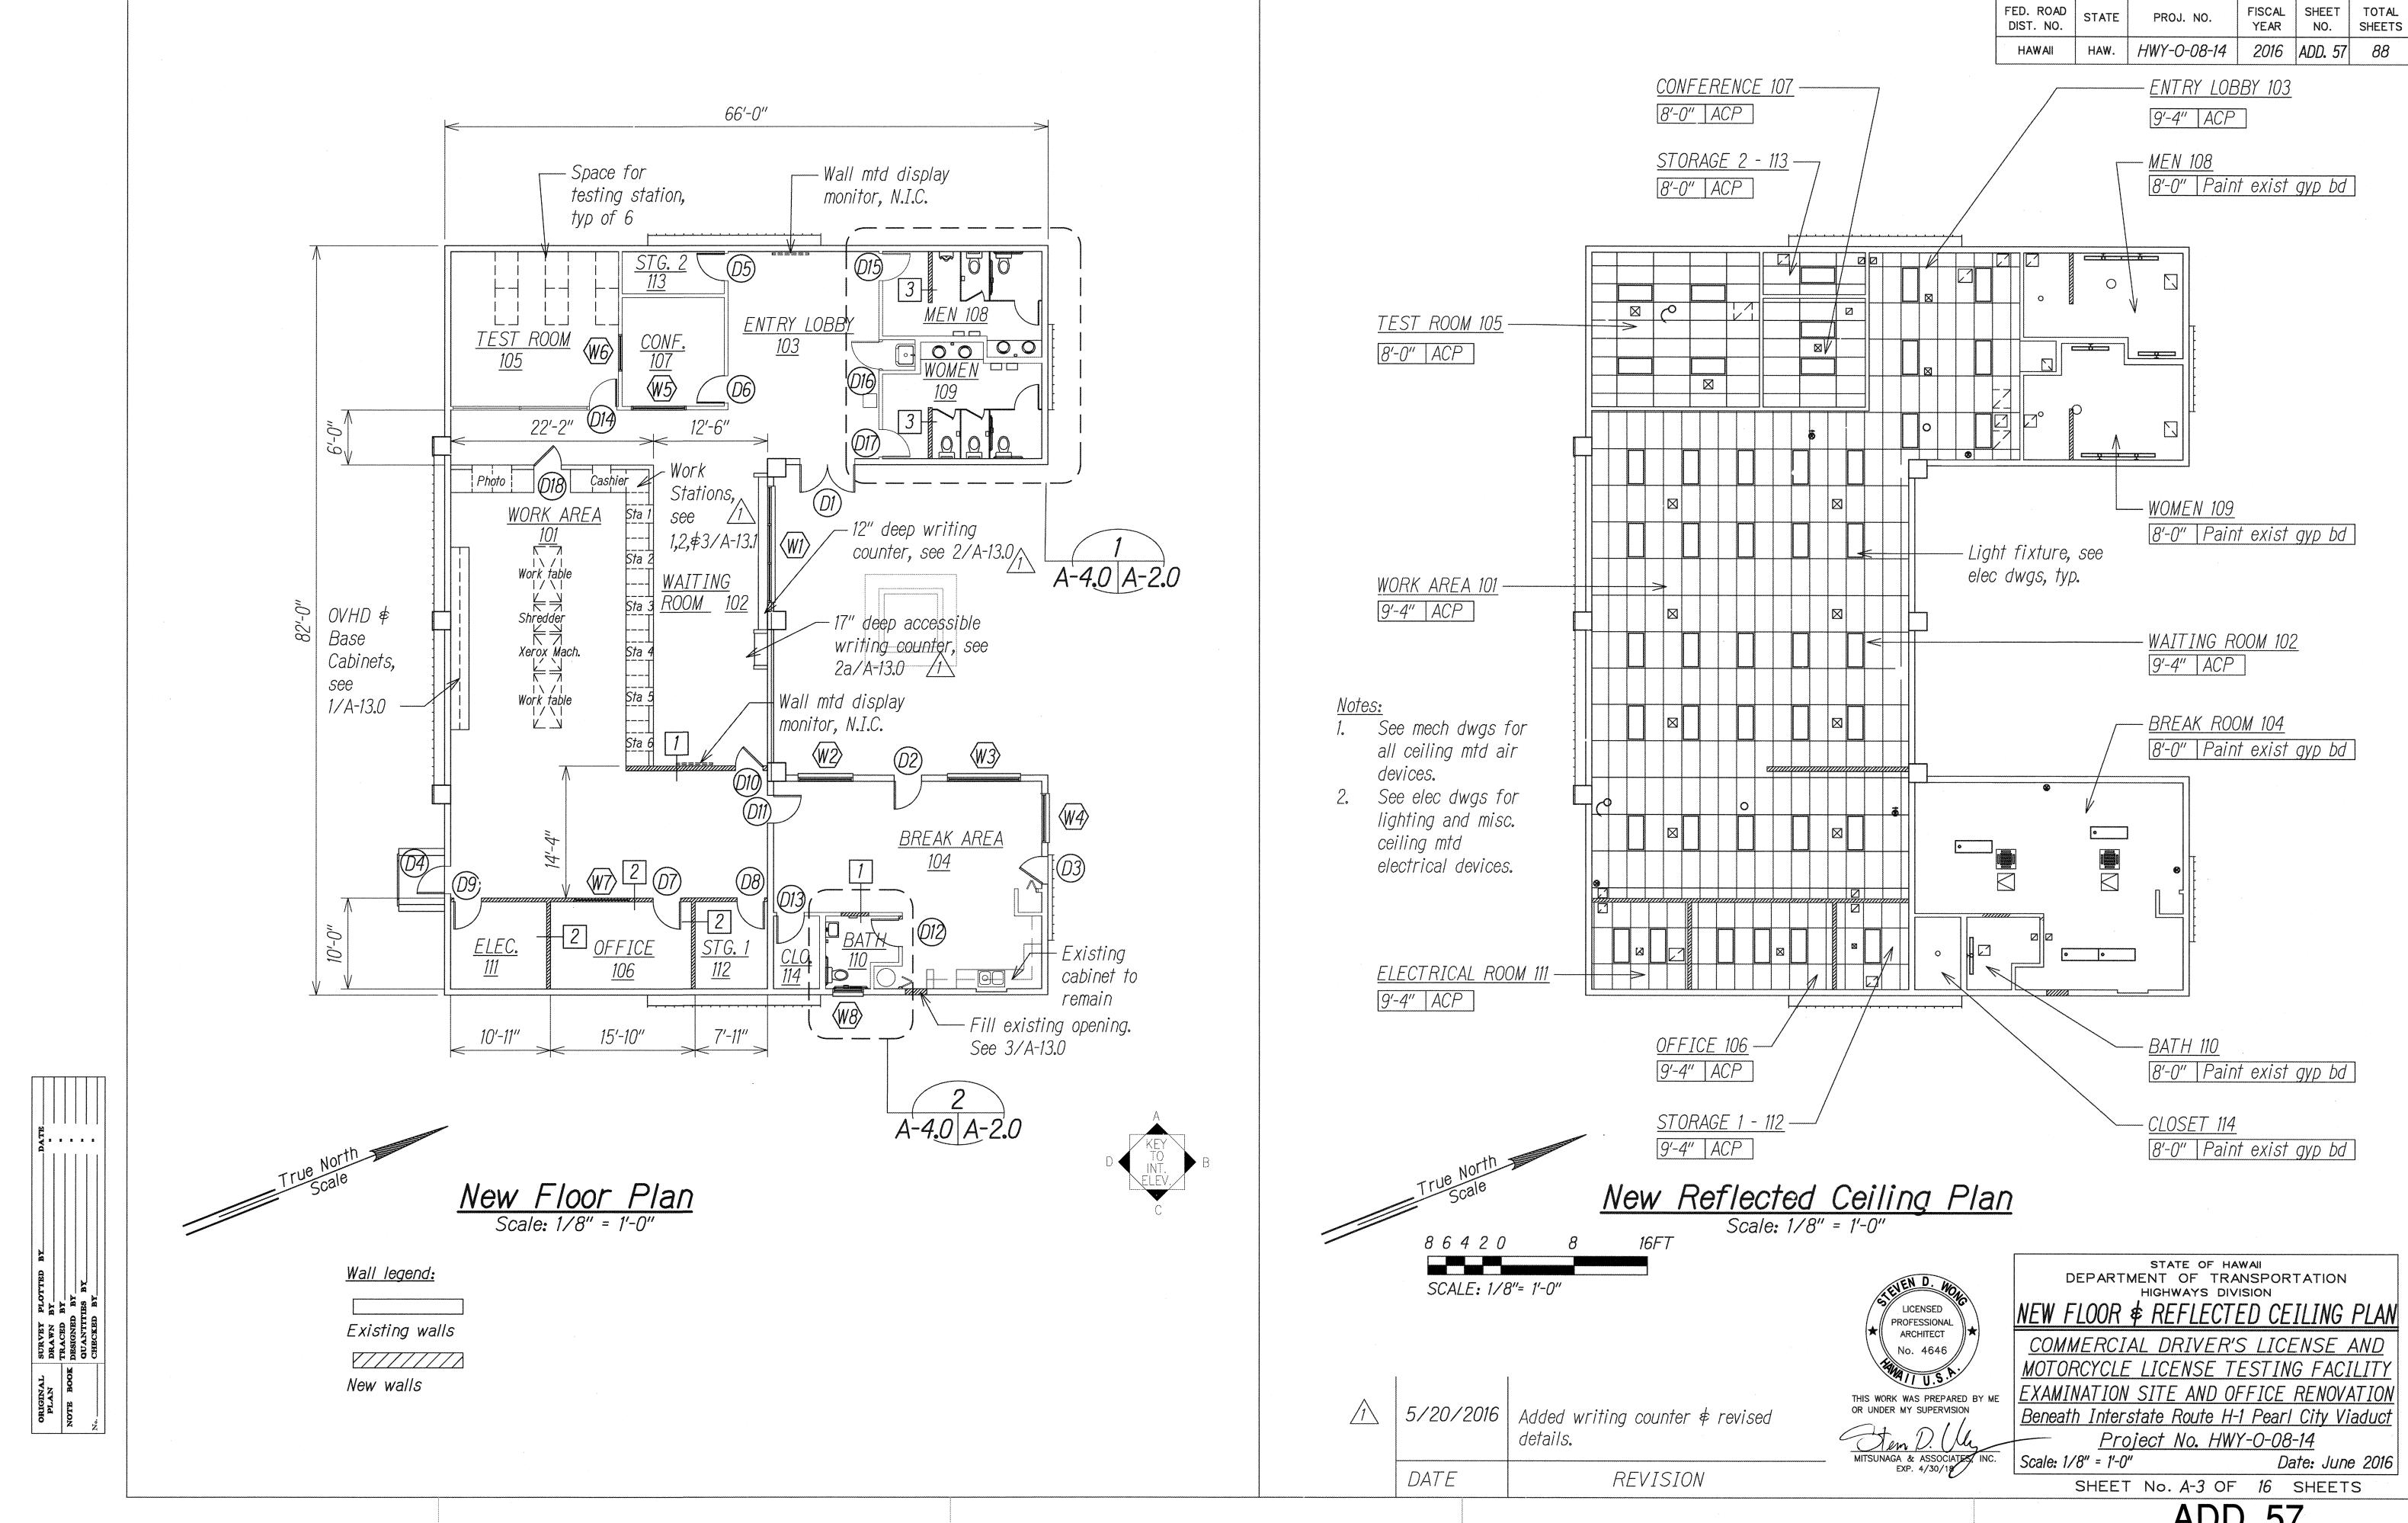1. Provide new door hardware. Existing door to remain.

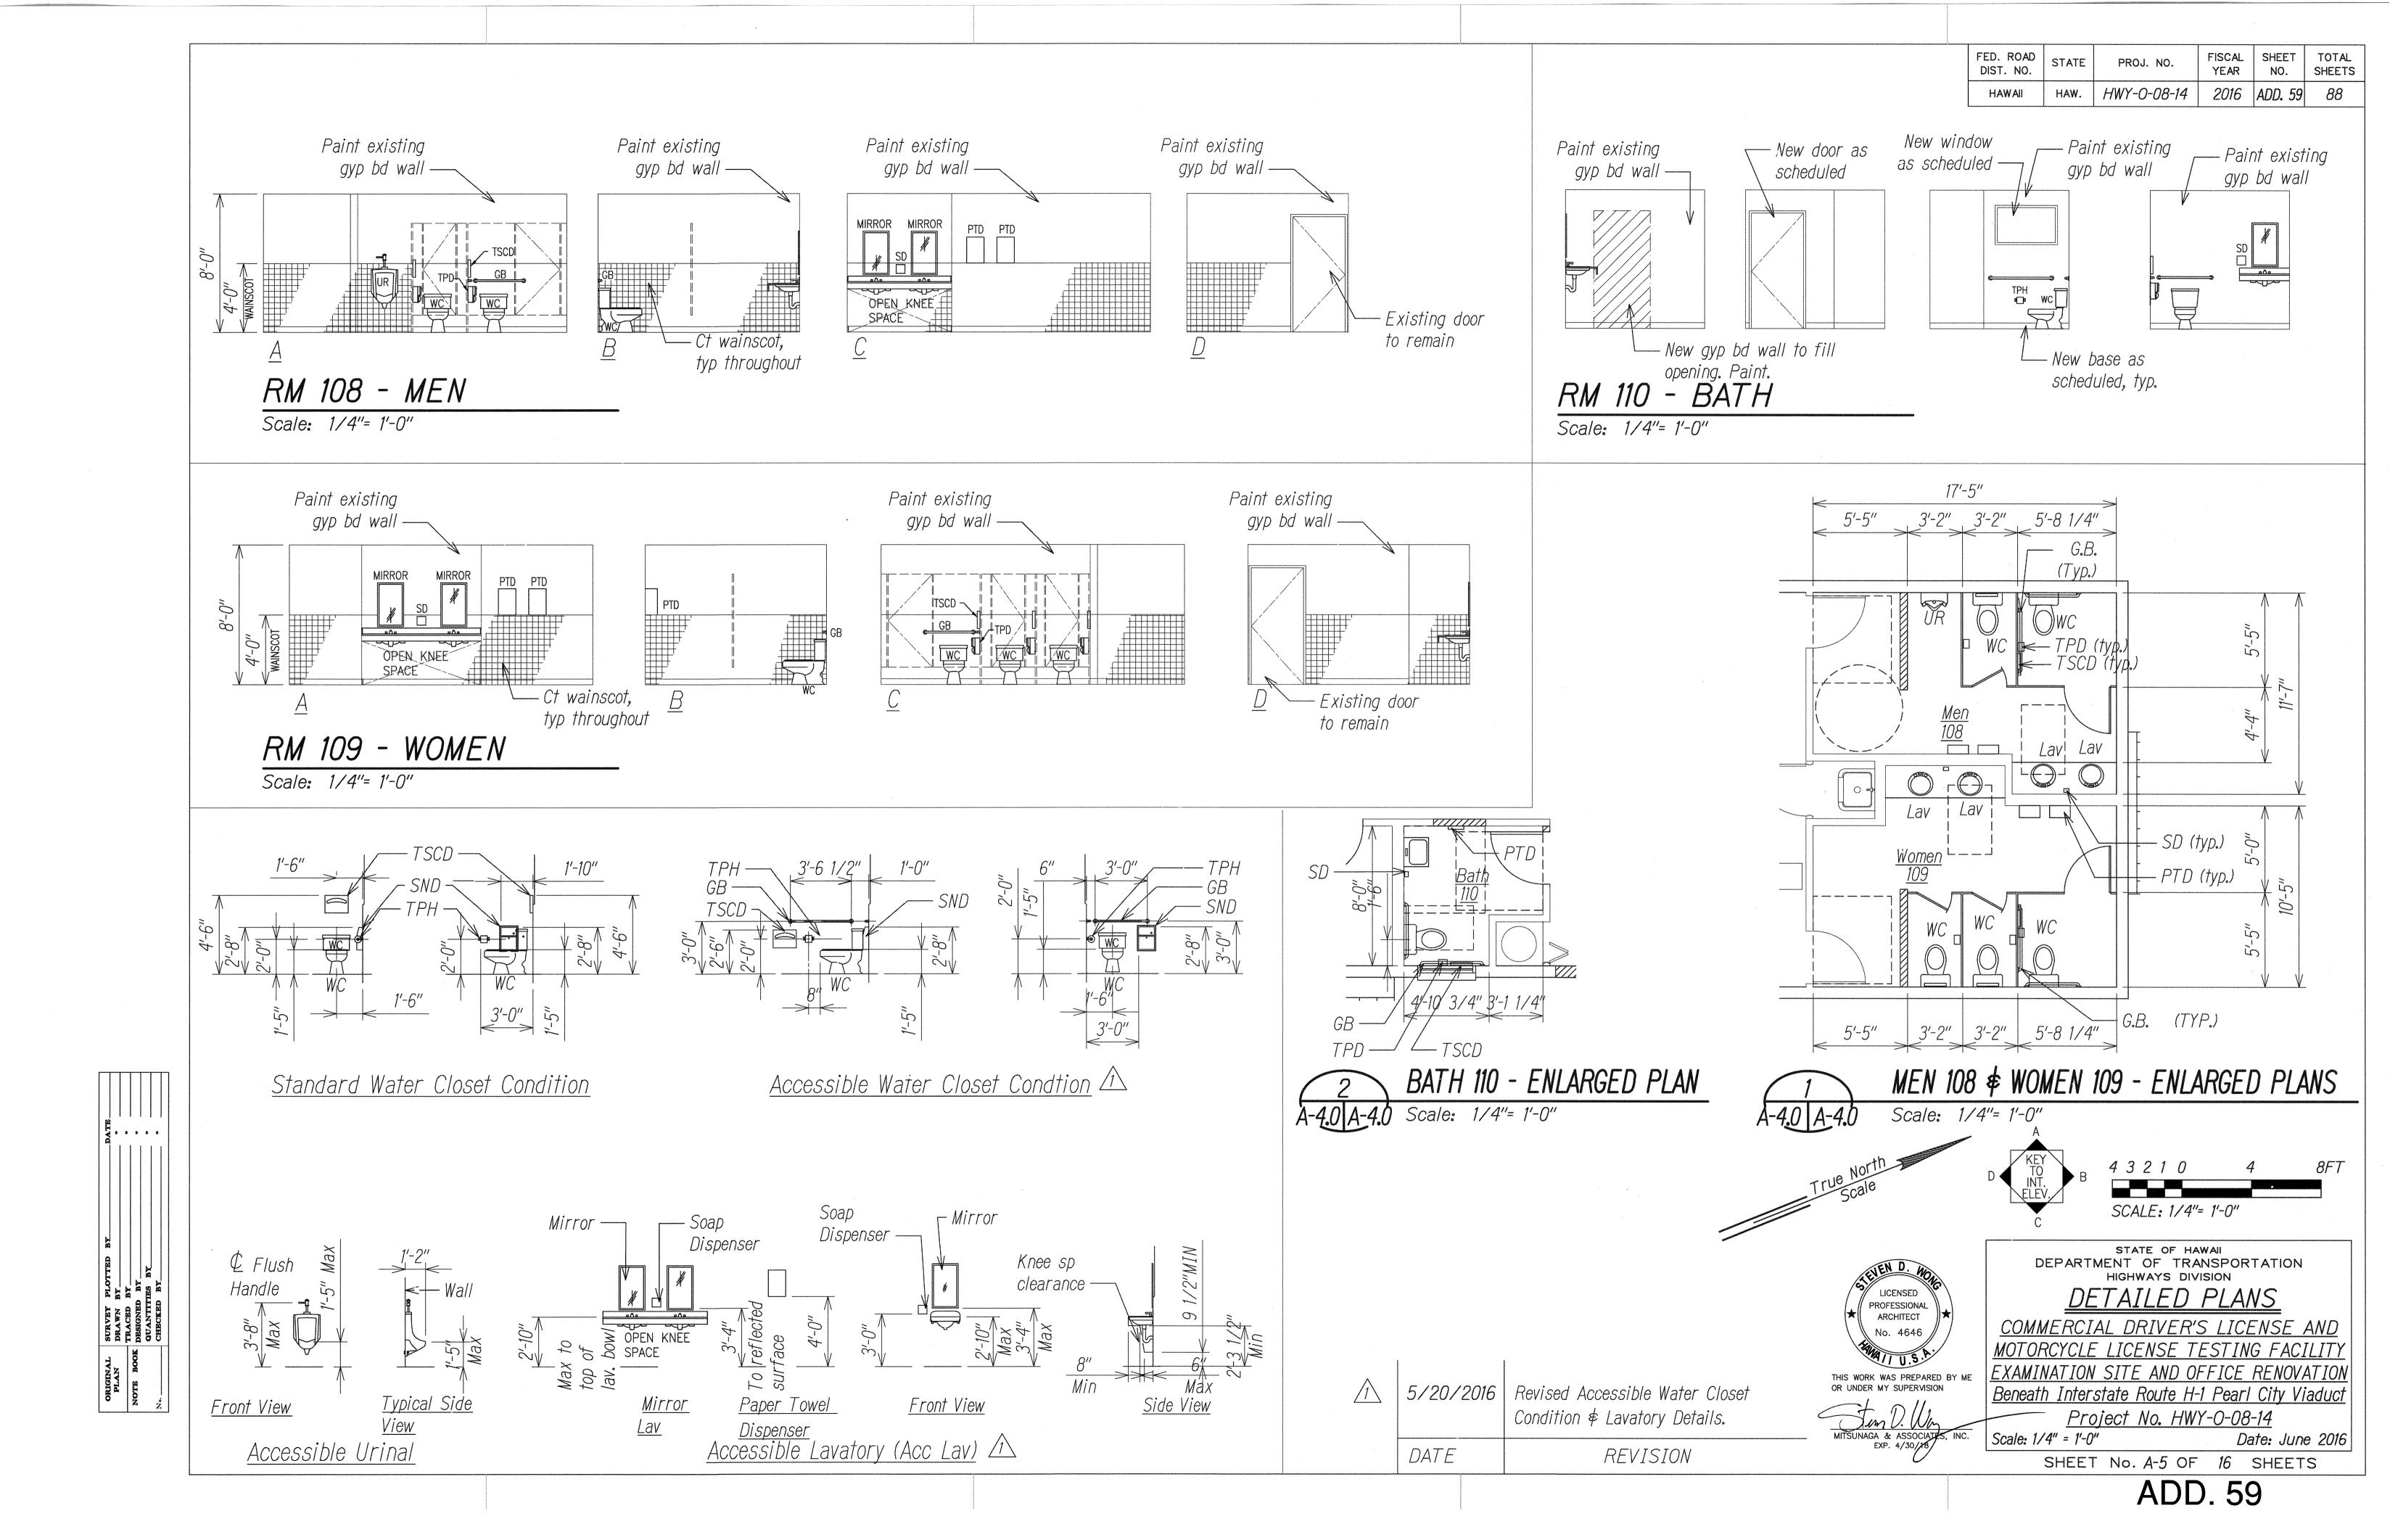


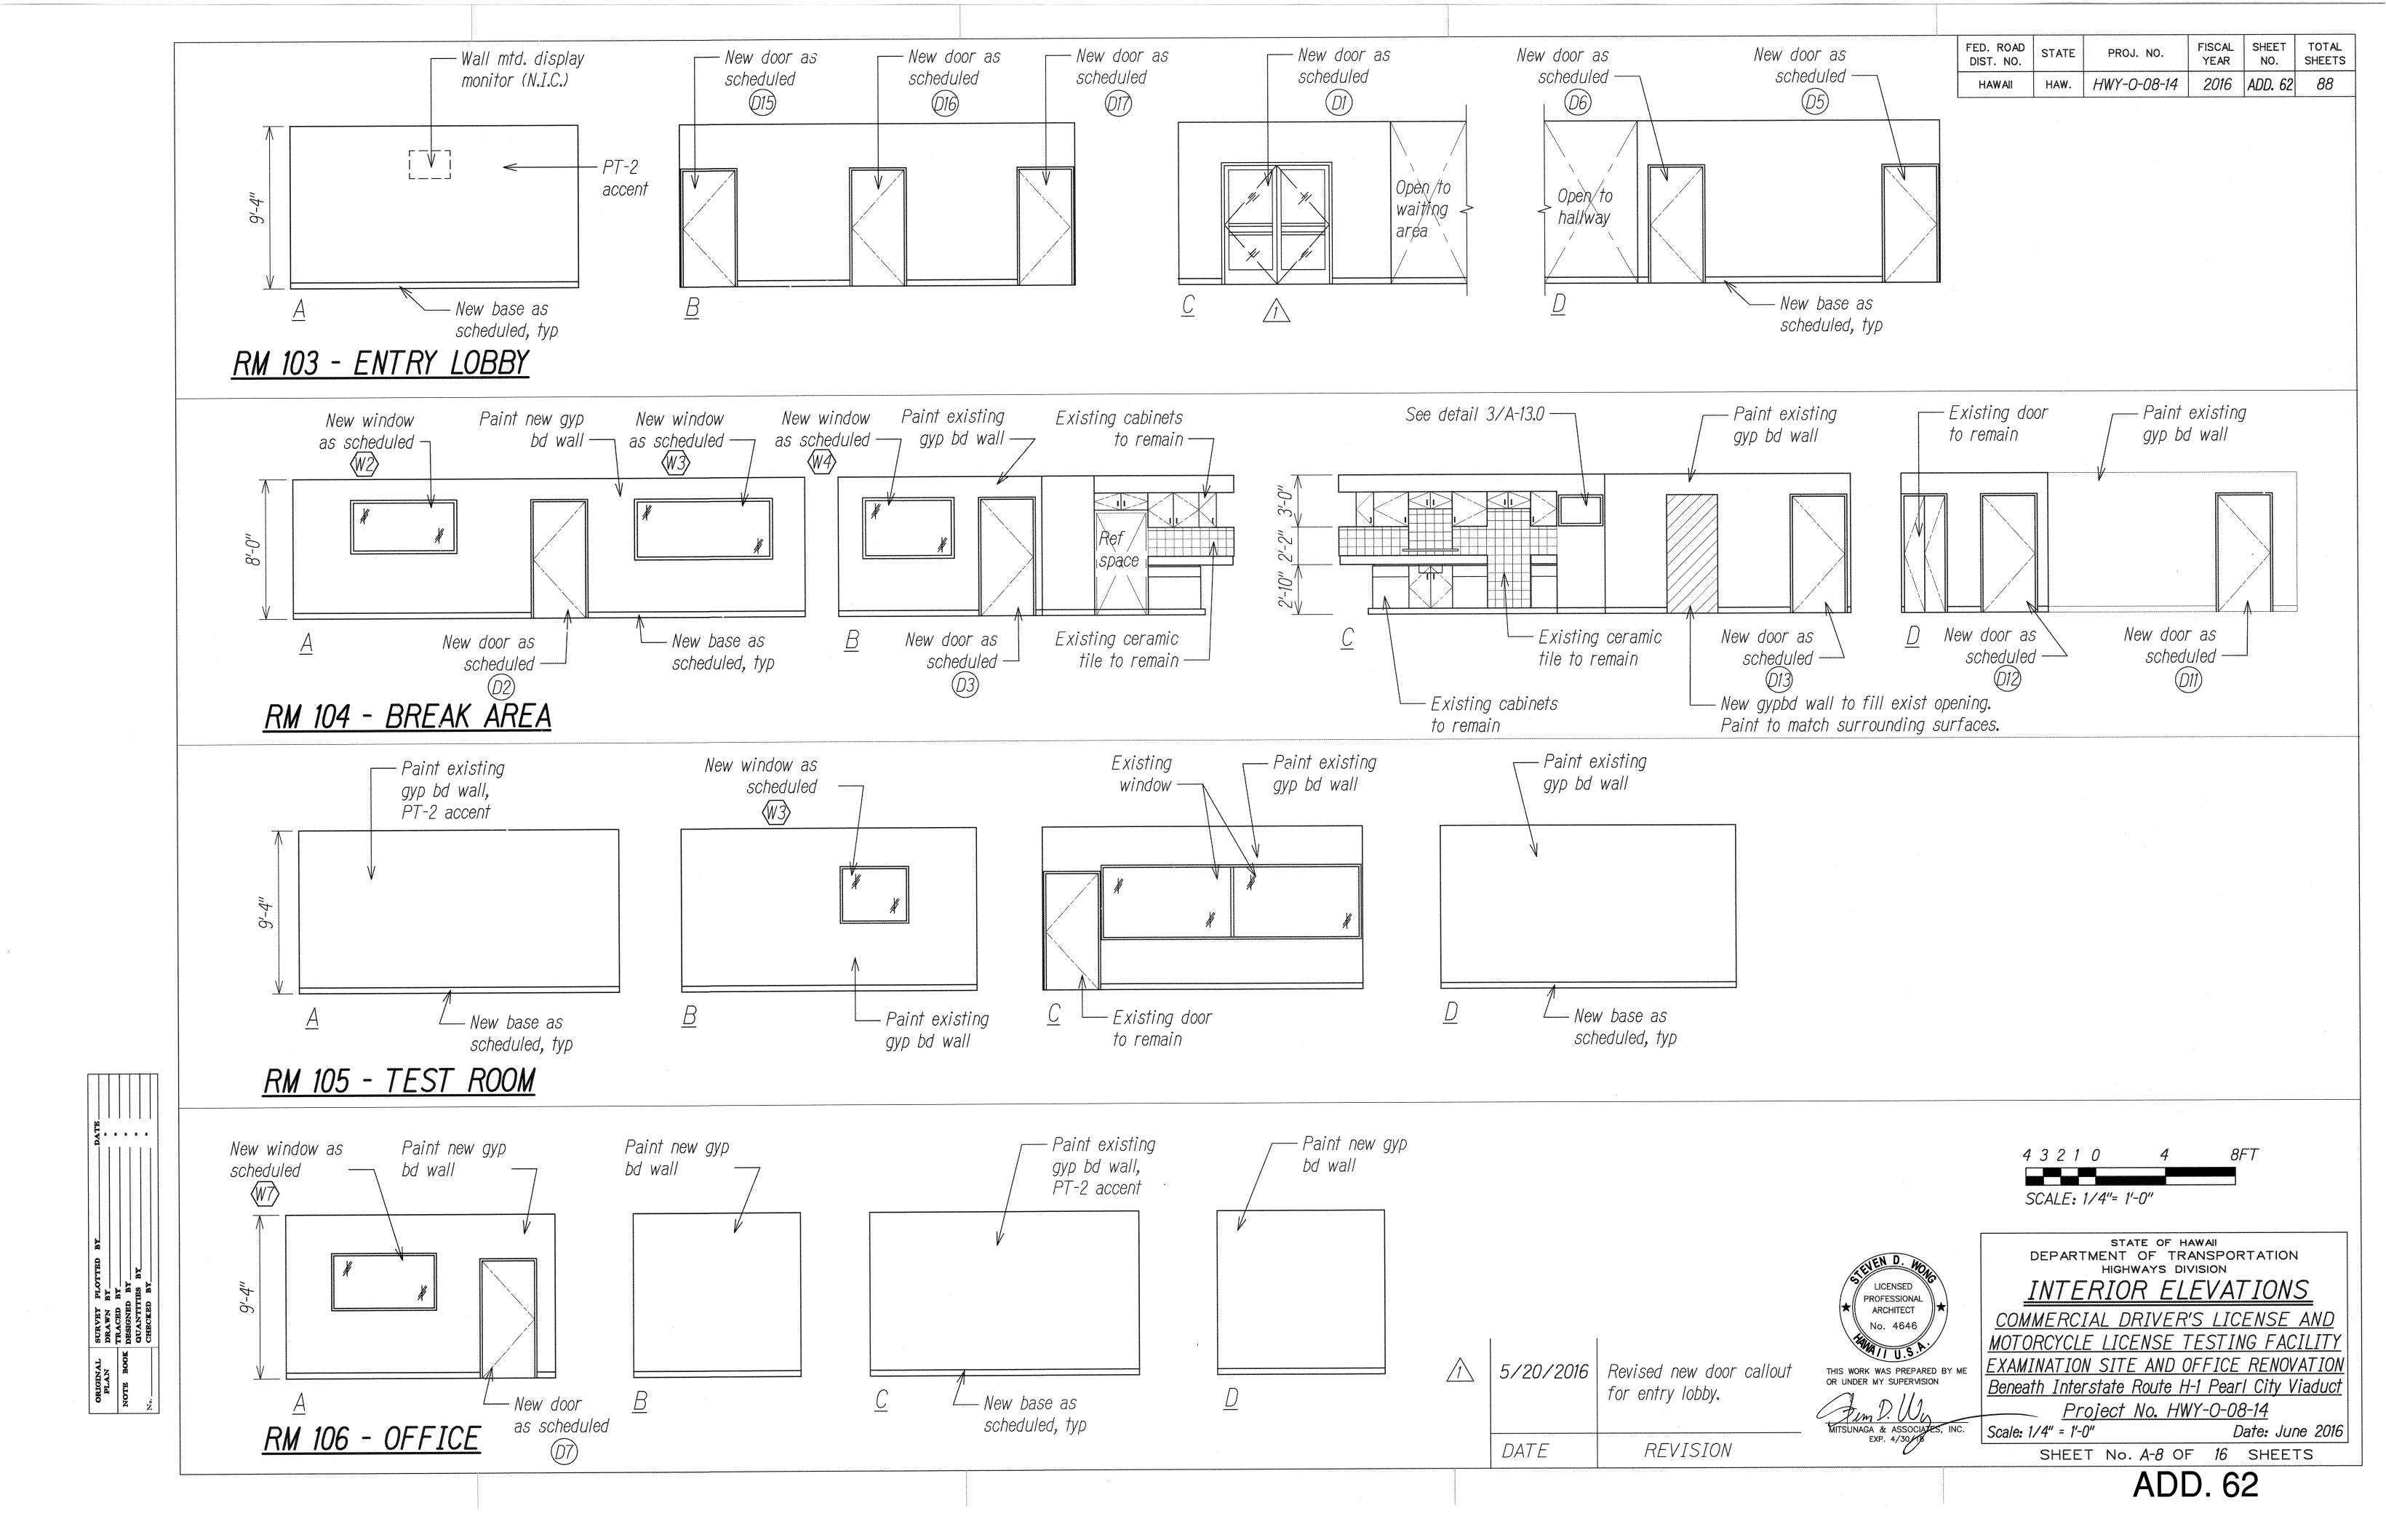Door Types

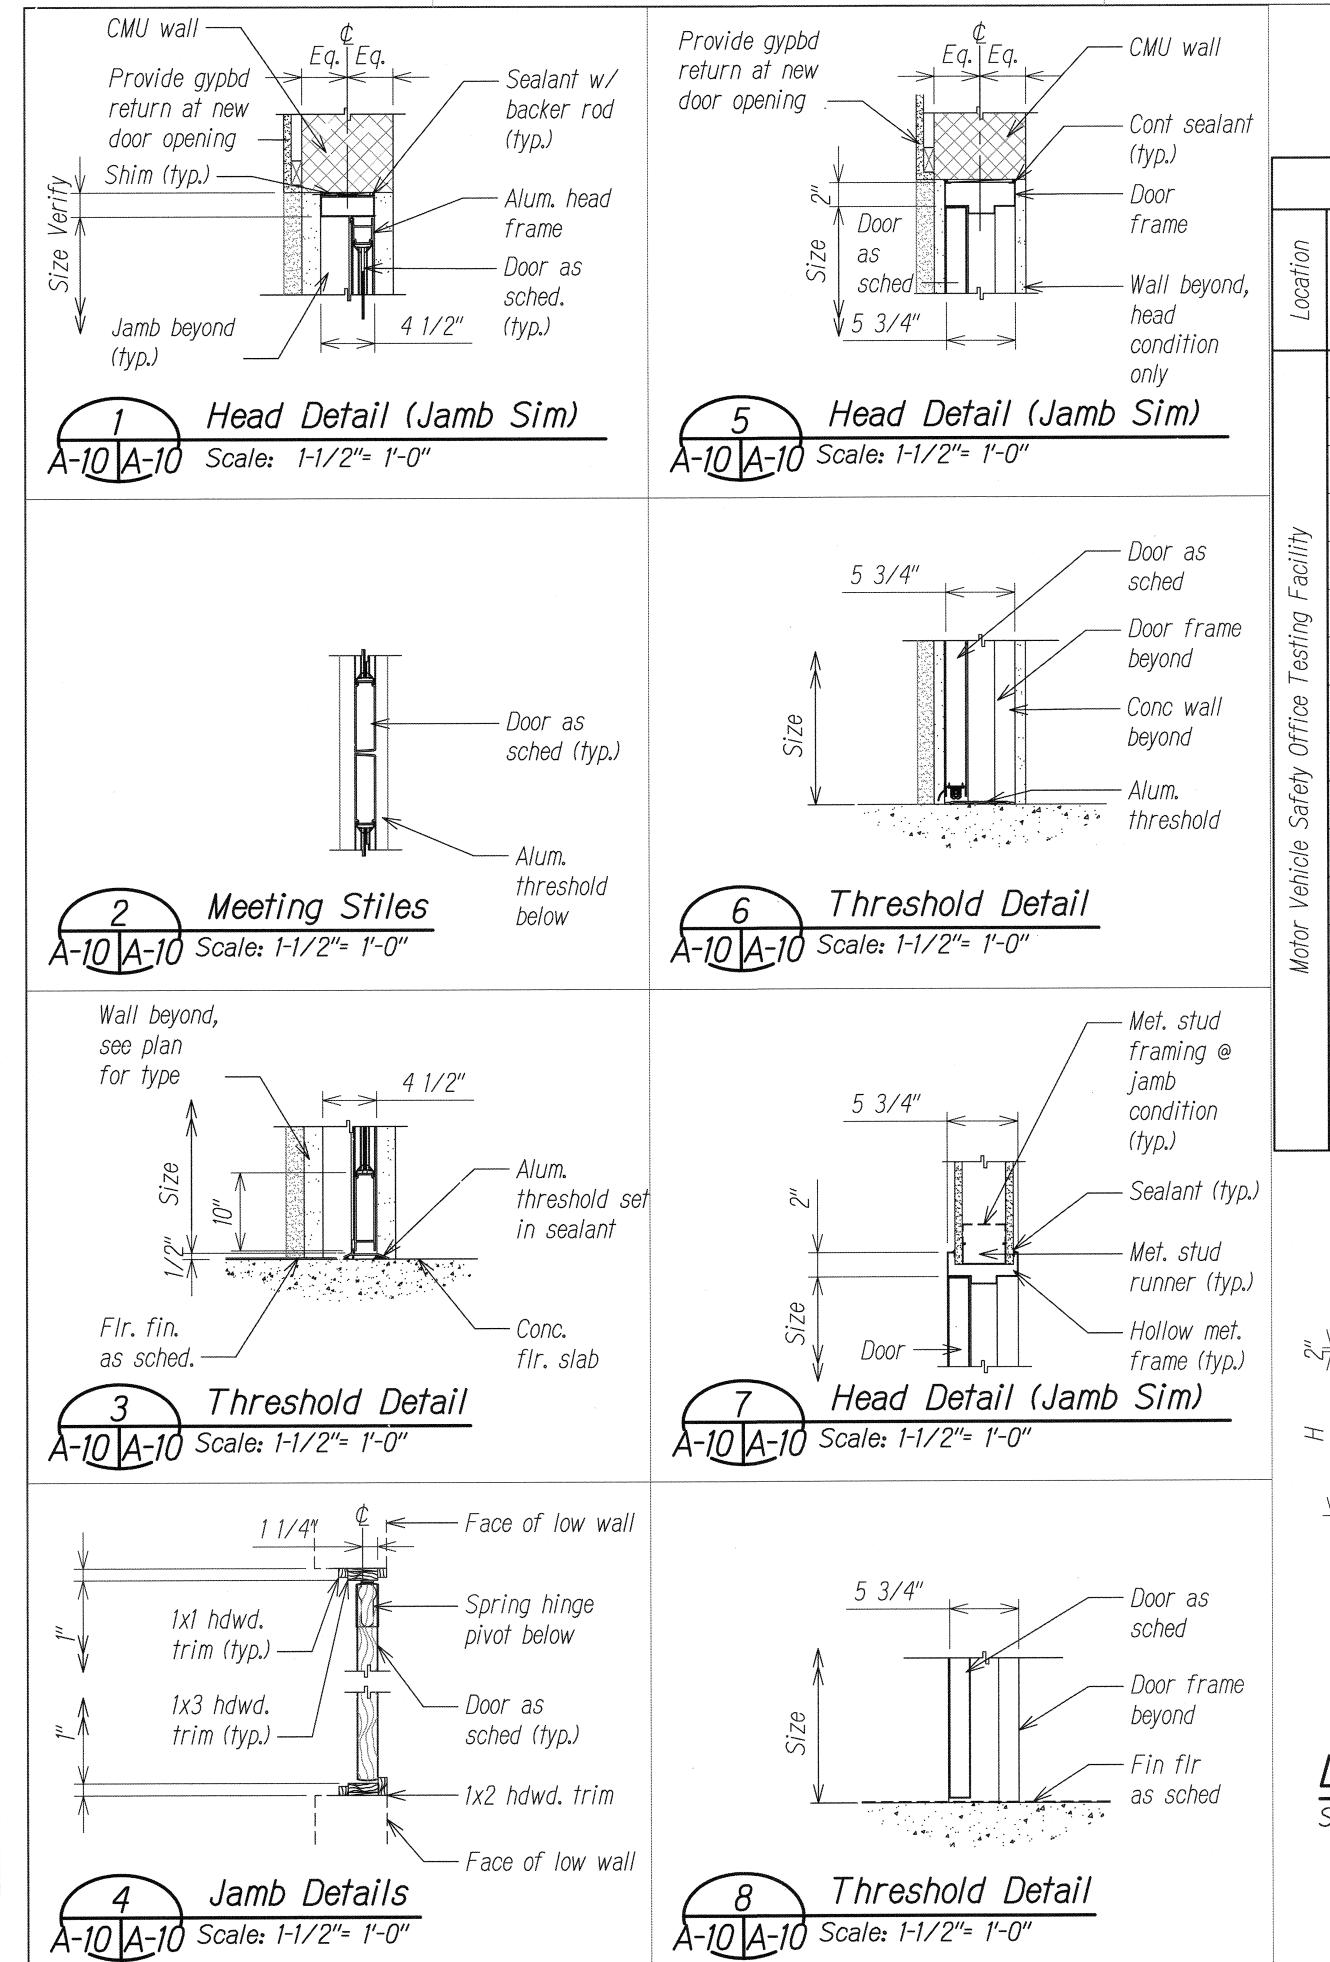Scale: 1/4"= 1'-0"

5/20/2016 Added dimension for Aluminum Storefront Door.


DATE REVISION

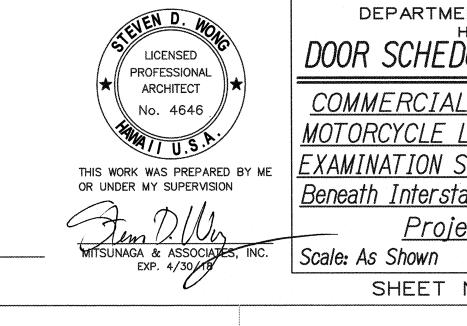


DEPARTMENT OF TRANSPORTATION
HIGHWAYS DIVISION
DOOR SCHEDULES, TYPES, & DETAILS

COMMERCIAL DRIVER'S LICENSE AND MOTORCYCLE LICENSE TESTING FACILITY EXAMINATION SITE AND OFFICE RENOVATION Beneath Interstate Route H-1 Pearl City Viaduct

Project No. HWY-0-08-14
As Shown Date: June 2016
SHEET No. A-11 OF 16 SHEETS

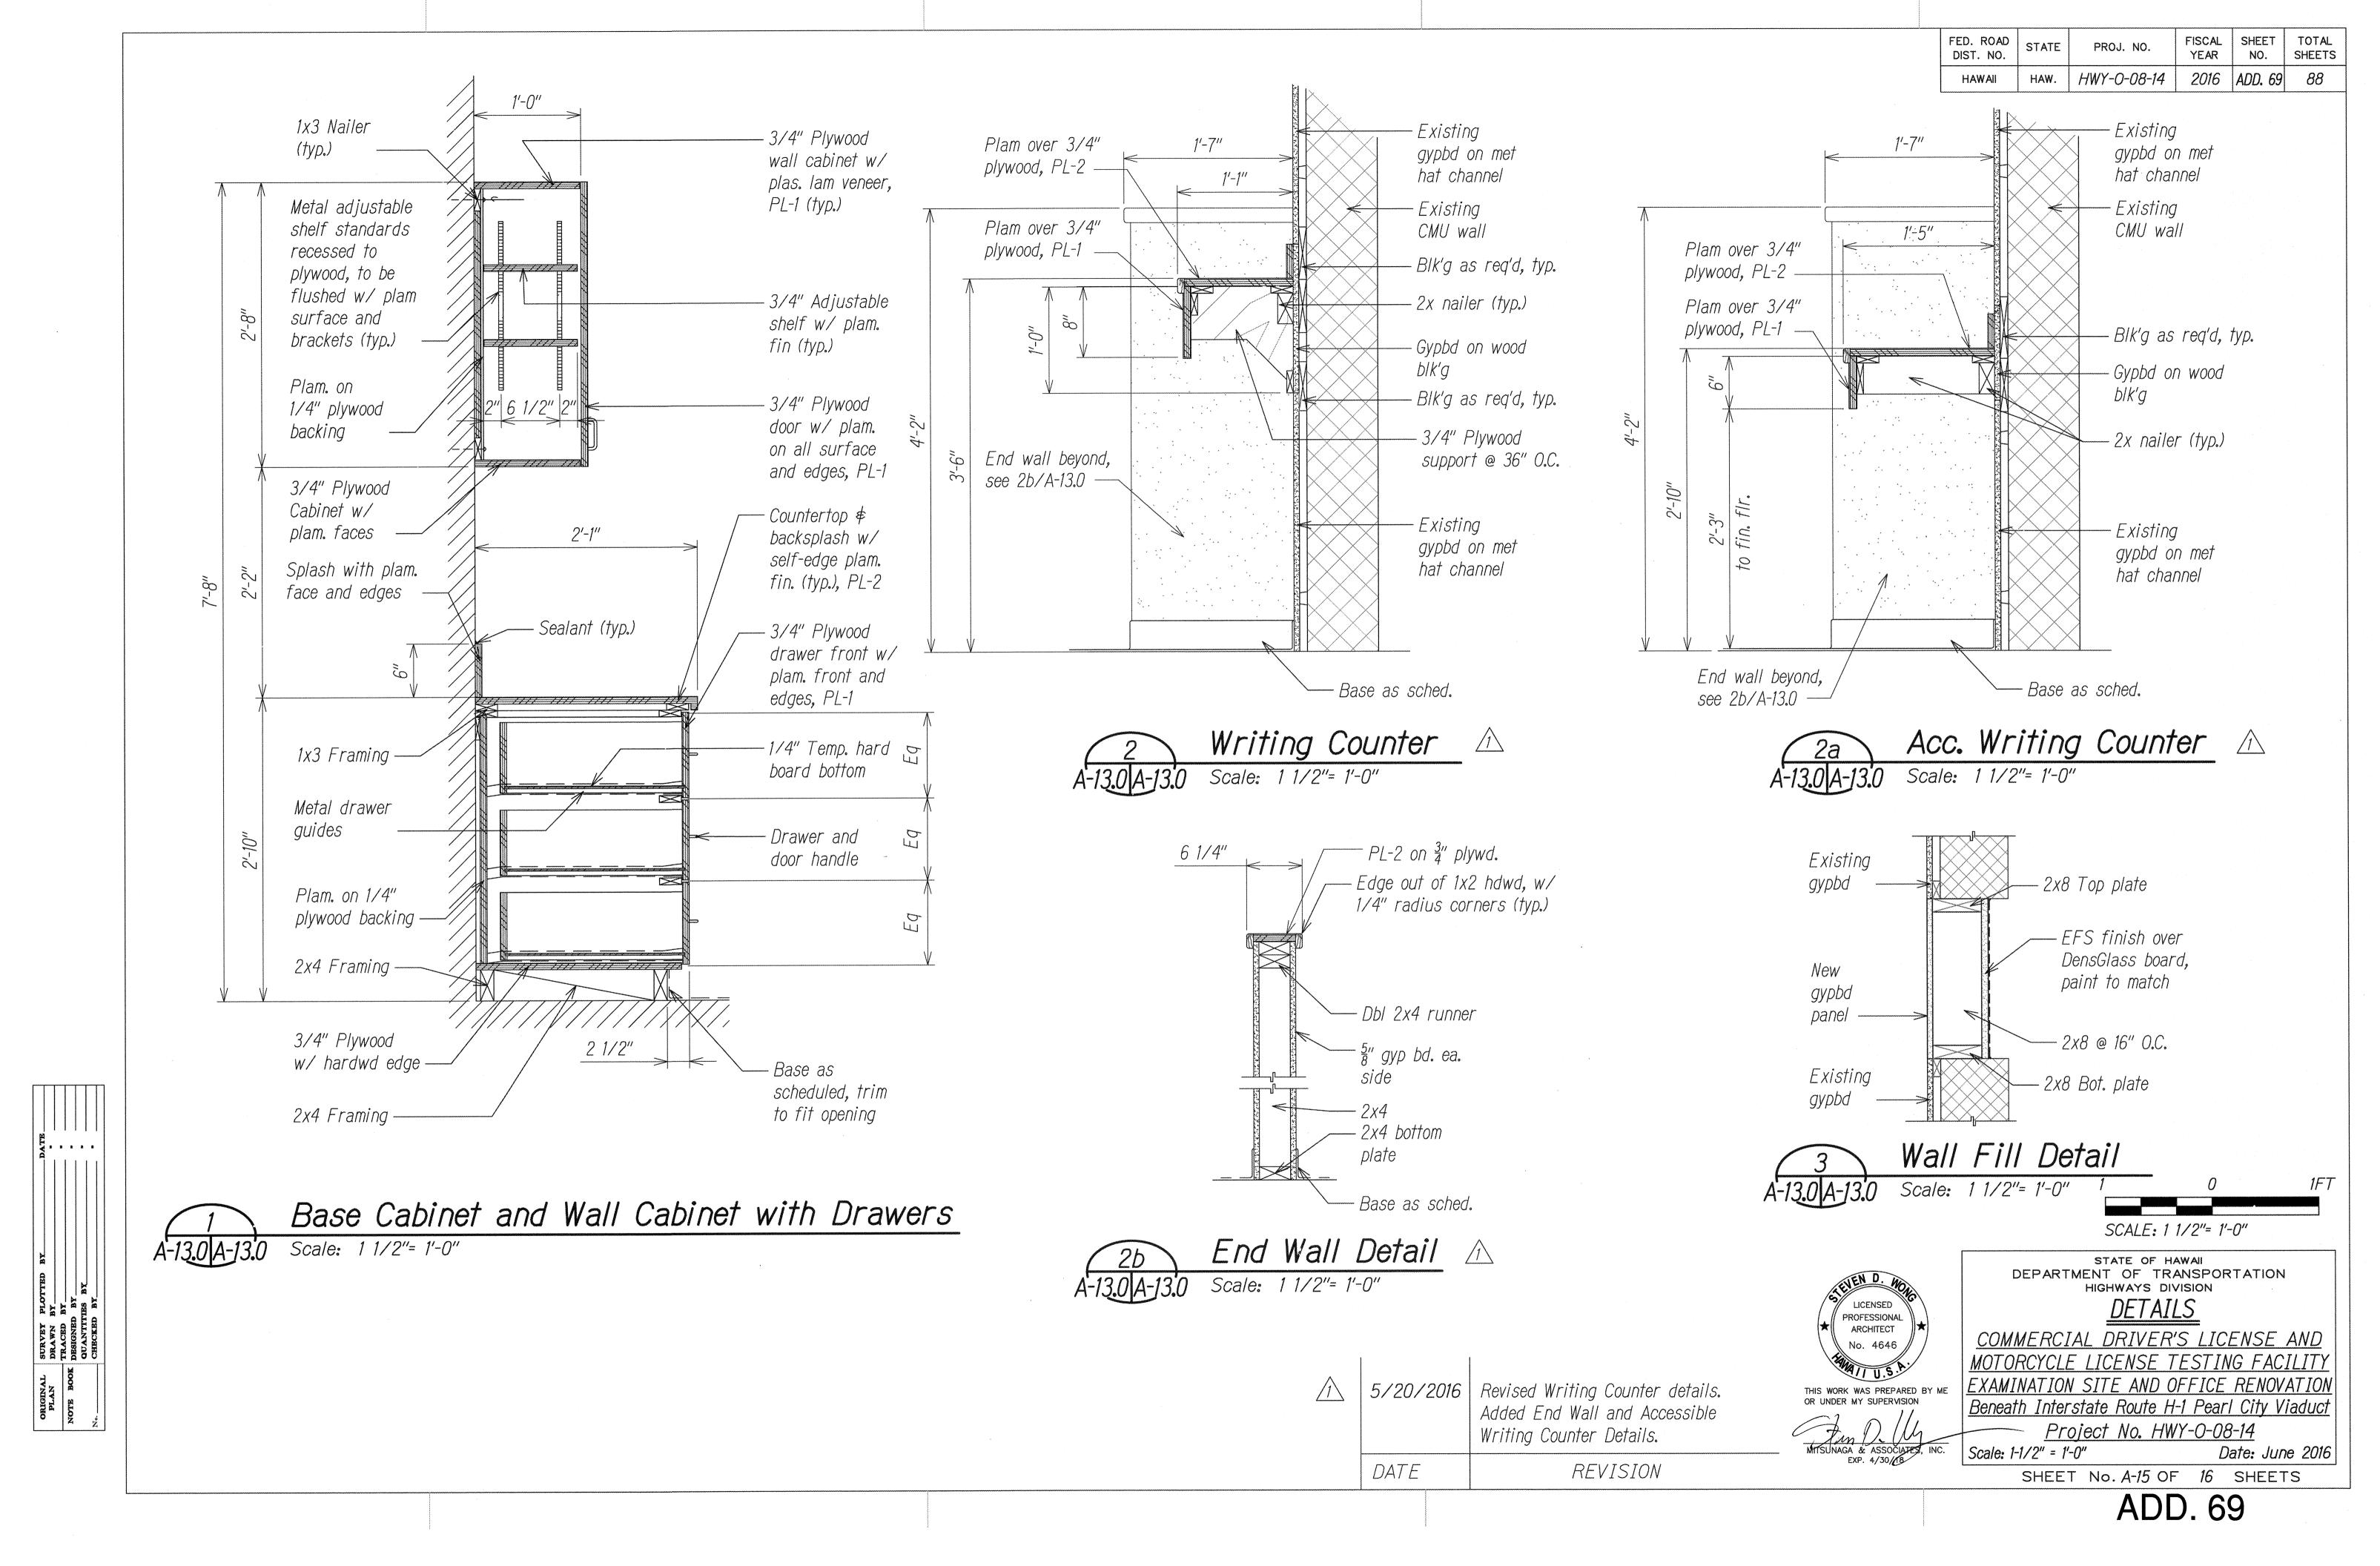


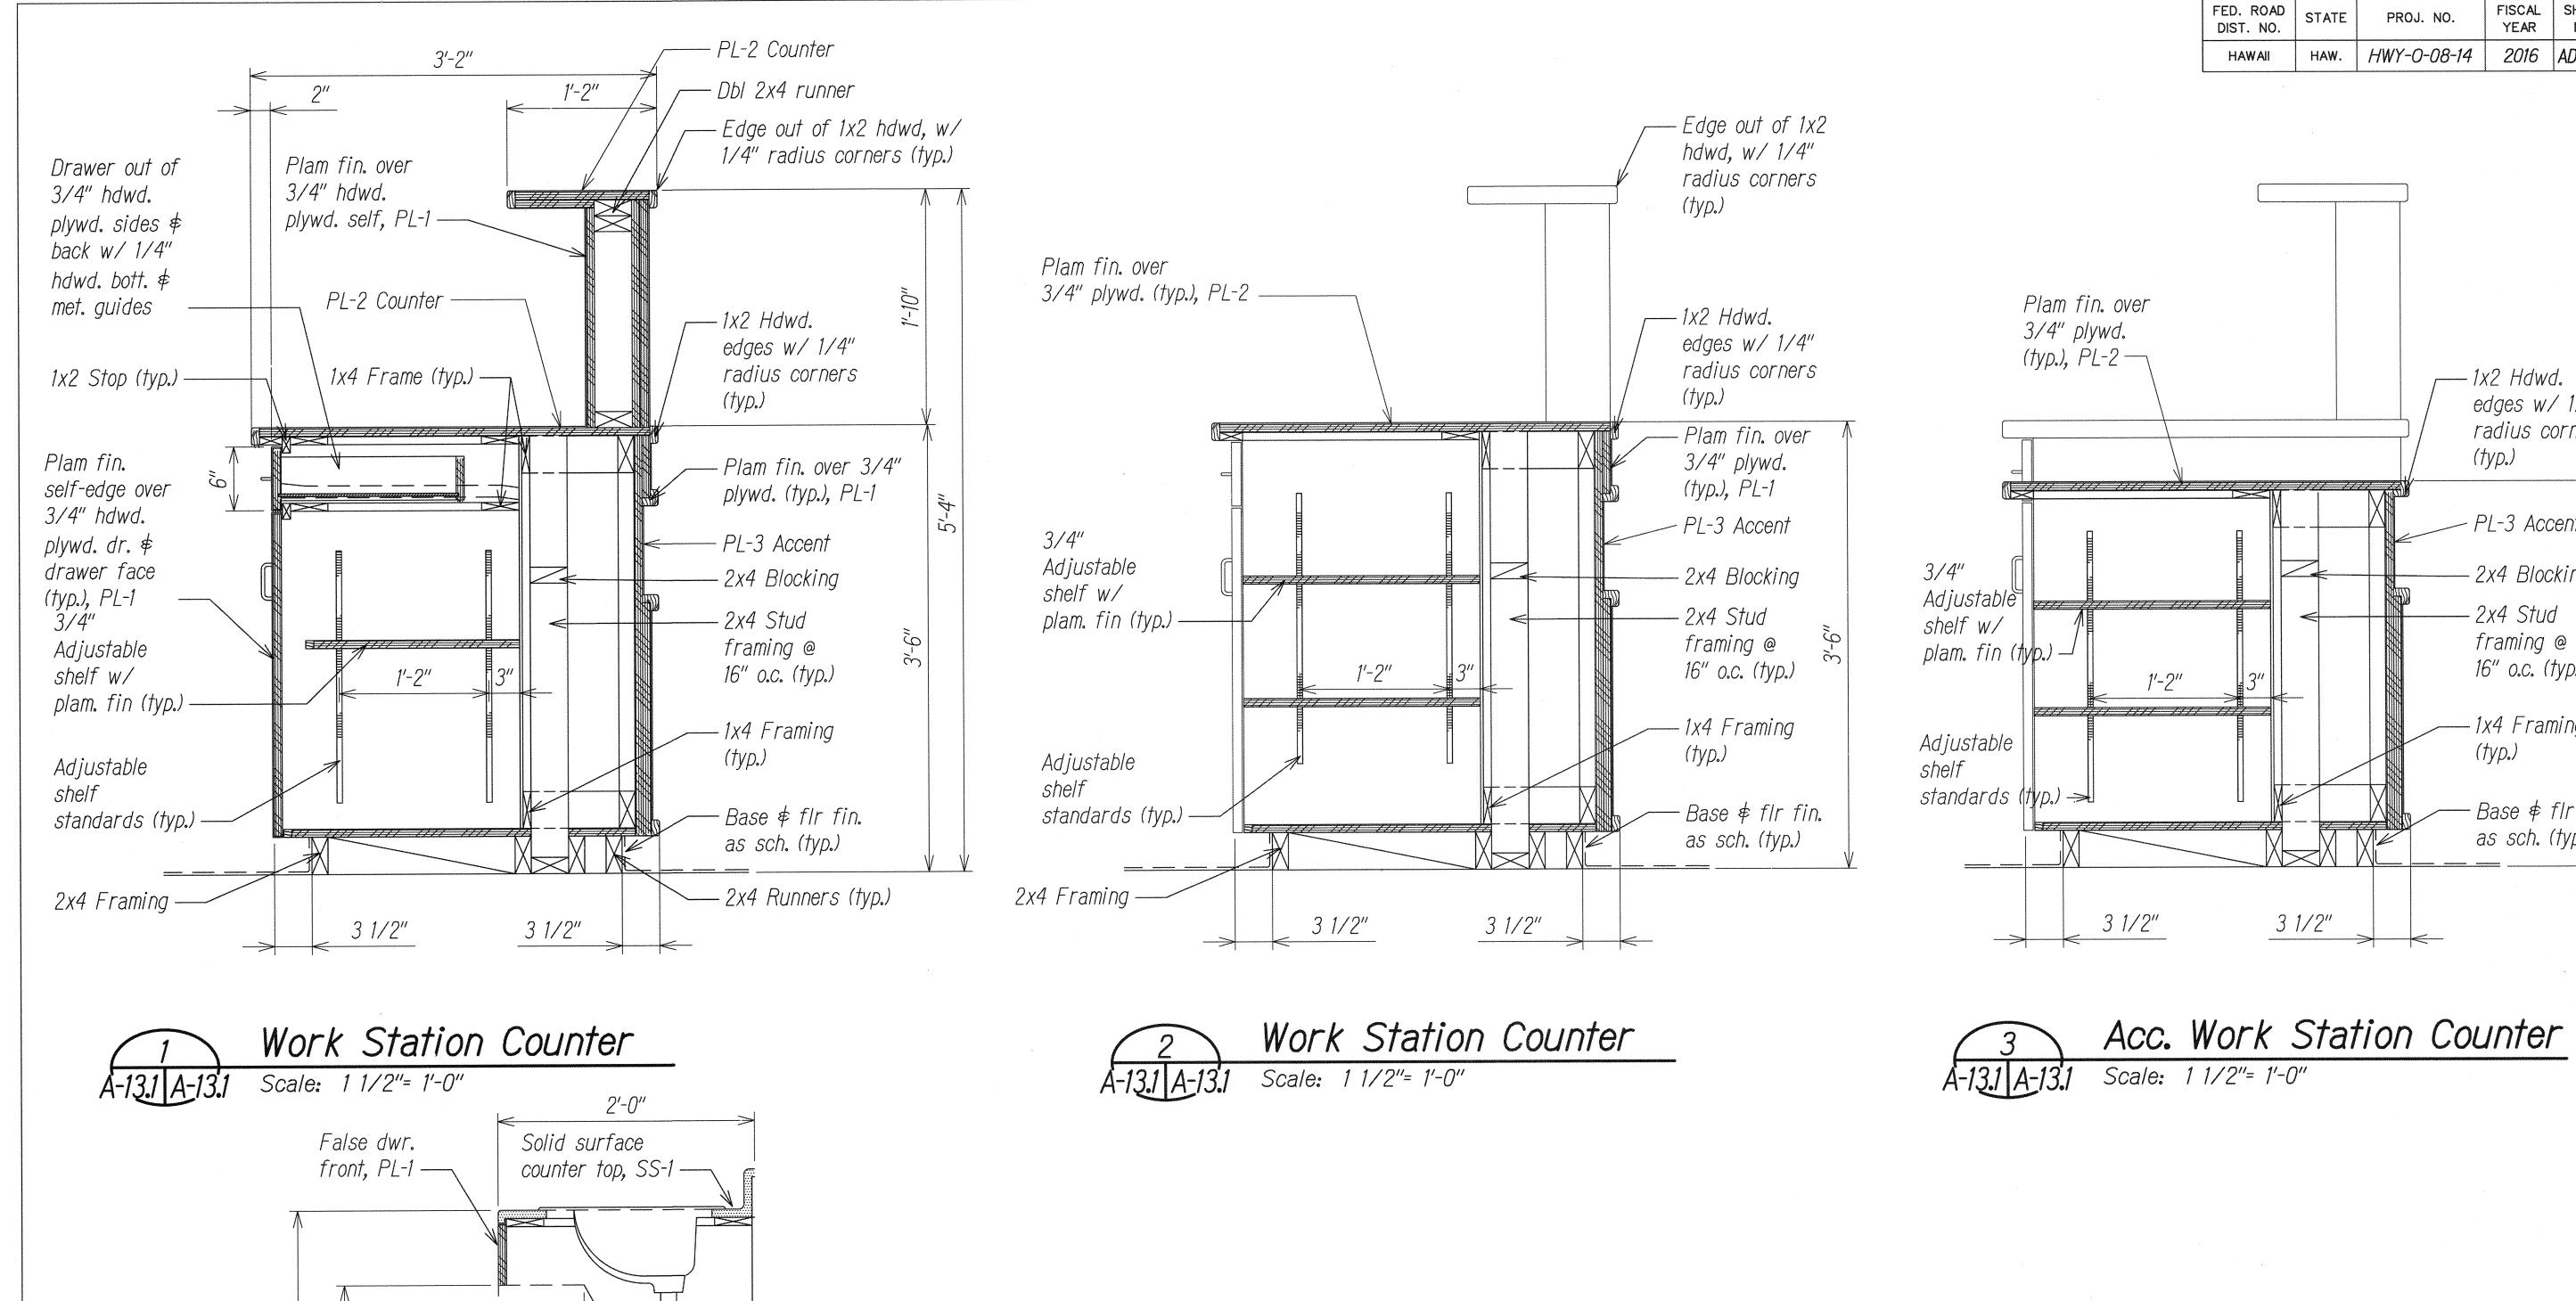

Dashed lines


denotes knee


clearance

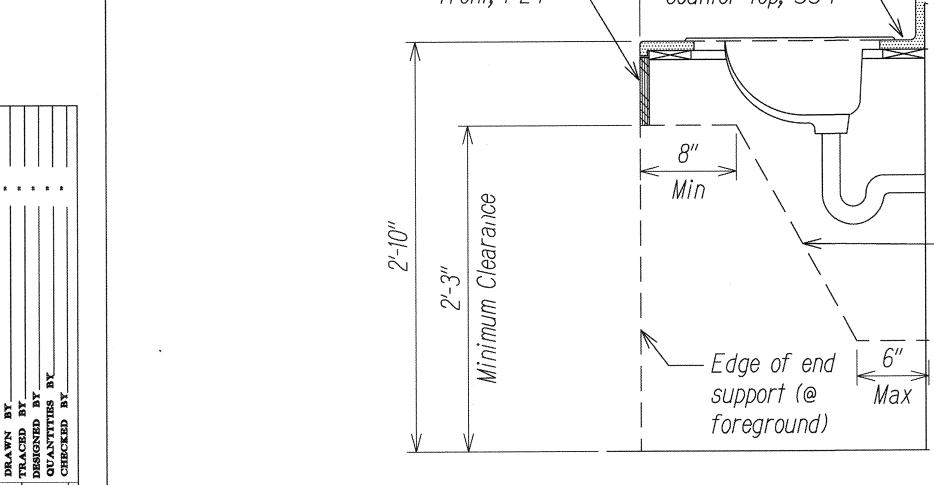

Lav Vanity Section

Scale: 1 1/2"= 1'-0"

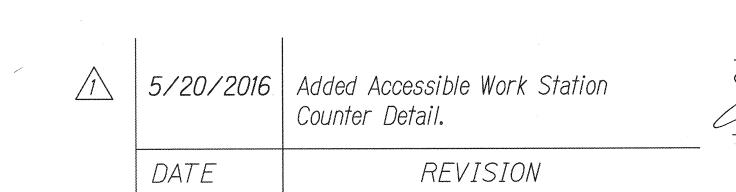

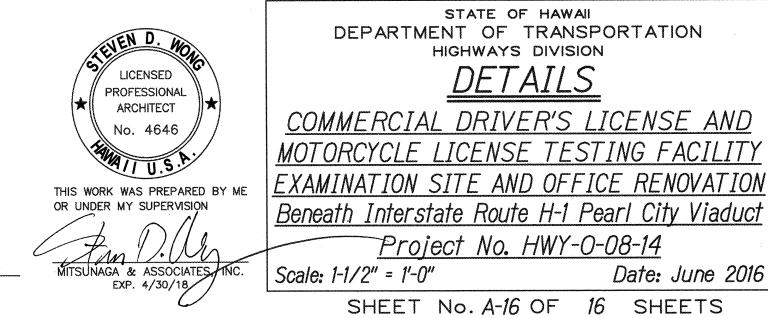

SCALE: 1 1/2"= 1'-0"

ADD. 70

Date: June 2016

FISCAL SHEET TOTAL YEAR NO. SHEETS

2016 ADD. 70 88

— 1x2 Hdwd.

(typ.)

edges w/ 1/4"

radius corners

PL-3 Accent

- 2x4 Blocking

- 2x4 Stud

framing @

16" o.c. (typ.)

-1x4 Framing

-Base \notin fin.

as sch. (typ.)

(typ.)

PROJ. NO.

-	101001	9
Symbol	ABBREV.	DESCRIPTION
	S OR W	Soil, sewer or waste piping below floor or grade
	(E)S OR (E)W	Existing soil, sewer or waste piping below floor or grade
	V	Vent piping
	(E)V	Existing vent piping
	CW	Cold water piping
	(E)CW	Existing cold water piping
#000000000 #0000 #0000	HW	Hot water piping
***************************************	(E)HW	Existing hot water piping
	(N)	New
	OU	Outdoor unit
	ACCU	Air-cooled condensing unit
I L	CO; WCO	Cleanout; wall cleanout
<u></u>	COTG; FCO	Cleanout to grade; floor cleanout
Ψ		
	D D	Condensate drain Refrigerant piping
R	R_{i}	Refrigerant piping
{ 12/8 }		Ductwork (first size side shown)
	CD	Ceiling diffuser
	BWS	Board of water supply
	EA	Exhaust air
	EF	Exhaust fan
	EXH.	Exhaust
	(E) OR EXIST.	Existing
	FC	Flexible connection
	FCU	Fan coil unit
	FD	Floor drain
+-	HB	Hose bibb
	IU	Indoor unit
	KS	Kitchen sink
	SK	Sink
	A-LAV	Accessible lavatory
	LAV	Lavatory
<u> </u>	VD	Manual volume damper
	OA	Outside air
(T)		Thermostat
	RA	Return air
	RAR	Return air register
K	SA	Supply air
	S.P.	Static pressure
) · · · ·	Union
. 11	VTR	Vent thru roof
	W/	With
	WC A-WC	Water closet
	A-WC	Accessible water closet
	UR	Urinal
	POR	Point of removal
	POC	Point of connection

Mechanical Legend

General Notes:

- The contractor shall verify all conditions prior to fabrication, installation and commencement of all work to be performed. Coordinate all work to be performed with other trades. Contractor shall notify contracting officer of any major deviations or discrepancies in the plans and specifications.
- 2. The entire installation shall comply with all applicable requirements, including all amendments, of the building code of the City and County of Honolulu, State Department of Health Regulations, Uniform Plumbing Code, Uniform Fire Code and all other agencies having jurisdiction.
- 3. The drawings and specifications are intended to cover the complete installation of systems to function as described and specified. The omission of reference to any necessary item of labor or material shall not relieve the contractor from providing such labor and material.
- 4. All equipment shall be capable of fitting into the spaces allocated while meeting the manufacturer's recommended access/clearance requirements.
- 5. Verify and coordinate all wall, floor and roof penetrations.
- Contractor shall coordinate all work with other trades and field conditions affected by this installation prior to, commencing and during construction.
- 7. Tone and/or scope to locate existing under slab waste and vent piping to verify location prior to saw cutting of existing concrete slab.
- 8. Tone and locate all utility lines or other interferences in areas of proposed trench work prior to start of excavation.
- 9. Drawings do not attempt to show exact details of piping and ductwork. Provide offsets as necessary to avoid local obstructions or interference with other trades. Review all piping and duct runs prior to fabrication and immediately notify the contracting officer of any interference and/or lack of adequate clearances.
- 10. Should project conditions require rearrangement of work, mark such changes on the as-built drawings. If these changes require alternate methods to those approved by the contract drawings, submit shop drawings showing the proposed alternate methods to the contracting officer for review. Do not proceed until review.
- 11. The contractor shall provide seismic restraints for mechanical systems in accordance with the building code. The contractor shall acquire the services of a licensed structural engineer and provide all required calculations to determine the required bracing, if a seismic restraint vendor is used, the vendor's calculations shall be verified by a licensed structural engineer.
- 12. Structures undergoing construction, alteration, or demolition including those in underground locations, shall comply with NFPA 241 and NFPA 1-2006.

Plumbing Fixture Connection Schedule								
Fixture	Waste (in.)	Vent (in.)	Cw (in.)	HW (IN.)	Remarks			
Water closet (F.T.)	3	2	1/2					
Urinal	2	2	3/4	-				
Lavatory	2	2	1/2					
Floor drain	2	2	_					
2-Comp. Kitchen sink	2	2	1/2	1/2				

FED. ROAD DIST. NO.	STATE	PROJ. NO.	FISCAL YEAR	SHEET NO.	TOTAL SHEETS
HAWAII	HAW.	HWY-0-08-14	2016	ADD. 72	88


Demolition Plumbing Fixture Count										
Fixture Quantity F.U. (ea.) Total										
Water Closet (F.T)	5	1.7	8.5							
Lavatory	5	0.6	3.0							
Urinal	2	1.7	3.4							
Tub/shower	1, 1,	1.6	1.6							
Total			16.5							

Proposed Plumbing Fixture Count				
Fixture	Quantity ,	F.U. (ea.)	Total	
Water closet (F.T.)	5	1.7	8. 5	
Lavatory	4	0.6	2.4	
Urinal	1	1.7	1.7	
Trap primer	2	0.6	1.2	
Total			13.8	

B.W.S. Flow Requirements Premise ID#: 7882014984 Meter number (M/N): 110-31679					
Proposed domestic	13.8 F.U.'S	11 GPM'S	350 GPD'S		
Proposed irrigation	F.U.'S	GPM'S	GPD'S		
Other	F.U.'S	GPM'S	GPD'S		
Total proposed	13.8 F.U.'S	<u>11</u> GPM'S	350 GPD'S		
Demolition Demo permit #	16.5 F.U.'S DATE:	<u>13</u> GPM'S	400 GPD'S		
Net change	-2.7 F.U.'S	3 GPM'S	70 GPD'S		
Existing to remain	6.7 F.U.'S	6 GPM'S	60 GPD'S		
Grand total	20.5 F.U.'S	15 GPM'S	410 GPD'S		

Existing water meter does not serve automatic fire sprinkler. Irrigation performed during off peak hours.

A/C Work will not affect water demand.

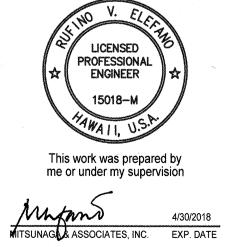

NOTE: Contractor to check and verify dimensions at job before

DEPARTMENT OF TRANSPORTATION NOTES AND LEGEND

STATE OF HAWAII

COMMERCIAL DRIVER'S LICENSE AND MOTORCYCLE LICENSE TESTING FACILITY

> Beneath Interstate Route H-1 Pearl City Viaduct Project No. HWY-0-08-14 Date: March 2016

EXAMINATION SITE AND OFFICE RENOVATION

6/2/2016 Added note. DATE REVISION