EXOI	INEVV			
~ - -O		Highway Light Standard		
	التا	Large Junction Box, Size as Noted on Plans		
۳۰۱	HJ	Wall Surface Mounted		
ΓŊ K J		HECO Transformer Pad		
\boxtimes		Traffic Signal Controller		
[]-	гъ	Metering Equipment & Support, See Detail On		
[]:	D D	Sheet A/E-10		
		Type "B" Metric Communication Pullbox,		
		(Approx. 28" X 40"), See State Standard Details TE-3		
		Type "A" Metric Electric Pullbox		
		(Approx. 22" X 28"), See Standard State Detail TE-3.		
	\boxtimes	Electrical Handhole		
	X	DOT Cabinet		
K 71		HECo Transformer		
	С	CCTV Equipment Cabinet		
	\otimes	CCTV Camera w/Pole		
	\sim	Conduit Riser		
		PVC Underground Ductline		
		Surface Mounted PVC Coated GRC Conduit		
—-е		Electrical/Signal Ductline with Designator,		
	·	Indicates Type "A" Duct Section with "2-4E"		
(2- 4)	A (1/5)	Ducts. See Sheet E-7 for Typ Duct Sections		
		and Conduit Schedule		
[>		Traffic Signal Head Mounted on Viaduct		
۲.		Type I Traffic Signal Standard with Traffic Signal		
O{>		Head.		
[<u>o</u>]		Type II Traffic Signal Standard with Traffic Signal		
>		Heads Mounted on Mast Arm and Standard;		
<u> </u>		Number of Traffic Signal Heads May Vary.		
		Type III Traffic Signal Standard with Traffic Signal		
(1-1>		Heads Mounted on Mast Arm and Standard,		
		Highway Light Luminaire and Bracket Arm.		
		Number of Traffic Signal Heads May Vary.		
<u>—е—</u>		Electrical Ductline		
t		Telephone Ductline		
—catv—		Cable Ductline		
irr		Irrigation Ductline		
W		Water Ductline		
s		Sewer Ductline		
		Drain Ductline		
g		Gas Ductline		
ts		Traffic Signal Ductline		
s/		Street Light Ductline		
—ts/s⊢		Traffic Signal & Street Light Ductline		
—eoh—		Overhead Lines		
— sig —	* (1 · · · · · · · · · · · · · · · · · ·	City & County Signal Ductline		
	<u> </u>	orly a country digital bactille		

ELECTRICAL SYMBOLS

DESCRIPTION

SYMBOL

NEW

EXST

SURVEY PLC DRAWN BY TRACED BY DESIGNED B' QUANTITIES

SYMBOL NOTES:

1. "X" Through Symbol Indicates Item to be Removed.

GENERAL ELECTRICAL NOTES

- 1. Electrical Work shall be New Unless Indicated Otherwise.
- 2. Existing Electrical Equipment shall Remain Unless Indicated Otherwise.
- 3. The Location of Existing Underground Utilities Shown on Plans are from Existing Records and are Approximations Only. Contractor shall Exercise Caution when Construction Crosses or is in Close Proximity to Existing Underground Utilities. Damages to Utility Companies' Existing Facilities shall be Repaired by the Respective Utility Company and Repair Costs shall be Paid by the Contractor at No Additional Cost to the State.
- 4. Communication Conduits to have a Minimum Bending Radii of 12".
- 5. Contractor to Route Conduit Under Exst. Ductlines at Same Depth.

EQUIPMENT SCHEDULE

The Hawaiian Electric Company (HECO) Pullboxes shall be Constructed as Shown in these Drawings & in Accordance with the Following Standard Drawings:

Туре

Description

2' x 4' Elec Pullbox

2' x 4' Precast Concrete Pullbox with Precast Concrete Cover, Provided in Accordance with HECO Standard Drawing No. 30-2005 Except with Elec Inscribed on Cover.

FED. ROAD STATE FEDERAL AID PROJ. NO. FISCAL SHEET TOTAL SHEETS

HAWAII HAW. IM-0300(127) 2011 34 60

NO. DATE REVISION

LICENSED PROFESSIONAL ENGINEER
No. 7637-E

HAWAII, U.S. P.


DEPARTMENT OF TRANSPORTATION
HIGHWAYS DIVISION


Symbol List

Freeway Management System, Phase 1C,
Part 1B: Installation of CCTV and
Communication Infrastructure
Federal Aid Project No. IM-0300(127)
SCALE: As Noted DATE: 9-7-11

SHEET No. E-1 OF 11 SHEETS

34

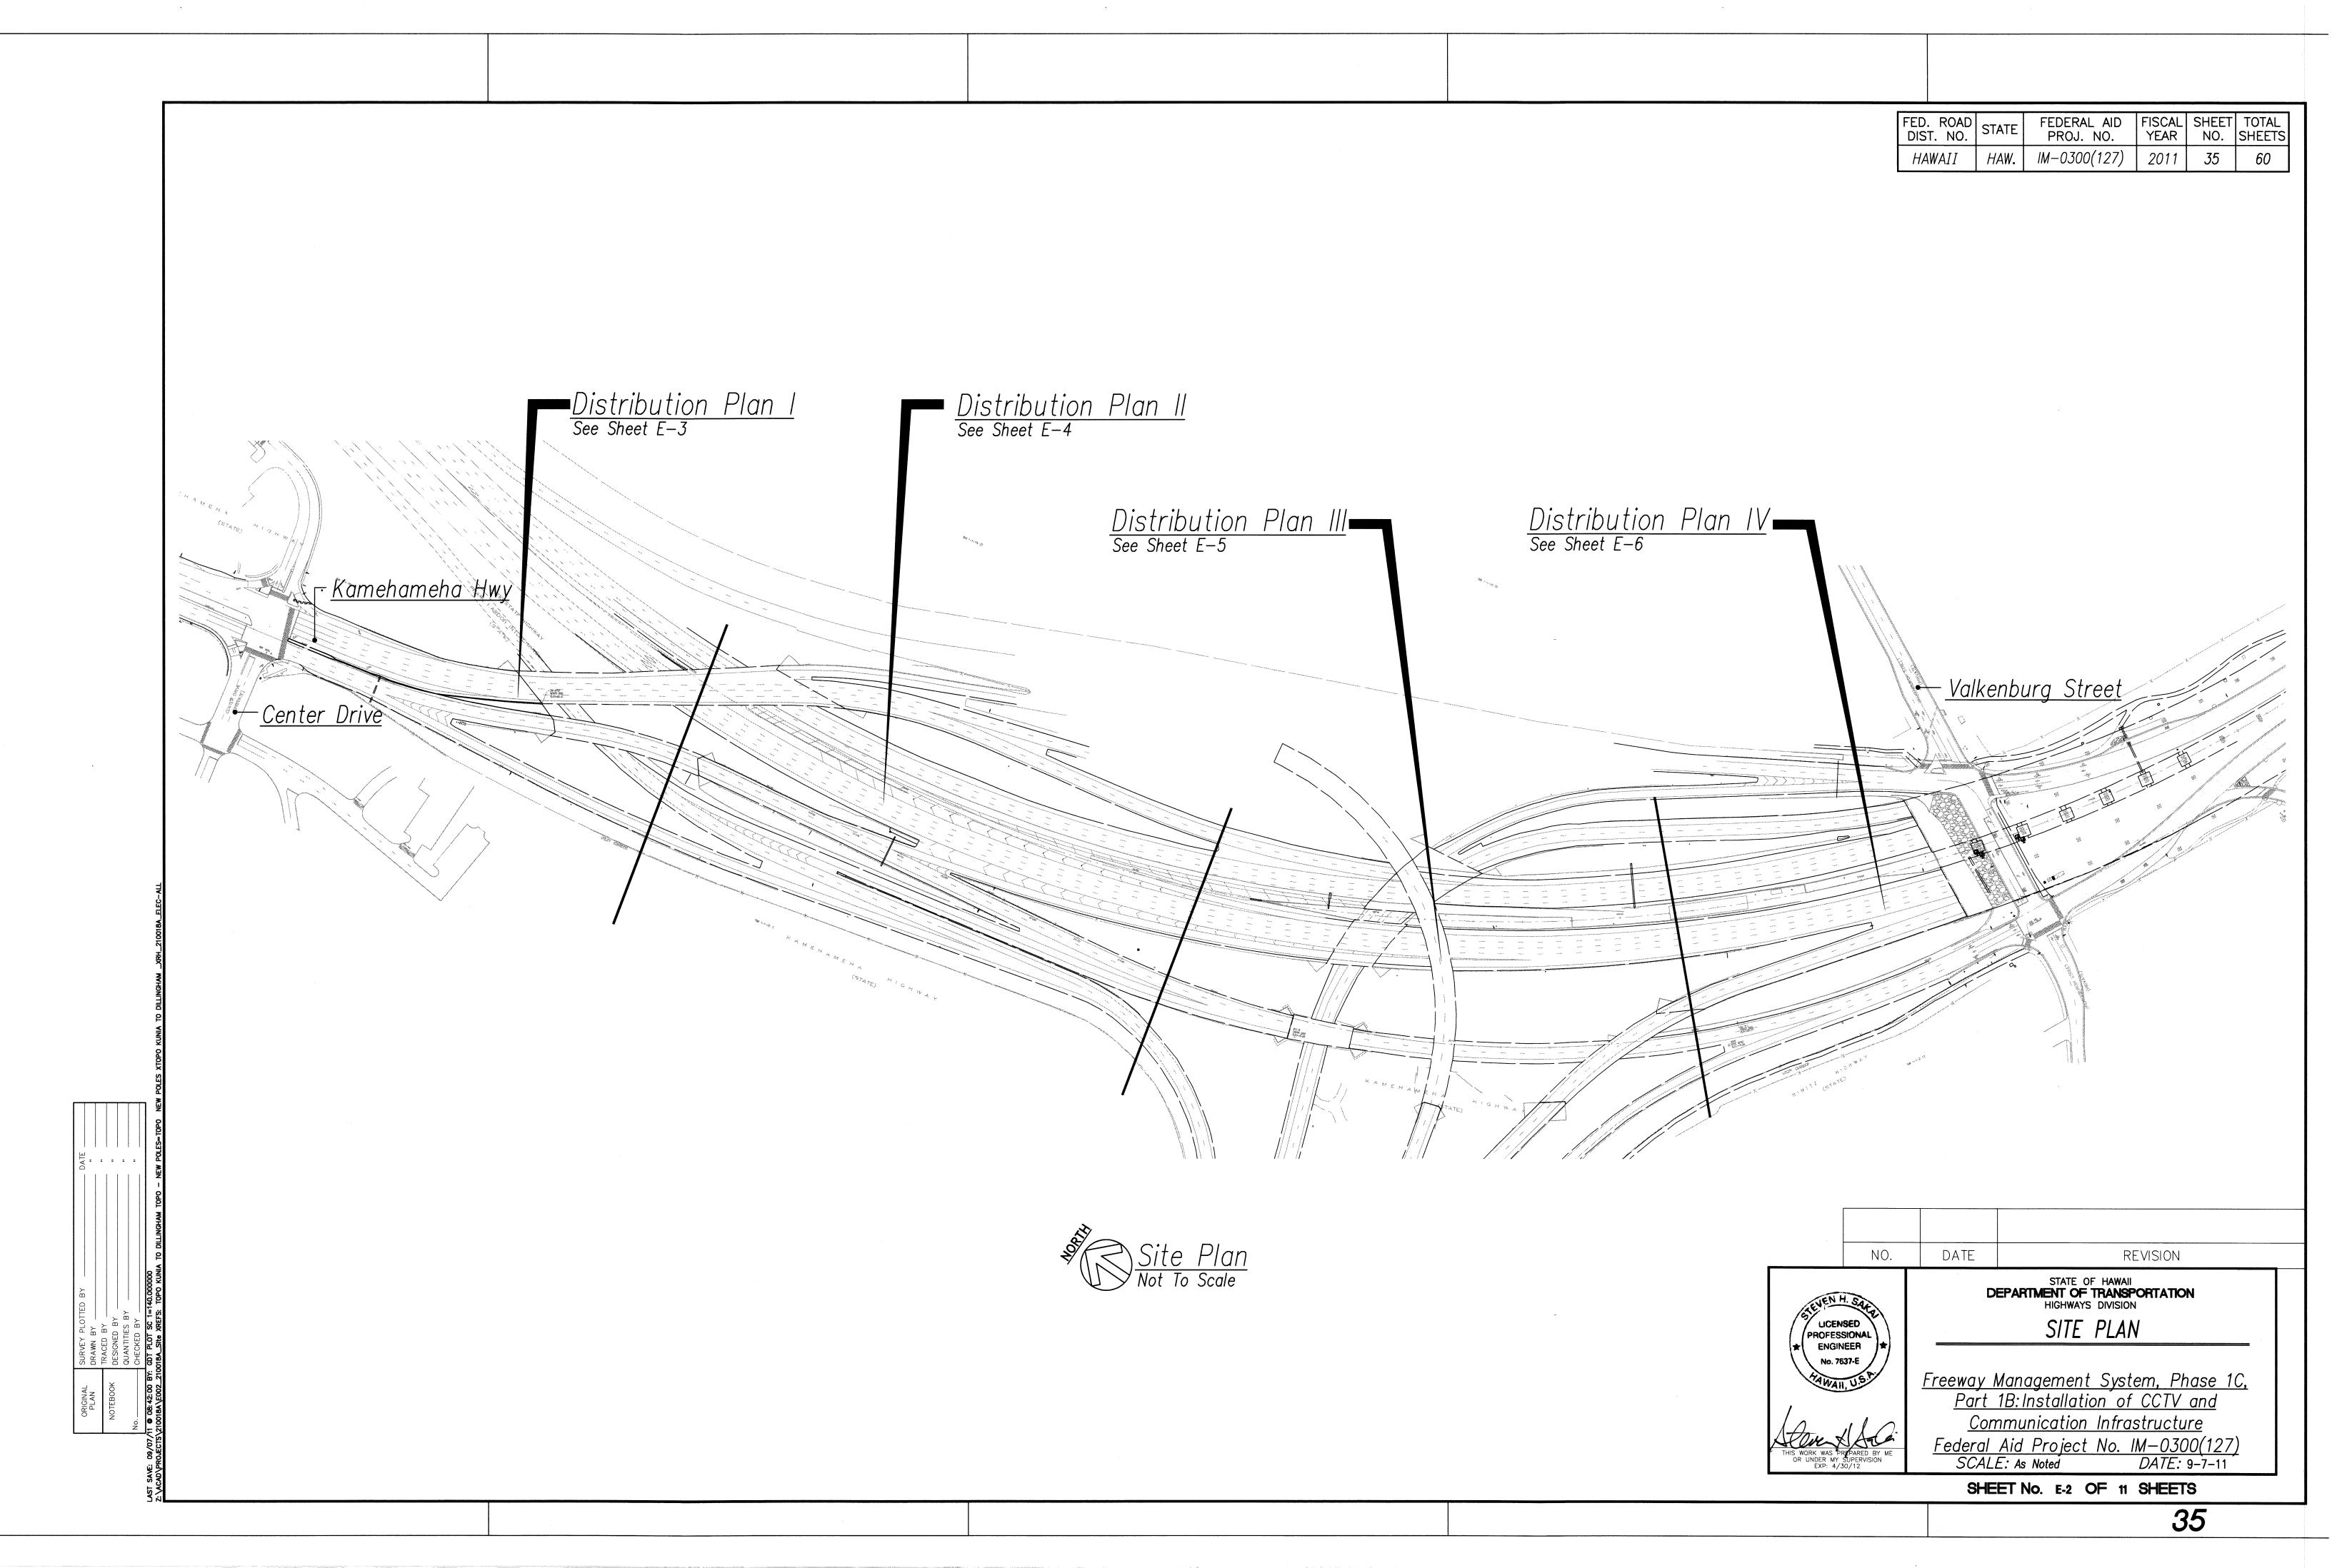


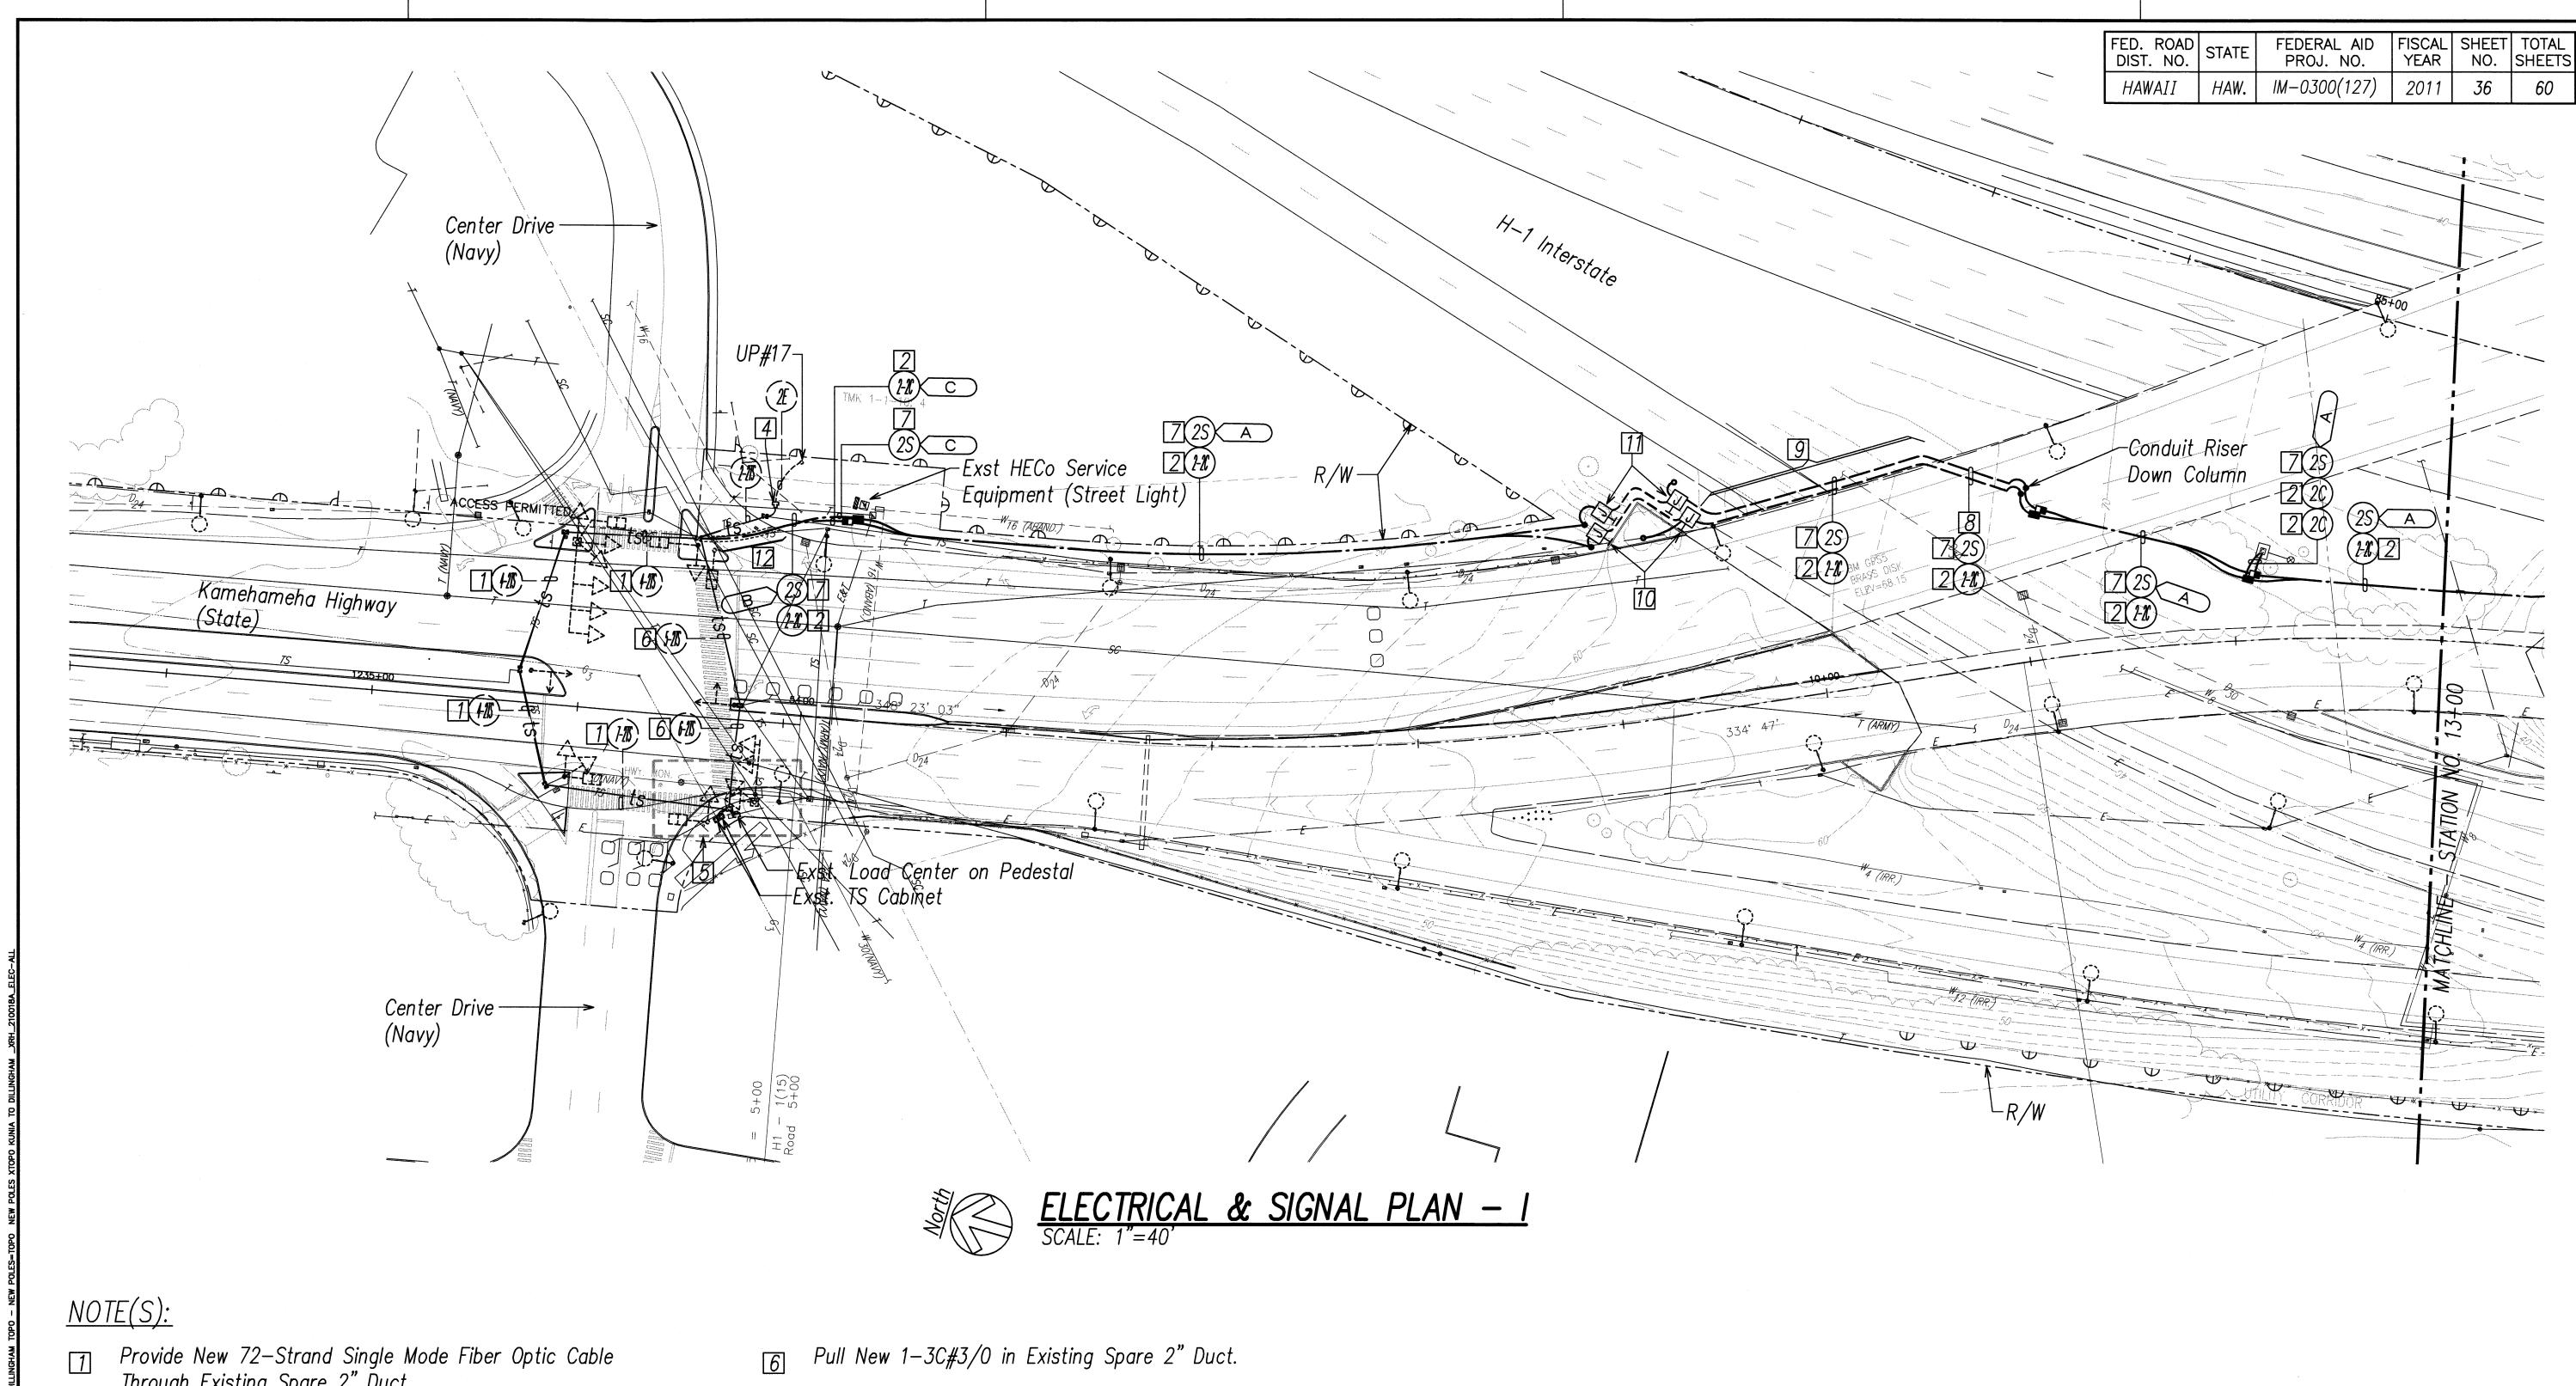



- Provide New 72—Strand Single Mode Fiber Optic Cable Through Existing Spare 2" Duct.
- Provide New 72—Strand Single Mode Fiber Optic Cable Through One New 2" Duct.
- Fiber Optic Cable Splicing In CCTV Cabinet Shall Be Performed By The Contractor. See Communications Plan for Detail.
- Exst. HECo Meter Pedestal, #550453
- See Enlarged Plan on C/E-8.

- Pull New 1-3C#3/0 in New 2" Duct.
- Strap to Underside of Ramp. See Detail B/E-11.
- Strap to Ramp Parapet. See Detail B/E-11.
- 16" X 16" X 8" SS Communication Junction Box
- 16" X 16" X 8" SS Electrical Junction Box
- Contractor to Avoid Exst. Curb Ramp and Pavement Markings.

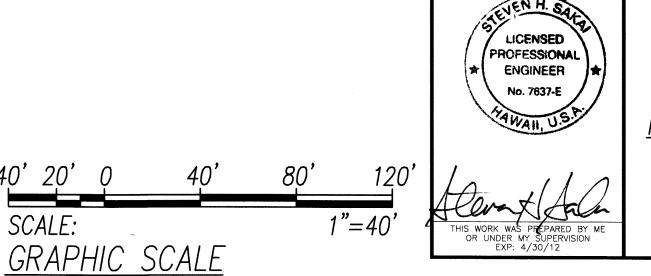


STATE OF HAWAII DEPARTMENT OF TRANSPORTATION HIGHWAYS DIVISION


ELECTRICAL & SIGNAL PLAN - I


Freeway Management System, Phase 1C, Part 1B: Installation of CCTV and <u>Communication Infrastructure</u> Federal Aid Project No. IM-0300(127)


SCALE: As Noted DATE: 9-7-11 DATE: 9-7-11


SHEET No. E-3 OF 11 SHEETS

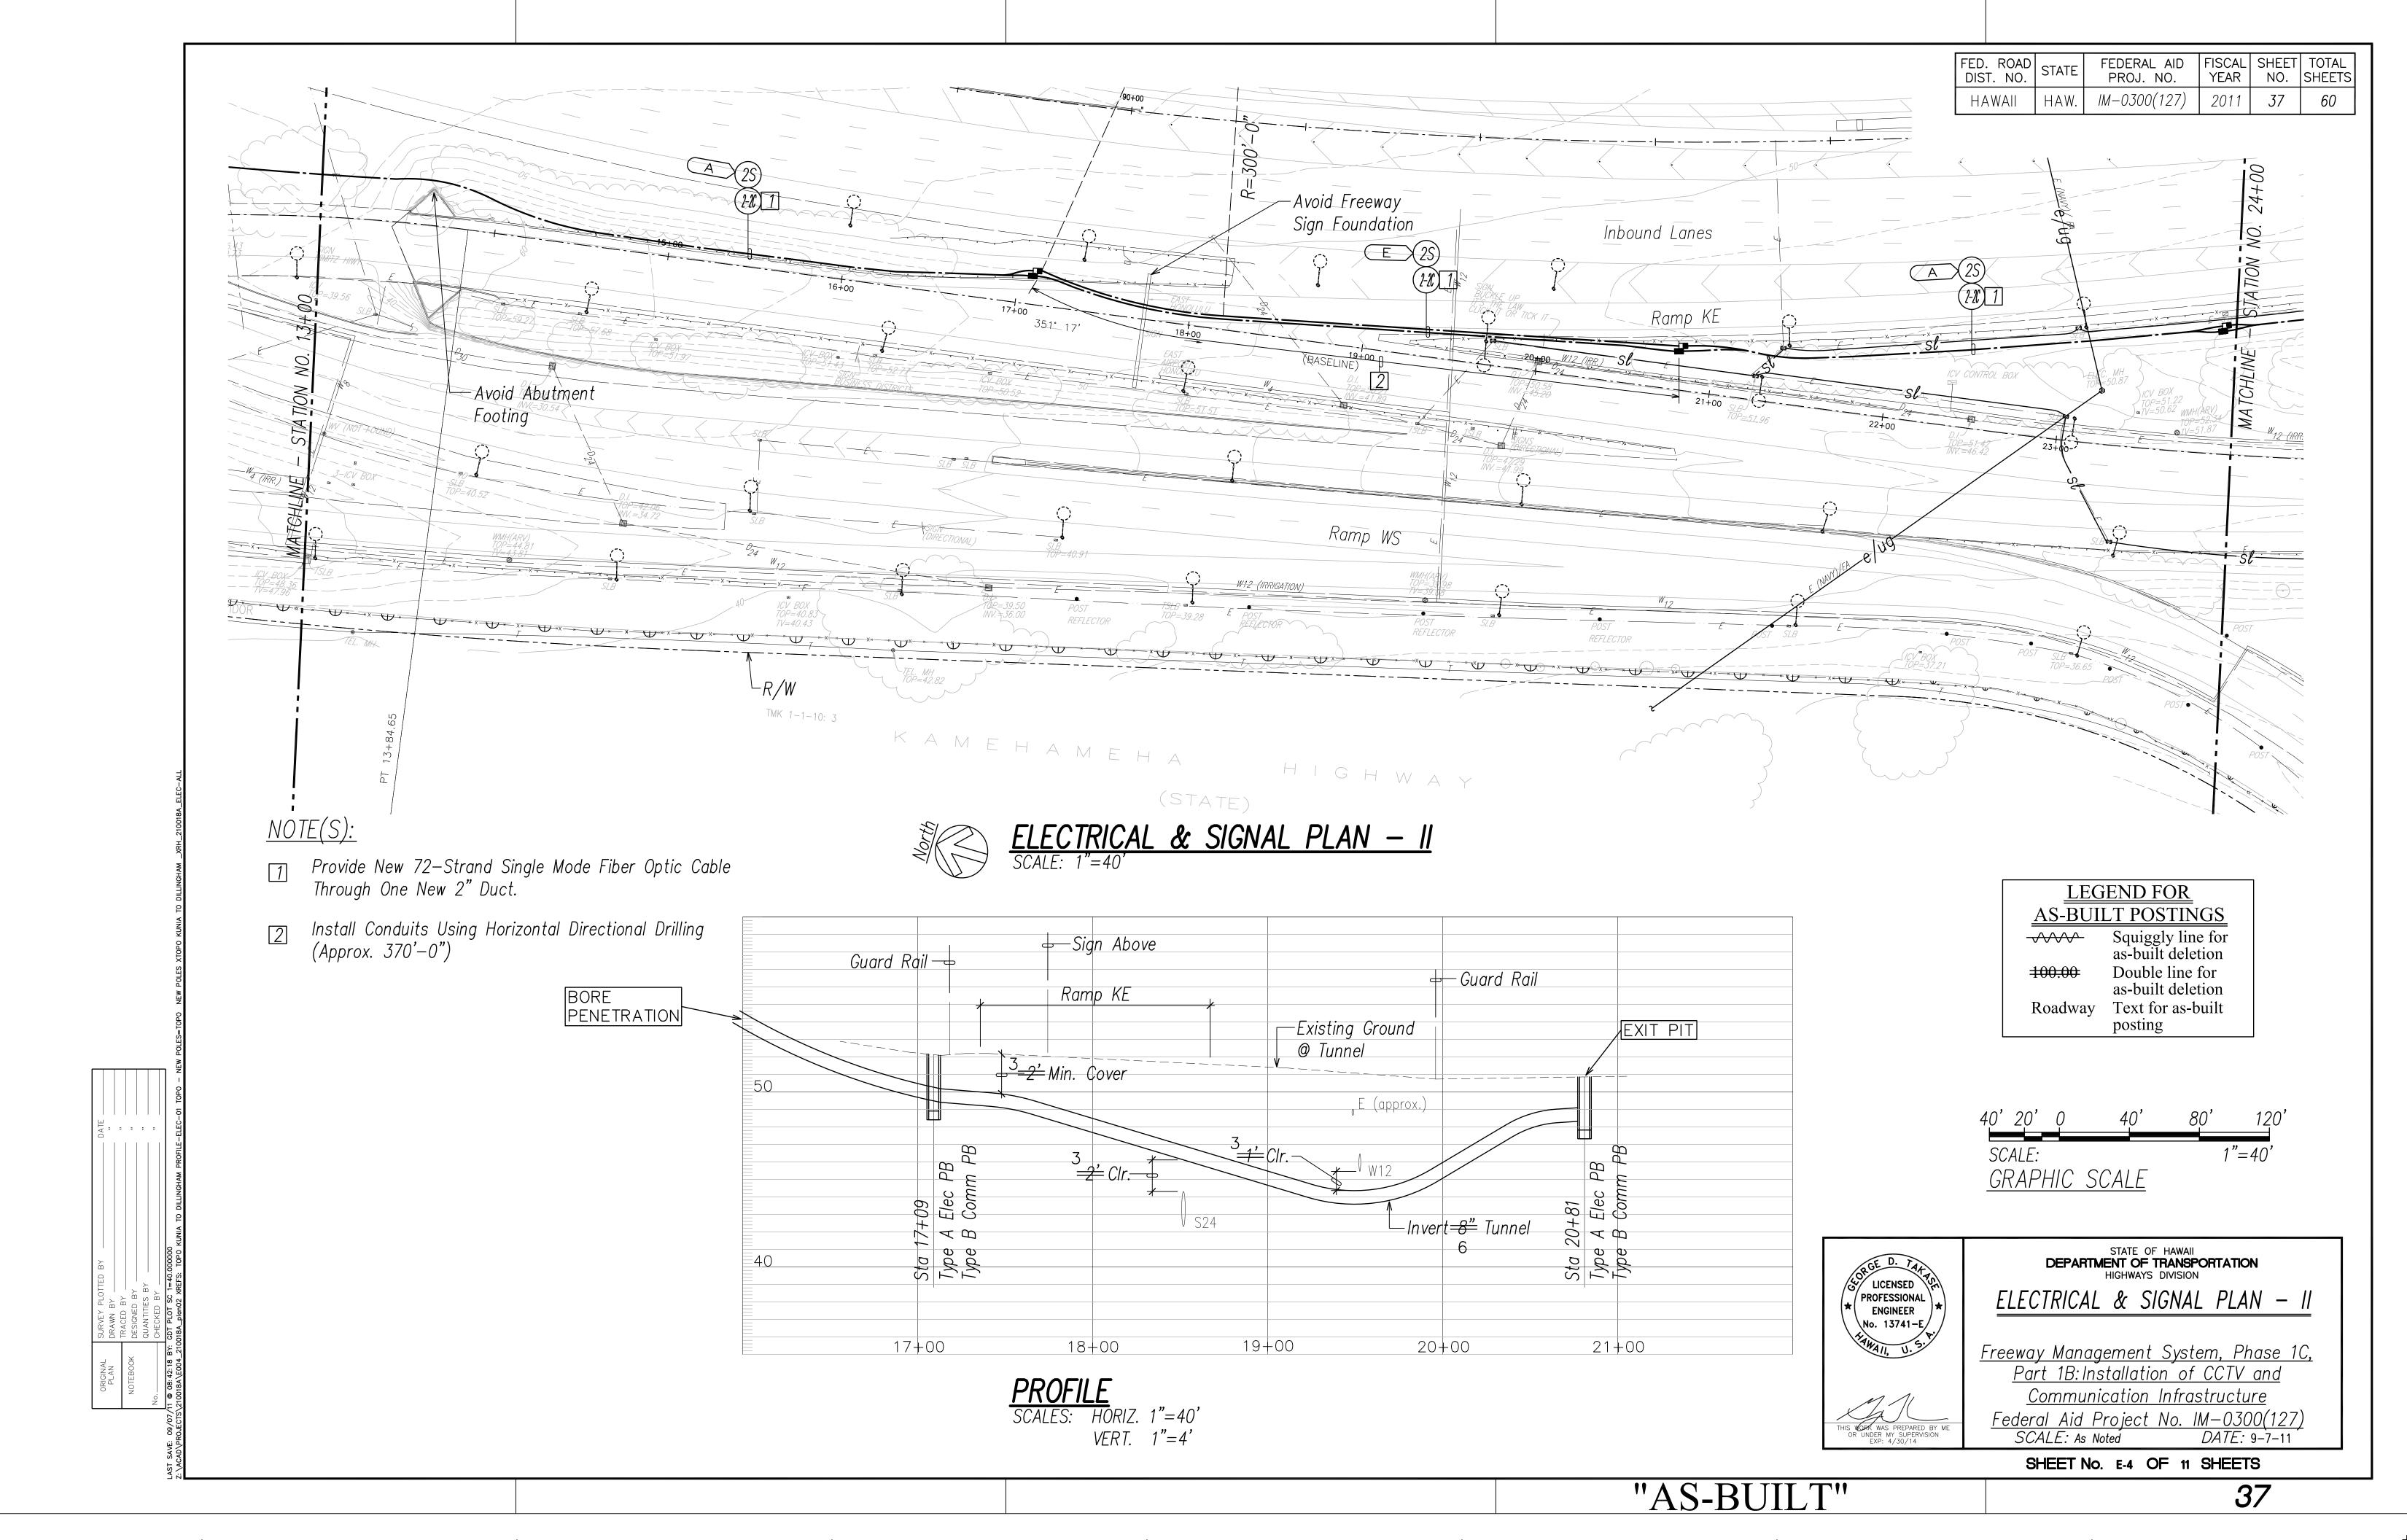

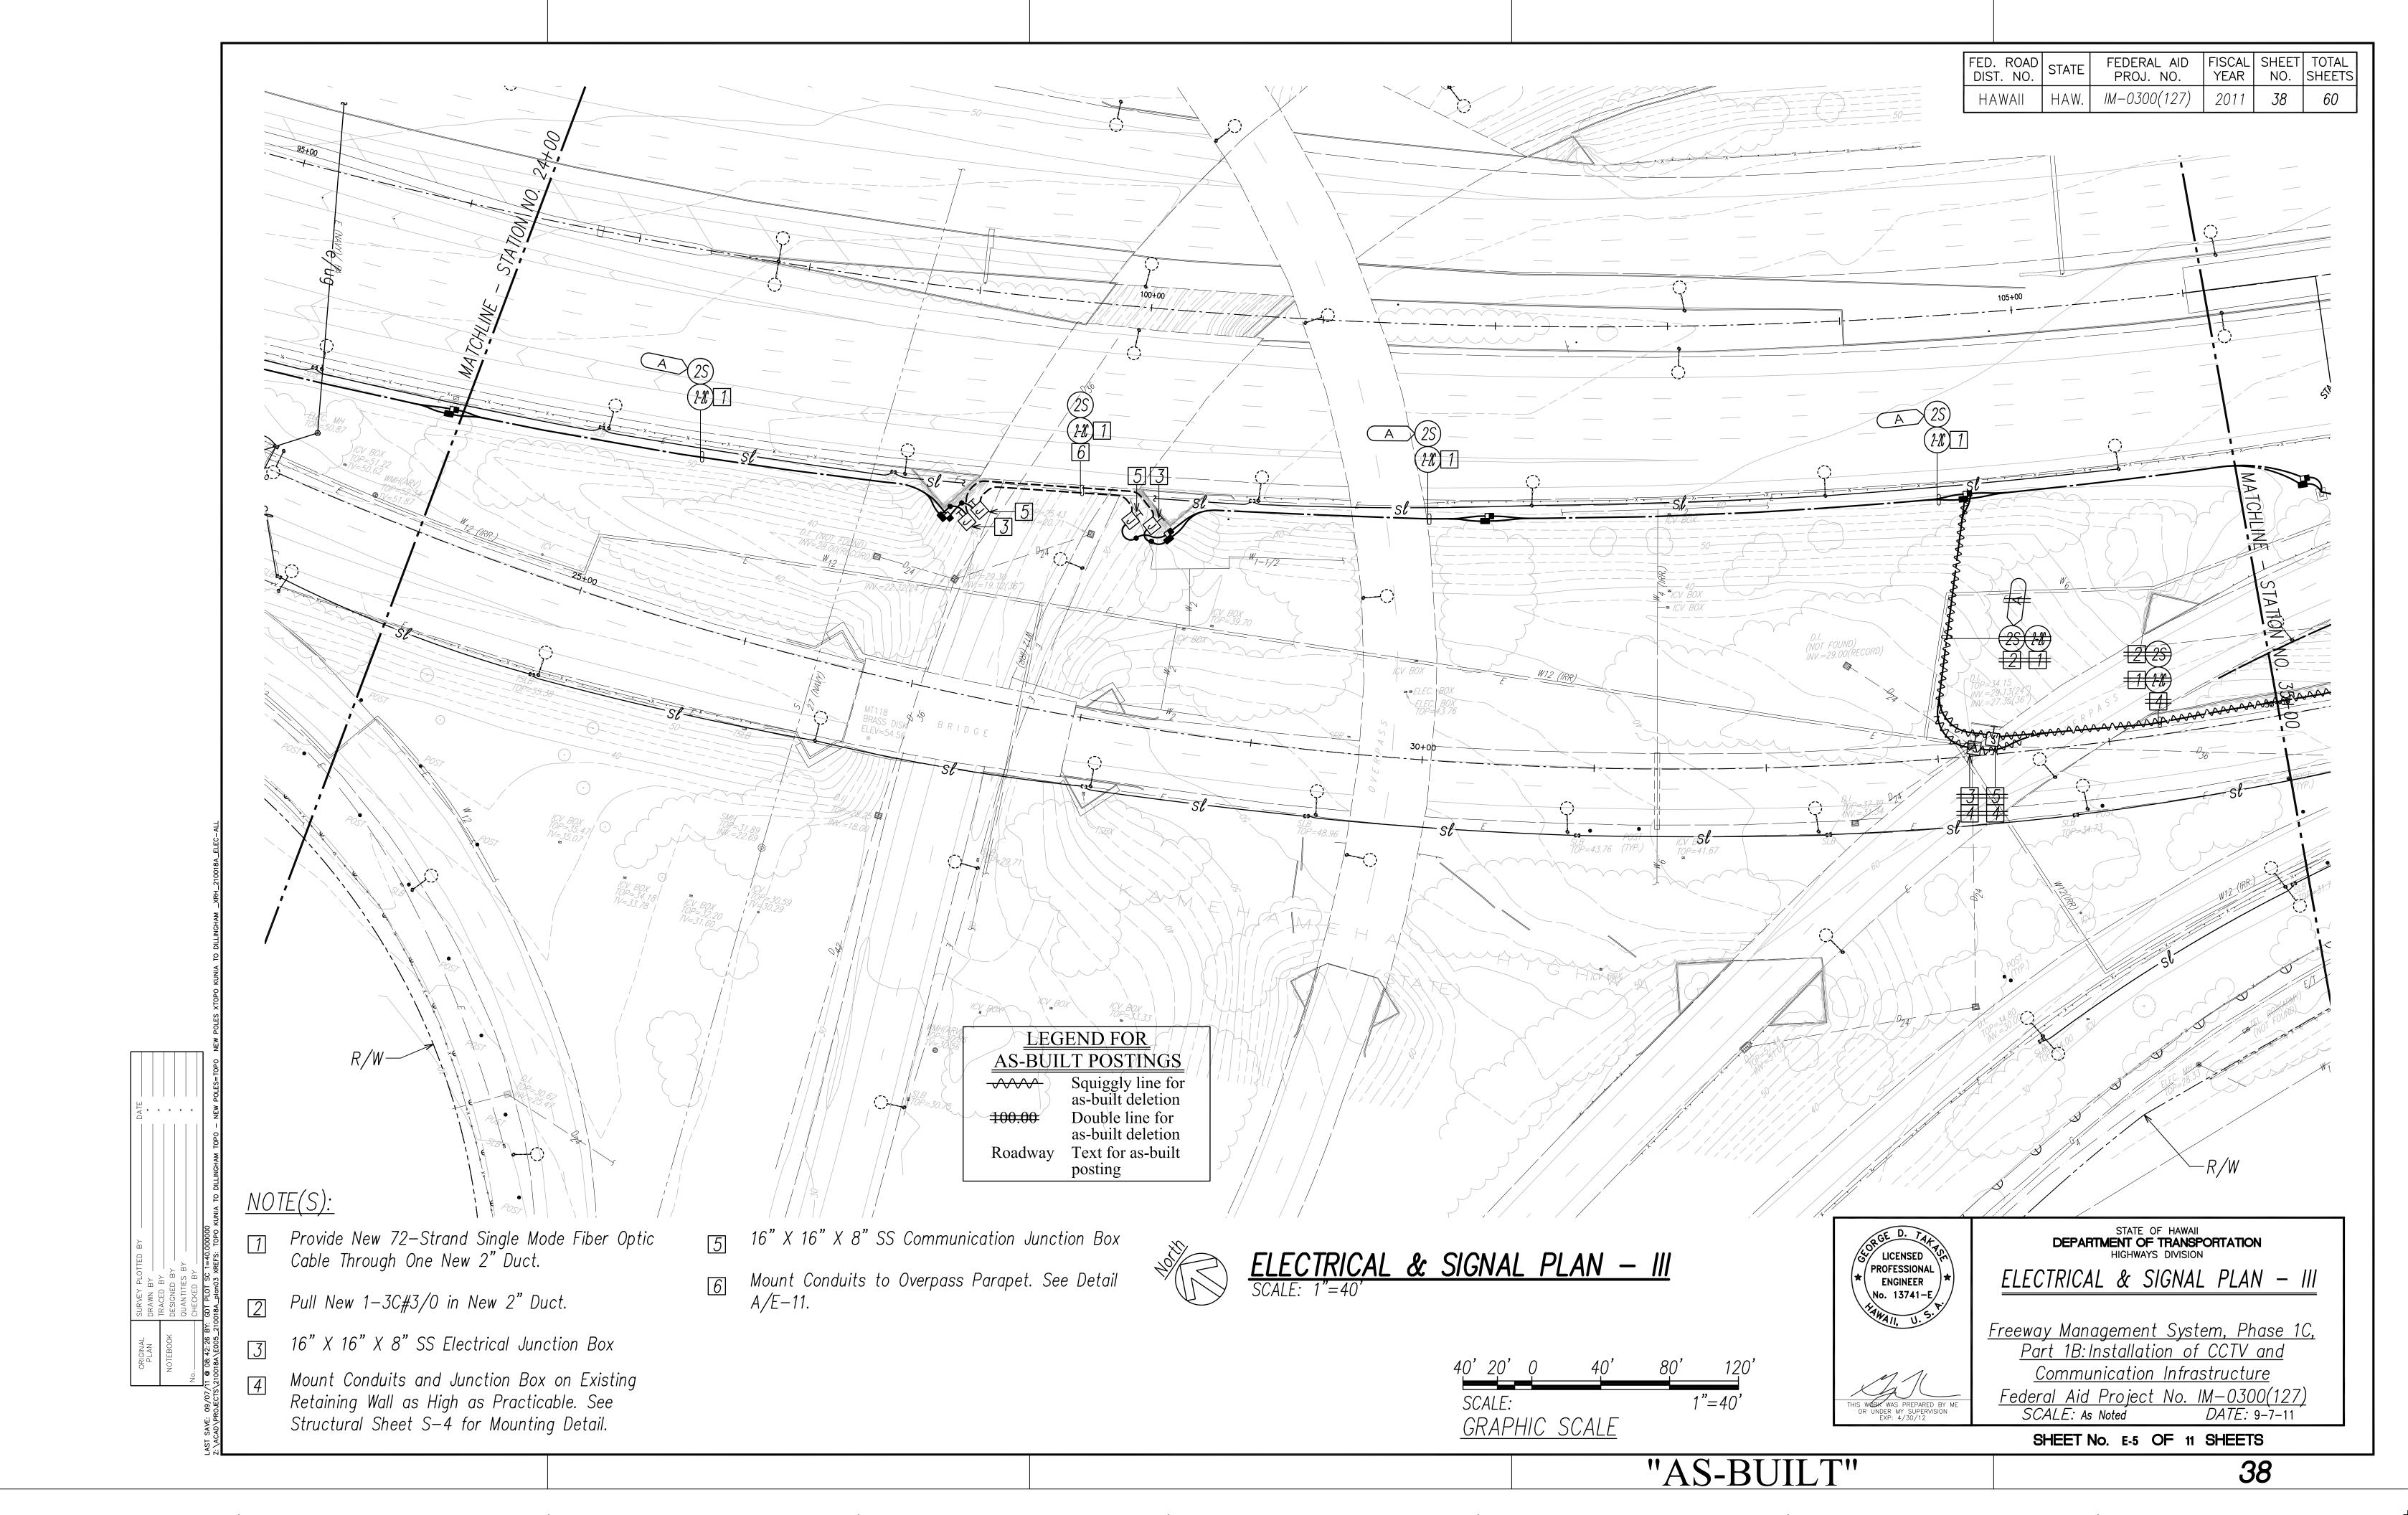

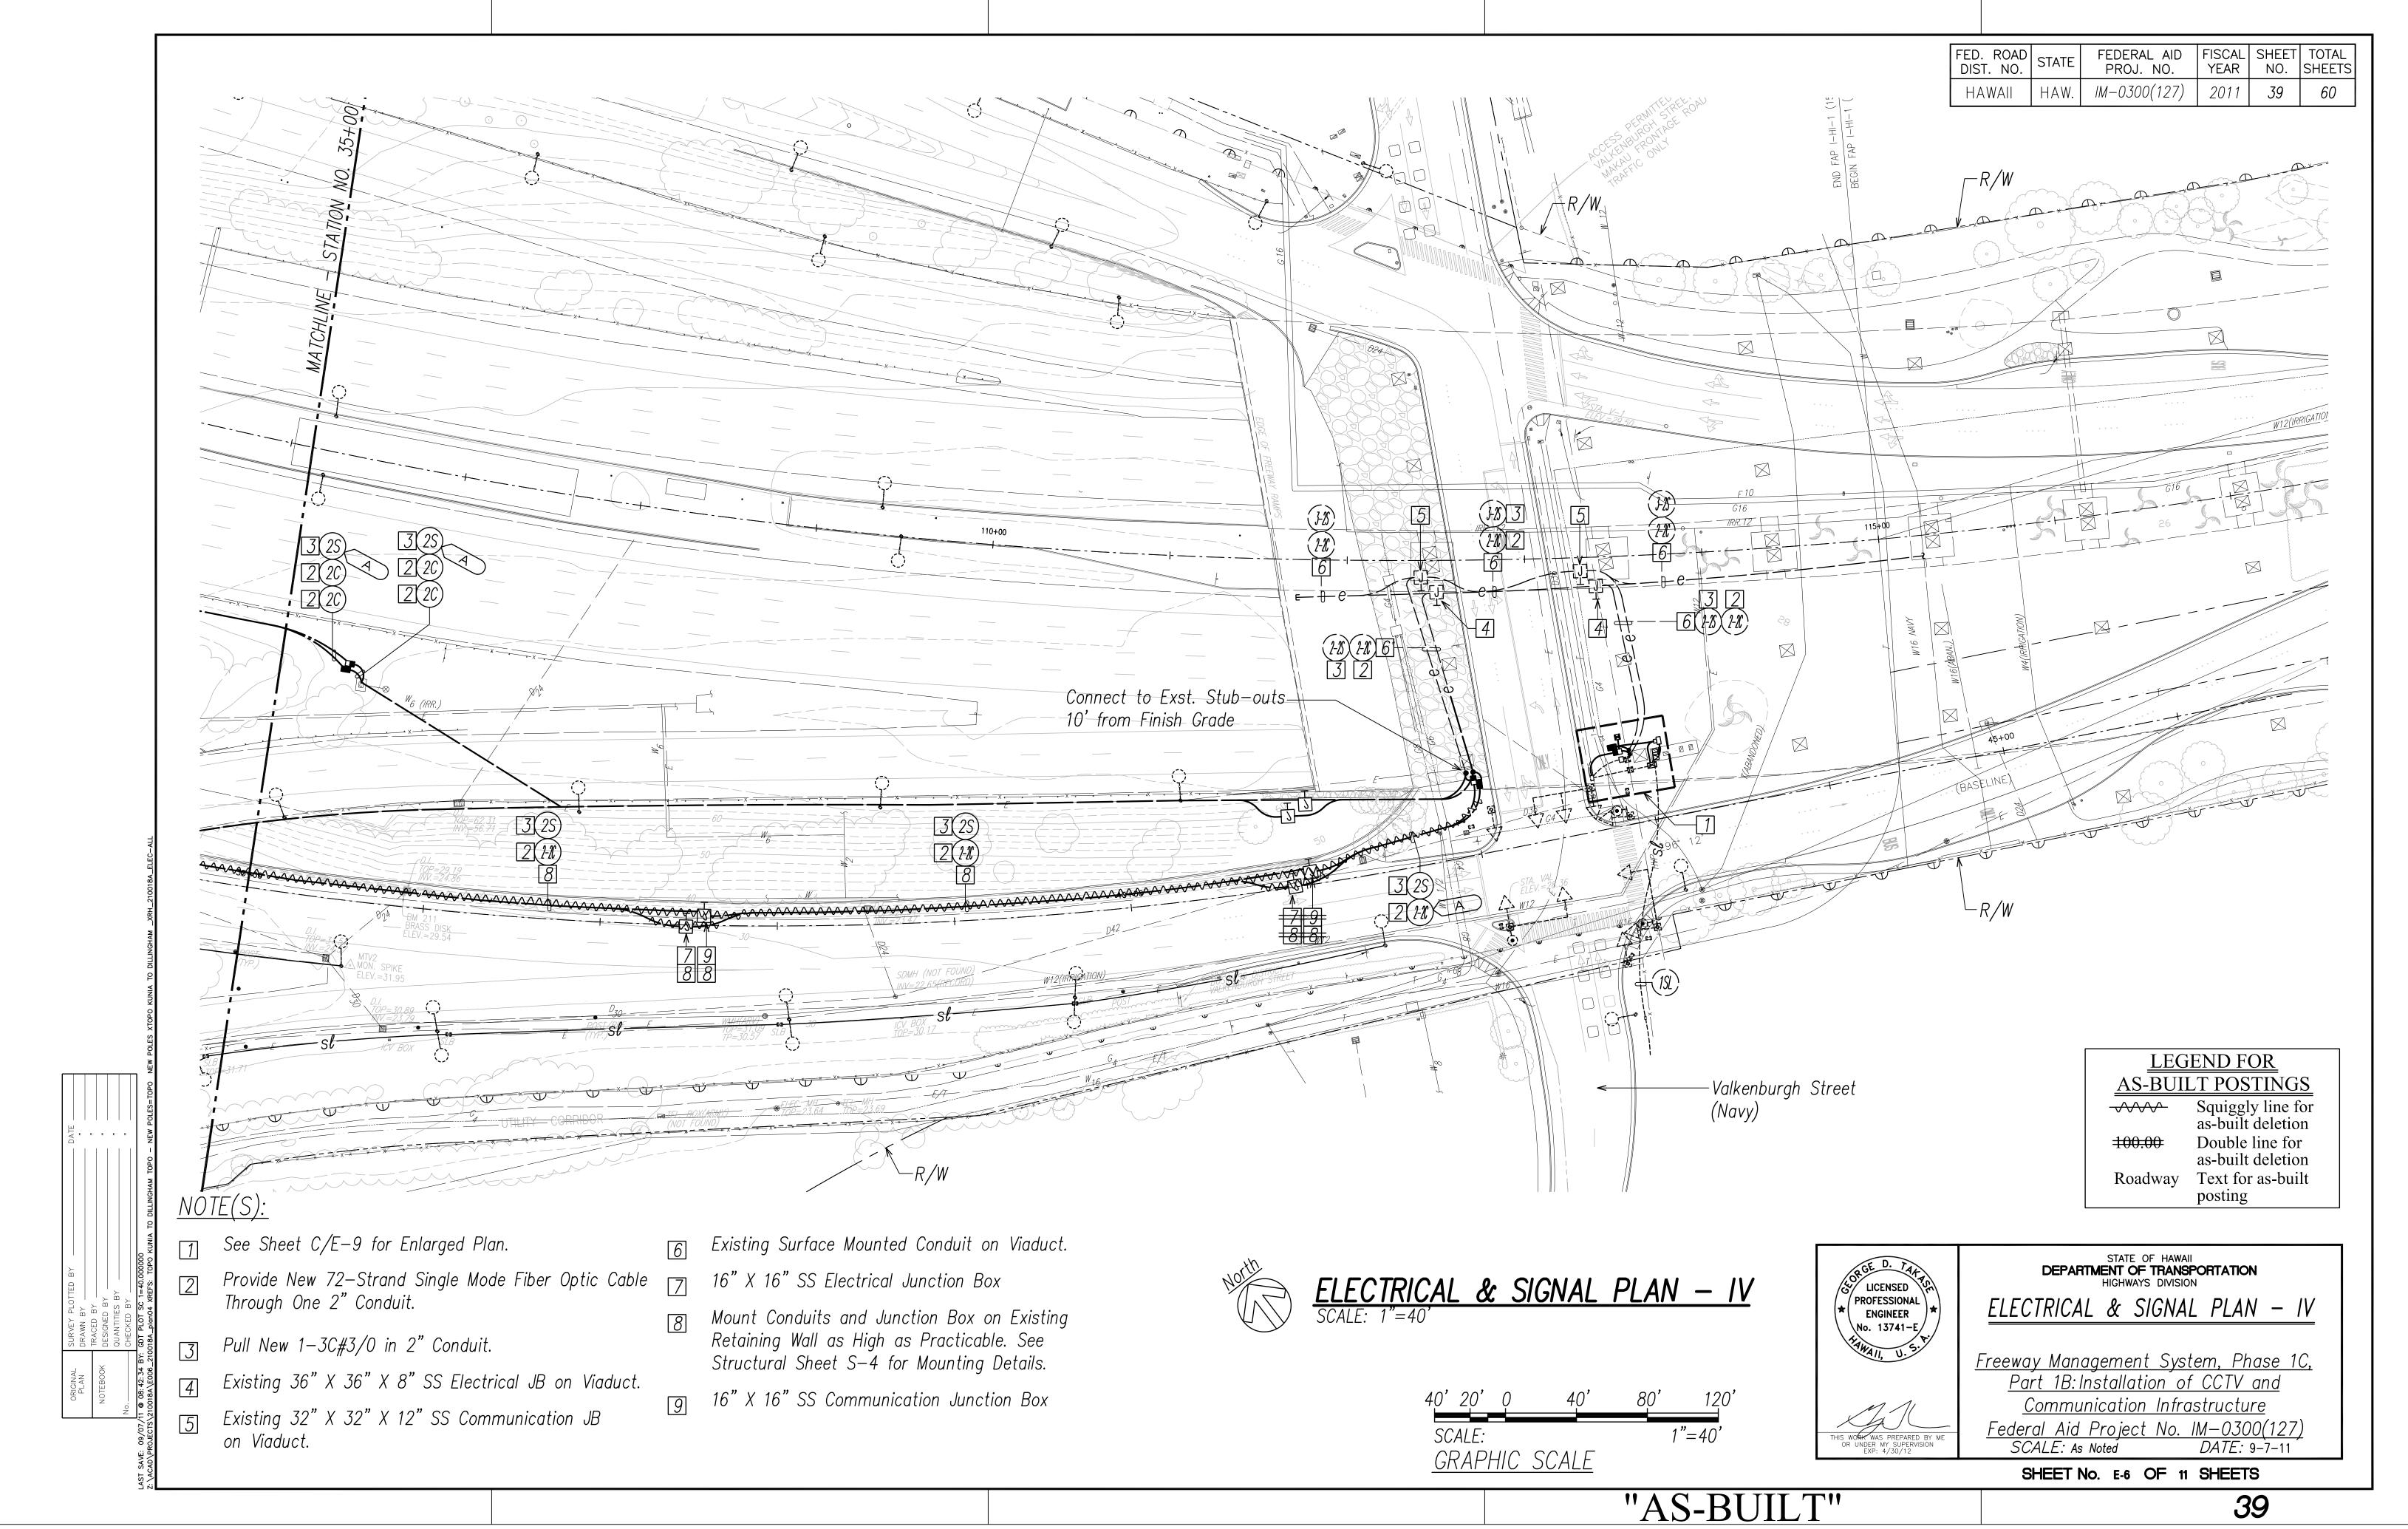

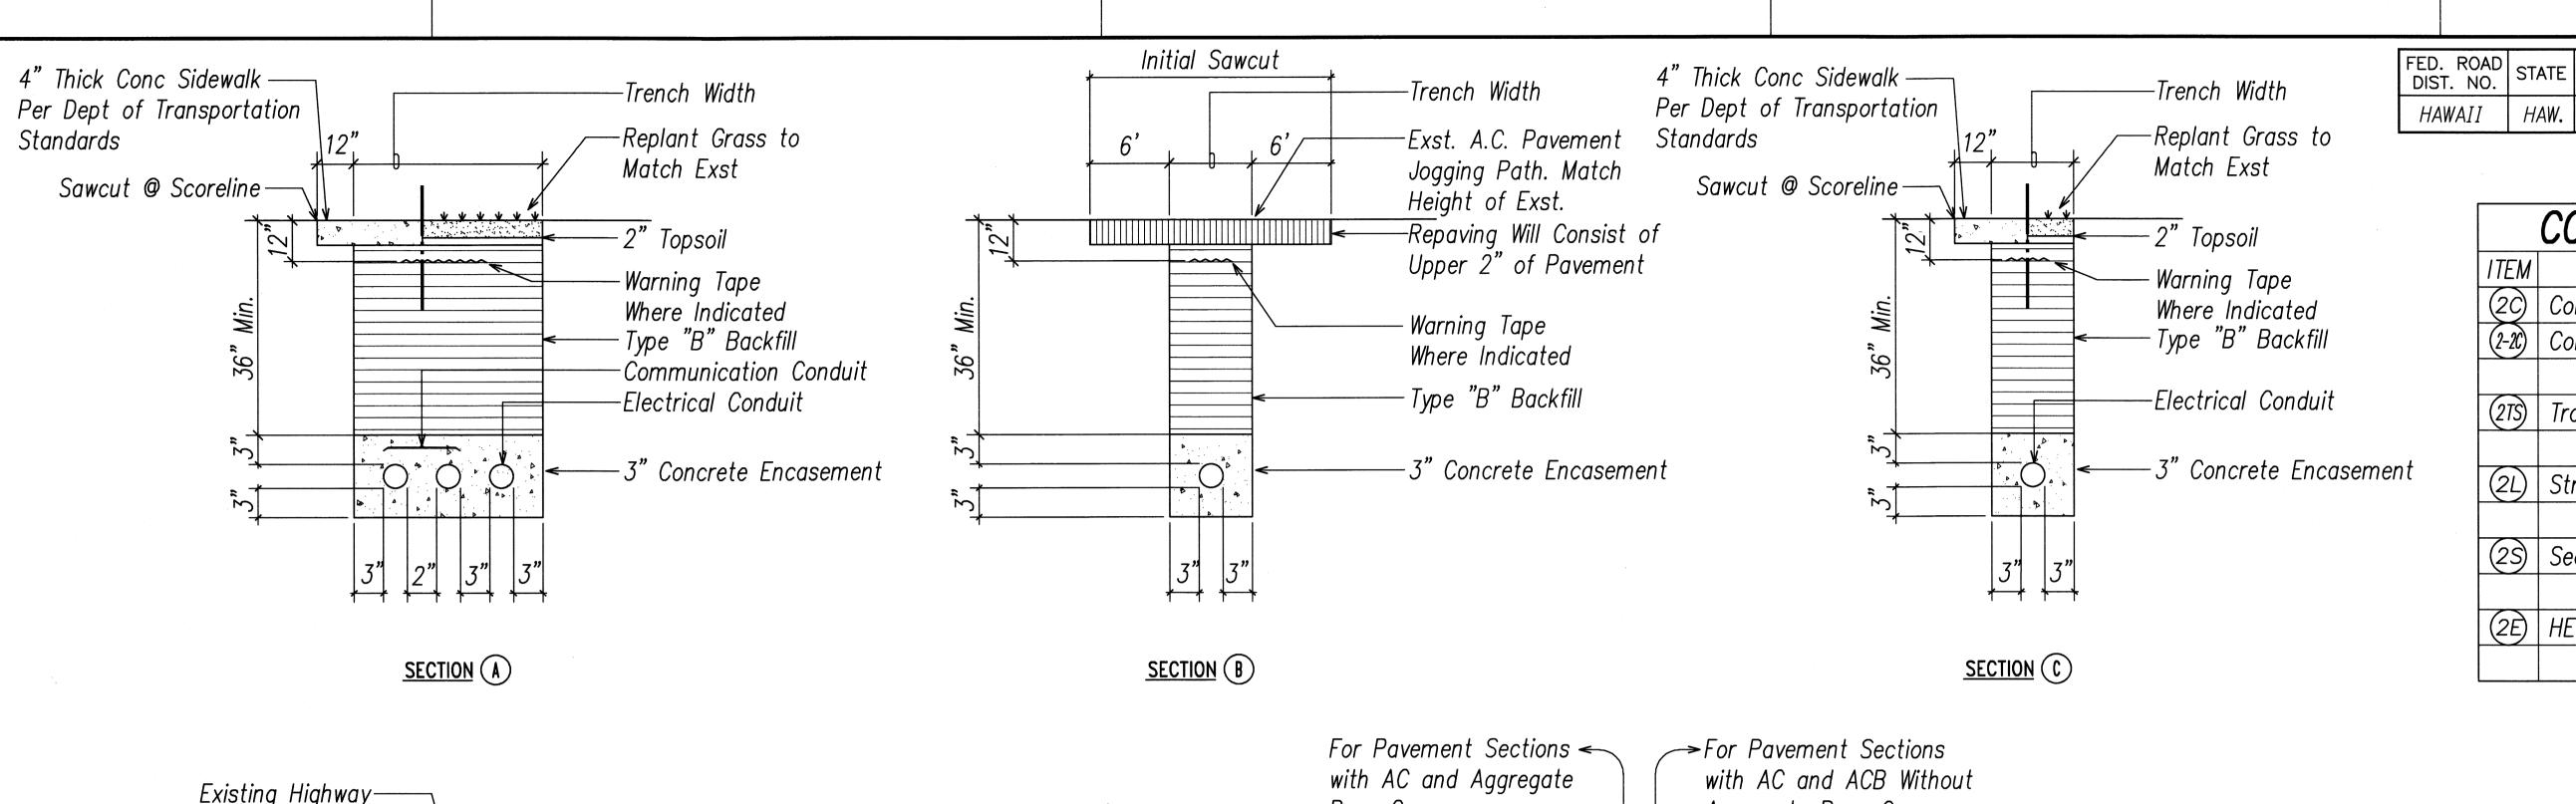

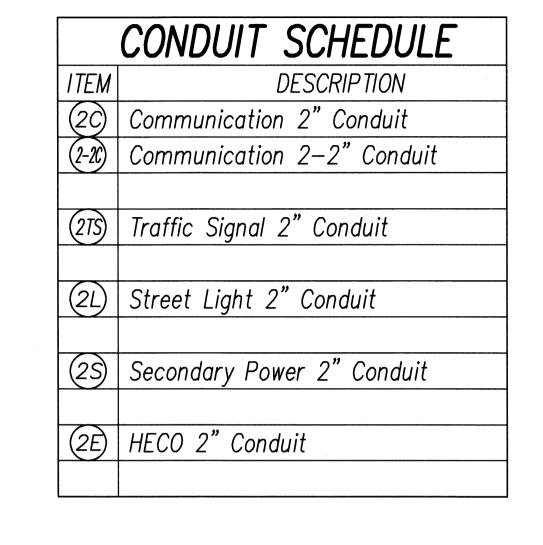

FEDERAL AID PROJ. NO.


IM-0300(127)


HAWAII HAW.

FISCAL SHEET TOTAL YEAR NO. SHEETS

40

2011

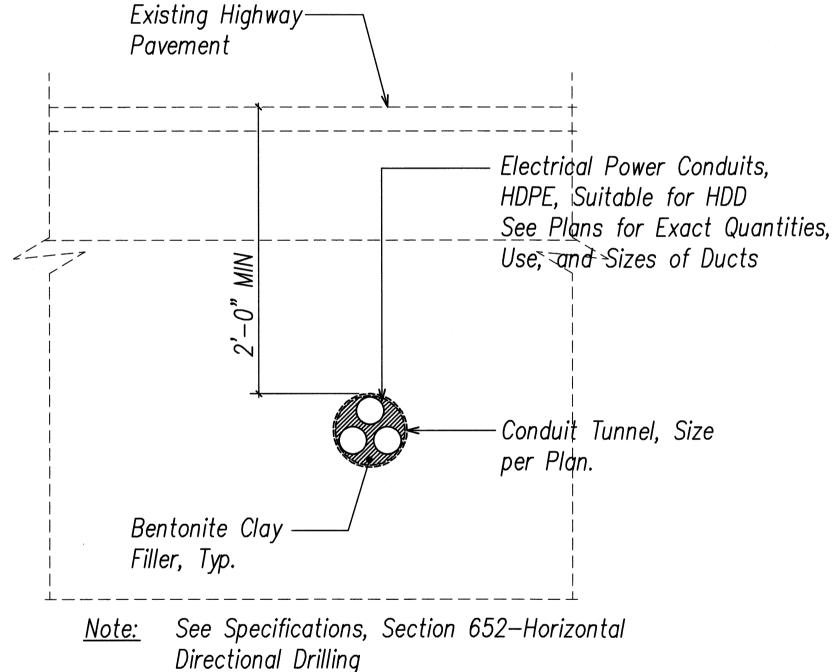

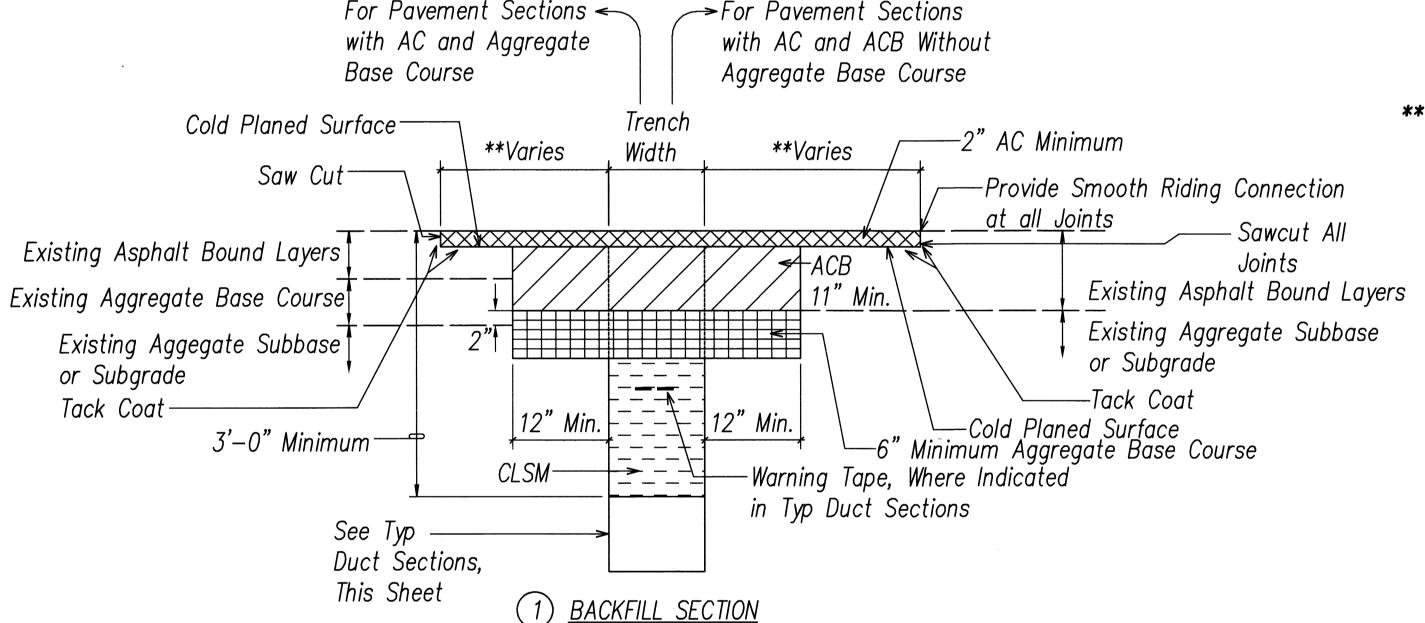

WITHIN STATE RIGHT-OF-WAY

UNDER EXISTING ROADWAY &

PAVED SHOULDER 1, 2

** Notes For Backfill Section (1)

- If Trench Aligned Transverse to Direction of Travel, Sawcut 1 Foot on Each Side of Trench.
- If Trench Aligned Along Direction of Travel, Sawcut to Edge of Lane in which Edge of Trench is Located.
- Smoothness of Paved Surfaces: The Distance from the Paved Surface to the Testing Edge of a Ten-foot Straight Edge Between Two Points of Contact shall not Exceed 3/16".

SECTION (E)

STATE RIGHT-OF-WAY BACKFILL NOTES


Trench Backfill Material "B" 1. Sand Equivalent ≥ 2 2. 8" Max. Lift Loose 3. 95% Compaction

Concrete - 3" Encasement, 2500 PSI Compressive Strength @ 28 Days.

NOTE(S):

- 1 Contractor to Observe Best Management Practices and take Measures Required for Existing Storm Drain Inlets or Catch Basins. See Sheet C-8 for Details.
- Contractor to Observe Best Management Practices for Existing Grassed or Landscaped Areas. See Detail on Sheet C-8.

Typical Duct Section NOT TO SCALE

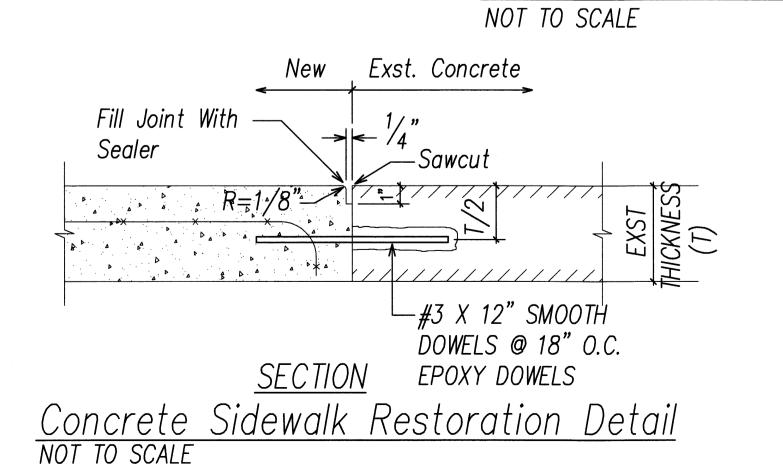

NO. LICENSED PROFESSIONAL ENGINEER No. 7637-E

TYPICAL BACKFILL SECTION (STATE)

DATE REVISION STATE OF HAWAII

DEPARTMENT OF TRANSPORTATION


HIGHWAYS DIVISION

DUCT SECTION

Freeway Management System, Phase 1C, Part 1B: Installation of CCTV and <u>Communication</u> Infrastructure Federal Aid Project No. IM-0300(127) SCALE: As Noted DATE: 9-7-11


SHEET No. E-7 OF 11 SHEETS



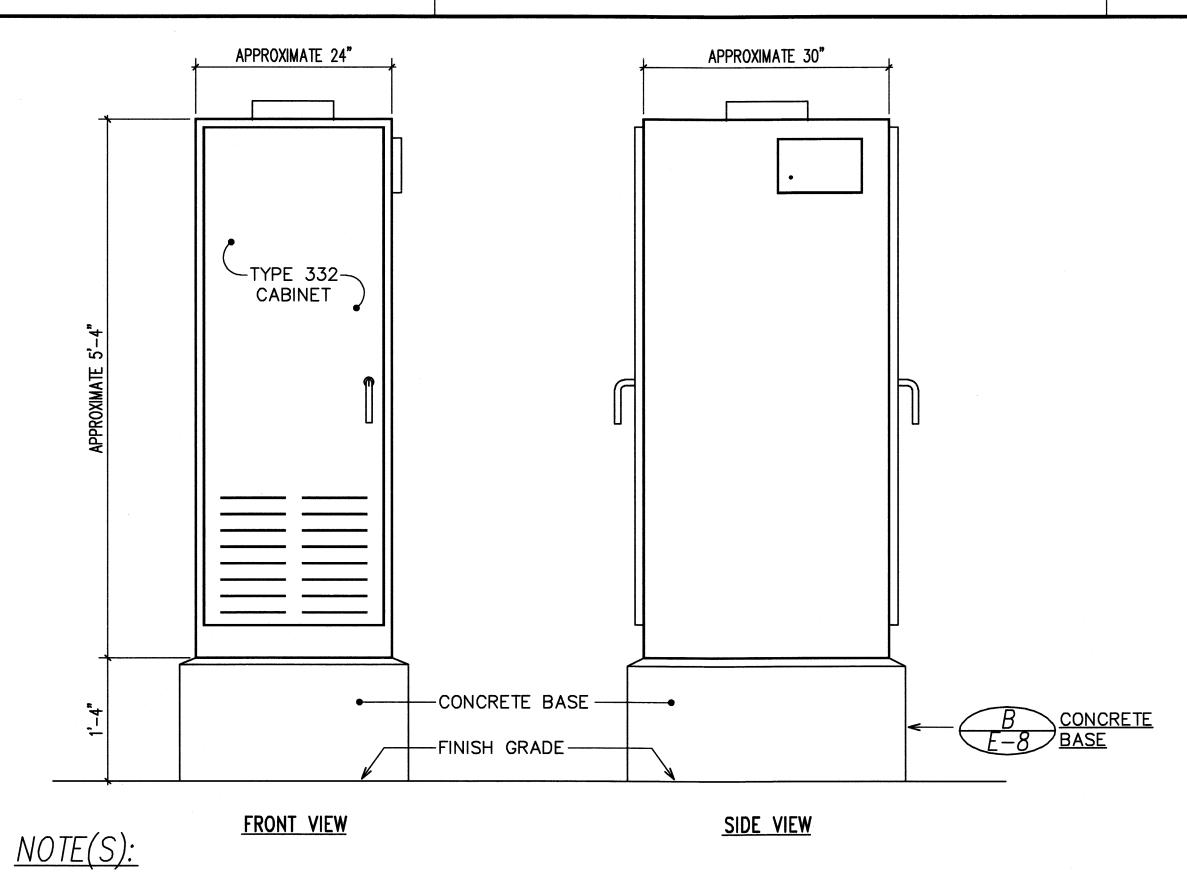



Splice Cabinet with Rack Mounted Interconnect Center. Rack Mounted Interconnect Center shall be paid under Section 681-CCTV System.

Type 332 Traffic Controller Cabinet Detail
Not To Scale

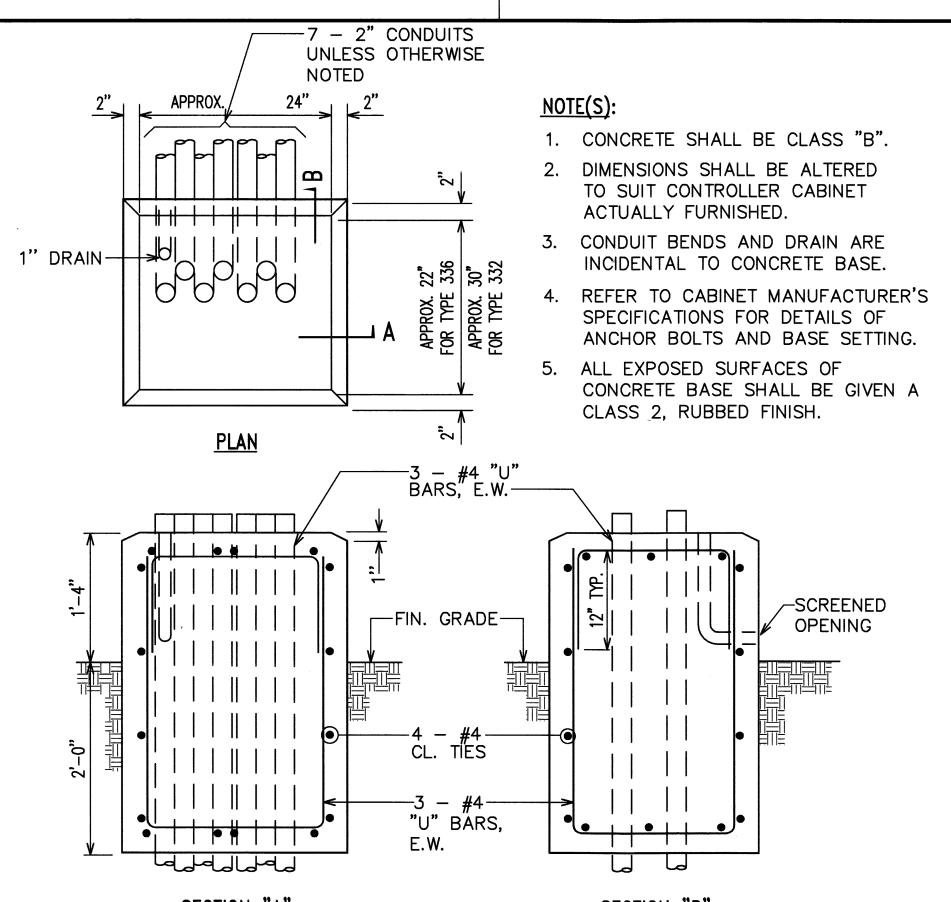

FEDERAL AID PROJ. NO. FISCAL SHEET TOTAL YEAR NO. SHEETS FED. ROAD STATE NO. SHEETS IM-0300(127) 2011

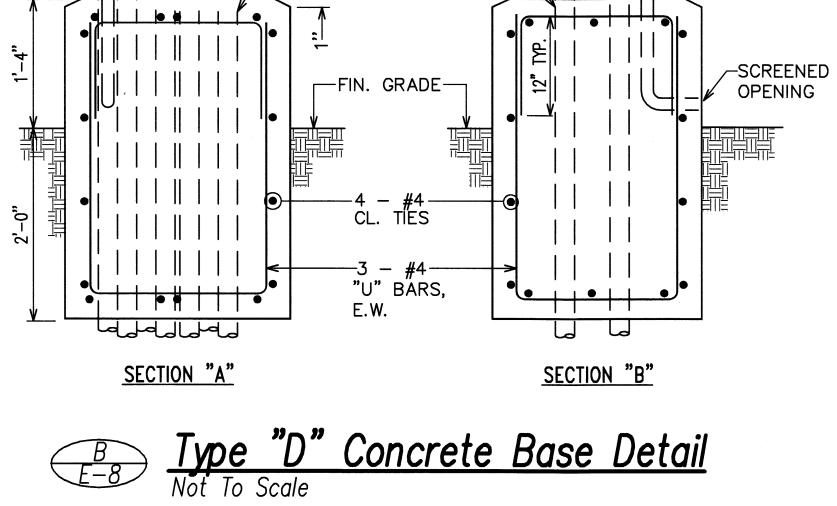

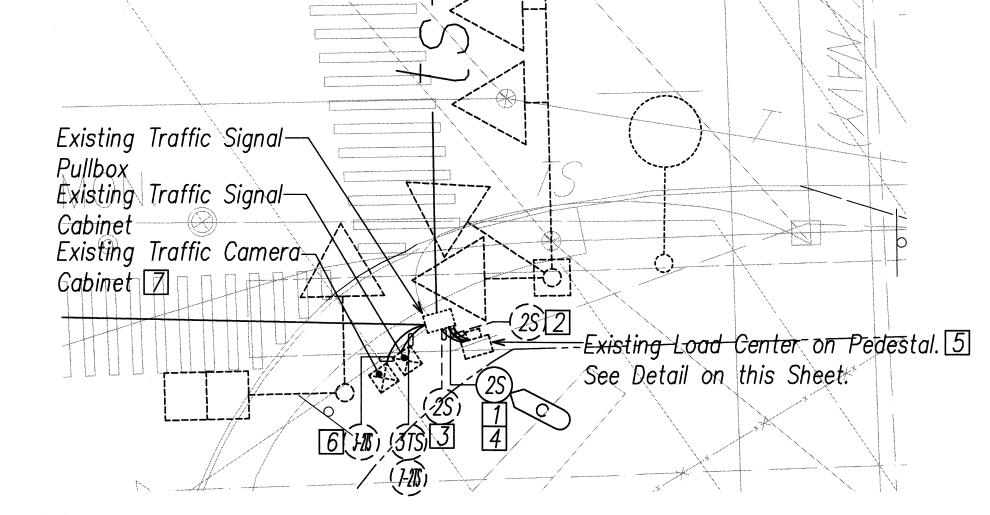


NOTE(S):


SURVEY DRAWN TRACED DESIGNE QUANTITI


- Provide new 2" Conduit from Existing Load Center to Existing Traffic Signal Pullbox. Penetrate Pull Box for Conduit Installation.
- Exst. 2"C, 1-3C#2
- Exst. 2"C, 1-3C#6
- New 2"C, 1-3C#1/0

- 5 Provide new 1P30A Circuit Breaker in Exst. Load Center for Traffic Camera.
- Provide New 72—Strand Single Mode Fiber Optic Cable Through Existing 2" Duct with Exst. Fiber Cable.
- See Communications Plan for Fiber Splicing Details.

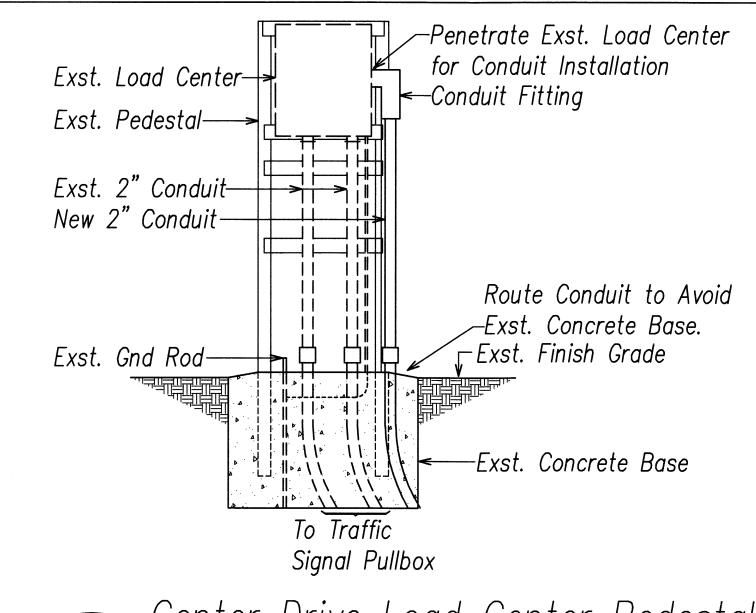

Center Drive Load Center Pedestal
NOT TO SCALE

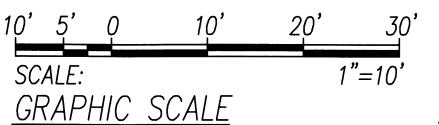

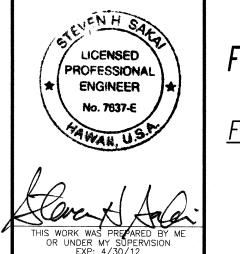

NO.

DATE

STATE OF HAWAII

DEPARTMENT OF TRANSPORTATION

HIGHWAYS DIVISION


REVISION

Fiber Cabinet & Center Drive Detail


Freeway Management System, Phase 1C, Part 1B: Installation of CCTV and Communication Infrastructure Federal Aid Project No. IM-0300(127)

SCALE: As Noted DATE: 9-7-11


SHEET No. E-8 OF 11 SHEETS

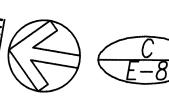


Center Drive Enlarged Plan SCALE: 1"=10"

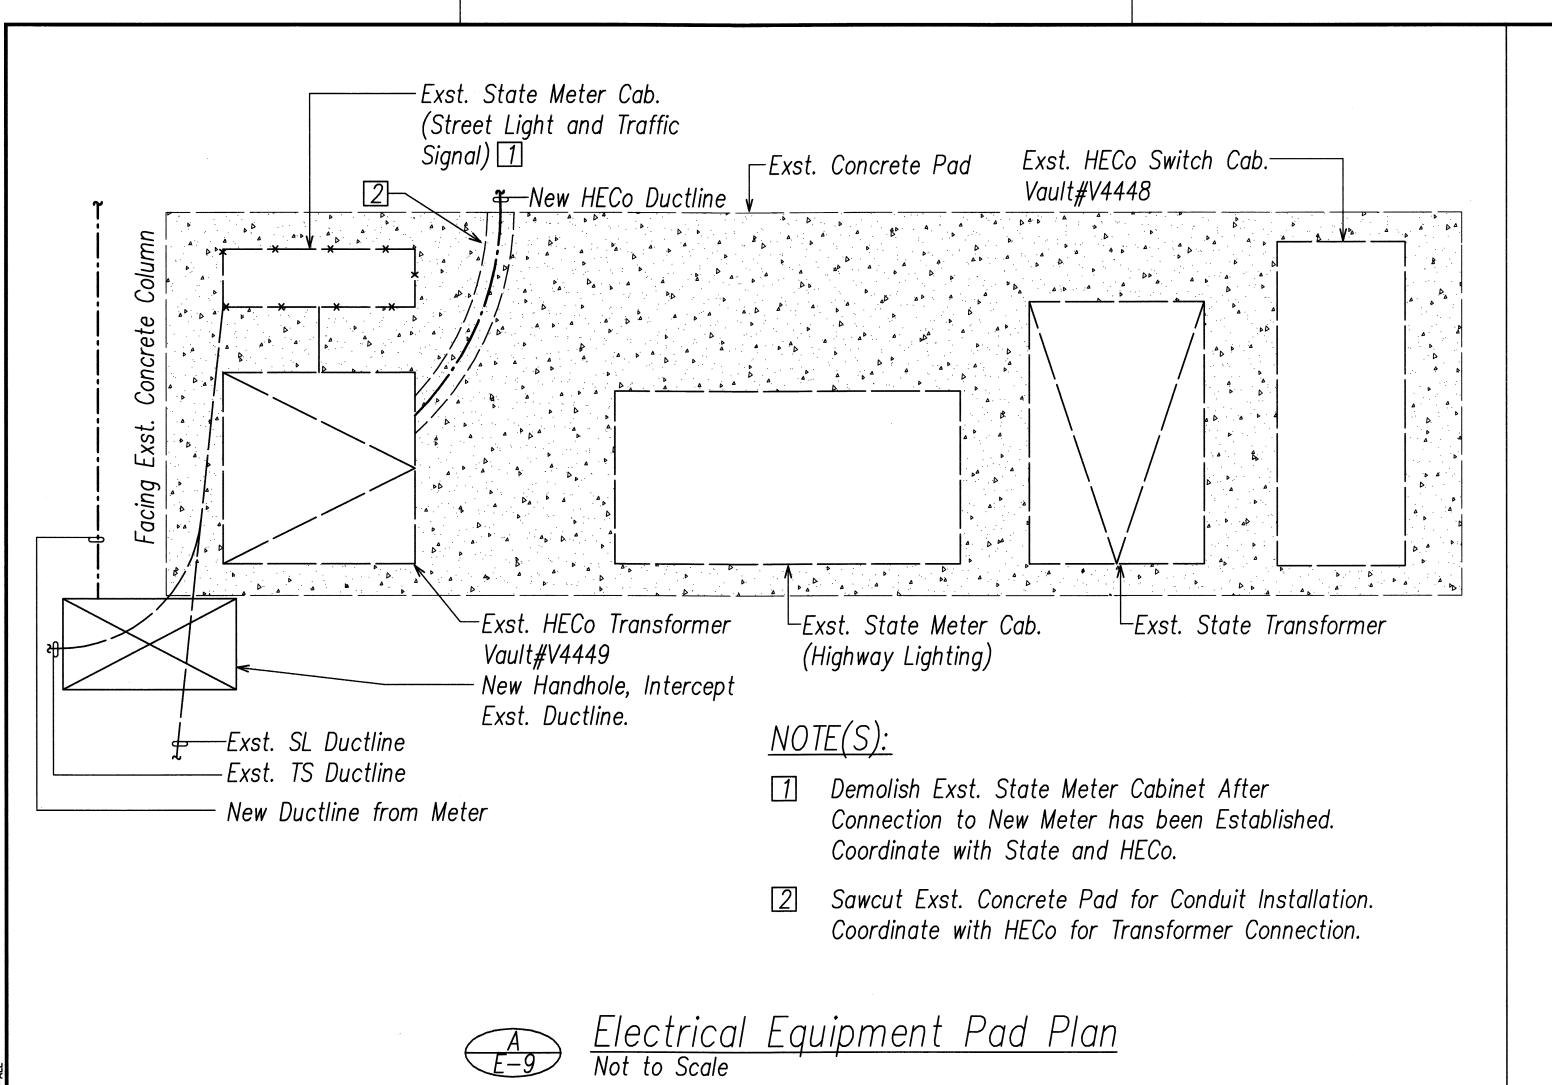

FISCAL SHEET TOTAL YEAR NO. SHEETS FEDERAL AID PROJ. NO. FED. ROAD DIST. NO. STATE IM-0300(127) 2011 42 HAW.

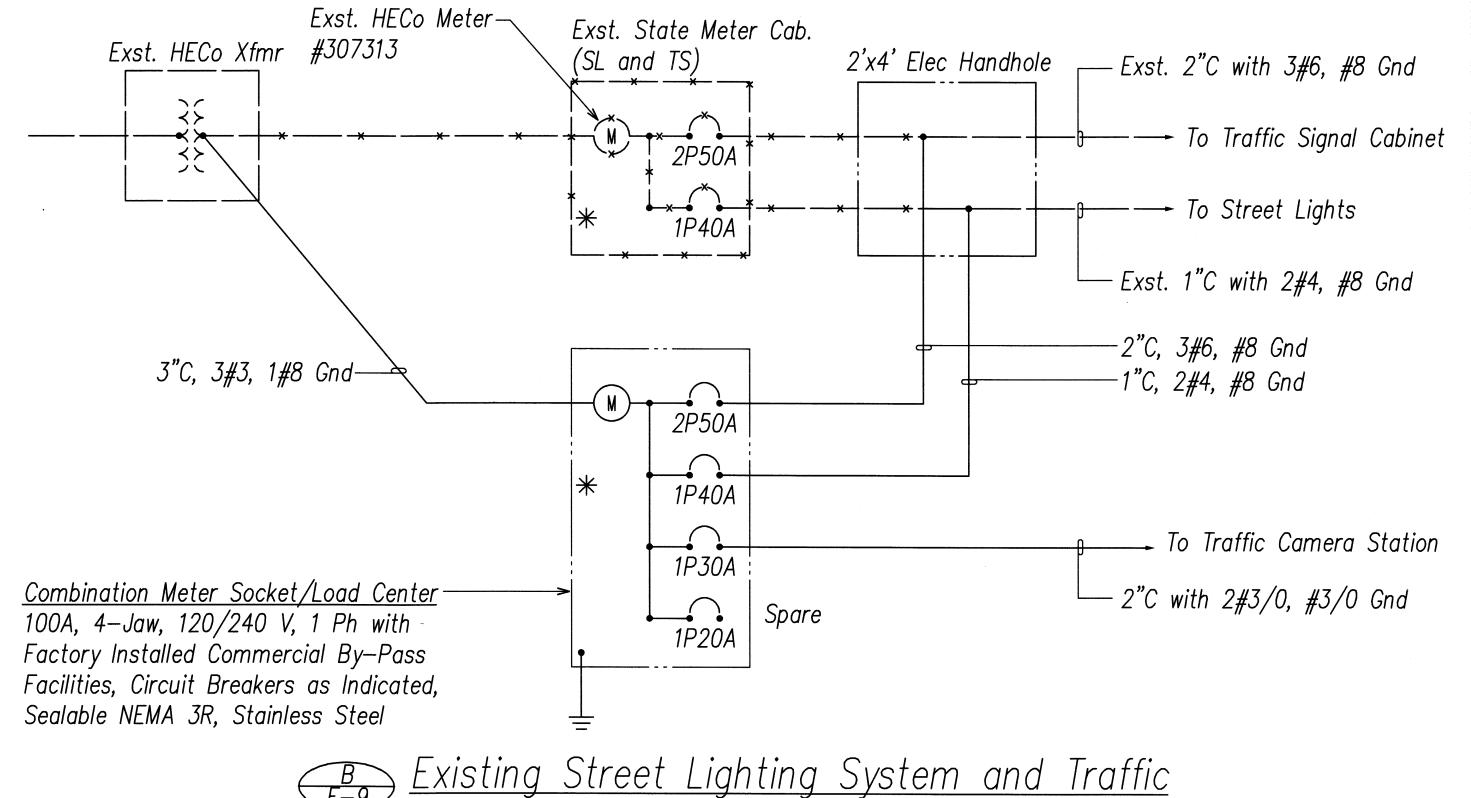

Signal Service One-Line Diagram
Not to Scale

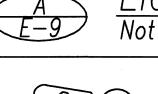


Connect to Exst. Stub-outs

-10' from Finish Grade

NOTE(S):

- $\boxed{1}$ Pull New 1-3C#3/0 in 2" Conduit.
- Provide New 72—Strand Single Mode Fiber Optic Cable Through One 2" Conduit.
- Provide New 24-Strand Single Mode Fiber Optic Cable Through One 2" Conduit.
- Contractor to Tone for Electrical Ductline and Intercept with Handhole.
- Sawcut Exst. Concrete Pad for Conduit Installation.
- Exst. State Meter Cab. (SL and TS)
- See Communications Plan for Fiber Splice Details.
- Provide New 24-Strand Single Mode Fiber Optic Cable Through Exst. 2" Conduit.
- Route Ductline Under Exst. Telephone and Gas lines. Provide 12" Vertical Clearance from both Telephone and Gas lines.

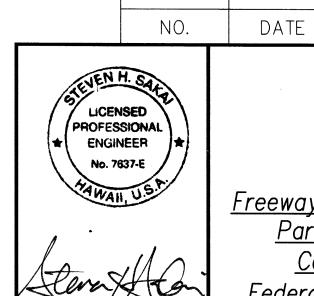

STATE OF HAWAII

DEPARTMENT OF TRANSPORTATION

HIGHWAYS DIVISION Valkenburgh Detail

REVISION

Freeway Management System, Phase 1C, Part 1B: Installation of CCTV and Communication Infrastructure <u>Federal Aid Project No. IM-0300(127)</u> SCALE: As Noted DATE: 9-7-11

SHEET No. E-9 OF 11 SHEETS

SURVEY
DRAWN
TRACED
DESIGNE

New Fiber Cabinet 7

Exst. Handhole-

Handhole

Cabinet 🗾

Exst. Traffic Signal

Exst. Traffic Signal-

Exst. Traffic Camera


Exst. Concrete Column


Enlarged Communication Equipment Plan SCALE: 1"=10'


SCALE: GRAPHIC SCALE

NOTES:

- 1. All Conduits to Contain a Polyolefin Pull Line.
- 2. Pedestal shall be Hot-Dipped Galvanized After Fabrication.
- 3. All Fastening Bolts, Nuts & Washers shall be 316 Stainless Steel.
- 4. Provide 4 Ft Clearance in Front of Meter.
- 5. See One-Line Diagram on B/E-9.
- 6. Contractor shall Make All Electrical Connection to Traffic Camera Cabinet.

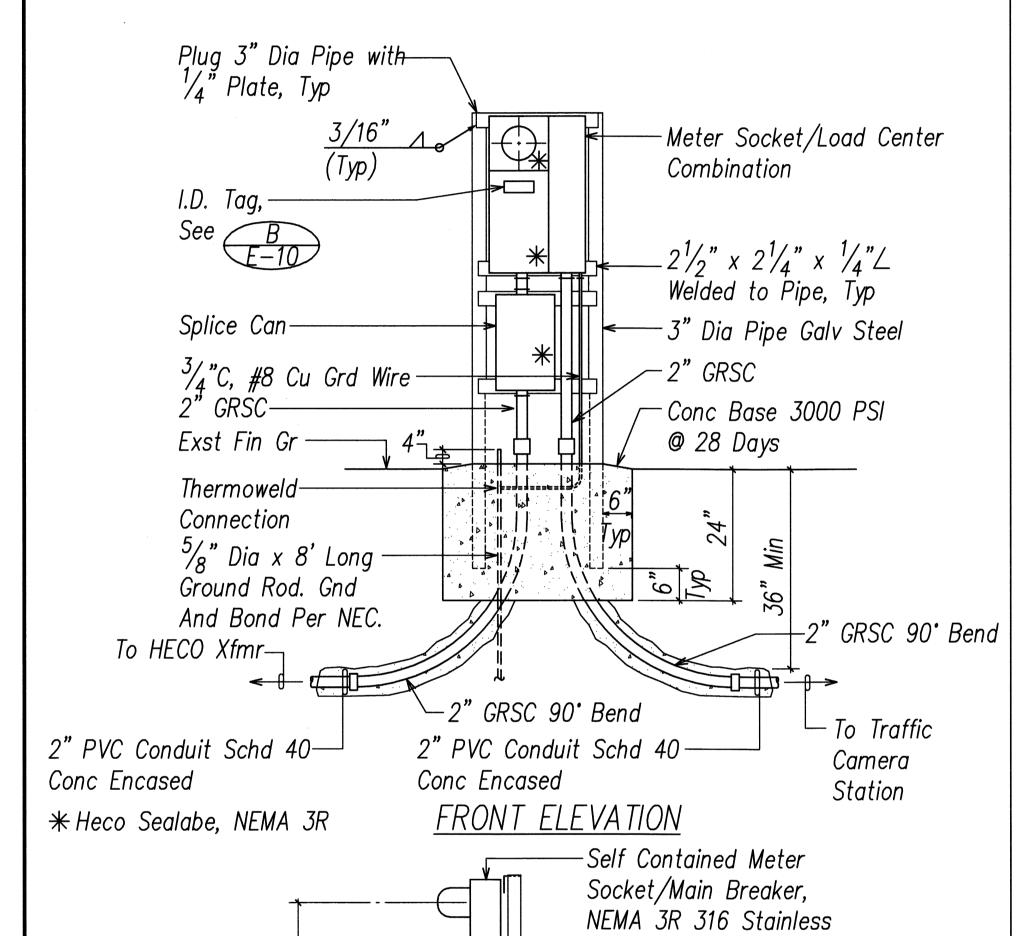

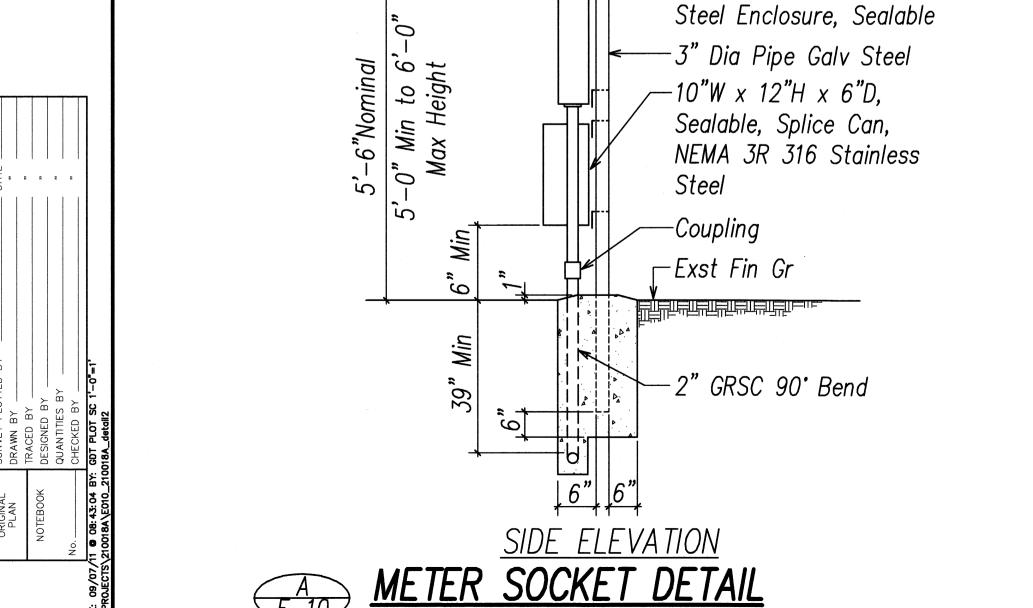

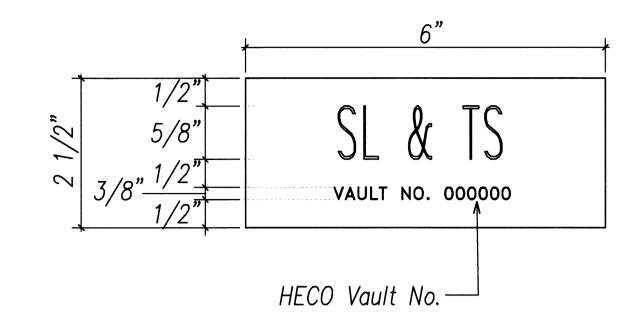

NOTES:

- 1. Use 3-Ply Laminated Flexible Plastic, Black-White-Black Thickness: Black Cap Sheet-0.010", White Base Sheet-0.052", Black Base Sheet-0.010".
- 2. Attach to Meter Socket Using Scotch 3M Brand Very High Bond (VHB) Double Coated Acrylic Foam Tape or Equivalent.
- 3. Letters/Numbers shall be 1/16" Stroke, (White in Color).
- 4. Letters/Numbers Area Inscribed by Cutting through "Black Cap Sheet" to Expose White Letters/Numbers.



ED. ROAD DIST. NO.	STATE	FEDERAL AID PROJ. NO.	FISCAL YEAR		TOTAL SHEETS
HAWAII	HAW.	IM-0300(127)	2011	43	60

LICENSED
PROFESSIONAL
ENGINEER
No. 7637-E

NO. DATE REVISION

DEPARTMENT OF HAWAII

DEPARTMENT OF TRANSPORTATION


HIGHWAYS DIVISION


Meter Pedestal Detail


Freeway Management System, Phase 1C,
Part 1B: Installation of CCTV and
Communication Infrastructure
Federal Aid Project No. IM-0300(127)
SCALE: As Noted DATE: 9-7-11

SHEET No. E-10 OF 11 SHEETS

FED. ROAD DIST. NO.	STATE	FEDERAL AID PROJ. NO.	FISCAL YEAR	SHEET NO.	TOTAL SHEETS
HAWAII	HAW.	IM-0300(127)	2011	44	60

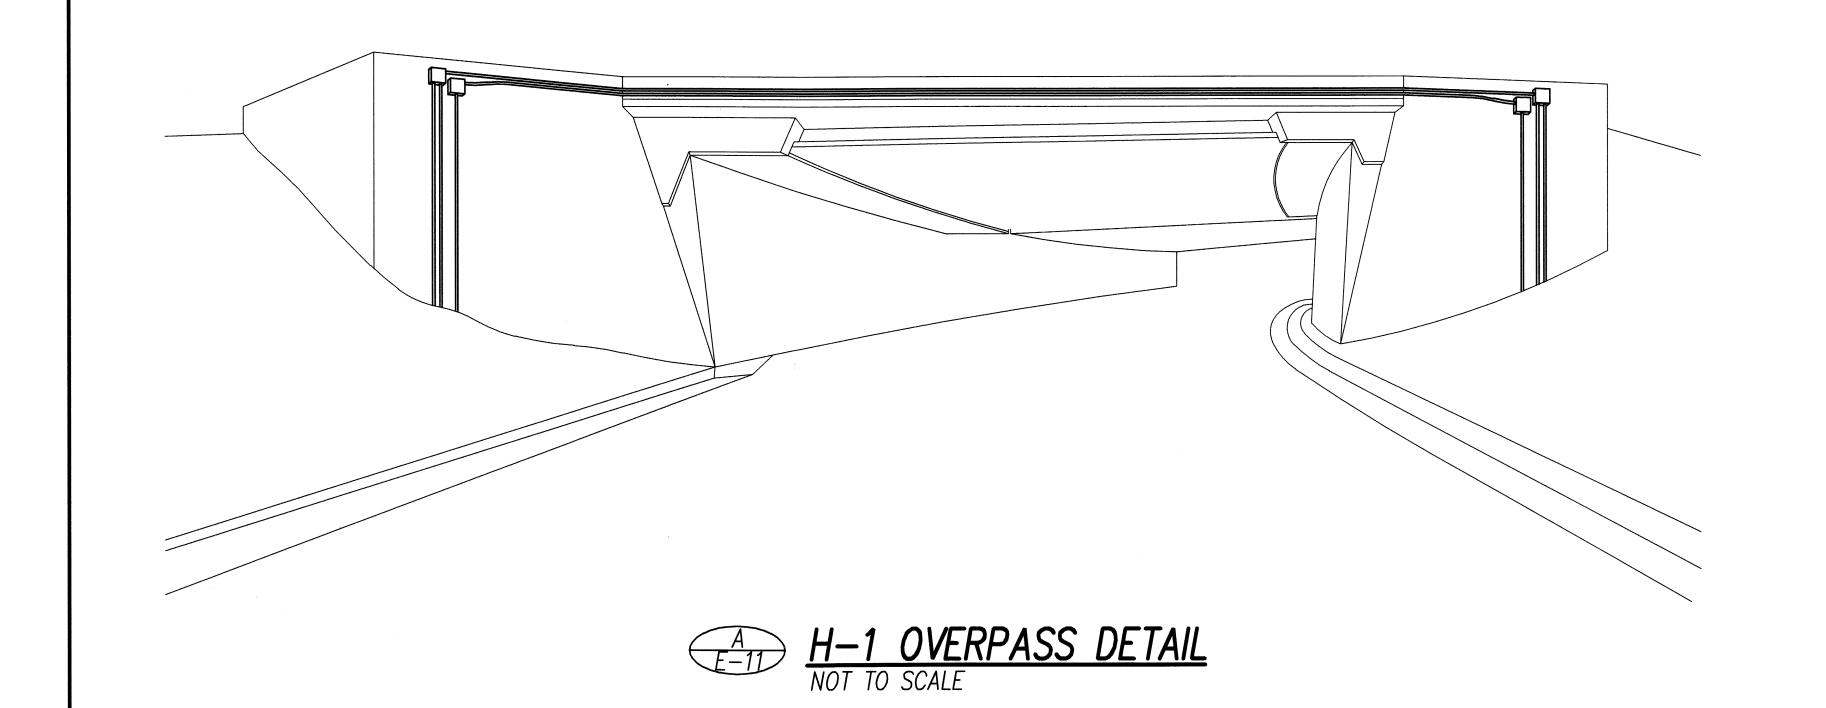

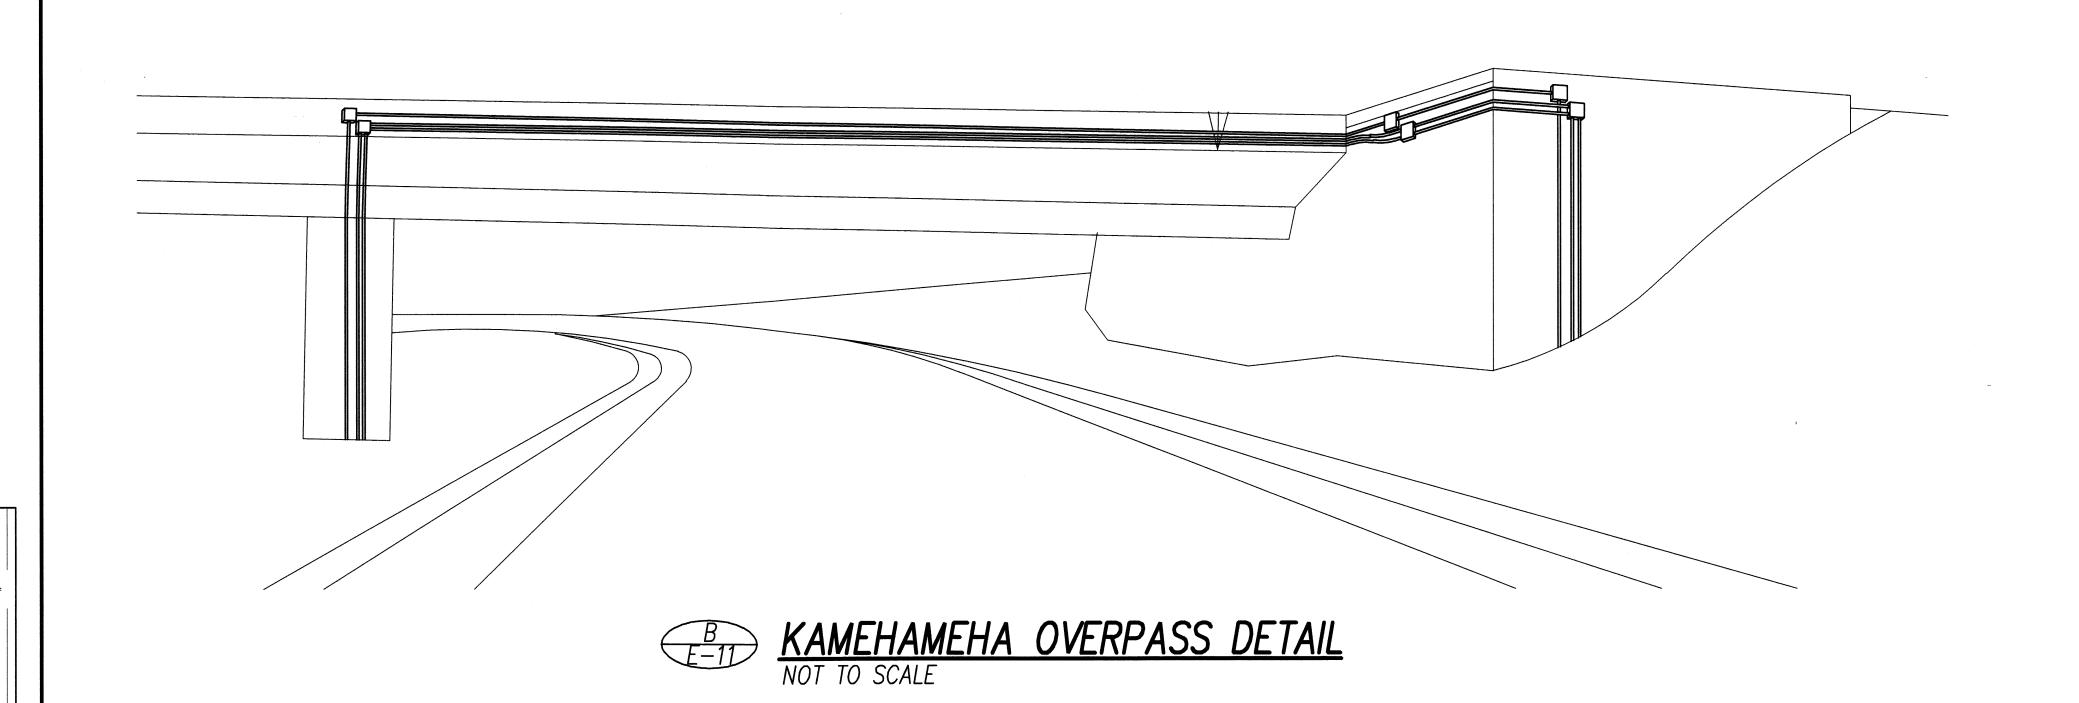

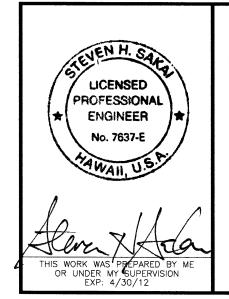

STATE OF HAWAII

DEPARTMENT OF TRANSPORTATION

HIGHWAYS DIVISION

ELECTRICAL & SIGNAL PLAN - III

Freeway Management System, Phase 1C,

Part 1B: Installation of CCTV and

Communication Infrastructure

Federal Aid Project No. IM-0300(127)

SCALE: As Noted DATE: 9-7-11

SHEET No. E-11 OF 11 SHEETS