TRAFFIC SIGNAL NOTES

- 1. A solid #8 bare copper wire shall be pulled within all conduits for equipment ground. Cost shall be incidental to the installation of the control cable.
- 2. Conduits and pullbox locations as shown on the plans are schematic. They may be modified by the Contractor with the approval of the Engineer.
- 3. The Contractor shall install the controller and cabinet in the indicated location.
- 4. All work for the installation or modification of the Weigh—In—Motion system shall conform to the latest revisions of the "Hawaii Standard Specifications for Road and Bridge Construction, 1994" and the "Standard Plans" of the Department of Transportation, Highways Division and as shown on these drawings.
- 5. All splicing shall be done in the pullboxes.
- 6. Furnishing and installing the conduit stubouts (pullboxes to edge of pavement will not be paid for separately but shall be considered incidental to the various contract items.
- 7. The concrete jacket for the Conduit By-pass Detail shown on this sheet shall not be paid for separately but considered incidental to the various contract items. The Engineer shall determine if a concrete jacket is required.
- 8. All cable and elements for grounding shall be new.
- 9. Unless otherwise specified, all conduits shall be PVC.


LEGEND

NEW

- Type "A" Pullbox
- Type "B" Pullbox
- Type "C" Pullbox
- Controller and 336 Cabinet on New Base
- Loop Detector


CONSTRUCTION NOTES

- 1. Locations of existing underground structures and utilities such as pipelines, conduits, cables, etc., shown on plans are approximate only. It is not the intent of these plans to show the exact location of all underground utilities and structures. It is the responsibility of the Contractor to verify the locations of all existing utilities with the respective owners. Existing utilities damaged by the Contractor shall be repaired by the Contractor at his own cost.
- 2. The Contractor shall verify and check all dimensions and details shown on the drawings prior to the start of construction. Any discrepancy shall be immediately brought to the attention of the Engineer for clarification.
- 3. The Contractor shall notify all Agencies to verify, tone and locate their existing utilities within the project area prior to excavating. The Contractor shall coordinate all work.
- 4. The locations of the new weigh pad, controller, pullboxes, conduits and loop detectors shall be staked out in the field by the Contractor and approval of the locations shall be obtained from the Engineer prior to construction and installation.
- 5. All traffic signal work shall conform to the requirements of the "Manual on Uniform Traffic Control Devices Millennium Edition", Federal Highway Administration (2000) and amendments.
- 6. Maintenence of traffic through the construction area shall be in accordance with Part VI of the "Manual on Uniform Traffic Control Devices Millennium Edition", Federal Highway Administration (2000) as amended and as specified in the Special Provisions. The Contractor shall furnish and maintain adequate barricades, blinkers, construction signs, etc., for the safety of the motoring public.
- 7. At the end of each day's work, the Contractor shall remove all equipment and other obstructions to permit free and safe passage of public traffic.

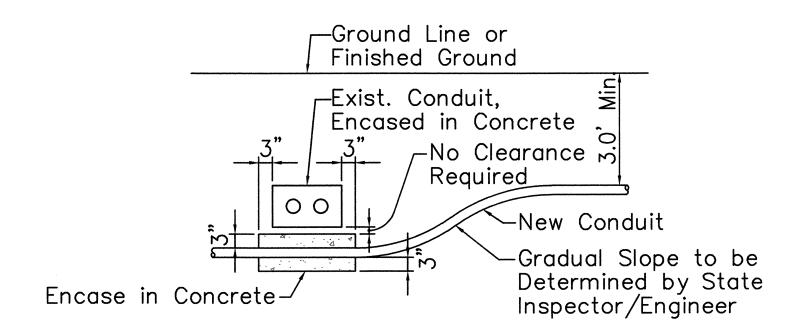

CONDUIT BY-PASS DETAIL

Not to Scale

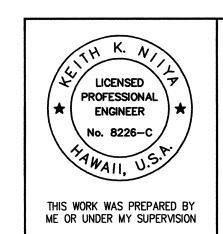

DATE: **S/9/01**

STATE OF HAWAII DEPARTMENT OF TRANSPORTATION

WEIGH-IN-MOTION STATION NOTES AND LEGEND

INTERSTATE ROUTE H-1

FED. ROAD STATE

DIST. NO.

FED. AID PROJ. NO.


HAW. | IM-NH-H1-1(239) | 2001 | 97


FISCAL SHEET TOTAL YEAR NO. SHEETS

Palailai Interchange Reconstruction F.A.I. Project No. IM-NH-H1-1(239) BY: JUL JKDC

> Scale: As Noted Date: 4/01/01 SHEET NO. W1 OF 6 SHEETS

> > 97

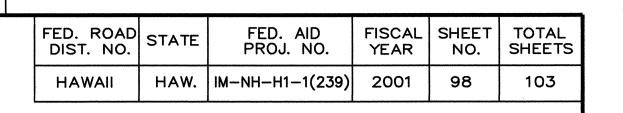


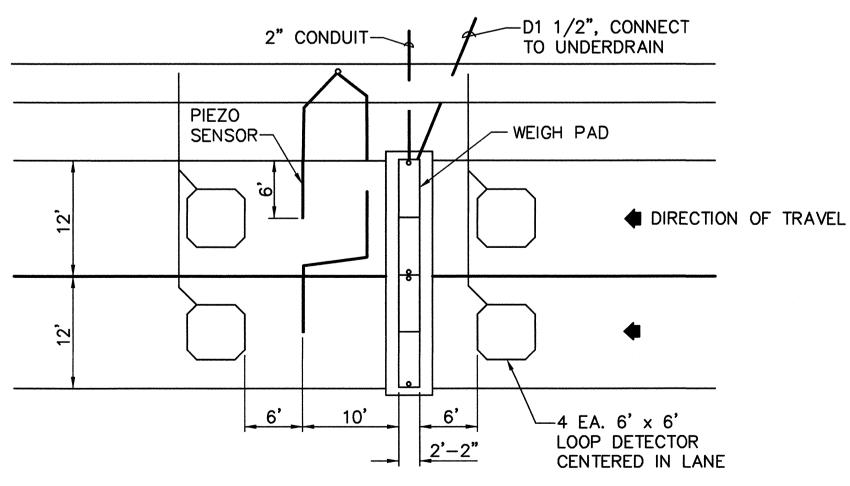


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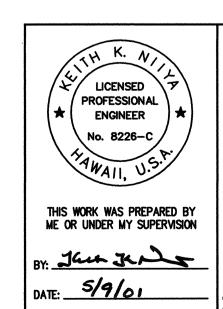
DATE: 01/31/01 PLOT SCALE: 1 = FILE: W2.dwg JOB. NO.: 9810B

WEIGH-IN-MOTION SYSTEM DETAILS
NO SCALE

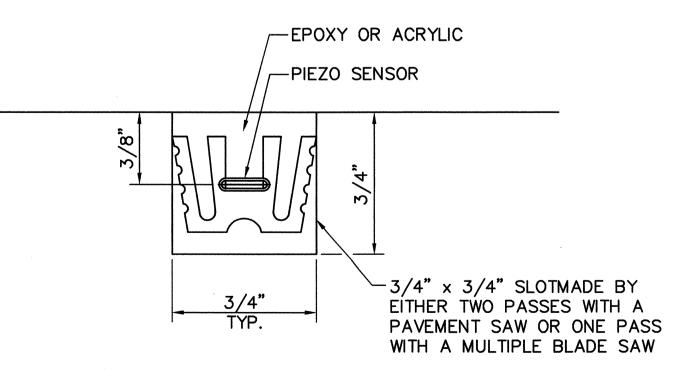

PIEZO SENSOR DETAIL
NO SCALE



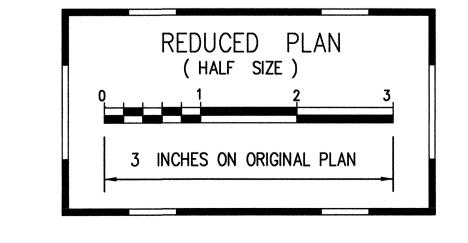

STATE OF HAWAII

DEPARTMENT OF TRANSPORTATION

HIGHWAYS DIVISION

ACTUALISM

WEIGH-IN-MOTION STATION PLAN AND DETAILS

INTERSTATE ROUTE H-1


WAS PREPARED BY R MY SUPERVISION Palailai Interchange Reconstruction


F.A.I. Project No. IM-NH-H1-1(239)

Scale: As Noted Date: 4/01/01 SHEET NO. W2 OF 6 SHEETS


0 SHEETS

98

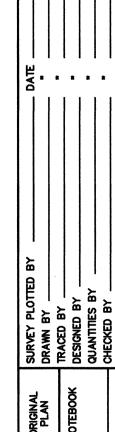

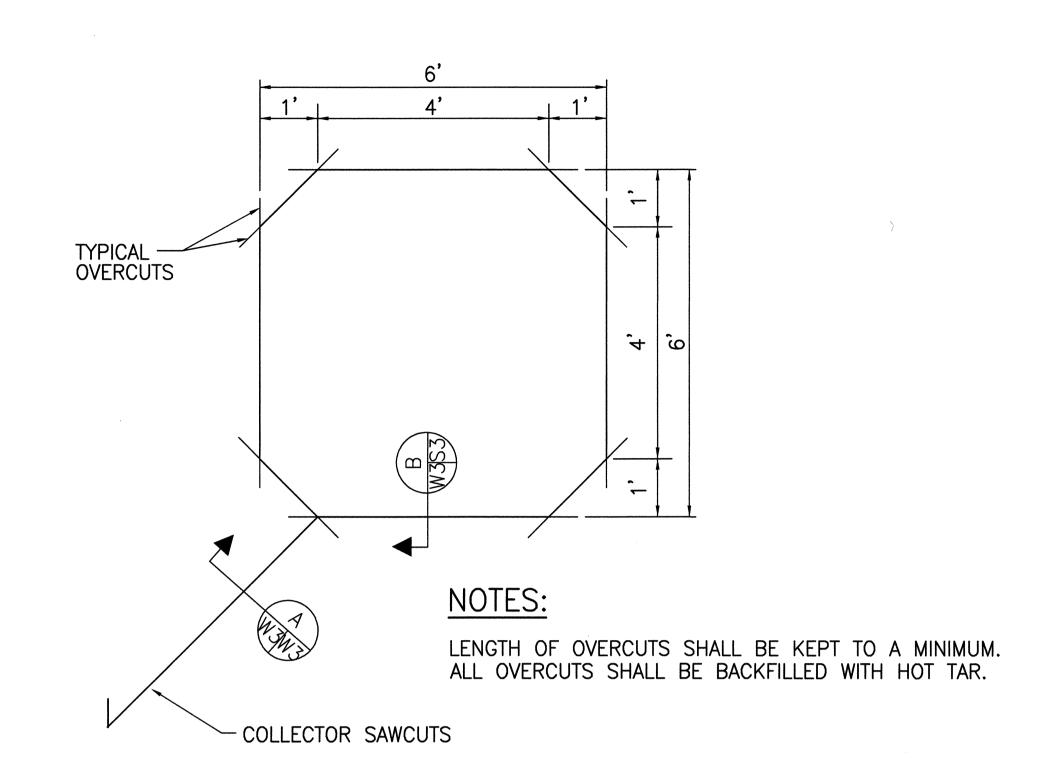


TYPICAL SENSOR LOOP SAWCUT DETAIL NOT TO SCALE

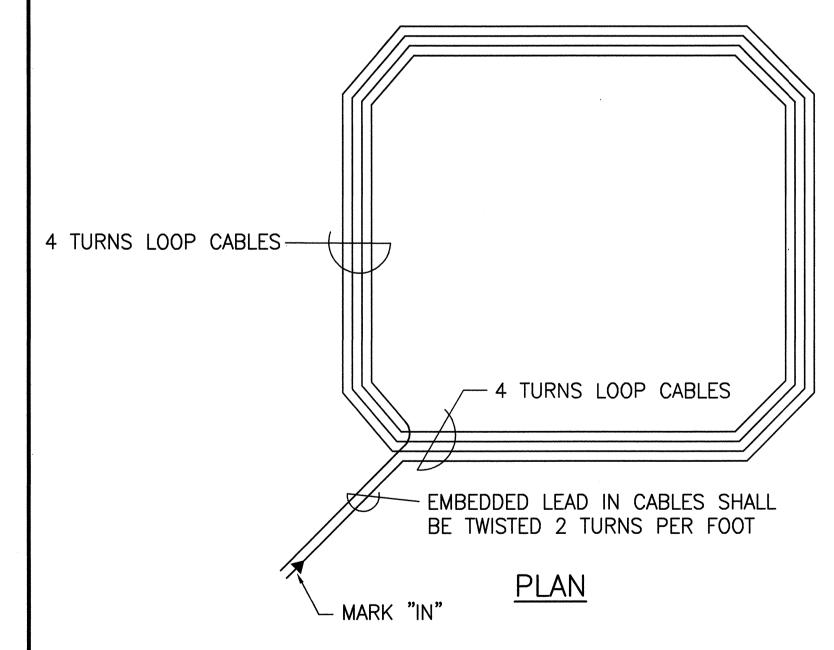


TYPICAL SENSOR LOOP WIRING DIAGRAM

NOT TO SCALE

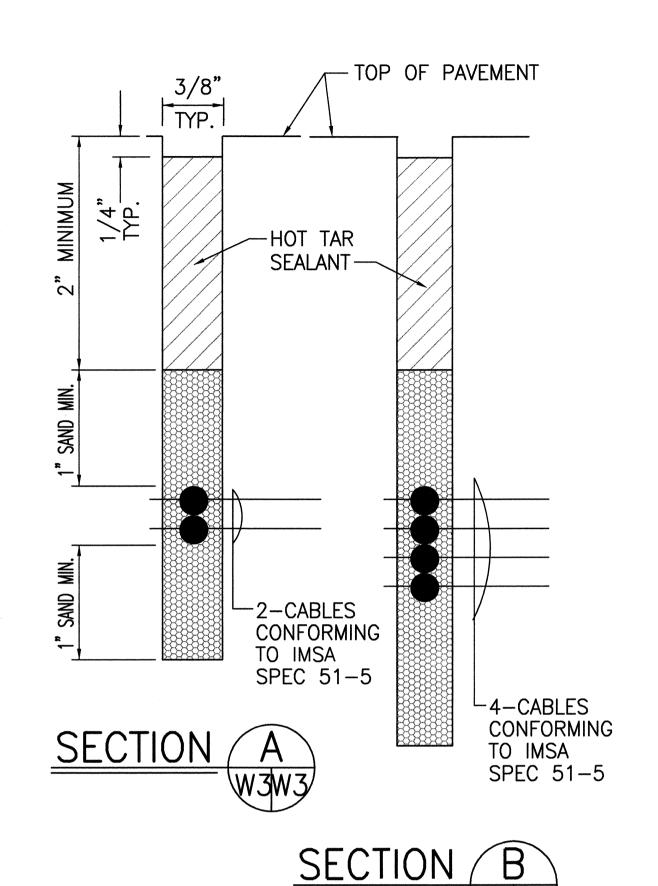

FED. ROAD DIST. NO. STATE FED. AID PROJ. NO. FISCAL SHEET NO. SHEETS

HAWAII HAW. IM-NH-H1-1(239) 2001 99 103

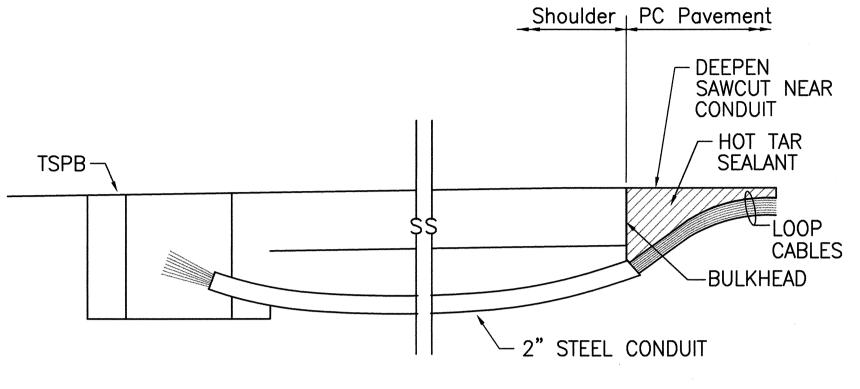



NOTES ON CONSTRUCTION AT END OF SAWCUT

- 1. SEAL ROADWAY END OF CONDUIT AFTER INSTALLATION OF CONDUCTORS
- 2. INSTALL BULKHEAD ACROSS CONDUIT TRENCH.
- 3. PLACE HOT TAR IN SAWCUT.
- 4. BACKFILL OVER CONDUIT WITH NEW A.C.
- 5. RECONSTRUCT CURB AND GUTTER AS REQUIRED.

DETAIL OF SENSOR LOOP INSTALLATION AT EDGE OF ROADWAY

NOT TO SCALE

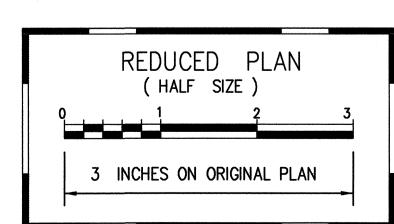

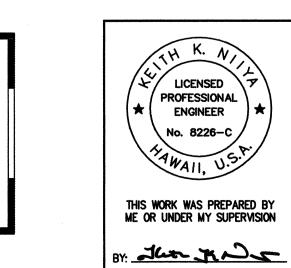

DATE: 5/9/01

STATE OF HAWAII
DEPARTMENT OF TRANSPORTATION
HIGHWAYS DIVISION


SENSOR LOOP DETAILS


INTERSTATE ROUTE H-1


Palailai Interchange Reconstruction F.A.I. Project No. IM-NH-H1-1(239)

Scale: As Noted Date: 4/01/01

SHEET NO. W3 OF 6 SHEETS

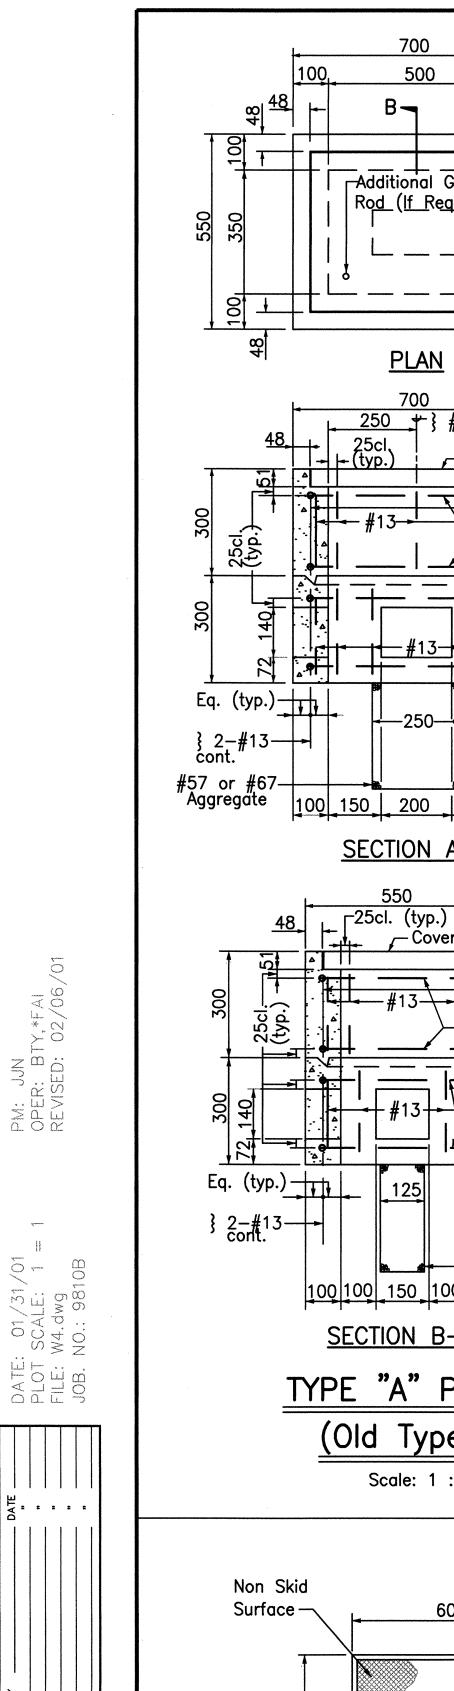

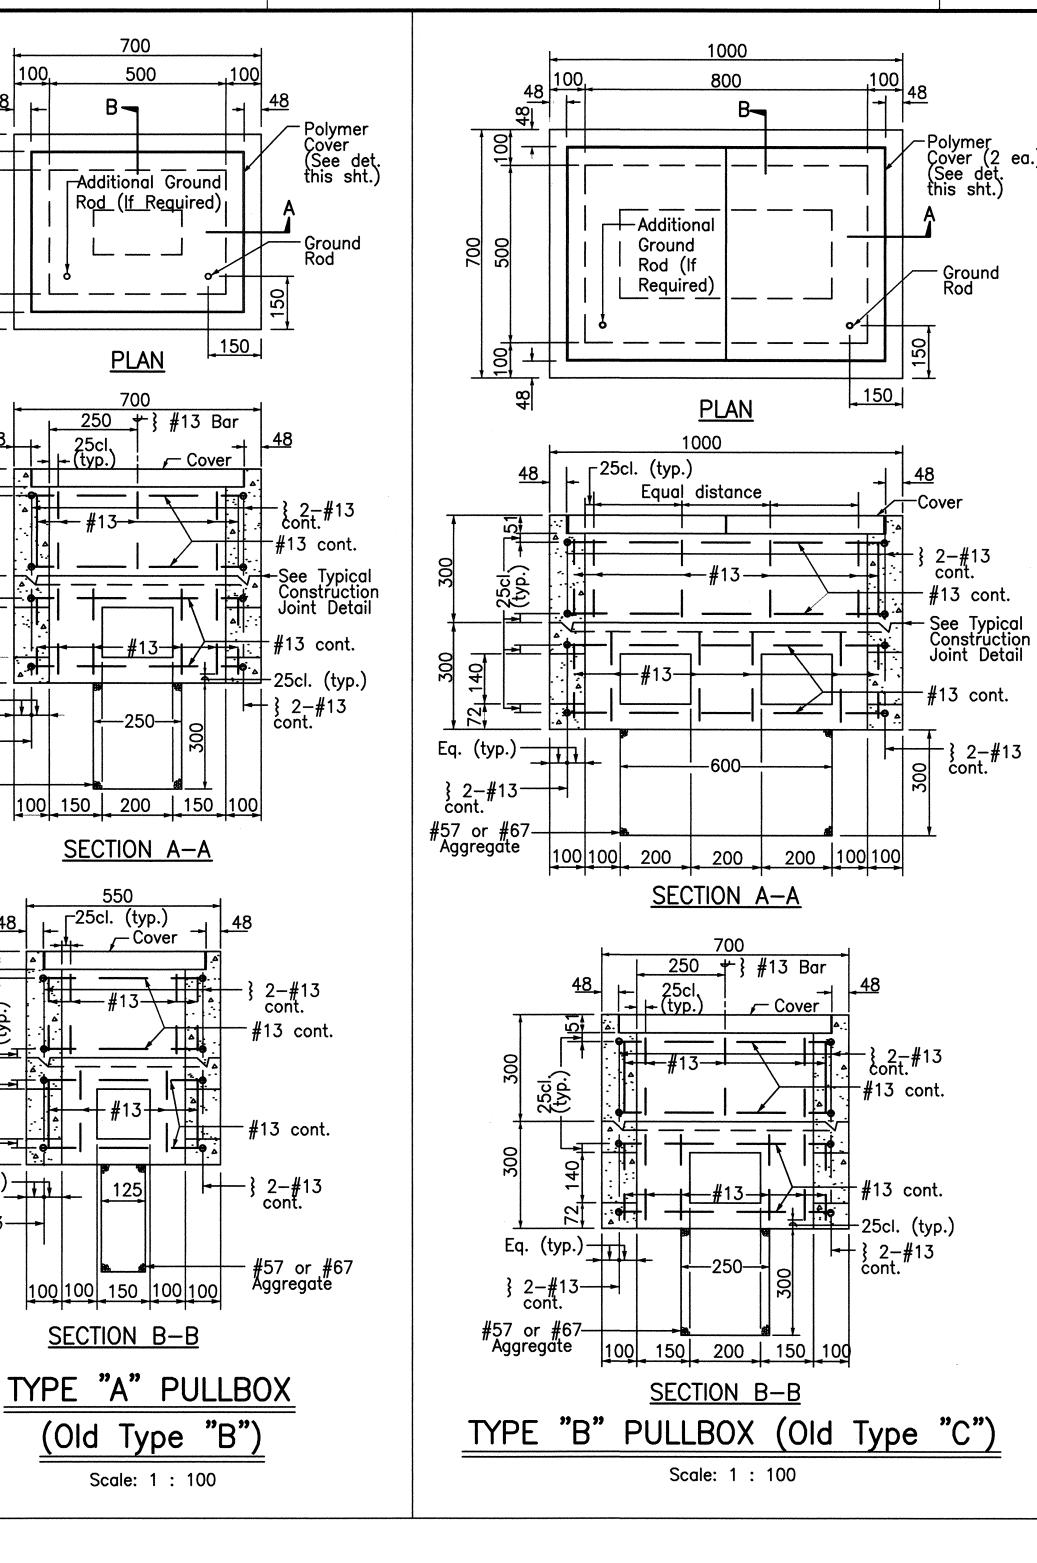

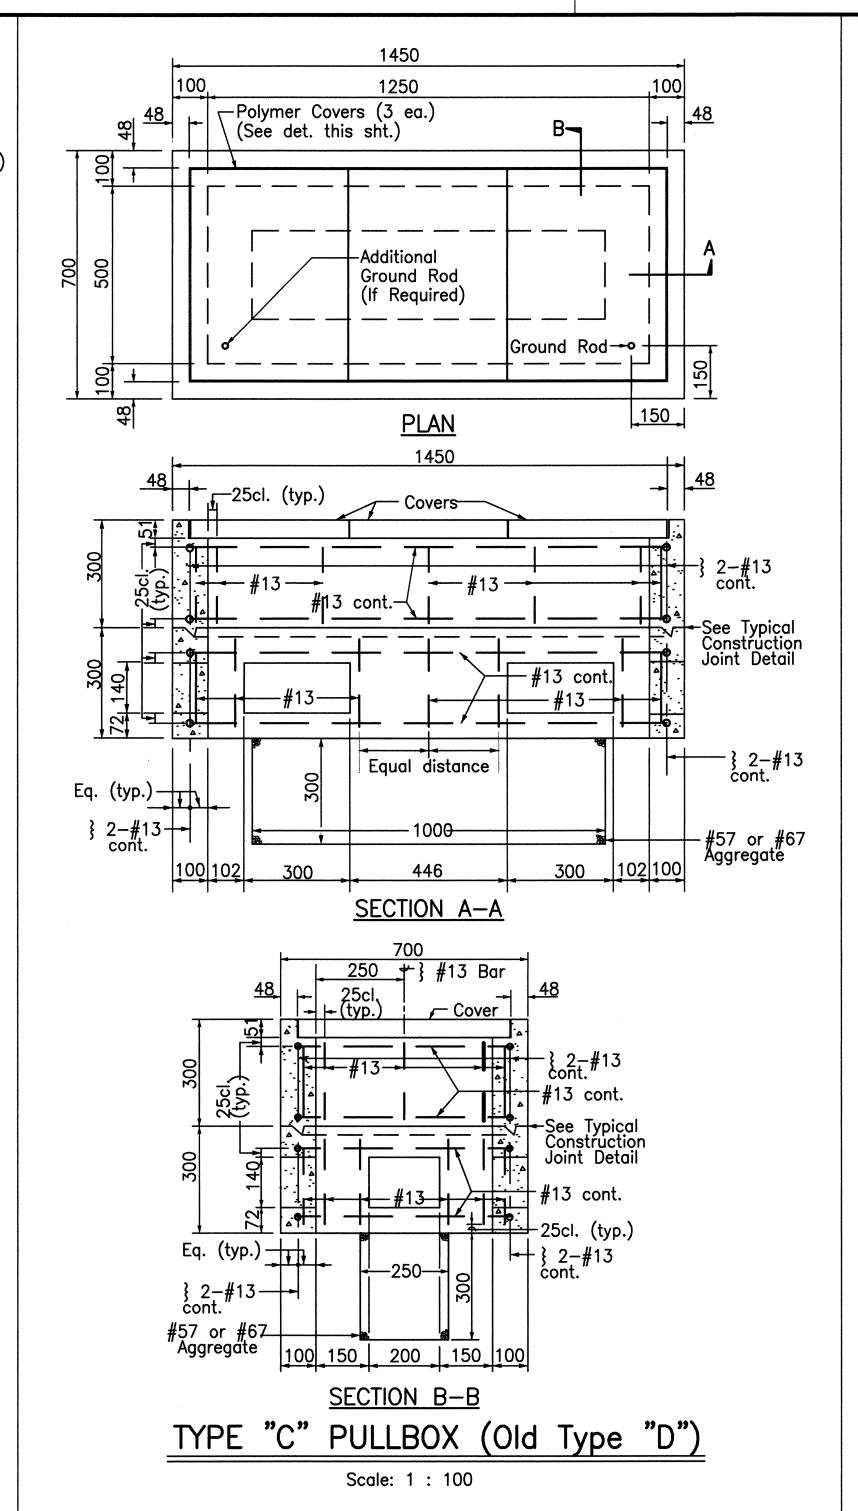


FED. ROAD DIST. NO. STATE FED. AID PROJ. NO. FISCAL SHEET TOTAL SHEETS

HAWAII HAW. IM-NH-H1-1(239) 2001 100 103


GENERAL NOTES


- 1. Provide a minimum of one 160 x 2.5m Copperweld Ground Rod in each pullbox. When directed by the Traffic Signal Inspector/Engineer, install additional Ground Rods. Cost of Ground Rods shall be incidental to the pullboxes.
- 2. All pre-cast concrete pullboxes shall be manufactured in two pieces.
- 3. The pullbox with cover shall be capable of supporting an MS 18 Loading.
- 4. The maximum weight of the pullbox cover shall not exceed 27 kilograms.
- 5. The openings for the conduits on all pullboxes shall be pre—cast concrete knockouts.
- 6. After installing the conduits in the openings of the pullboxes, the Contractor shall fill the excess opening in the pre—cast knockouts with concrete mortar.
- 7. Prior to installing the pullboxes, the Contractor shall level the bottom of the trench and achieve a minimum of 95% relative compaction of the bottom of the trench.
- 8. All concrete shall be Class A (21MPa or 3000PSI, min.)
- 9. Rebars shall be Grade 300 and all lapped splices shall be 360mm minimum.
- 10. The #57 or #67 size aggregate shall conform to latest version of of AASHTO M32 (ASTM D 448).
- 11. Type "C" Pullbox shall be installed in a location protected from vehicular traffic (i.e. raised sidewalk, behind A.C. curbs, traffic signal standard or pipe guards).

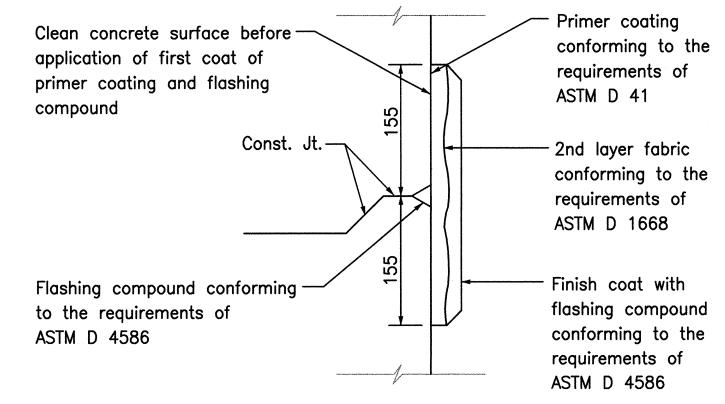

TYPICAL FLASHING COMPOUND WATERPROOFING DETAILS

Not to Scale

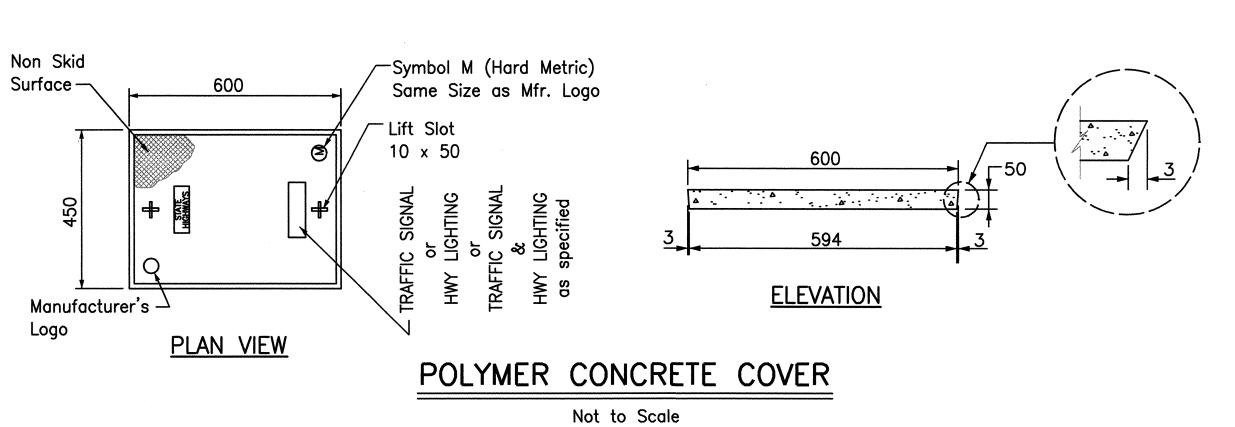


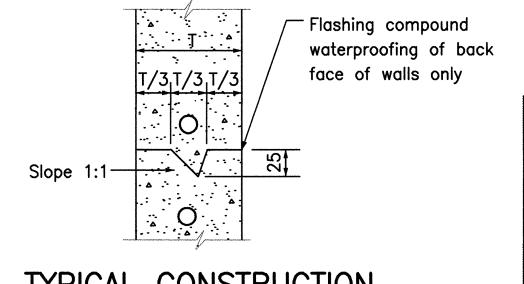


TYPICAL CONSTRUCTION

JOINT DETAIL


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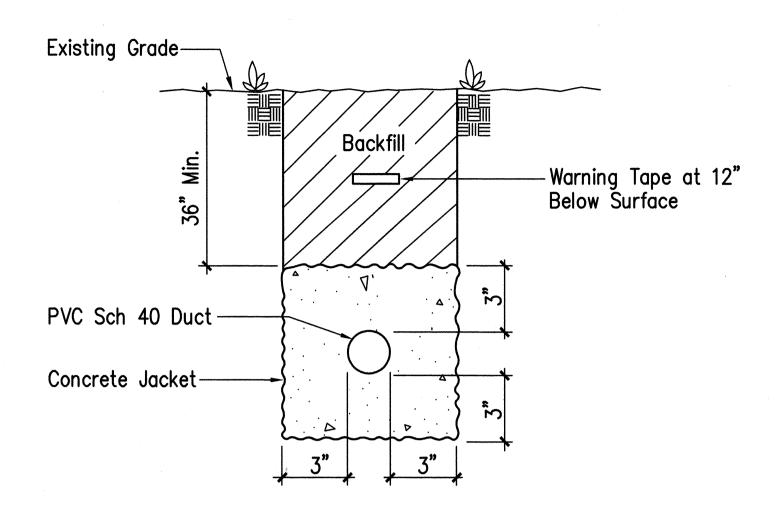
UNLESS OTHERWISE SHOWN

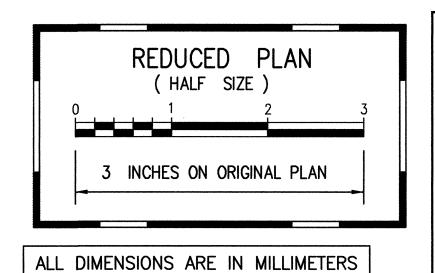

100

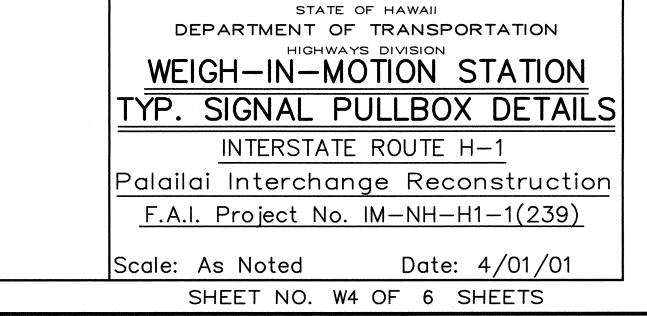


FED. ROAD DIST. NO.	STATE	FED. AID Proj. NO.	FISCAL YEAR		TOTAL SHEETS
HAWAII	HAW.	IM-NH-H1-1(239)	2001	102	103

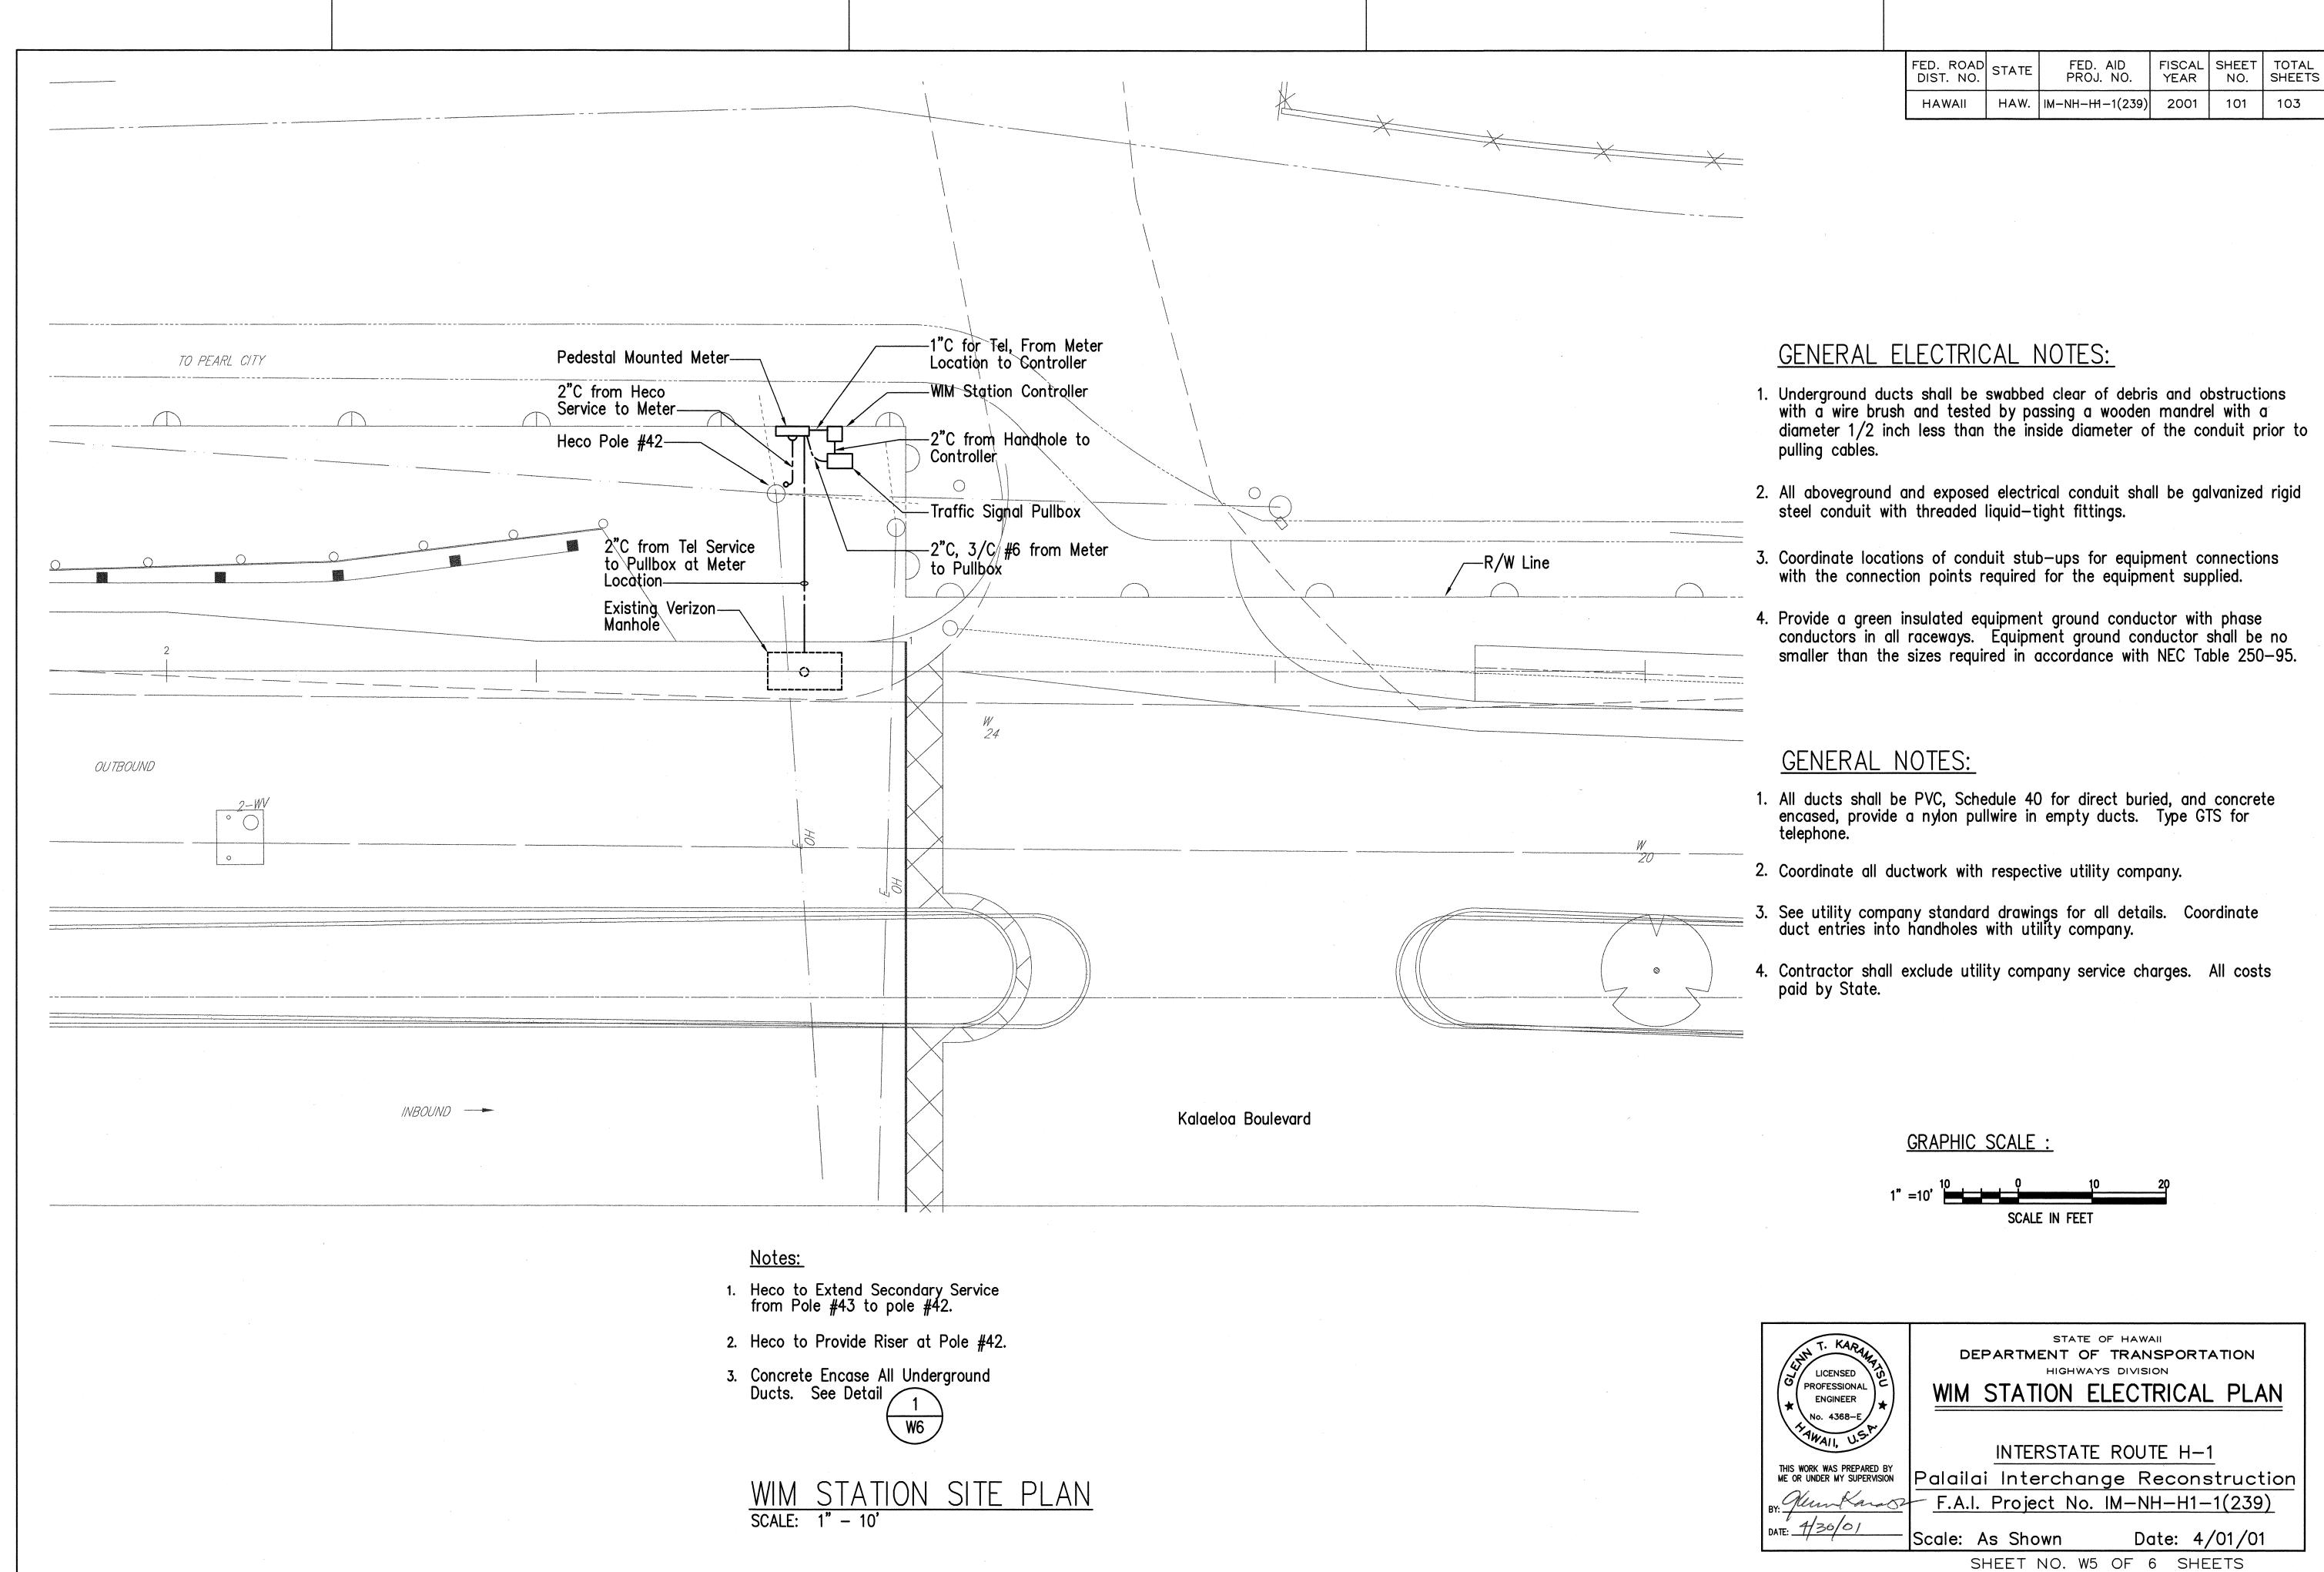



* Concrete Encase All Duct Runs



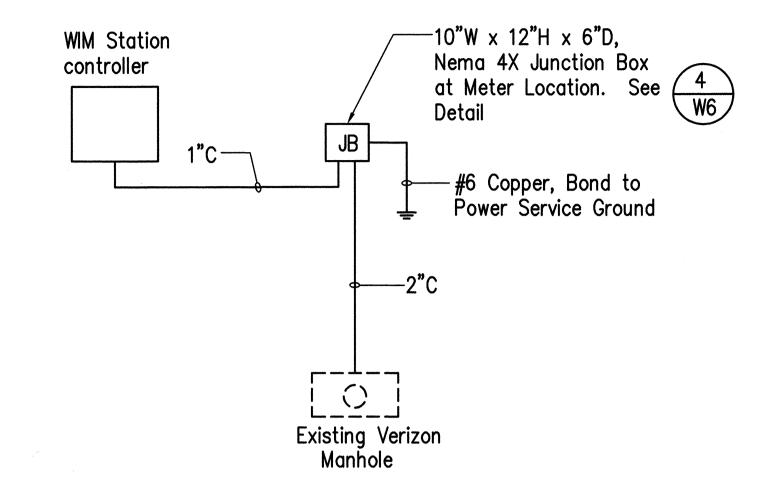

TELEPHONE SERVICE DIAGRAM W6 NO SCALE

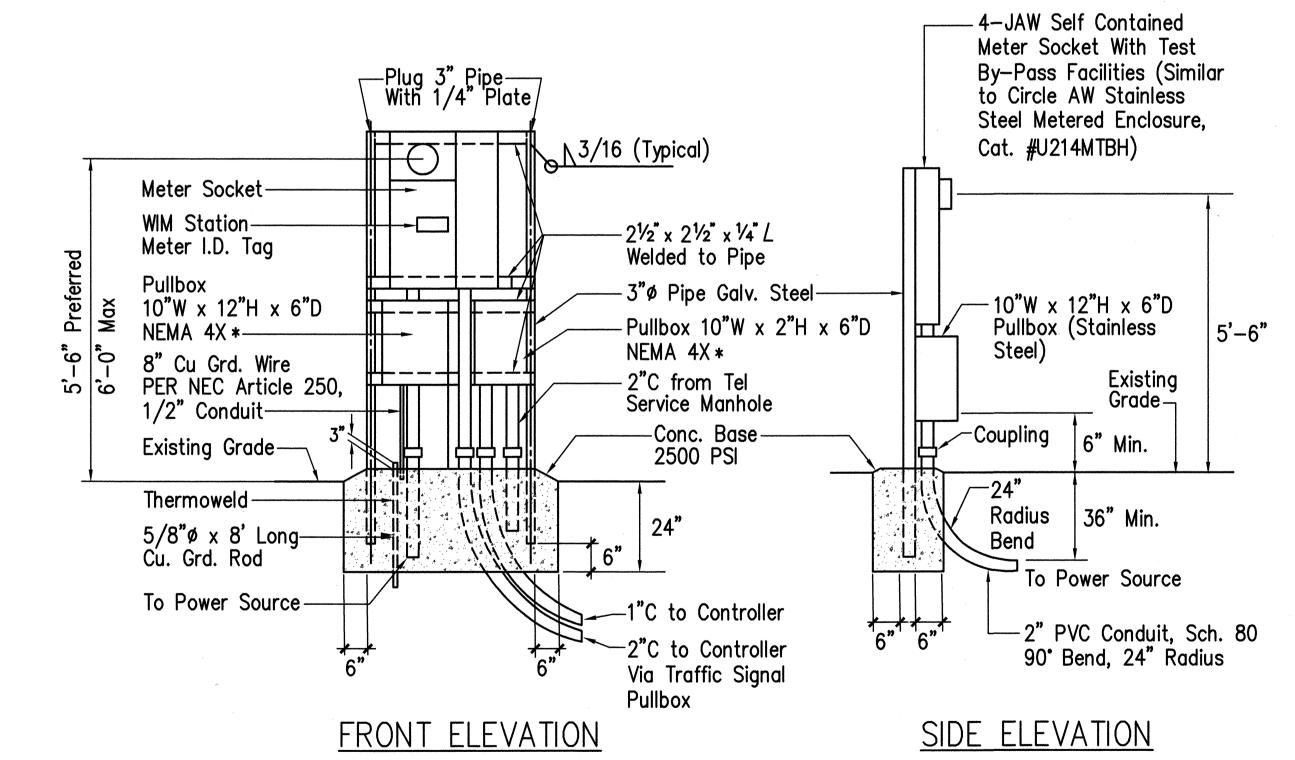


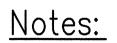

Pedestal Shall Be Hot-Dipped Galvanized After Fabrication. All Fastening Bolts, Nuts and Washers Shall Be Stainless Steel.
Provide 4 Ft. Cl. in Front of Meter.

* Sealable NEMA 4x Stainless Steel Enclosure 10"W x 12"H x 6"D.

METER PEDESTAL FOR UNDERGROUND SERVICE DETAIL W6/ NO SCALE

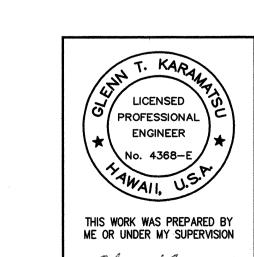


STATE OF HAWAII DEPARTMENT OF TRANSPORTATION

WIM STATION ELECTRICAL DETAILS

INTERSTATE ROUTE H-1 Palailai Interchange Reconstruction "Glew Karenda F.A.I. Project No. IM-NH-H1-1(239) DATE: 4/30/01


Scale: As Shown Date: **4/01/01**

SHEET NO. W6 OF 6 SHEETS

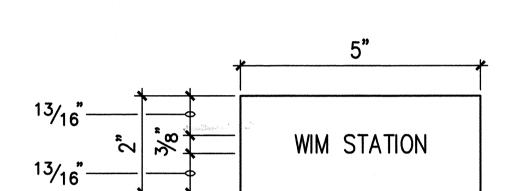

- Use 3-Ply Laminated Flexible Plastic, Black-White-Black "Thickness: Black Cap Sheet-0.010", White Base Sheet-0.052", Black Base Sheet-0.010".
- Attach to Meter Socket Using Scotch 3m Brand Very High Bond (VHB) Double Coated Acrylic Foam Tape or Equivalent.
- 3. Letters/Numbers Shall be 3/8" High, 1/16" Stroke, (White in Color).
- 4. Letters/Numbers Area Inscribed by Cutting Through "Black Cap Sheet" to Expose White Letters/Numbers.

METER ID TAG DETAIL

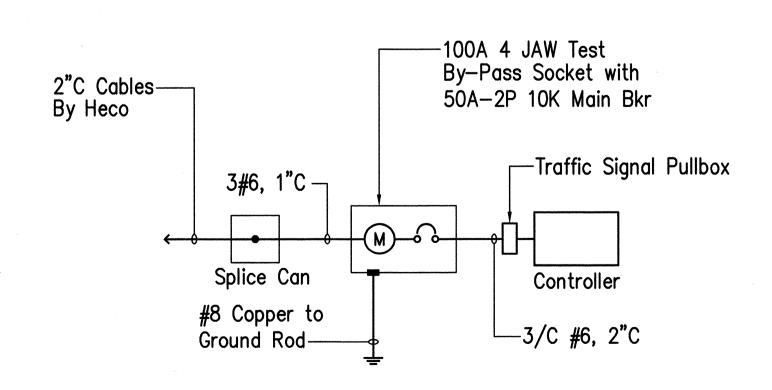

ONE-LINE DIAGRAM NO SCALE