

FED. ROAD DIST. NO. FED. AID PROJ. NO. FISCAL YEAR TOTAL SHEETS 56 HAW. HIC-01-90

> PROFESSIONAL ENGINEER

THIS WORK WAS PREPARED BY ME OR UNDER MY SUPERVISION.

DEPARTMENT OF TRANSPORTATION HIGHWAYS DIVISION

LOCATION MAP, EQUIPMENT SCHED., ELECTRICAL SYMBOLS

INTERSTATE ROUTE H-1

PAIWA STREET INTERCHANGE PROJECT NO. HIC-OI-90

SCALE: AS NOTED

DATE: AUG., 1991 SHEET No. E-1 OF 21 SHEETS

APPROVED: Director, Dept. of Trans. Services (within City right-of-way only)  $\frac{5/17/9}{\text{Date}}$ 

DATE

REVISION

G: \ACAD\PROJECTS\GENERAL\PAIWA\85072C\LOC\_MAP

# **GENERAL NOTES:**

- 1. THE LOCATION OF OVERHEAD AND UNDERGROUND FACILITIES SHOWN ON THE PLANS ARE FROM EXISTING RECORDS WITH VARYING DEGREES OF ACCURACY AND ARE NOT GUARANTEED AS SHOWN. THE CONTRACTOR SHALL EXERCISE EXTREME CAUTION WHENEVER CONSTRUCTION CROSSES OR IS IN CLOSE PROXIMITY OF UNDERGROUND LINES AND SHALL MAINTAIN ADEQUATE CLEARANCE WHEN OPERATING EQUIPMENT WITHIN OR UNDER ANY OVERHEAD LINES.
- 2. THE CONTRACTOR SHALL OBTAIN AN EXCAVATION PERMIT FROM HECO'S MAPPING AND RECORDS DIVISION LOCATED AT 820 WARD AVENUE, 4TH FLOOR, TWO WEEKS PRIOR TO STARTING CONSTRUCTION.
- 3. THE CONTRACTOR SHALL BE LIABLE FOR ANY DAMAGES TO HAWAIIAN ELECTRIC CO. FACILITIES AND SHALL IMMEDIATELY REPORT SUCH DAMAGES TO HAWAIIAN ELECTRIC CO.'S TROUBLE DISPATCHER AT 548-7961.
- 4. THE CONTRACTOR IS TO COMPLY WITH THE DIRECTIONS OF THE STATE OF HAWAII OCCUPATIONAL SAFETY AND HEALTH LAW (DOSH).
- 5. FOR VERIFYING THE LOCATION OF UNDERGROUND DUCT LINES AND FOR ASSISTANCE IN PROVIDING PROPER SUPPORT AND PROTECTION OF THE UNDERGROUND DUCT LINES, THE CONTRACTOR IS TO CONTACT HAWAIIAN ELECTRIC CO. UNDERGROUND DIVISION AT 548-7395 A MINIMUM OF 72 HOURS IN ADVANCE.
- 6. THE CONTRACTOR SHALL EXERCISE EXTREME CAUTION WHEN THE EXCAVATION AND CONSTRUCTION CROSSES OR IS IN CLOSE PROXIMITY OF UNDERGROUND TELEPHONE AND SIGNAL CABLE FACILITIES AND SHALL MAINTAIN ADEQUATE CLEARANCE FOR HIS EQUIPMENT WHILE WORKING CLOSE TO AND/OR UNDER OVERHEAD FACILITIES. ANY DAMAGES TO THE EXISTING UNDERGROUND FACILITIES SHALL BE REPAIRED AND PAID FOR BY THE CONTRACTOR.
- FOR FIELD LOCATION OF HAWAIIAN TELEPHONE CO. FACILITIES, CONTACT HAWAIIAN TELEPHONE OUTSIDE PLANT ENGINEERING SECTION, A MINIMUM OF 72 HOURS IN ADVANCE, PRIOR TO START OF EXCAVATION.
- 8. SHOULD FIELD CONDITIONS AND CONSTRUCTION PROCEDURES REQUIRE THAT UTILITY POLES BE BRACED, THE CONTRACTOR SHALL CONTACT THE FOLLOWING PERSON FOR POLE BRACING INSTRUCTIONS A MINIMUM OF 72 HOURS IN ADVANCE OF ACTUAL REQUIRED BRACING — HAWAIIAN TELEPHONE CO. - CALVIN CHOY - AREA CONSTRUCTION SUPERVISOR AT 546-3381.
- WHEN TRENCH EXCAVATION IS ADJACENT TO EXISTING STRUCTURES OR FACILITIES, THE CONTRACTOR IS RESPONSIBLE FOR PROPERLY SHEETING AND BRACING THE EXCAVATION AND STABILIZING THE EXISTING GROUND TO RENDER IT SAFE AND SECURE FROM POSSIBLE SLIDES, CAVE-INS, AND SETTLEMENT, AND FOR PROPERLY SUPPORTING EXISTING STRUCTURES AND FACILITIES WITH BEAMS, STRUTS, OR UNDERPINNING TO FULLY PROTECT IT FROM DAMAGE.
- 10. SHOULD IT BECOME NECESSARY, ANY WORK REQUIRED TO RELOCATE HAWAIIAN ELECTRIC CO. FACILITIES SHALL BE DONE BY HAWAIIAN ELECTRIC CO. THE CONTRACTOR SHALL BE RESPONSIBLE FOR COORDINATION.


#### STREET LIGHT NOTES: (CITY & COUNTY)

- THE CONTRACTOR SHALL NOTIFY THE ELECTRICAL AND MAINTENANCE SERVICES DIVISION, DEPARTMENT OF TRANSPORTATION SERVICES, TWO (2) WORKING DAYS PRIOR TO COMMENCING WORK ON THE STREET LIGHTING SYSTEM. (PHONE 527-5002)
- STREET LIGHTING SHALL BE KEPT OPERATIONAL DURING CONSTRUCTION. ANY RELOCATION REQUIRED SHALL BE APPROVED BY THE ELECTRICAL AND MAINTENANCE SERVICES DIVISION, DEPARTMENT OF TRANSPORTATION SERVICES, AND PAID FOR BY THE CONTRACTOR.
- 3. THE CONTRACTOR SHALL BE RESPONSIBLE FOR ANY DAMAGES TO EXISTING STREET LIGHTING FACILITIES AND DAMAGES SHALL BE REPAIRED BY THE CONTRACTOR.
- 4. DO NOT BACKFILL TRENCHES OR POUR CONCRETE UNTIL WORK HAS BEEN INSPECTED AND APPROVED BY THE INSPECTOR.
- 5. THE CONTRACTOR SHALL MEASURE AND RECORD THE GROUND RESISTANCE AT EACH STANDARD WITH NO EXTERNAL GROUND WIRES CONNECTED TO THE GROUND ROD. CONTRACTOR SHALL SCHEDULE GROUND RESISTANCE MEASUREMENTS 48 HOURS IN ADVANCE AND SHALL <u>NOT</u> PROCEED WITH MEASUREMENTS UNTIL APPROVAL IS GRANTED. SCHEDULES ARE SUBJECT TO CHANGE DEPENDING UPON WEATHER CONDITIONS. REPORTS SHALL INCLUDE NAME OF PERSONNEL CONDUCTING THE TEST. METER TYPE AND SERIAL NUMBER, DATE OF TEST AND SOIL CONDITIONS. TEST RESULTS SHALL BE CERTIFIED BY THE CONTRACTOR.
- 6. ALL CONDUCTORS SHALL BE 600V TYPE RHW-USE, EXCEPT GROUND WIRE WHICH MAY BE 5. TYPE TW WITH GREEN INSULATION.
- 7. ALL NEUTRAL CONDUCTORS SHALL HAVE SOLID WHITE INSULATION. ANY OTHER METHODS OF IDENTIFICATION ARE NOT ACCEPTABLE.
- 8. ALL LUMINAIRES SHALL BE HIGH PRESSURE SODIUM TYPE WITH WATTAGE AND IES TYPE LIGHT DISTRIBUTION AS INDICATED.
- 9. SEE THIS SHEET FOR TYPICAL CONSTRUCTION DETAILS. ALSO, REFER TO APPLICABLE STANDARD DETAILS OF THE ELECTRICAL & MAINTENANCE SERVICE DIVISION, DEPARTMENT OF TRANSPORTATION SERVICE, CITY & COUNTY OF HONOLULU.
- 10. CONTRACTOR SHALL STENCIL THE DATE OF INSTALLATION ON THE BOTTOM OF PHOTO CELL.
- CONTRACTOR SHALL MAINTAIN ONE SET OF APPROVED PLANS AT THE PROJECT SITE AT ALL TIMES DURING CONSTRUCTION WORK.
- 12. FINAL ACCEPTANCE INSPECTION WILL BE UNDERTAKEN ONLY AFTER ALL WORK HAS BEEN COMPLETED.
- 13. AFTER COMPLETION OF FINAL INSPECTION WITH THE ENGINEER AND THE DEPARTMENT OF TRANSPORTATION SERVICES, CONTRACTOR SHALL OBTAIN WRITTEN ACCEPTANCE OF STREET LIGHT SYSTEM FROM THE ELECTRICAL & MAINTENANCE SERVICES DIVISION, DEPARTMENT OF TRANSPORTATION SERVICES, CITY & COUNTY OF HONOLULU.

## GENERAL NOTES - TRAFFIC SIGNAL SYSTEM

- SEE HIGHWAY LIGHTING PLANS FOR ELECTRICAL SERVICE CONNECTIONS TO CONTROLLERS.
- ALL TRAFFIC SIGNAL WORK SHALL CONFORM TO THE REQUIREMENTS OF THE "MANUAL ON UNIFORM TRAFFIC CONTROL DEVICES FOR STREETS AND HIGHWAYS", FEDERAL HIGHWAY ADMINISTRATION, LATEST EDITION, AND AMENDMENTS.
- THE LOCATIONS OF THE TRAFFIC SIGNAL STANDARDS, TRAFFIC SIGNAL STANDARDS WITH MAST-ARM, PEDESTRIAN PUSH BUTTONS, TRAFFIC CONTROLLER, PULLBOXES, CONDUITS, BARRIERS & LOOP DETECTORS SHALL BE STAKED OUT IN THE FIELD BY CONTRACTOR & APPROVAL OF THE LOCATIONS OBTAINED FROM THE ENGINEER PRIOR TO CONSTRUCTION & INSTALLATION. LOCATIONS SHOWN ON THE PLANS SHALL BE ADJUSTED AS NECESSARY TO PREVENT CONFLICTS WITH EXISTING OR NEW FACILITIES.
- ALL NEW CONDUITS UNDER ROADWAY SHALL BE PVC SCHEDULE 80. CONTRACTOR SHALL HAVE THE OPTION OF USING PVC SCHEDULE 40 FOR NEW CONDUITS NOT UNDER ROADWAY. UNLESS OTHERWISE NOTED.
- IN ADDITION TO THE CONDUITS INDICATED IN THE "CONDUIT AND CABLE SCHEDULE". INSTALL ONE 3-INCH CONDUIT IN THE FOOTINGS OF ALL FINAL CONTROLLERS. CONDUIT SHALL BE STUBBED-OUT 12 INCHES FROM FOOTING AND SHALL BE CAPPED.
- 6. A SOLID #8 BARE COPPER WIRE SHALL BE INSTALLED IN THE ENTIRE TRAFFIC SIGNAL CONDUIT SYSTEM FOR USE AS A SYSTEM GROUND.
- LOOP DETECTORS SHALL BE IN ACCORDANCE WITH STANDARD PLAN TE-40, EXCEPT FOR THE FOLLOWING:
  - LOOP SIZE SHALL BE 6'X6'
  - LOOP SPACING SHALL BE 10'-0"
  - PROVIDE 4 CABLE TURNS IN A LOOP
- 8. LEAD—IN WIRES IN PULLBOX NEAR LOOPS SHALL BE TAGGED WITH LOOP NUMBER(S).
- DEPARTMENT OF TRANSPORTATION SERVICES, CITY & COUNTY OF HONOLULU WILL ASSIST THE ENGINEER IN CONSTRUCTION INSPECTION FOR THE TRAFFIC SIGNAL SYSTEM. WORK BY THE DEPARTMENT OF TRANSPORTATION SERVICES, C & C OF HONOLULU:
  - TEST CONTROLLER & AUXILIARY EQUIPMENT IN (a) CABINET.
  - MAKE ALL ELECTRICAL EQUIPMENT CONNECTIONS IN THE FIELD FOR SIGNAL SYSTEM AFTER THE SYSTEM HAS BEEN INSTALLED IN PLACE BY THE CONTRACTOR.
  - FINAL ADJUSTMENT OF TRAFFIC SIGNAL CONTROL EQUIPMENT.

- FED. ROAD DIST. NO. FISCAL YEAR SHEET NO. TOTAL SHEETS FED. AID PROJ. NO. STATE HIC-01-90 57 109 HAW.
- 10. LOCATIONS OF EXISTING UNDERGROUND STRUCTURES AND UTILITIES SUCH AS PIPE-LINES, CONDUITS, CABLES, ETC., SHOWN ON PLANS ARE APPROXIMATE ONLY. IT IS NOT THE INTENT OF THESE PLANS TO SHOW THE EXACT LOCATION OF ALL UNDER-GROUND UTILITIES AND STRUCTURES. IT IS THE RESPONSIBILITY OF THE CONTRAC-TOR TO VERIFY THE LOCATIONS OF ALL EXITING UTILITIES WITH THE RESPECTIVE OWNERS. EXISTING UTILITIES DAMAGED BY THE CONTRACTOR SHALL BE REPAIRED BY THE CONTRACTOR AT HIS OWN COST.
- 11. LOCATIONS OF TRAFFIC MARKINGS AND MARKERS (LANE LINES, STOP LINES, CROSS-WALK, ETC.) SHOWN ON THE PLANS SHALL BE VERIFIED WITH THE ENGINEER PRIOR TO THE INSTALLATION OF THE TRAFFIC SIGNAL SYSTEM.
- 12. ALL TRAFFIC SIGNAL CONTROLLER EQUIPMENT SHALL BE COMPLETELY WIRED IN THE CABINET AND SHALL CONTROL THE TRAFFIC SIGNALS AS CALLED FOR IN THE PLANS.
- 13. SIGNAL INDICATIONS DURING CLEARANCE INTERVAL:
  - A. IF A SIGNAL IS G OR -G AND WILL REMAIN G OR -G DURING THE NEXT PHASE, IT SHALL BE G OR -G DURING THE CLEARANCE INTERVAL.
  - B. IF A SIGNAL IS G OR  $\leftarrow$ G AND WILL BECOME R OR EXTINGUISHED DURING THE NEXT PHASE, IT SHALL BE Y OR \*Y DURING THE CLEARANCE INTERVAL.
  - C. IF THE SIGNAL IS R AND WILL REMAIN R OR BECOMES G DURING THE NEXT PHASE, IT SHALL REMAIN R DURING THE CLEARANCE INTERVAL.
- 14. THE FOLLOWING STATE STANDARD DETAILS SHALL BE USED: TE-38, TE-39, TE-40, TE-41, TE-42, TE-43

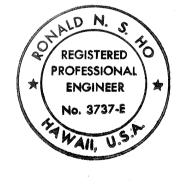

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STATE OF HAWAII
DEPARTMENT OF TRANSPORTATION
HIGHWAYS DIVISION

ELECTRICAL NOTES

INTERSTATE ROUTE H-1 PAIWA STREET INTERCHANGE PROJECT NO. HIC-01-90

SCALE: AS NOTED

DATE: AUG., 1991 SHEET No. E-2 OF 2 SHEETS

APPROVED: 5/29/9/ Date Hawaiian Electric Co. son Wuch K Jawah 5-31-91 Hawaiian Telephone Co. Date Director, Dept. of Trans. Services Date (within City right-of-way only)

DATE REVISION

G: \ACAD\PROJECTS\GENERAL\PAIWA\85072C\EL\_NOTES

# ELECTRICAL SYMBOLS ITEM **DESCRIPTION** HECO 4'x6' HANDHOLE HTCO 3'x5' HANDHOLE EXISTING UTILITY COMPANY MANHOLE. EXISTING UTILITY COMPANY WOOD JOINT POLE TO REMAIN, JOINT POLE NUMBER "170" INDICATED. METAL STANDARD TYPE "E" ON GRADE WITH FOUNDATION, WITH 150 WATT H.P.S. LUMINAIRE (CITY), 30' GLV. STEEL POLE WITH 6'-0" MAST ARM. EXISTING LUMINAIRE, BRACKET ARM AND METAL STANDARD TO REMAIN (CITY) ----- UNDERGROUND DUCT/CONDUIT METAL STANDARD TYPE "A" OR "B" ON GRADE WITH FOUNDATION, WITH 250 WATT H.P.S. LUMINAIRE. (STATE) METAL STANDARD TYPE "C" ON RETAINING WALL FOUNDATION, WITH 250 WATT H.P.S. LUMINAIRE. (STATE) STATE HIGHWAY LIGHTING PULL BOX, TYPE A, IN GRADE STATE HIGHWAY LIGHTING CAST METAL JUNCTION BOX, IN CONCRETE BARRIER EXISTING CITY & COUNTY STREET LIGHT PULLBOX -POLE LOCATION FROM EDGE OF TRAVELWAY, IN FEET -HIGHWAY LIGHT & POLE NUMBER -BRACKET ARM SPAN IN FEET -LUMINAIRE HEIGHT ABOVE PAVEMENT, IN FEET LIGHTING STANDARD TYPE -HIGHWAY LIGHT CIRCUIT NUMBER NOTE INDICATOR, "SEE NOTE NO. 1" INDICATED. JUNCTION BOX, UNDERPASS CEILING SURFACE MOUNTED. JUNCTION BOX, WALL MOUNTED. INDICATES "WEATHERPROOF" DUCT SECTION INDICATOR

# TRAFFIC SIGNAL SYMBOLS

$\underline{TR}$	AFFIC SIGNAL SYMBOLS
<u>ITEM</u>	DESCRIPTION
	CONDUITS AND CABLES, "CONDUIT RUN #2" INDICATED
	PEDESTRIAN SIGNAL HEAD WITH PEDESTRIAN PUSH BUTTON ASSEMBLY AND SIGN R10-46, R10-46(L) OR R10-46(R), AS APPROPRIATE
<b>─</b>	12" RYG STANDARD TRAFFIC SIGNAL HEAD
	12" RYT TRAFFIC SIGNAL HEAD
O>	STANDARD TRAFFIC SIGNAL HEAD MOUNTED ON TYPE I SIGNAL STANDARD, HEIGHT = 10'
	STANDARD TRAFFIC SIGNAL AND PEDESTRIAN SIGNA HEADS MOUNTED ON TYPE I SIGNAL STANDARD, HEIGHT = 10'
	12" RY← TRAFFIC SIGNAL HEAD
	PROGRAMMED VISIBILITY HEAD
24' O	TRAFFIC SIGNAL HEAD MOUNTED ON TYPE II SIGNAL STANDARD, ARM SPREAD SHOWN IS 24'
24, ©	TRAFFIC SIGNAL HEADS MOUNTED ON TYPE II SIGNAL STANDARD, ARM SPREAD SHOWN IS 24' AND DISTANCE BETWEEN SIGNAL HEADS IS 12'
	TYPE "B" TRAFFIC SIGNAL PULLBOX  TYPE "B" TRAFFIC SIGNAL PULLBOX  LOOP DETECTOR, SERIES—PARALLEL CONNECTED

LOOP DETECTOR, SERIES CONNECTED

TRAFFIC SIGNAL CONTROLLER AND FOUNDATION

FED. ROAD	STATE	FED. AID	FISCAL	SHEET	TOTAL
DIST. NO.		PROJ. NO.	YEAR	NO.	SHEETS
HAWAII	HAW.	HIC-01-90	1991	58	109

# EQUIPMENT SCHEDULE

HAWAIIAN ELECTRIC CO. INC., AND HAWAIIAN TELEPHONE CO., HANDHOLES TO BE PROVIDED AS INDICATED & IN ACCORDANCE WITH THE FOLLOWING STANDARD DRAWINGS:

4'x 6' HECO HANDHOLE

4'x 6' TYPE 46 REINFORCED CONCRETE HANDHOLE

WITH PRECAST CONCRETE COVERS, CONSTRUCTED IN ACCORDANCE WITH HECO STANDARD DRAWING

NO. 18842.

3'x5' HECO HANDHOLE

3'x5' TYPE 35 REINFORCED CONCRETE HANDHOLE WITH PRECAST CONCRETE COVERS, PROVIDED IN ACCORDANCE WITH HECO STANDARD DRAWING

NO. 15501.

3'x5' HTCO HANDHOLE

3'x5' PRECAST POLYMER CONCRETE HANDHOLE WITH

2-PIECE POLYMER CONCRETE COVERS, PROVIDED IN ACCORDANCE WITH HTCO STANDARD DRAWING

NO. 34082.

REGISTERED PROFESSIONAL ENGINEER
No. 3737-E

WAII, U.S.P.

THIS WORK WAS PREPARED BY ME OR UNDER MY SUPERVISION.

Date

| Oate | O

REVISION

DEPARTMENT OF TRANSPORTATION
HIGHWAYS DIVISION

ELECTRICAL SYMBOLS

TRAFFIC SIGNAL SYMBOLS

INTERSTATE ROUTE H-1

PAIWA STREET INTERCHANGE

PROJECT NO. HIC-01-90


SCALE: AS NOTED


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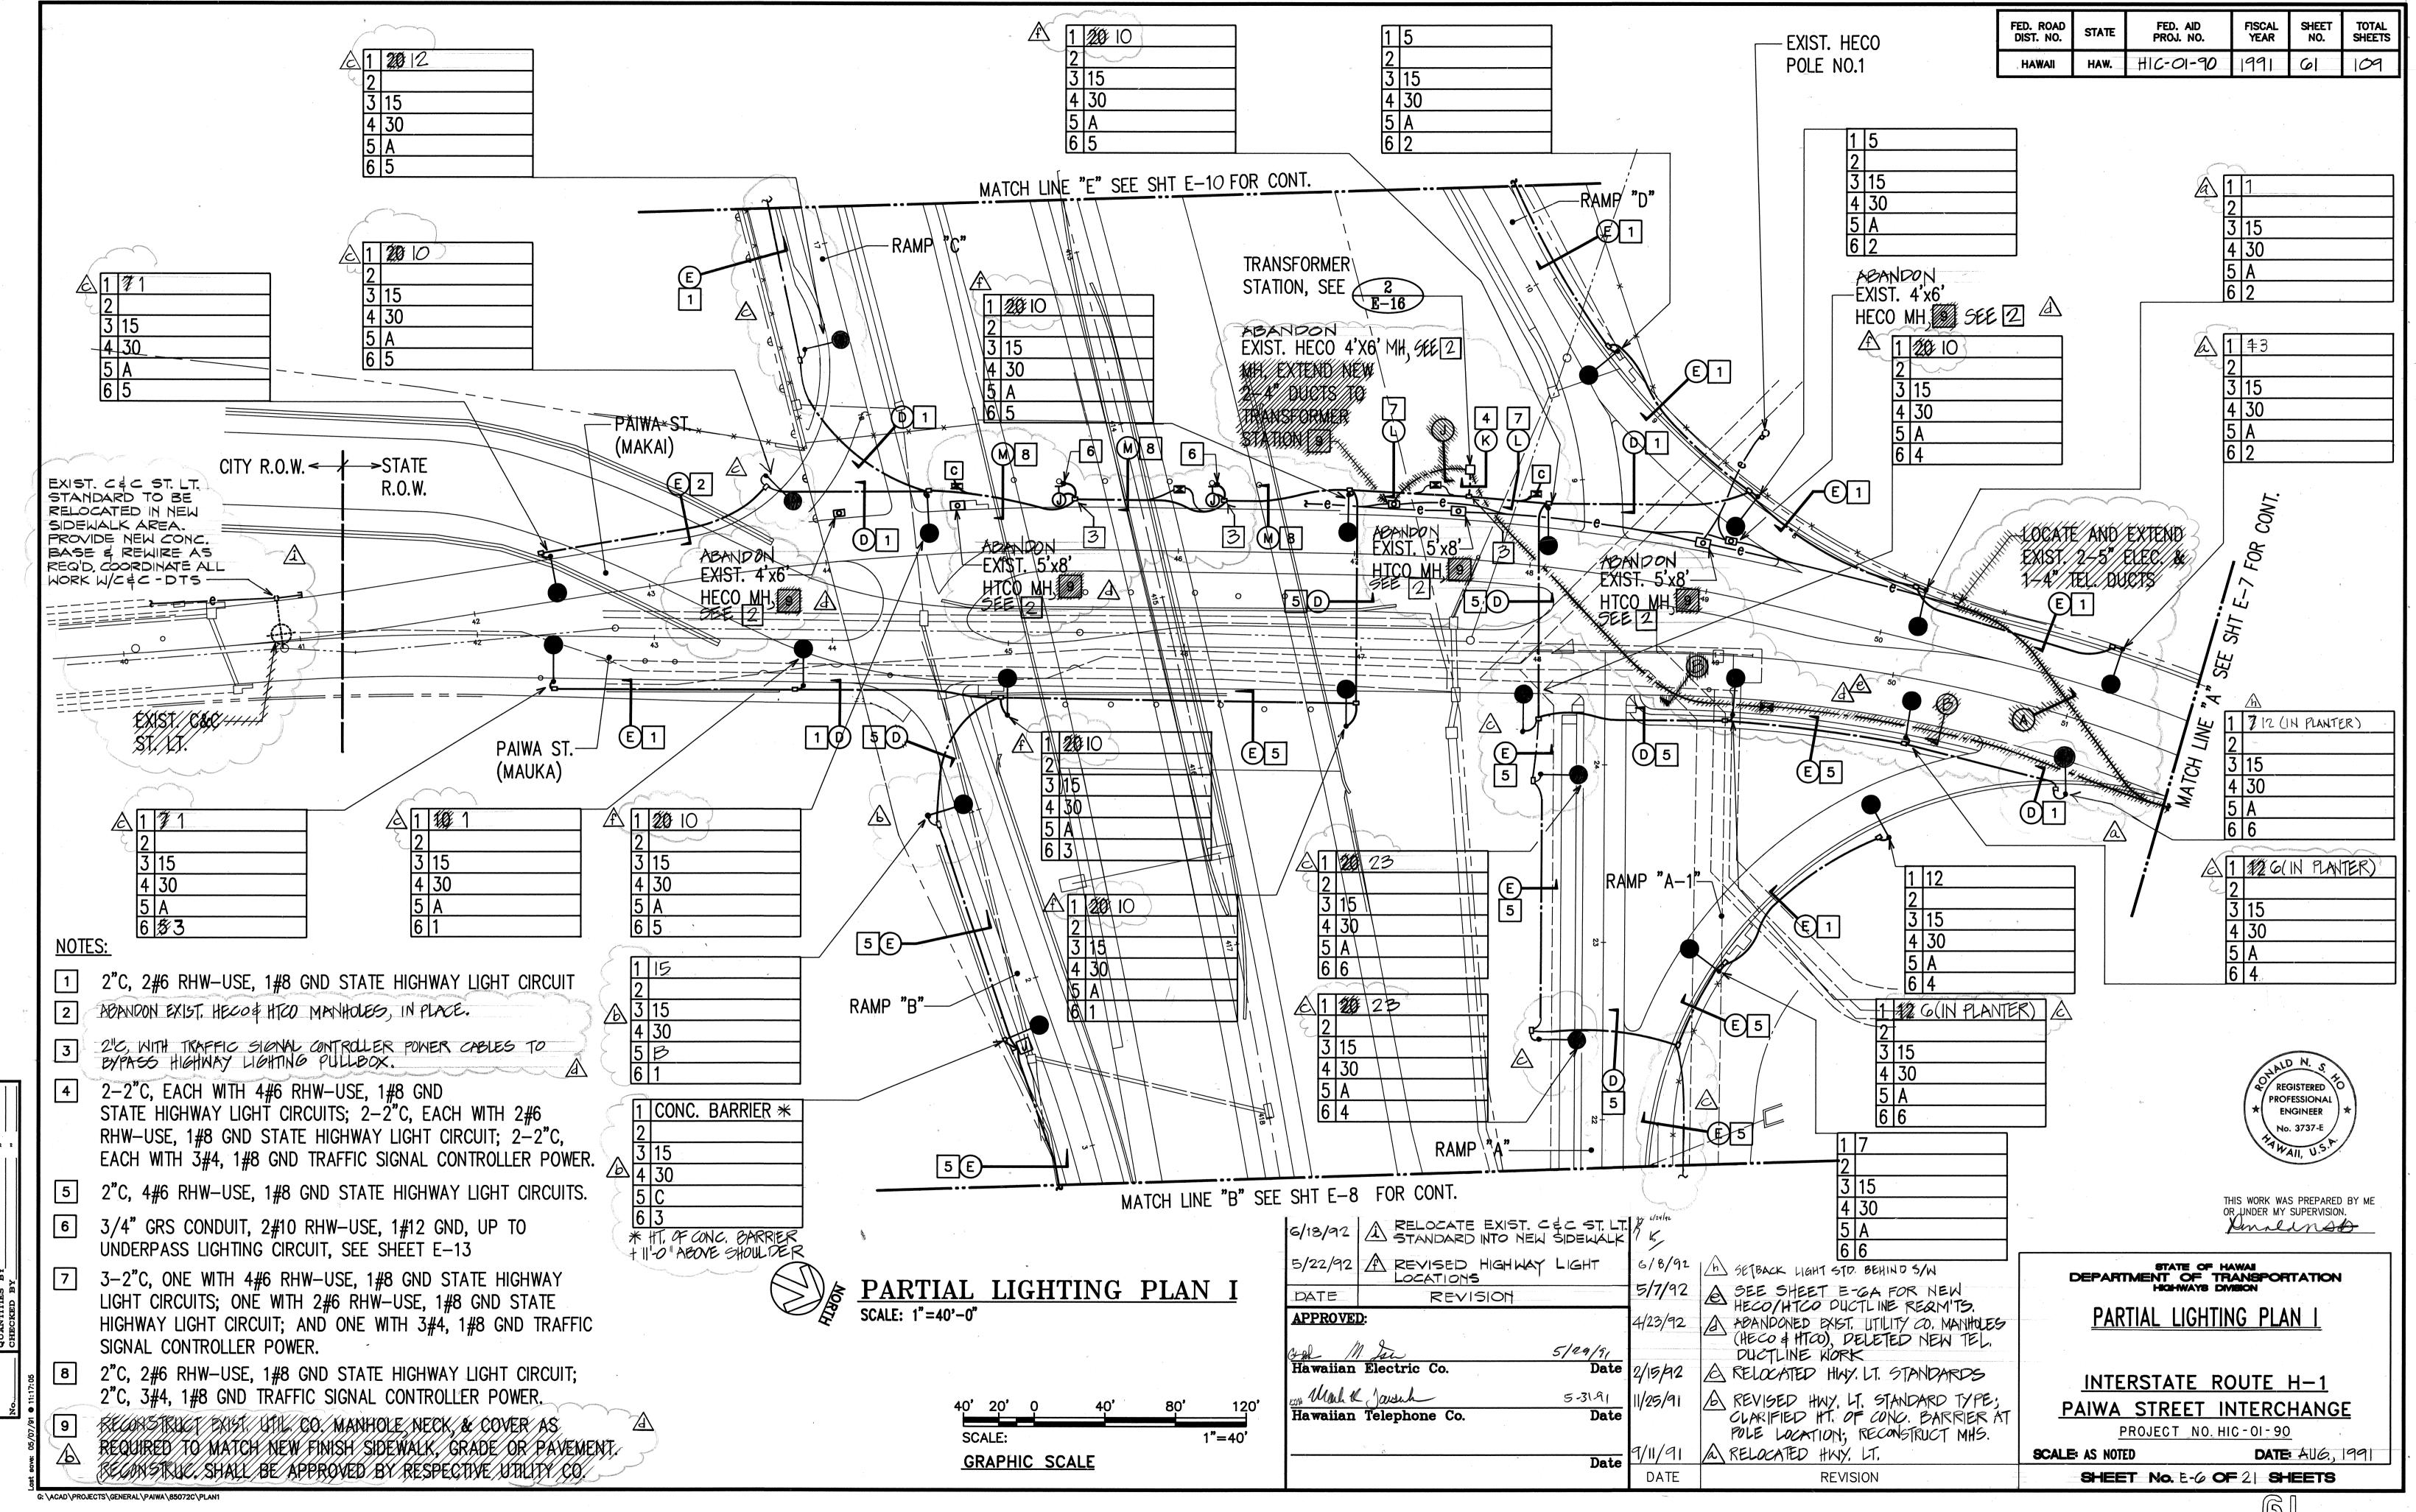
SHEET No. E-3 OF 2 | SHEETS

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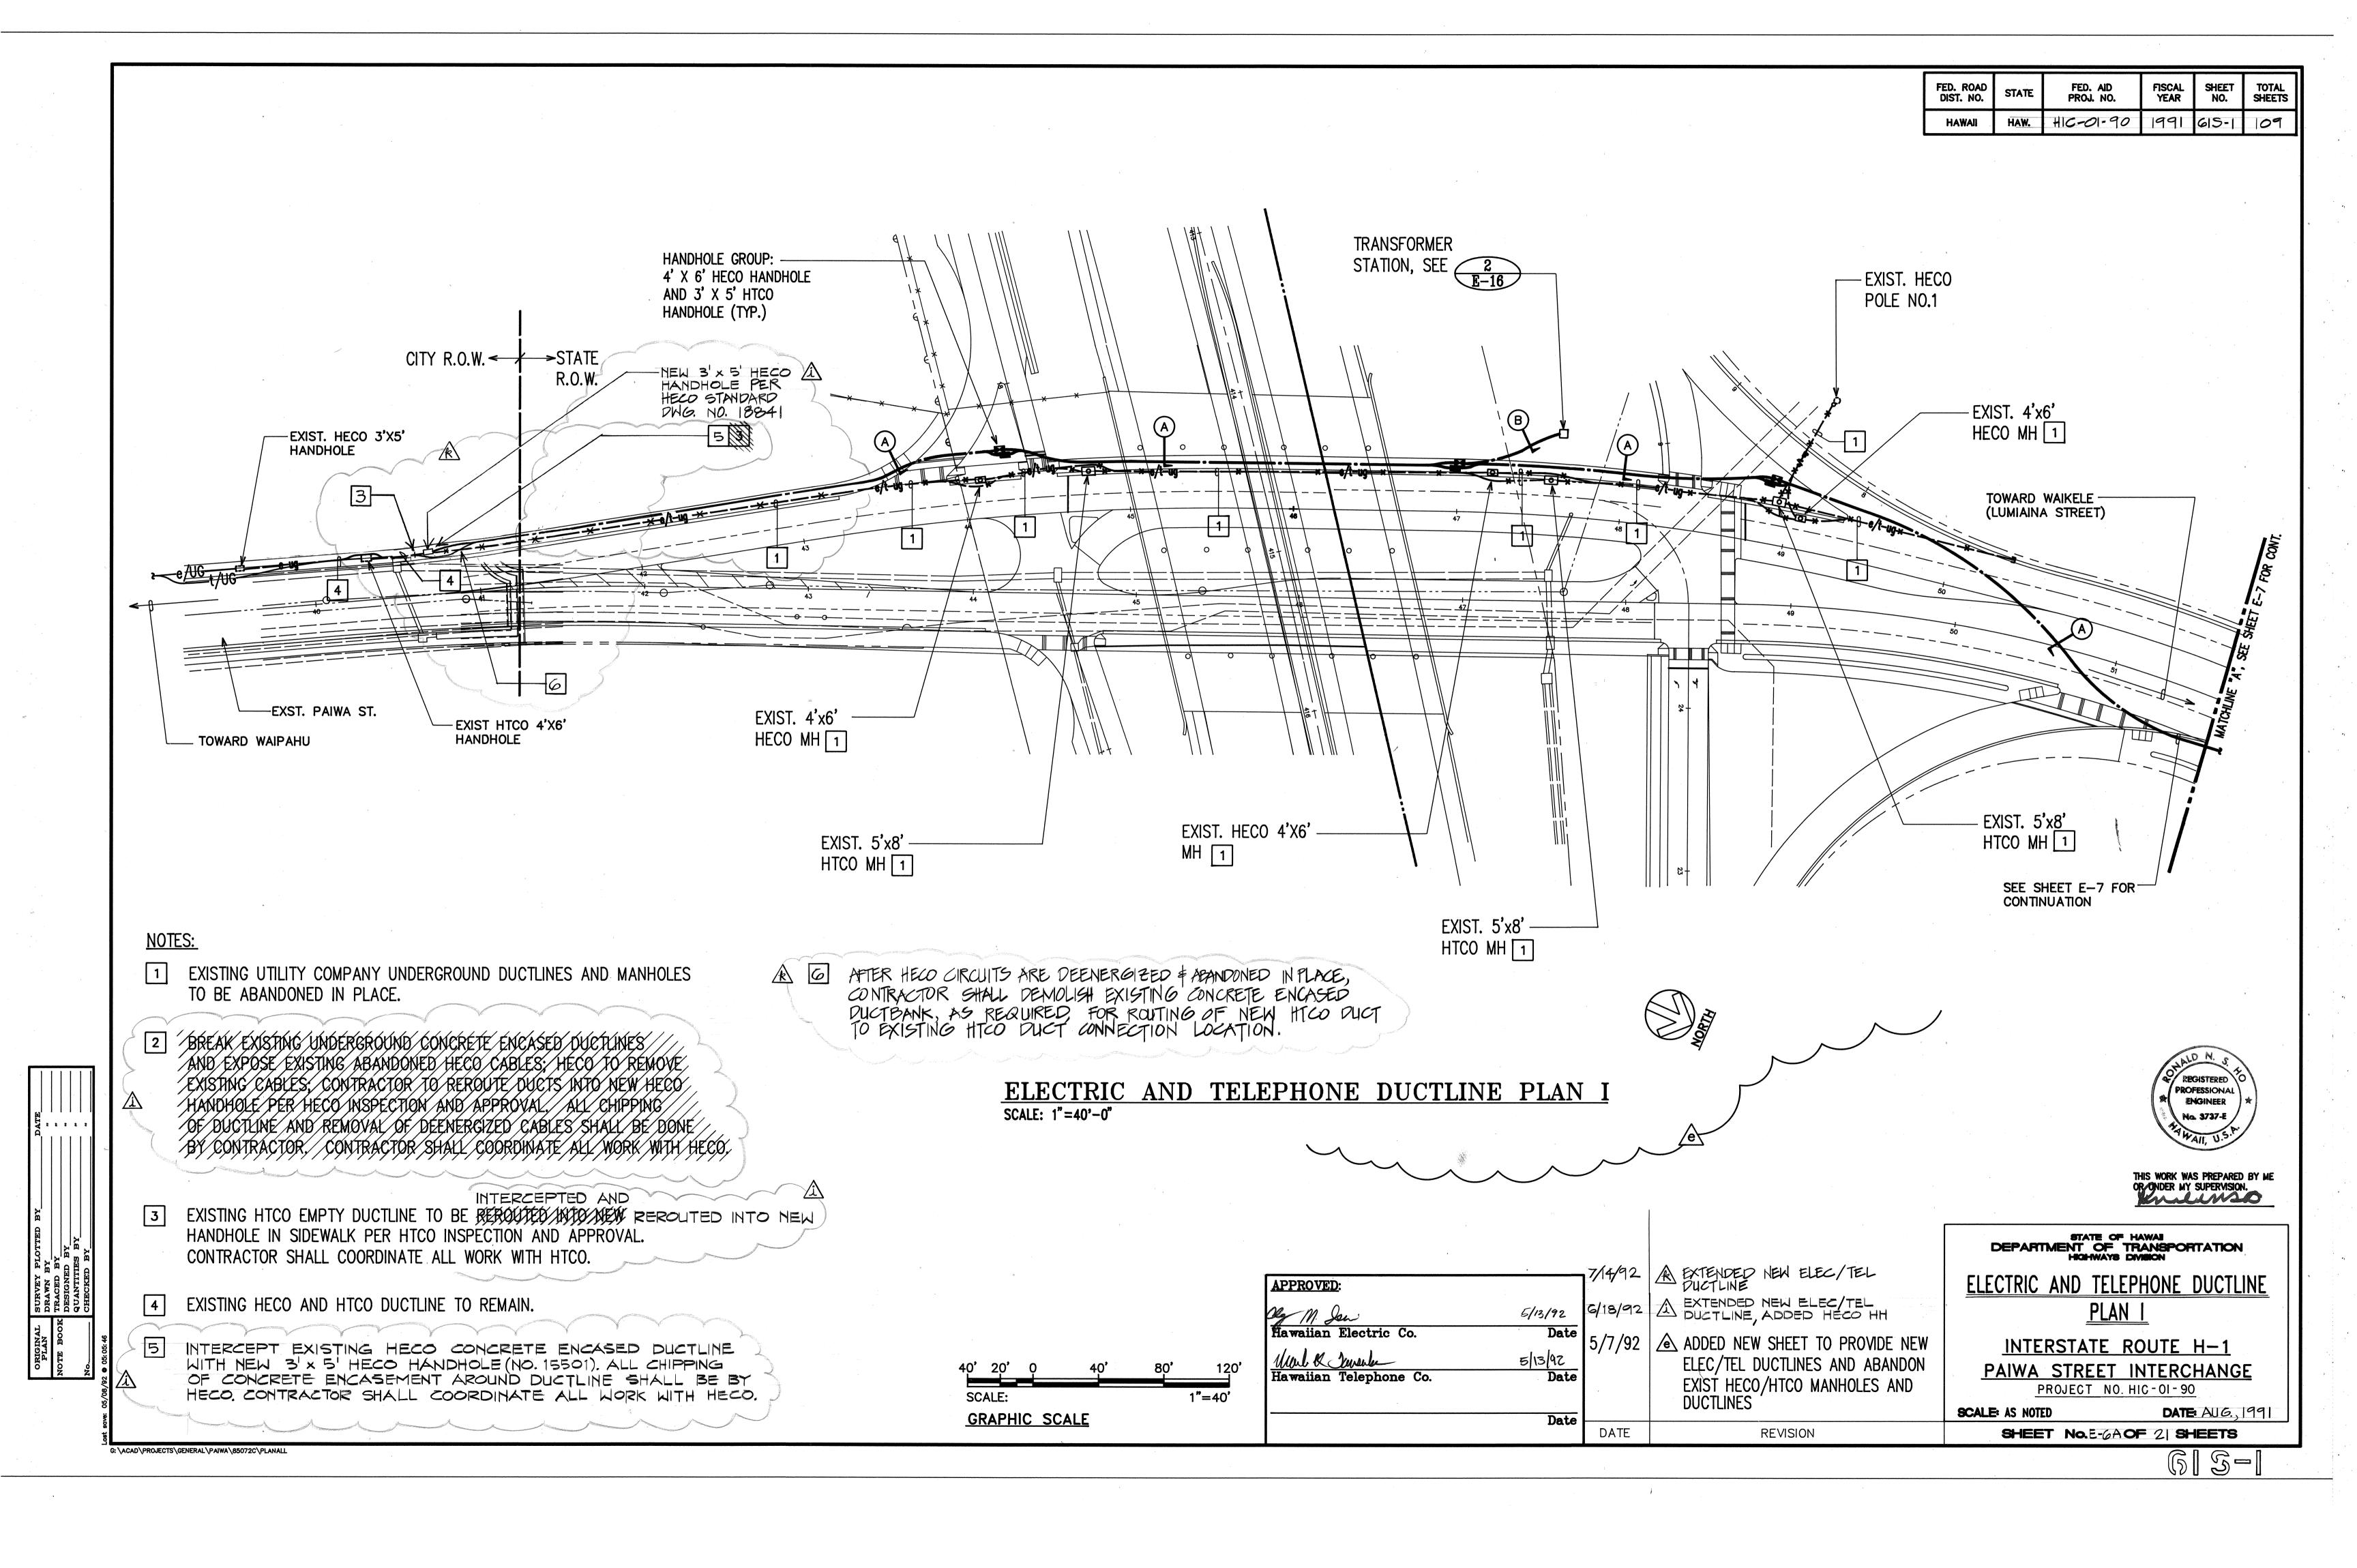
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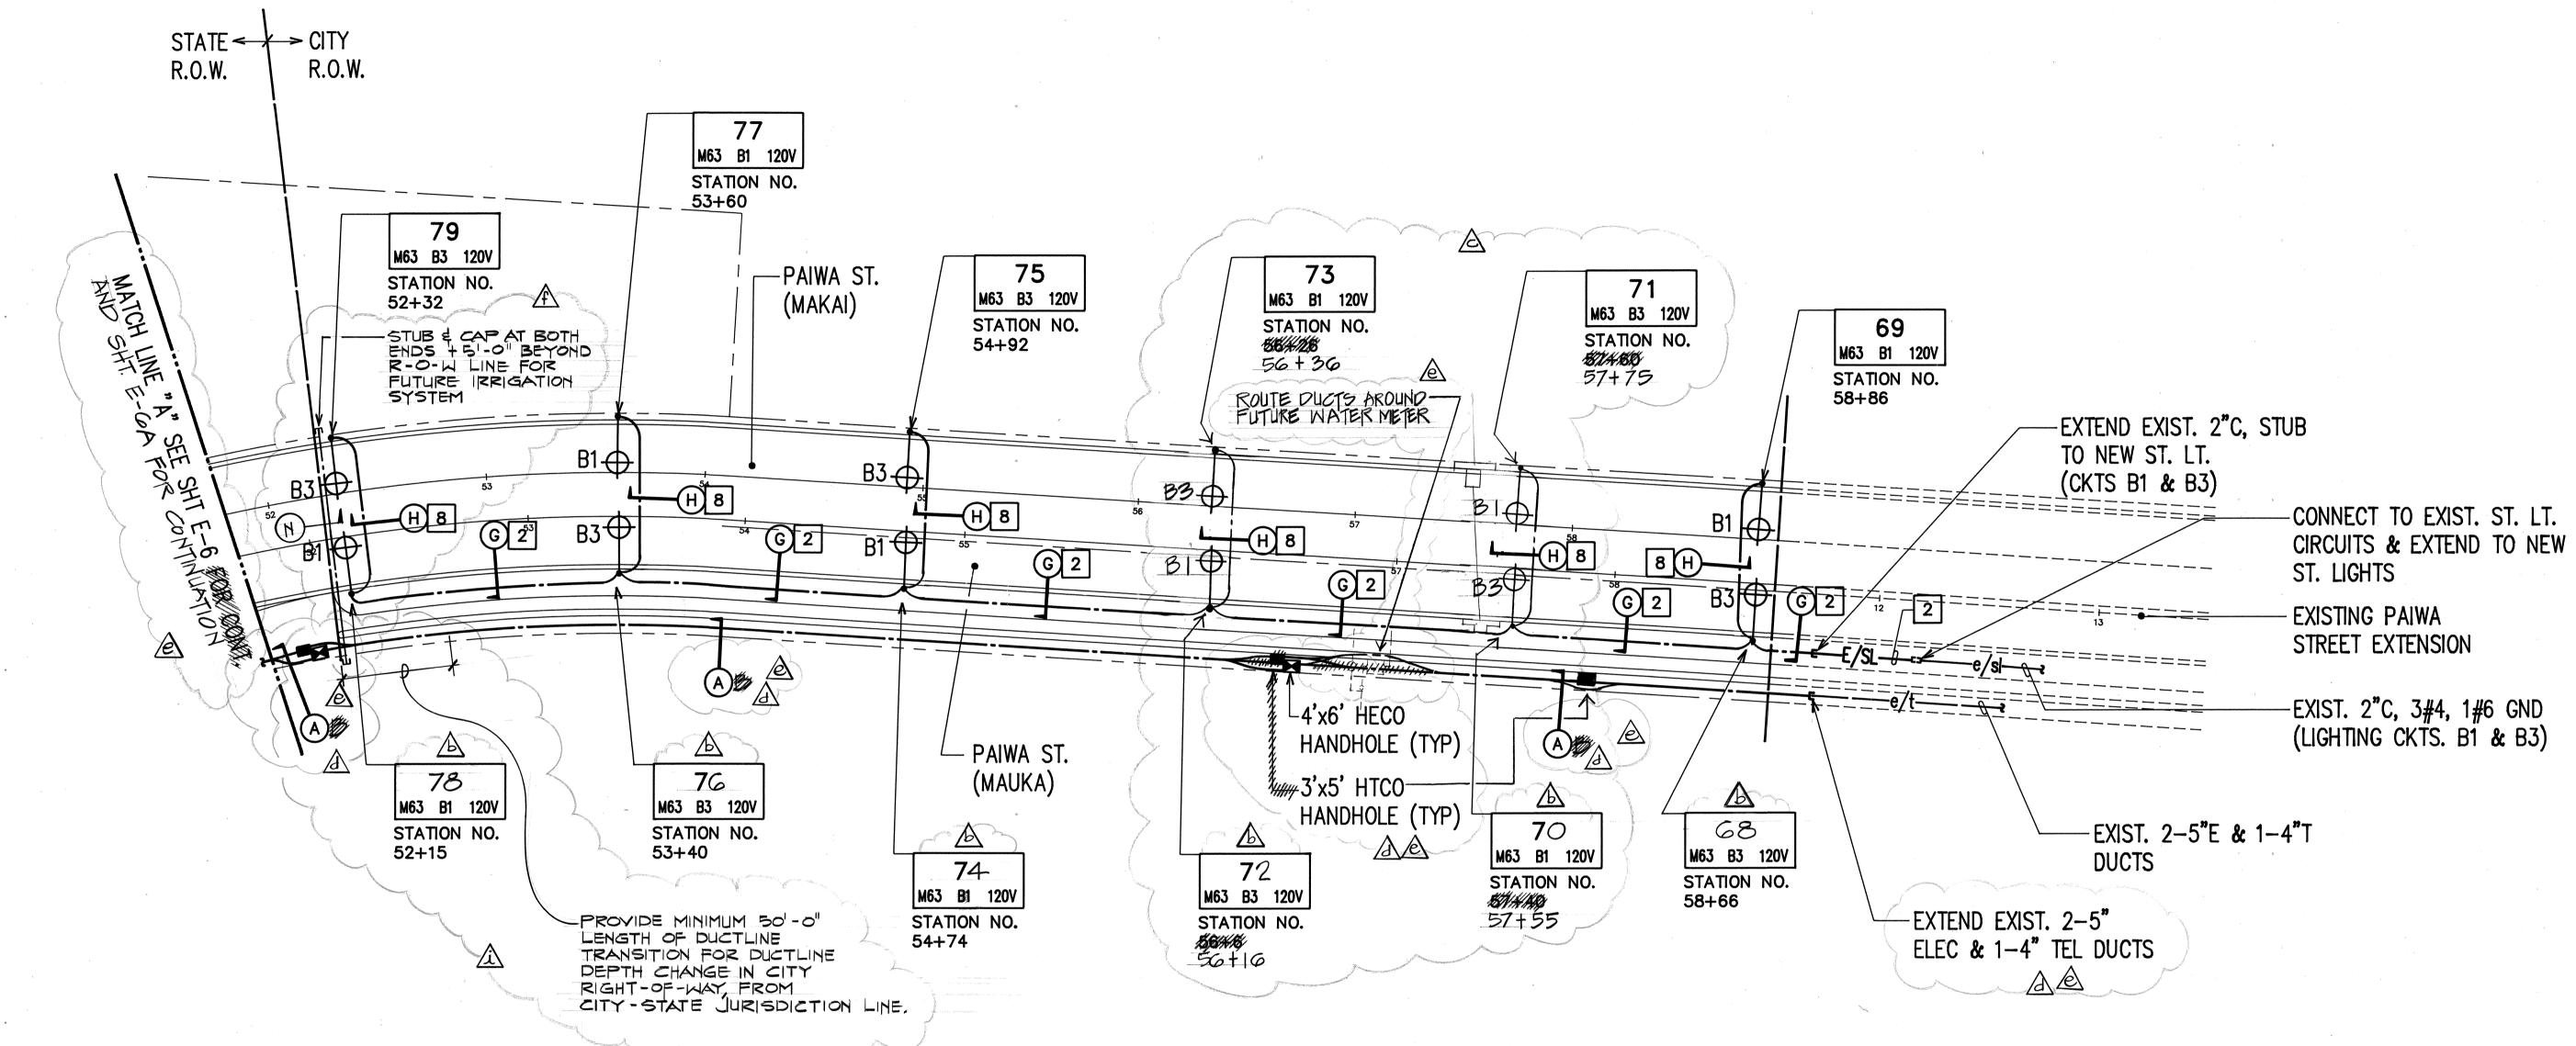




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	HAWAII	HAW.	HIC-01-90	1991	62	109

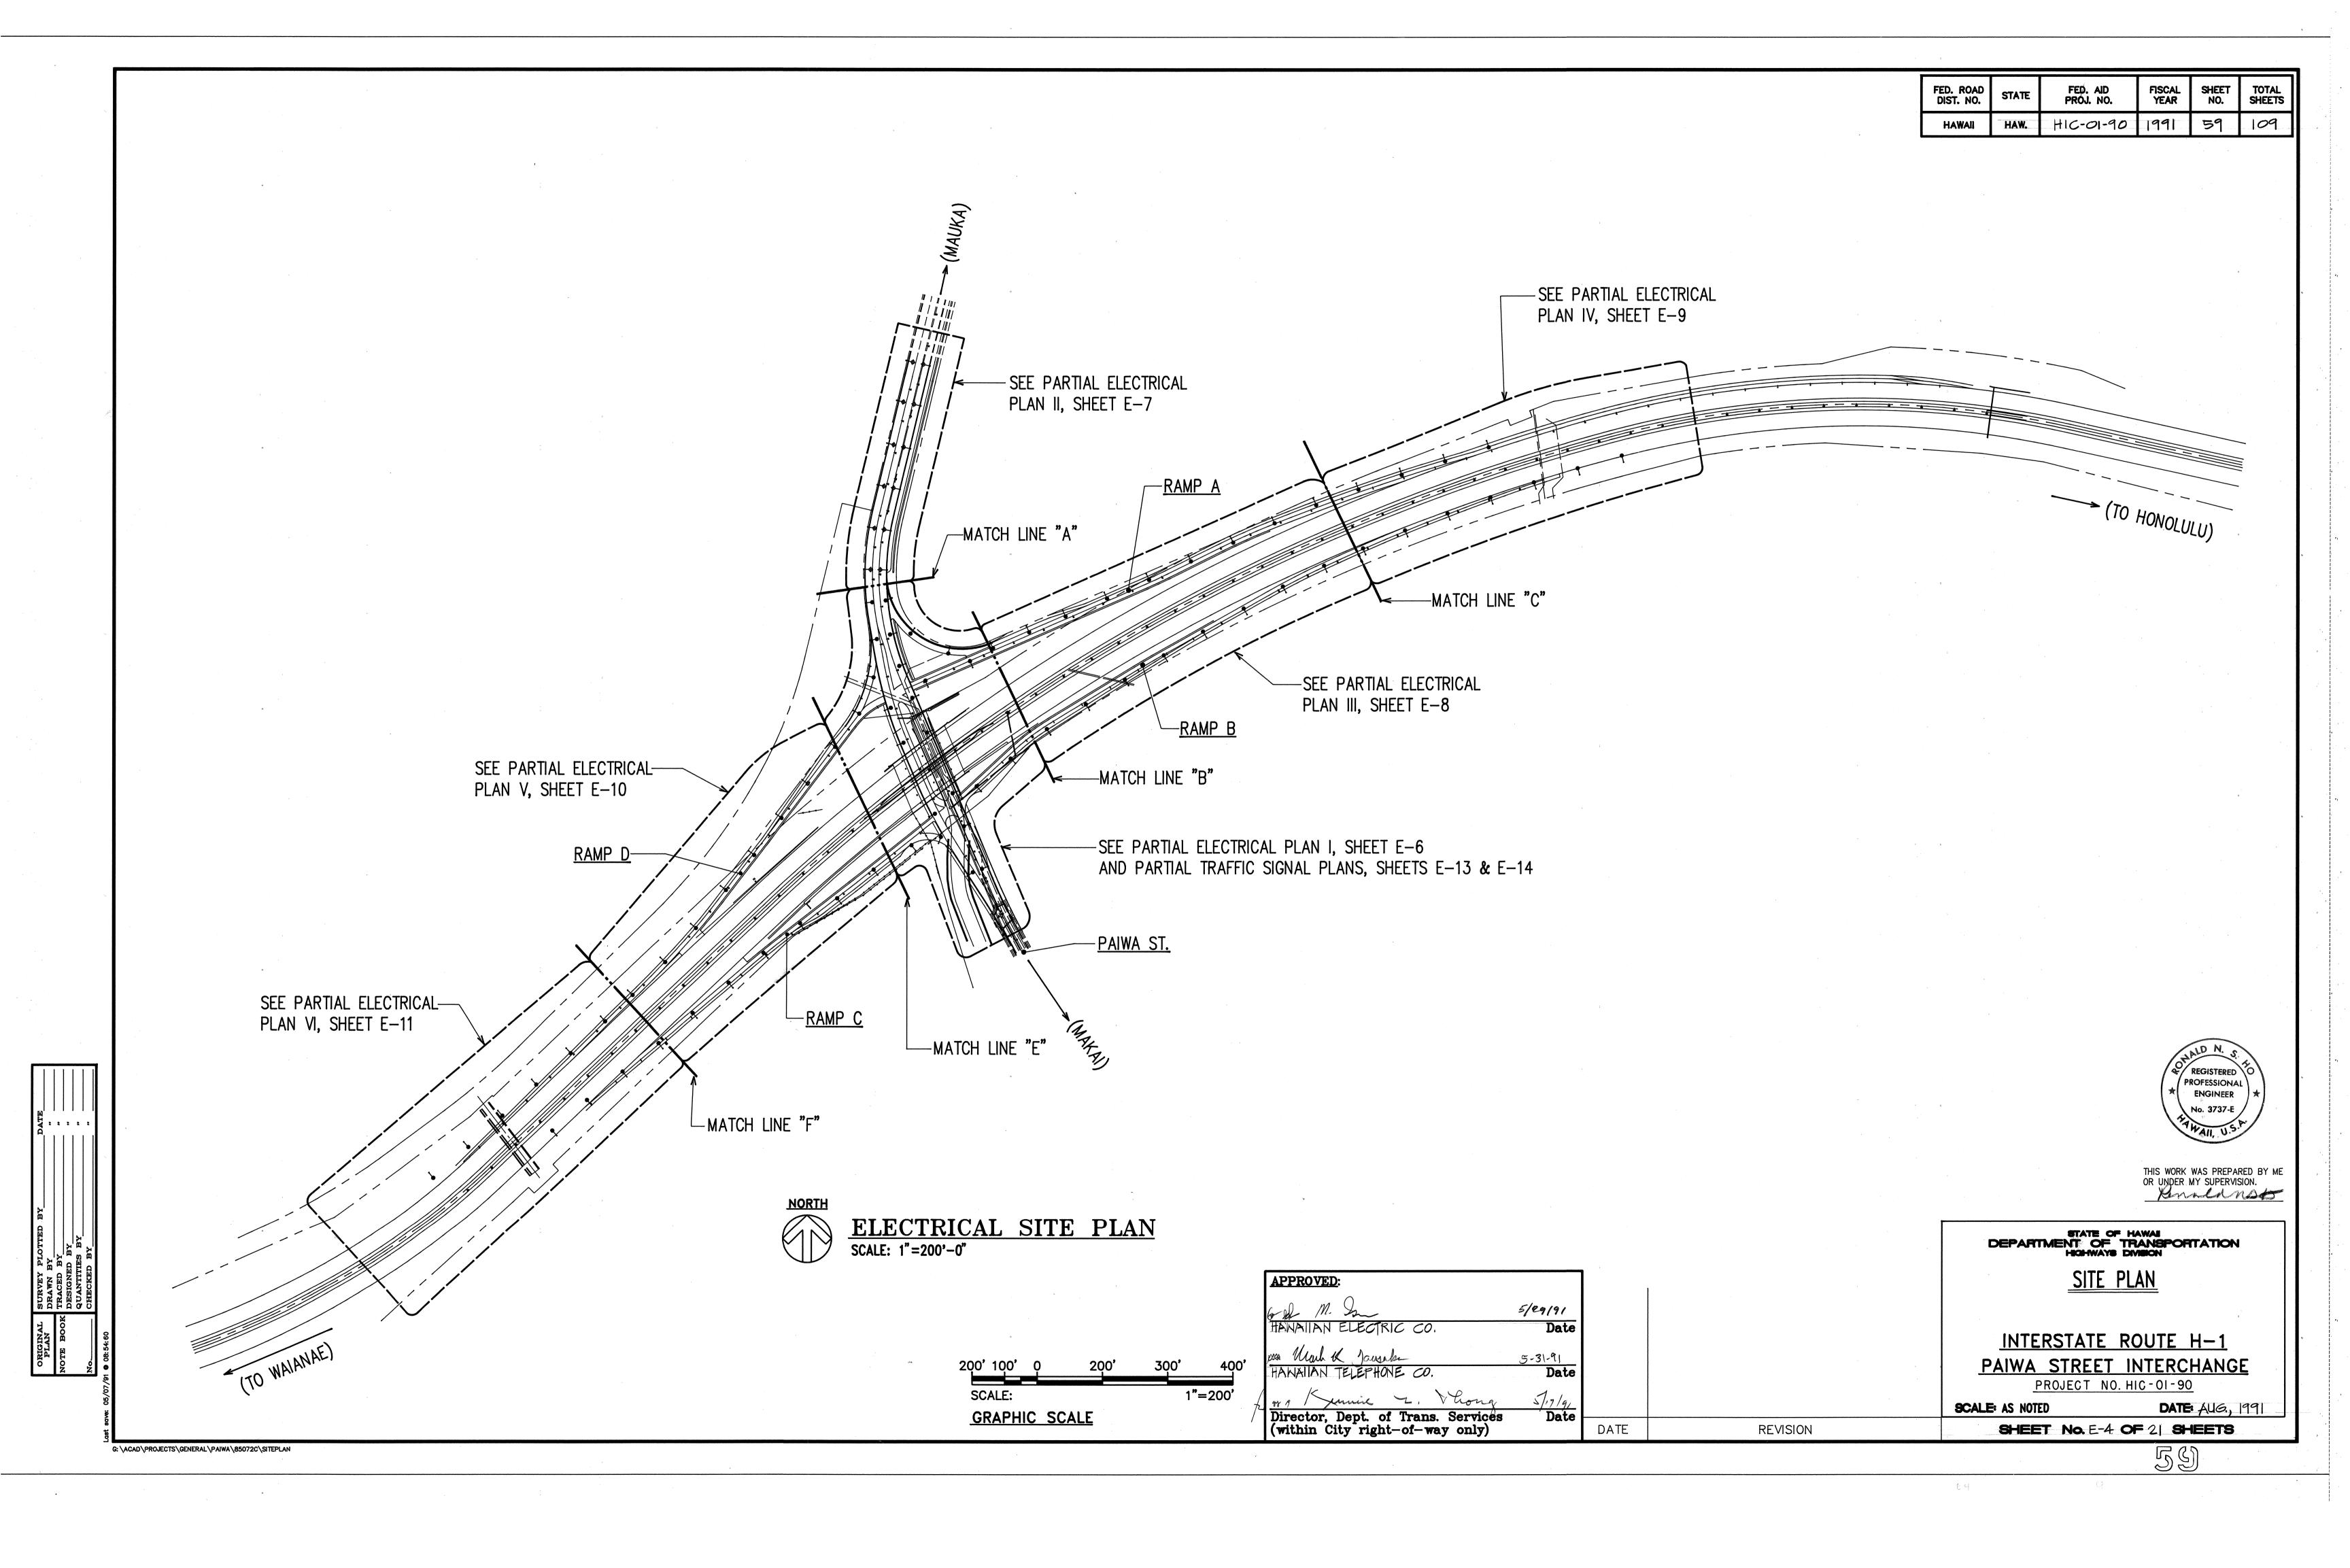

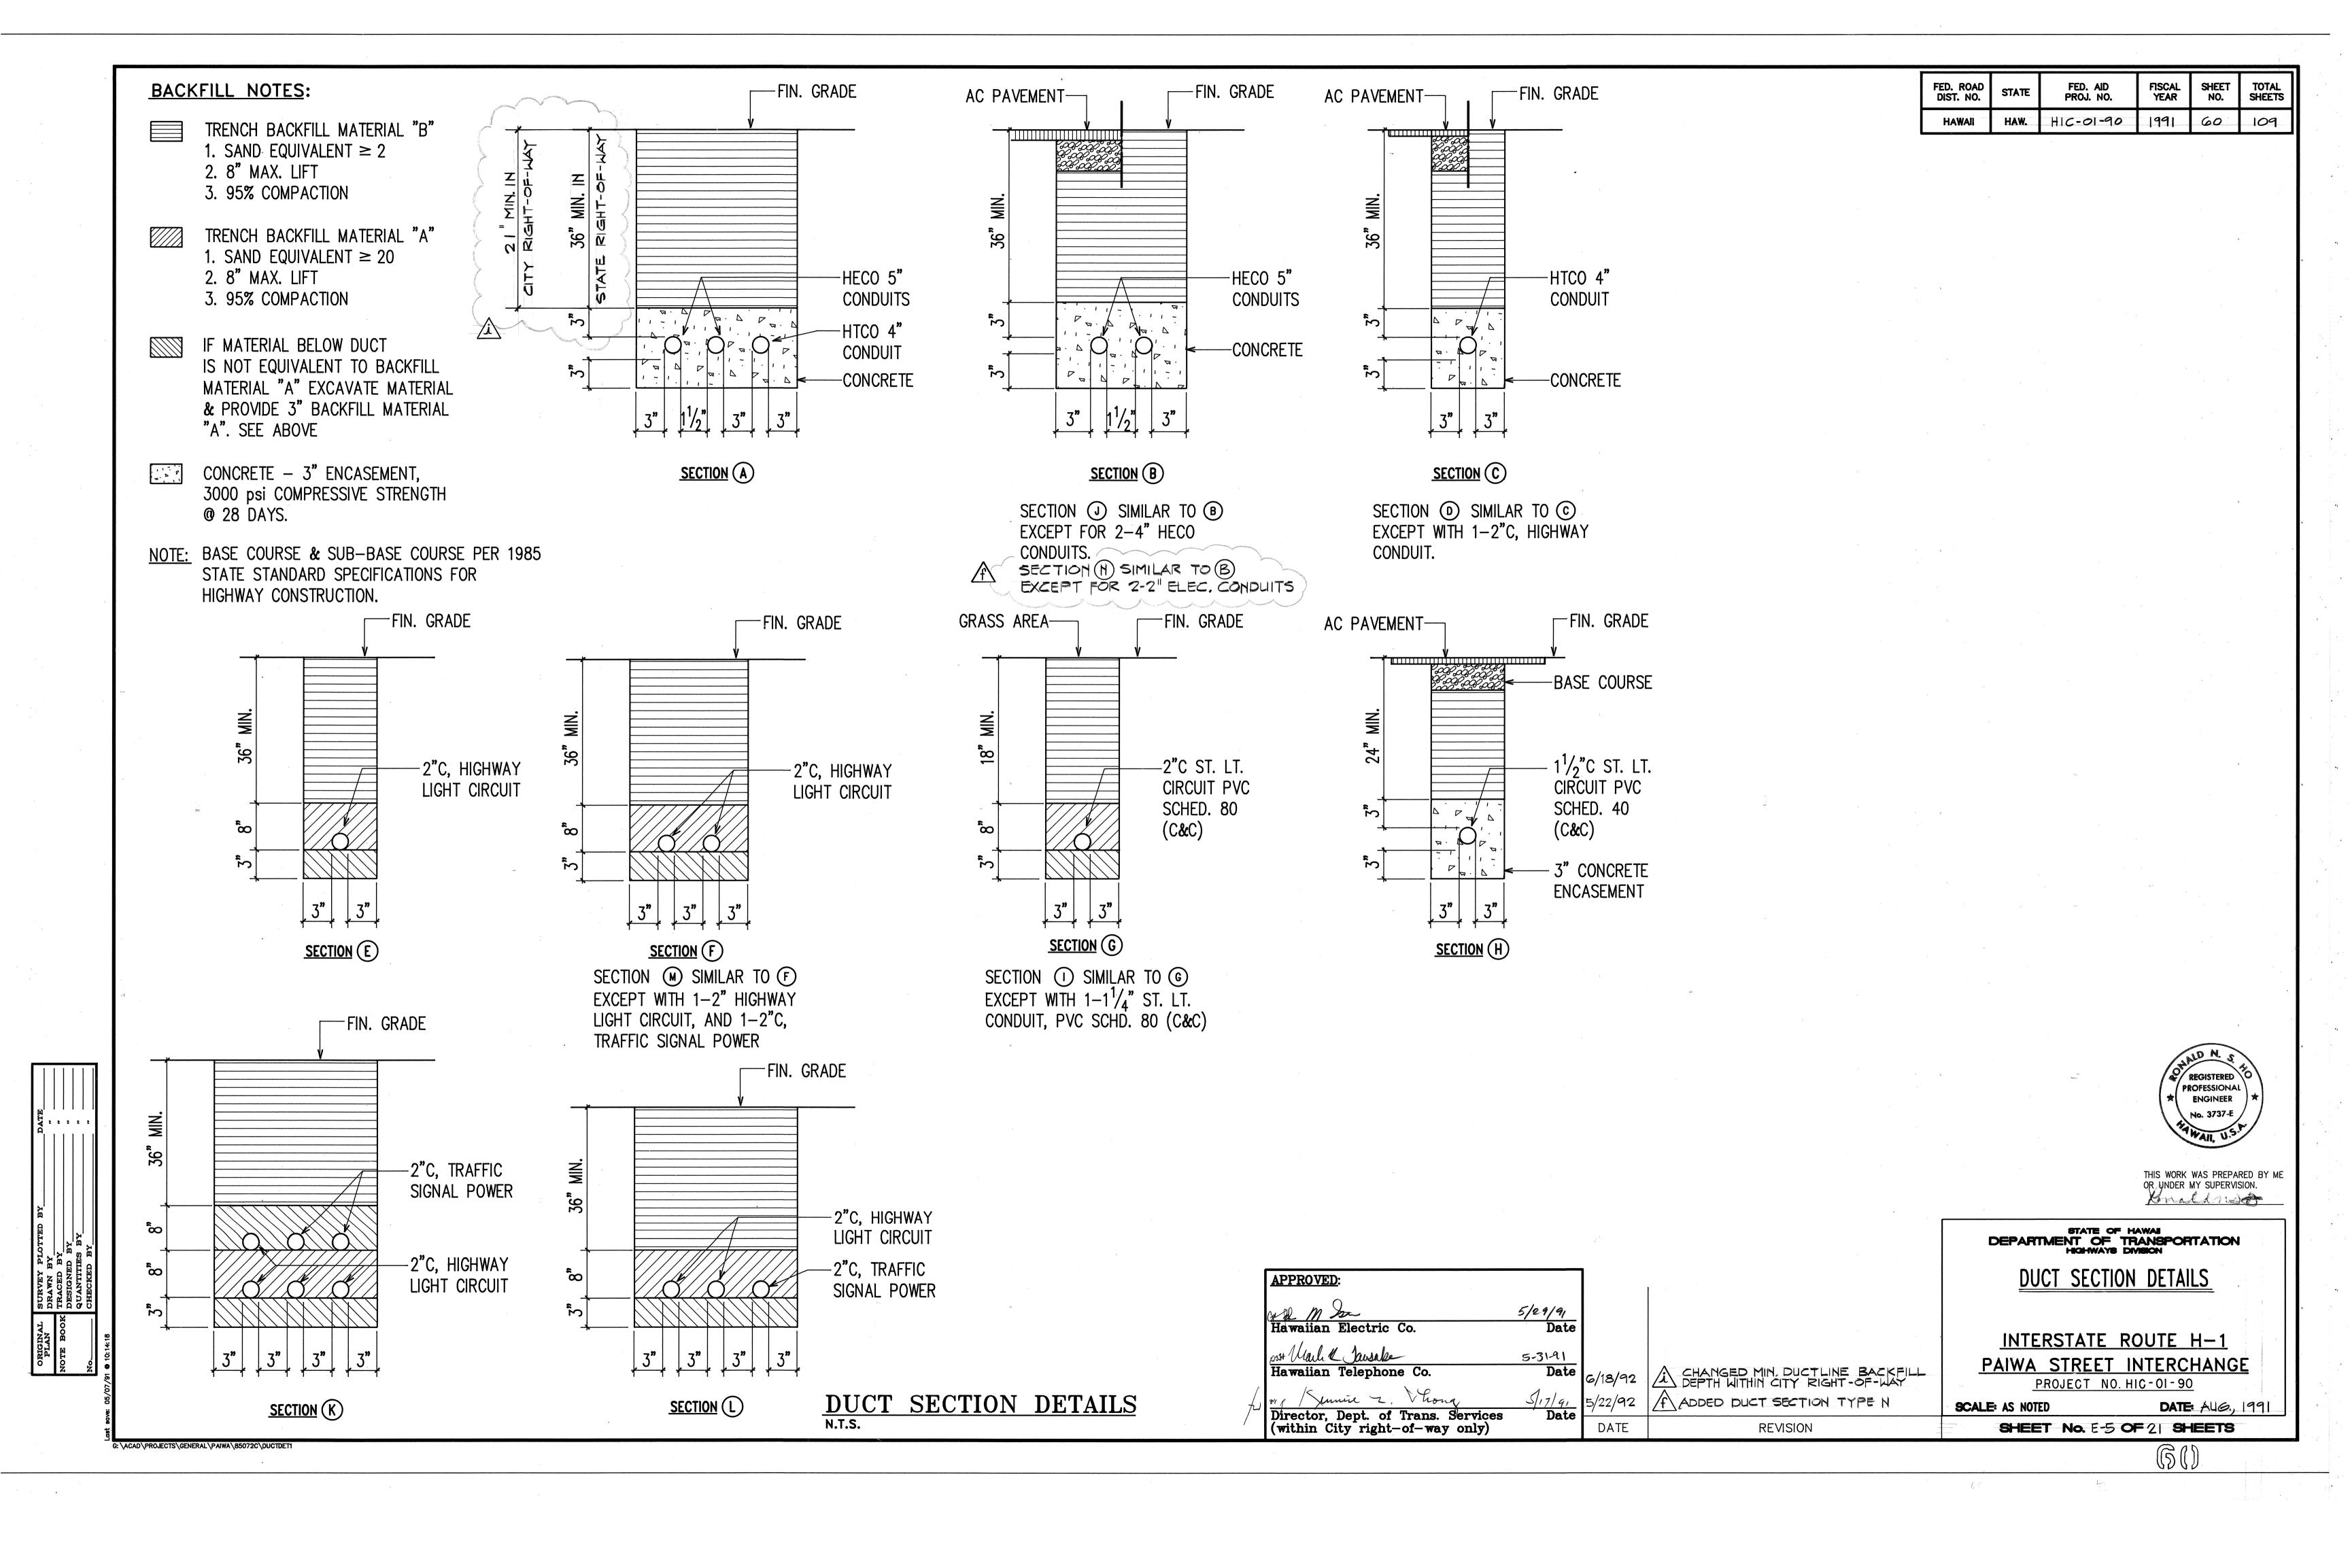
2"C, 3#4 RHW-USE, 1#6 GND C&C ST. LT. CIRCUITS.

 $1^{1}/_{2}$ "C, 2#8 RHW-USE, 1#8 GND C&C ST. LT. CIRCUIT.





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STATE OF HAWAII
DEPARTMENT OF TRANSPORTATION
HIGHWAYS DIVISION

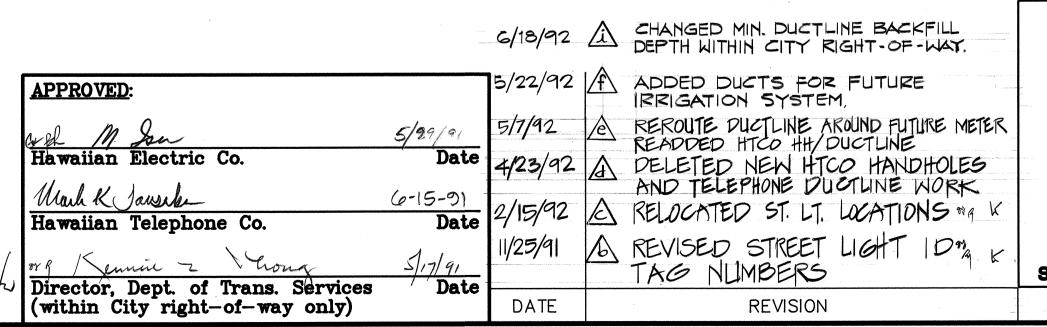INTERSTATE ROUTE H-1
PAIWA STREET INTERCHANGE
PROJECT NO. HIC-01-90

PARTIAL LIGHTING PLAN II

SHEET No. E-7 OF 2 SHEETS


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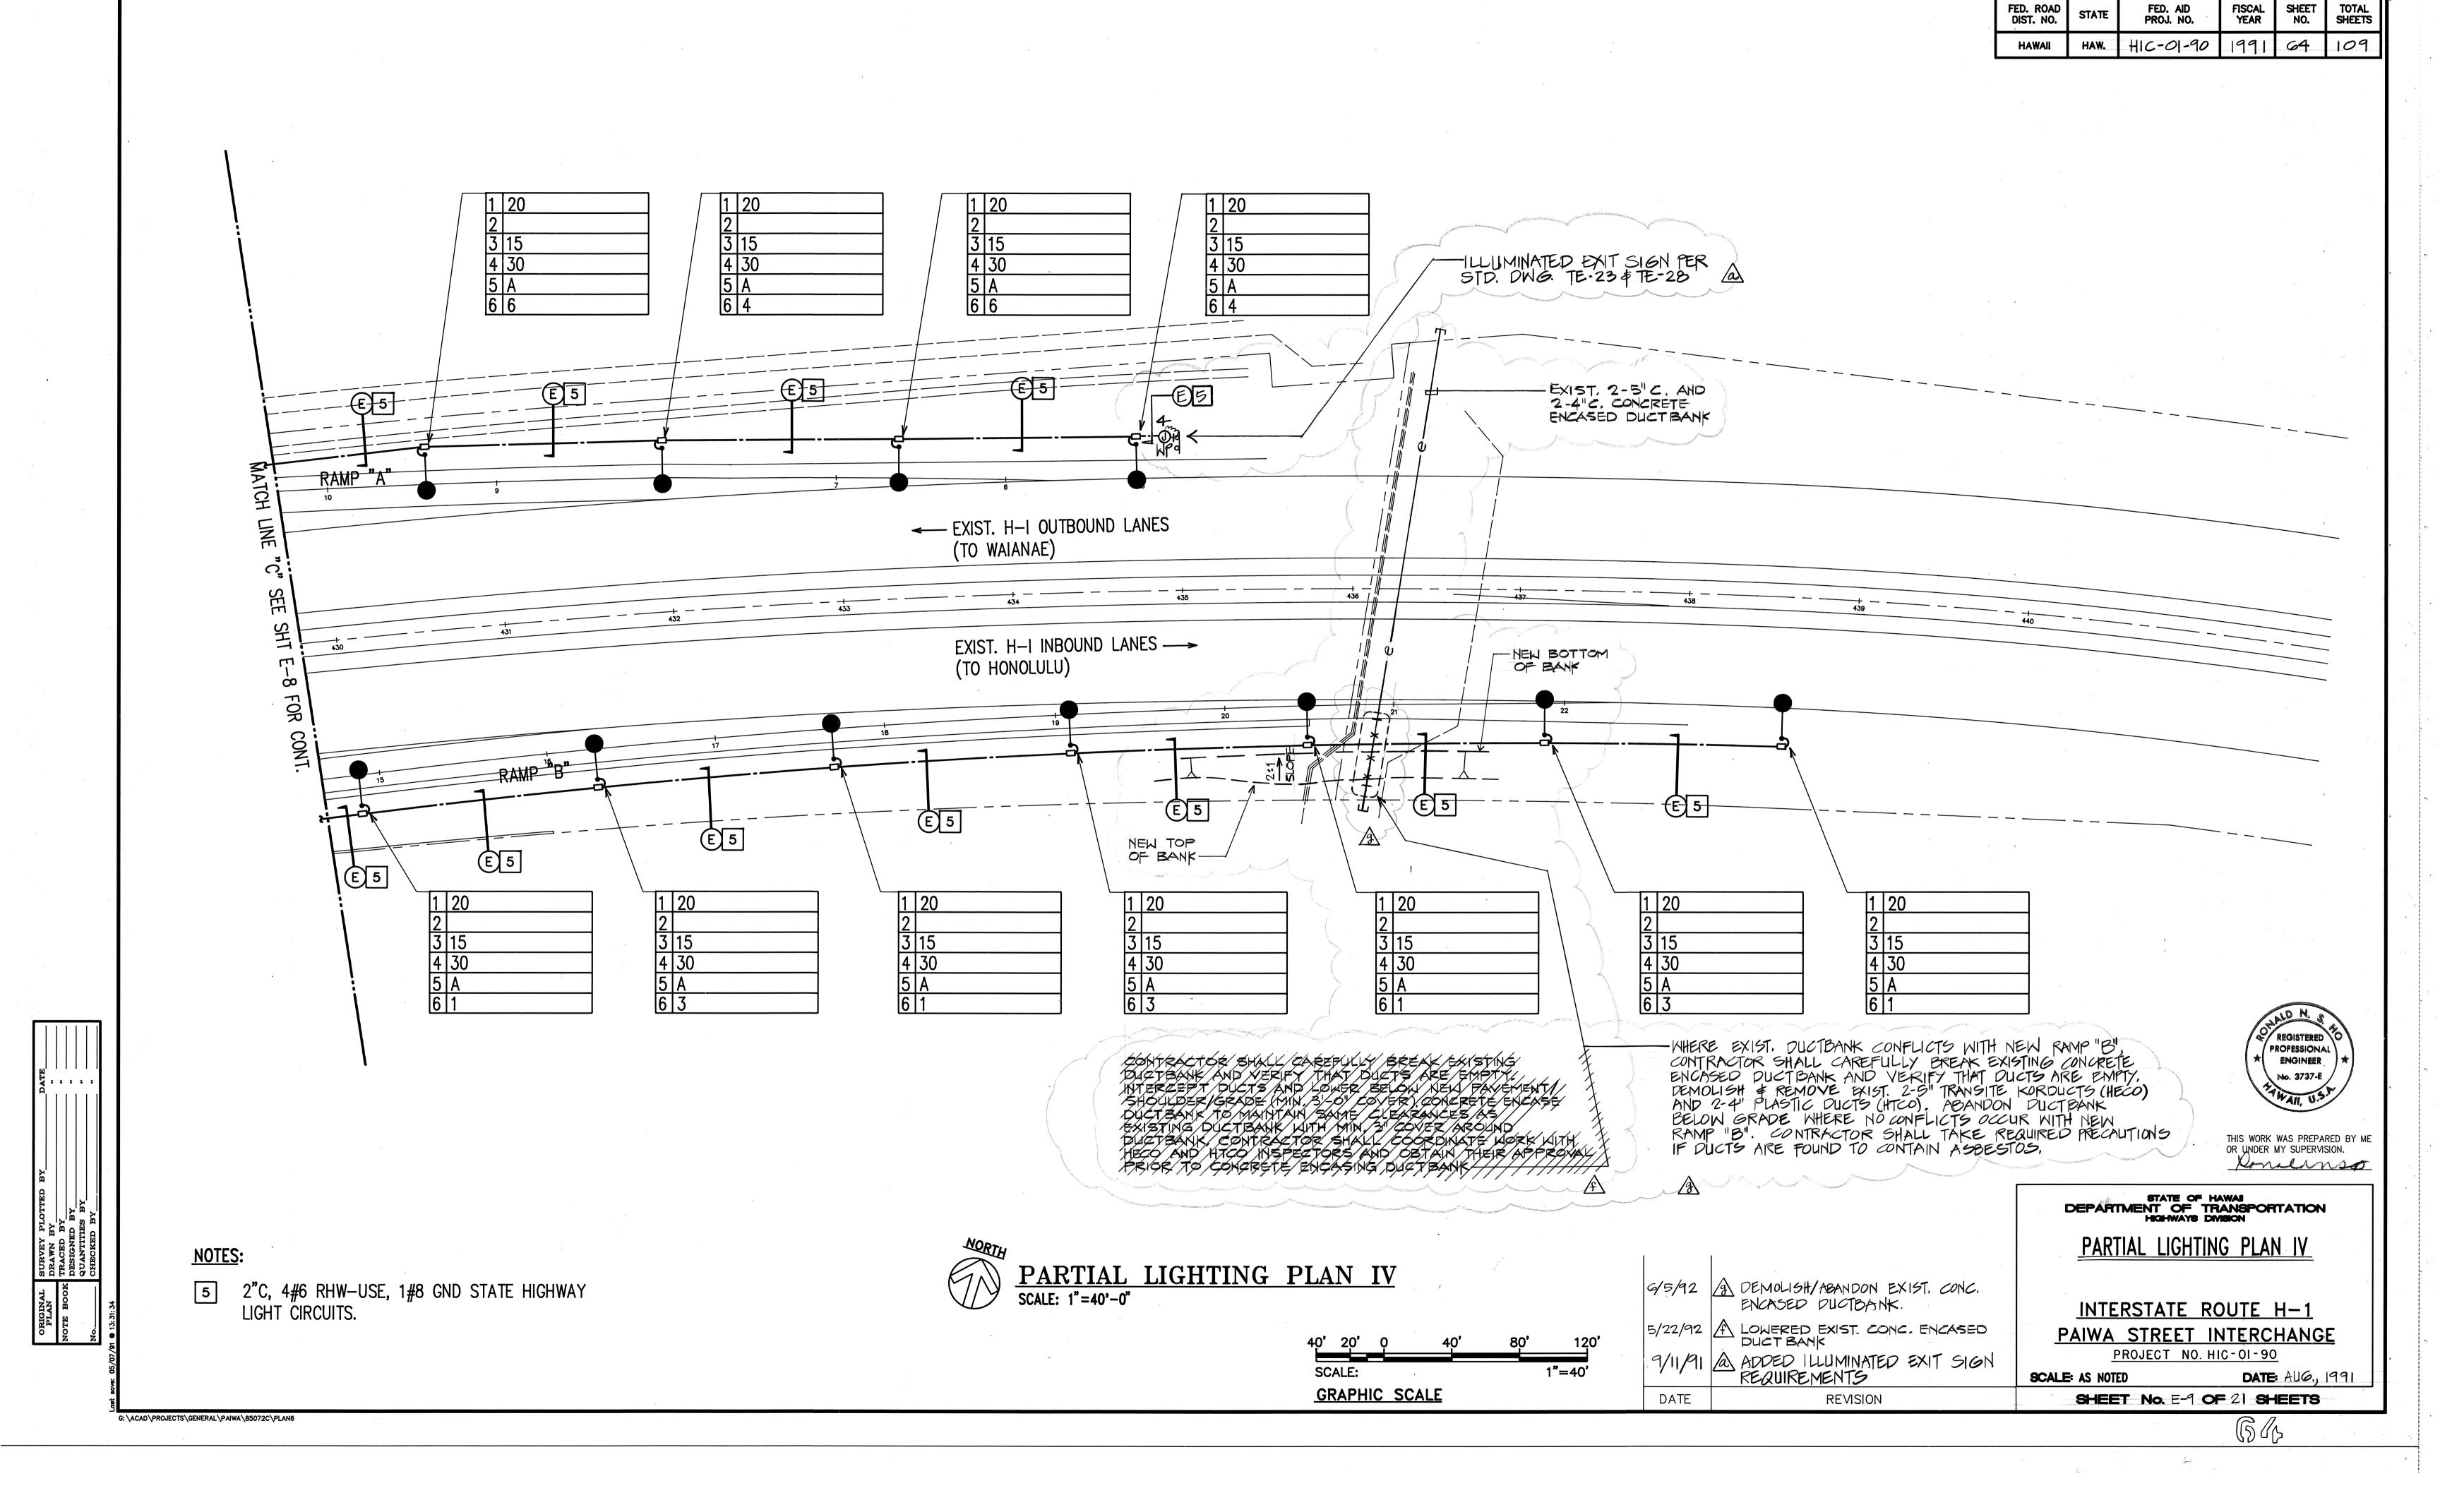
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CHECKED BY "
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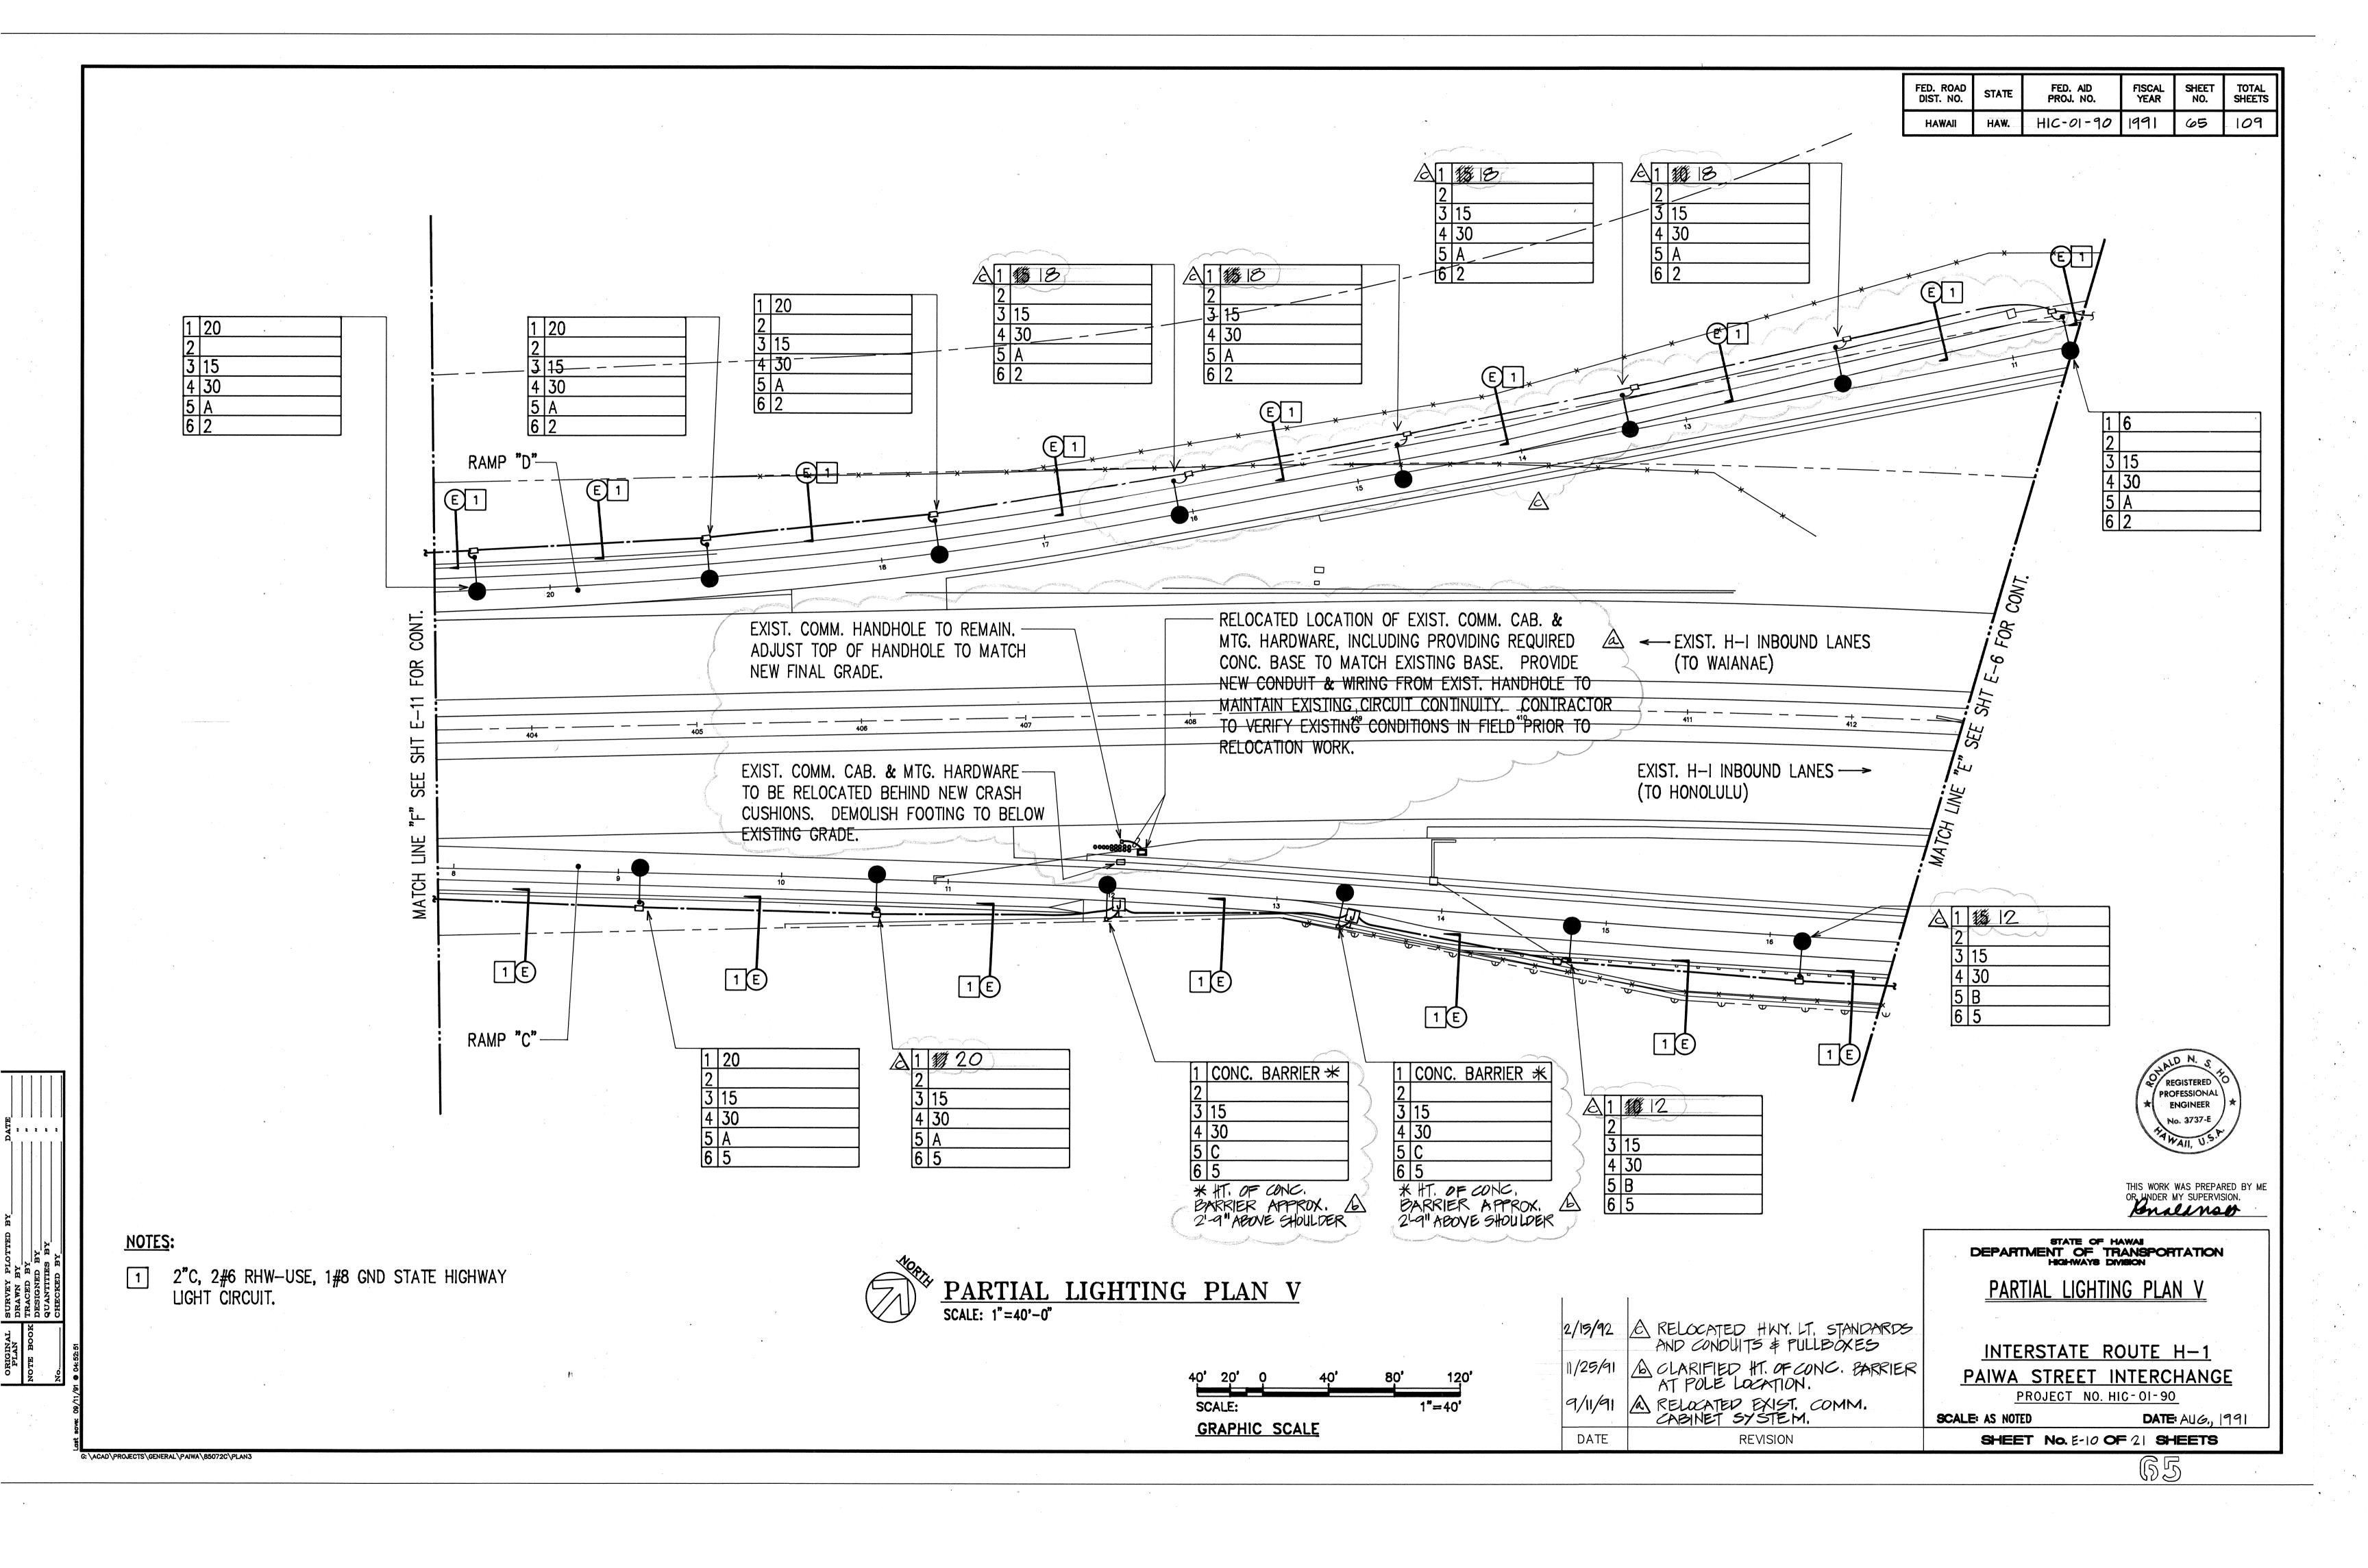
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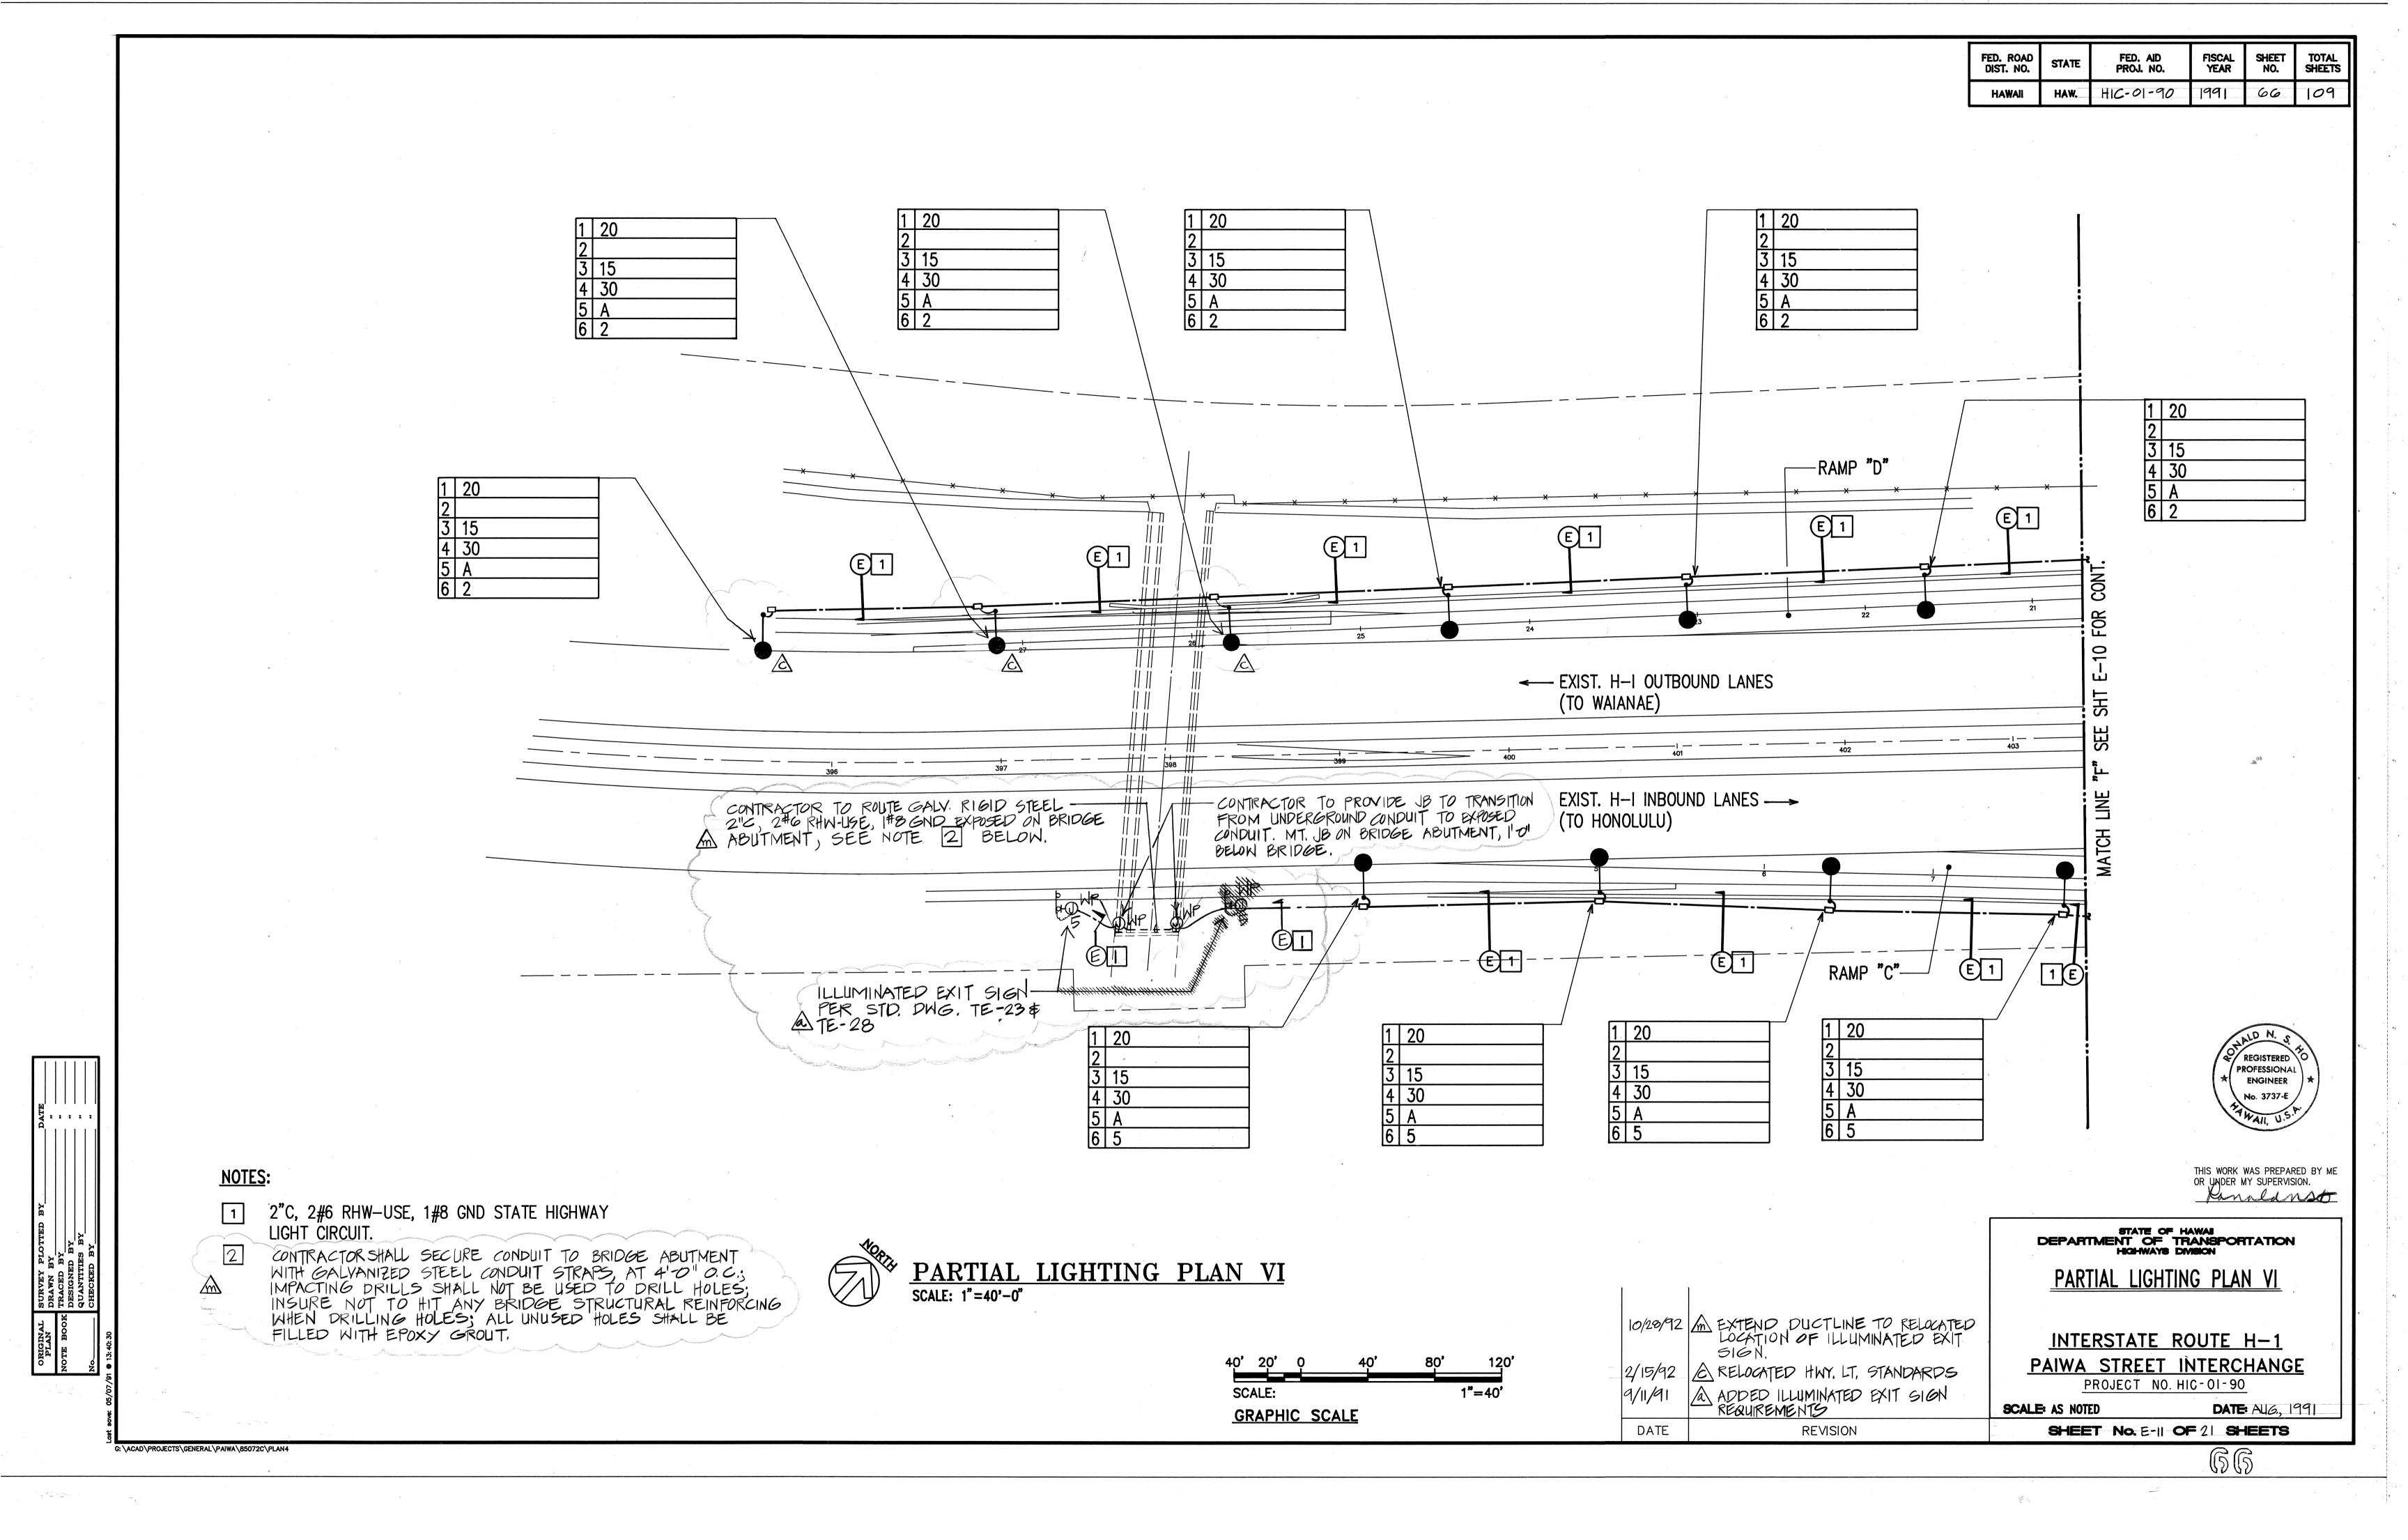
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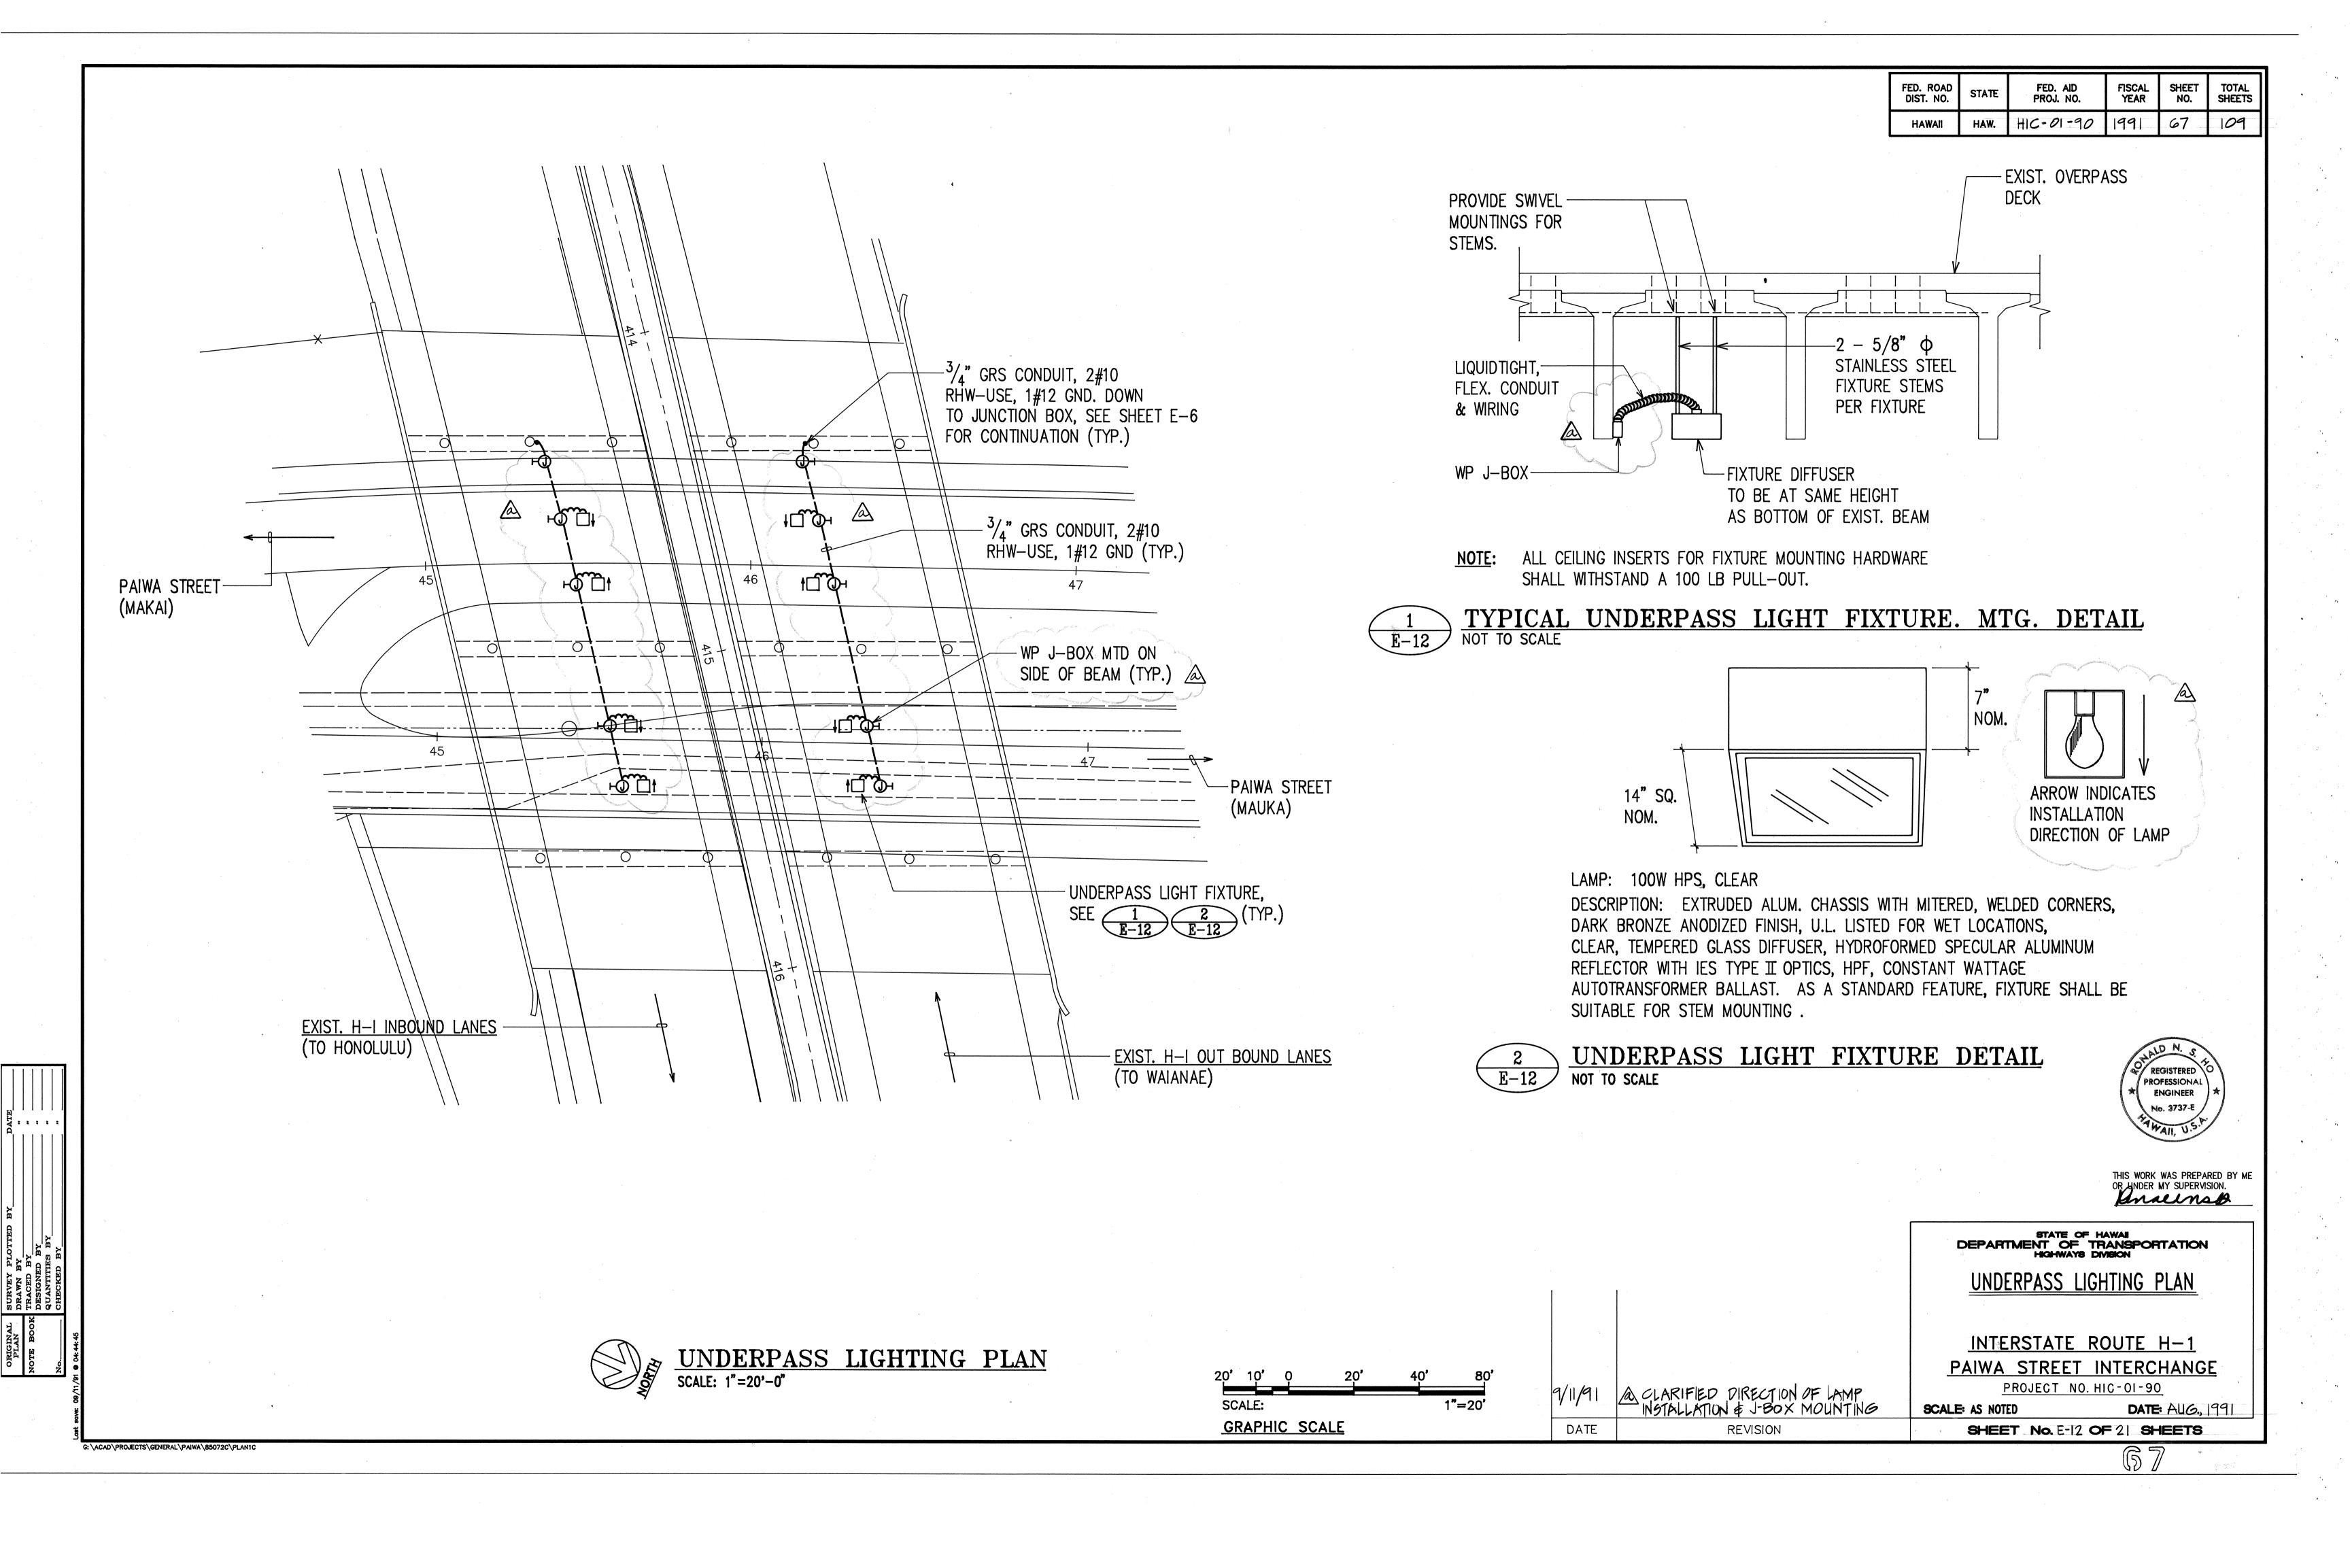
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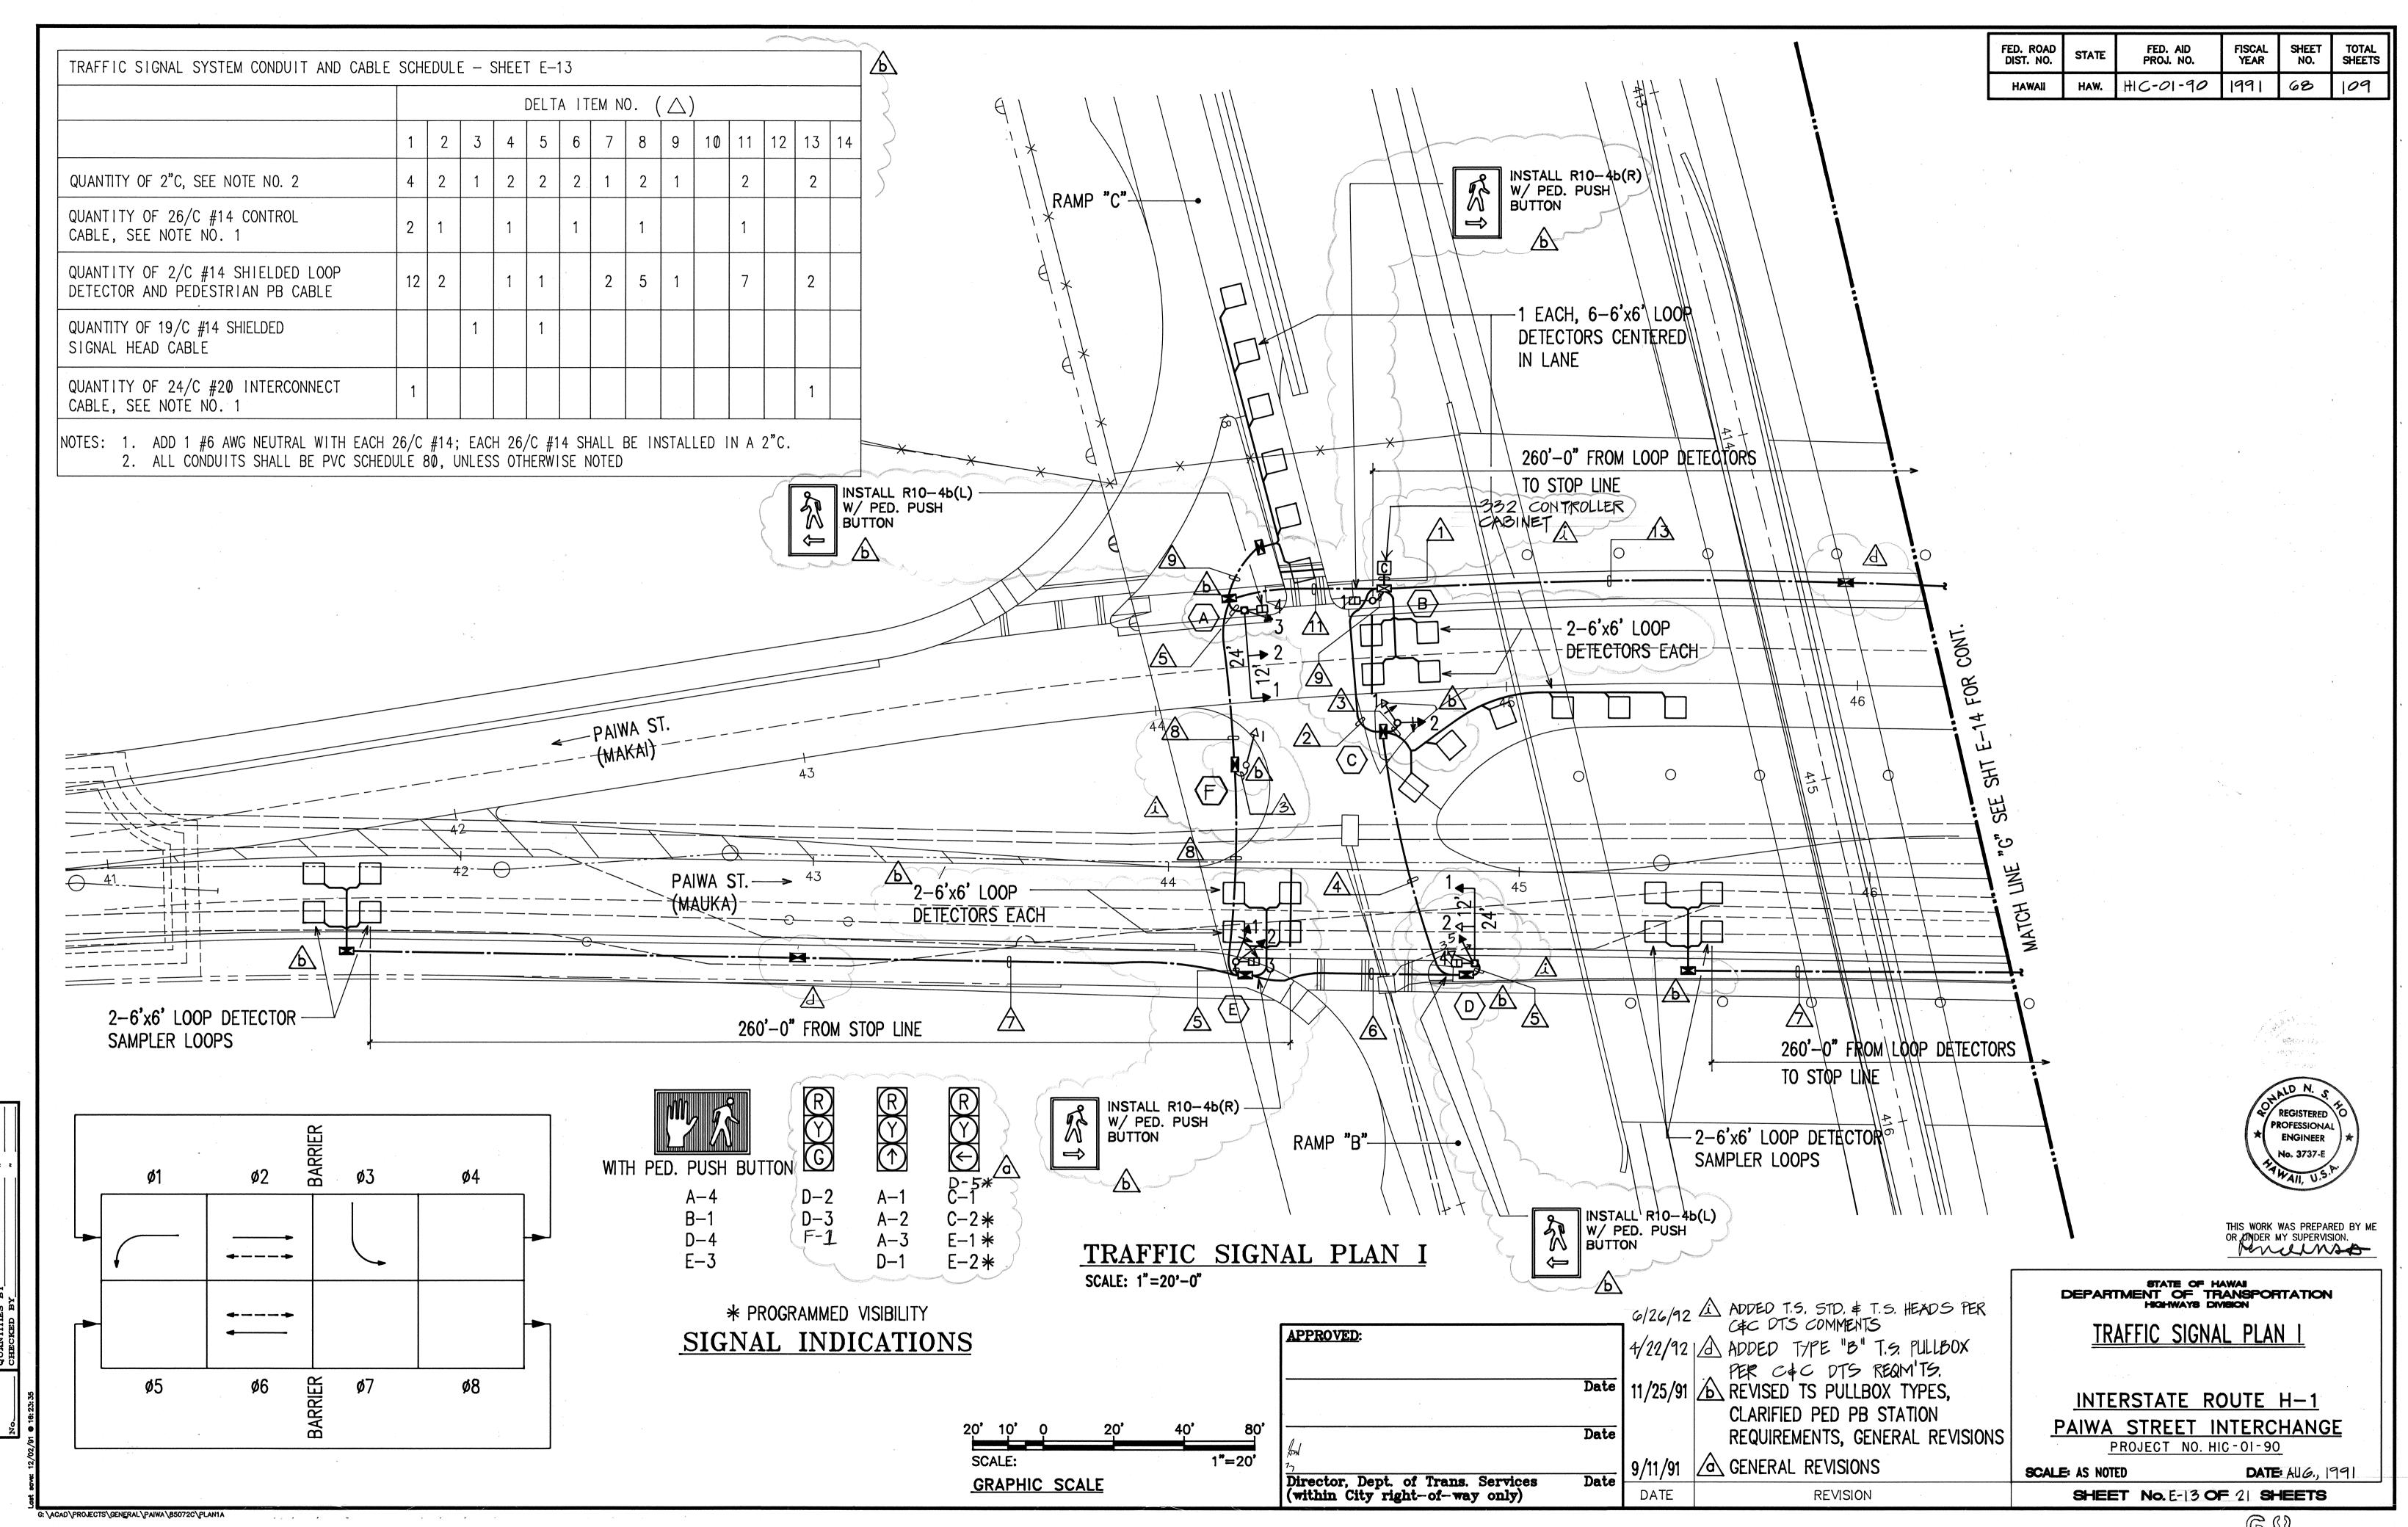














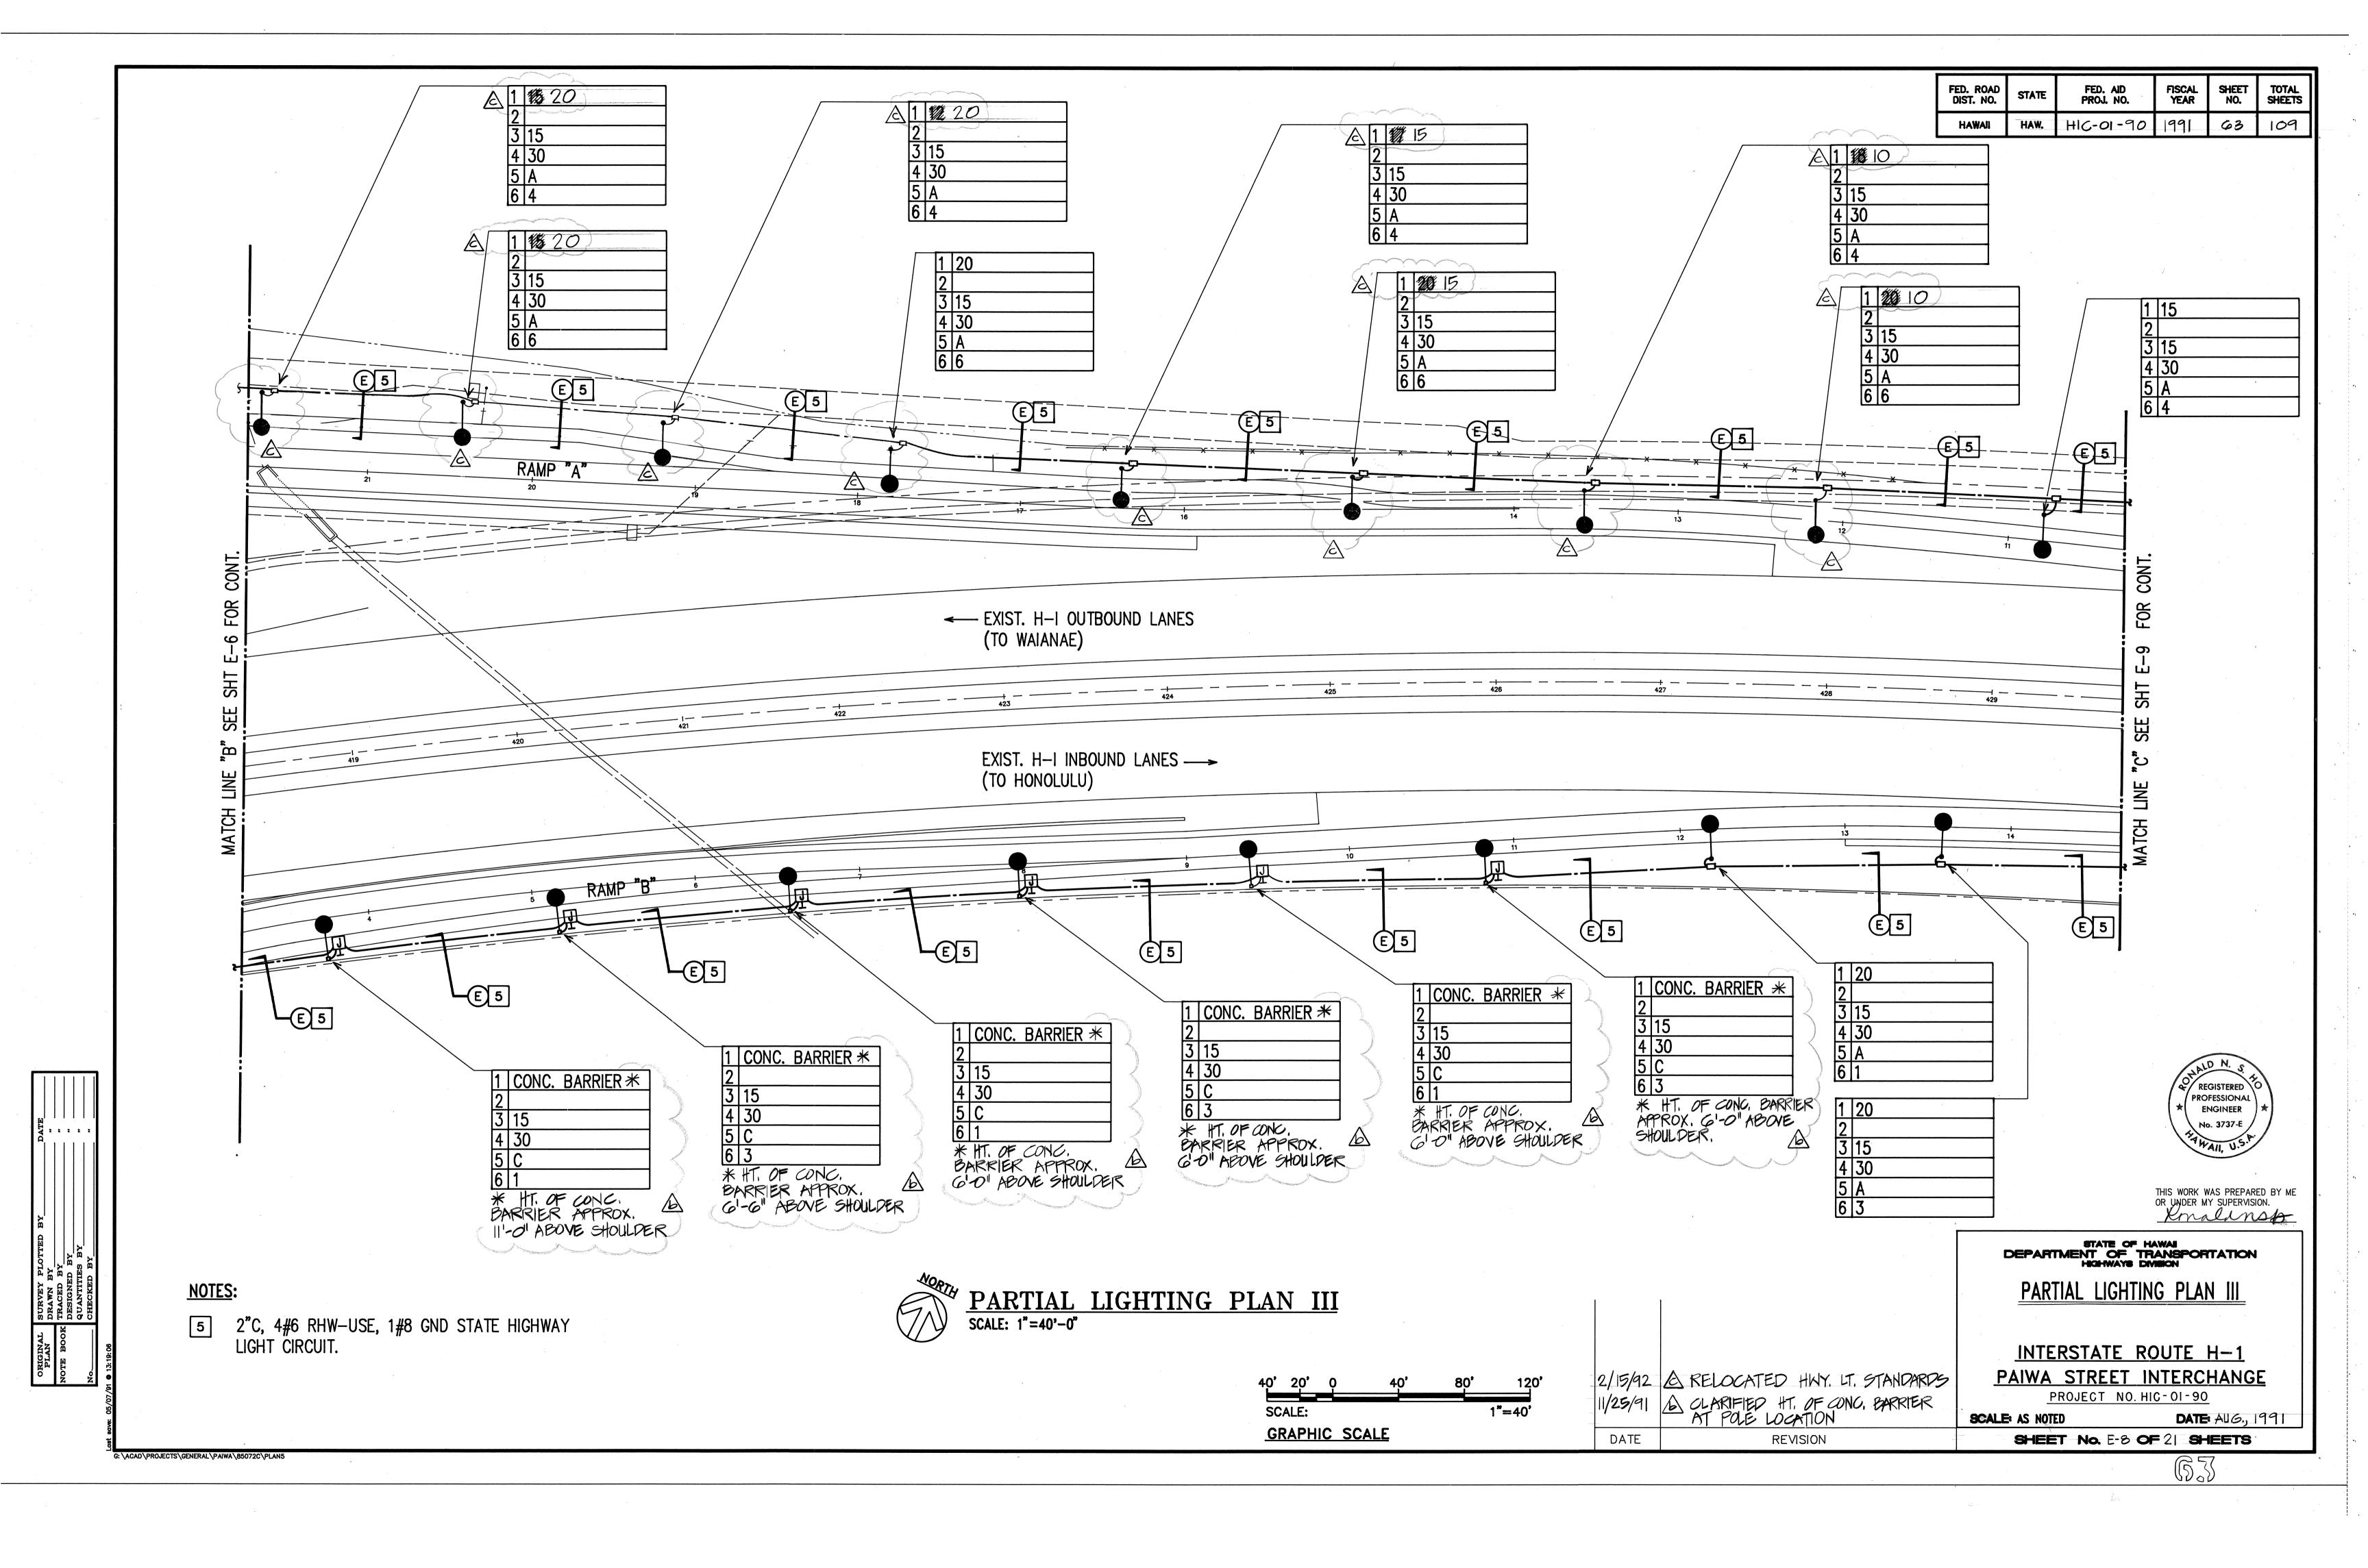

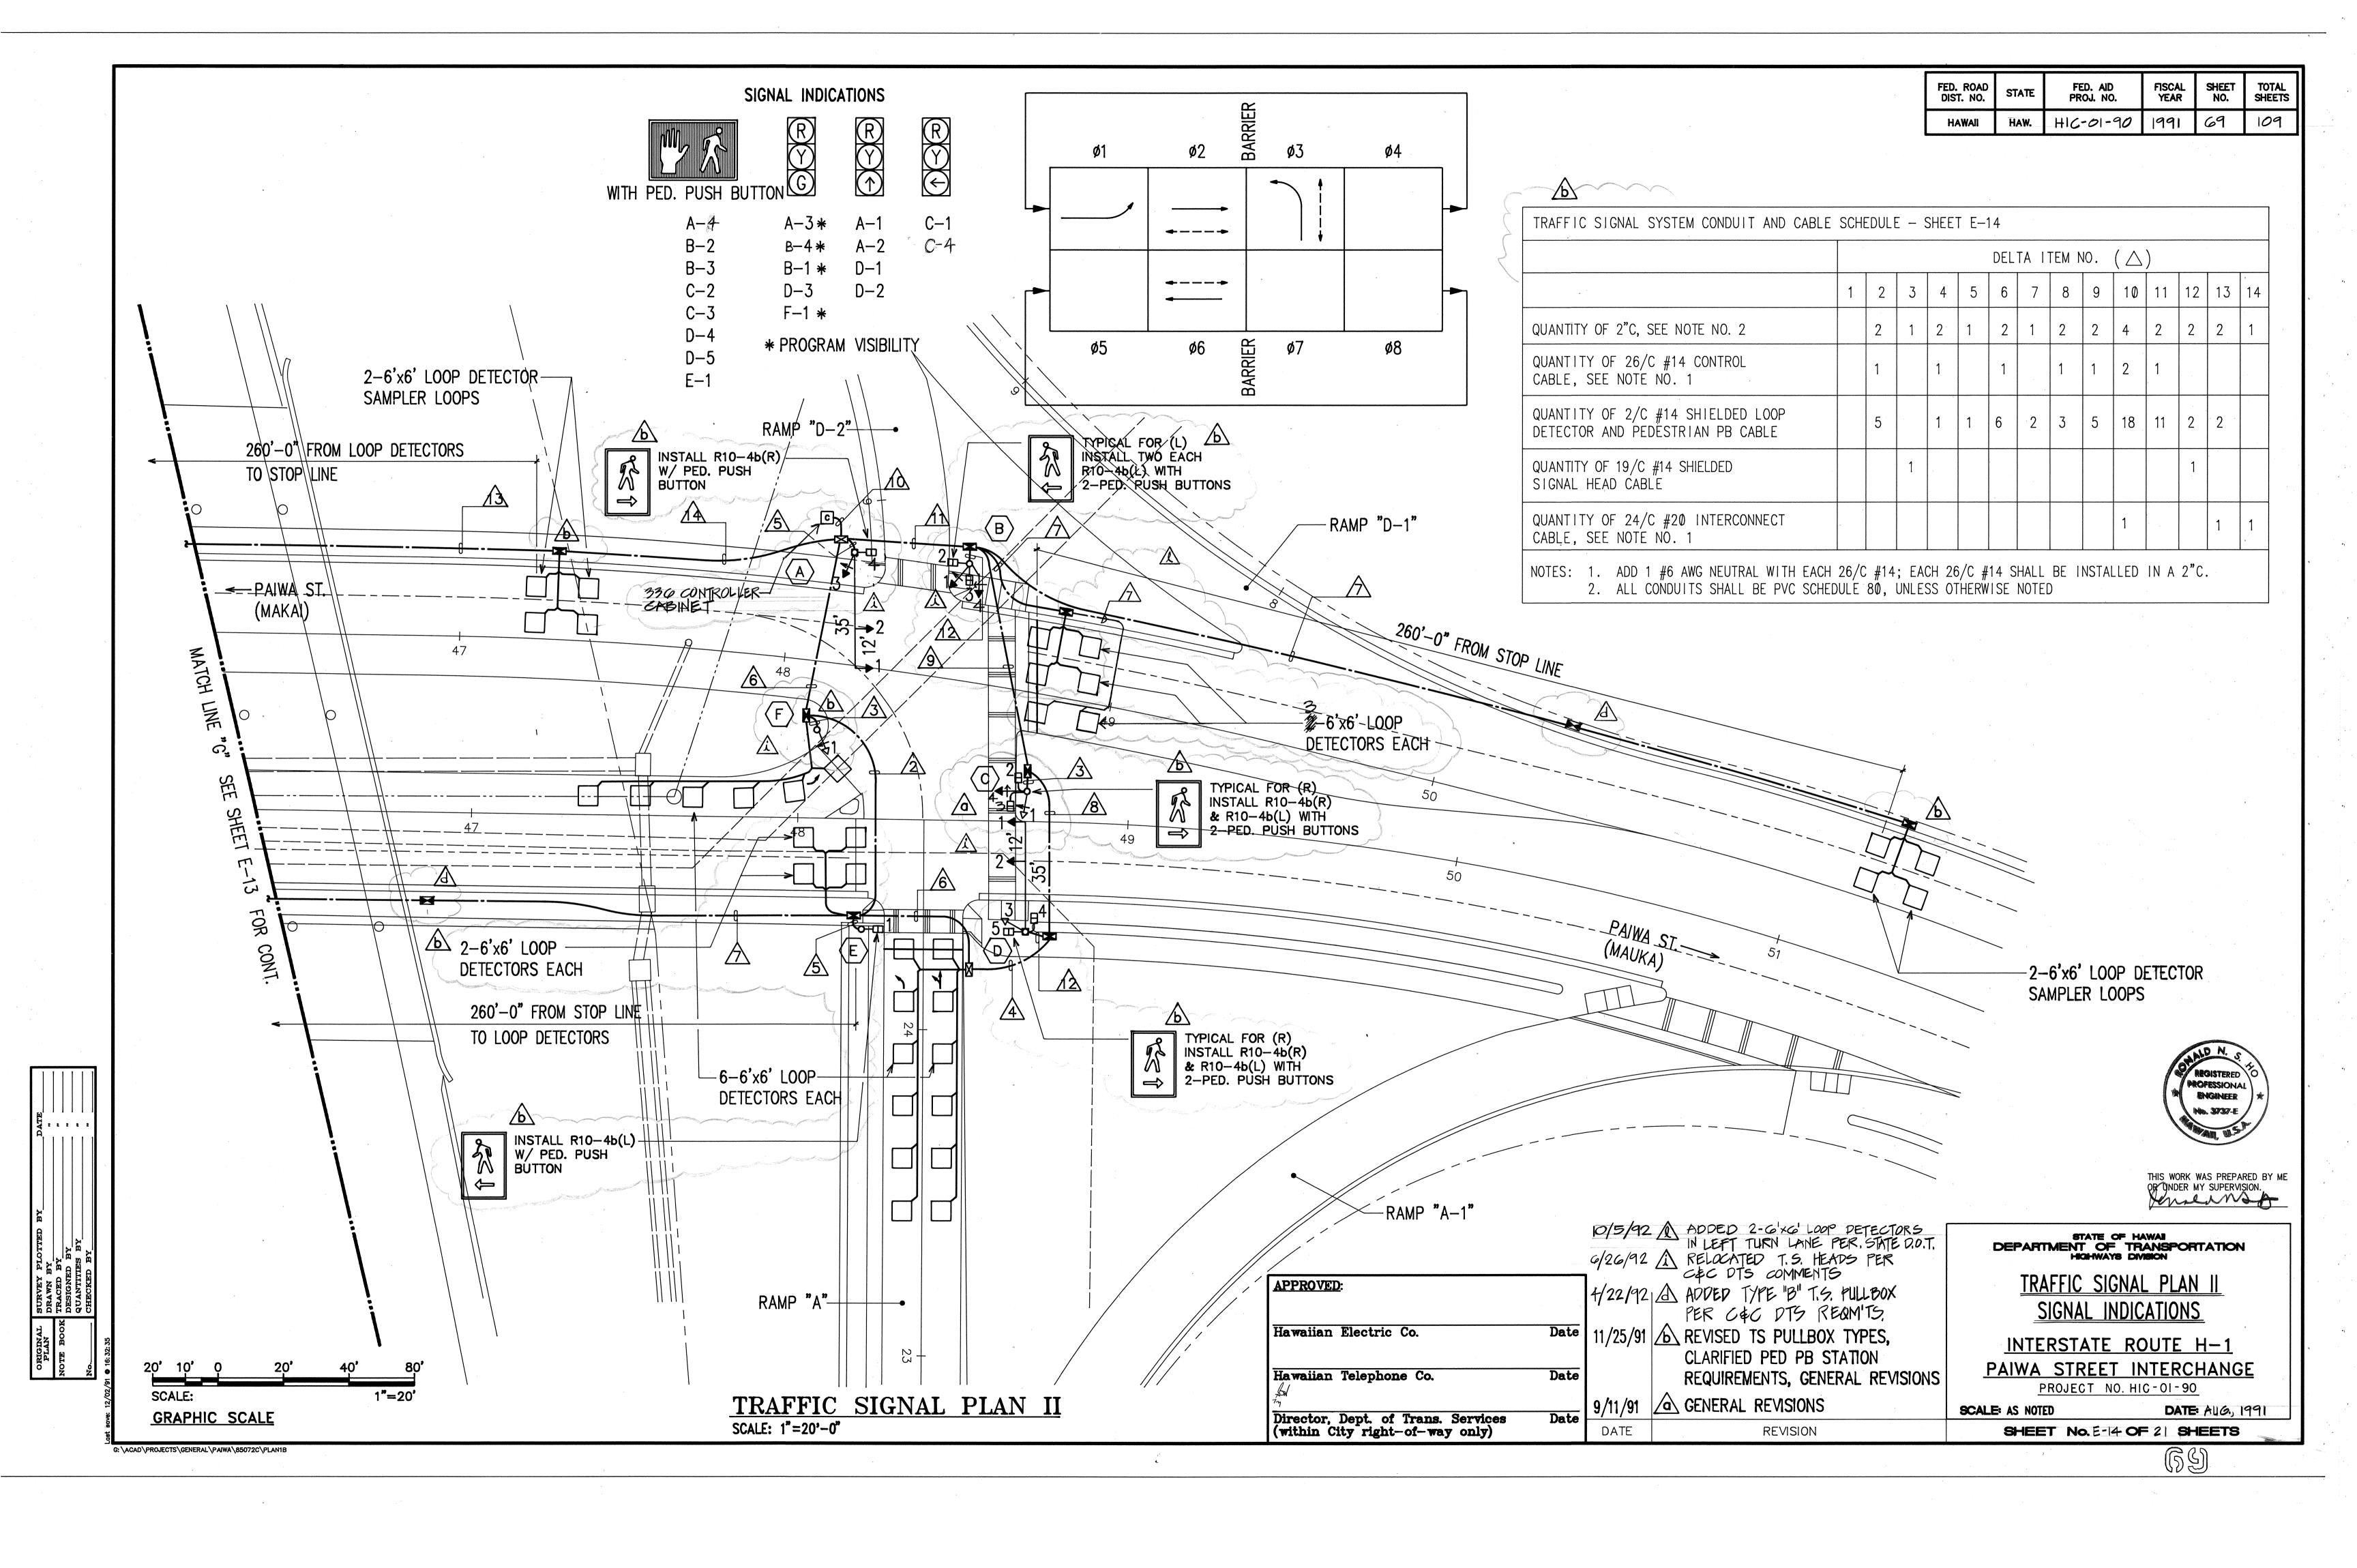

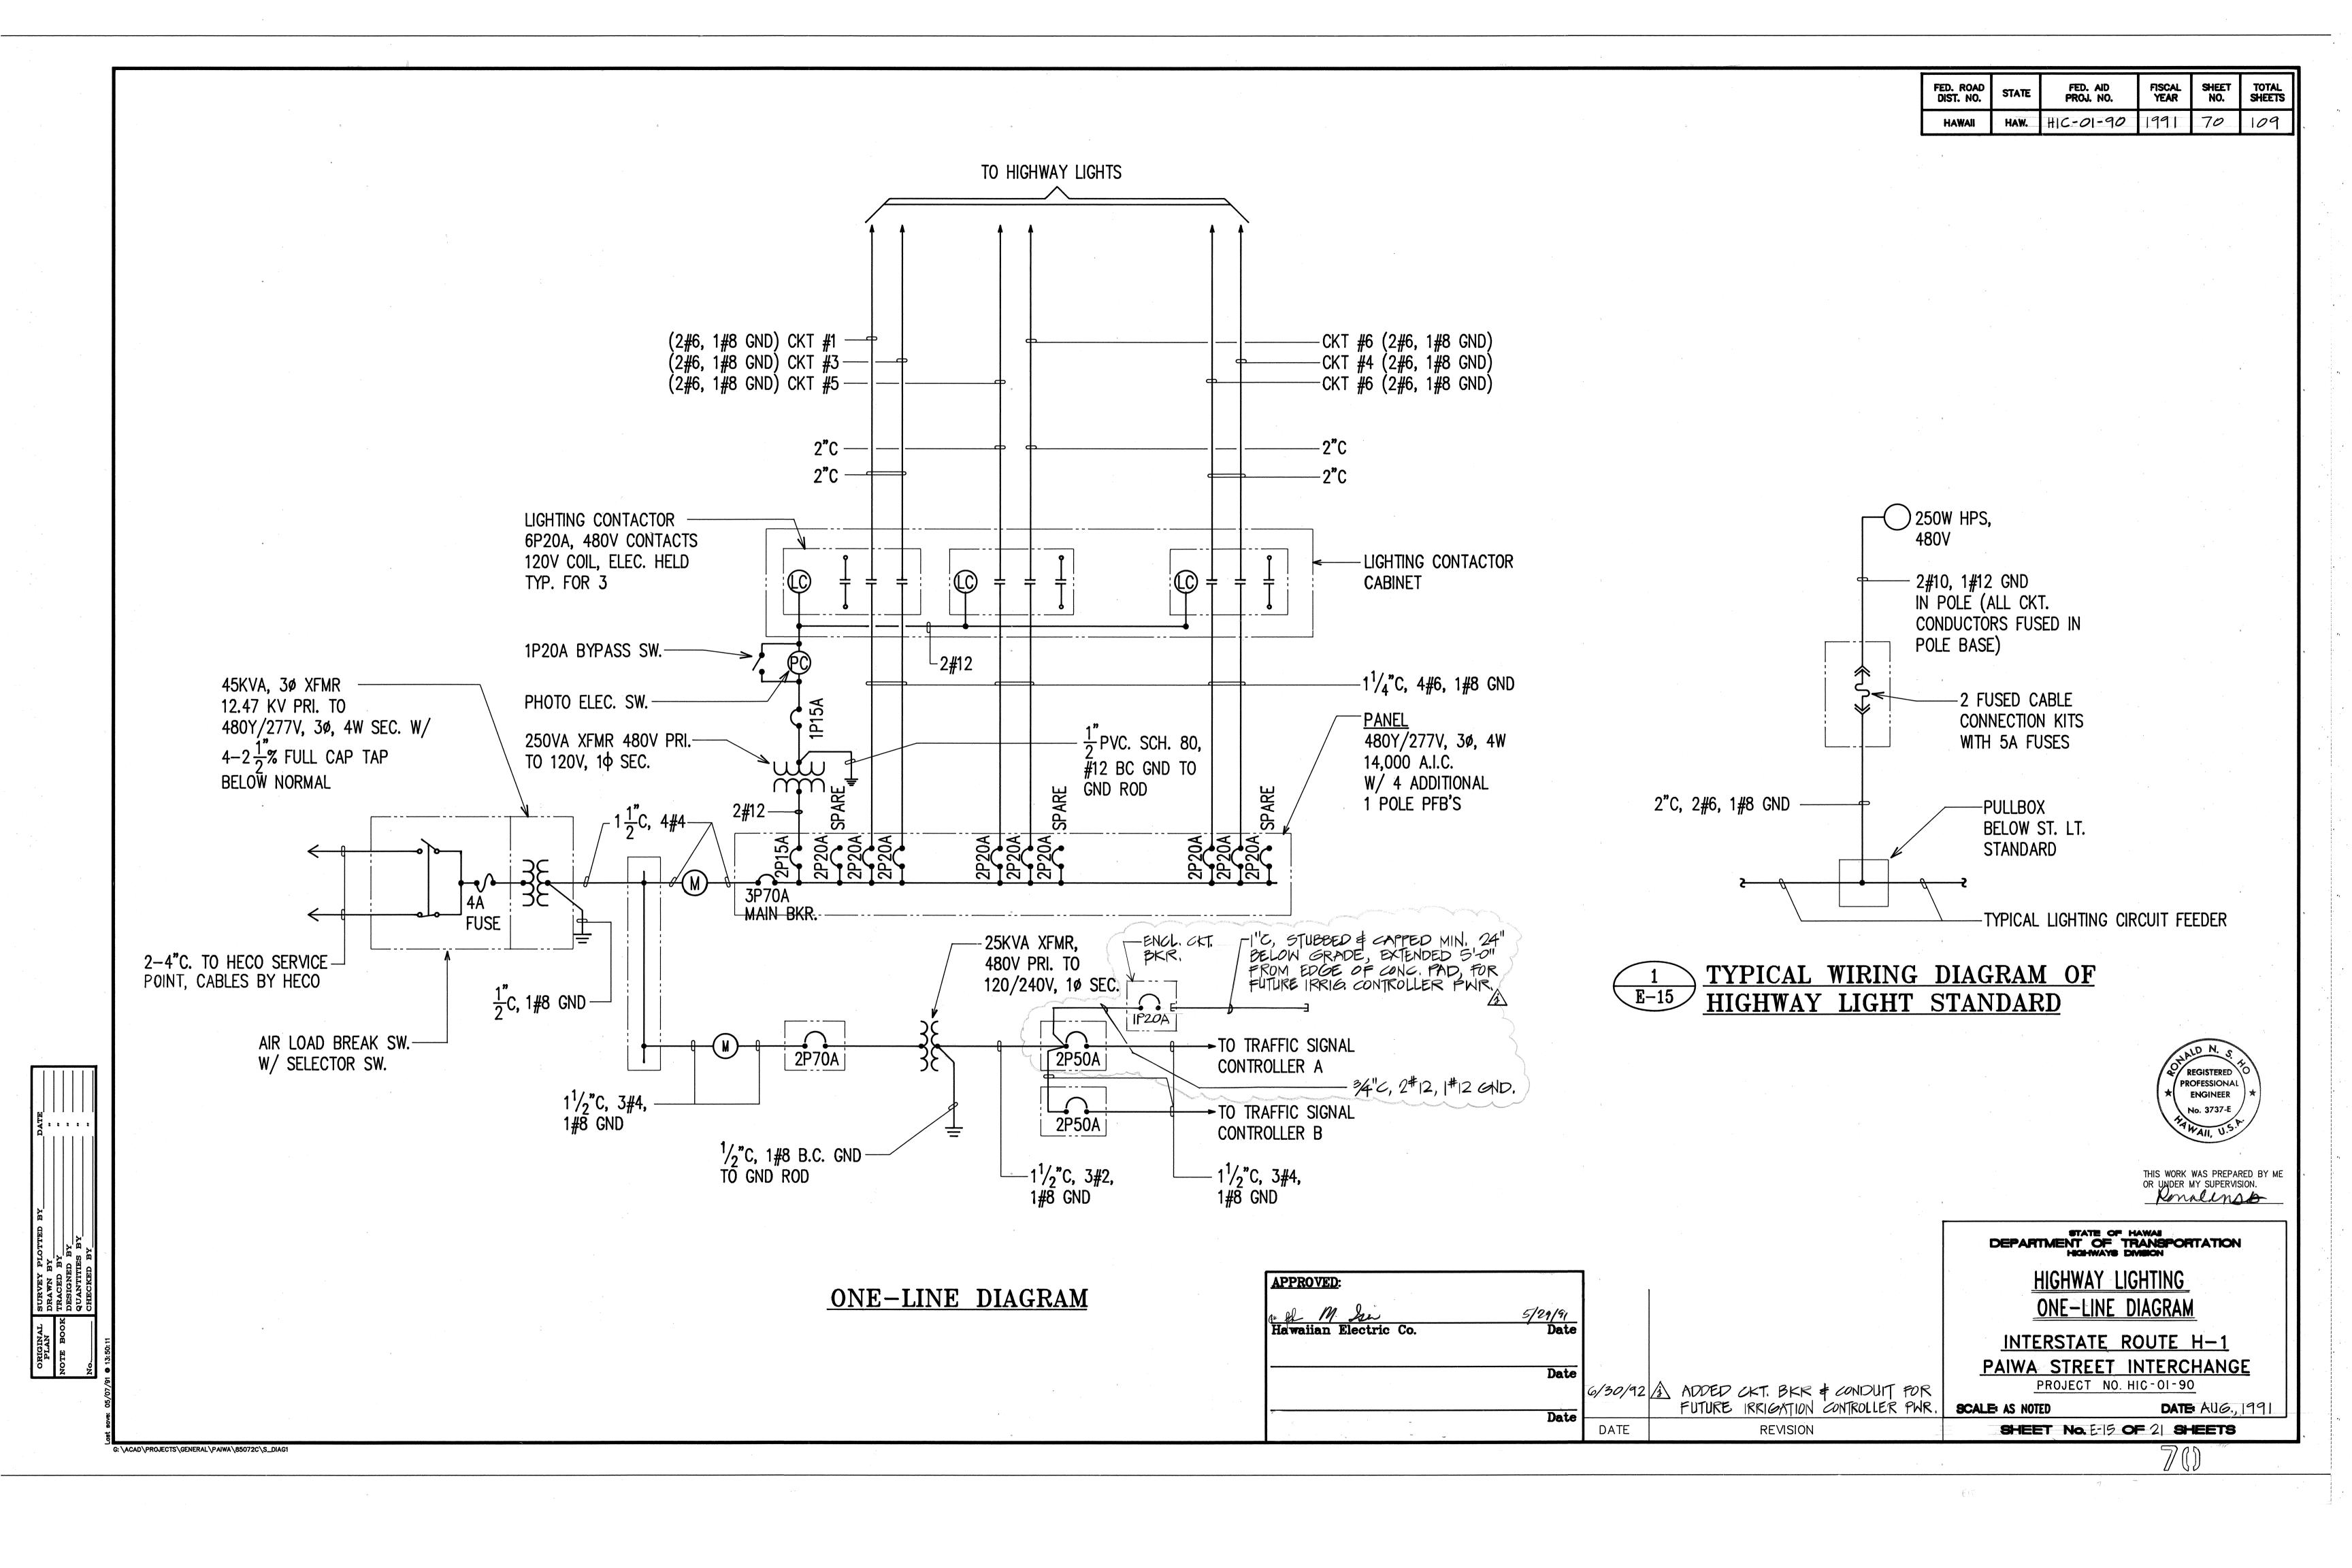

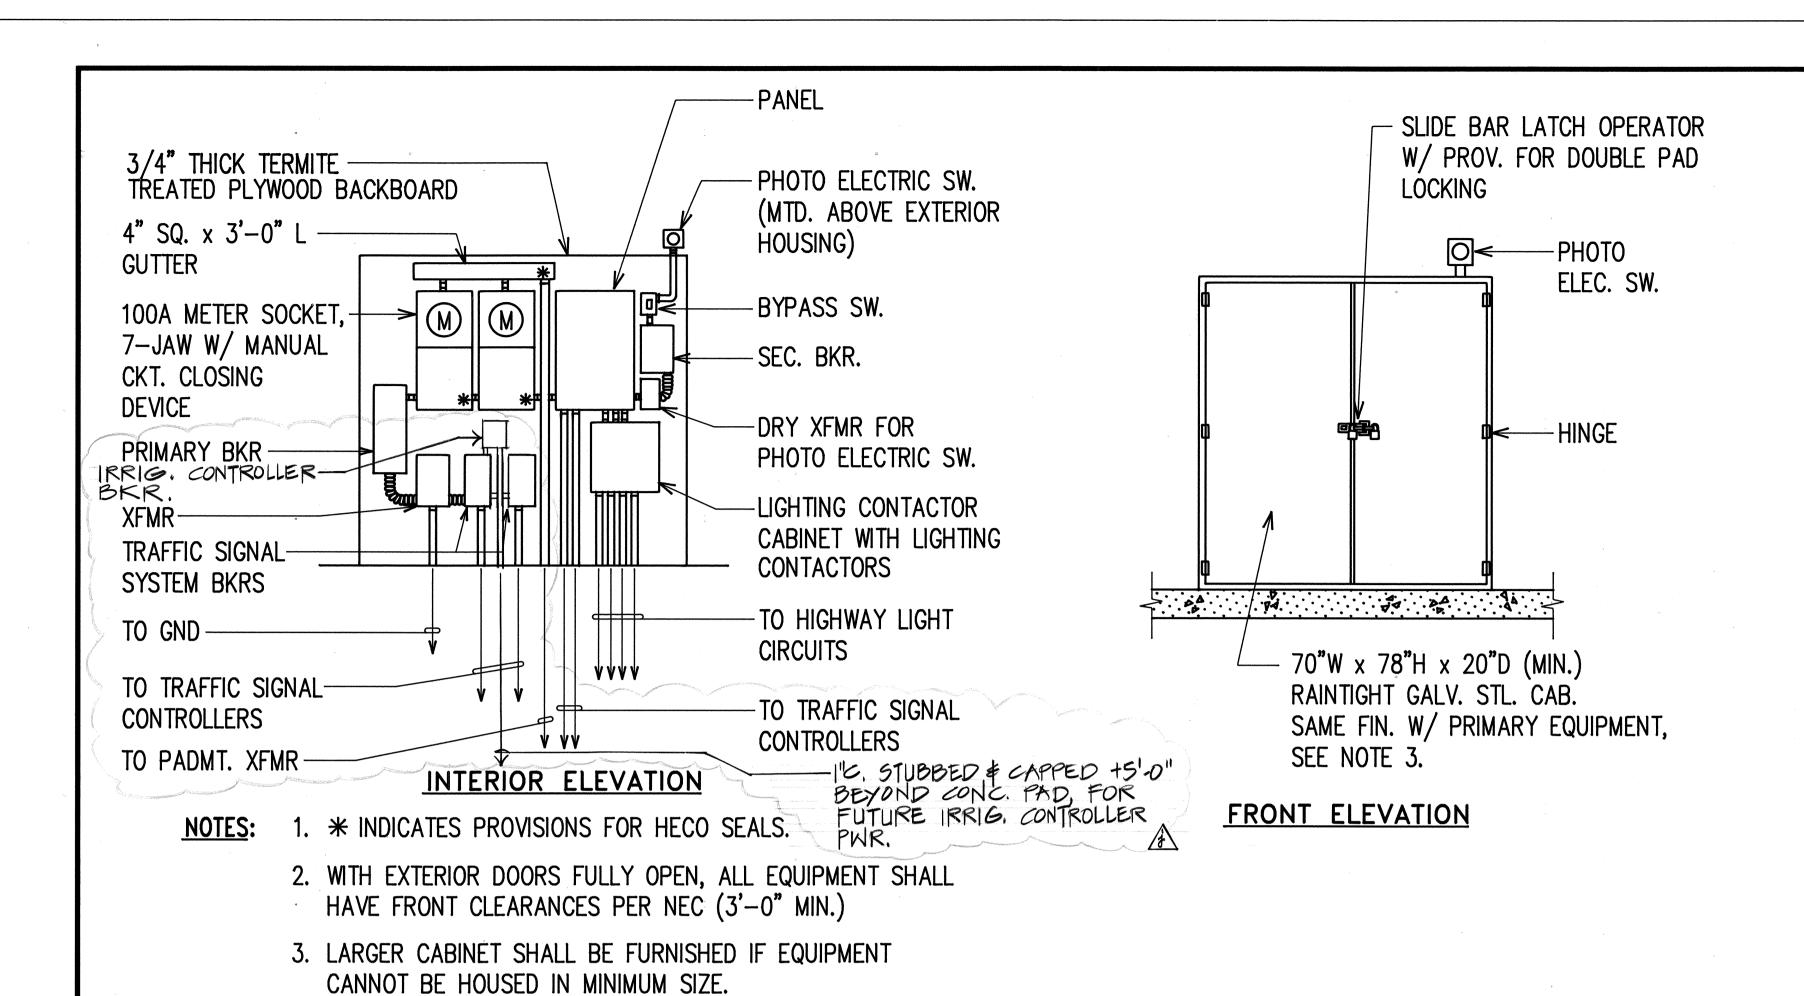

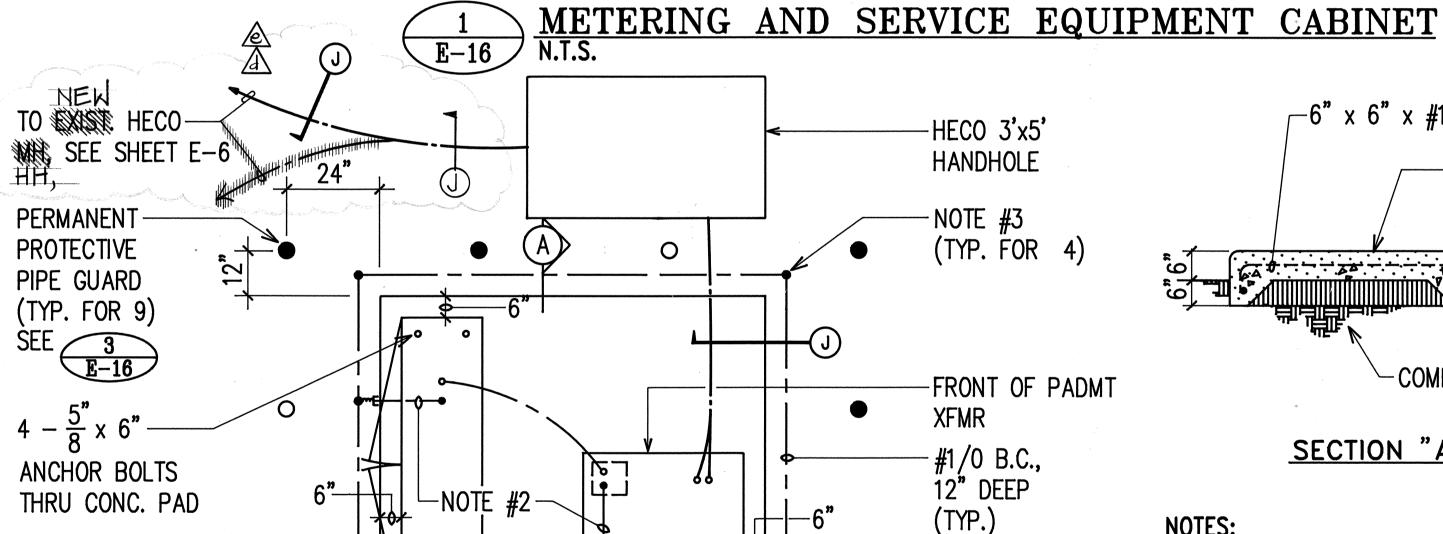

-METER &

**PLAN** 

SERVICE EQUIP.


E-16

ENCL. SEE 1 E-16

-PADMT. XFMR.

24"


TRANSFORMER STATION

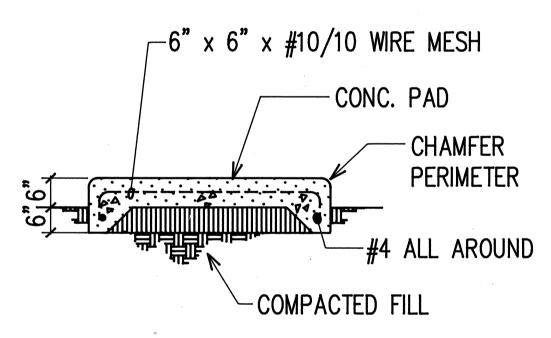

SECTION "A-A"


# **NOTES:**

- HARDWARE TO BE HOT DIPPED GALV. AFTER FABRICATION.
- 2.  $\frac{1}{2}$  C, 1#8 GND.
- 3. GND. ROD  $\frac{5}{8} \div x \ 8' 0"$
- 4. VERIFY EQUIP. DIMENSIONS & CONC. PAD REQUIREMENTS WITH EQUIPMENTS BEING PROVIDED.

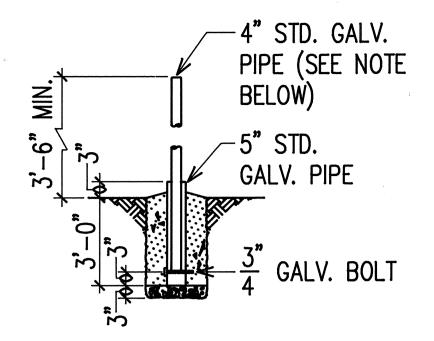

THE 4" STANDARD GALV. PIPE TO BE FILLED WITH CONCRETE TO WEIGH APPROXIMATELY 150 LBS.



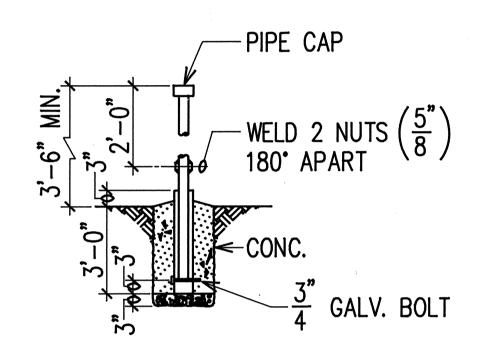

THE PIPE THAT IS TO BE PLACED DIRECTLY IN FRONT OF THE DOORS SHALL NOT BE FILLED WITH CONCRETE. THE PIPE SHALL BE CAPPED AND THE WELDED NUTS ARE FOR SCREWING IN BOLTS TO ACT AS "HANDLES" FOR LIFTING. THE BOLTS ARE TO BE REMOVED AFTER INSTALLATION.




HAW. HIG-01-90 1991 71 109

FED. AID PROJ. NO.

FISCAL YEAR

SHEET NO.

TOTAL SHEETS

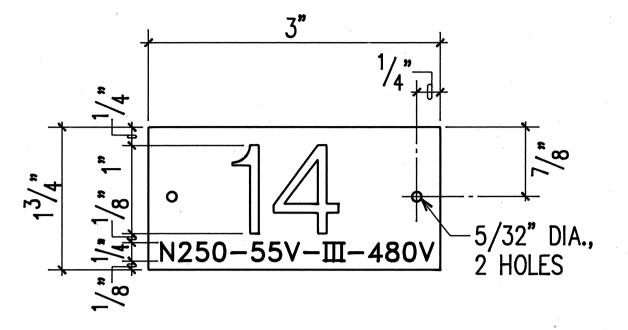

= POLE & LIGHT NUMBER PER STATE REQM'TS.

N250 = LAMP TYPE & WATTAGE, N = SODIUM

55V = LAMP VOLTAGE

FED. ROAD DIST. NO.

STATE

= IES TYPE DISTRIBUTION

480V = BALLAST VOLTAGE

- 1. USE 3-PLY PLASTIC BLACK, WHITE, BLACK.
- 2. NUMBER SIZE SHALL BE 1" HIGH & ENGRAVED 1/8" WIDE, WHITE IN COLOR (NO. AS REQUIRED).
- 3. NOMENCLATURE SIZE SHALL BE 1/4" HIGH & ENGRAVED 1/32" WIDE, WHITE IN COLOR (WATTAGE, LAMP VOLTAGES, IES DISTRIBUTION & BALLAST VOLTAGE).
- 4. ATTACH SECURELY TO POLE WITH NO. 7 CADIUM PLATES SCREWS.
- 5. "N" FOR SODIUM LAMPS.
- 6. ATTACH TAG 6'-0" ABOVE FINISH GRADE ON STREET SIDE.





BARRIER POSTS ARE TO BE PAINTED YELLOW AS PER ANSI SPEC. Z53.1 TO COMPLY WITH THE OSHA STANDARDS FOR COLOR CODING.

# PIPE GUARD DETAILS

THIS WORK WAS PREPARED BY ME OR UNDER MY SUPERVISION.

	5/7/92	ADDED CKT. BKR & CONDUIT FOR FUTURE IRRIGATION CONTROLLER PWR.  REVISED DUCTLINE HOMERUN	INTER PAIWA S
Date	4/23/92	DIRECTION	DD.
Date	DATE	A REROUTED NEW DUCTLINE INTO NEW HECO HH IN PAIWA ST.  REVISION	SCALE: AS NOTED

STATE OF HAWAII
DEPARTMENT OF TRANSPORTATION
HIGHWAYS DIVISION HIGHWAY LIGHTING TRANSFORMER STATION LAYOUT PLAN

INTERSTATE ROUTE H-1 PAIWA STREET INTERCHANGE PROJECT NO. HIC-01-90

SHEET No. E-16 OF 2 SHEETS

TOWARD <

PAIWA ST.

**REMOVABLE** 

PROTECTIVE

PIPE GUARD

(TYP. FOR 3)


SEE 4 E-16


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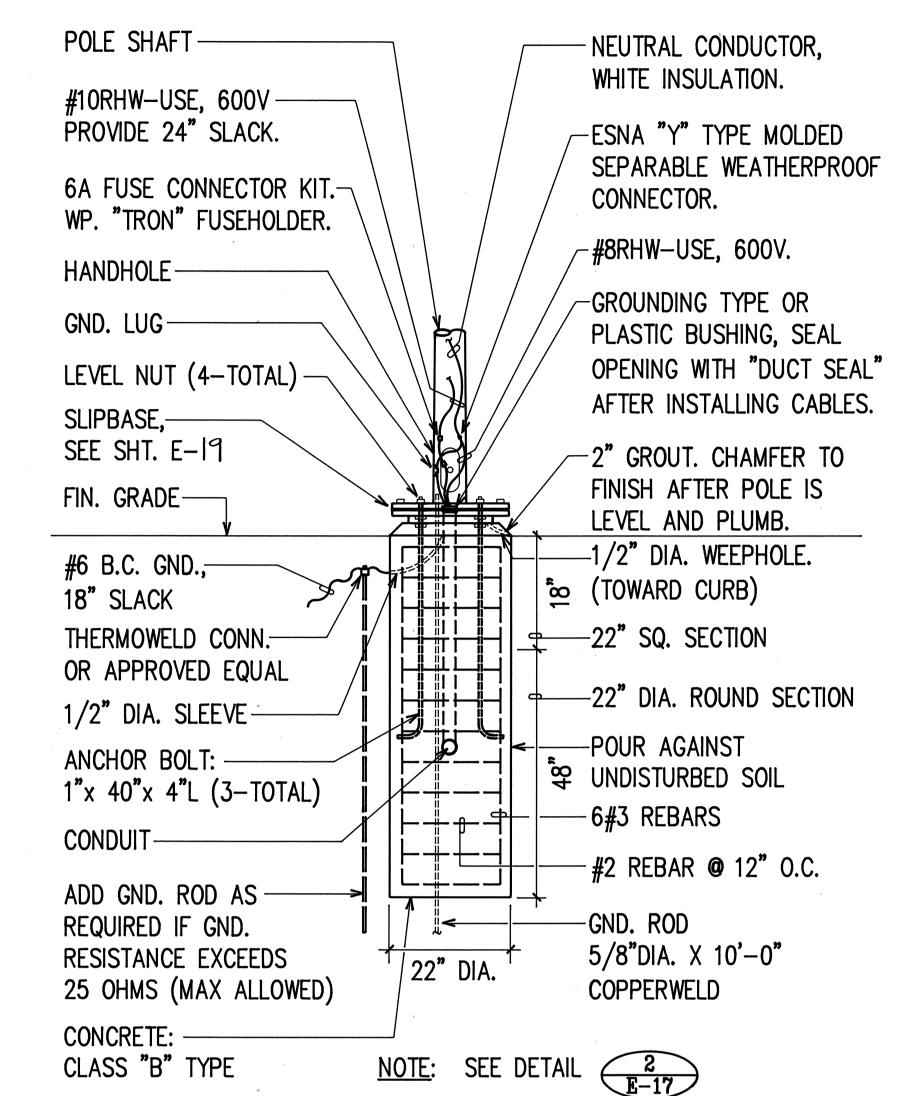
CONC. PAD,—

SEE NOTE #4

DATE: AUG., 1991



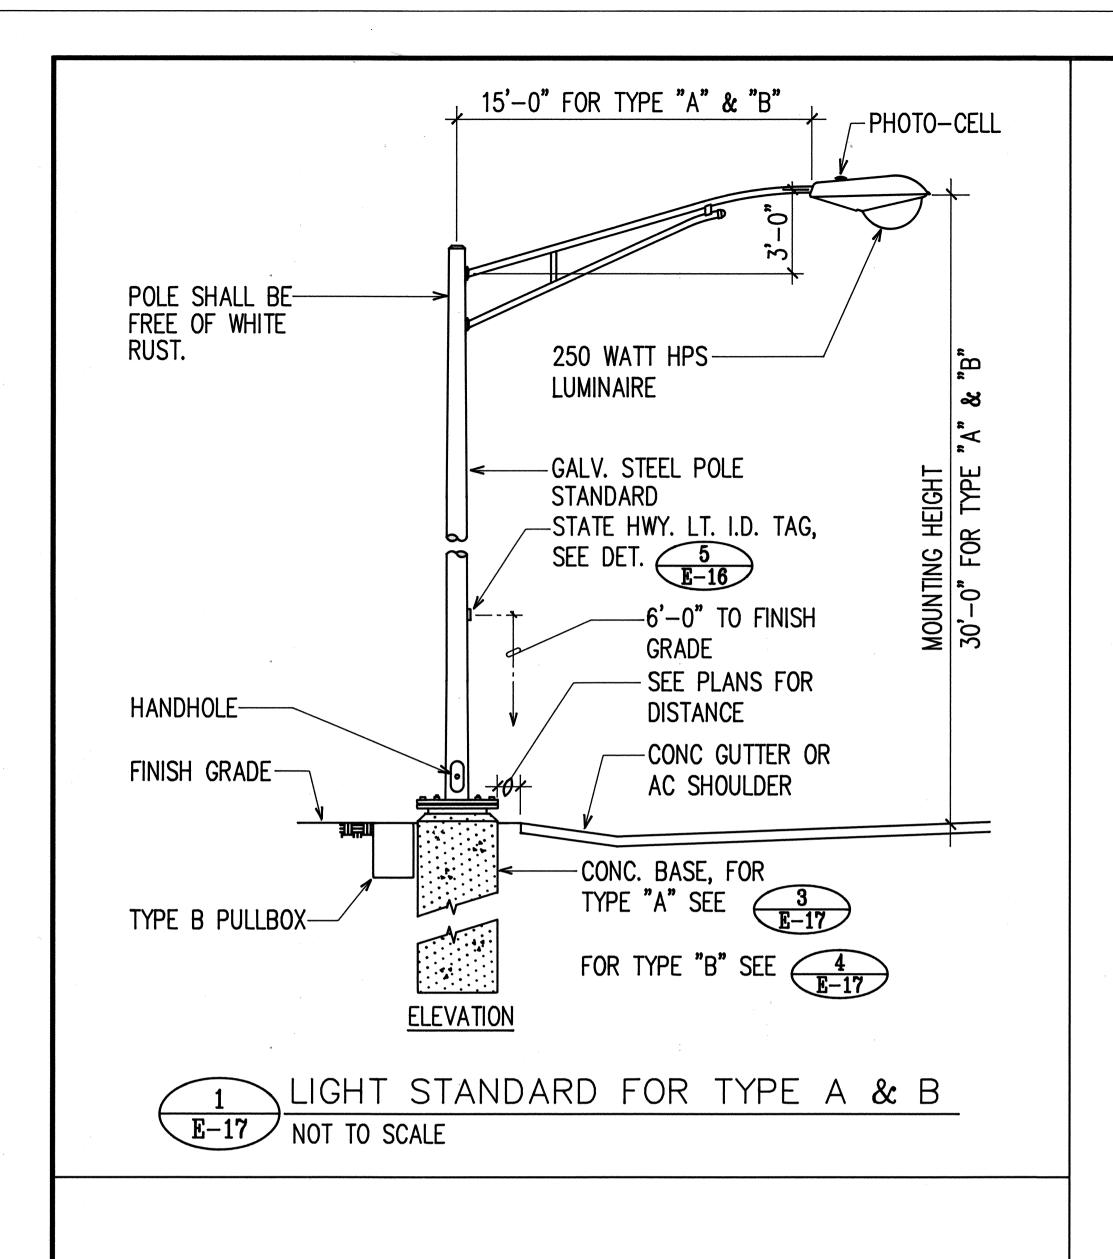


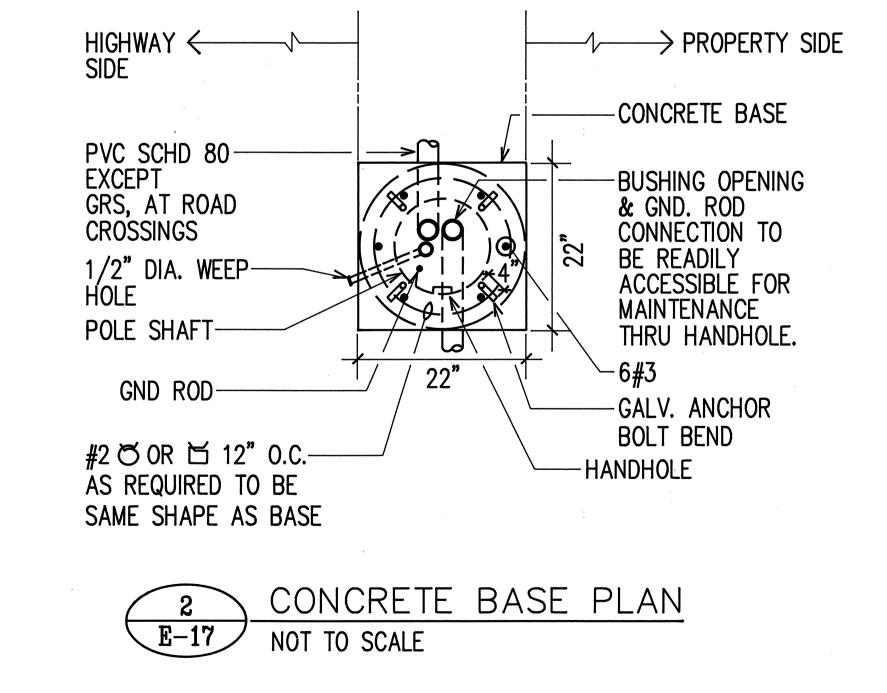

CONCRETE BASE ELEVATION
NOT TO SCALE

FED. ROAD DIST. NO. STATE FED. AID PROJ. NO. FISCAL SHEET NO. SHEETS


HAWAII HAW. HIG-01-90 1991 72 109

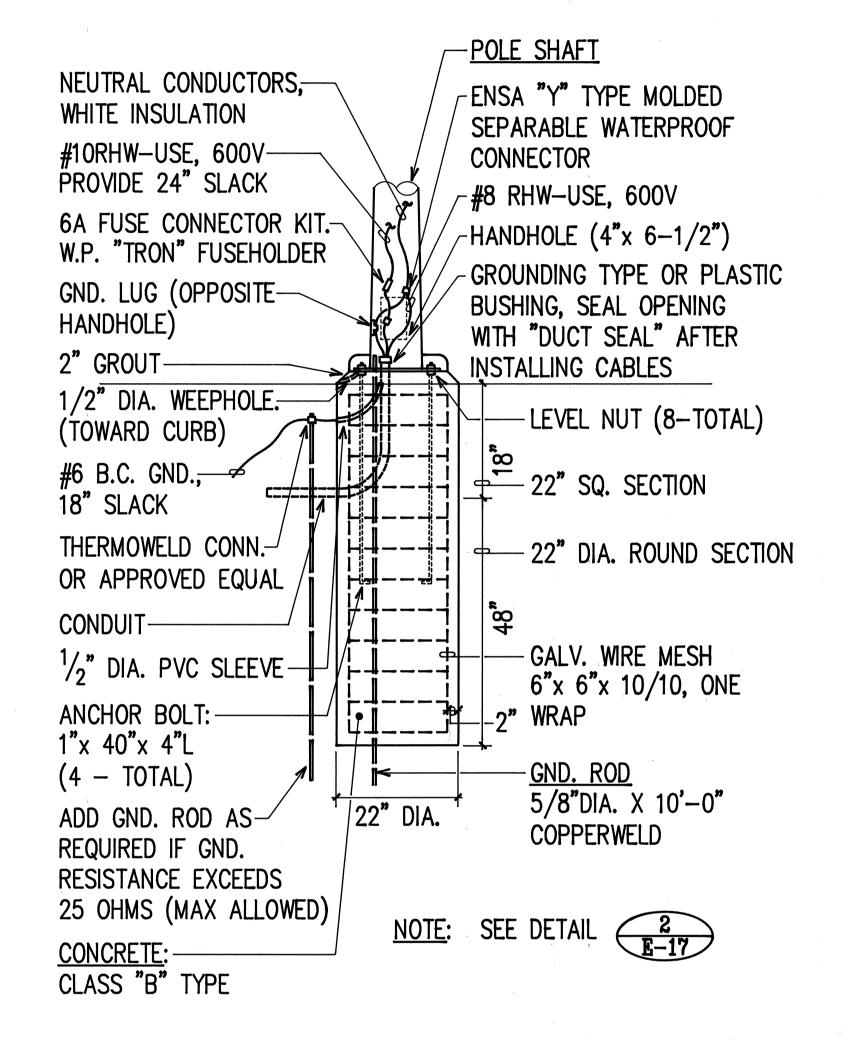

CONCRETE BASE ELEVATION
NOT TO SCALE

REVISION

DATE

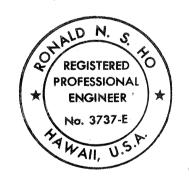

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DEPARTMENT OF TRANSPORTATION
HIGHWAYS DIVISION

STREET LIGHT DETAILS


INTERSTATE ROUTE H-1
PAIWA STREET INTERCHANGE
PROJECT NO. HIC-01-90


SCALE: AS NOTED
DATE: AUG., 1991

SHEET No. E- 17 OF 2 SHEETS

7

7/22

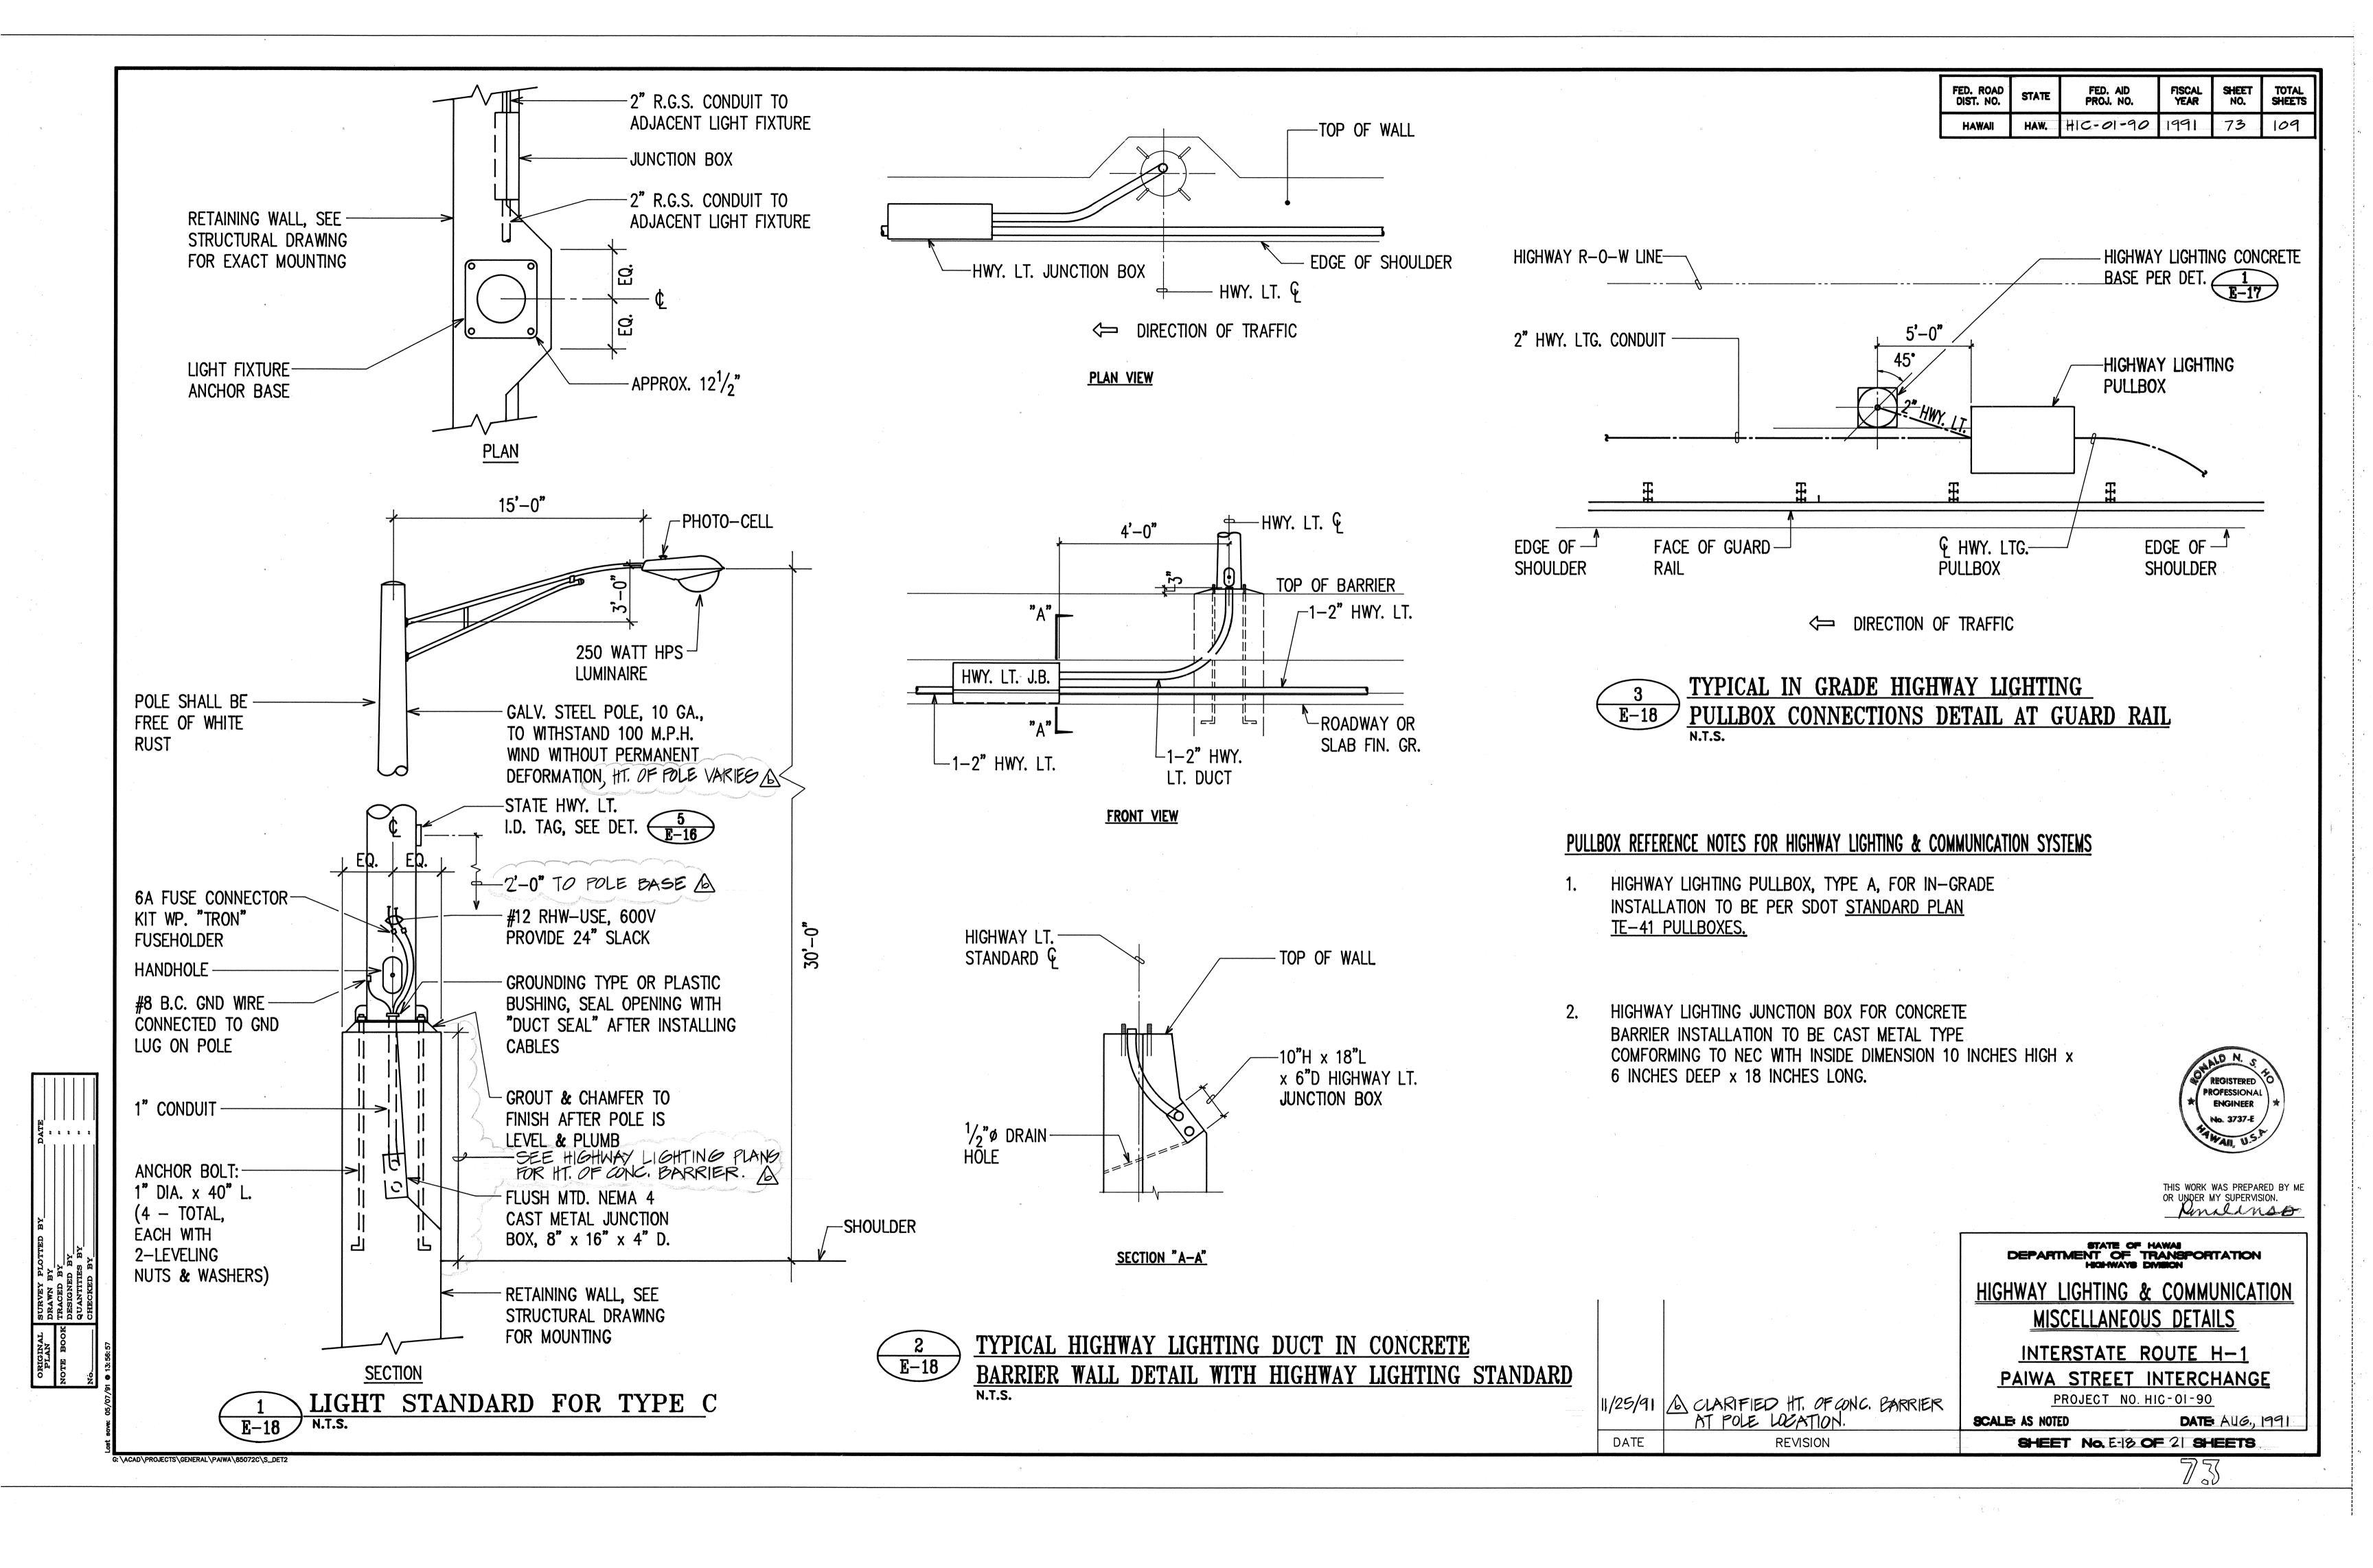

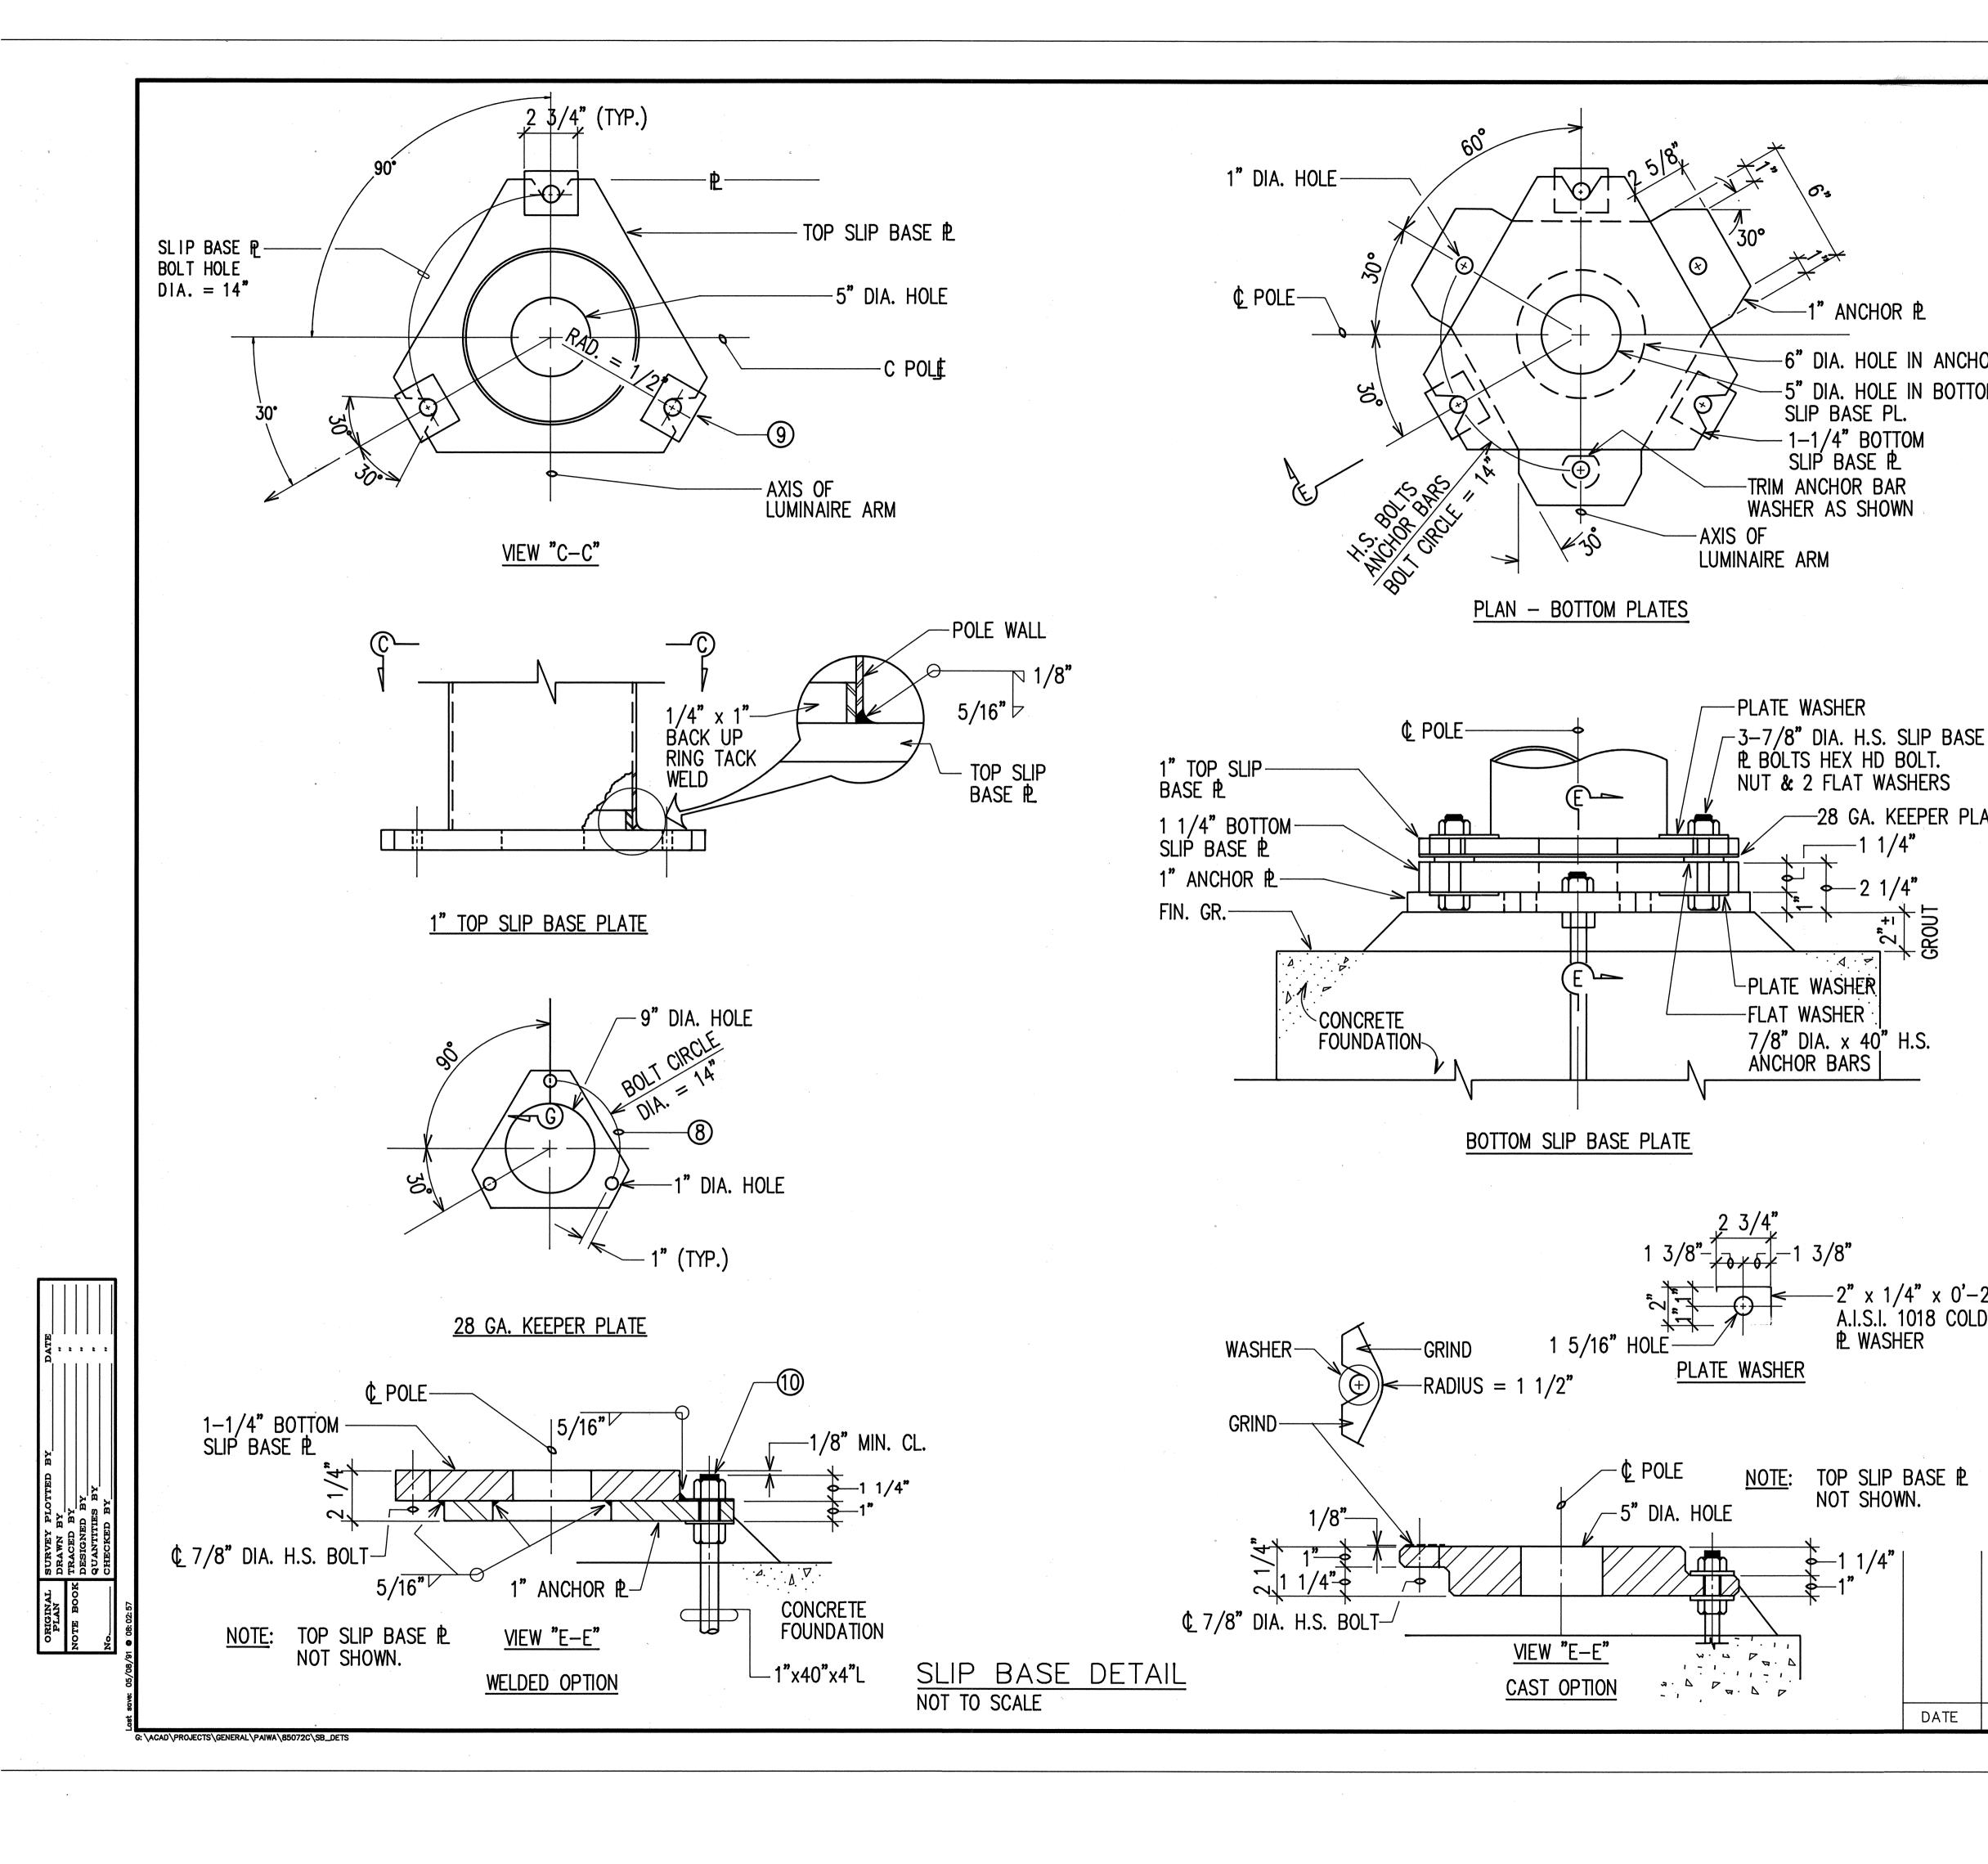

FED. ROAD DIST. NO. FISCAL YEAR SHEET NO. FED. AID PROJ. NO. TOTAL SHEETS STATE HIC-01-90

## NOTES:

1" ANCHOR PL

SLIP BASE PL.

1-1/4" BOTTOM SLIP BASE PL

6" DIA. HOLE IN ANCHOR PL

-28 GA. KEEPER PLATE

-2" x 1/4" x 0'-2 3/4" A.I.S.I. 1018 COLD DRAWN ₧ WASHER

DATE

TOP SLIP BASE LE NOT SHOWN.

5" DIA. HOLE IN BOTTOM

- (1) ALL STEEL SHAFTS, PLATES, MAST ARMS, BOLTS, SCREWS, NUTS & WASHERS TO BE GALVANIZED AFTER FABRICATION OR MODIFICATION.
- 2 PLATES TO CONFORM TO ASTM A-36.
- (3) CAST OPTION TO CONFORM TO ASTM A-486 CL. 90.
- 4 TORQUE 7/8" DIAMETER H.S. SLIP BASE PLATE BOLTS TO 84 FEET PER POUND.
- 5 7/8" DIAMETER H.S. ANCHOR BARS, WRENCH TIGHTEN TORQUE RÉQUIREMENT WAIVED.
- (6) FABRICATORS ELECTING LARGER THAN MINIMUM ARM DIAMETERS MUST ADJUST DETAILS AS REQUIRED TO PERMIT SOLID SEATING OF CAP SCREWS. IN LIEU OF TORQUE REQUIREMENTS FOR H.S. BOLTS, CAP SCREWS SHALL BE TIGHTENED BY THE TURN OF NUT METHOD 1/6 TURN FROM SNUG CONDITION. NO WASHER WILL BE REQUIRED.
- 7 4" x  $6\frac{1}{2}$ " HANDHOLE REINFORCED WITH #3 GAUGE RING  $\frac{1}{2}$ " WIDE WELDED TO OUTSIDE OF POLE COVER OF 10 GAUGE PLATE LOCATE 90 DEGREES OF MAST ARM UNLESS SHOWN OTHERWISE.
- 8 28 GAUGE KEEPER PLATE, PLACE ON TOP OF MIDDLE FLAT WASHER, ASTM A-526 125 COMMERCIAL.
- 9 PLATE WASHER.

REVISION

- 10 3 7/8" DIAMETER H.S. BARS, THREAD 6" & GALVANIZED 10", WITH HEX., HEAD, NUT, LEVELING NUT & WASHER.
- 11) HEX. HEAD NUT SHOWN OR AS AN ALTERNATE DETAIL ANCHOR PLATES MAY BE RETAINED WITH 5/16" FILLET WELDS ALL AROUND OR FORMED HEADS.
- 12 ROUND TAPERED STEEL TUBE WITH MAXIMUM TAPER OF 0.15"/FOOT.
- (13) NO. 11 GAUGE SHEET STEEL OF WELDABLE GRADE ACCEPTABLE IF STEEL AFTER FABRICATION HAS A MINIMUM YIELD STRENGTH OF 40,000 P.S.I.



THIS WORK WAS PREPARED BY ME OR UNDER MY SUPERVISION.

STATE OF HAWAII
DEPARTMENT OF TRANSPORTATION
HIGHWAYS DIVISION


HIGHWAY LIGHTING SLIP BASE DETAILS


INTERSTATE ROUTE H-1 PAIWA STREET INTERCHANGE PROJECT NO. HIC-01-90

SCALE: AS NOTED

DATE: AUG., 1991 SHEET No. E-19 OF 21 SHEETS

7 1/2

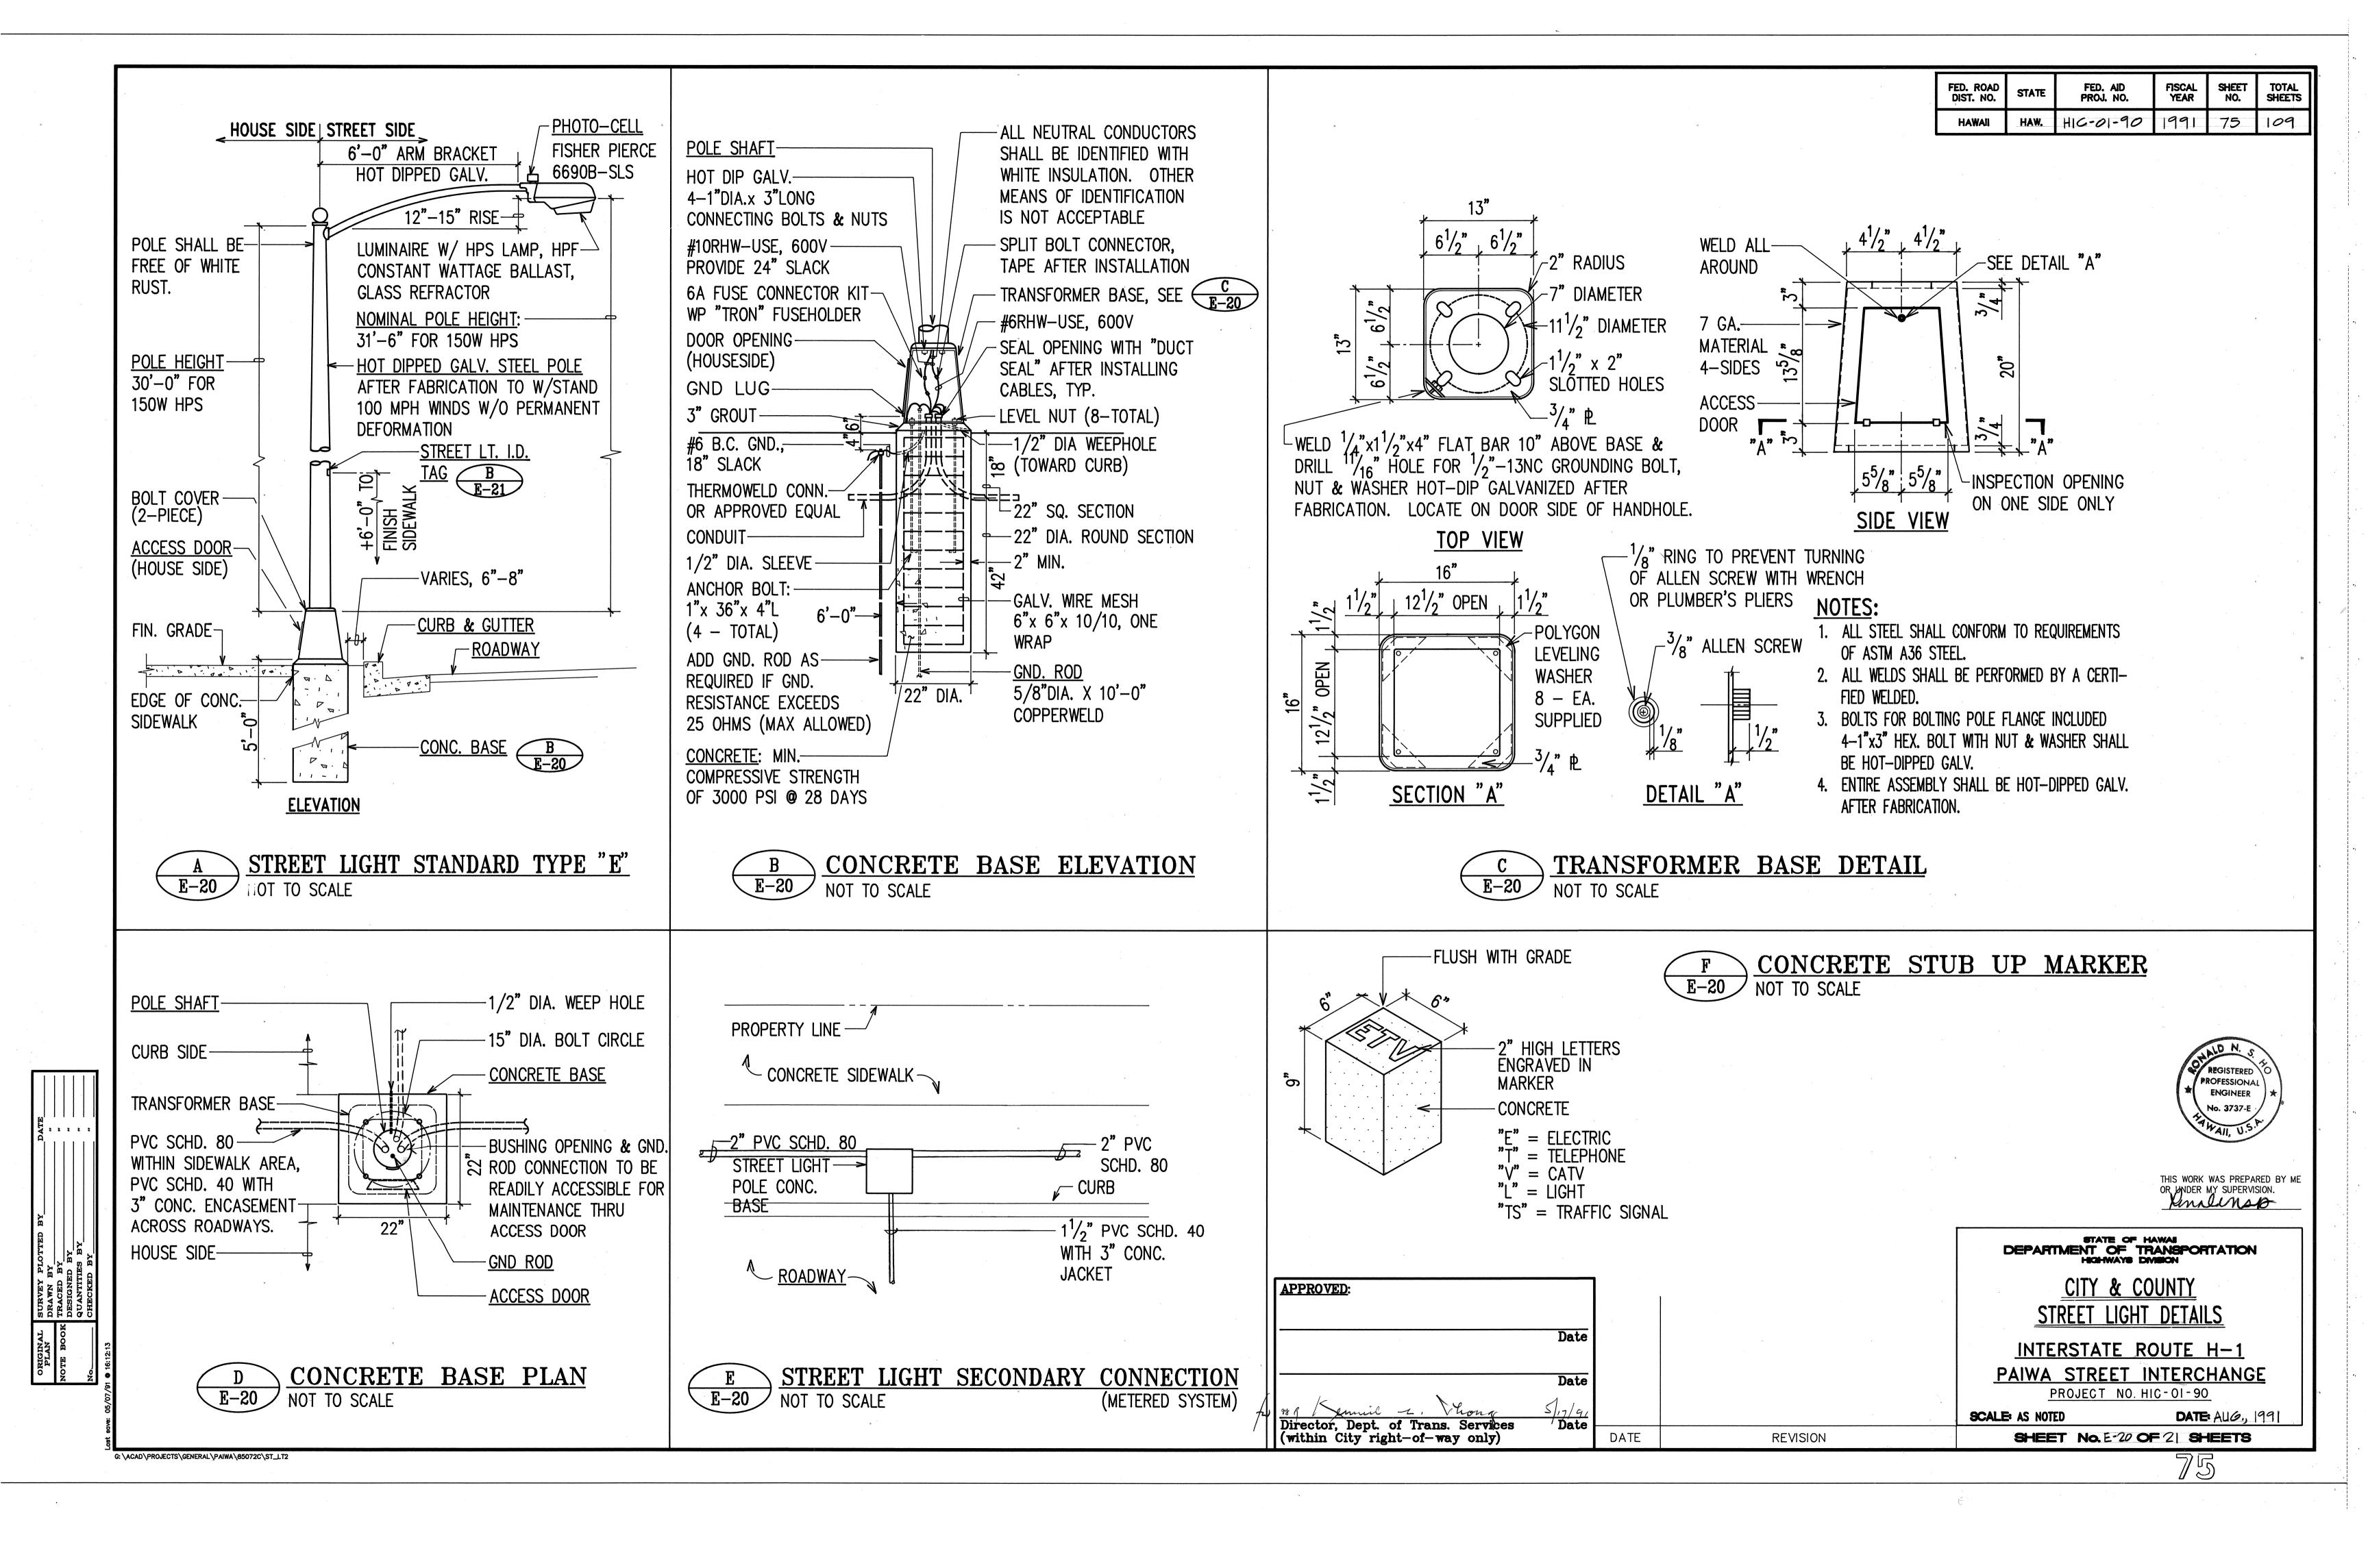

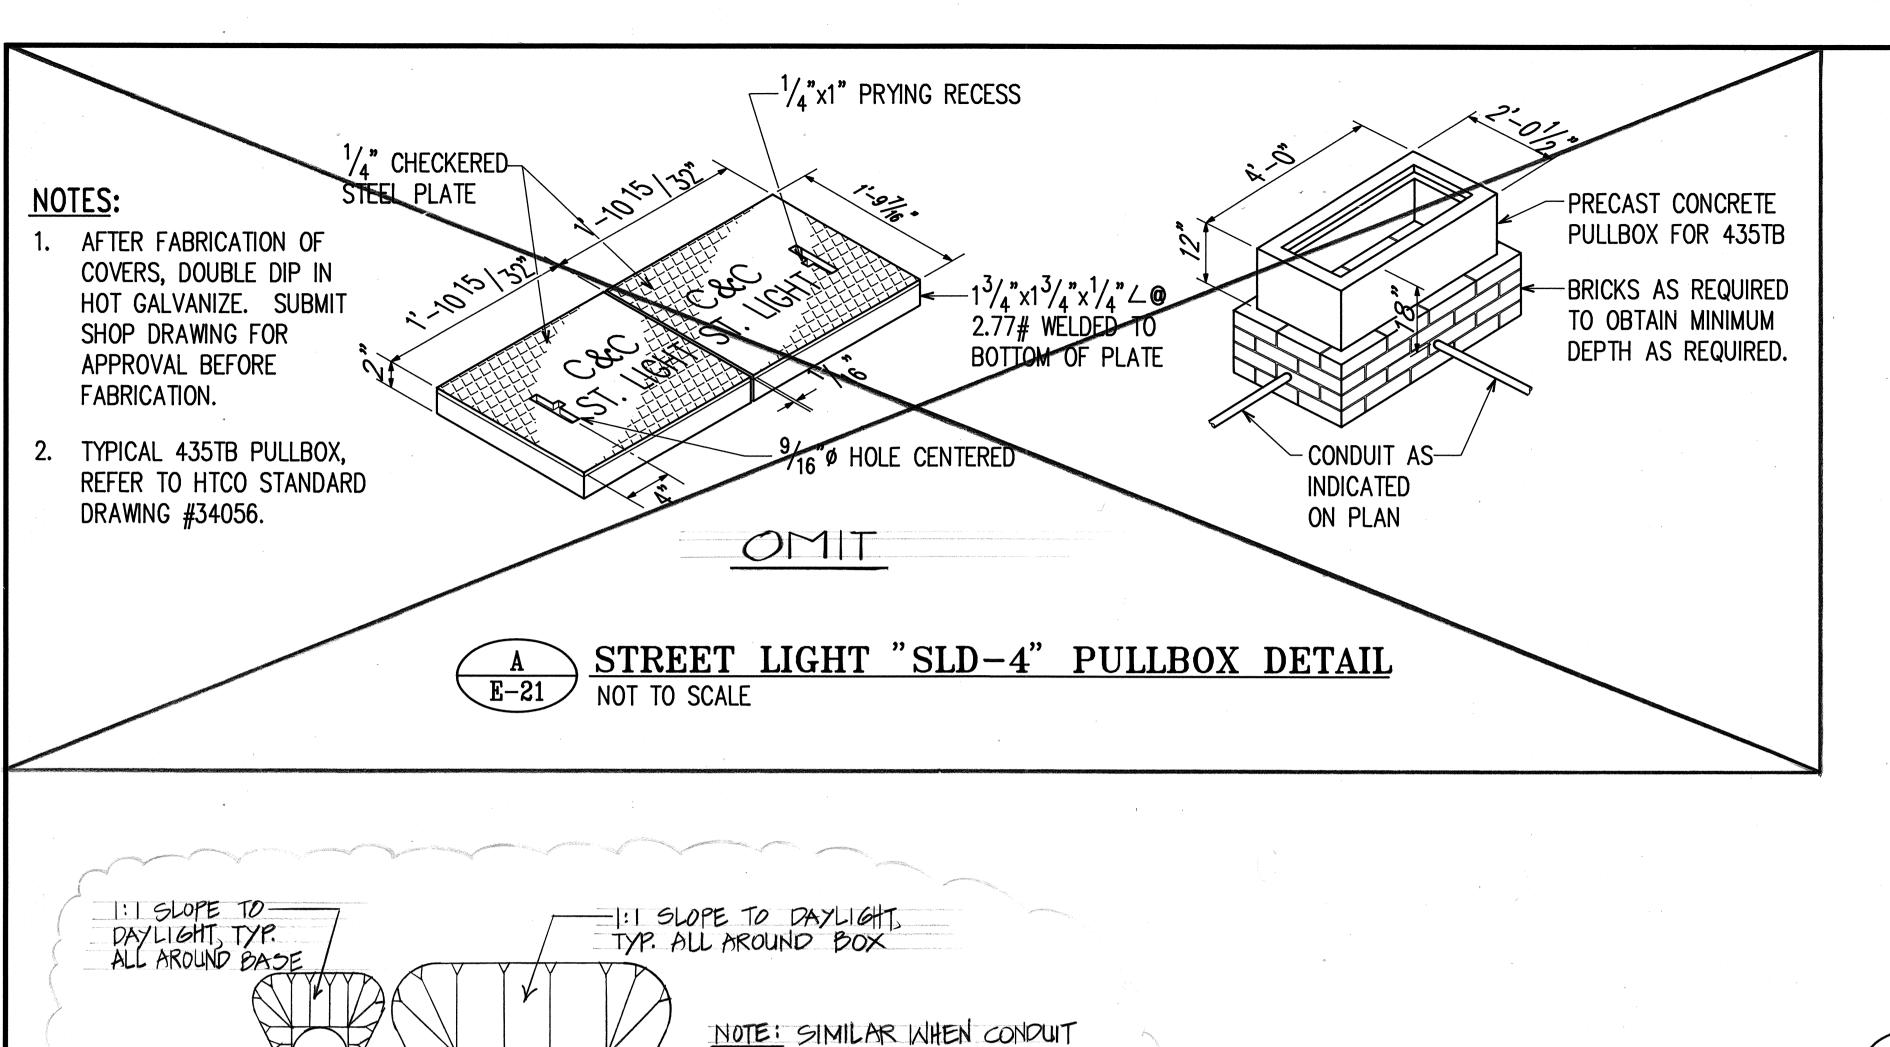

RUNS ABOVE HWY. LT.

-2:1 SLOPE

TYPICAL GRADING SECTION THRU HIGHWAY

LIGHT PULLBOX AT 2:1 SLOPE

HWY. LT. PULLBOX-

-1:1 SLOPE TO DAYLIGHT

-HMY, LT. PULLBOX

-HWY. LT. POLE BASE

-1:1 SLOPE TO DAYLIGHT

-HWY. LT. POLE BASE

TYPICAL GRADING PLAN AROUND HIGHWAY

LIGHT BASE AND PULLBOX AT 2:1 SLOPE

TYPICAL GRADING SECTION THRU HIGHWAY

LIGHT POLEBASE AT 2:1 SLOPE

2:15LOPE

-conduit (typ.)  $^{ackslash}$ 

G: \ACAD\PROJECTS\GENERAL\PAIWA\85072C\PBOXDE

METER NUMBER-CIRCUIT NUMBER LINE VOLTAGE-LIGHT NUMBER (FOR METERED-MULTIPLE SYSTEM)

# NOTES:

- 1. USE 2 PLY LAMINATED FLEXIBLE PLASTIC BLACK-WHITE. THICKNESS: BLACK CAP SHEET-0.010", WHITE BASE SHEET-0.052".
- 2. NUMBER SIZE SHALL BE 1" HIGH AND ENGRAVED 1/8" WIDE, WHITE IN COLOR (NUMBER AS REQUIRED).
- 3. NOMENCLATURE SIZE SHALL BE 1/4" HIGH AND ENGRAVED 1/32" WIDE, WHITE IN COLOR (METER NUMBER, CIRCUIT NUMBER AND VOLTAGE AS REQUIRED).
- 4. ATTACH TO ALUMINUM AND STEEL POLES WITH NO. 8 STAINLESS STEEL, 1/2" LONG DRIVE SCREWS IN 1/8" DRILL
- 5. NUMBERS ARE INSCRIBED BY CUTTING THROUGH "BLACK CAP SHEET" TO EXPOSE "WHITE LETTERS".
- 6. ASSIGN CIRCUIT NUMBER FOR SYSTEMS WITH TWO OR MORE CIRCUITS (LETTER INDICATES PANEL BOARD, NUMBER INDICATES CIRCUIT).

STREET LIGHT I.D. TAG DETAIL METERED SYSTEM NOT TO SCALE

> PROFESSIONA ENGINEER

STATE OF HAWAII
DEPARTMENT OF TRANSPORTATION
HIGHWAYS DIVISION CITY & COUNTY **PULLBOX DETAILS** 

INTERSTATE ROUTE H-1 PAIWA STREET INTERCHANGE

PROJECT NO. HIC-01-90 SCALE: AS NOTED

FED. ROAD DIST. NO.

STATE

FED. AID PROJ. NO.

HIC-01-90

FISCAL YEAR


1991


SHEET NO.

76

TOTAL SHEETS

DATE: AUG., 1991 SHEET No. E-2| OF 2| SHEETS

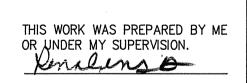

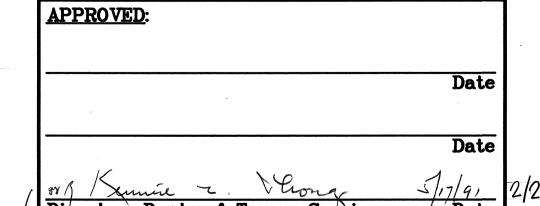

DATE

Director, Dept. of Trans. Services (within City right-of-way only)

ADDED GRADING DETAILS AROUND POLE BASE & PULLBOX AT 2:1 SLOPE REVISION