00 Sta. 0+35.04± 1-6"/a" Rend (Bell & Spigot) NAKUINA STREET New 6" Ductile Iron Pipe, Class 52 VExisting Concrete Jacket Existing 6" Water J New Conc. Jacket STA. O+OI± STA, 0+36.54 ± Connect to Existing 6" Water 1-6" 1/8 Bend (Horiz.) Connect to Existing 6" Water 1-6" 1/8 Bend (Horiz.) 1-Conc. Reaction Block w/Struc. Strut STA.0+21.00+ 1-Conc. Reaction Block 1-6" 5/ceve, 12" Long 1-6" 18 Bend W/Struc. Strut & Strap 8 Lin Ft.- 6" Ductile Iron Pipe, Class 52 (Bottom Vert.) 8-6" Sleeve, 12" Long 8 Lin Ft. 6" Ductile Iron Pipe, Class 32 TEMPORARY FOR TESTING 1-6" Cap with 21/2" Cleanout 1- Concrete Block STA.0+08.07± 1-6" 1/8 Bend (Horiz.) 5TA. 0+29.47± STA. 0+11.07± 1-6" 1/8 Bend (Horiz.) 1-6" 1/8 Bend (Top Vert.) TEMPORARY FOR TESTING 1-6" Cap with 2/2" cleanout PLAN-NEW 6" WATER 1- Concrete Black \$ 5TA. 41+60 ± SCALE: 1"=10' New Concrete Jacket Existing Invert New 6" Water 8" Sower -Dowel out with 4-5/8" self drilling anchors -Guard Rail with 12" long threaded Type 4EF Existing Concrete Jacket Invert Existing 6" Water Existing 30" Drain 0+00 1+00

PROFILE-NEW 6" WATER

VERT: 1" = 5

₽ 5TA. 41+60 ±

SCALE: HORIZ .: 1"=10'

FED. ROAD
DIST. NO.STATEFED. AID
PROJ. NO.FISCAL
YEARSHEET
NO.TOTAL
SHEETSHAWAIIHAW.1-H1-1(187)198418197

GENERAL WATER NOTES

- Unless otherwise specified, all materials and construction of water system facilities and appurtenances shall be in accordance with the STANDARD SPECIFICATIONS FOR ROAD AND BRIDGE CONSTRUCTION, dated 1976, as amended, of the Hawaii Highways Division, Department of Transportation.
- 2. The BWS Standard Details, Figures 1 to 62 inclusive, bound in the "Water System Standards" of the BWS, dated March 1977, as amended, are applicable to this Project.
- 3. The Contractor shall notify the Board of Water Supply in writing one week prior to commencing work on the Water System.
- 4. The existence and location of underground utilities and structures as shown on the plans are from the latest available data but is not guaranteed as to the accuracy or the encountering of other obstacles during the course of the work. The Contractor shall be responsible and shall pay for all damages to existing utilities.
- 5. Any adjustments to the existing water system required during construction to meet requirements of BWS Standards, whether shown on the plans or not, shall be done by the Contractor at no cost to the Board.
- 6. Unless otherwise specified, connections to existing water mains and chlorination of new water mains shall be done by the Contractor, with the BWS Inspector coordinating the work. For details, contact BWS Planning and Engineering Division, Engineering Branch, Construction Section.
- 7. All east iron (gray or ductile) pipes, fittings, and valves shall be enclosed in plastic material in accordance with AWWA Specifications C105-72 "Polyethylene Encasement for Gray and Ductile Cast Iron Piping for Water and other Liquids."

APPROVED:

CHIEF, PLANNING & ENGINEERING, BWS

- 8. Prior to excavating for new drain, sewer and other utility lines, the Contractor shall verify in the field the location of existing water mains and appurtenances. Where the installation of new drain, sewer or other utility lines are to cross over or under existing water mains, the Contractor shall expose the existing water mains prior to trenching. Excavation around water mains shall be done by hand.
- 9. In the event that water mains other than Ductile Iron is to be used, the plans shall be resubmitted for approval.
- 10. Reapproval shall be required if this project is not under construction within a period of one year. (See Rules and Regulations of the Board of Water Supply)
- 11. Contractor shall furnish and install additional fittings if necessary to meet field conditions.
- 12. The Contractor shall notify the Board of Water Supply Field Operation Division for toning services to locate the water mains in the following locations prior to commencing any work.
 - 1.) \$5 to 17+35±, 24~inch Water Main 2.) \$5 to 37+00± 36-inch Water Main
- 3.) \$\mathbb{E}\tan.41+60\pm\$ 6~inch Water Main
 The Contractor shall not operate any heavy
 equipment over these pipes when the cover
 over these pipes are less than three feet.
 During excavation and subgrade work and
 during laying and compaction of the Base
 Materials every precaution shall be taken
 to prevent any heavy equipment from being
 operated over these pipes.
- 13. Anchors installed on existing concrete jacket will not be measured for payment but shall be considered incidental to Class B Concrete for Water System.

DEPARTMENT OF TRANSPORTATION
HIGHWAYS DIVISION

WATER UTILITY PLAN

INTERSTATE ROUTE HI IMPROVEMENTS MIDDLE STREET TO KALIHI INTERCHANGE


STATE OF HAWAII

EA.I. PROJ. NO.I-HI-I(187)

SCALE: As Shown

SHEET NO. / OF / SHEETS

8

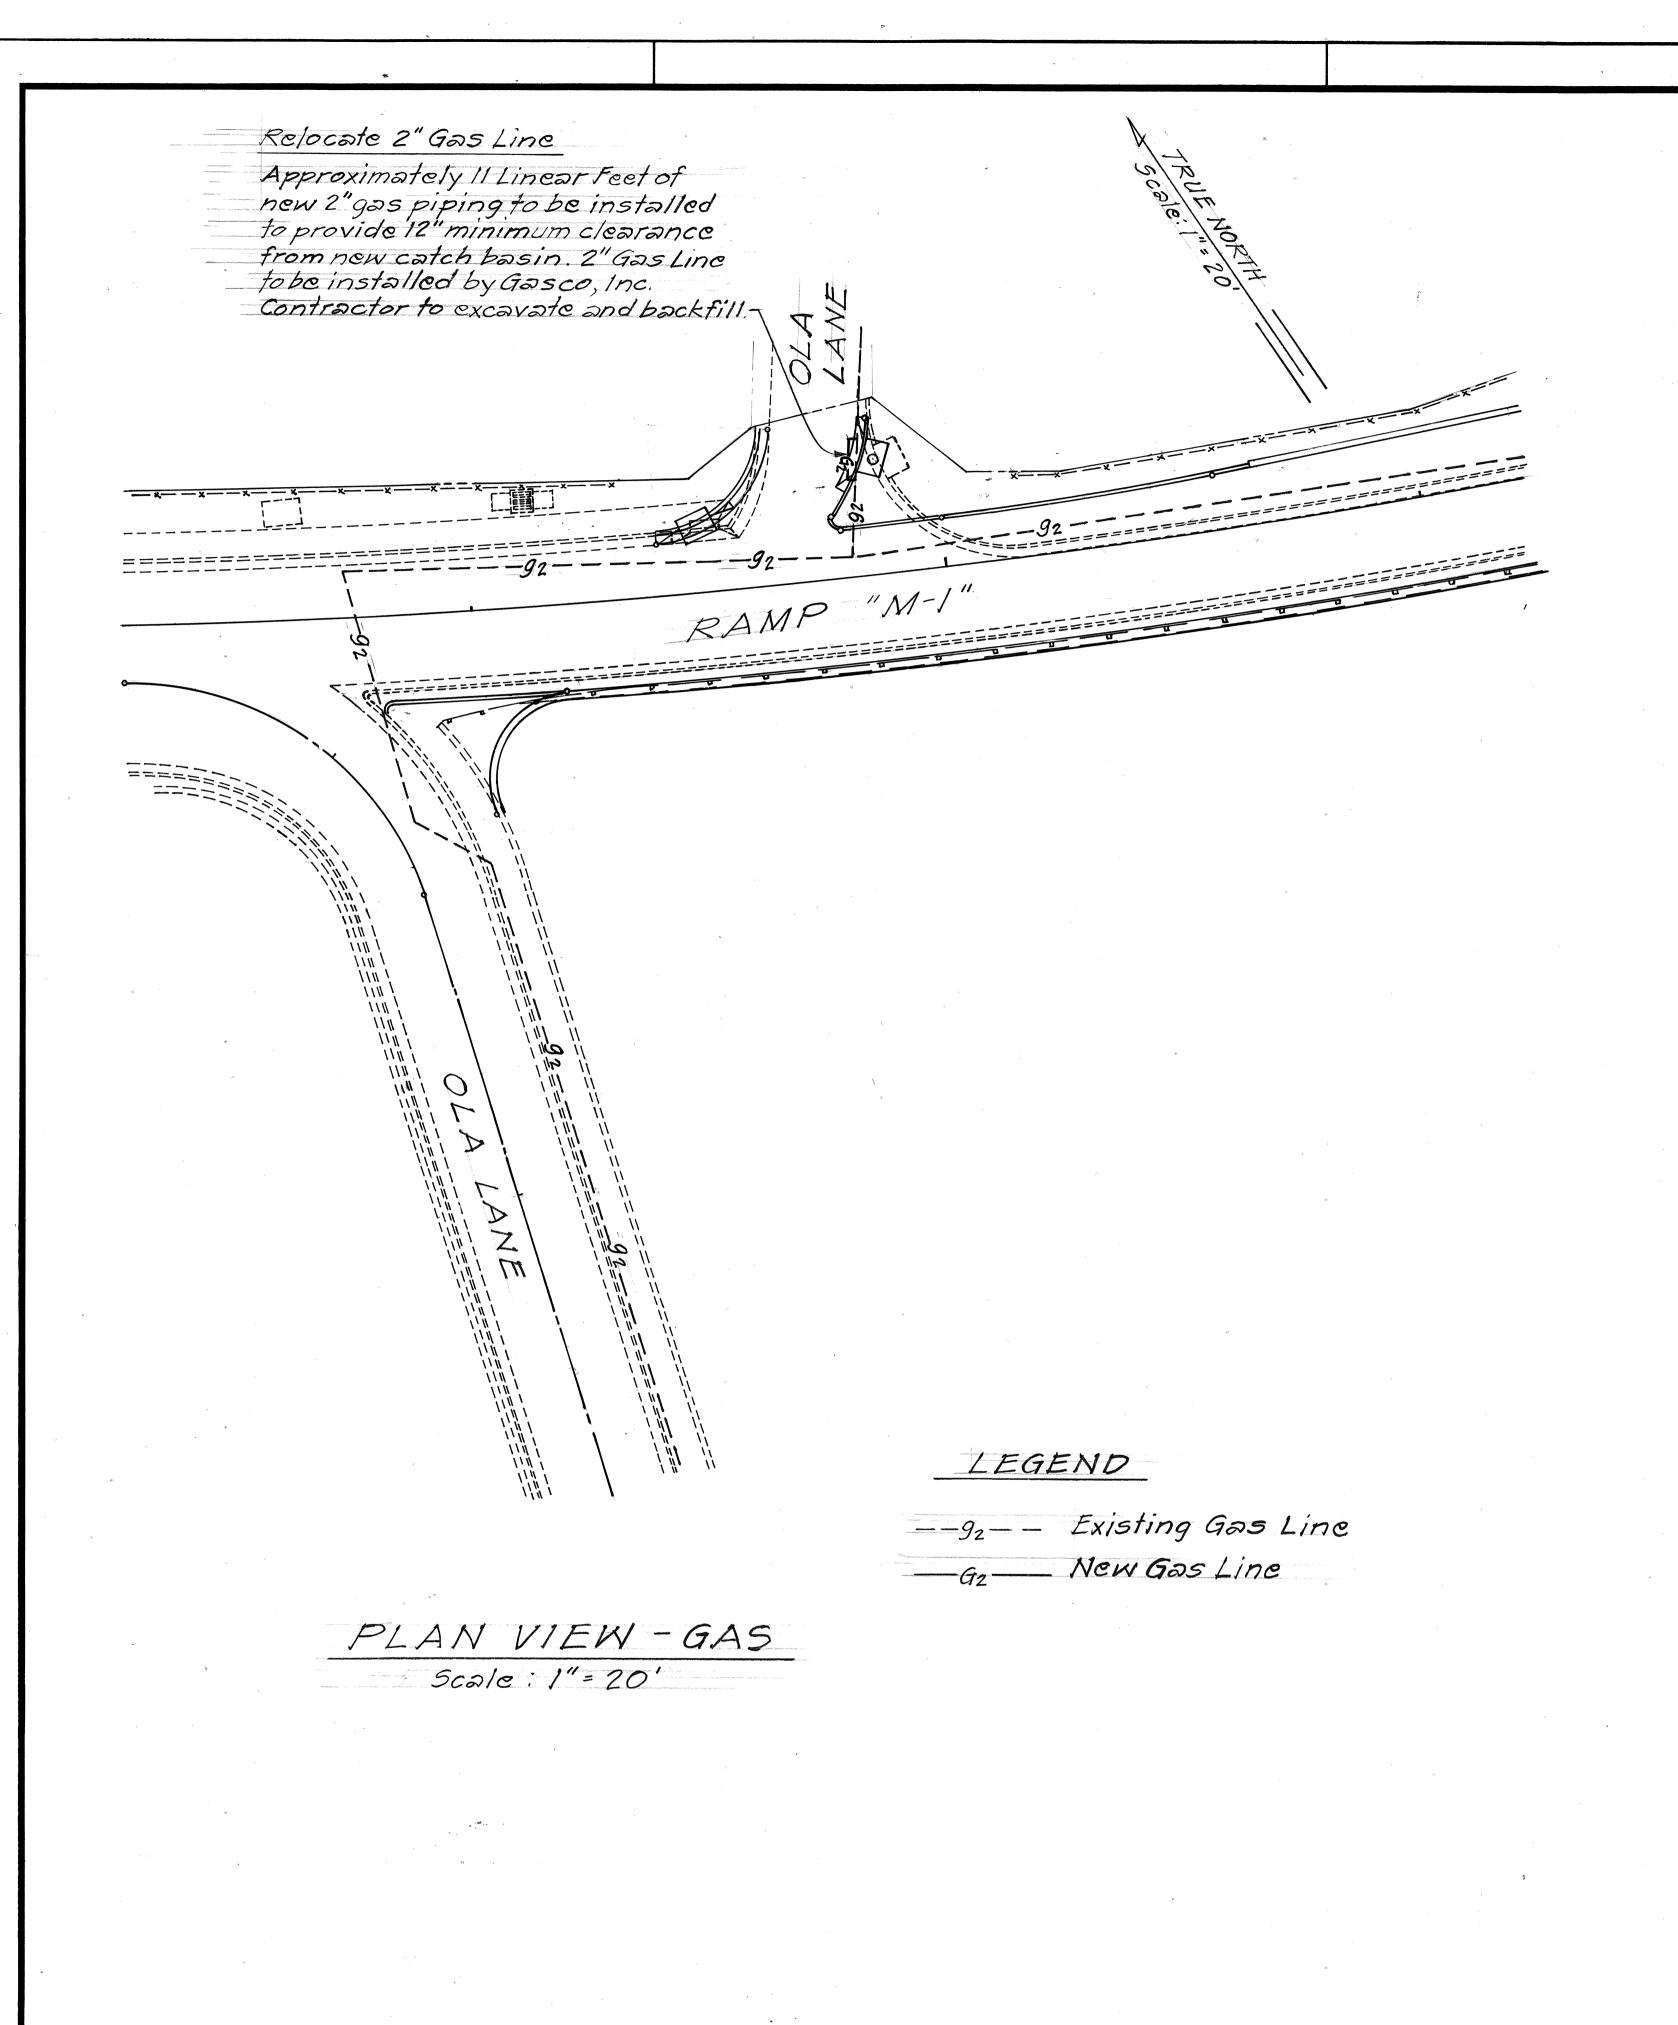

FED. ROAD
DIST. NO.STATEFED. AID
PROJ. NO.FISCAL
YEARSHEET
NO.TOTAL
SHEETSHAWAIIHAW.1-H1-1 (187)198419197

GAS NOTES

- 1. The Gasco, Inc. gas pipe lines in the project area are plastic coated and cathodically protected. The Contractor shall be extremely careful when working near gas pipe lines.
- 2. Prior written clearance must be obtained from Gasco, Inc. at least five(5) working days before starting excavation near these gas lines.

 Since gas line locations on field maps are approximate, the Contractor, after obtaining a written clearance, shall call Gasco, Inc., a minimum of 48 hours before starting excavation to arrange for field location of existing gas lines. The telephone number is 547-3575 during business hours, and 526-0066 after hours.

The Contractor shall excavate and backfill around gas pipe lines in the presence of a Gasco, Inc. representative. All backfill within six inches of gas pipe line shall be select cushion material approved by Gasco, Inc.

- 3. For relocation of any gas pipe line, the Contractor shall notify Gasco, Inc. five (5) working days before starting work. The Contractor shall provide the necessary excavation and backfill, arrange for traffic permits and restore sidewalk pavement or other facilities. Any relocation of gas facilities shall be done by Gasco, Inc.
- 4. The Contractor shall notify Gasco, Inc. immediately after any damage has been caused to existing gas pipelines, their coatings or their cathodic protection devices. Repair work on this damage shall be done by Gasco, Inc. with payment for this work to be borne by the Contractor.
- 5. Minimum vertical or horizontal clearance between gas pipe lines and other pipelines, conduits, or ductlines shall be 12 inches. Adequate support and protection for gas pipe lines exposed in the trench shall be provided. Such support and protection shall be approved by Gasco, Inc.
- 6. The Contractor shall work in an expeditious manner in order to keep uncovered gas pipe lines exposed for as short a period of time as possible.
- 7. Any excavation and backfill required for the relocation of the 2" gas pipe line at Ola Lane will not be measured and paid for but shall be considered incidental to the new catch basin.

APPROVED:

GASCO, INC.

08 17 83 DATE STATE OF HAWAII
DEPARTMENT OF TRANSPORTATION
LAND TRANSPORTATION FACILITIES DIVISION

UTILITY - GASCO, INC.

INTERSTATE ROUTE HIIMPROVEMENTS MIDDLE STREET TO KALIHI INTERCHANGE

<u>WESTBOUND LANES</u> F.A.I. PROJ. NO.I-H1-1(187)

Scale: As Shown Date: August, 1983

SHEET No. / OF / SHEETS