


LAYOUT PLAN

LIST OF ABBREVIATIONS

ASSY.	ASSEMBLY	I.E.S.	ILLUMINATING ENGG. SOCIETY
BKT.	BRACKET ARM	J.B.	JUNCTION BOX
C	RACEWAY (TYPE & SIZE AS INDICATED)	K	
CAD	CEMENT ASBESTOS DUCT	LT.	LIGHT
CKT.	CIRCUIT	LTG.	LIGHTING
CONC.	CONCRETE	MT./MTD./MTG.	MOUNT / MOUNTED / MOUNTING
D		N.I.C.	NOT IN CONTRACT
EXST.	EXISTING	N.M.R.	NON METALLIC RACEWAY
E.T.W.	EDGE OF TRAVELED WAY	N.T.S.	NOT TO SCALE
FIXT.	Fixture	O	
FDR.	FEEDER (OR BRANCH THEREOF)	PVC	POLYVINYLCHLORIDE CONDUIT
FLUOR.	FLUORESCENT	Q	RECEPTACLE
FND.	FOUNDATION	RCPT.	RIGID GALV. STL. CONDUIT
FUT.	FUTURE	S/B	SLIP BASE
GRD.	GROUND	STL.	STEEL
HG	MERCURY VAPOR LAMP	SW.	SWITCH
H.P.S.	HIGH PRESSURE SODIUM LAMP	SCHD.	SCHEDULE
H.WY.	HIGHWAY	STD.	STANDARD
HT.	HEIGHT	TRANS.	TRANSFORMER

ORIGINAL SURVEY FLUTED BY	DATE
PLAN DRAWN BY	RECORDED BY
NOTE BOOK	QUADRANGLES BY
No.	CHECKED BY

DD-6-4

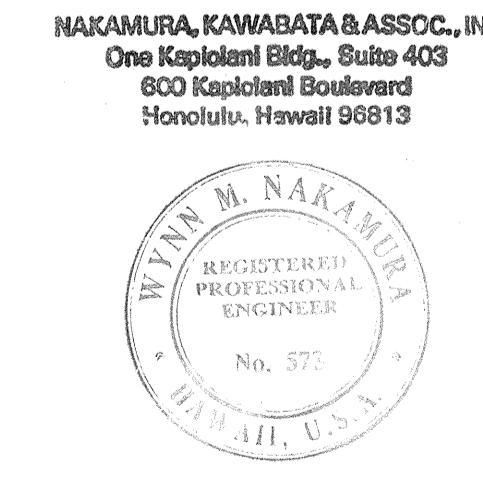

Yann Nakamura

ELECTRICAL SYMBOLS

EXST.	NEW	
•—○	HWY. LT. ASSY. w/ 250 HPS (30,000 LUMENS) I.E.S. M-N-III	
○—○	NO CHANGE UNLESS NOTED OTHERWISE	
○—○	REMOVE ASSEMBLY & FOUNDATION	
□—○	MTD. ON CONC. RETAINING WALL	
	TH TIME SWITCH	
	REPLACE FIXTURE WITH 150 W HPS OR AS INDICATED ON WOOD POLE.	
■—○	REPLACE FIXT. w/ 150 HPS ON EXST. WOOD POLE.	
■—○	HWY. SIGN w/ MERCURY VAPOR UNITS	
■—○	HWY. SIGN, REPLACE LTG. AS NOTED.	
*—e—	DIRECT BURIED CABLES TO BE ABANDONED	
—e—	SERIES CKT 1/6 CABLE	
—e—	PVC SCH'D. 40 OR ABS CONDUIT	
—e—	CONC. ENCASED 2" CONDUIT OR W/ IN CONC. STRUCTURE	
1	1. POLE NUMBER	
2	2. CIRCUIT ASSIGNMENT NUMBER	
3	INDICATOR	3. LETTERS, SEE REFERENCE
4		4. POLE HT. FROM BASE TO ARM BRACKET.
5		5,6 #7, SEE REFERENCES
6		
7		
W	INDICATES POLE TO BE MTD. ON CONC. WALL, DET.	
BW	POLE TO BE MTD. ON GR. BACK OF CONC. WALL	
T	TRANS. BASE	
R	REPLACE HWY. LT. ASSY.	
S/B	SLIP BASE	
P	HWY. LT. ASSY. MTD. ON CONC. BARRIER	
H250	WATTAGE, 250W HPS III	
N/C	NO CHANGES FOR POLE ASSY.	
C	TRUSS ARM BRACKET, LENGTH AS NOTED	
PL/A	HWY. LT. INSTALLATION	
MSII	MEDIUM, SEMI-CUTOFF, TYPE II	
	IES DISTRIBUTION	
□	HANDHOLE, STATE HWY. DIV. TYP. TYPE "A"	
□	PULLBOX, STATE HWY. DIV., 2'x3', D.T. 510, SH. 24L	
□	PHOTO ELEC. SN. W/ RCPT. STATE HWY. DIV. STD.	
□	MERCURY VAPOR BALLAST IN NEMA-3R ENCL.	
—e—	CONDUIT CONN. BETWEEN NEW & EXST.	
□	HANDHOLE, STATE HWY. DIV. TYP. TYPE "C", NOTE #4	
—eo—	OVERHEAD SERIES CKT.	
—em—	OVERHEAD MULTIPLE CKT.	
—em—	MULTIPLE CKT. IN CONDUIT	
---	EXPOSED CONDUIT	
M-N-IV	INDICATES FIXTURE w/ I.E.S. MED. NON-CUTOFF IV	
M-S-II	INDICATES FIXTURE w/ I.E.S. MED. SEMI-CUTOFF II	
Ⓐ	DUCT SECT. A, SEE SH. 22L	
—eo	REMOVE OVERHEAD SERIES CKT.	
—OH—	MULTIPLE CKT. 4# DRINJ w/ MESSENGER	

FED. ROAD DIST. NO.	STATE	FED. AID PROJ. NO.	FISCAL YEAR	SHEET NO.	TOTAL SHEETS
HAWAII	HAW.	I - HI-I(178)	1982	92	165

GENERAL NOTES

- FOR GROUNDING SYSTEM, PROVIDE 1#6 TH GREEN BOND AMONG ALL LTG. STDS, PULLBOX, GRD. RODS, JUNCTION BOXES & METAL RACEWAYS.
- FOR BARRIER TYPES, SEE STRUCTURAL DWGS. & PROVIDE 3-FOOT SECTION FOR MTG. OF POLES. ALSO PROVIDE #6 TIE BARS BETWEEN 3-FOOT SECTION & ADJACENT WALLS PER STRUCTURAL DWGS.
- PROVIDE AN EXPANSION DEFLECTION FITTING IN ALL RACEWAY AT BRIDGE STRUCTURE EXPANSION JOINTS.
- ALL PULLBOXES TO BE OUTBOARD FROM CURBS, GUARD RAILS & RETAINING WALLS, UNLESS OTHERWISE NOTED.
- DAMAGED HWY. LTG. SYSTEMS PARTS, HARDWARE & COMPONENTS SHALL BE REPLACED w/ NEW ITEMS AT NO COST TO THE STATE.
- STUB OUT: 2" PVC, 5 FT. LONG, TERMINATE w/ DICT SEAL & BUSHING.
- WHERE EXST. CABLE BECOMES EXPOSED DUE TO NEW GRADES, PROVIDE SLIP DUCTS w/ 3" CONC. JACKET 24" DEEP, & WILL BE CONSIDERED INCIDENTAL TO THE CONTRACT. AT NO TIME SHALL NEW OR EXPOSED CABLES BE DIRECT BURIED.
- IF DIRECT BURIAL SPLICE MUST BE MADE, PROVIDE CONC. MARKER WHICH SHALL BE CONSIDERED INCIDENTAL TO THE CONTRACT.
- PROVIDE INTERIM LTG. FOR HWY. RAMPS, SIGNS, STRUCTURES (TUNNELS) DURING CONSTRUCTION & WORK WILL BE CONSIDERED INCIDENTAL TO THE CONTRACT.

STATE OF HAWAII DEPARTMENT OF TRANSPORTATION LAND TRANSPORTATION FACILITIES DIVISION HIGHWAY LIGHTING SYMBOLS


INTERSTATE H-1 IMPROVEMENTS
MIDDLE STREET TO KALIHI INTERCHANGE
EASTBOUND LANES
F.A.I. PROJECT NO. I - HI-I(178)

SHEET NO. 1L OF SHEETS


FED. ROAD DIST. NO.	STATE	FED. AID PROJ. NO.	FISCAL YEAR	SHEET NO.	TOTAL SHEETS
HAWAII	HAW.	I - HI-I(178)	1982	73	165

SYMBOLS



- EXST. LUMINAIRE, TO REMAIN
- ← EXST. ILLUM. SIGN, TO REMAIN
- (K) INDICATOR FOR RAMP ASSIGNMENT
- X REMOVE POLE ASSY.
- REPLACE EXST. FIXTURES w/ HPS & CONNECT TO MULTIPLE CKT.
- ☒ REPLACE ILLUM. SIGN FLUOR. w/ MERCURY VAPOR FIXTURES & CONNECT TO MULTIPLE CKT.
- * DIRECT BURIED CABLES TO BE ABANDONED

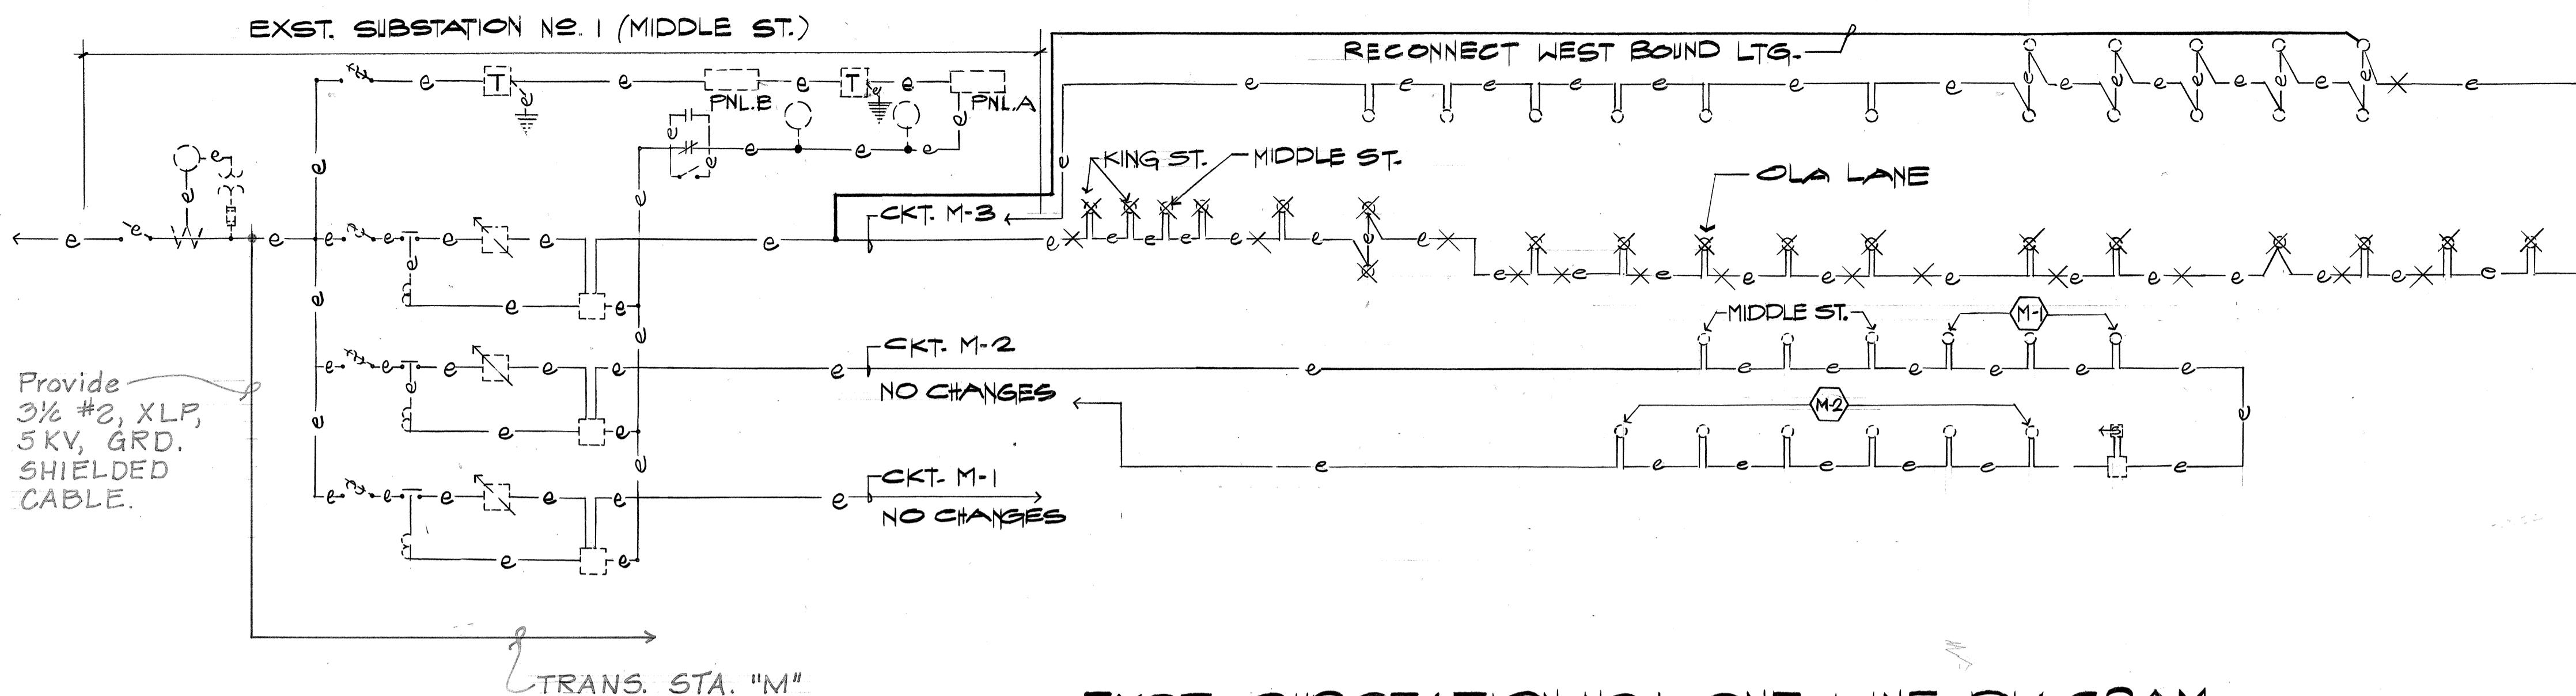

EXST. SUBSTATION NO. 1 ONE-LINE DIAGRAM

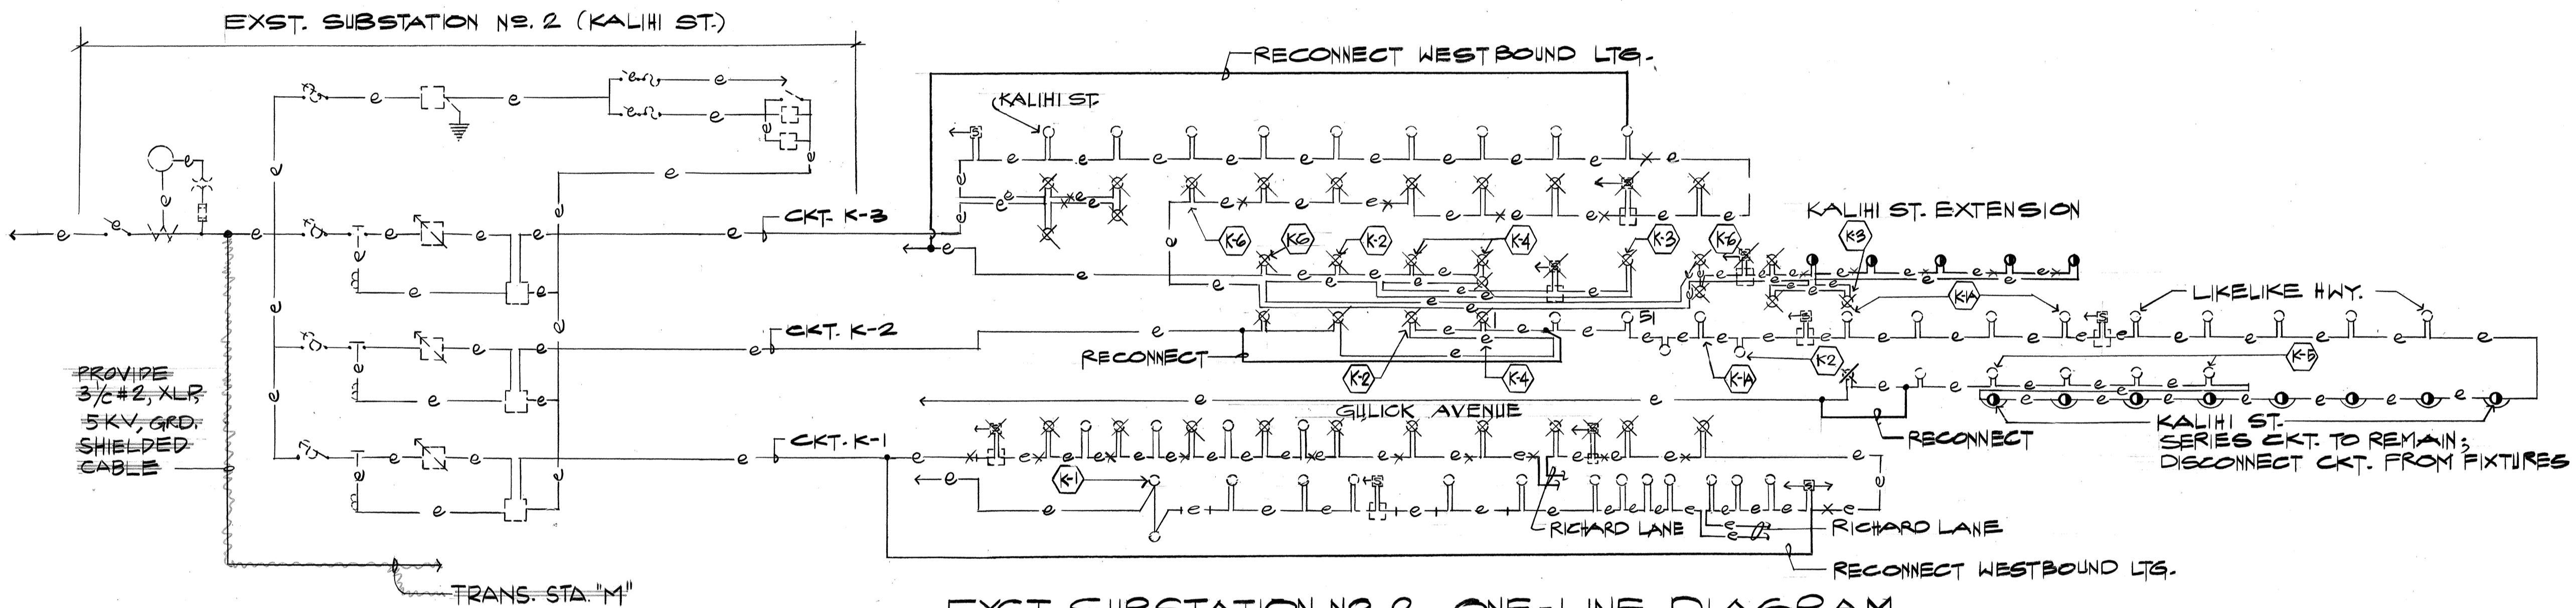

EXST. SUBSTATION NO. 2 ONE-LINE DIAGRAM

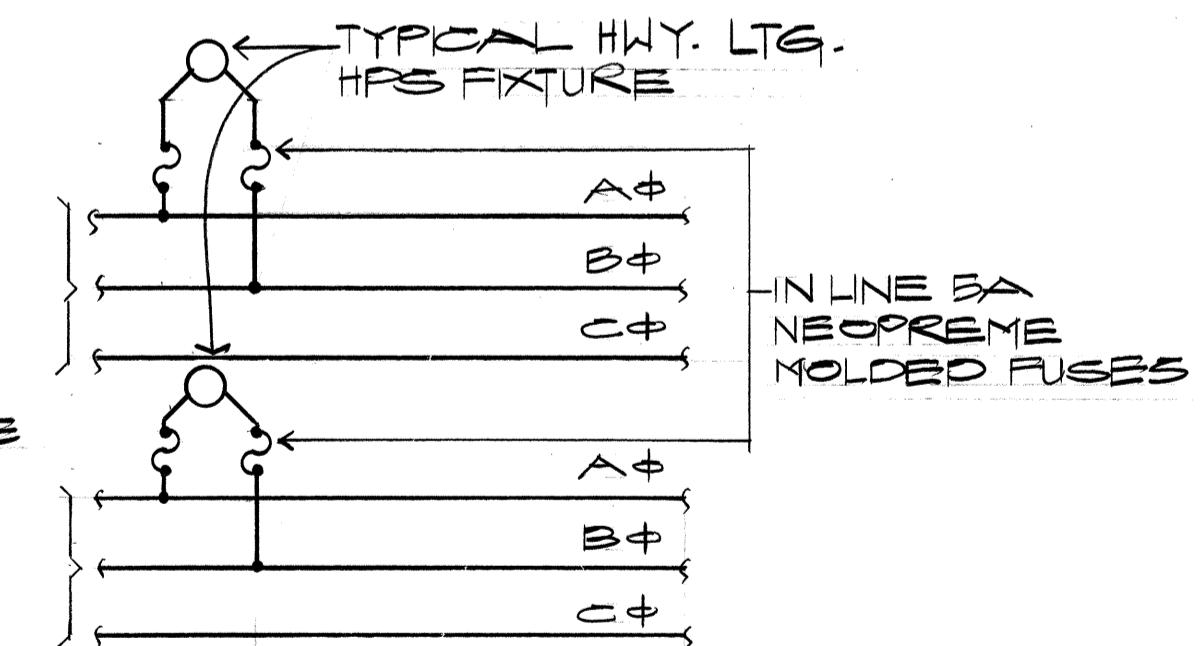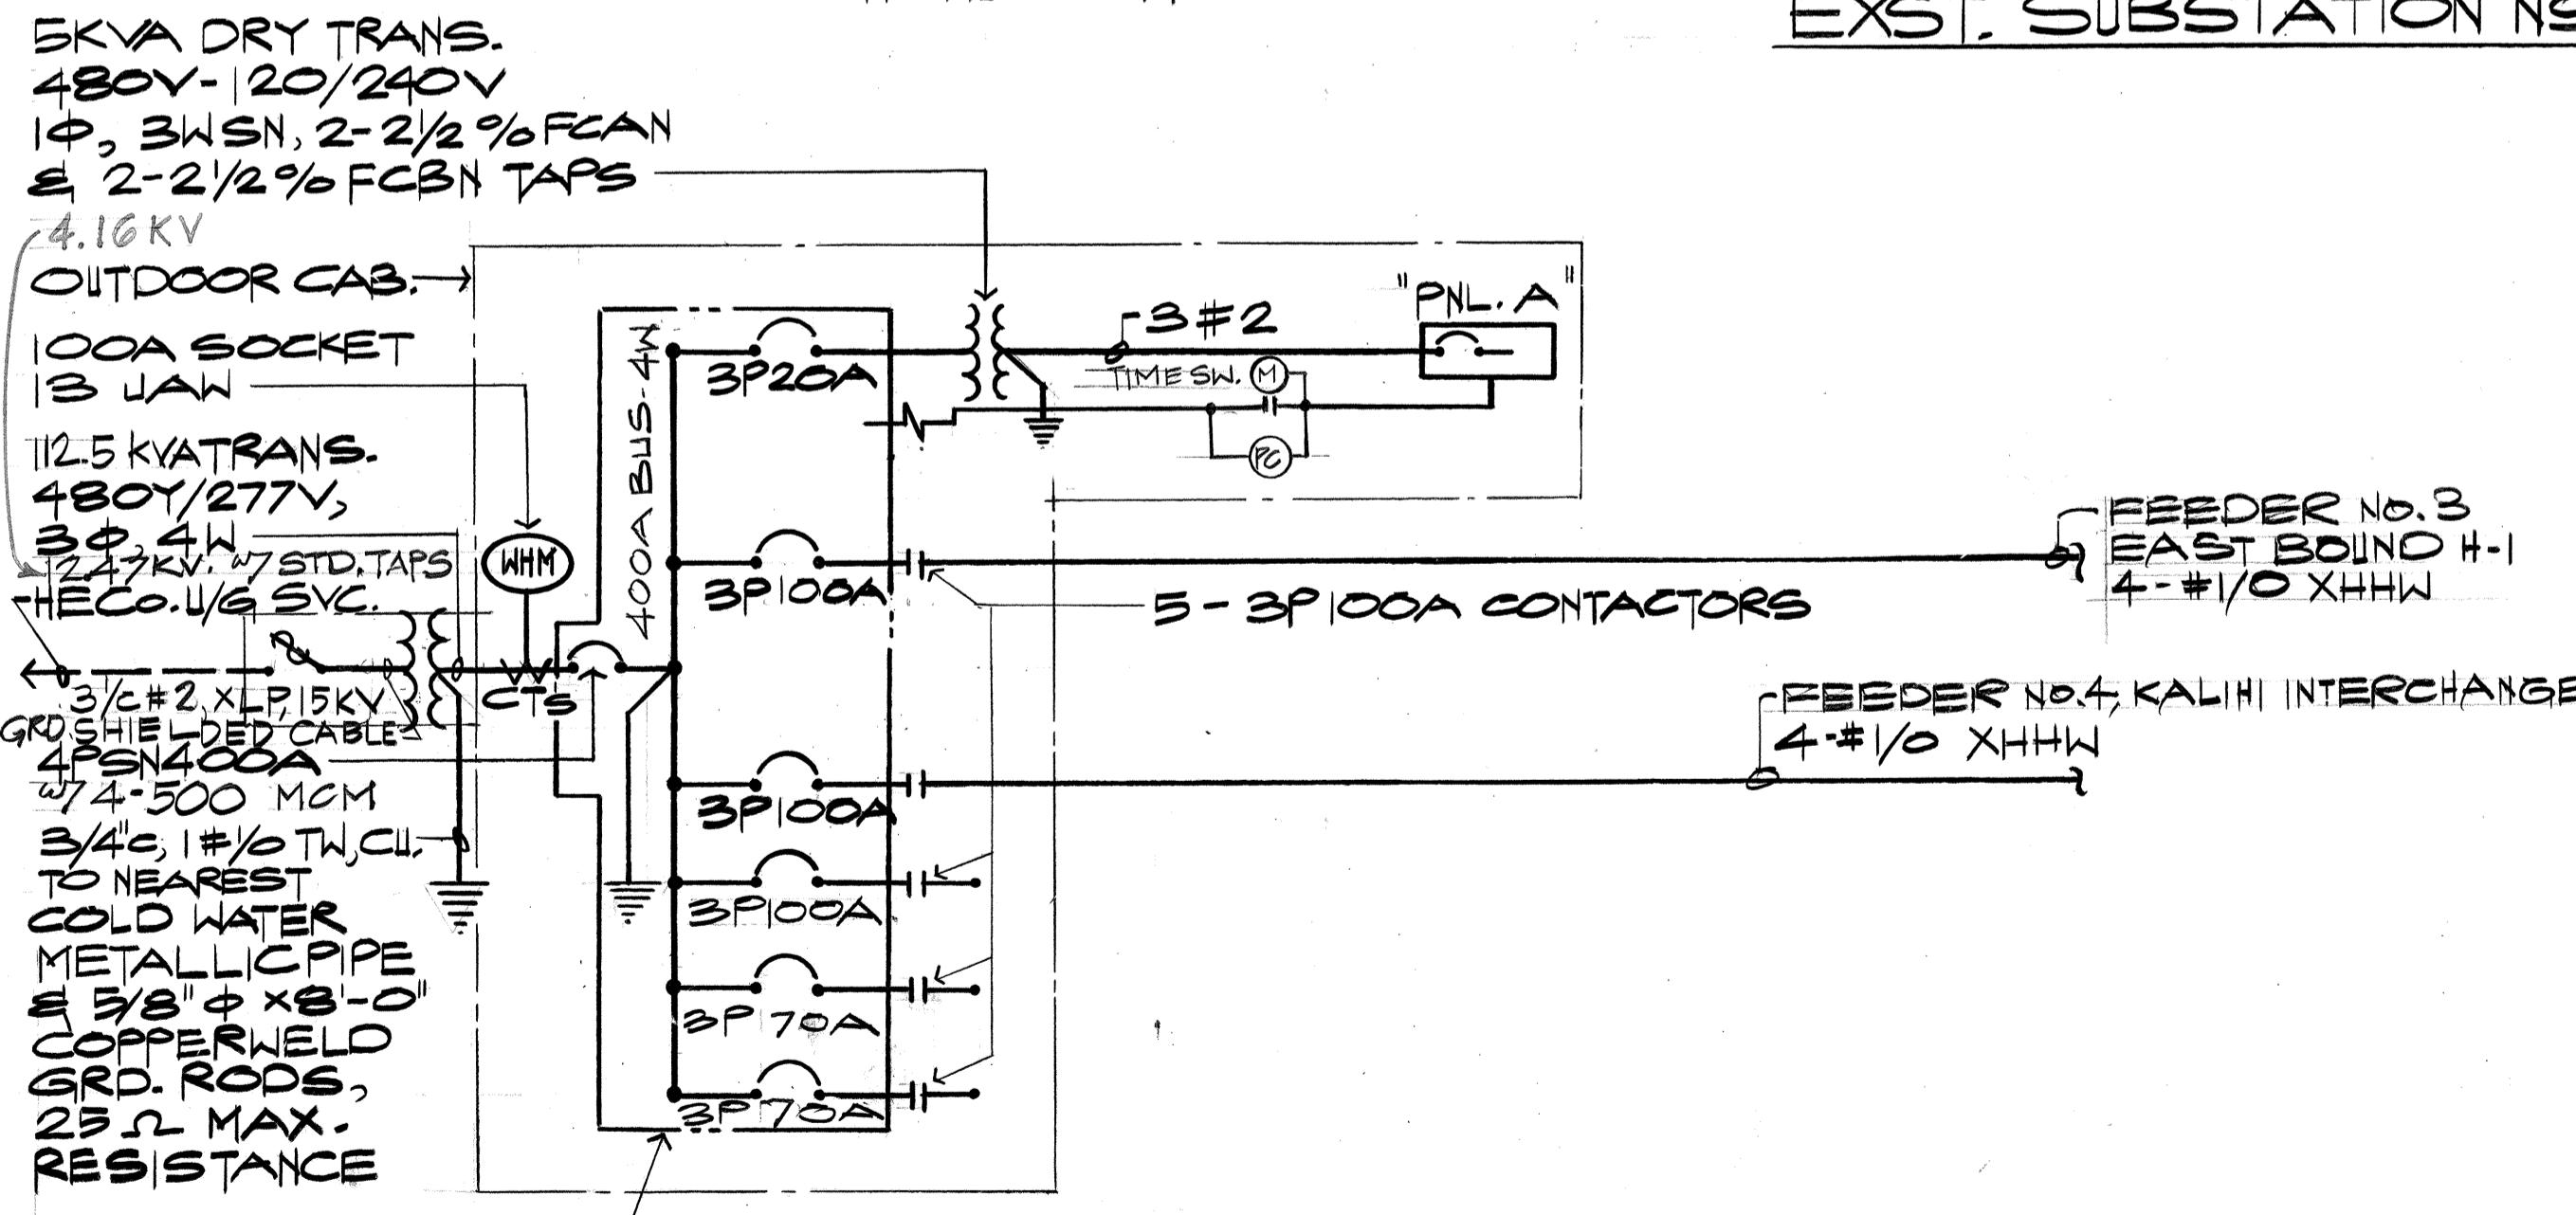

NAKAMURA, KAWABATA & ASSOC., INC.
One Kapolei Blvd., Suite 403
600 Kapolei Boulevard
Honolulu, Hawaii 96813



INTERSTATE H-1 IMPROVEMENTS
MIDDLE STREET TO KALIHI INTERCHANGE
EASTBOUND LANES
F.A.I. PROJECT NO. I - HI-I(178)

ONE-LINE DIAGRAM, TRANSFORMER STATION "K"

NOTE: FOR SIGN LTG. WIRING, SEE SHT 20L

Hyun Nakamura

SHEET NO. 21 OF SHEETS

FED. ROAD DIST. NO.	STATE	FED. AID PROJ. NO.	FISCAL YEAR	SHEET NO.	TOTAL SHEETS
HAWAII	HAW.	I -HI-I(178)	1982	94	165


PANEL SCHEDULE

CKT. NO.	BKR'S. P	USE: L-LTS, R-REC OF B-PROV, PUT-BKRS S-Spare	KVA			WIRE
			A	B	C	
1	1	20	3.5	3.5	3.5	10
2			3.5	3.5	3.5	
3			3.5	3.5	3.5	
4			3.5	3.5	3.5	
5			3.5	3.5	3.5	
6			3.5	3.5	3.5	
7			3.5	3.5	3.5	
8			3.5	3.5	3.5	
9			3.5	3.5	3.5	
10			3.5	3.5	3.5	
11			3.5	3.5	3.5	
12			3.5	3.5	3.5	
13			3.5	3.5	3.5	
14			3.5	3.5	3.5	
15			3.5	3.5	3.5	
16			3.5	3.5	3.5	
17			3.5	3.5	3.5	
18			3.0	3.0	3.0	4
19			3.0	3.0	3.0	-
20						
			55	55	55	
TOTALS						
KVA			165			
D.F.			1.0			
D.KVA			165			

PNL.A: 480Y/277V, 3PH, 4WSN 2-SECT.

400A LIGS A LIGS SURF.


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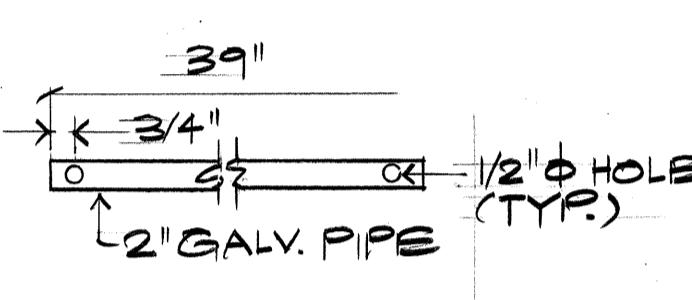
SECT. "A"
N.T.S.

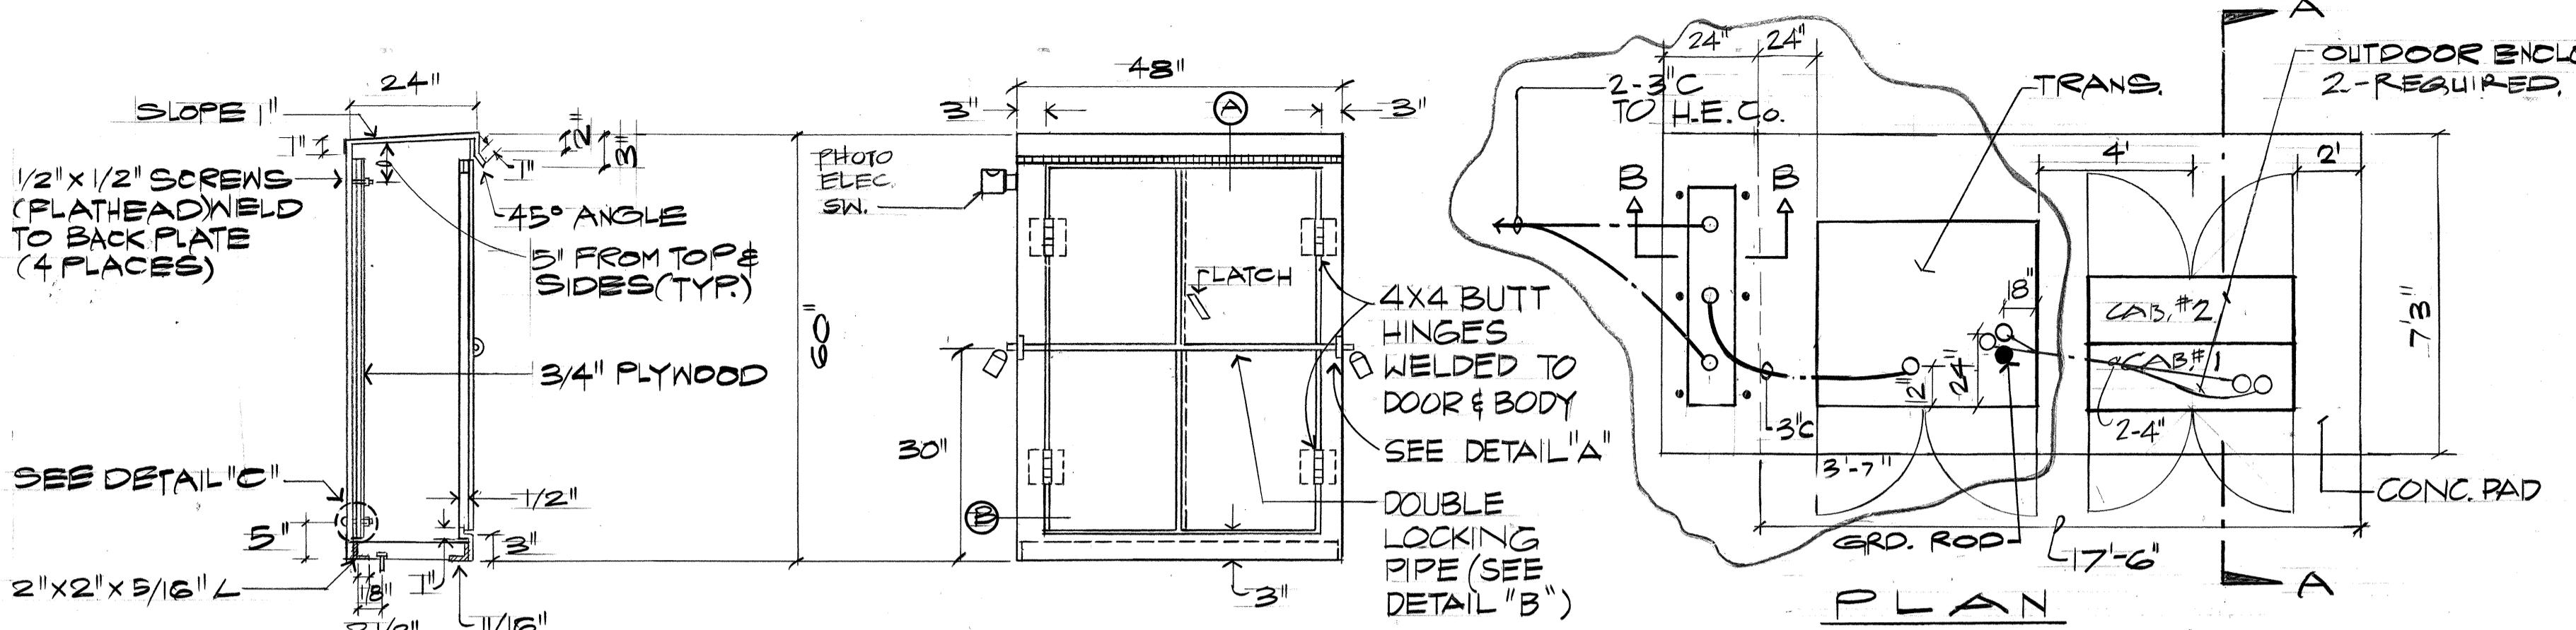ELEV.
N.T.S.


TRANSFORMER STATION
N.T.S.




DETAIL "A"
SIDE VIEW
N.T.S.

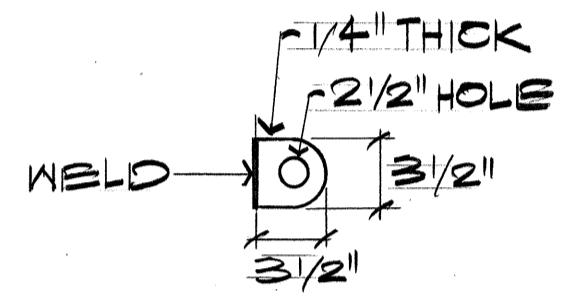

DETAIL "B"
N.T.S.

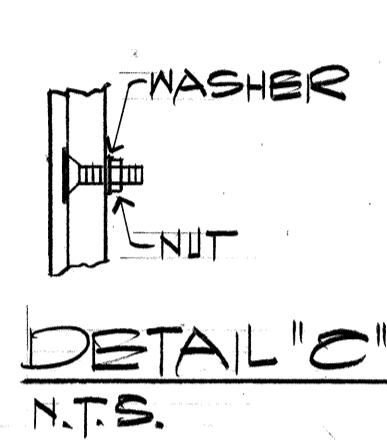

DETAIL "C"
N.T.S.

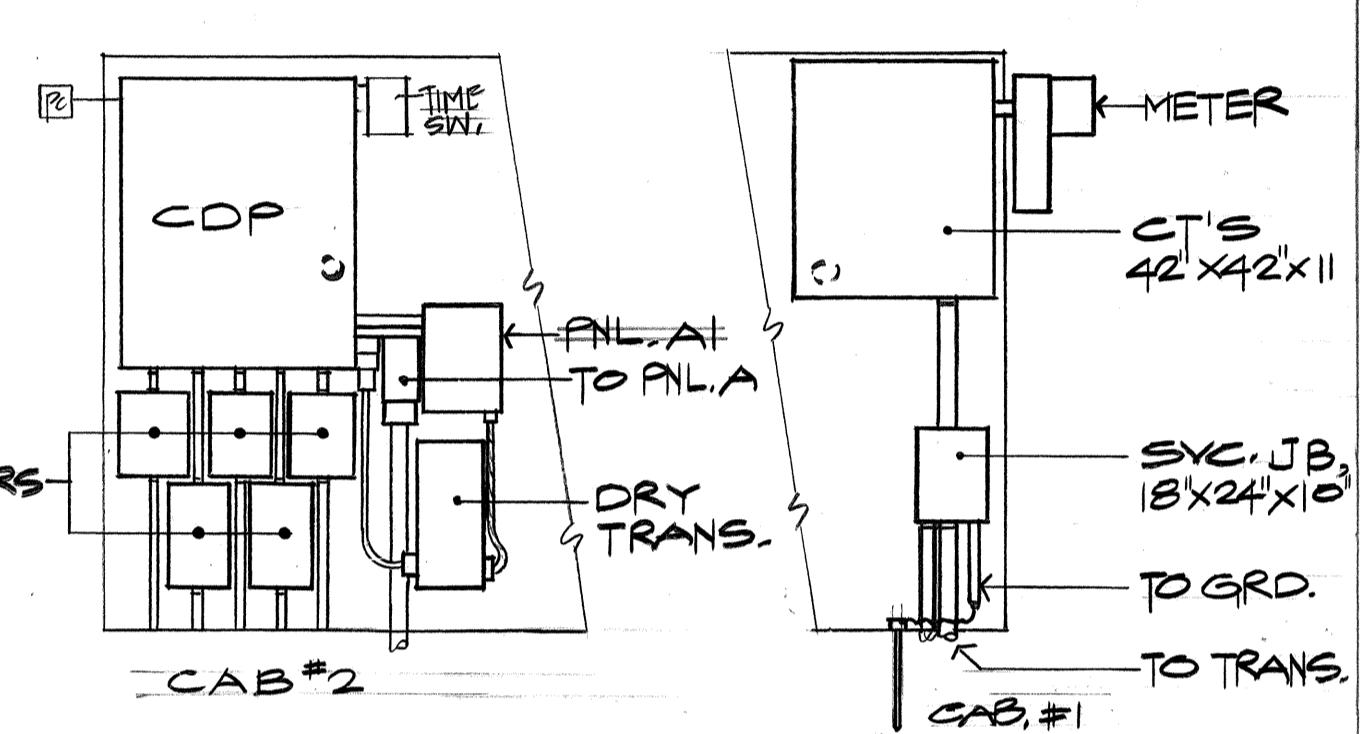


ELEV.
METER & SERVICE EQUIPMENT

N.T.S.

WEST BOUND

INTERSTATE
EASTBOUND

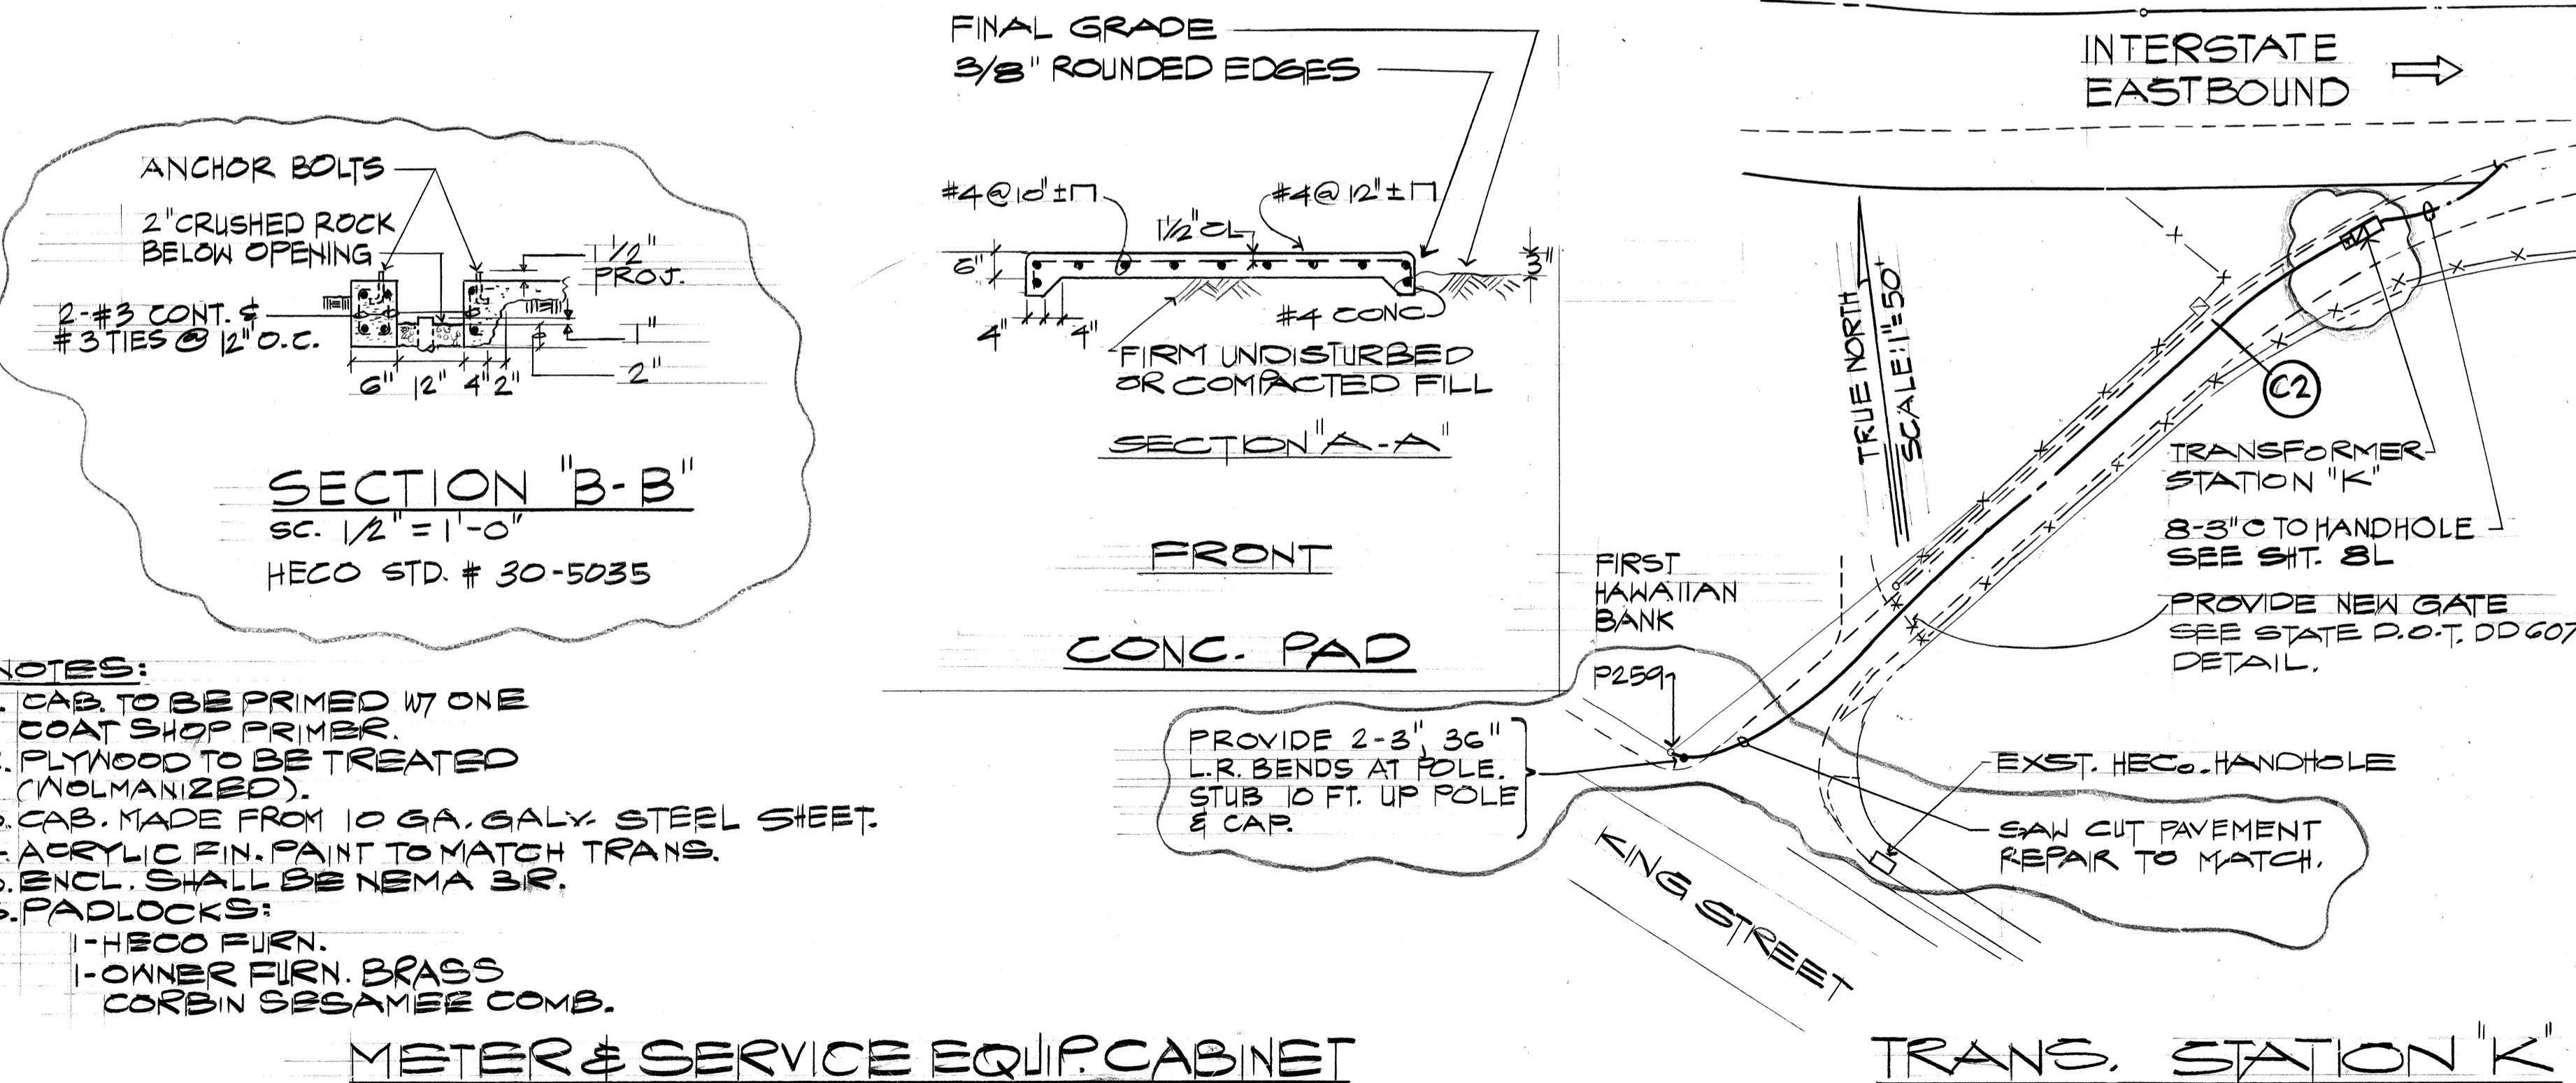

NOTES:

1. CAB. TO BE PRIMED W/ ONE COAT SHOP PRIMER.
2. PLYWOOD TO BE TREATED (WOLMANIZED).
3. CAB. MADE FROM 10 GA. GALV. STEEL SHEET.
4. ACRYLIC FIN. PAINT TO MATCH TRANS.
5. ENCL. SHALL BE NEMA 3R.
6. PADLOCKS:
I-HECO FURN.
I-OWNER FURN. BRASS
CORBIN SESAMEE COMB.

METER & SERVICE EQUIP. CABINET
N.T.S.

2/2/83 REVISED H.E. CO. U/G SVC &
TRANS. STATION

DATE REVISION

NAKAMURA, KAWABATA & ASSOC., INC.
One Kapolei Blvd., Suite 403
600 Kapolei Boulevard
Honolulu, Hawaii 96813

THIS DRAWING IS FOR INFORMATION
PURPOSES ONLY AND IS NOT DRAWN TO SCALE.

Hyun Nakamura

STATE OF HAWAII
DEPARTMENT OF TRANSPORTATION
LAND TRANSPORTATION FACILITIES DIVISION

SUB-STATION DETAILS


INTERSTATE H-1 IMPROVEMENTS
MIDDLE STREET TO KALIHI INTERCHANGE
EASTBOUND LANES
F. A. I. PROJECT NO. I -HI-I(178)

SHEET NO. 3L OF SHEETS


CO 94

FED. ROAD DIST. NO.	STATE	FED. AID PROJ. NO.	FISCAL YEAR	SHEET NO.	TOTAL SHEETS
HAWAII	HAW.	I - HI-I(178)	1982	95	165

FEEDER NO.1,
SUBSTATION NO.1
4-500 MCM
PNL. "A"

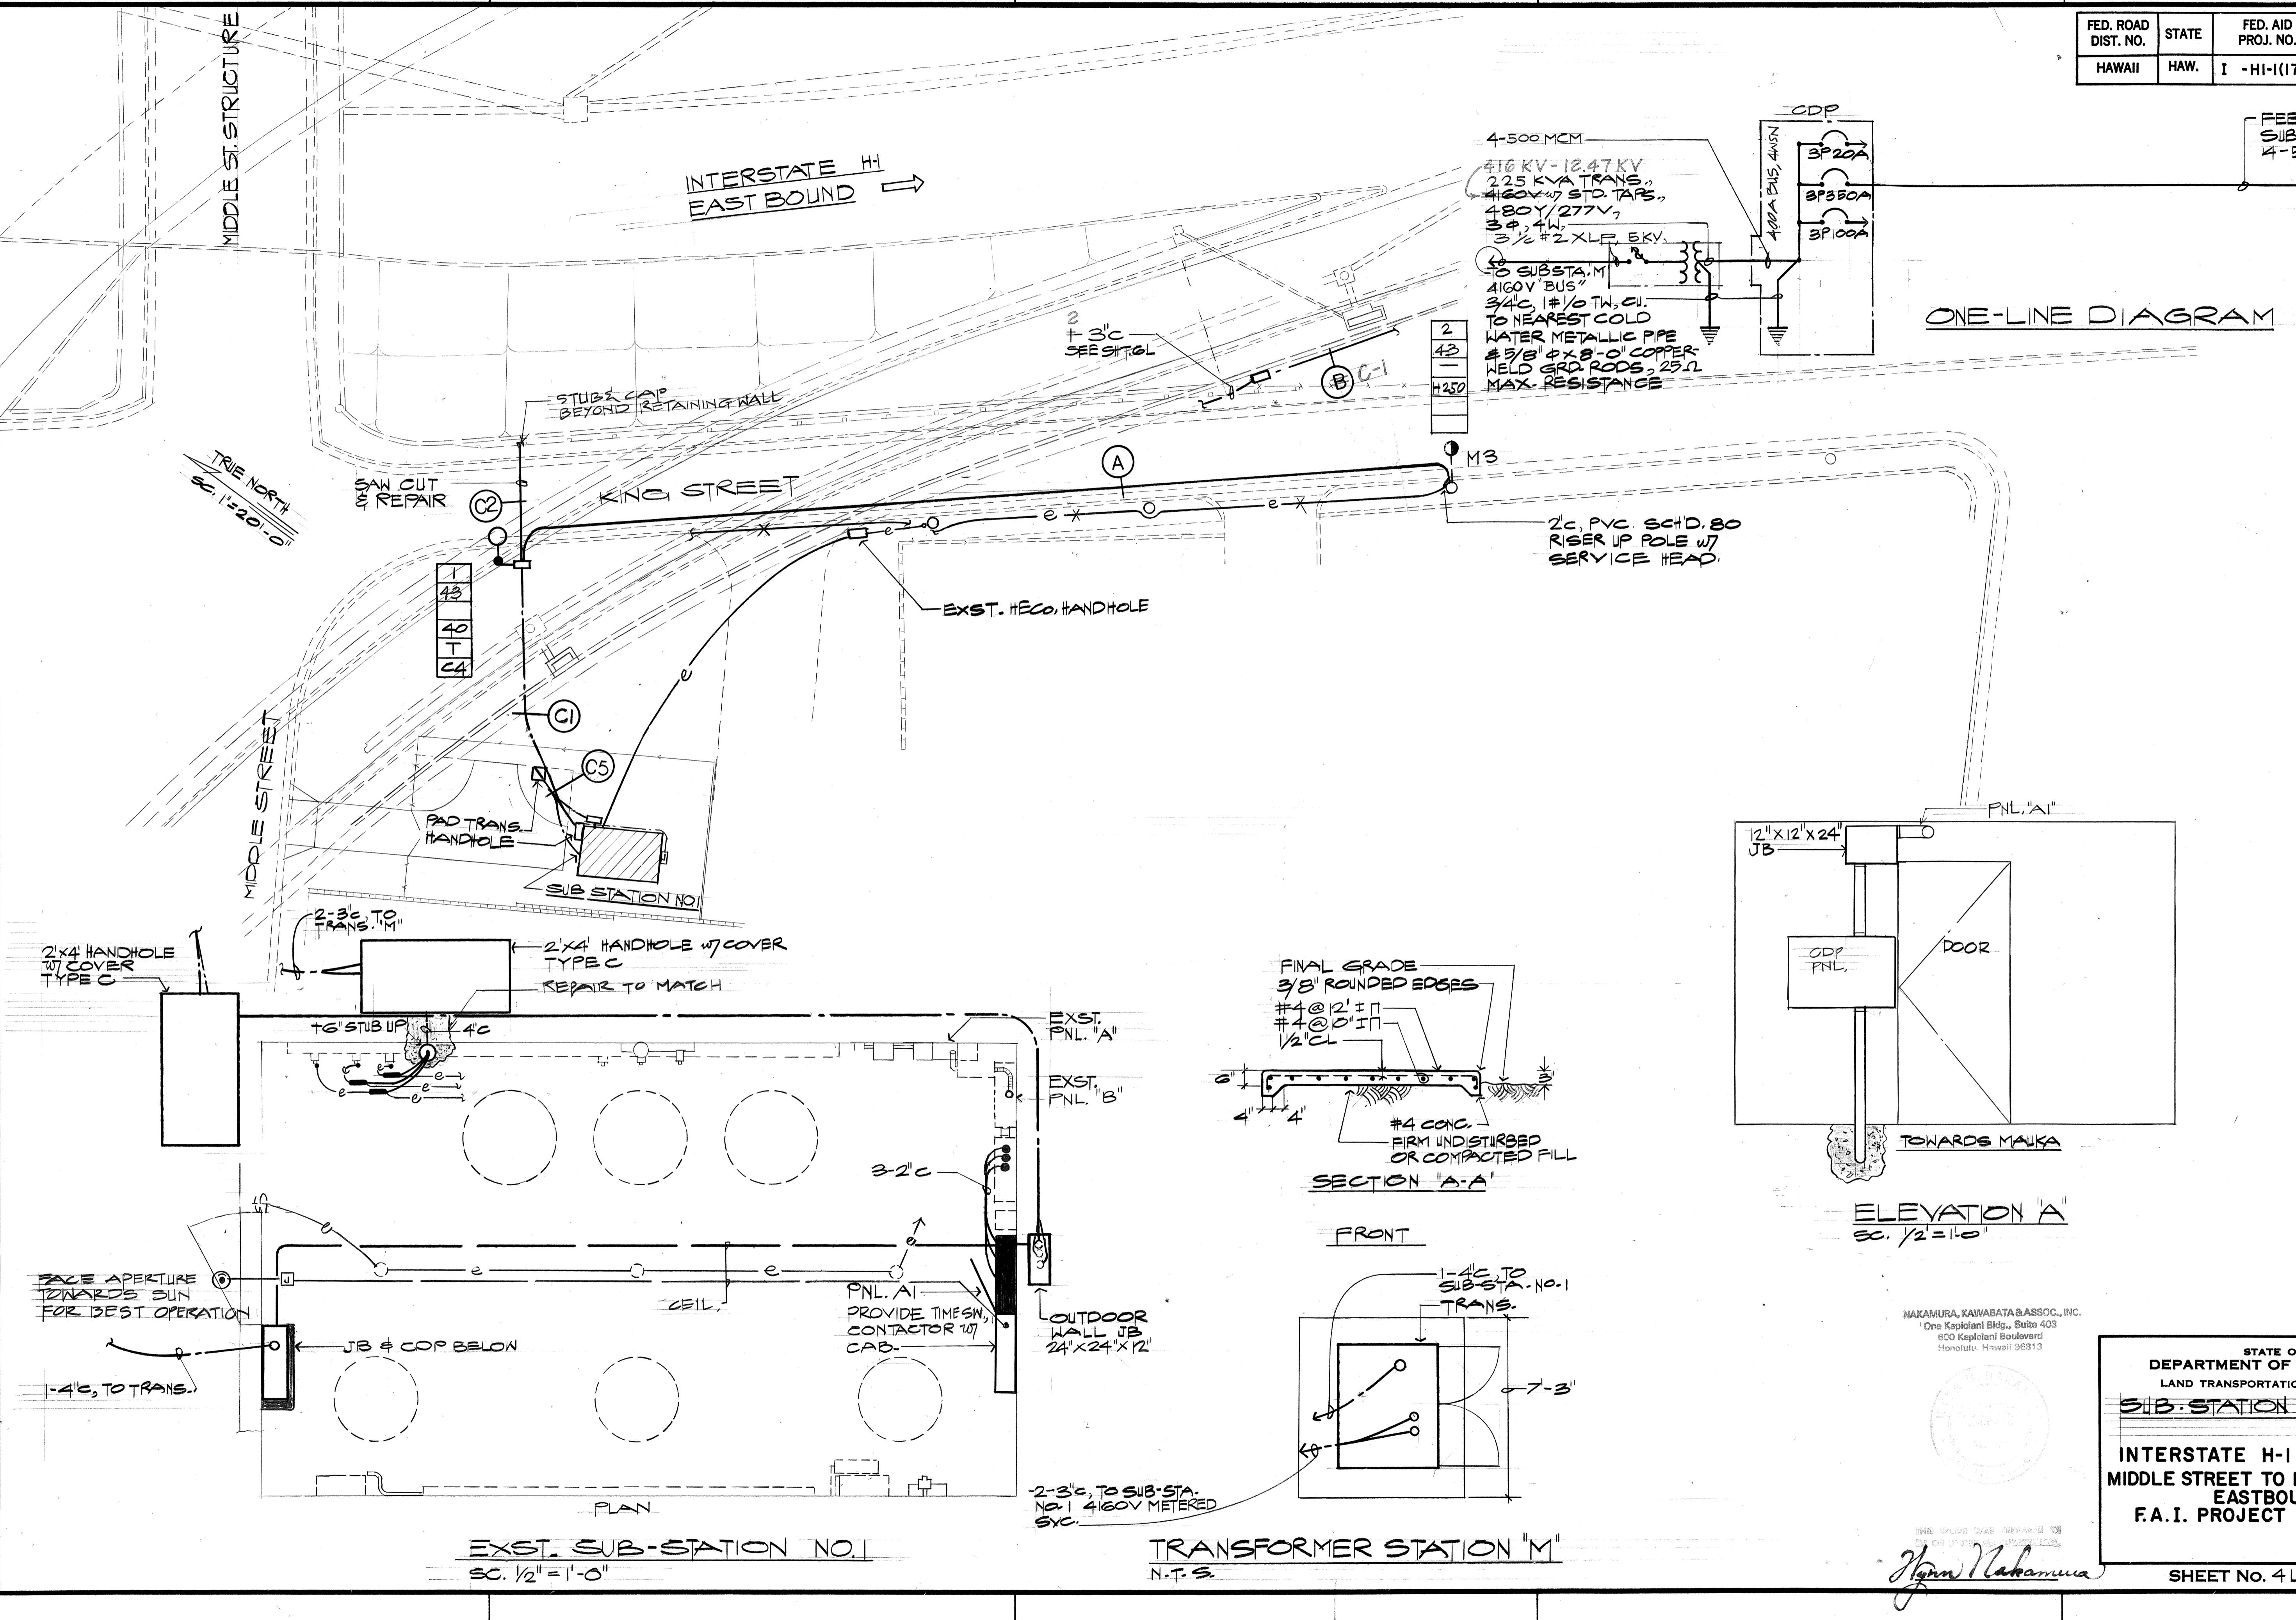

FED. ROAD DIST. NO.	STATE	FED. AID PROJ. NO.	FISCAL YEAR	HEET NO.	TOTAL SHEETS
HAWAII	HAW	I-HI-I(178) 1982	96	165	

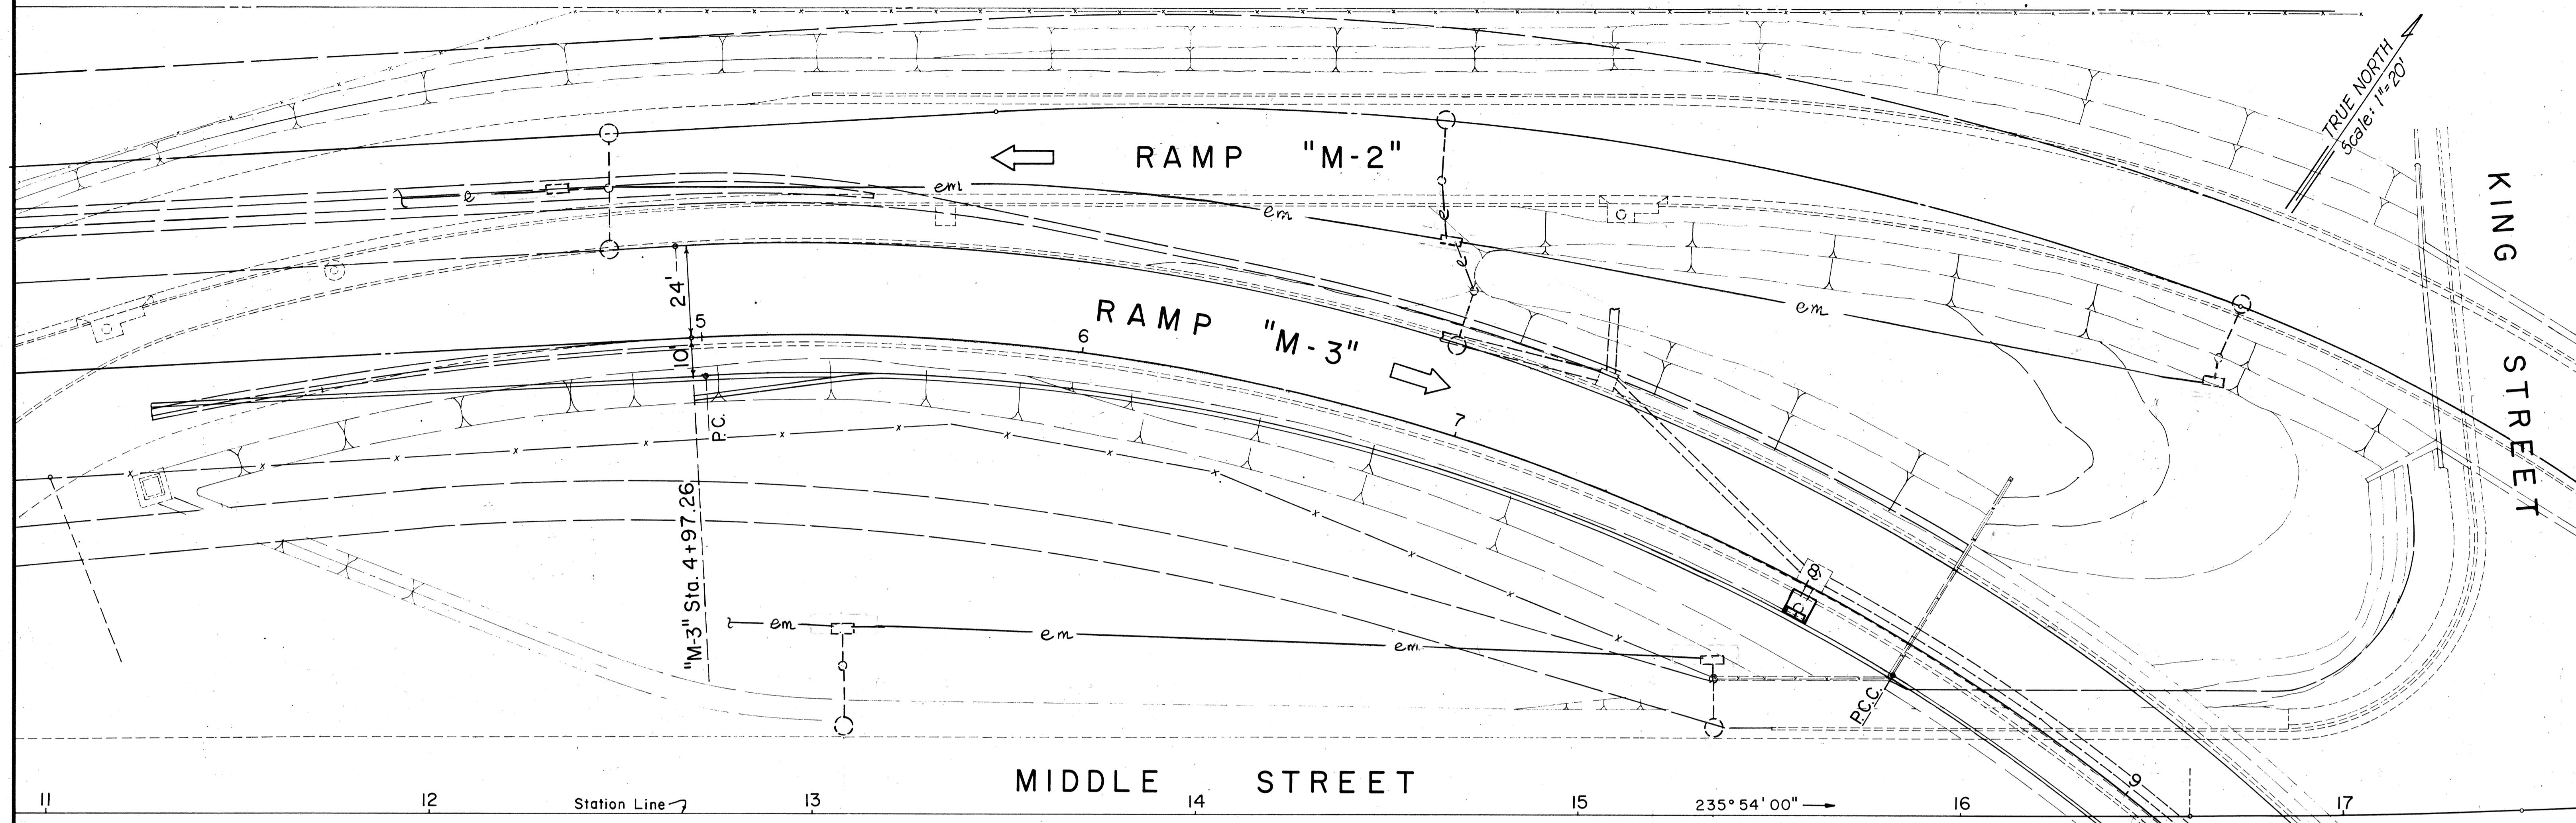

ORIGINAL PLAN
SURVEY PLOTTED BY _____
DRAWN BY _____
TRACED BY _____
DESIGNED BY _____
QUANTIFIED BY _____
NOTES BOOK _____
NO. _____

NAKAMURA, KAWABATA & ASSOC., INC.
One Kapiolani Blvd., Suite 403
600 Kapiolani Boulevard
Honolulu, Hawaii 96813




STATE OF HAWAII
DEPARTMENT OF TRANSPORTATION
HIGHWAYS DIVISION
HIGHWAY LIGHTING PLAN

INTERSTATE H-1 IMPROVEMENTS
MIDDLE STREET TO KALIHI INTERCHANGE
EASTBOUND LANES
F.A.I. PROJECT NO. I -HI-I(178)

SHEET NO. 5 L OF SHEETS

Nakamura

FED. ROAD DIST. NO.	STATE	FED. AID PROJ. NO.	FISCAL YEAR	SHEET NO.	TOTAL SHEETS
HAWAII	HAW.	I-HI-I(178)	1982	97	165

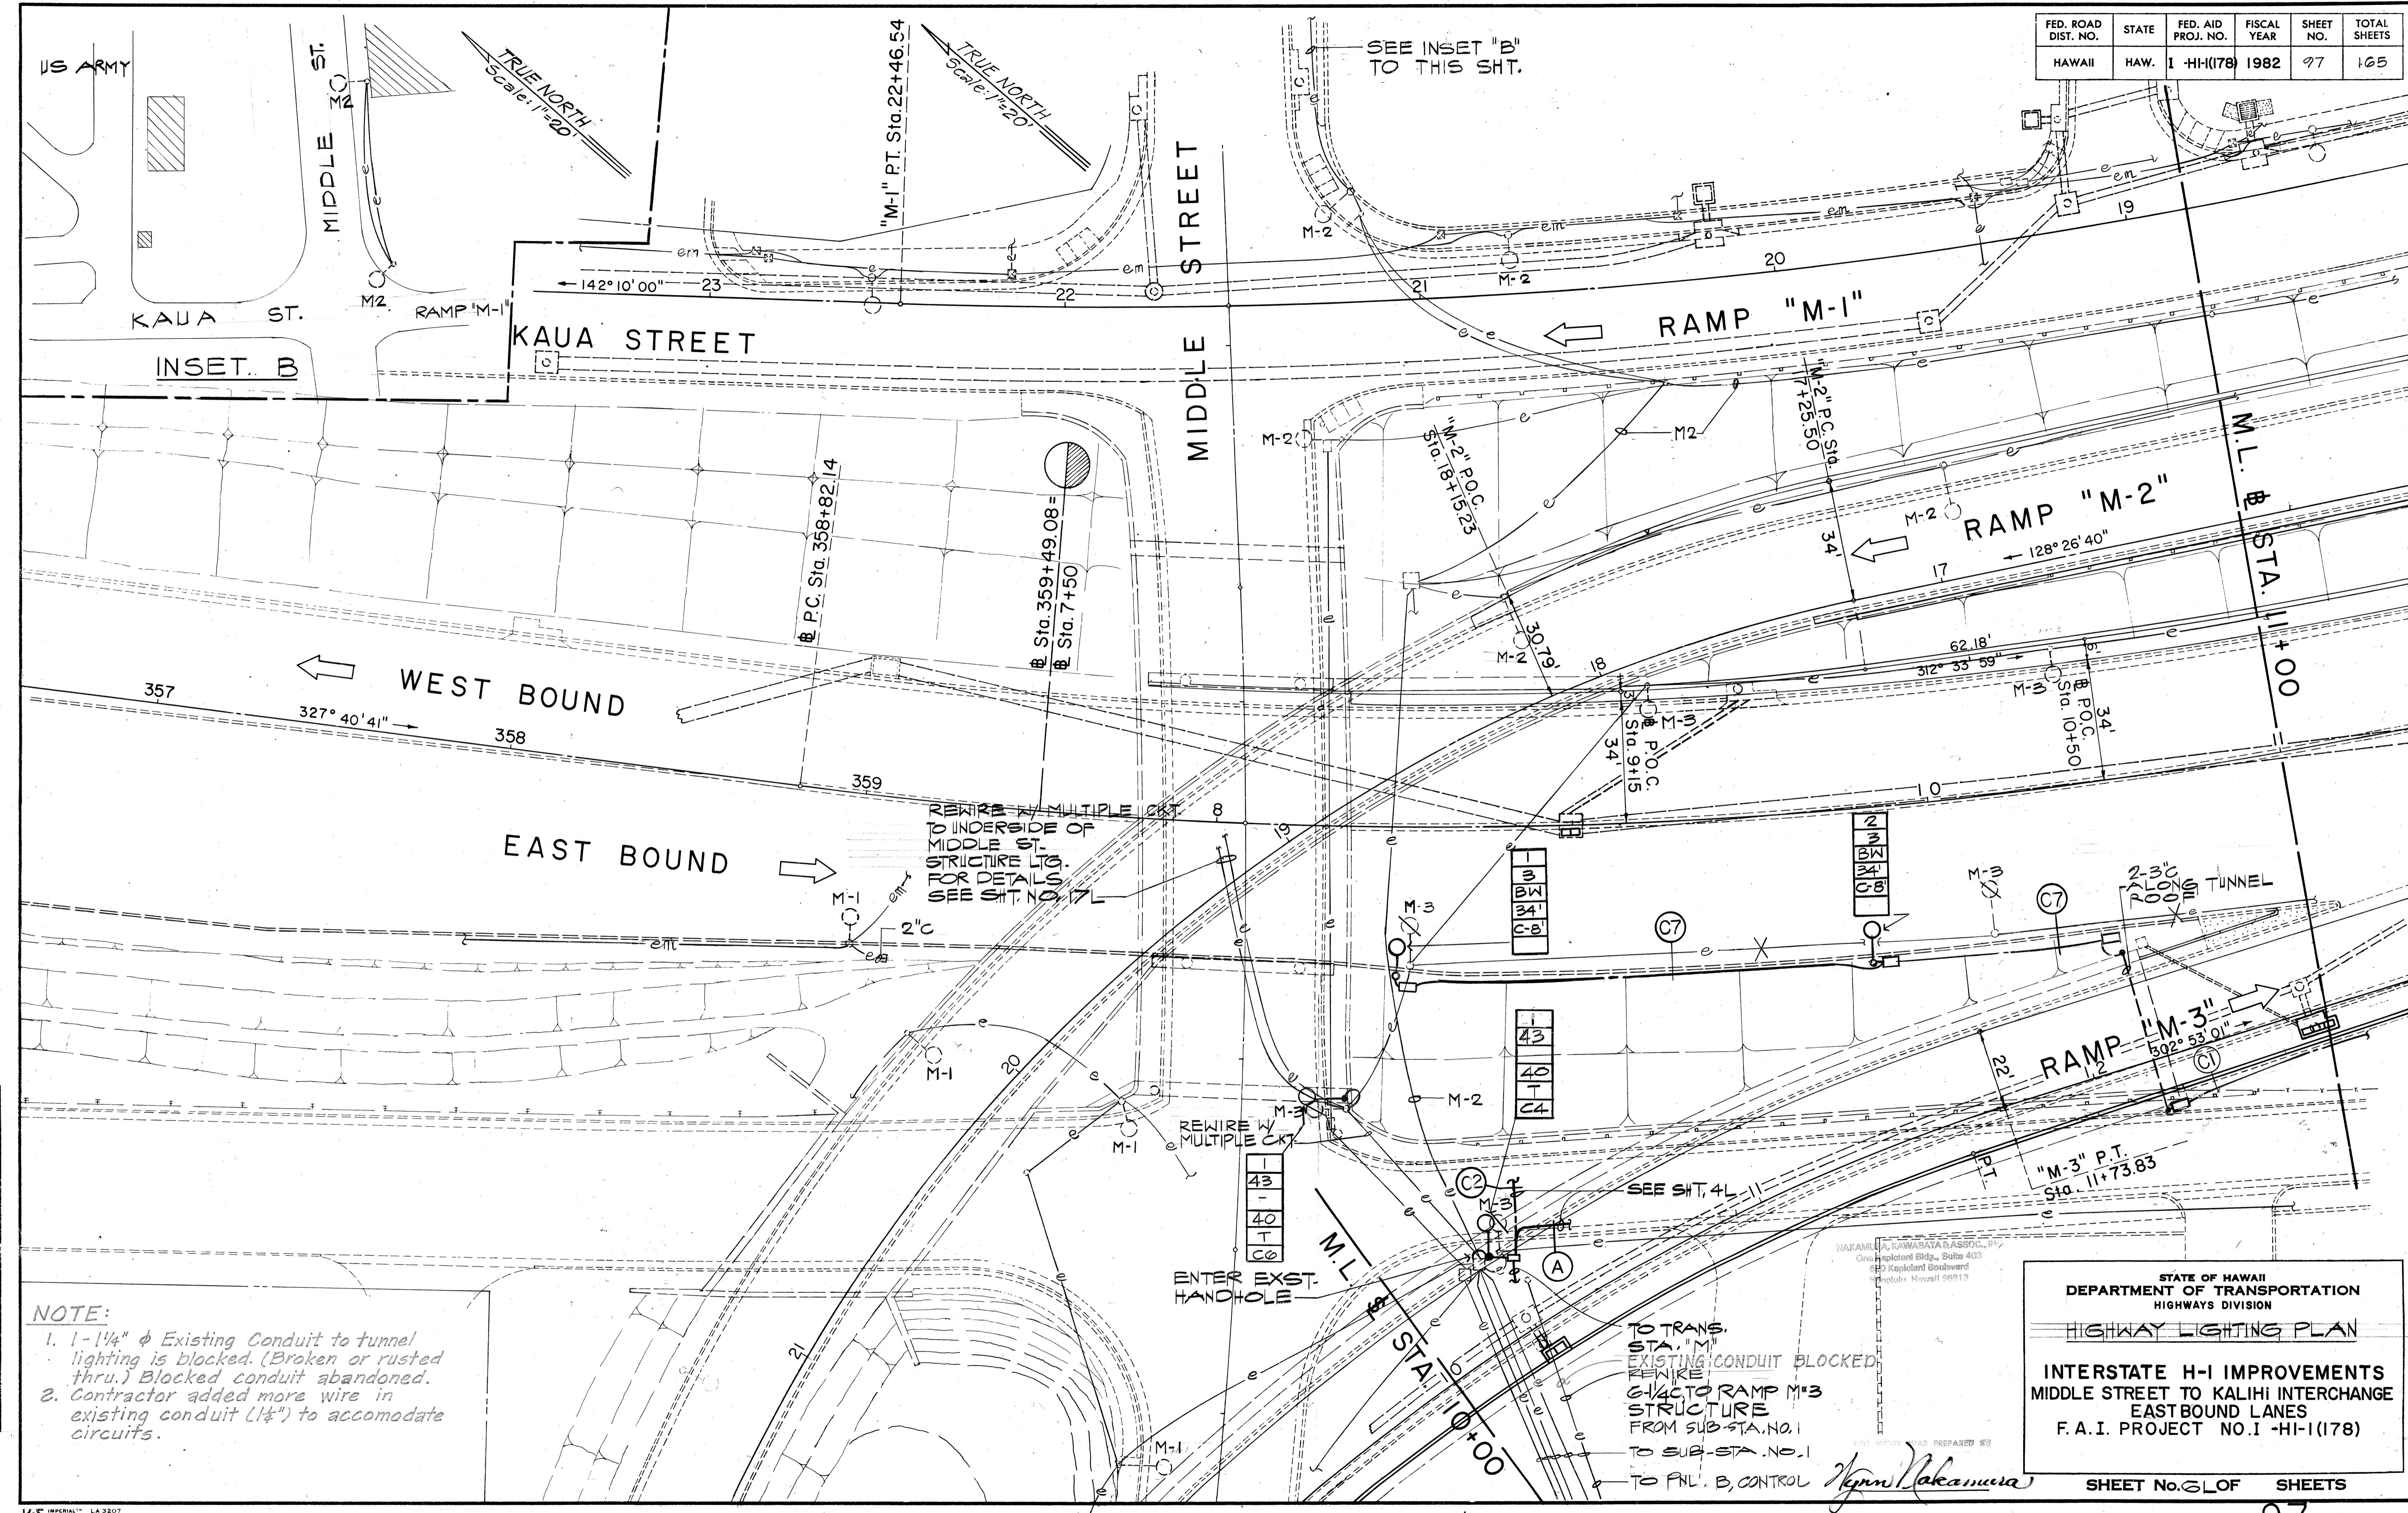


ORIGINAL SURVEY PLOTTED BY
PLAN DRAWN BY
TRACED BY
DESIGNED BY
CHECKED BY
NOTE BOOK NO.

FED. ROAD DIST. NO.	STATE	FED. AID PROJ. NO.	FISCAL YEAR	SHEET NO.	TOTAL SHEETS
HAWAII	HAW.	I - HH(178)	1982	98	165


TRUE NORTH
Scale: 1" = 1/20

"M-1" P.O.C.
Sta. 13+50

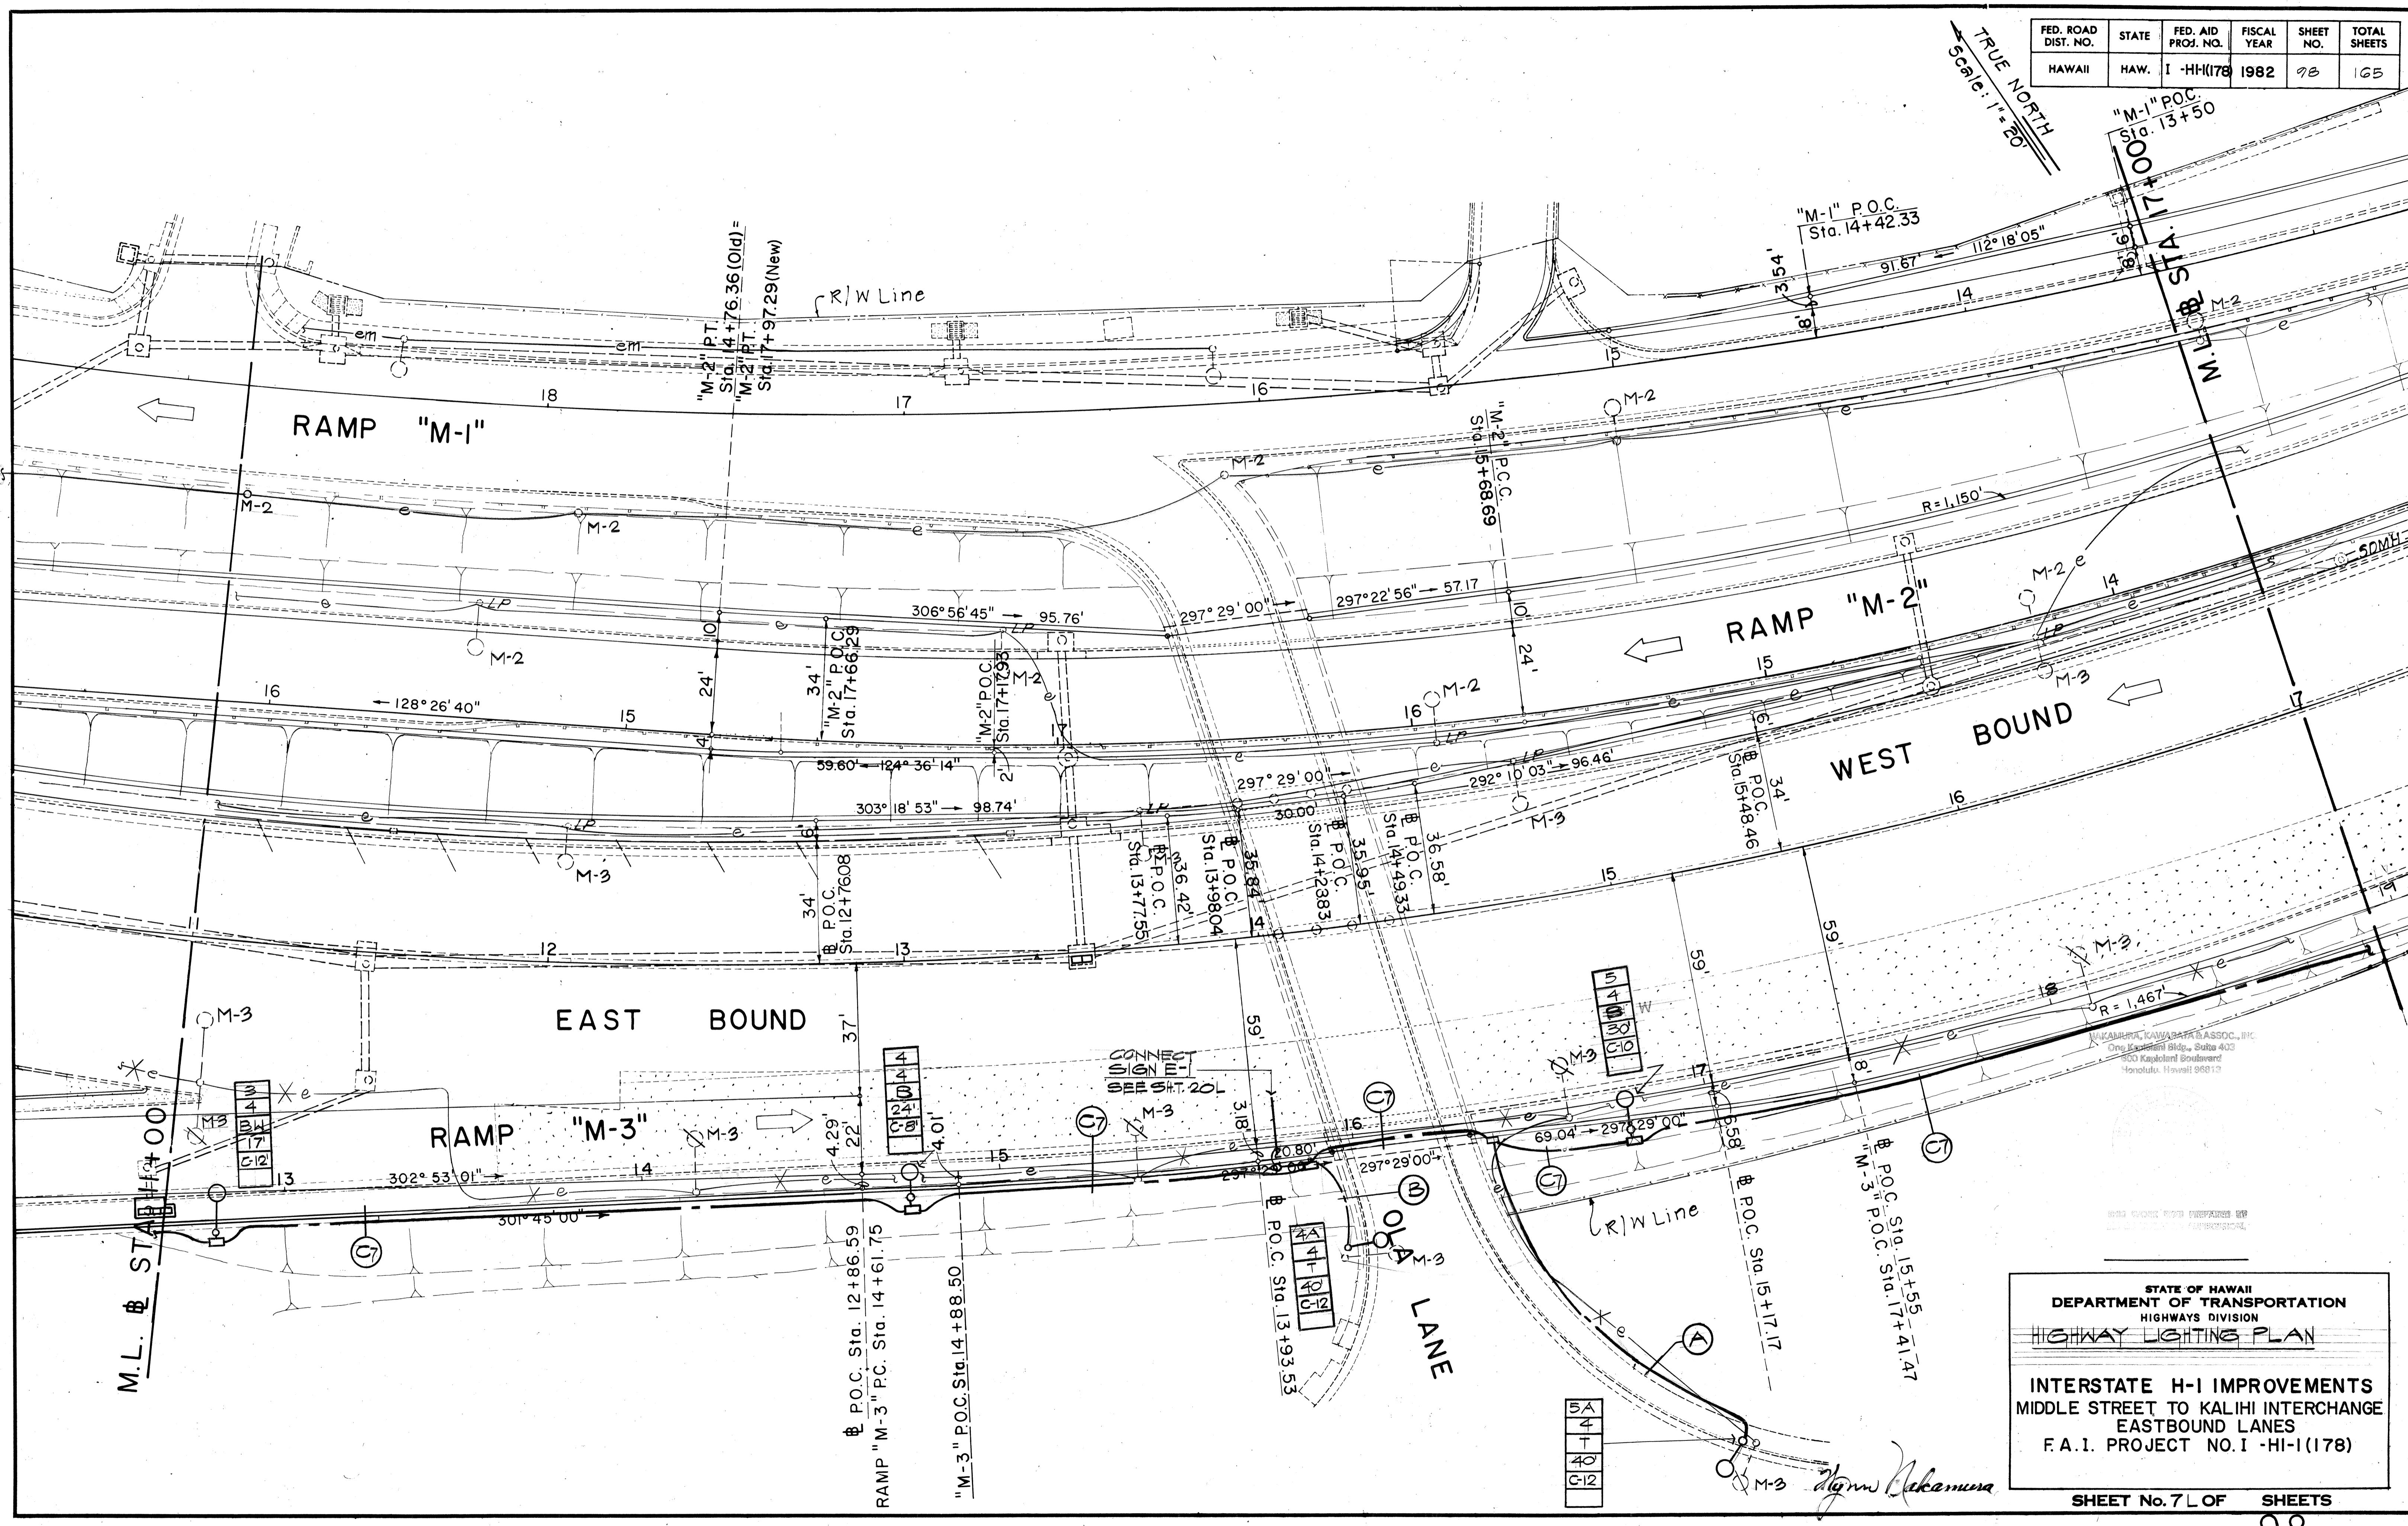

FED. ROAD DIST. NO.	STATE	FED. AID PROJ. NO.	FISCAL YEAR	SHEET NO.	TOTAL SHEETS
HAWAII	HAW.	I - HI-I(178)	1982	99	165


M.L. B STA. 17+00

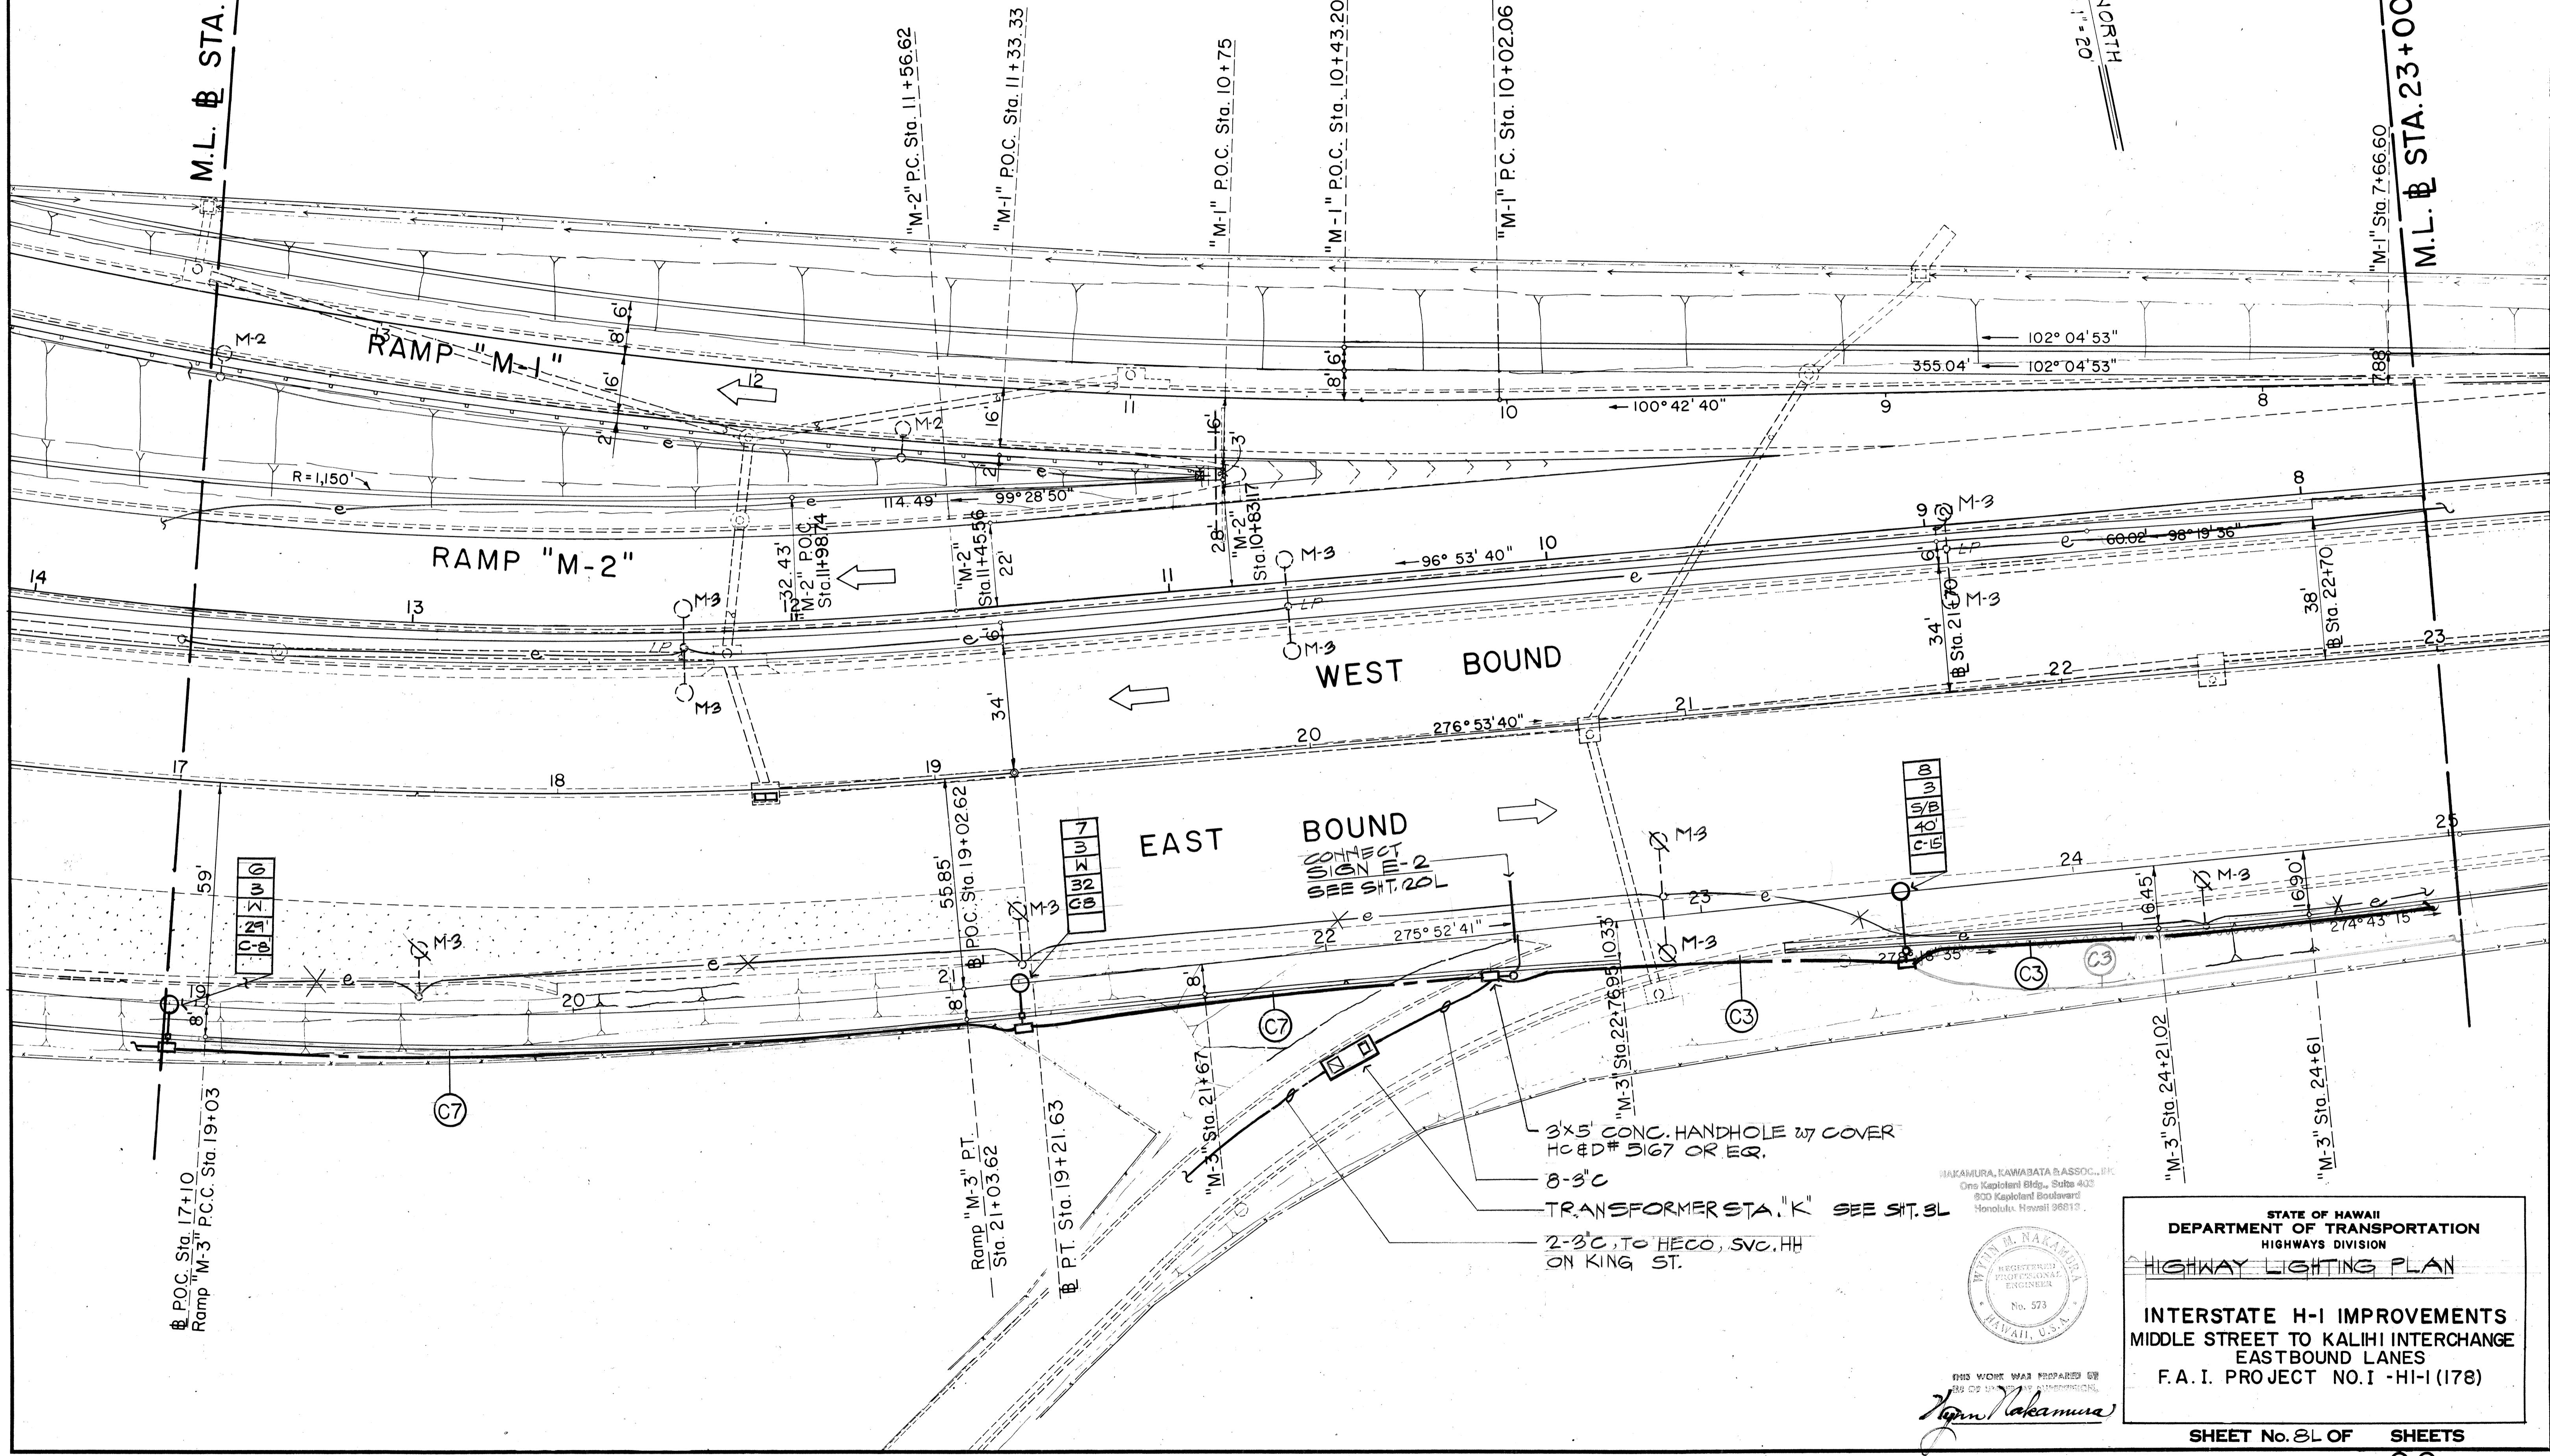

ORIGINAL	STORY PLOTTED BY	DATE
PLAN	DRAWN BY	
TRACED	DESIGNED BY	
NOTE BOOK	QUANTITIES BY	
CHECKED BY		
No. _____		

B POC Sta. 17+10
Ramp M-3" P.C.C. Sta. 19+03

SHEET No. 8L OF SHEETS
99

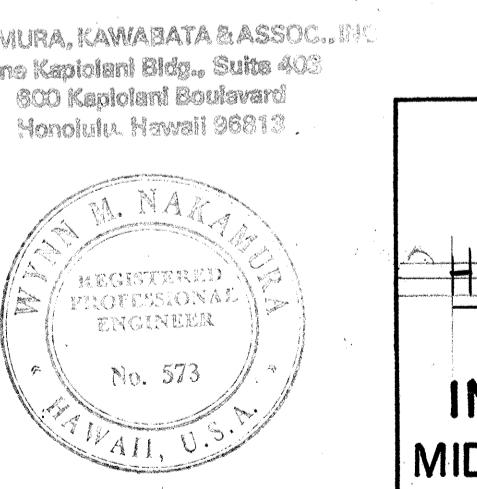

STATE OF HAWAII
DEPARTMENT OF TRANSPORTATION
HIGHWAYS DIVISION
HIGHWAY LIGHTING PLAN
INTERSTATE H-I IMPROVEMENTS
MIDDLE STREET TO KALIHI INTERCHANGE
EASTBOUND LANES
F.A.I. PROJECT NO. I - HI-I(178)


Nakamura

FED. ROAD DIST. NO.	STATE	FED. AID PROJ. NO.	FISCAL YEAR	HEET NO.	TOTAL SHEETS
HAWAII	HAW.	I -HI-I(178)	1982	100	165


Scale: 1" = 20'
TRUE NORTH

M.L. STA. 29+00

M.L. STA. 23+00

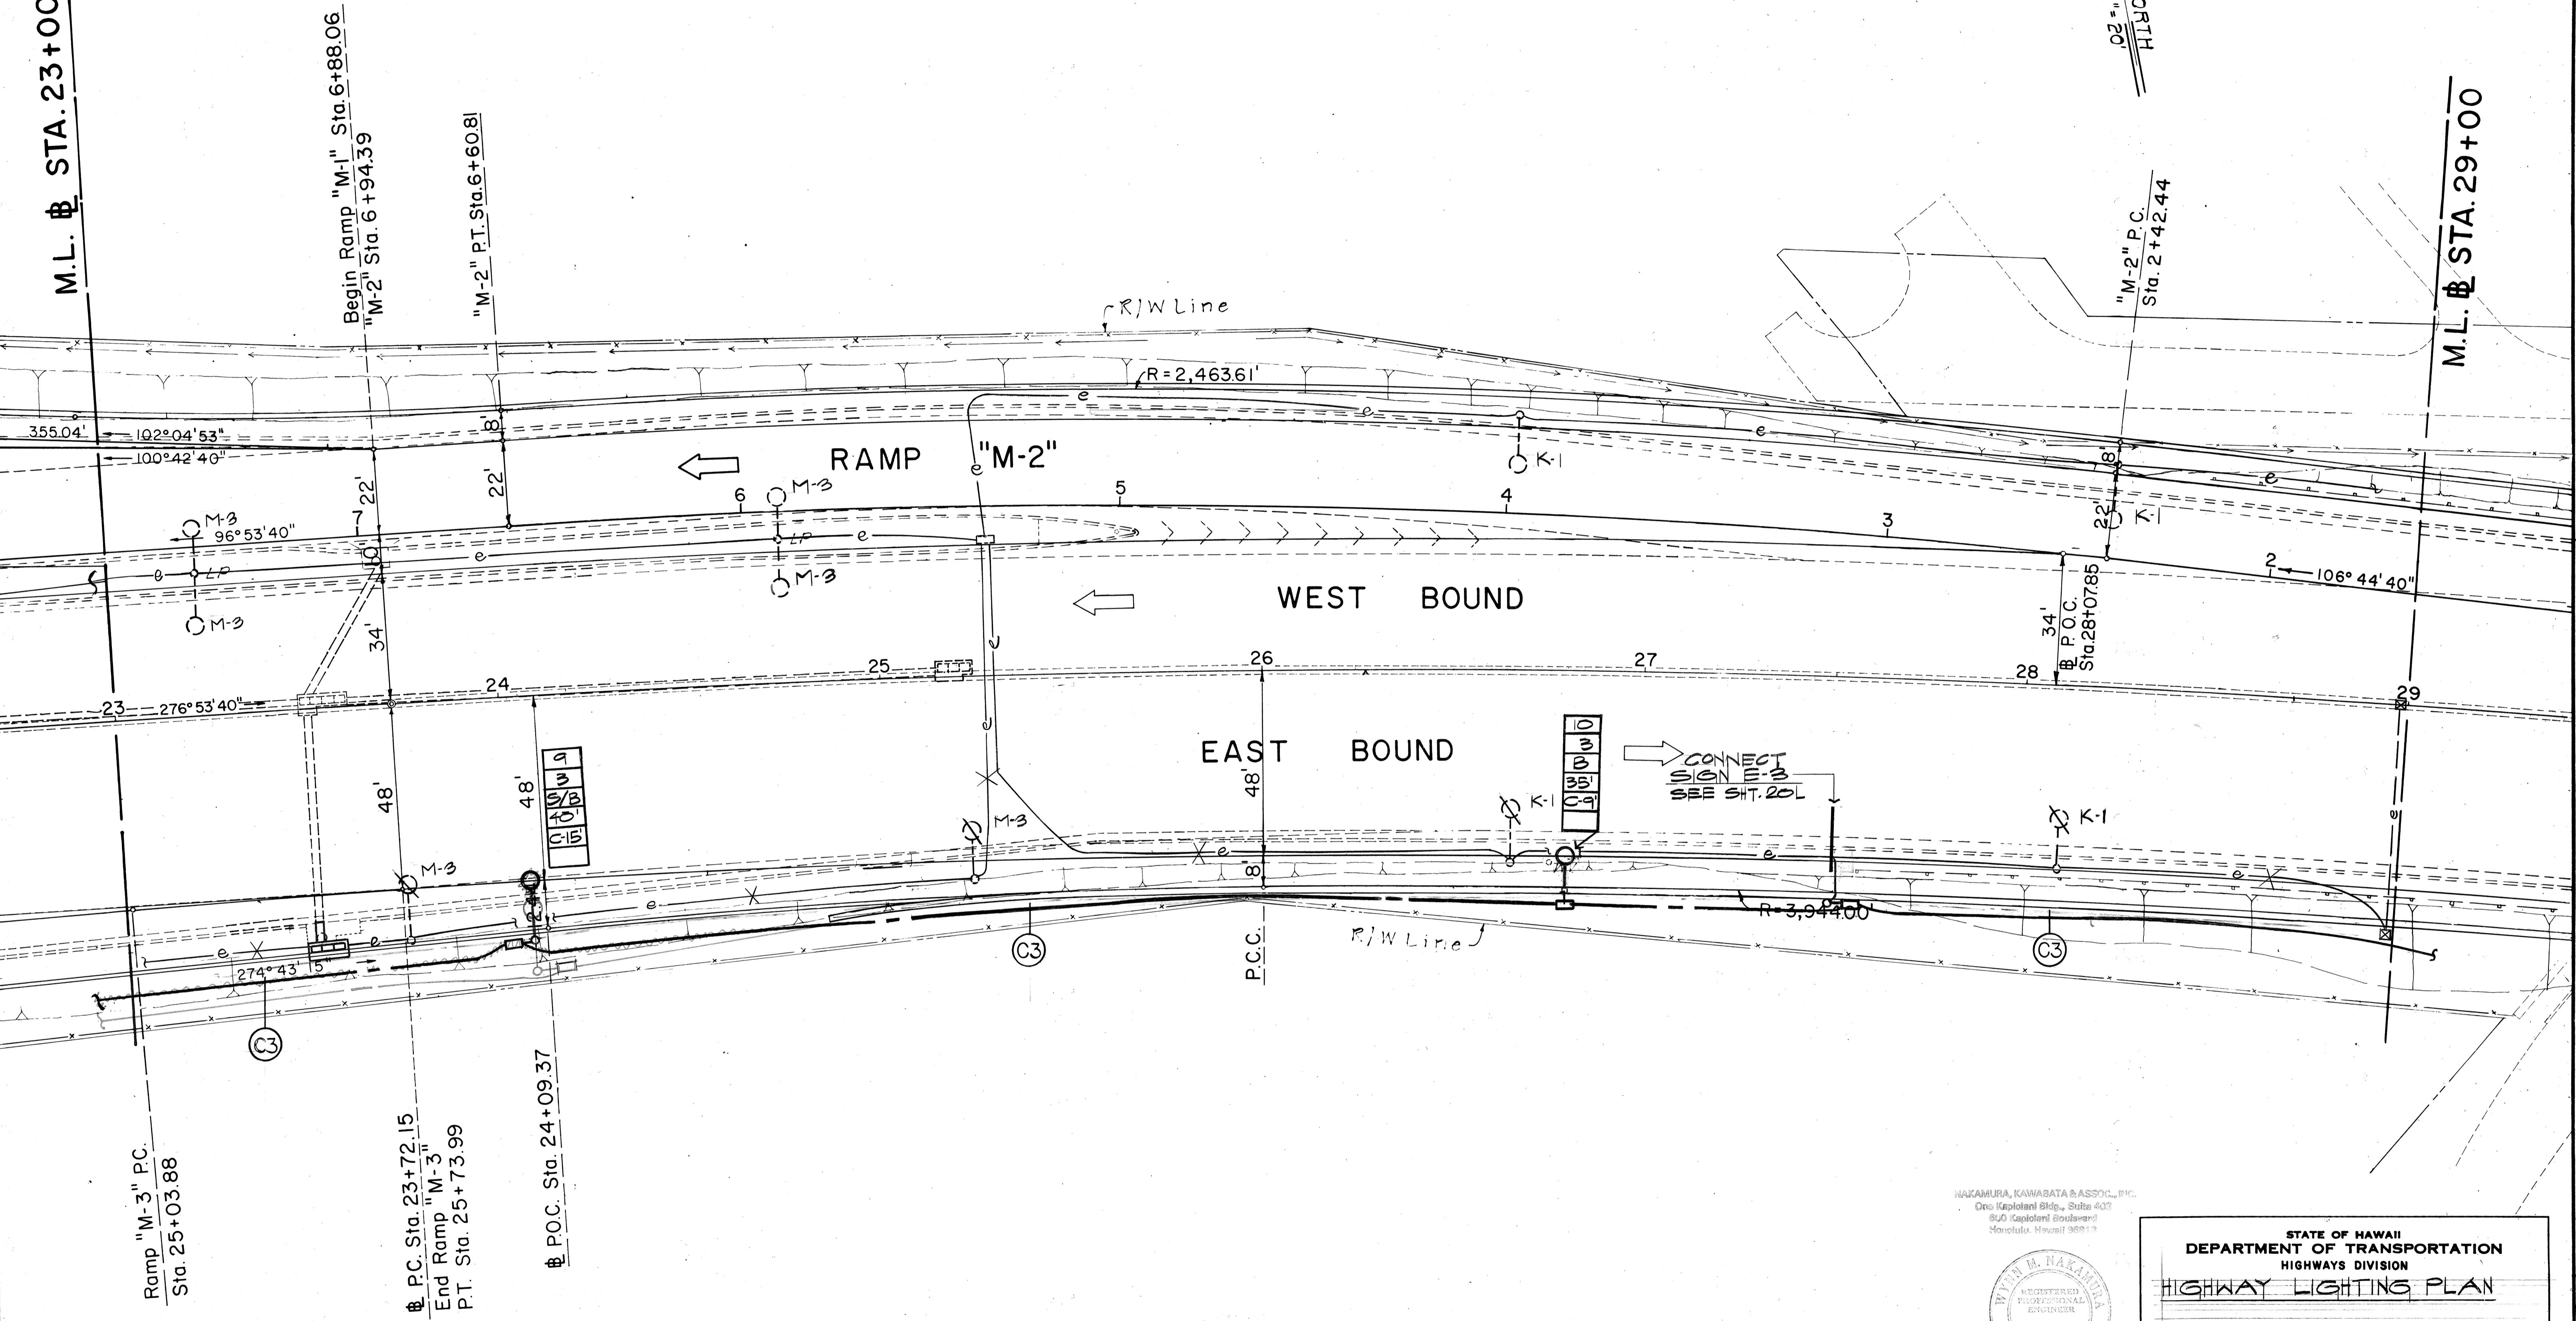

ORIGINAL SURVEY PLOTTED BY	DATE
PLAN DRAWN BY	
TRACED BY	
DESIGNED BY	
NOTE BOOK	
CHIEFED BY	
No. _____	

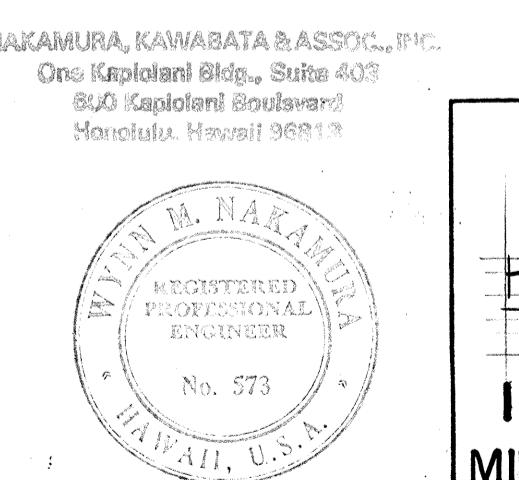

STATE OF HAWAII
DEPARTMENT OF TRANSPORTATION
HIGHWAYS DIVISION
HIGHWAY LIGHTING PLAN
INTERSTATE H-I IMPROVEMENTS
MIDDLE STREET TO KALIHI INTERCHANGE
EASTBOUND LANES
F.A.I. PROJECT NO.I-HI-I(178)

Nakamura

SHEET No. 100 OF SHEETS

E-G

100

INTERSTATE H-I IMPROVEMENTS

FED. ROAD DIST. NO.	STATE	FED. AID PROJ. NO.	FISCAL YEAR	SHEET NO.	TOTAL SHEETS
HAWAII	HAW.	I -HI-I(178) 1982	101	165	

TRUE NORTH
Scale: 1" = 20'

M.L. STA. 35+00

M.L. STA. 29+00

B POC Sta. 30+59.81
Begin Ramp "M-2" Sta. 0+00

RICHARD LANE

KALIHI STREAM

2-2°C

30

31

32

33

34

35

24" X 24" X 1/2"
CAST METAL JB
AT UndERSIDE
OF STRUCTURE

26'

22'

21'

20'

19'

18'

17'

16'

15'

14'

13'

12'

11'

10'

9'

8'

7'

6'

5'

4'

3'

2'

1'

0'

WEST BOUND

EAST BOUND

11
13
B
34
C-8

12
3
B
34
C-8

13
B
34
C-8

NAKAMURA, KAWABATA & ASSOC., INC.
One Kapilana Blvd., Suite 403
600 Kapilana Boulevard
Honolulu, Hawaii 96813
No. 573
EXPERIENCED PROFESSIONAL ENGINEERS



STATE OF HAWAII
DEPARTMENT OF TRANSPORTATION
HIGHWAYS DIVISION

HIGHWAY LIGHTING PLAN
INTERSTATE H-I IMPROVEMENTS
MIDDLE STREET TO KALIHI INTERCHANGE
EASTBOUND LANES

F.A.I. PROJECT NO.I -HI-I(178)

B POC Sta. 34+30


Yours sincerely,
Yoshi Nakamura

SHEET No. 10 OF SHEETS

101


ORIGINAL PLAN	STORY PLOTTED BY
NOTE BOOK	DRAWN BY
DESIGNED BY	TRADED BY
CHECKED BY	QUANTITIES BY

FED. ROAD DIST. NO.	STATE	FED. AID PROJ. NO.	FISCAL YEAR	HEET NO.	TOTAL SHEETS
HAWAII	HAW.	I -HI-I(178)	1982	102	105

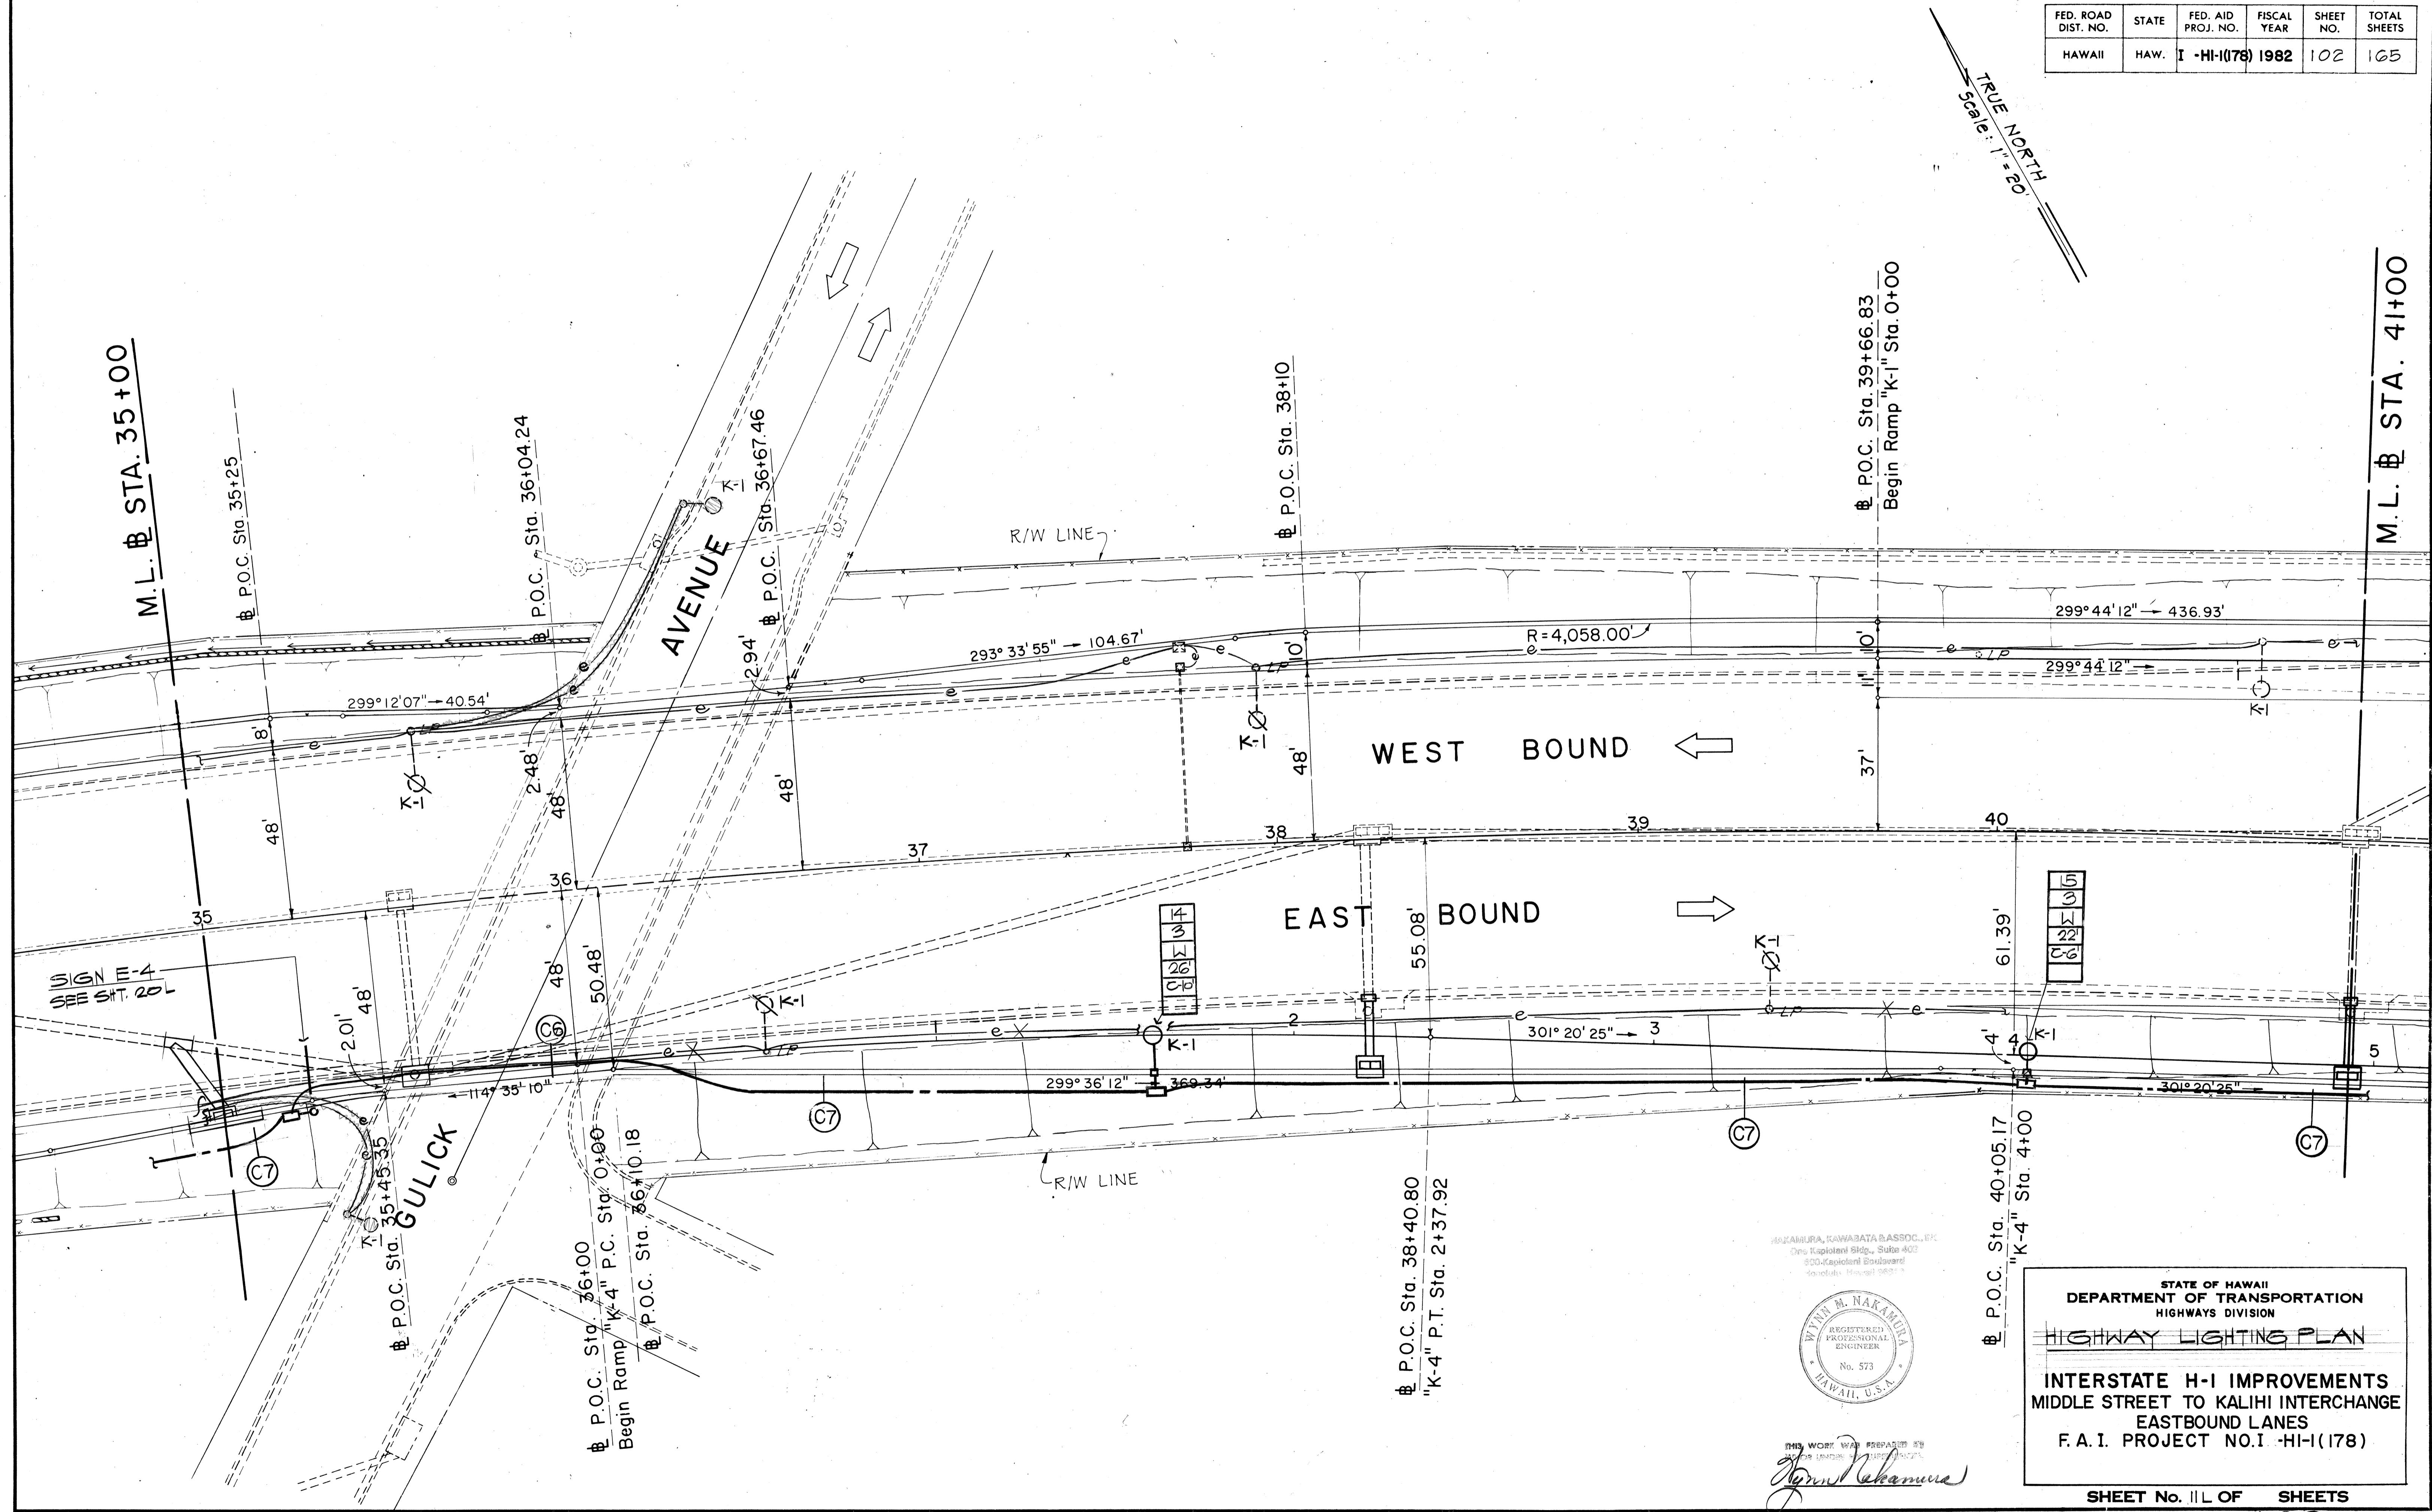

FED. ROAD DIST. NO.	STATE	FED. AID PROJ. NO.	FISCAL YEAR	SHEET NO.	TOTAL SHEETS
HAWAII	HAW.	I -HI-I(178)	1982	103	165

M.L. B STA. 41+00

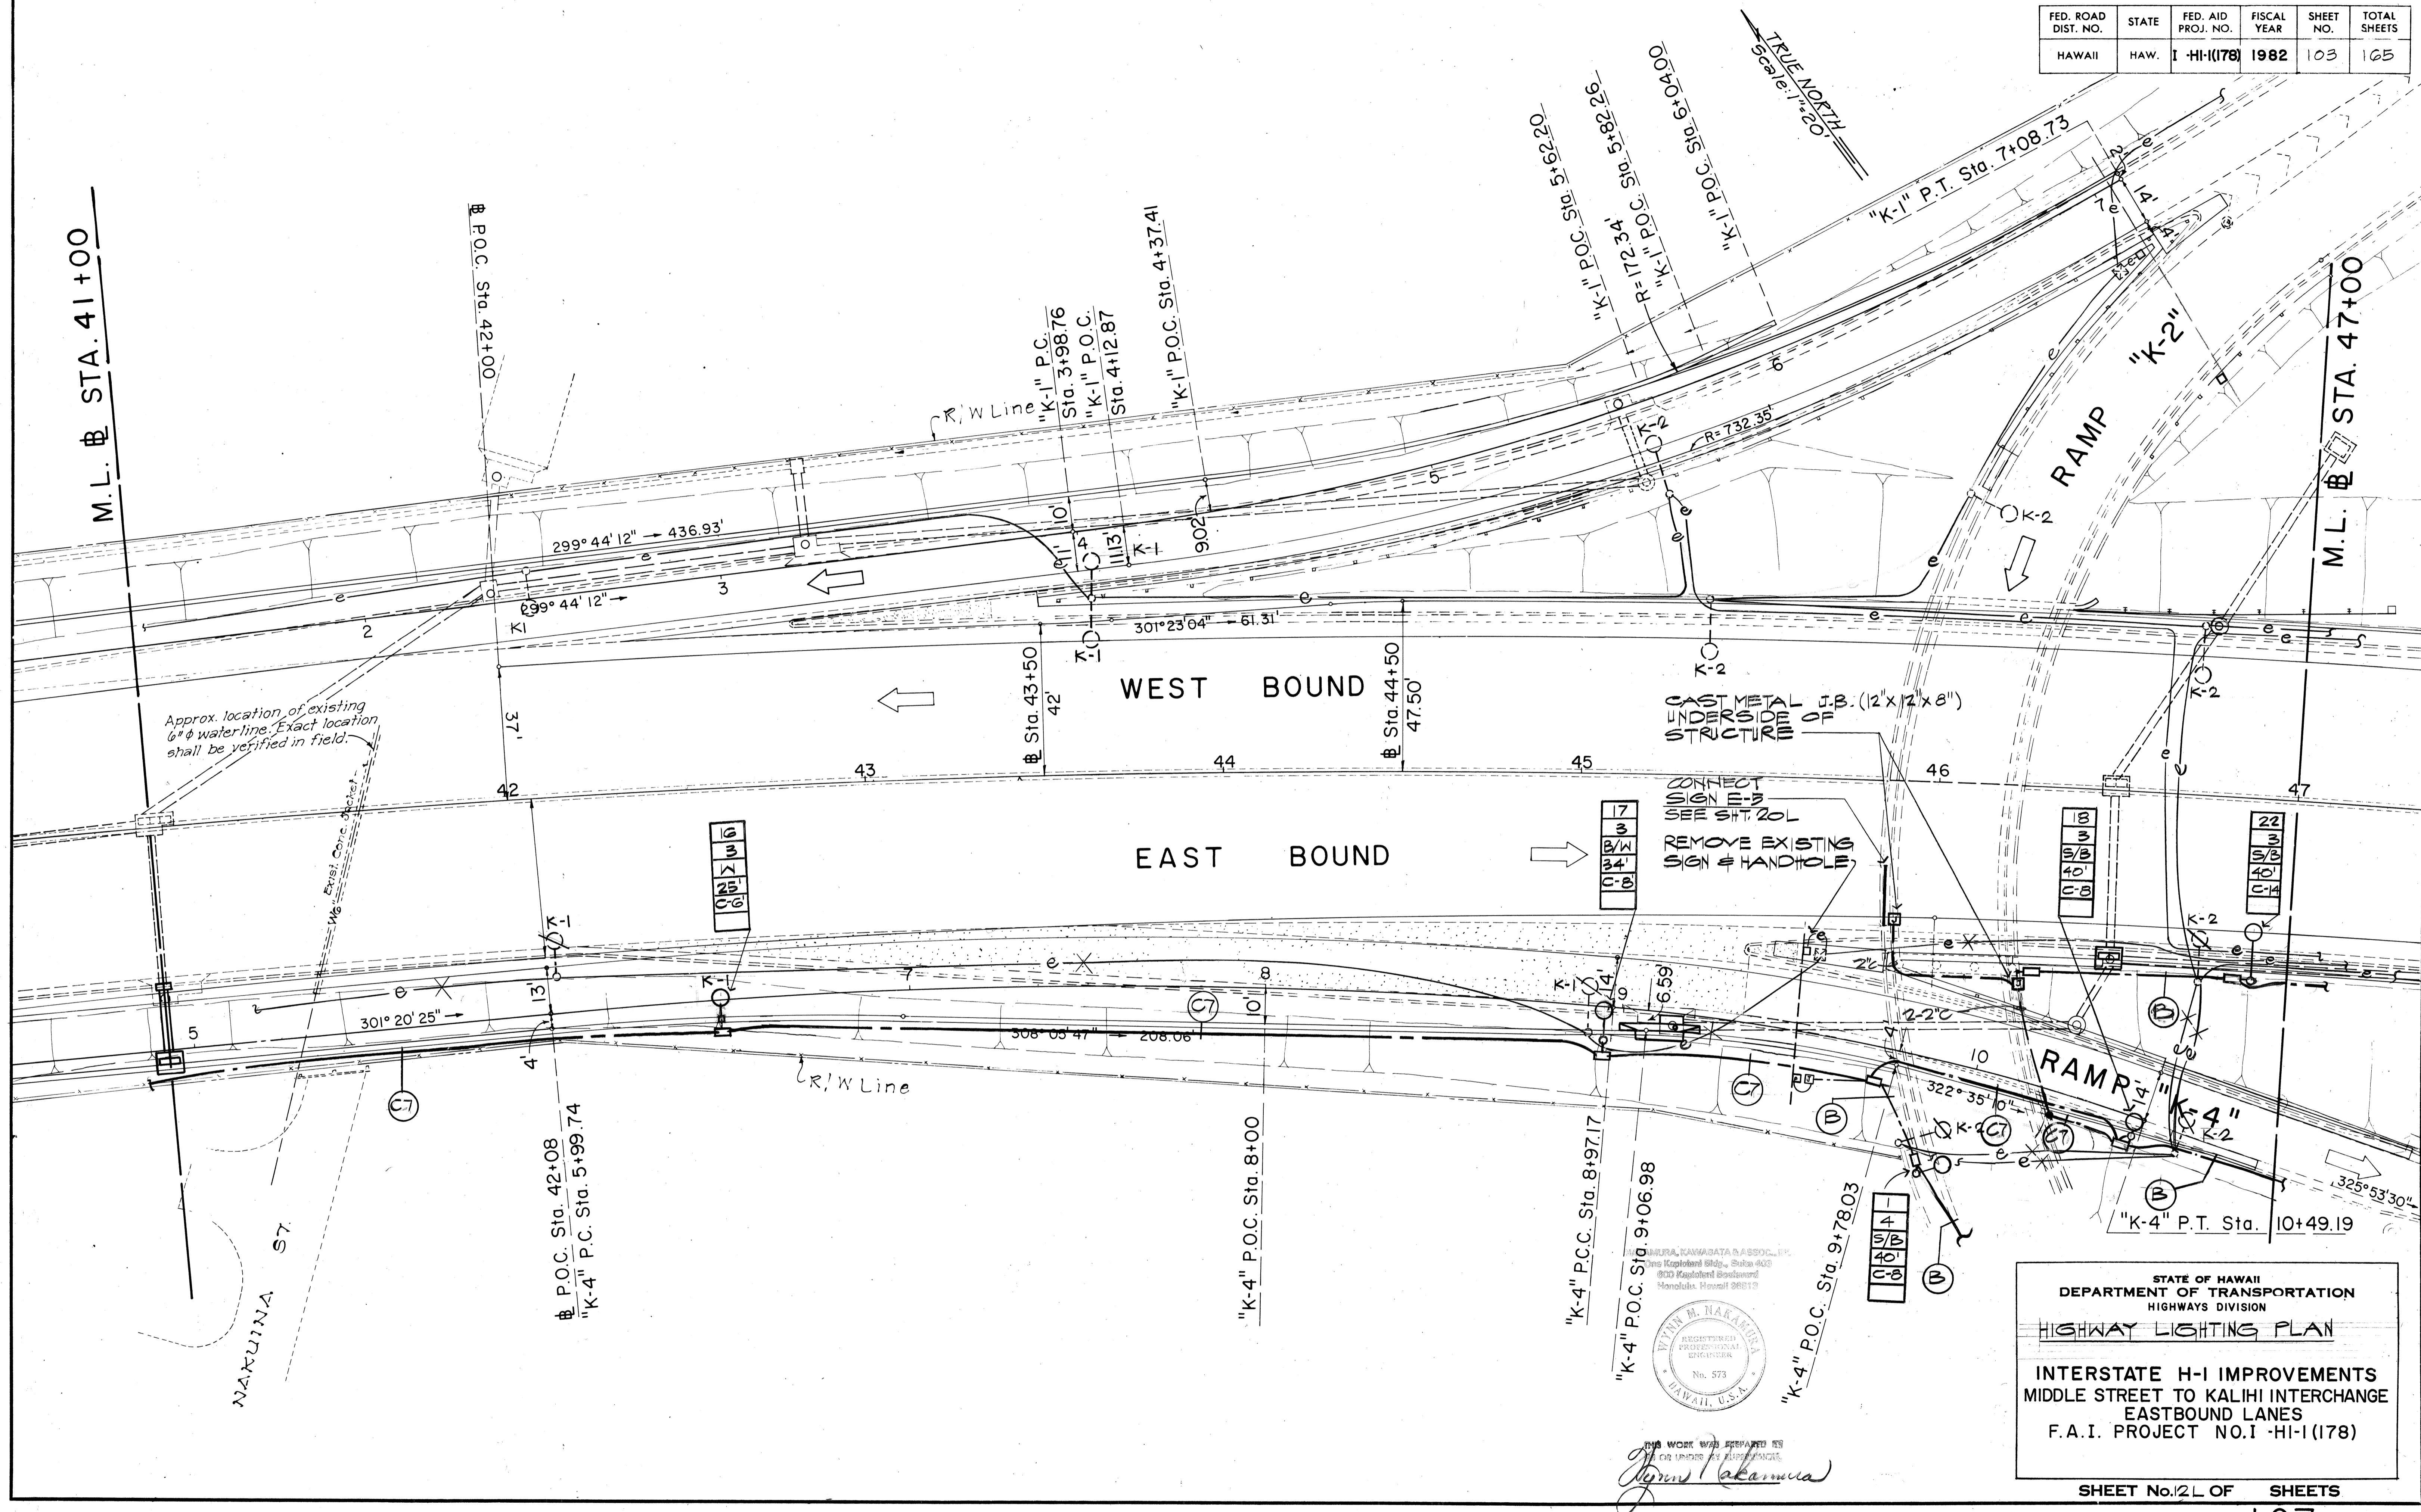


ORIGINAL PLAN	SURVEY PLOTTED BY
NOTE BOOK	DRAWN BY
No.	TRACED BY
	DESIGNED BY
	CHECKED BY

STATE OF HAWAII
DEPARTMENT OF TRANSPORTATION
HIGHWAYS DIVISION
HIGHWAY LIGHTING PLAN

INTERSTATE H-I IMPROVEMENTS
MIDDLE STREET TO KALIHI INTERCHANGE
EASTBOUND LANES
F.A.I. PROJECT NO. I-HI-I(178)


SHEET NO. 12L OF SHEETS

FED. ROAD DIST. NO.	STATE	FED. AID PROJ. NO.	FISCAL YEAR	SHEET NO.	TOTAL SHEETS
HAWAII	HAW.	I-HI-I(178)	1982	104	165

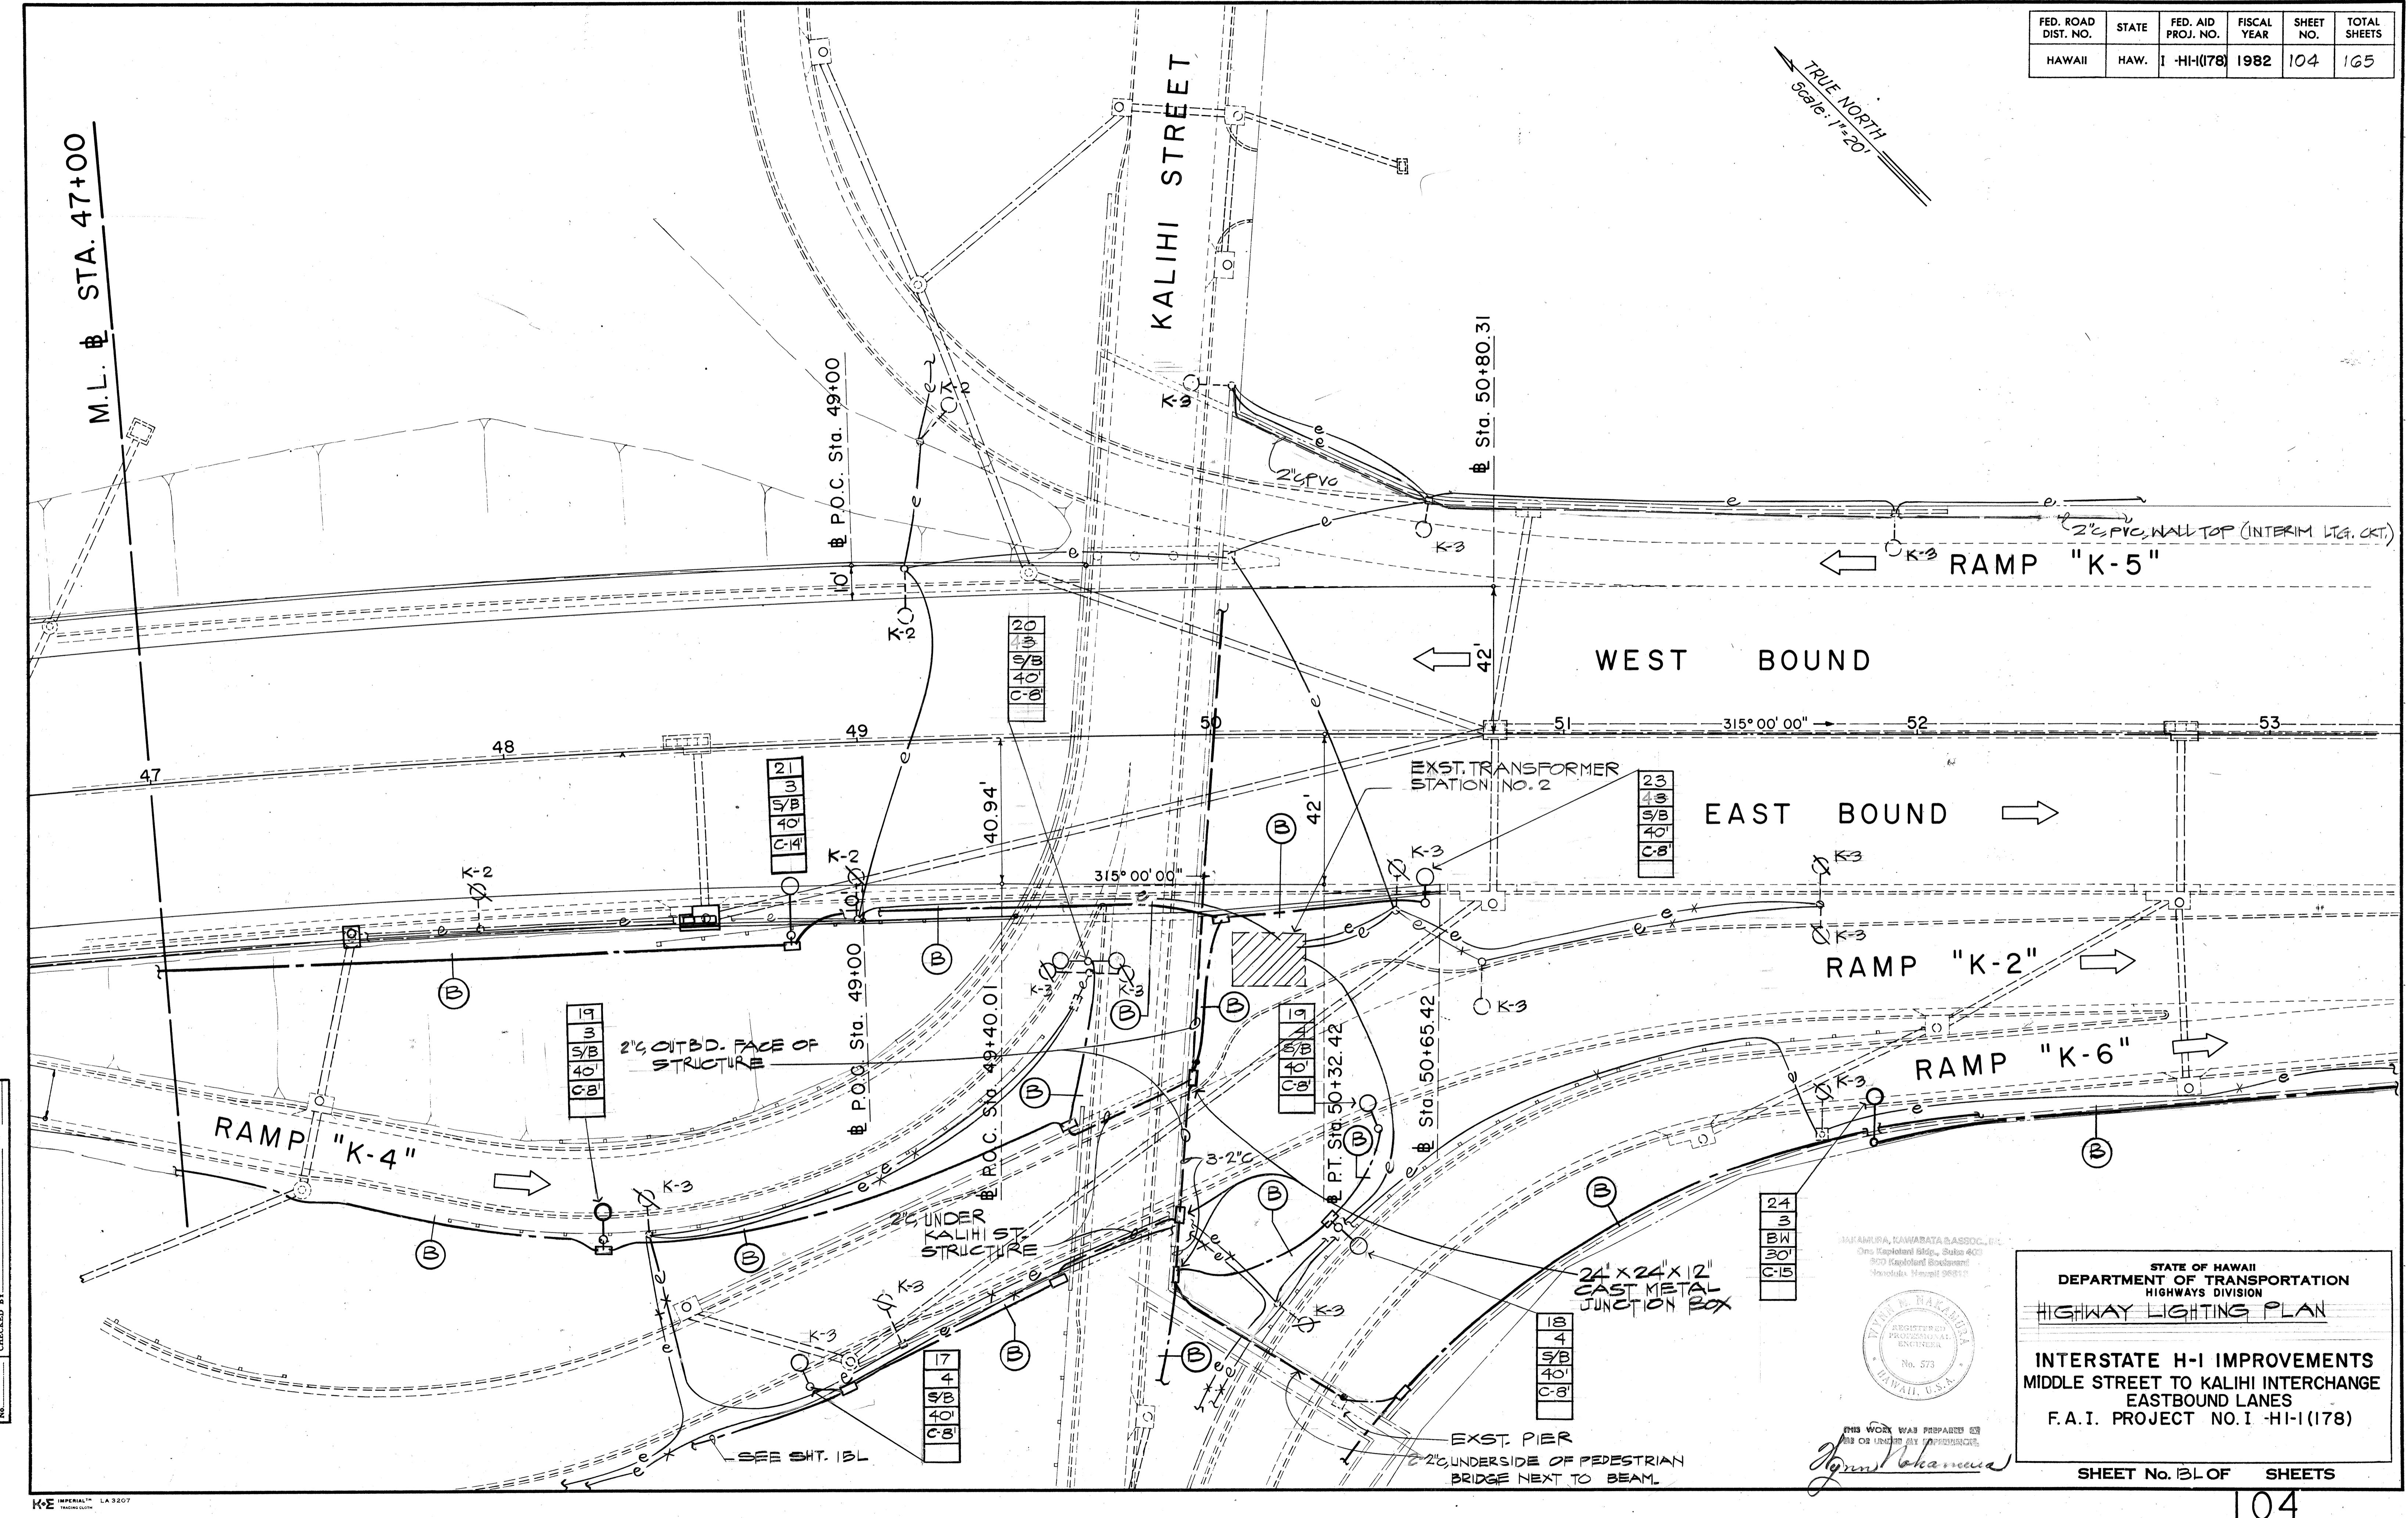

FED. ROAD DIST. NO.	STATE	FED. AID PROJ. NO.	FISCAL YEAR	SHEET NO.	TOTAL SHEETS
HAWAII	HAW.	I -HI-I(178)	1982	105	165

TRUE SCALE = 1" = 50'

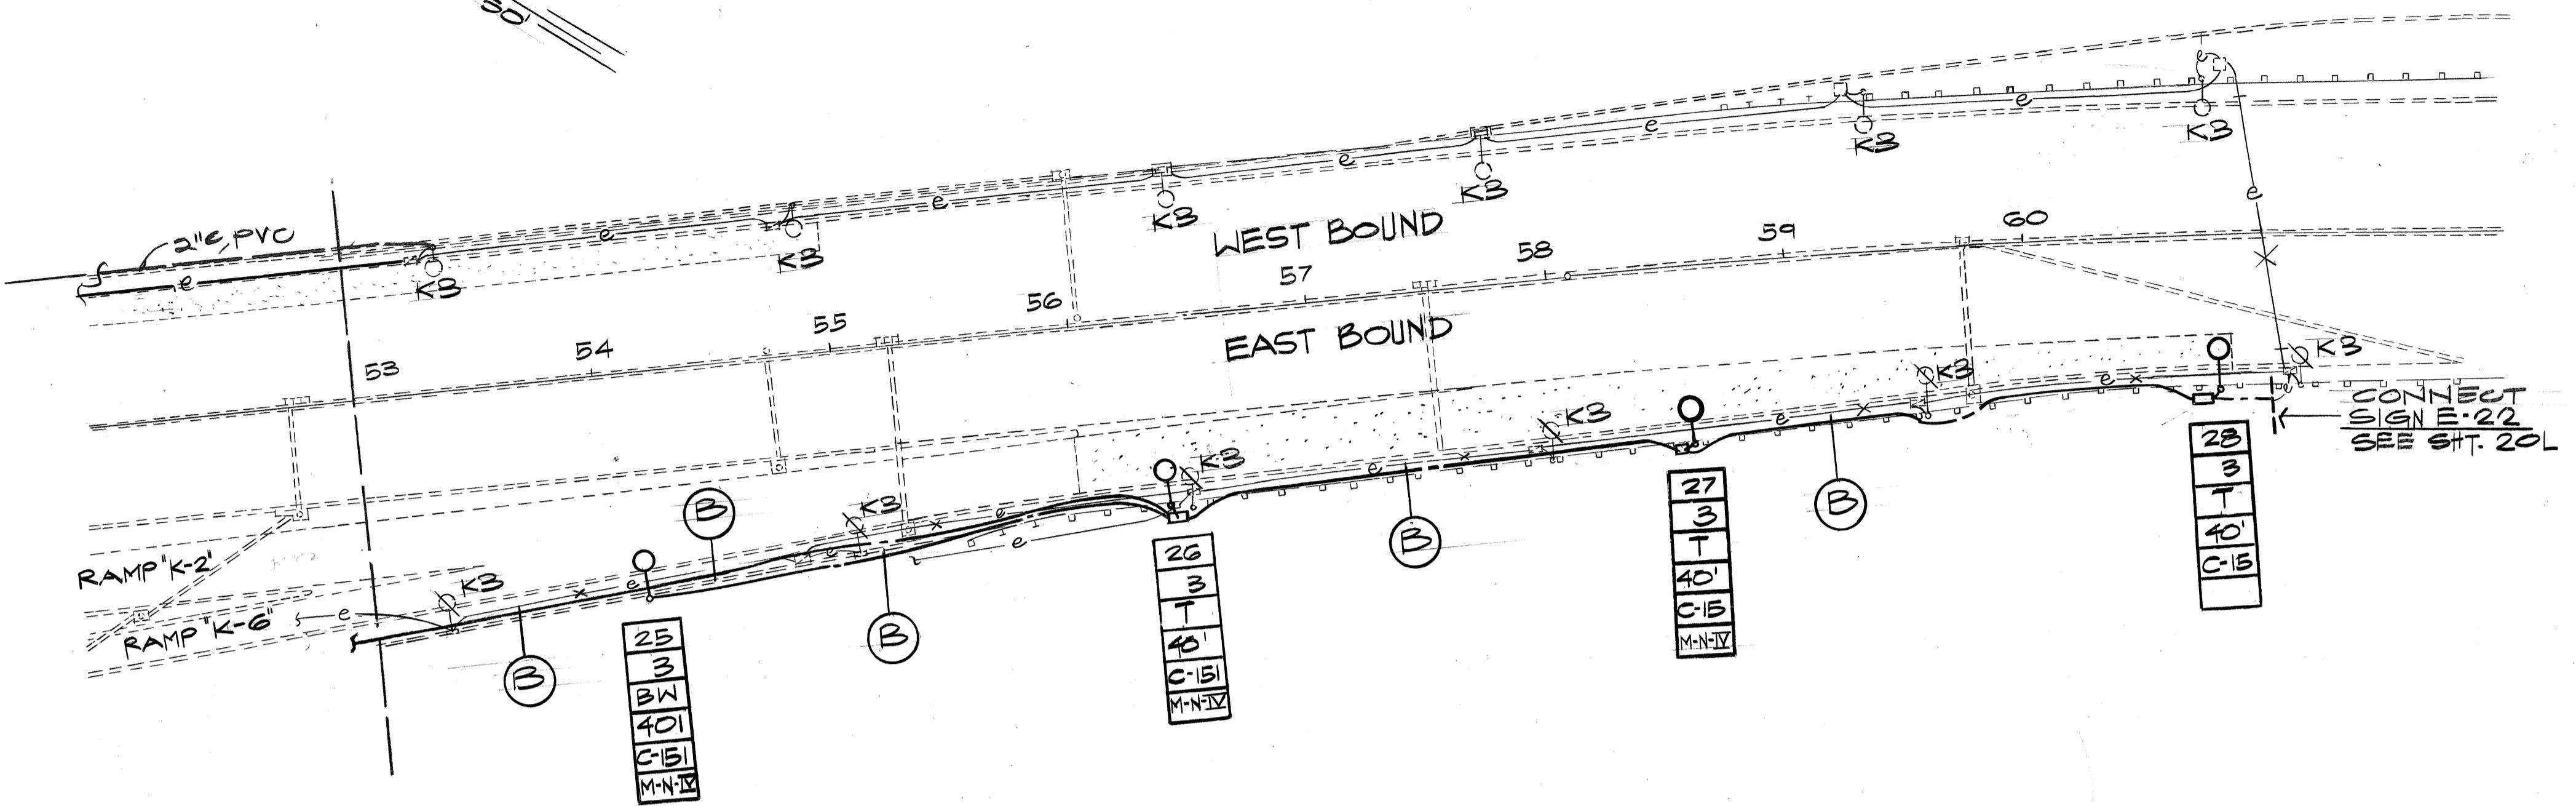

ORIGINAL SURVEY PLOTTED BY	DATE
DRAWN BY	
TRADED BY	
DESIGNED BY	
QUALIFIED BY	
NOTE BOOK	
NO.	
CHEMIST BY	

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One Kapolei Plaza, Suite 403
900 Kapolei Boulevard
Honolulu, Hawaii 96813



THIS WORK WAS PREPARED BY
ME OR UNDER MY SUPERVISION.


Wen Nakamura

STATE OF HAWAII
DEPARTMENT OF TRANSPORTATION
HIGHWAYS DIVISION
HIGHWAY LIGHTING PLAN
(I-1 EAST OF KALIHI INTERCHANGE)
INTERSTATE I-1 IMPROVEMENTS
MIDDLE STREET TO KALIHI INTERCHANGE
EASTBOUND LANES
F.A.I. PROJECT NO. I -HI-I(178)

SHEET NO. 14 OF 16 SHEETS


105

FED. ROAD DIST. NO.	STATE	FED. AID PROJ. NO.	FISCAL YEAR	SHEET NO.	TOTAL SHEETS
HAWAII	HAW.	I - HI-I(I78)	1982	106	165

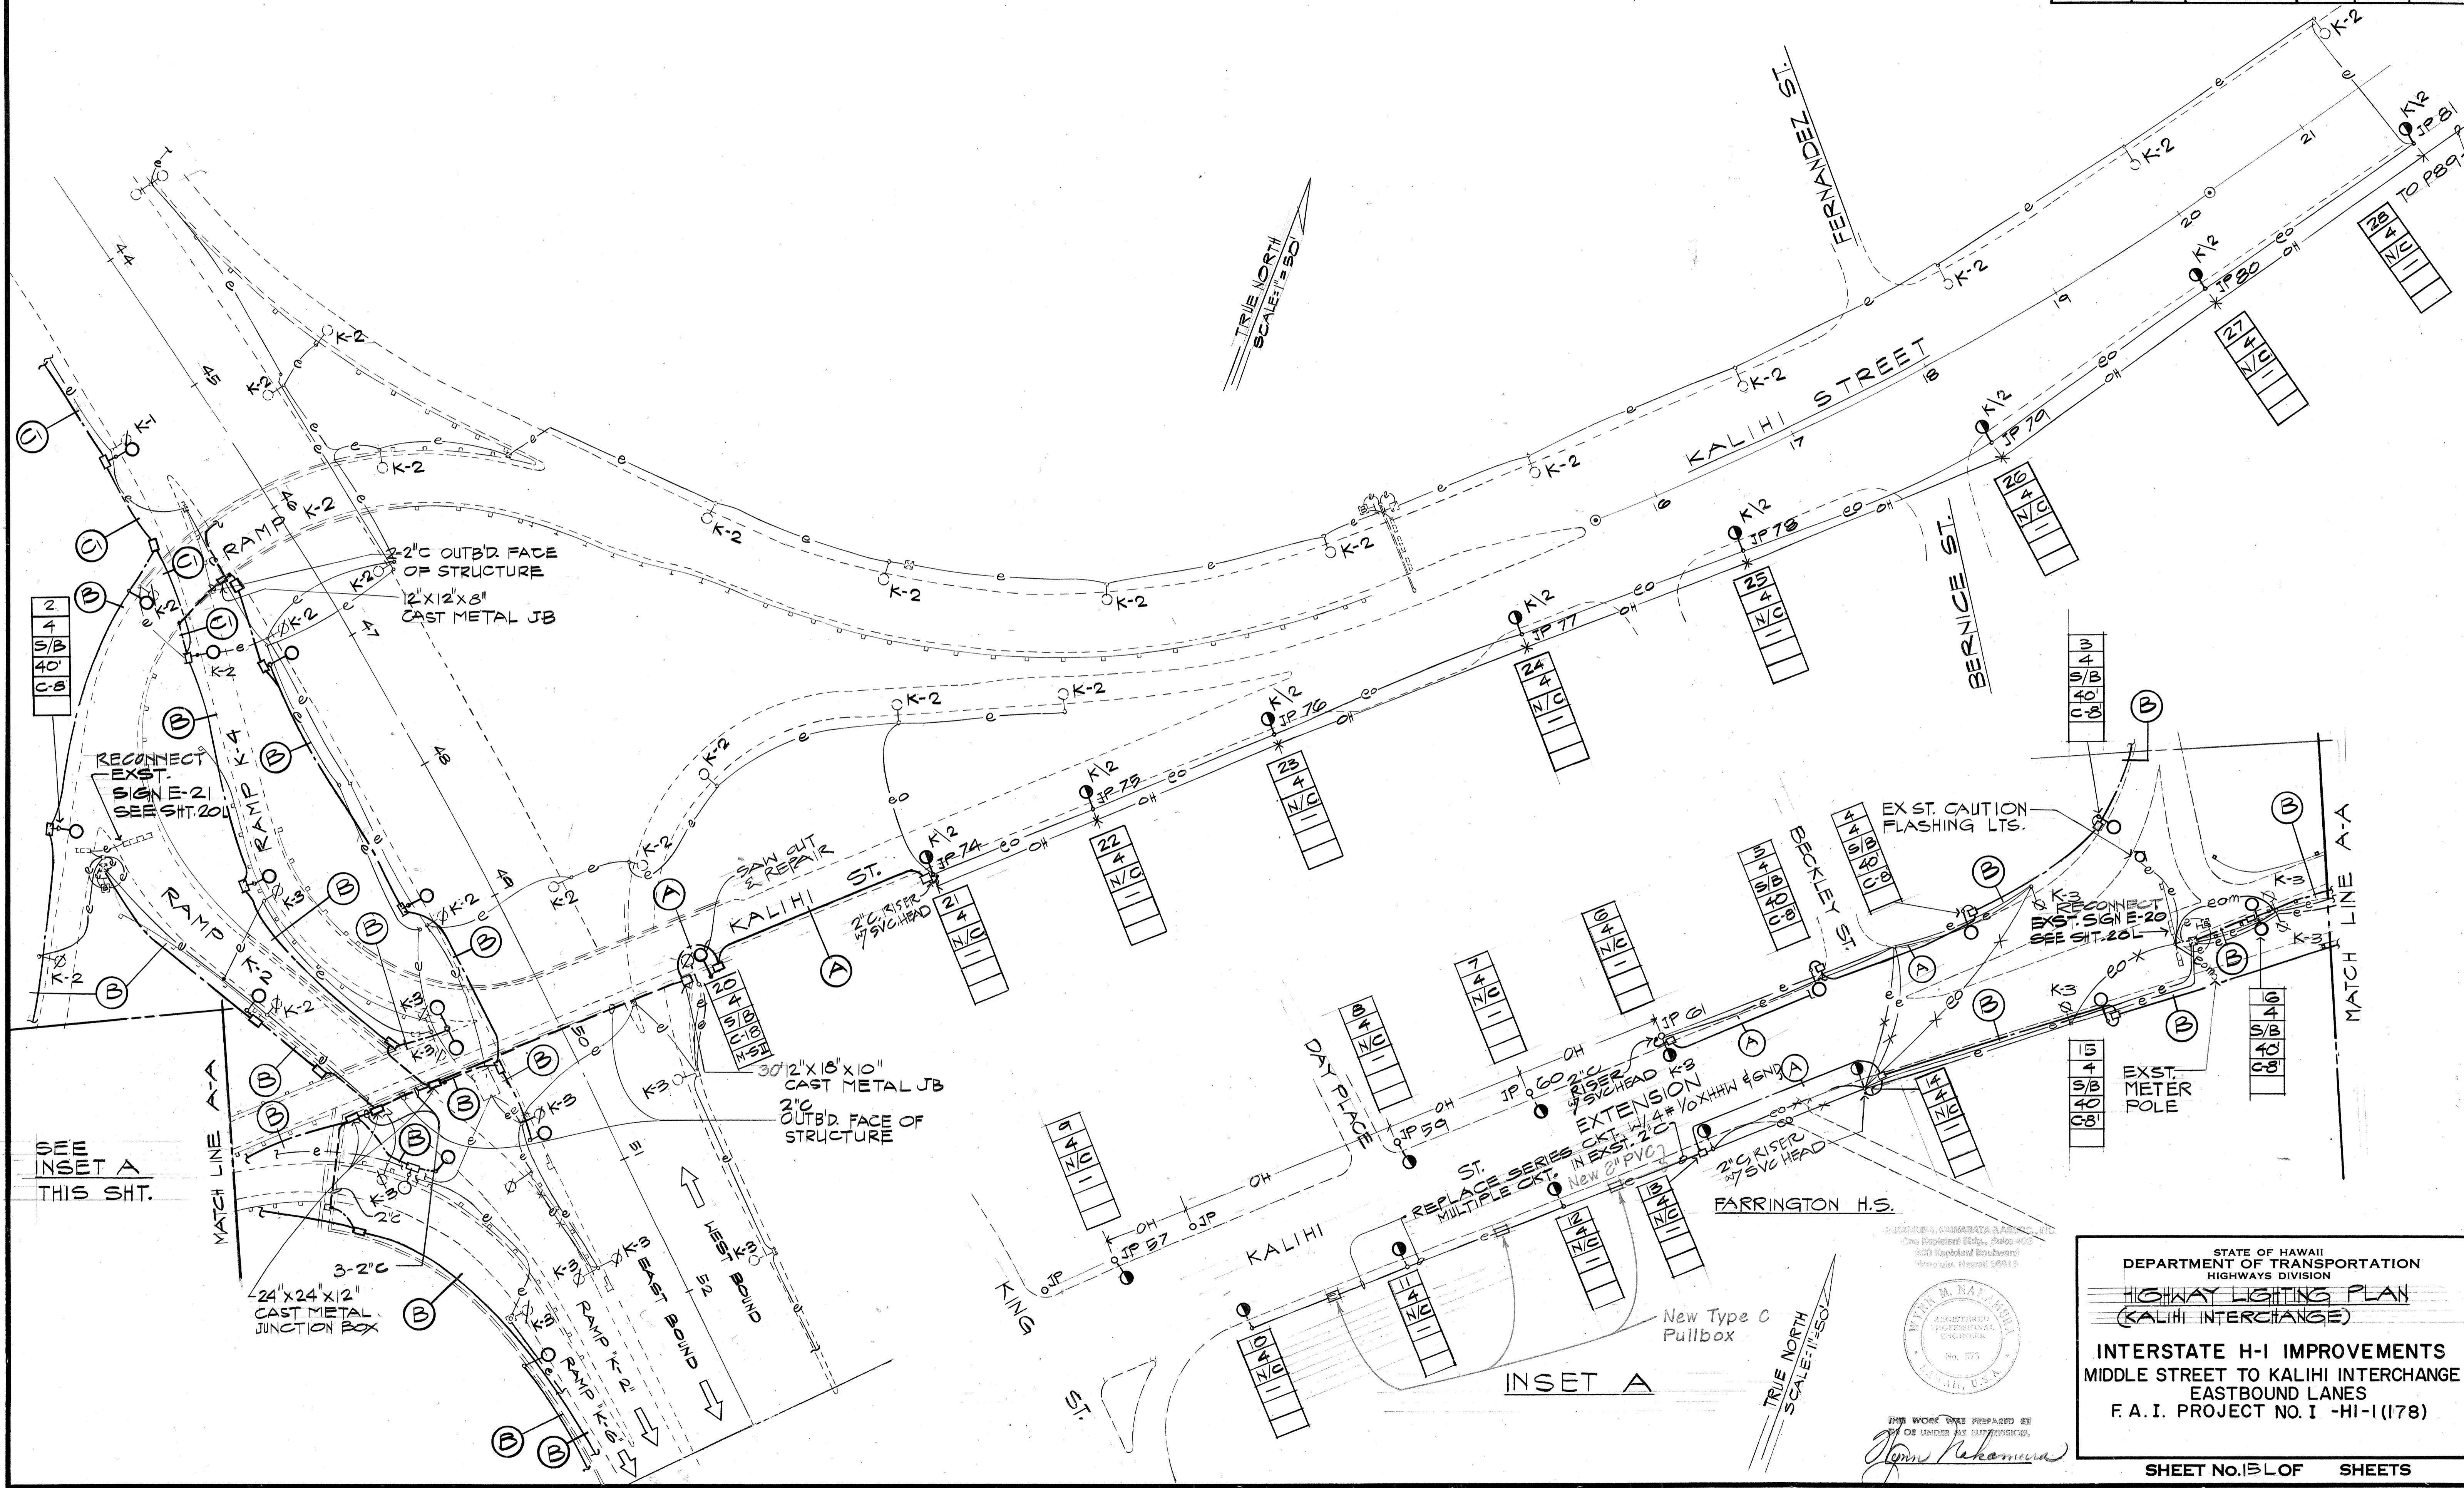


ORIGINAL SURVEY PLOTTED BY _____
DRAWN BY _____
TRACED BY _____
DESIGNED BY _____
QUANTITIES BY _____
CHECKED BY _____
NOTE BOOK No. _____

FED. ROAD DIST. NO.	STATE	FED. AID PROJ. NO.	FISCAL YEAR	SHEET NO.	TOTAL SHEETS
HAWAII	HAW.	I - HI-1(I78)	1982	107	165

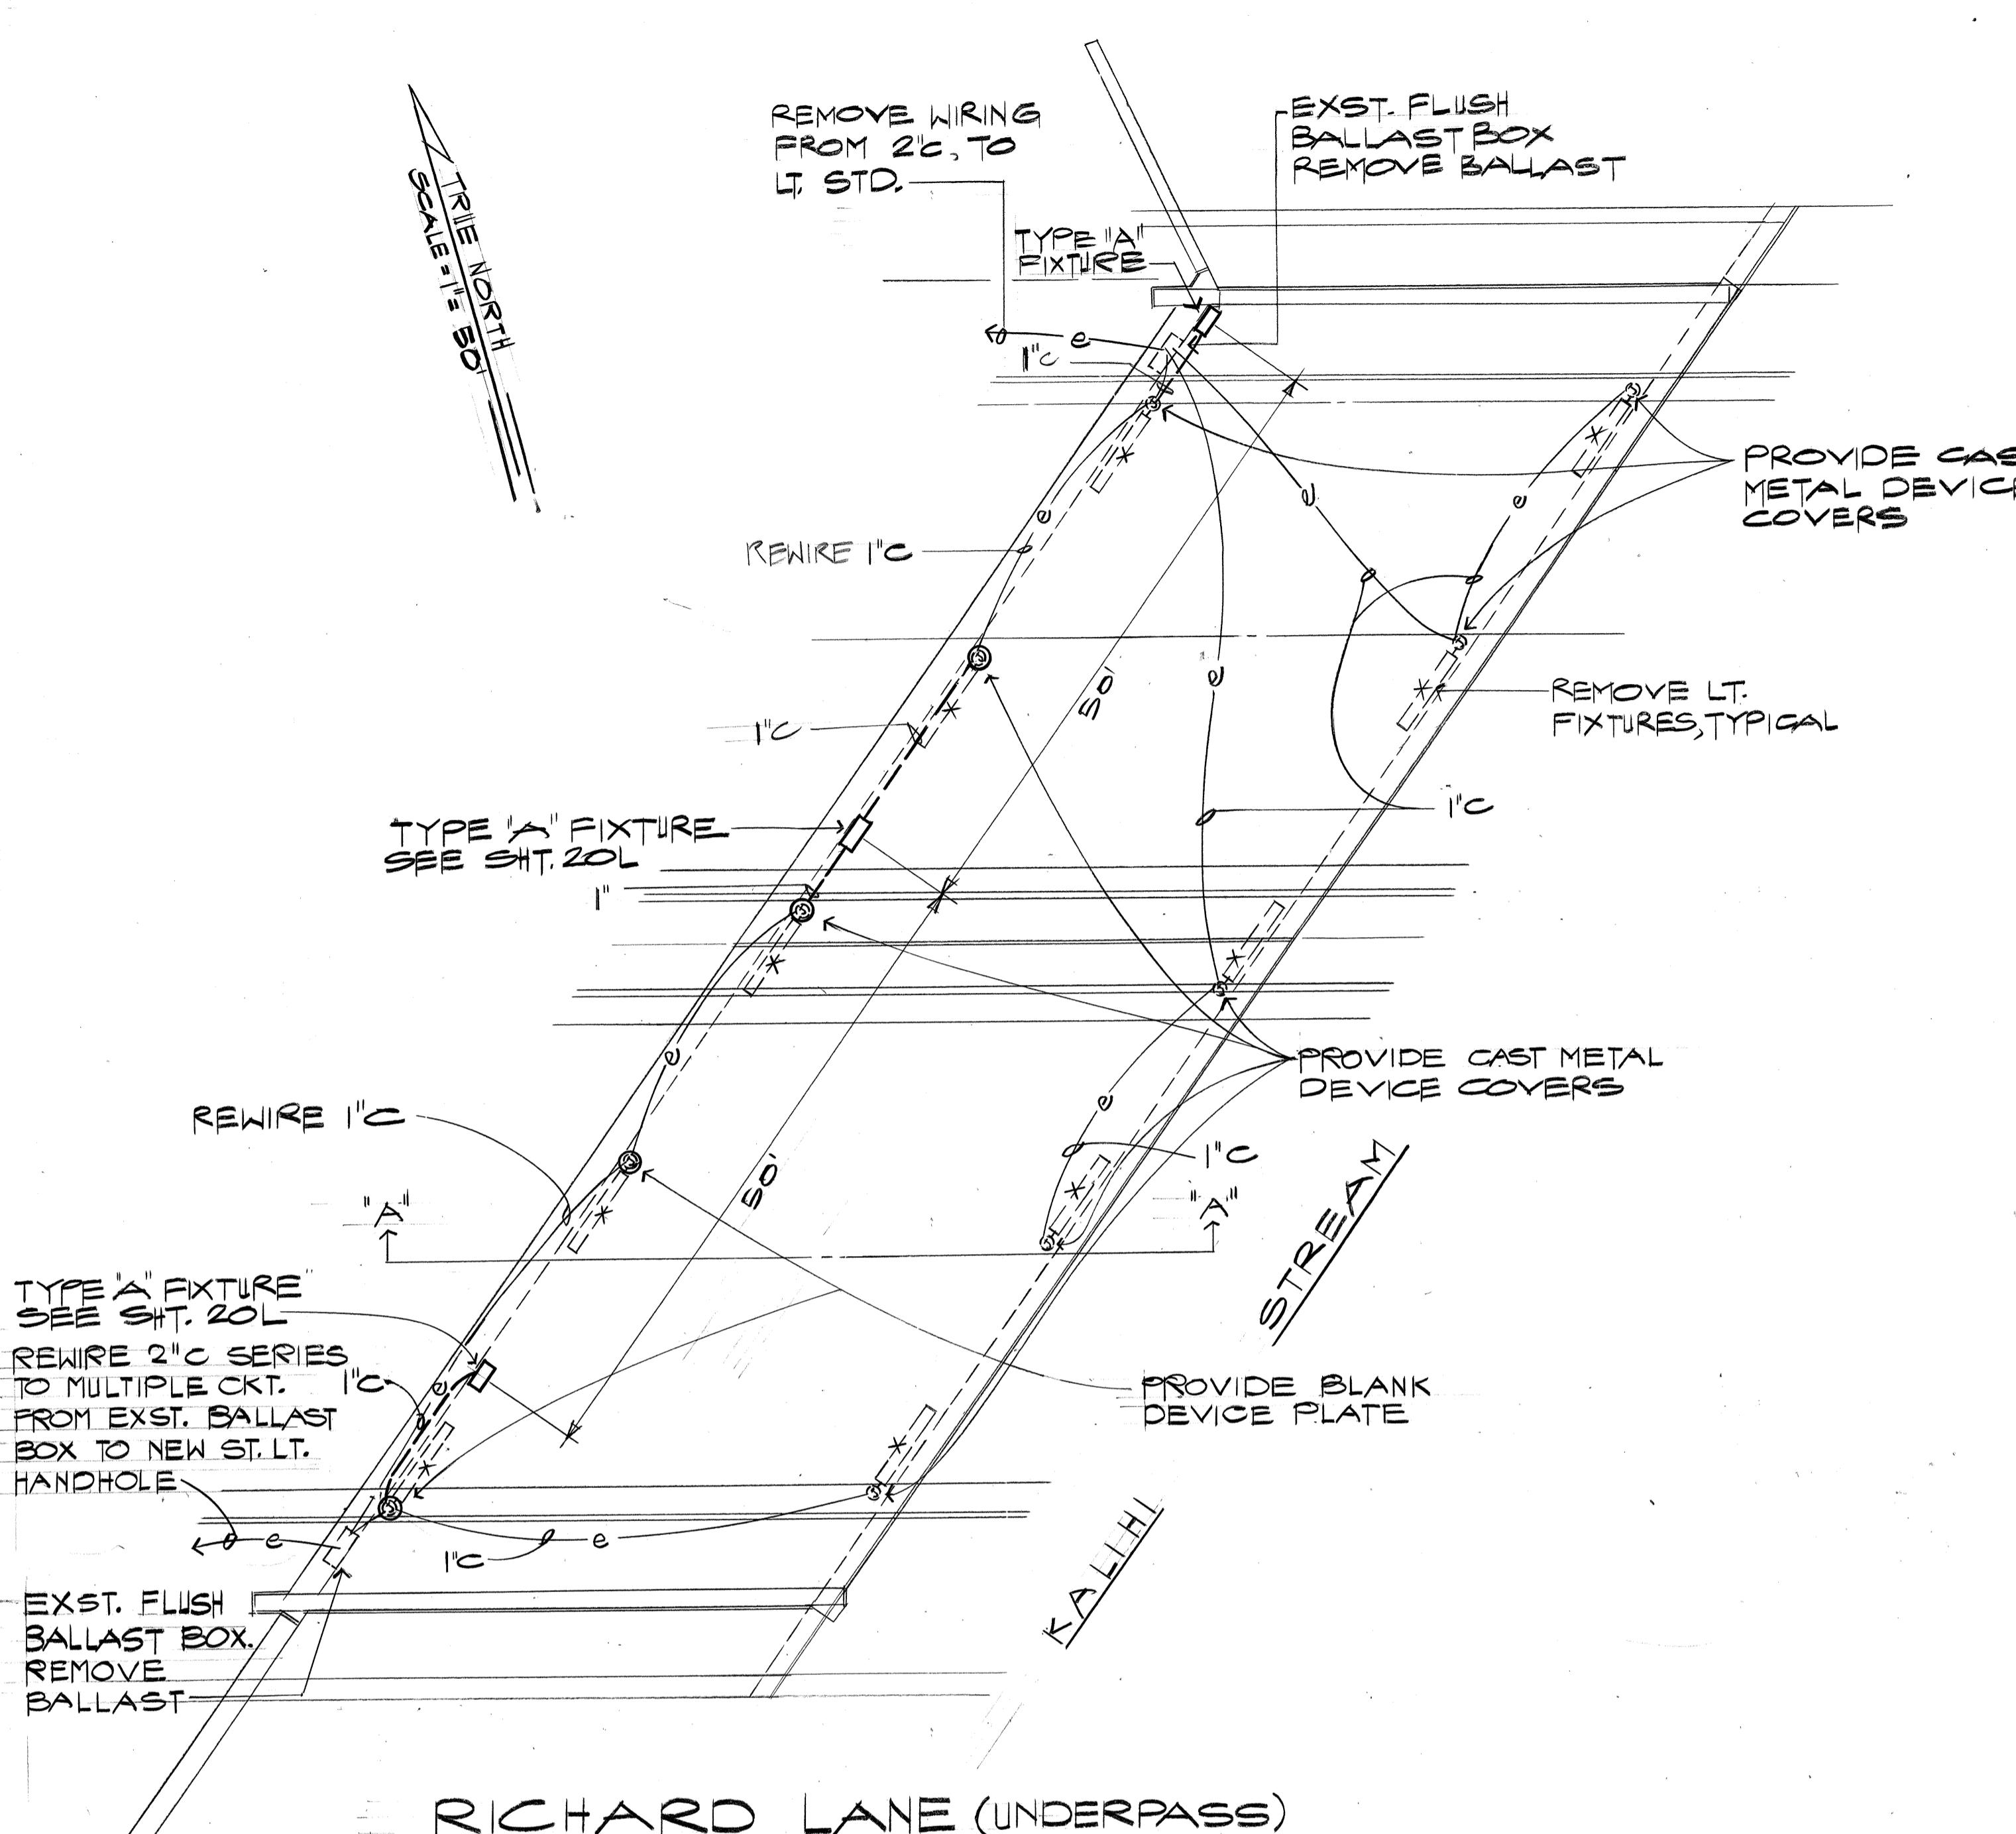


RICHARD LANE (UNDERPASS)
LIGHTING PLAN
SCALE: 1" = 10'-0"


ORIGINAL SURVEY PLOTTED BY DIA OWN R/T
DESIGNED BY TWT
CHECKED BY TWT
NOTE BOOK No.
PLAN

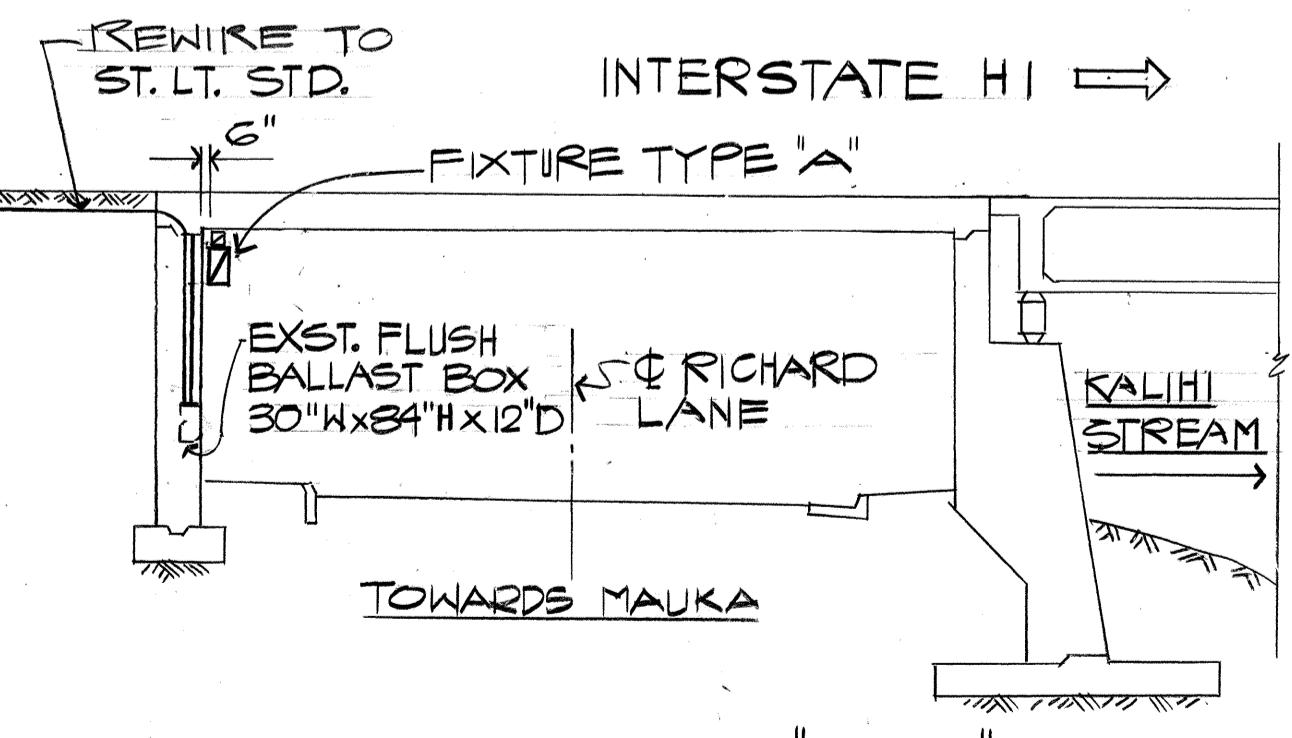

SECTION A-A
SC. 1" = 10'

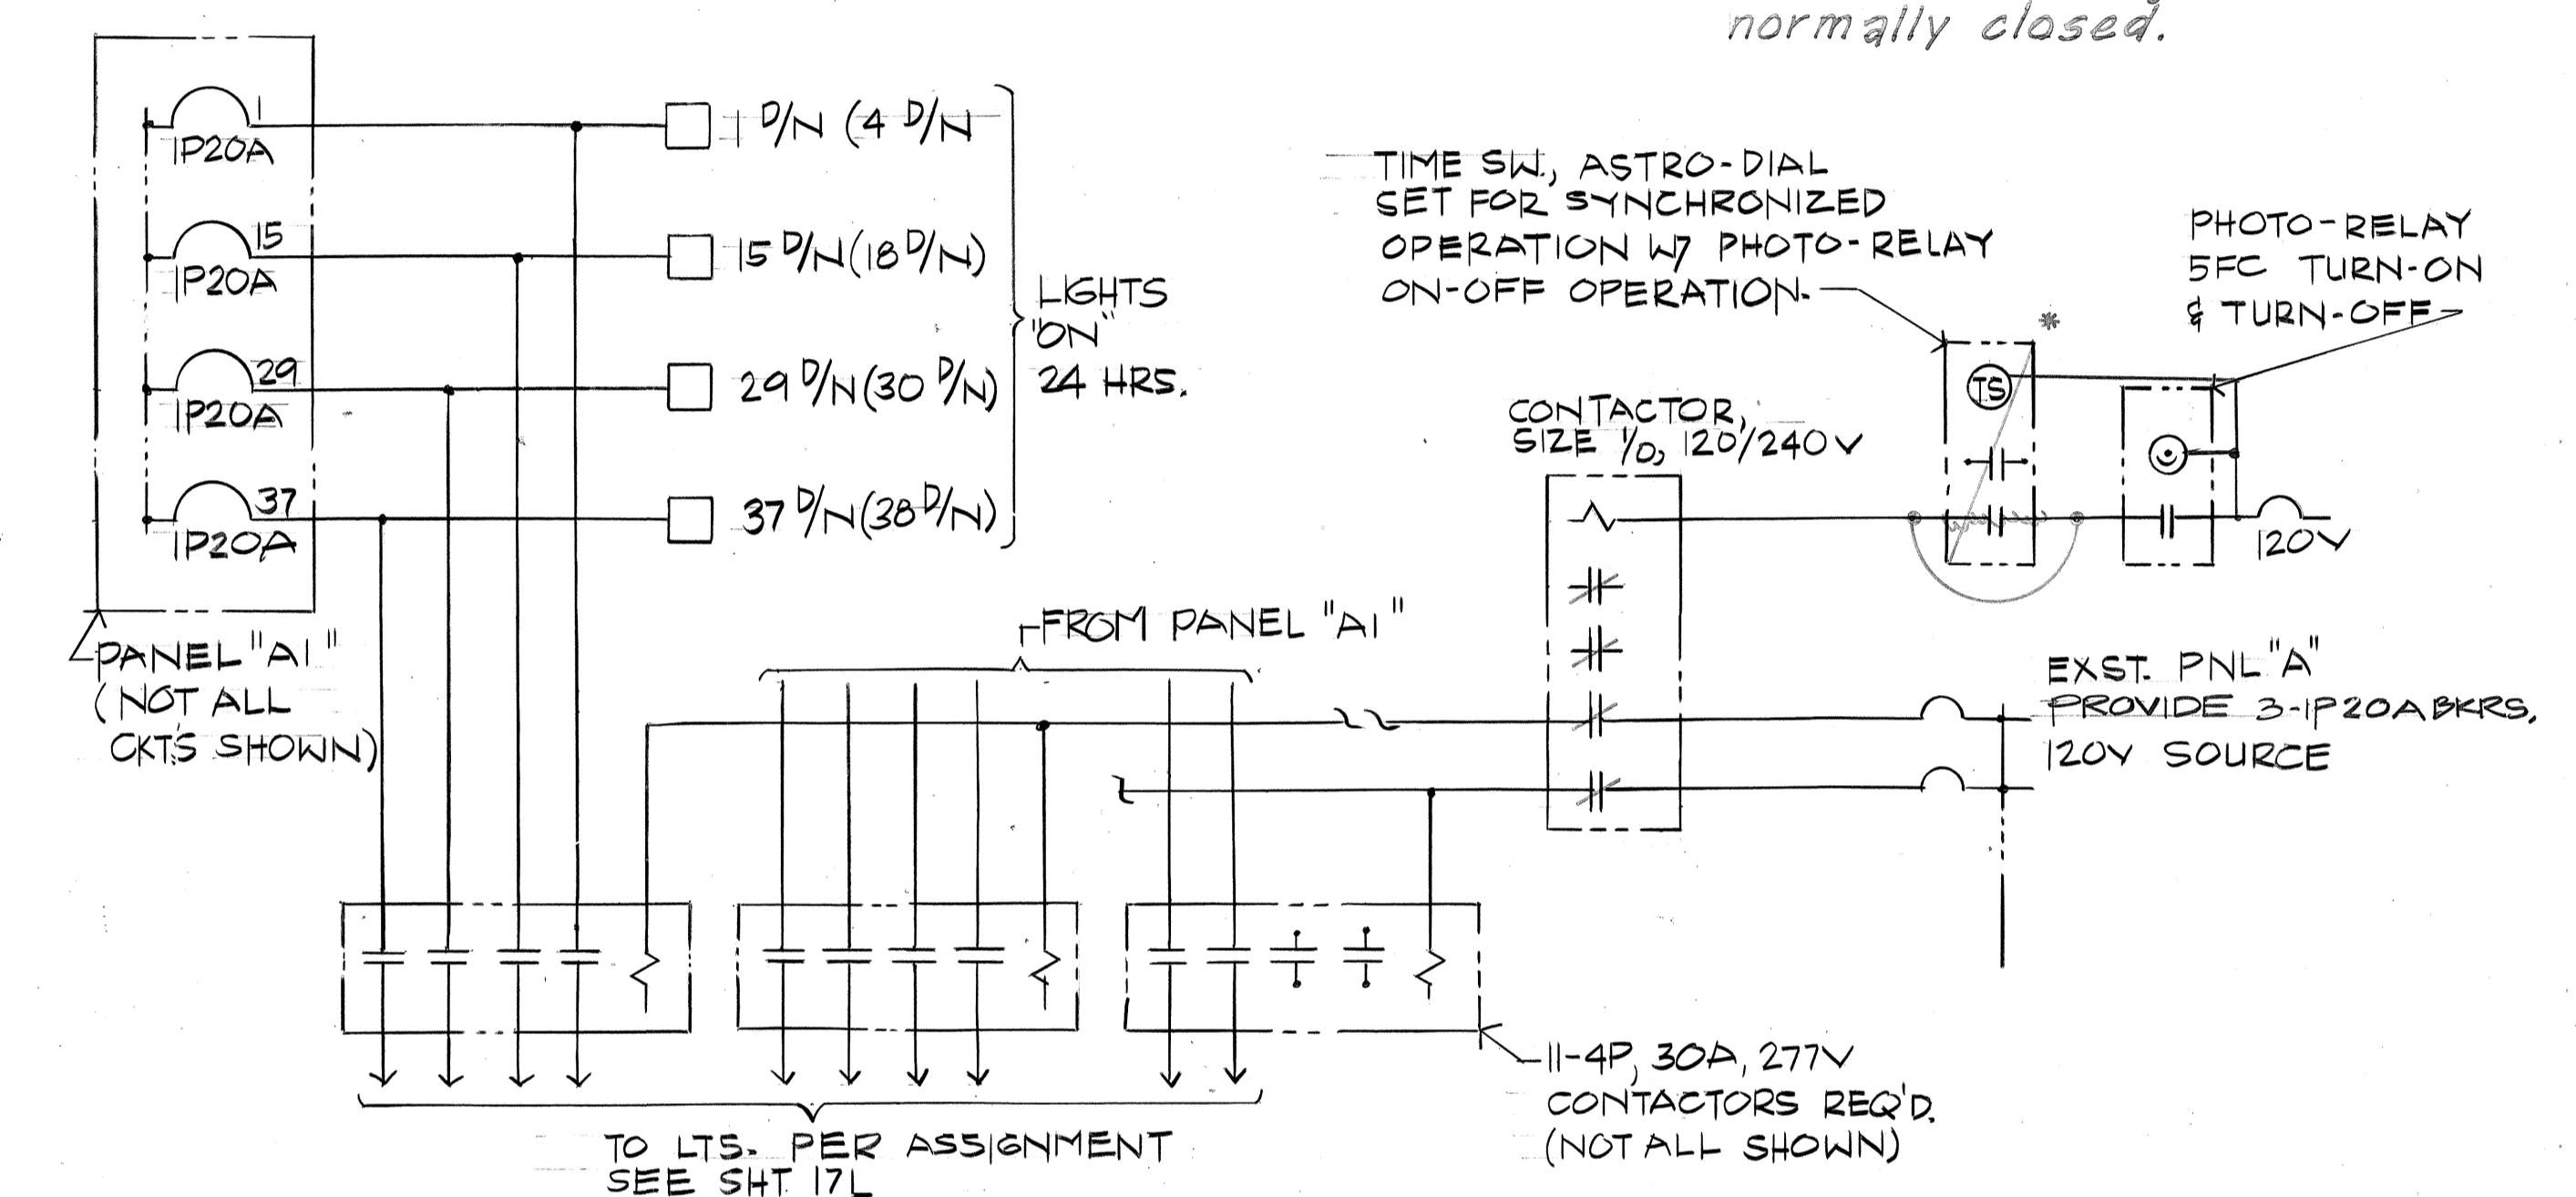

TUNNEL
RAMPS "M" STRUCTURE
LIGHTING CONTROL

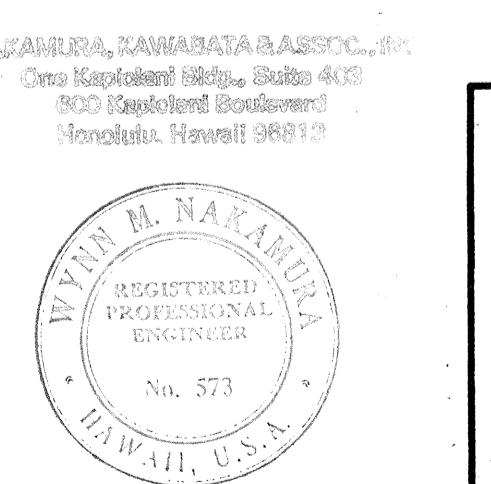

THIS WORK WAS PREPARED BY
OR UNDER MY SUPERVISION


William M. Nakamura

STATE OF HAWAII
DEPARTMENT OF TRANSPORTATION
HIGHWAYS DIVISION
KALIHI STREAM BRIDGE
(RICHARD LANE)
INTERSTATE H-I IMPROVEMENTS
MIDDLE STREET TO KALIHI INTERCHANGE
EASTBOUND LANES
F.A.I. PROJECT NO. I - HI-1(I78)



SHEET NO. 16 OF 16 SHEETS

107


FED. ROAD DIST. NO.	STATE	FED. AID PROJ. NO.	FISCAL YEAR	SHEET NO.	TOTAL SHEETS
HAWAII	HAW.	I - HI-1(178)	1982	108	165

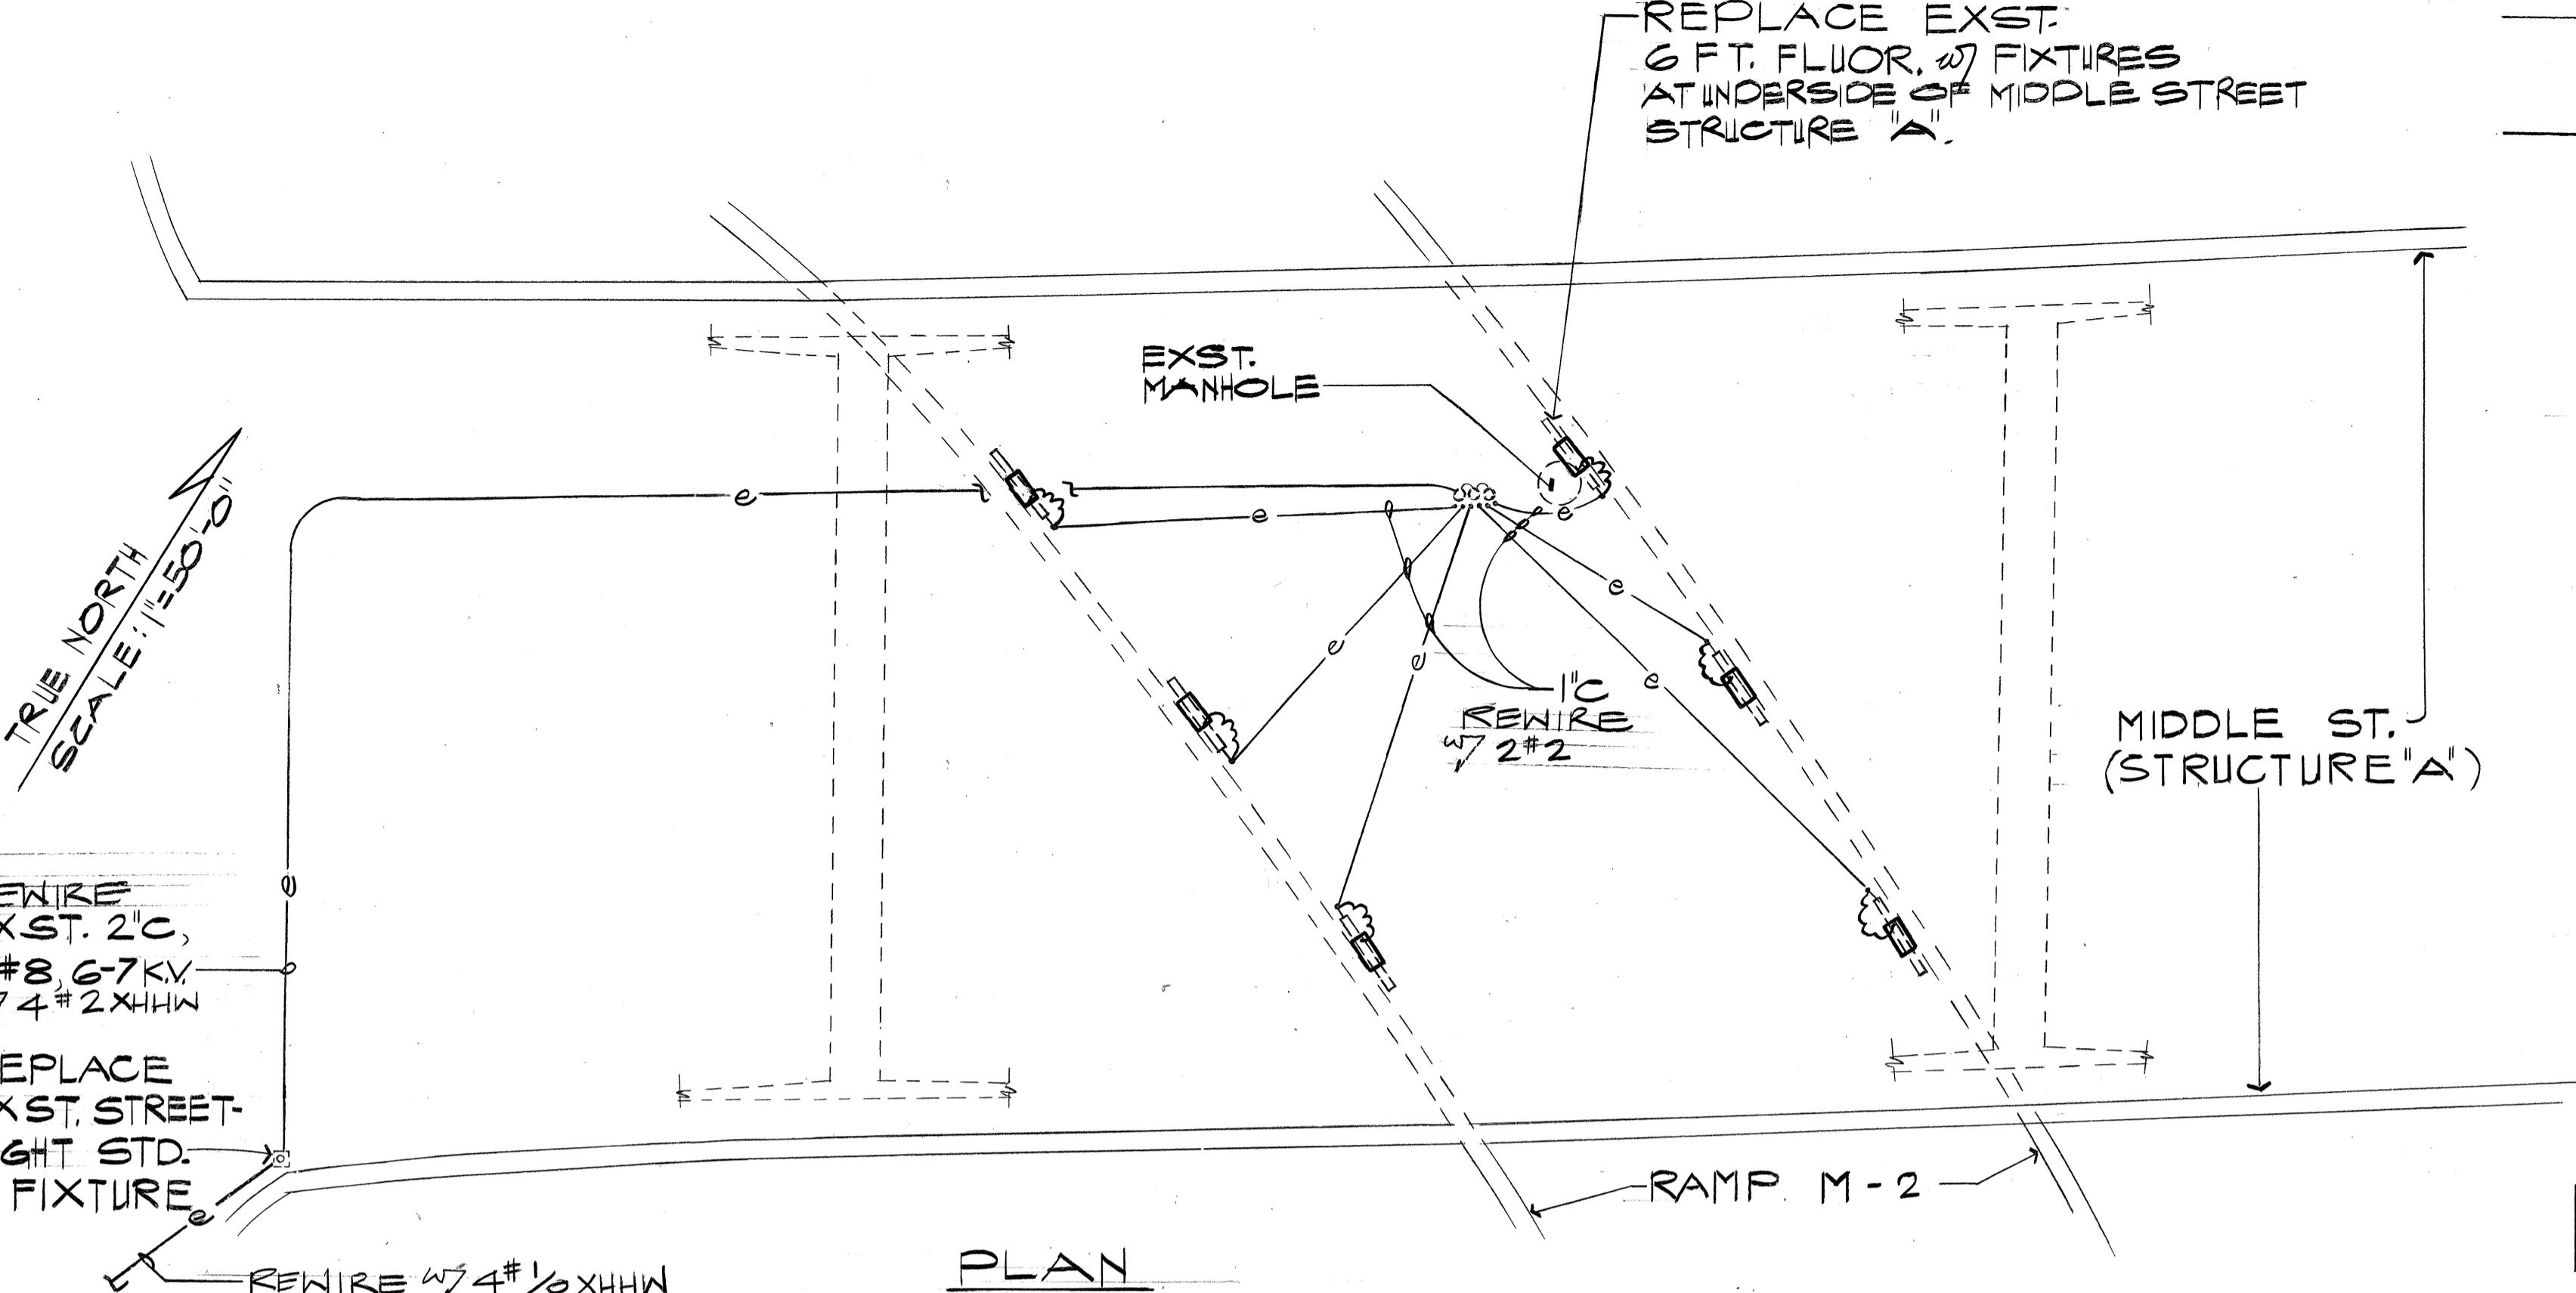

PLAN

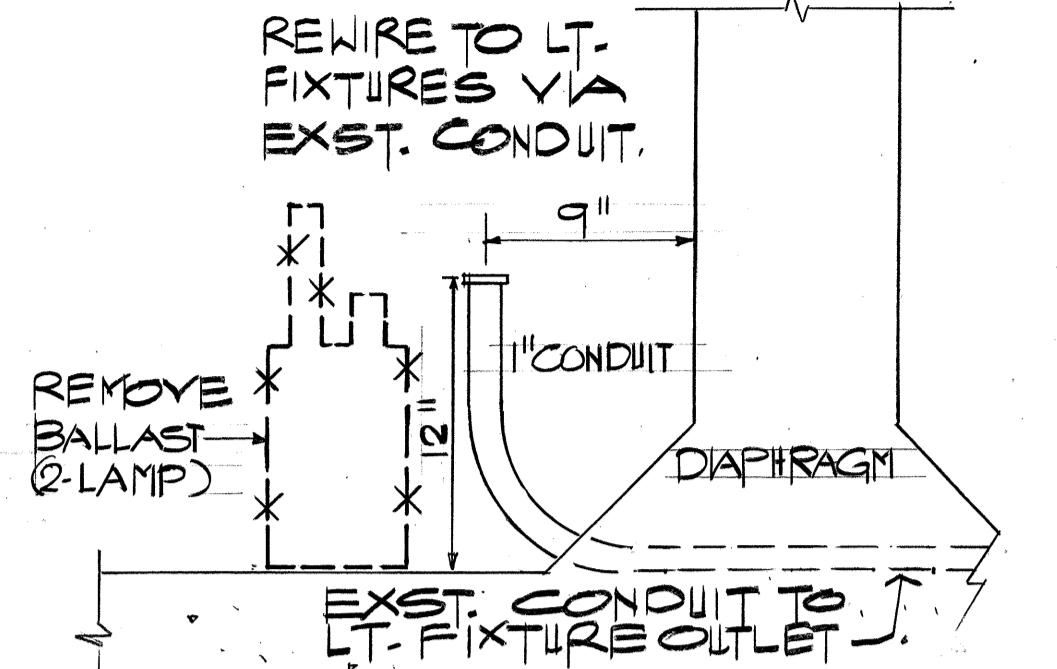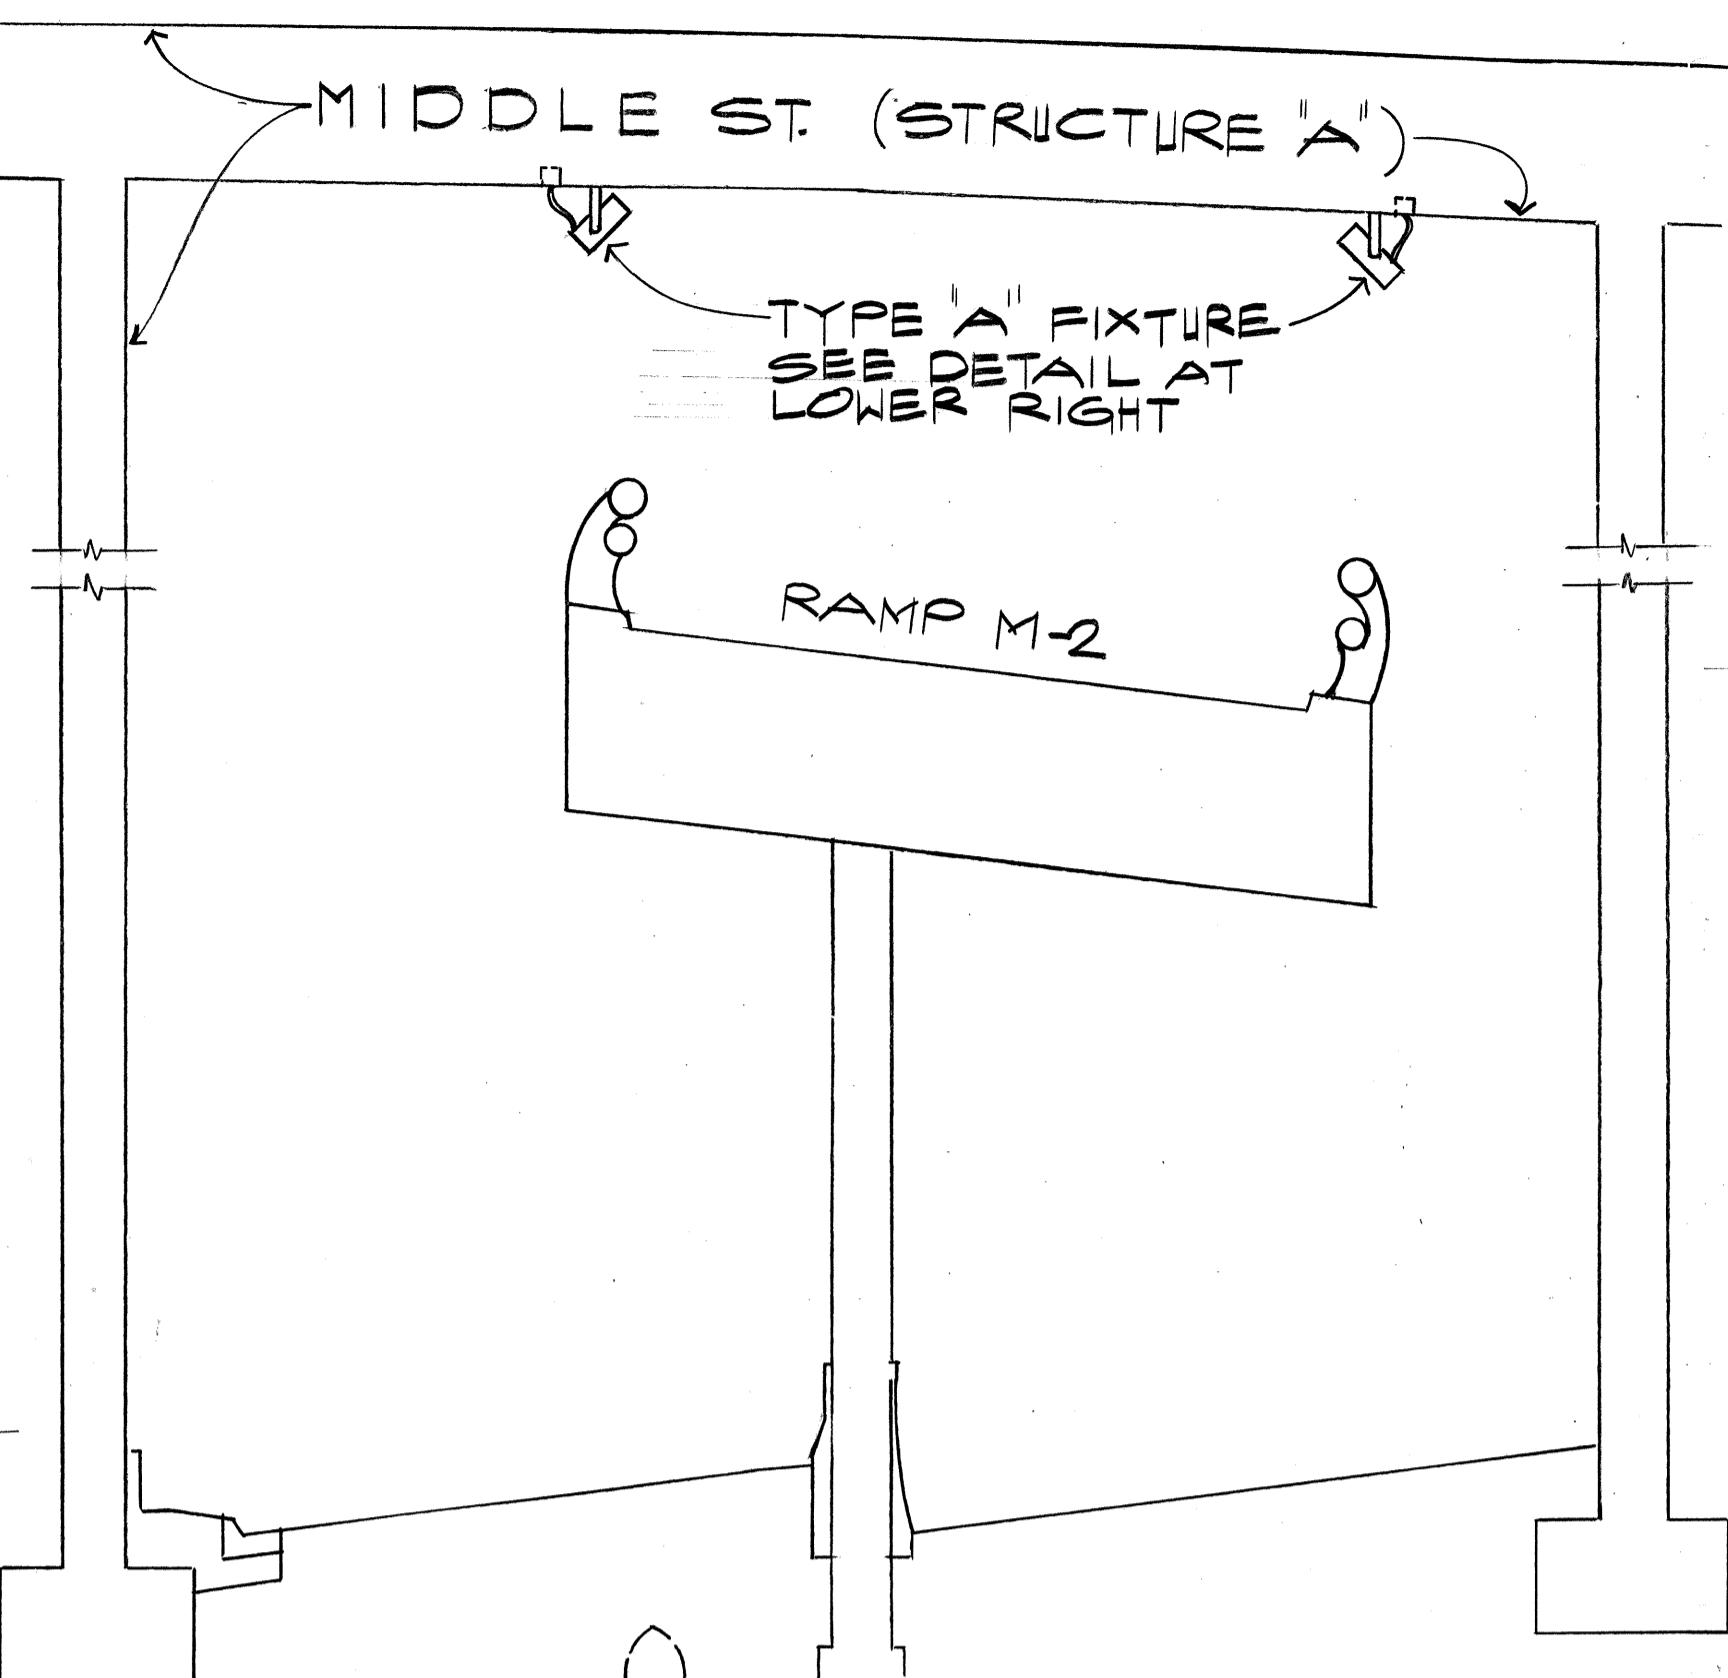

REMOVE EXST. BALLAST IN STRUCTURE CELL
SCALE: 1/2" = 1'-0"

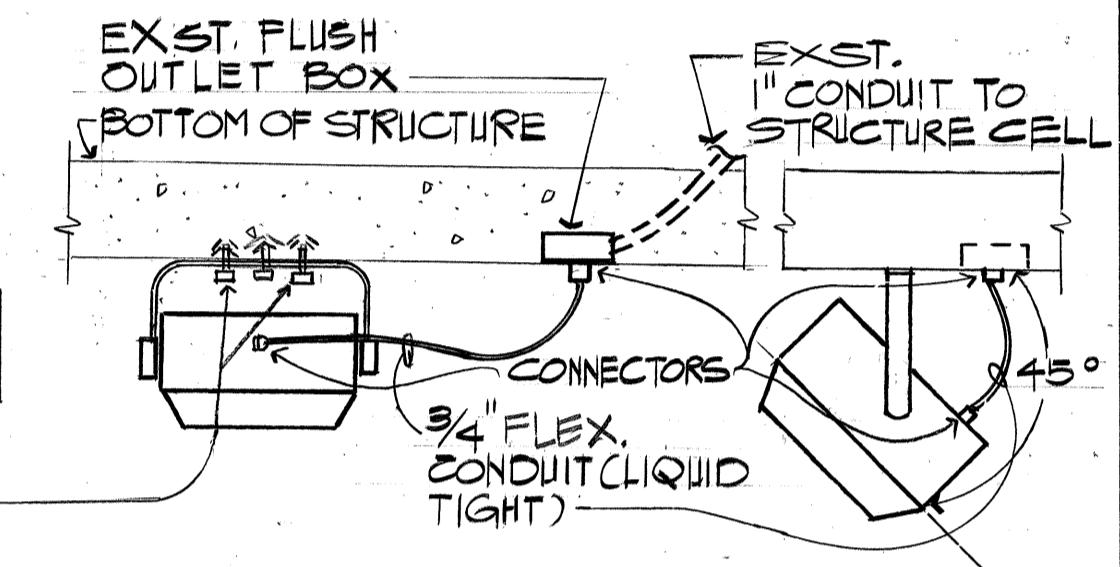


SIDE VIEW
END VIEW
TYPE "A" MOUNTING FOR RAMP M-2
SCALE: 1/2" = 1'-0"

RAMP M-2 STRUCTURE

LIGHTING

SCALE: 1" = 10'-0"

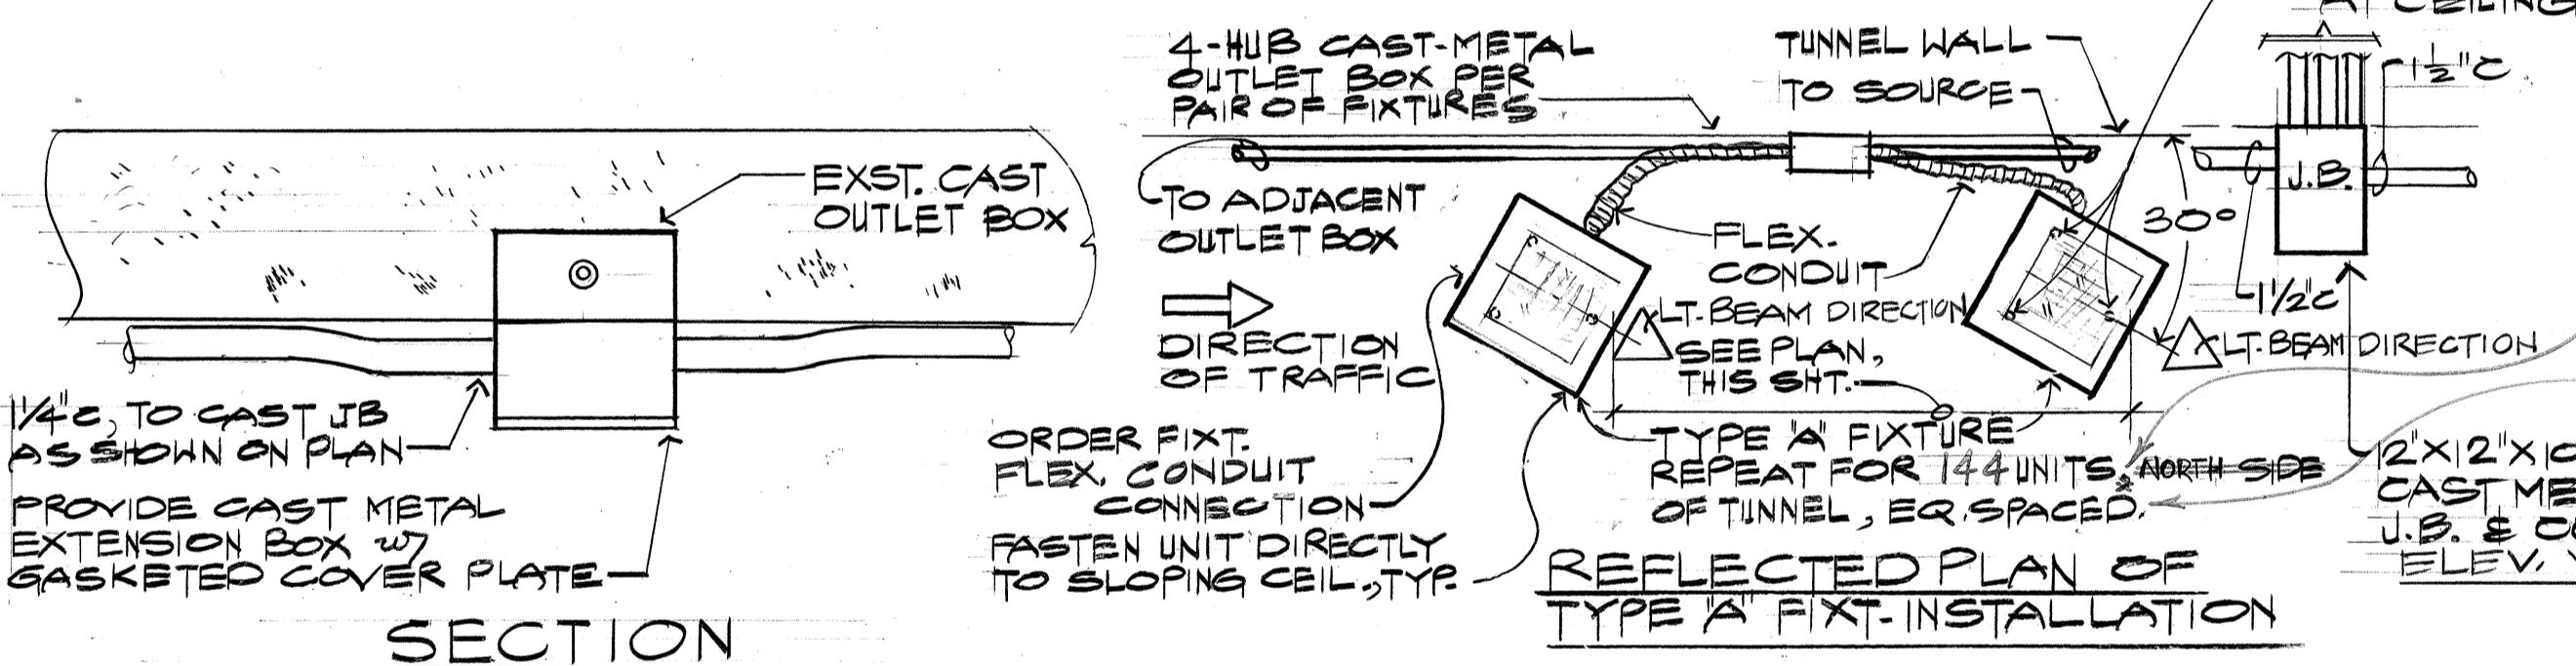

DRILL & PROVIDE EXPANSION BOLTS W/ AM. STD. REG. SQ. NUT #14 PLAIN BRASS WASHERS (3 REQ'D PER FIXTURE) CAUTION SHALL BE EXERCISED AS NOT TO DAMAGE OR INTERFERE w/ THE REINFORCEMENT. OBTAIN REINFORCEMENT DETAIL FROM D.O.T. PROJECT ENGINEER.


RAMP M-3 STRUCTURE FIXTURE MTS. DETAIL

N.T.S.


SECTION

RAMP M-2 STRUCTURE


LIGHTING
SCALE: HORIZONTAL 1" = 10'
VERTICAL 1" = 5'

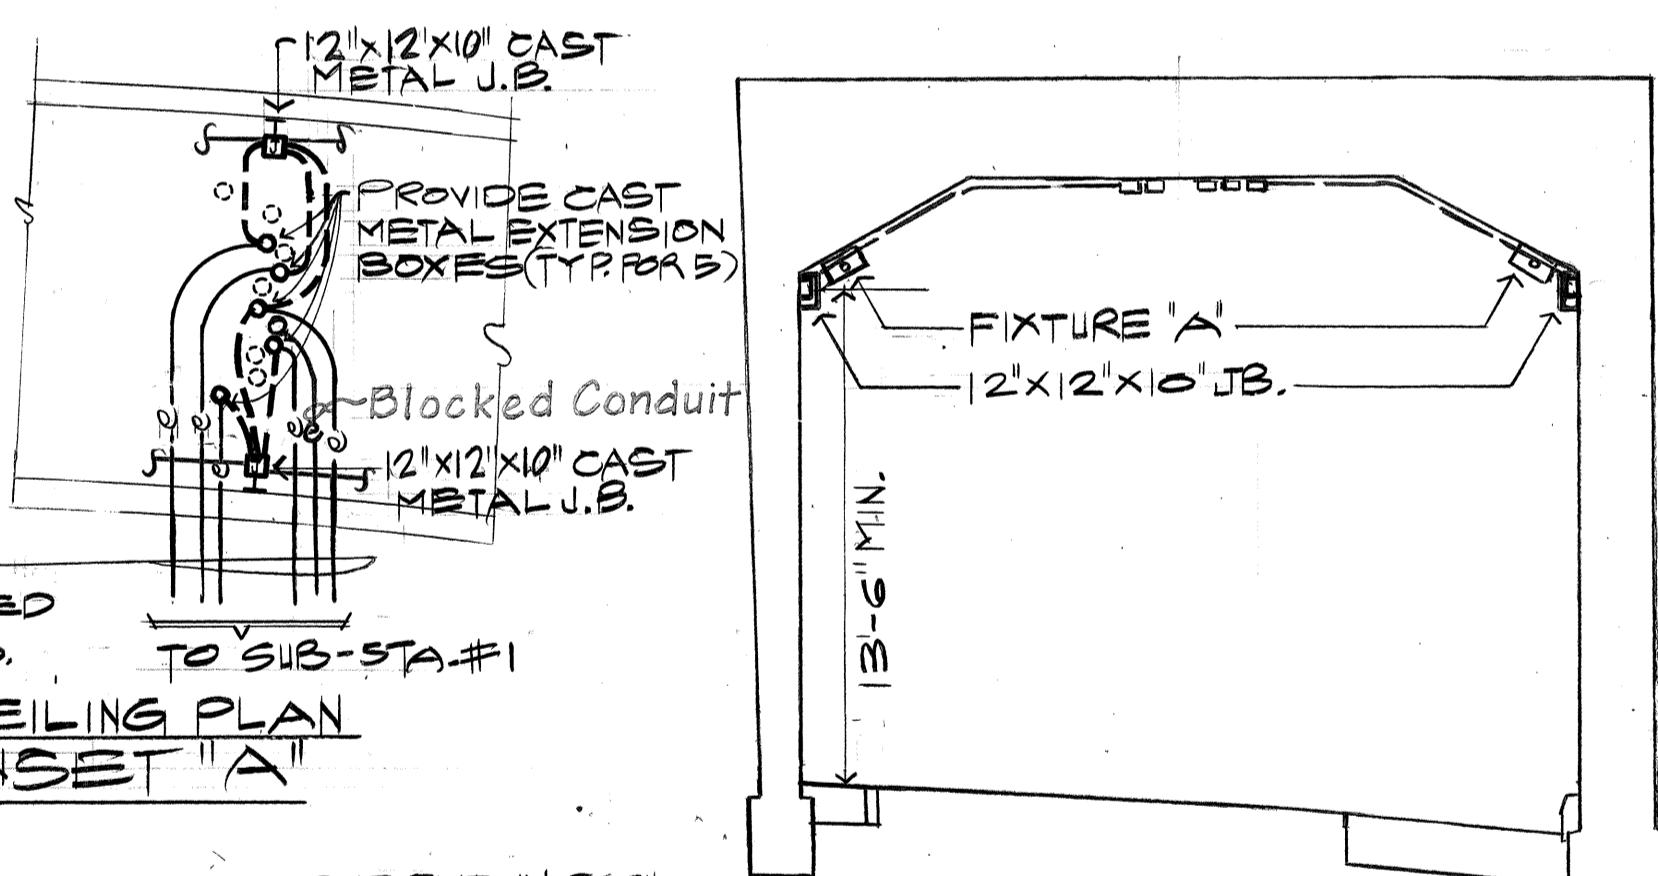

WATERPROOF IN-LINE MOLDED PLASTIC FUSE HOLDER, CAPTING NUT & WATERPROOFING "O" RING w/ 5 AMP. FUSE IN FIXTURE.

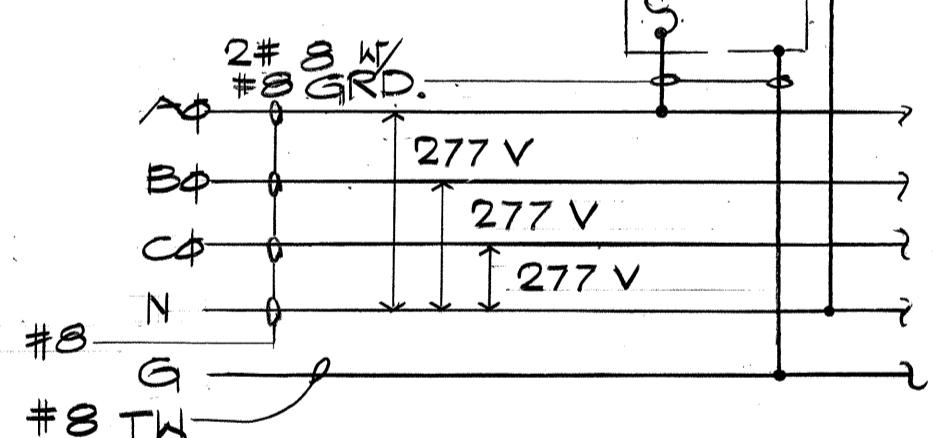



TUNNEL LIGHTING WIRING

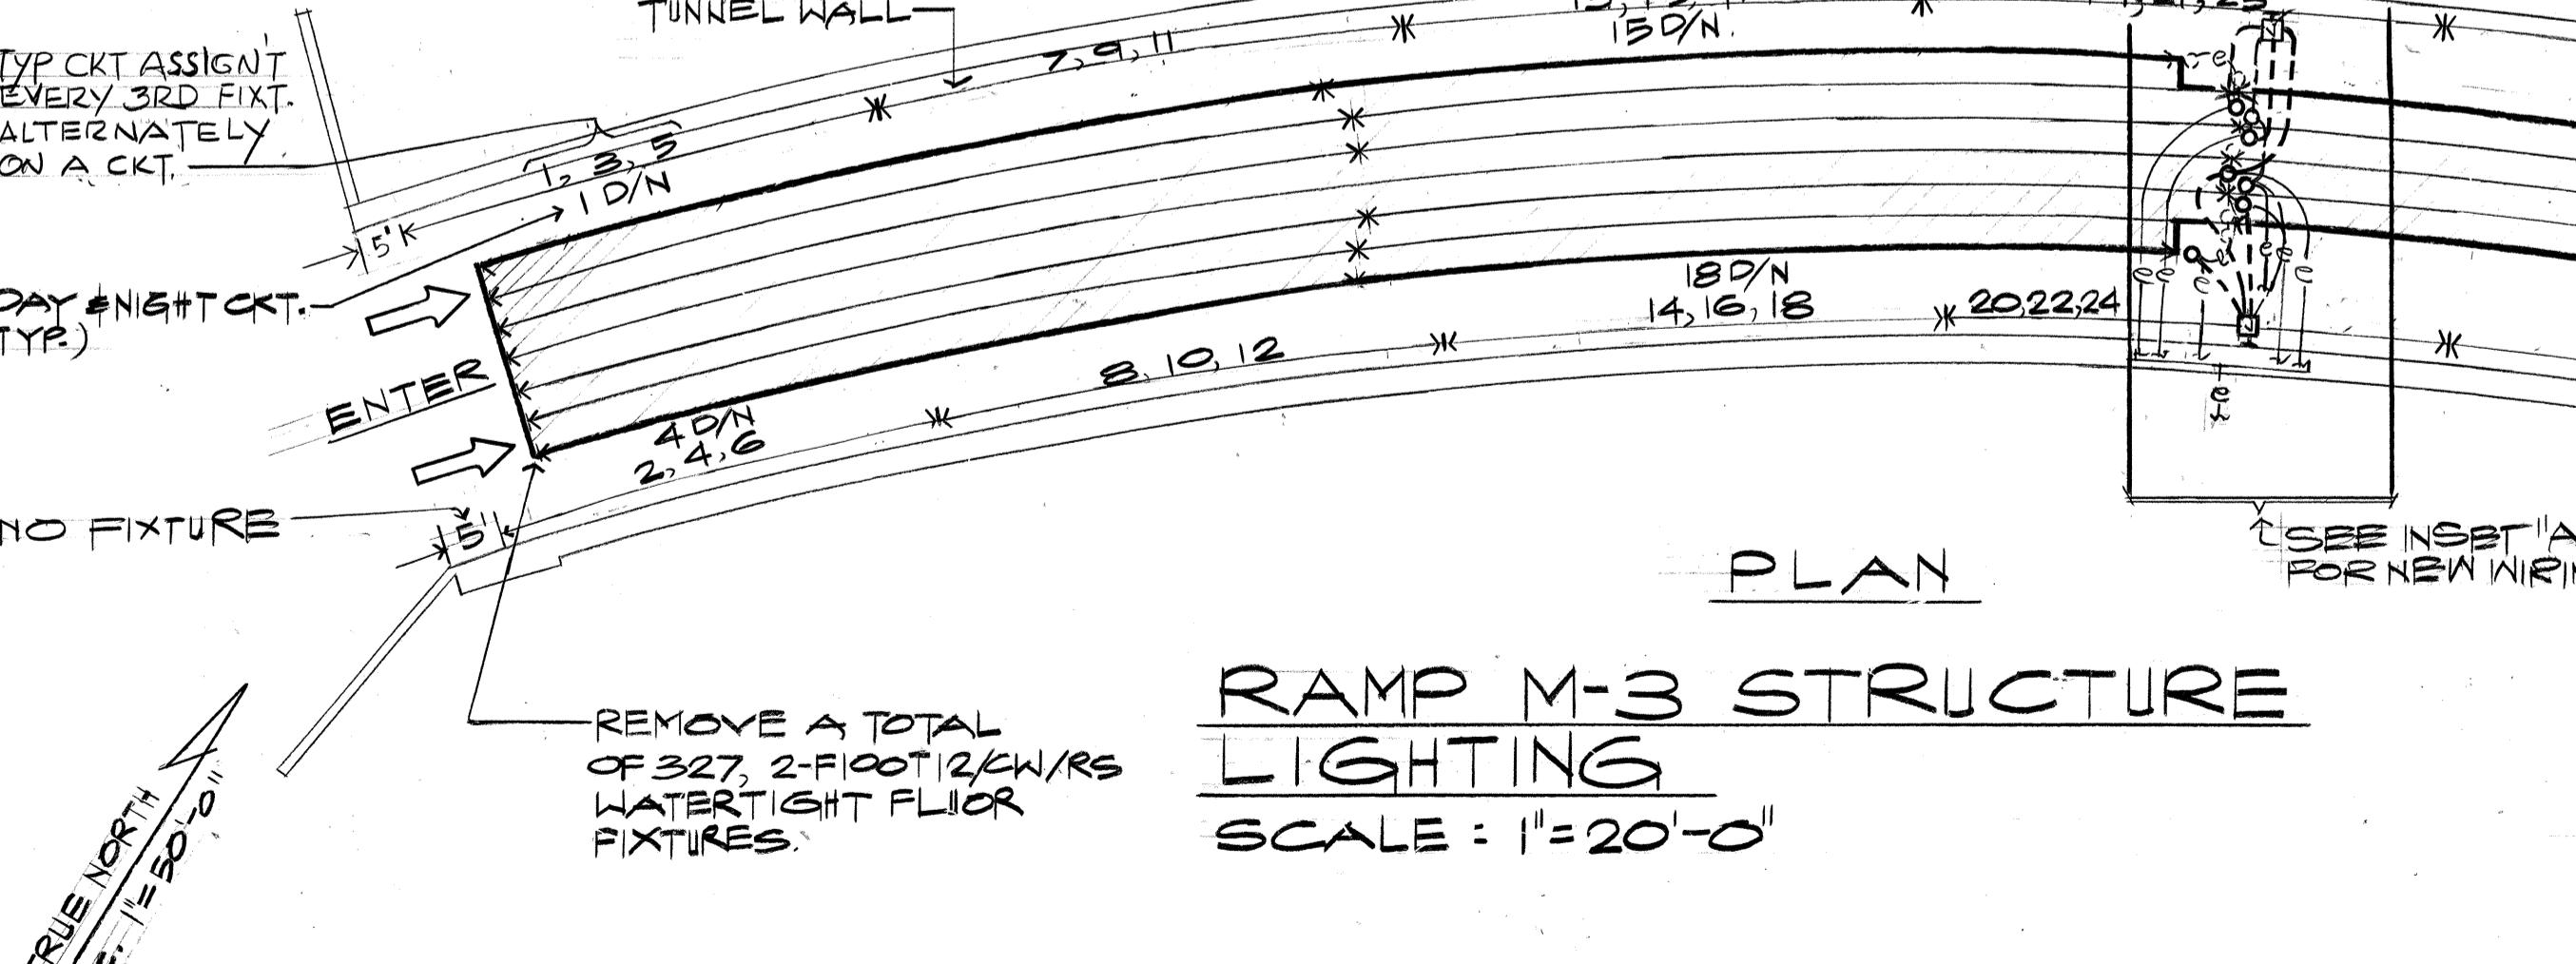

RAMP M-3 STRUCTURE

LIGHTING









SCALE: 1" = 20'-0"

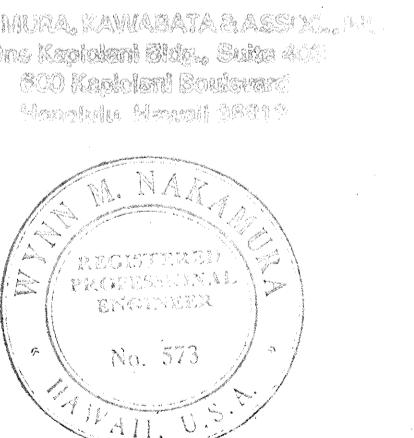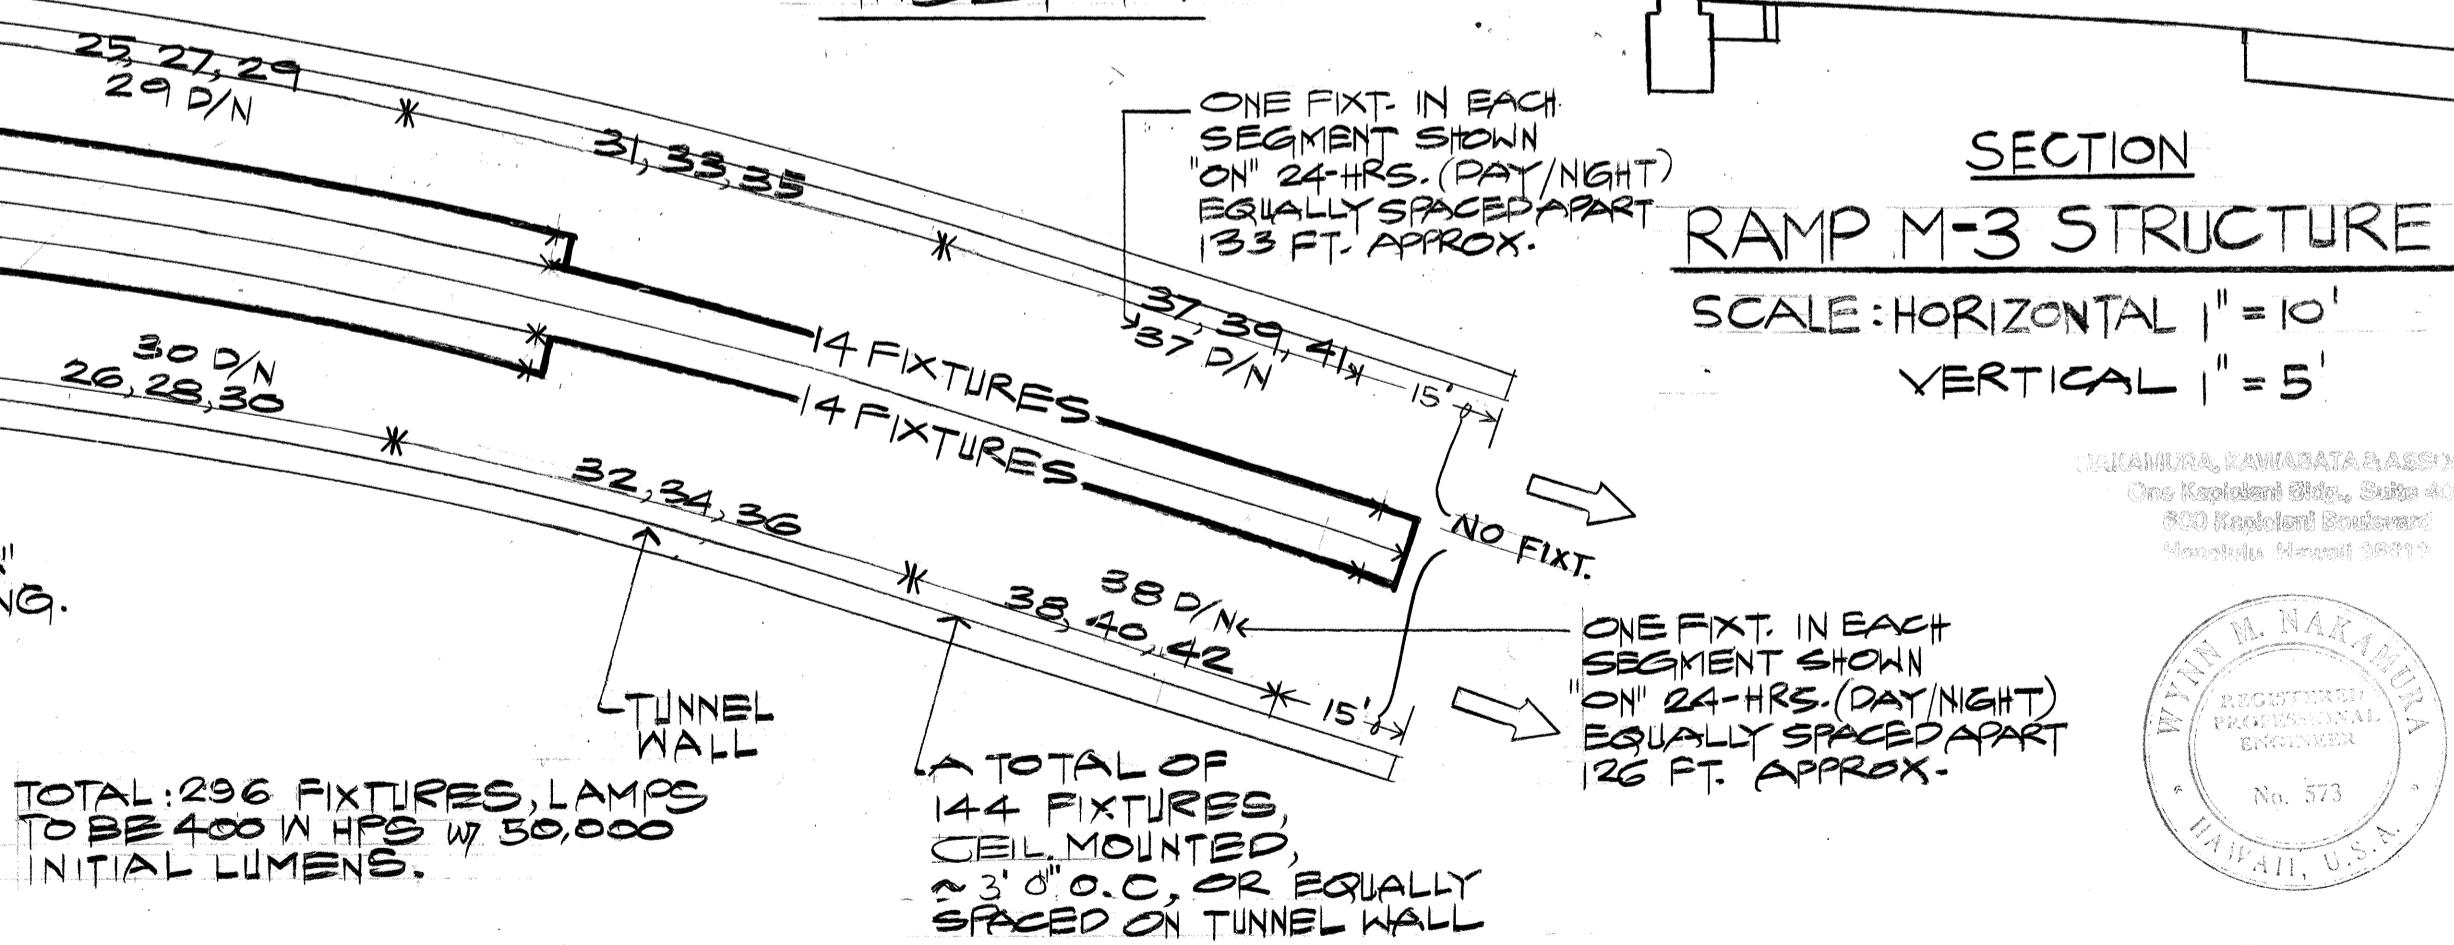


STATE OF HAWAII
DEPARTMENT OF TRANSPORTATION
HIGHWAYS DIVISION
RAMP "M-2" STRUCTURE
RAMP "M-3" EASTBOUND STRUCTURE
INTERSTATE H-1 IMPROVEMENTS
MIDDLE STREET TO KALIHI INTERCHANGE
EASTBOUND LANES
F.A.I. PROJECT NO. I - HI-1(178)

SHEET NO. 17 OF SHEETS

FED. ROAD DIST. NO.	STATE	FED. AID PROJ. NO.	FISCAL YEAR	SHEET NO.	TOTAL SHEETS
HAWAII	HAW.	I - HI-I(178)	1982	109	165

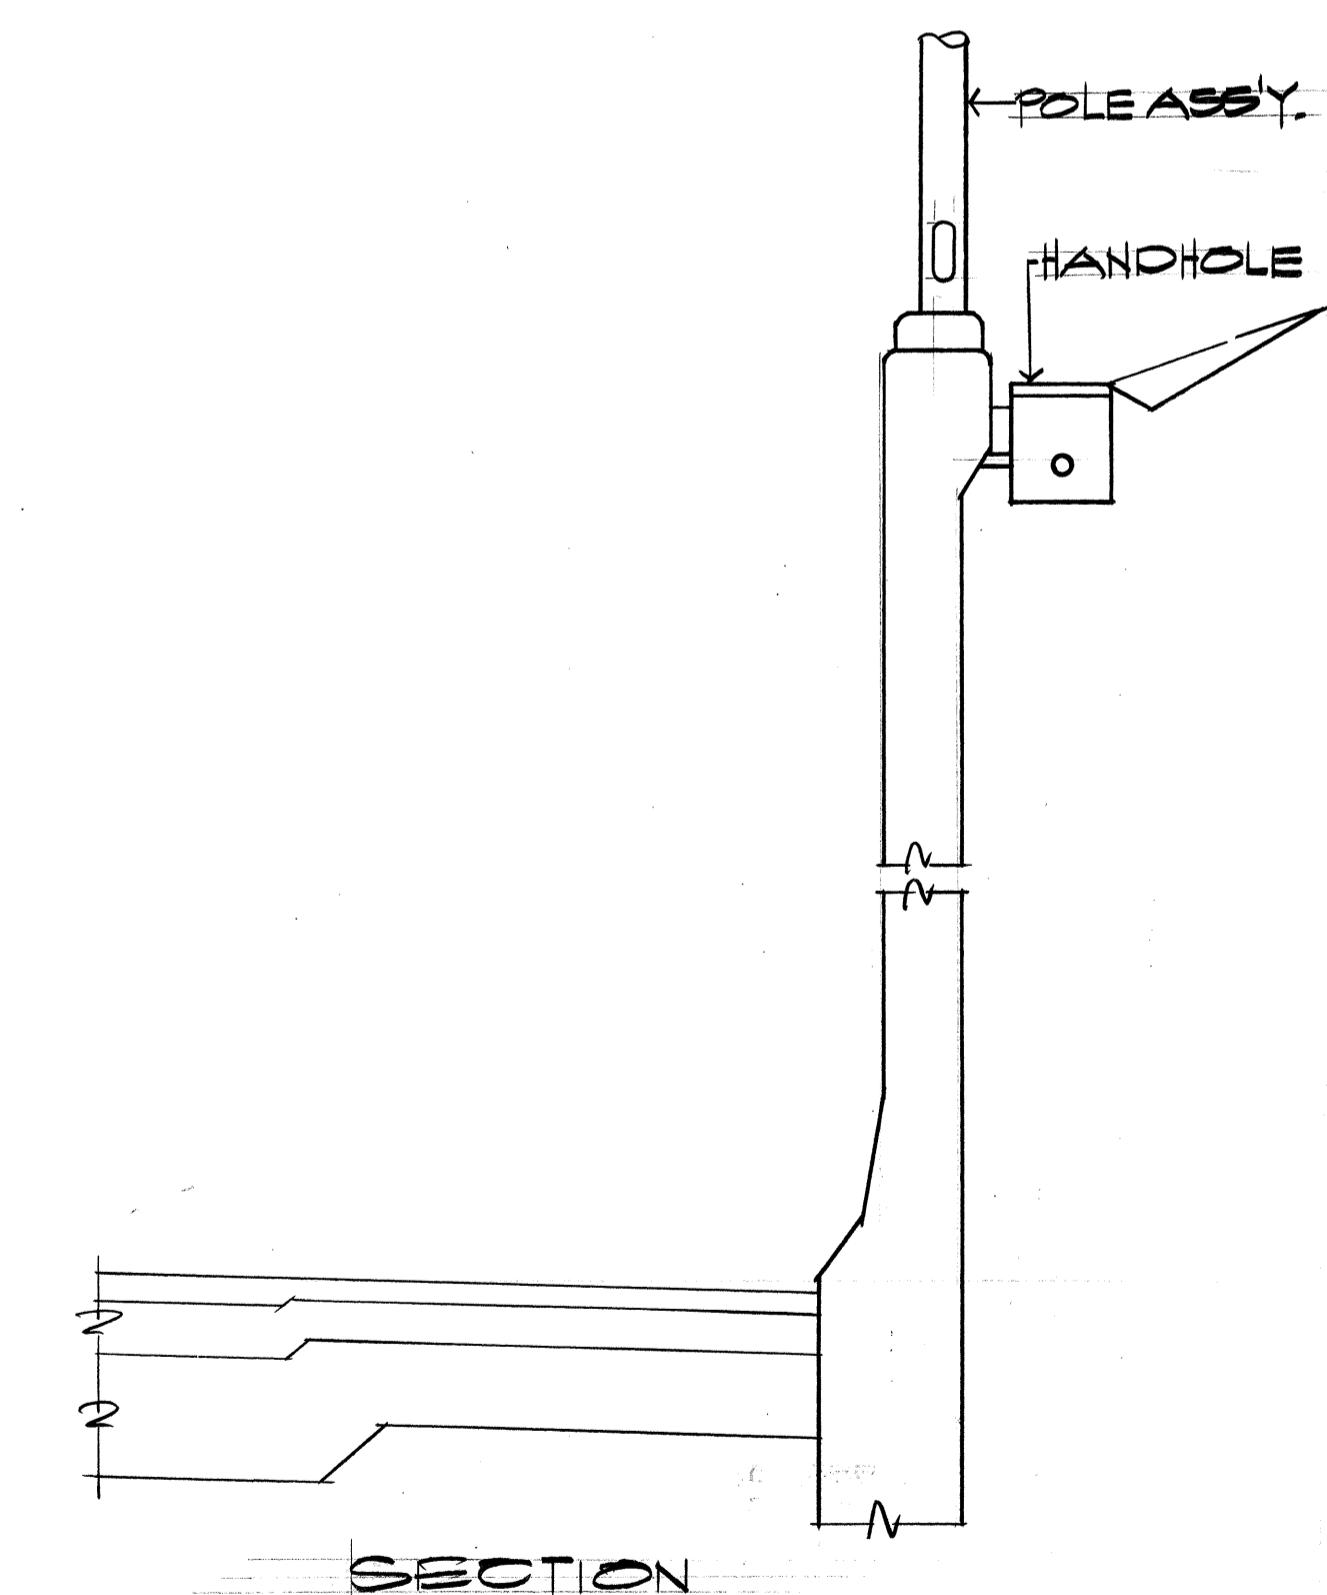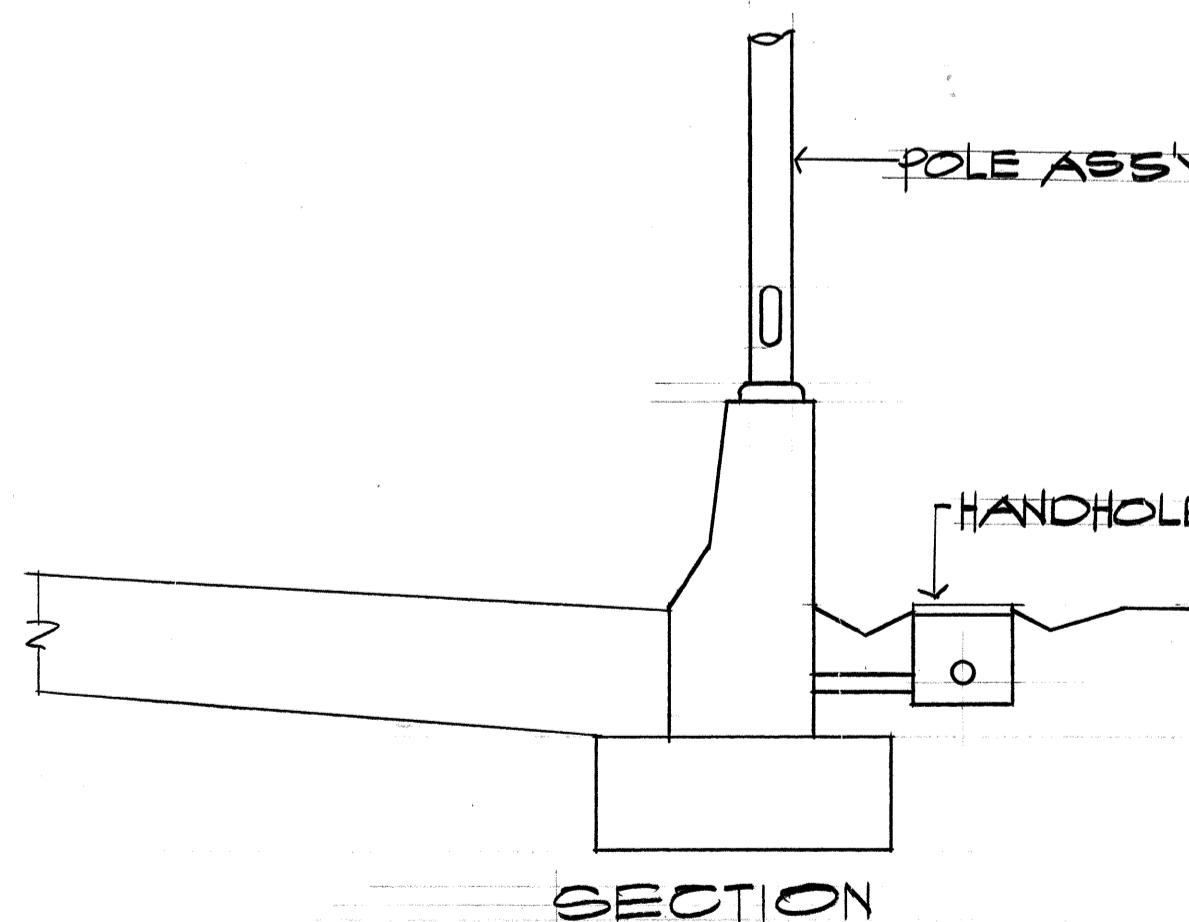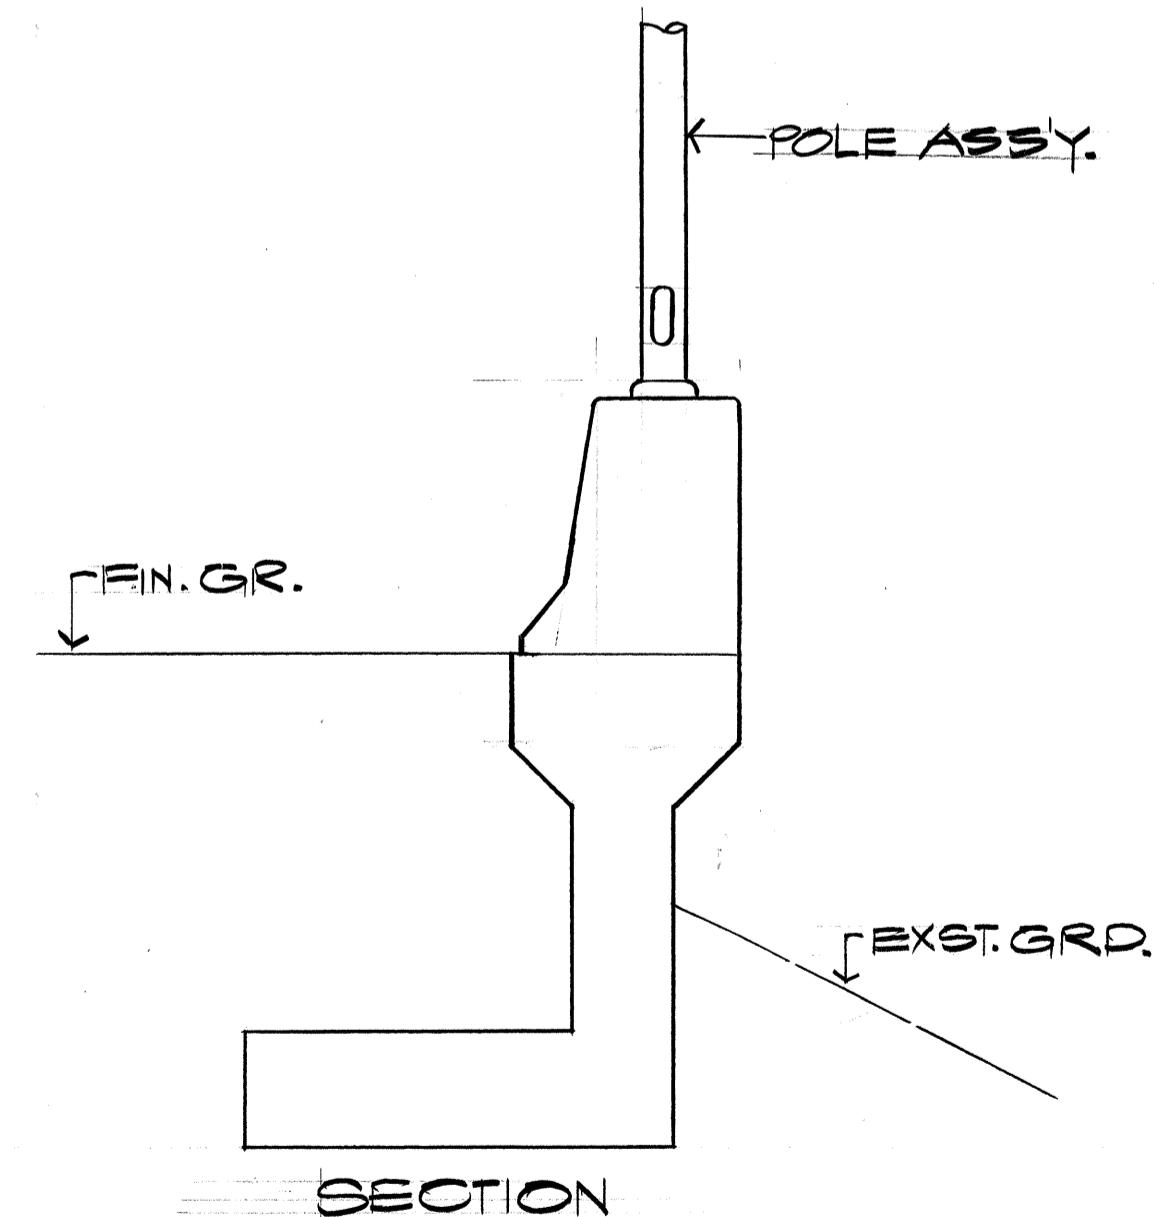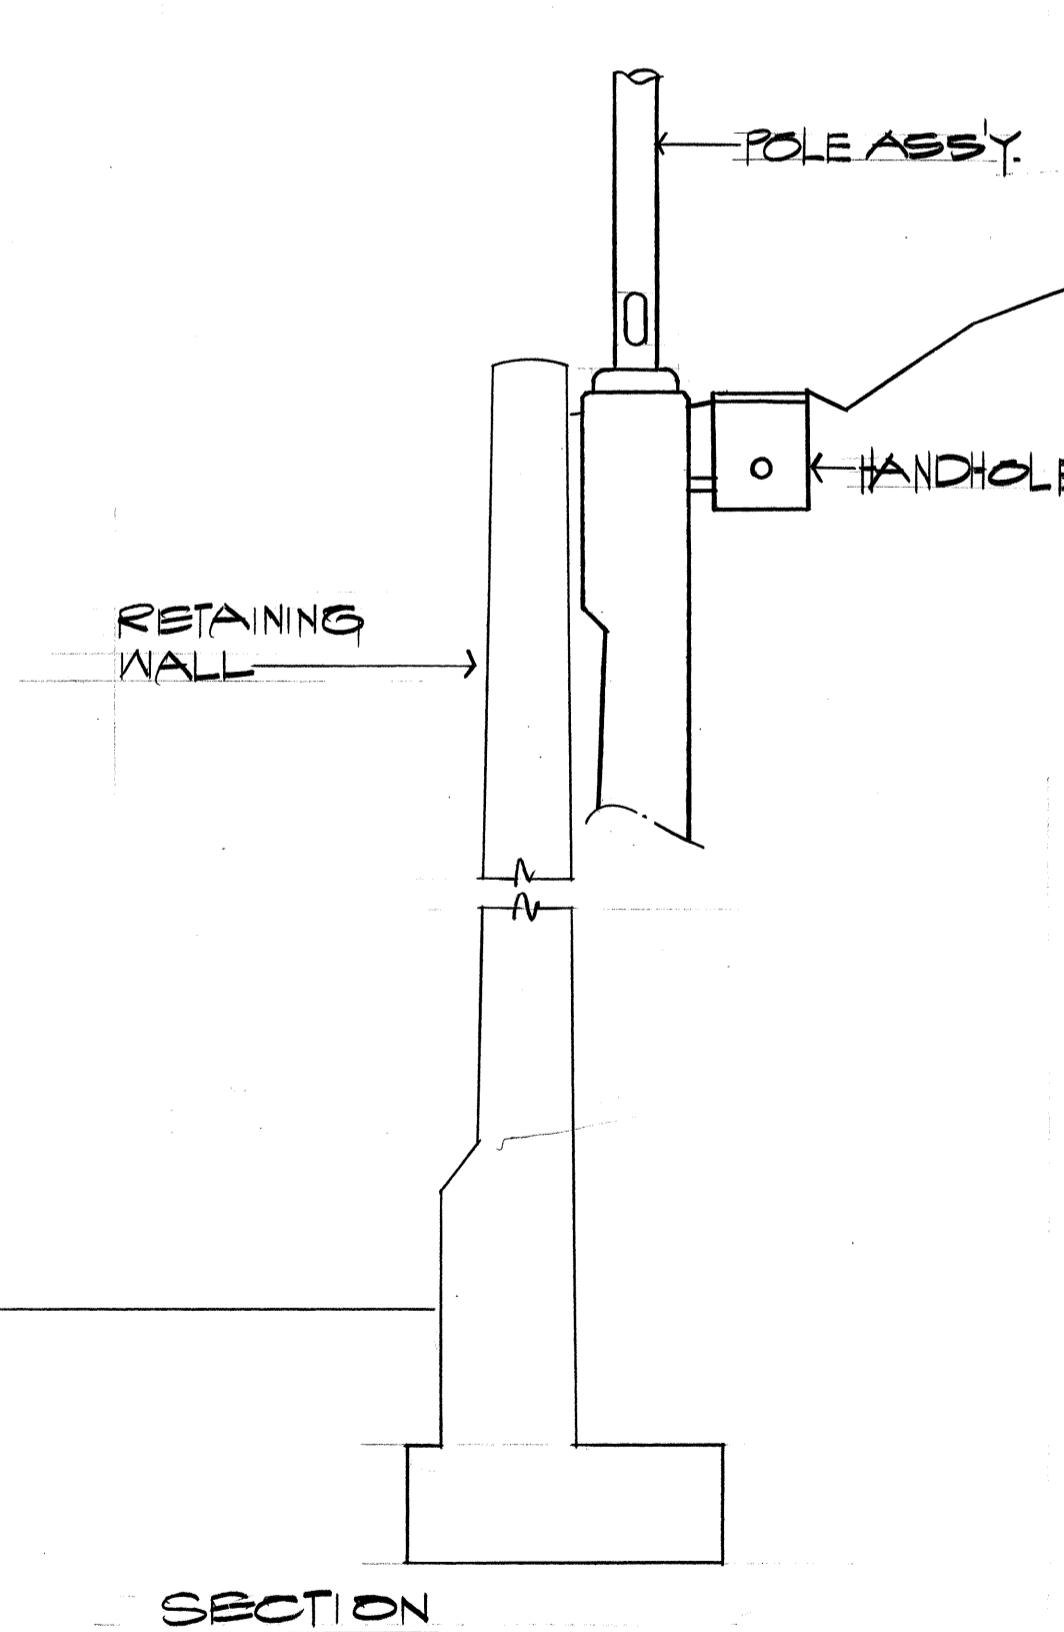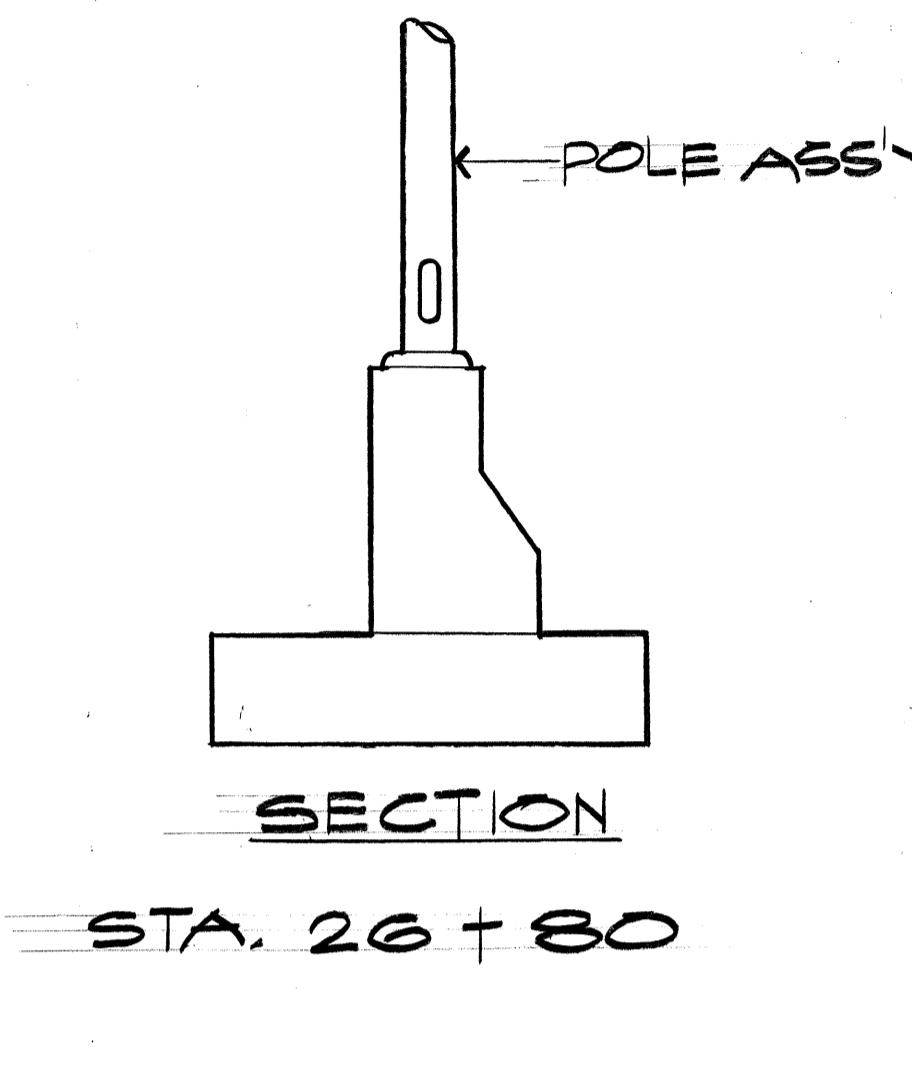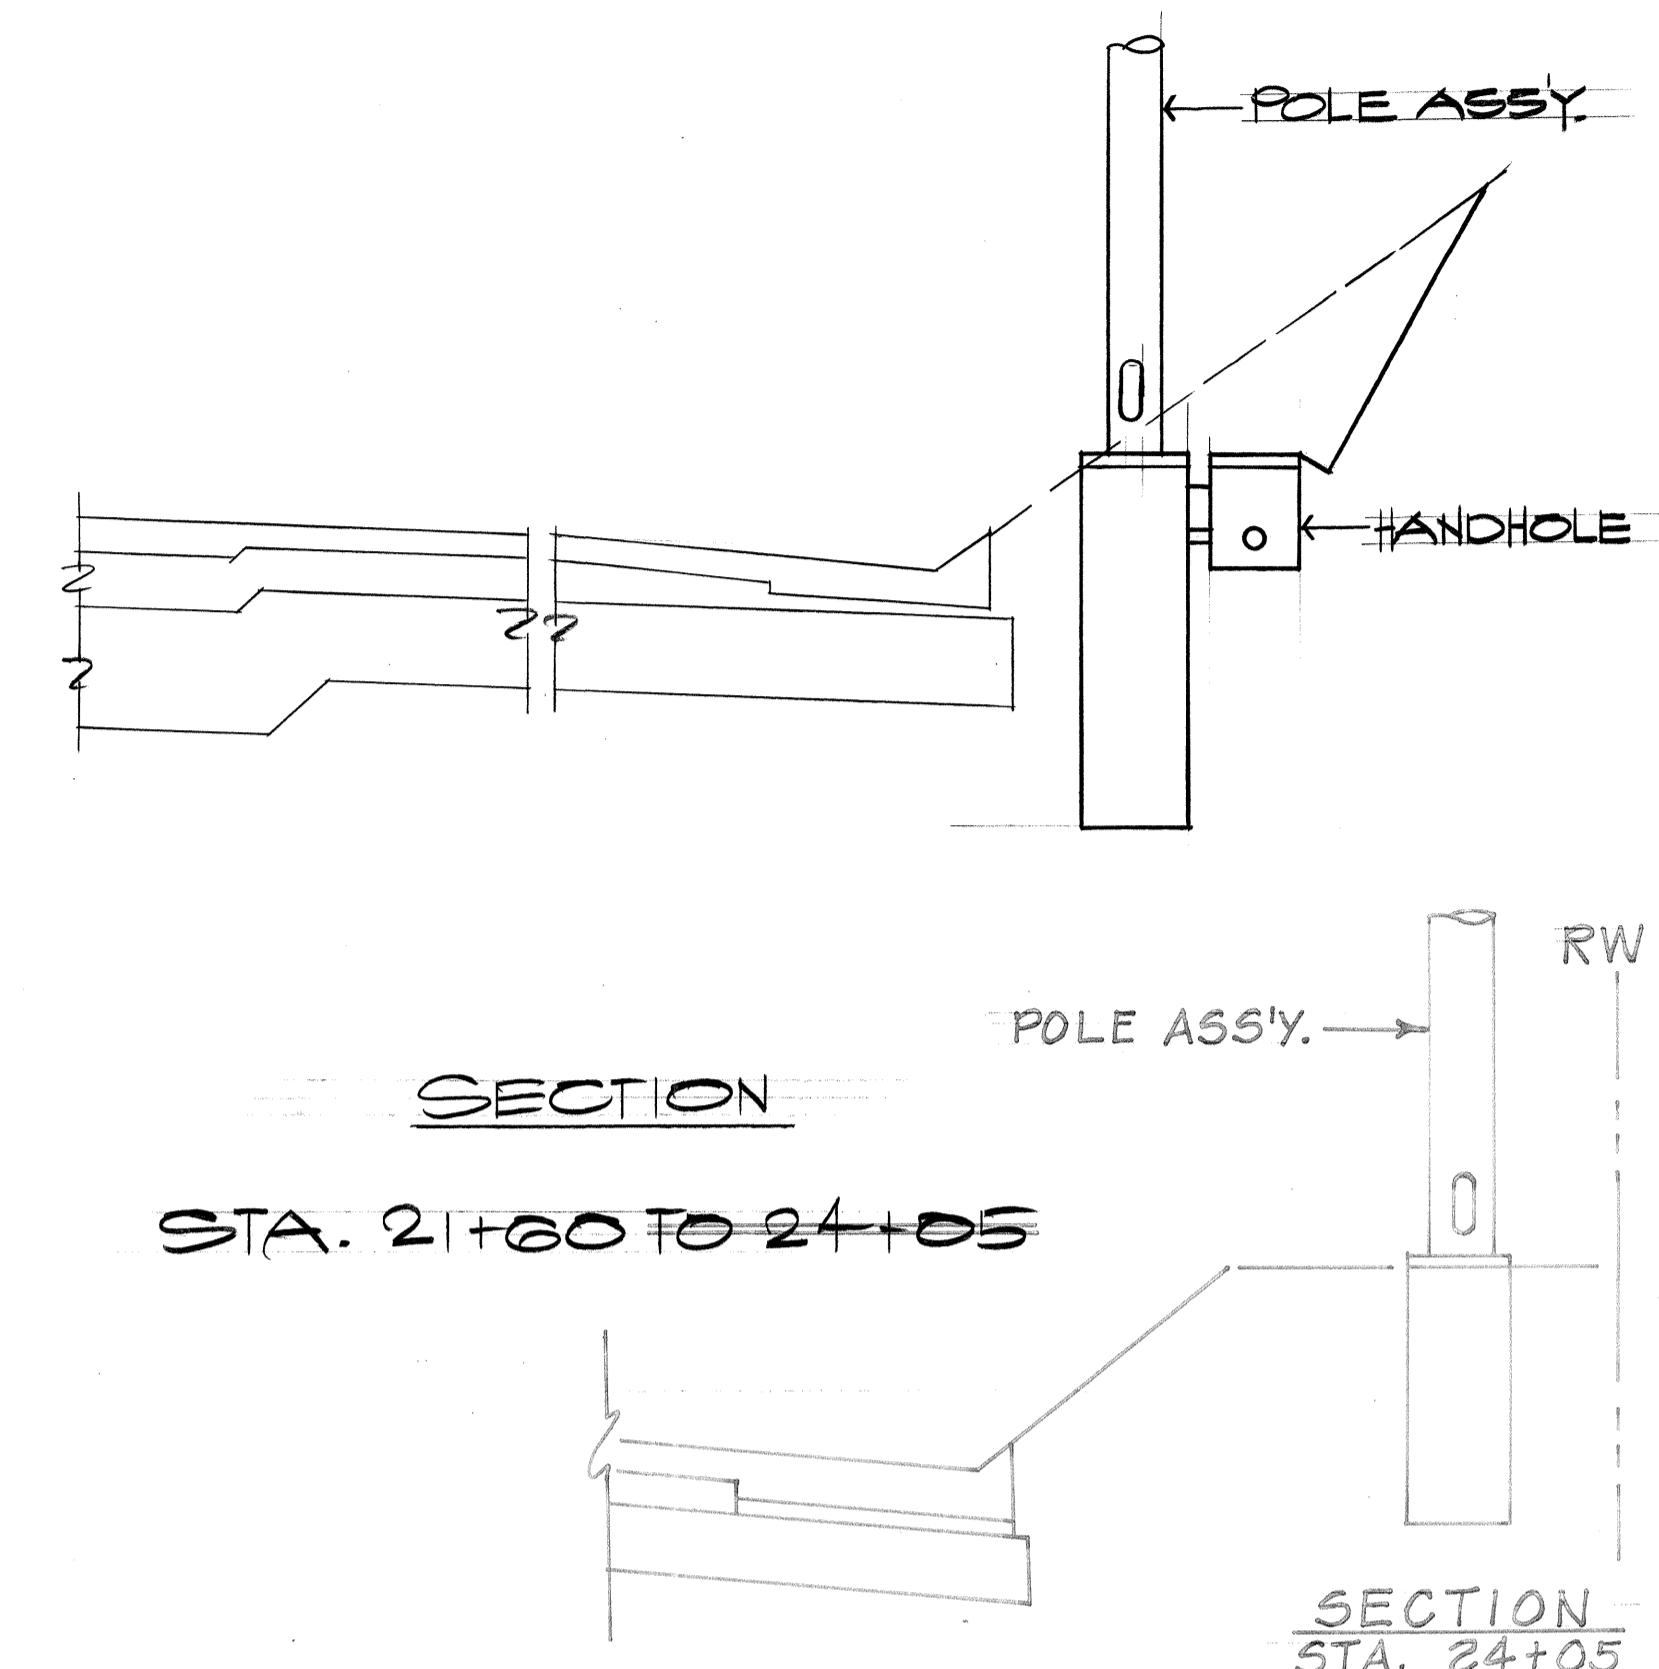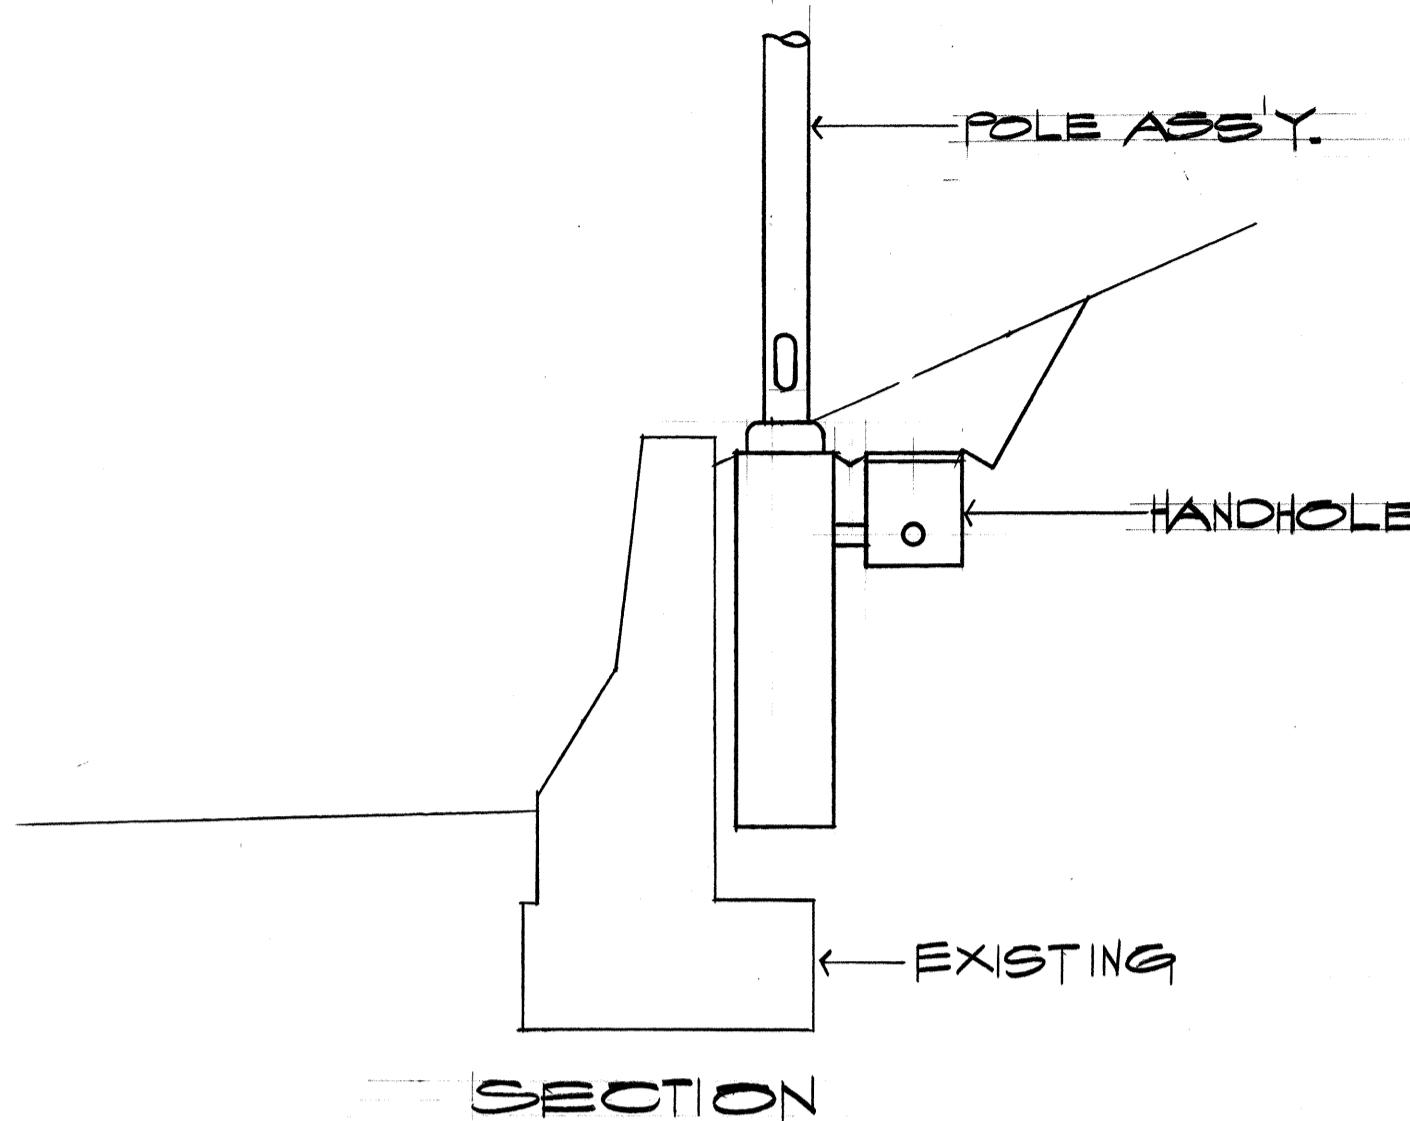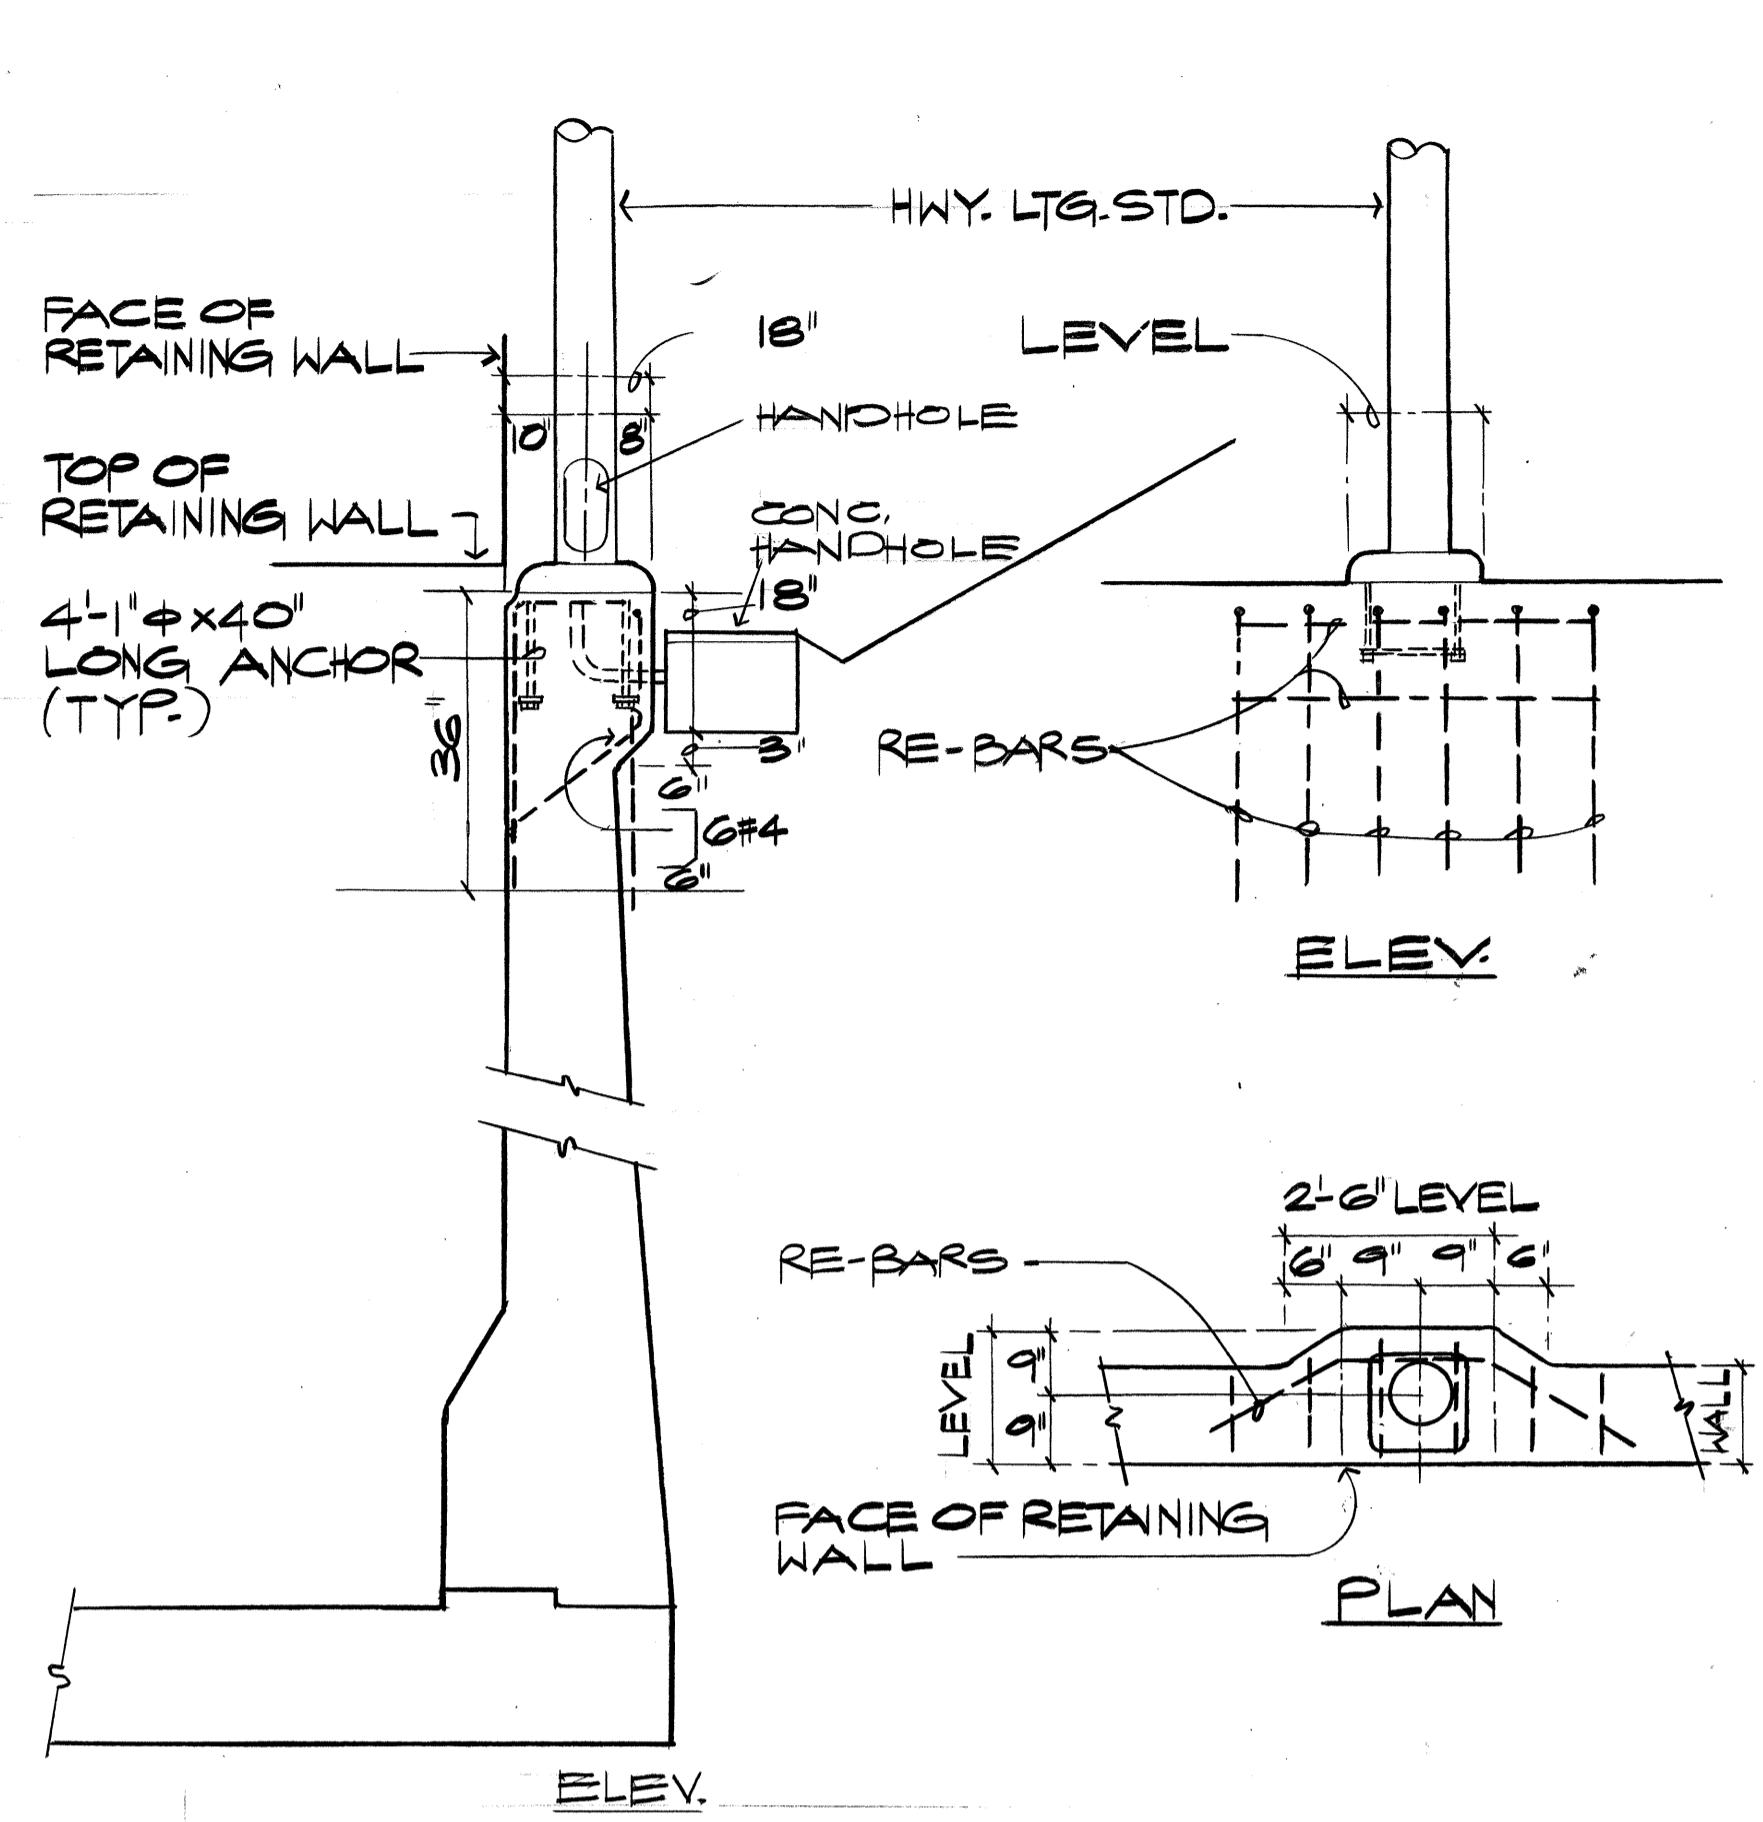

NAKAMURA, KAHABATA & ASSOC., INC.
One Kapolei Plaza, Suite 403
300 Kapolei Boulevard
Honolulu, Hawaii 96813

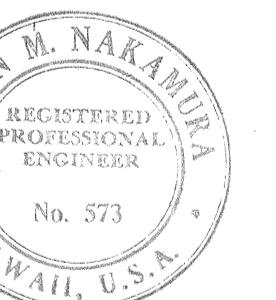

THIS WORK WAS PREPARED IN
OR UNDER MY SUPERVISION
Wynn M. Nakamura



STATE OF HAWAII
DEPARTMENT OF TRANSPORTATION
LAND TRANSPORTATION FACILITIES DIVISION
POLE ASSY. ON RETAINERS
INTERSTATE H-1 IMPROVEMENTS
MIDDLE STREET TO KALIHI INTERCHANGE
EASTBOUND LANES
F.A.I. PROJECT NO. I - HI-I(178)

SHEET NO. 109 OF 165 SHEETS



FED. ROAD DIST. NO.	STATE	FED. AID PROJ. NO.	FISCAL YEAR	SHEET NO.	TOTAL SHEETS
HAWAII	HAW.	I - HI-I(178)	1982	110	165

MATERIAL LIST

- ① LUMINAIRE
- ② TRUSS BRACKET
- ③ POLE
- ④ POLE BASE 4-BOLTS, WASHER & NUTS
- ⑤ POLE BASE BOLT COVER
- ⑥ GROUNDING LUGS
- ⑦ TRANSFORMER BASE w/ ACCESS COVER
- ⑧ 4-1"X40" GALV. ANCHOR BOLTS
- ⑨ GRD. ROD 5/8"φ X 10'-0" COPPER CLAD
- ⑩ PVC SCH'D. 40, 36" DEEP MIN.
- ⑪ CONC. w/ 6#3 BARS UNLESS OTHERWISE NOTED
- ⑫ WIRING ACCESS HANHOLE
- ⑬ SLIP BASE INSERT STD.
- ⑭ REINFORCED CONC. FOUNDATION INCLUDING 1#10 TW BONDED GRD. LUGS TO GRD. ROD, SIMILAR TO DETAIL "A" w/ EXCEPTIONS AS NOTED.
- ⑮ DOUBLE BRACKET CONDITION, COMPLETE w/ LUMINAIRES & WIRING. SEE PLAN FOR LOCATION.
- ⑯ PROVIDE 1#10 TW BOND BETWEEN POLE LUG & GRD. ROD
- ⑰ PROVIDE 1#10 TW BOND BETWEEN POLE LUG & PULL BOX GRD. ROD
- ⑱ AT EXST. CUT, INCREASE ROUND SECT. DEPTH BY 12 INCH PER 12 INCH VERT. DIFFERENCE FROM FOUNDATION TOP TO FIN. GR.
- ⑲ ALL POLES TALLER THAN 25' INCREASE ROUND SECT. DEPTH TO 66 INCHES

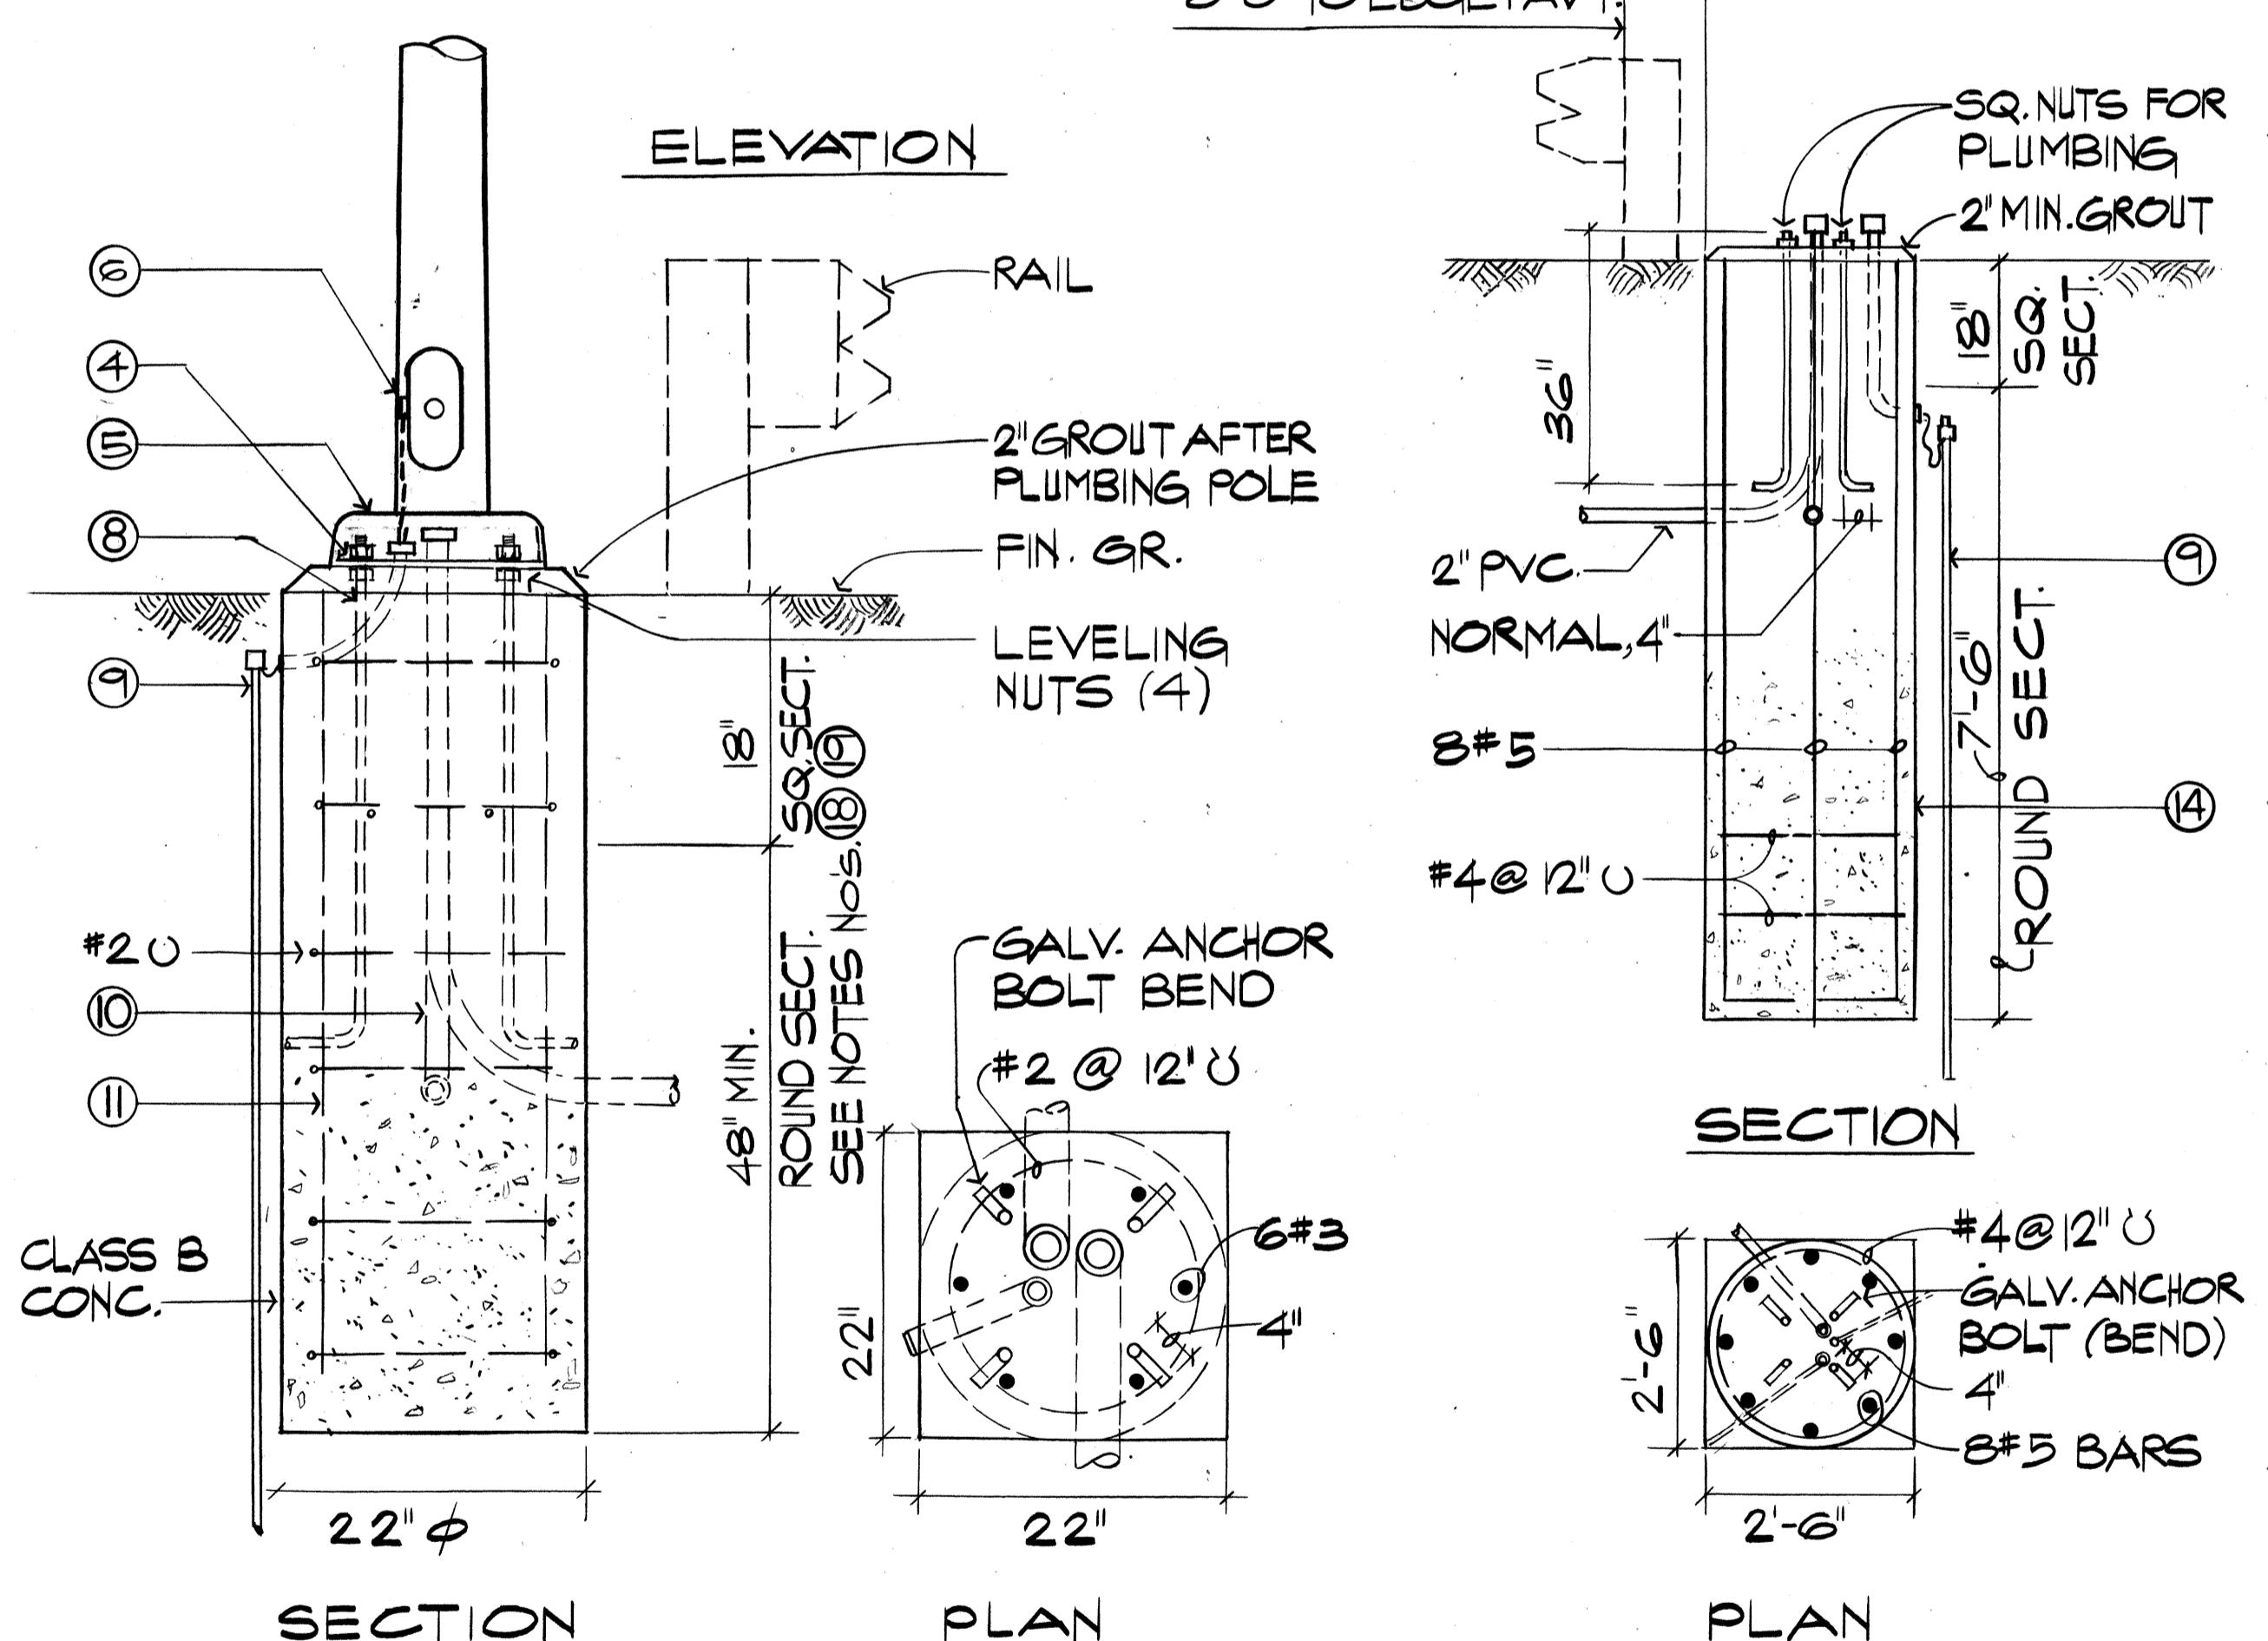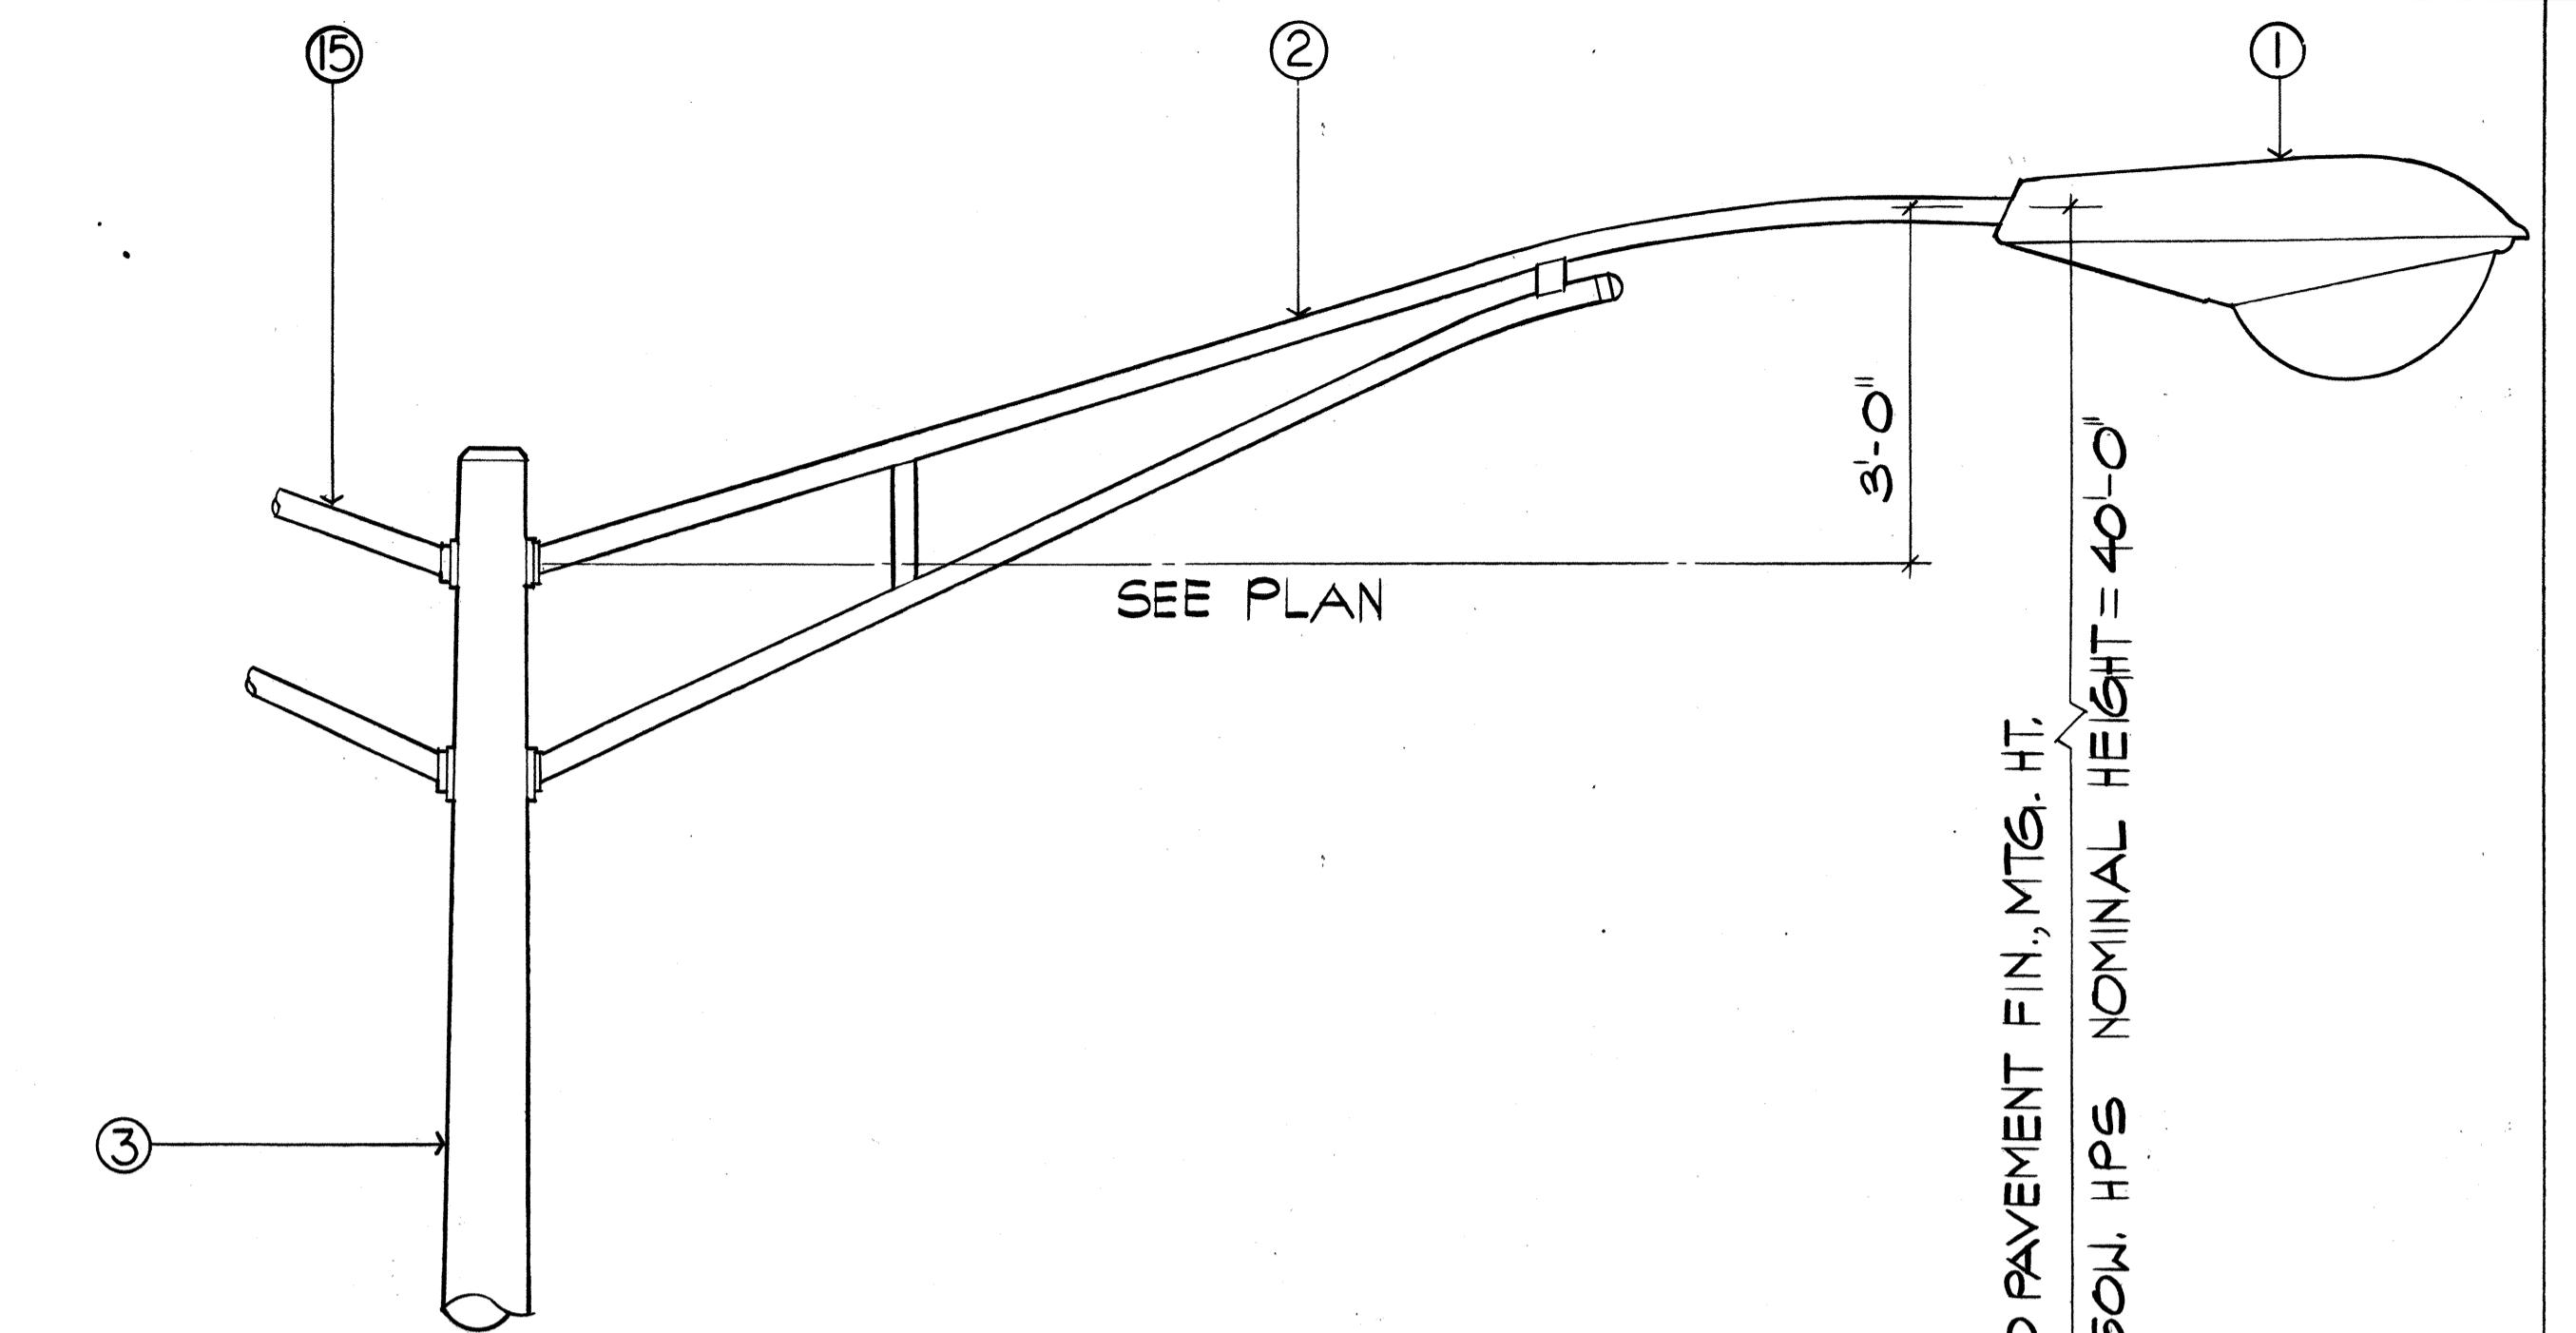


**HIGHWAY LIGHTING
STANDARD DETAIL
TYPE "A"**
SCALE : 1"=1'-0"
FOR USE IN LEVEL AREA
AS SHOWN ON PLAN

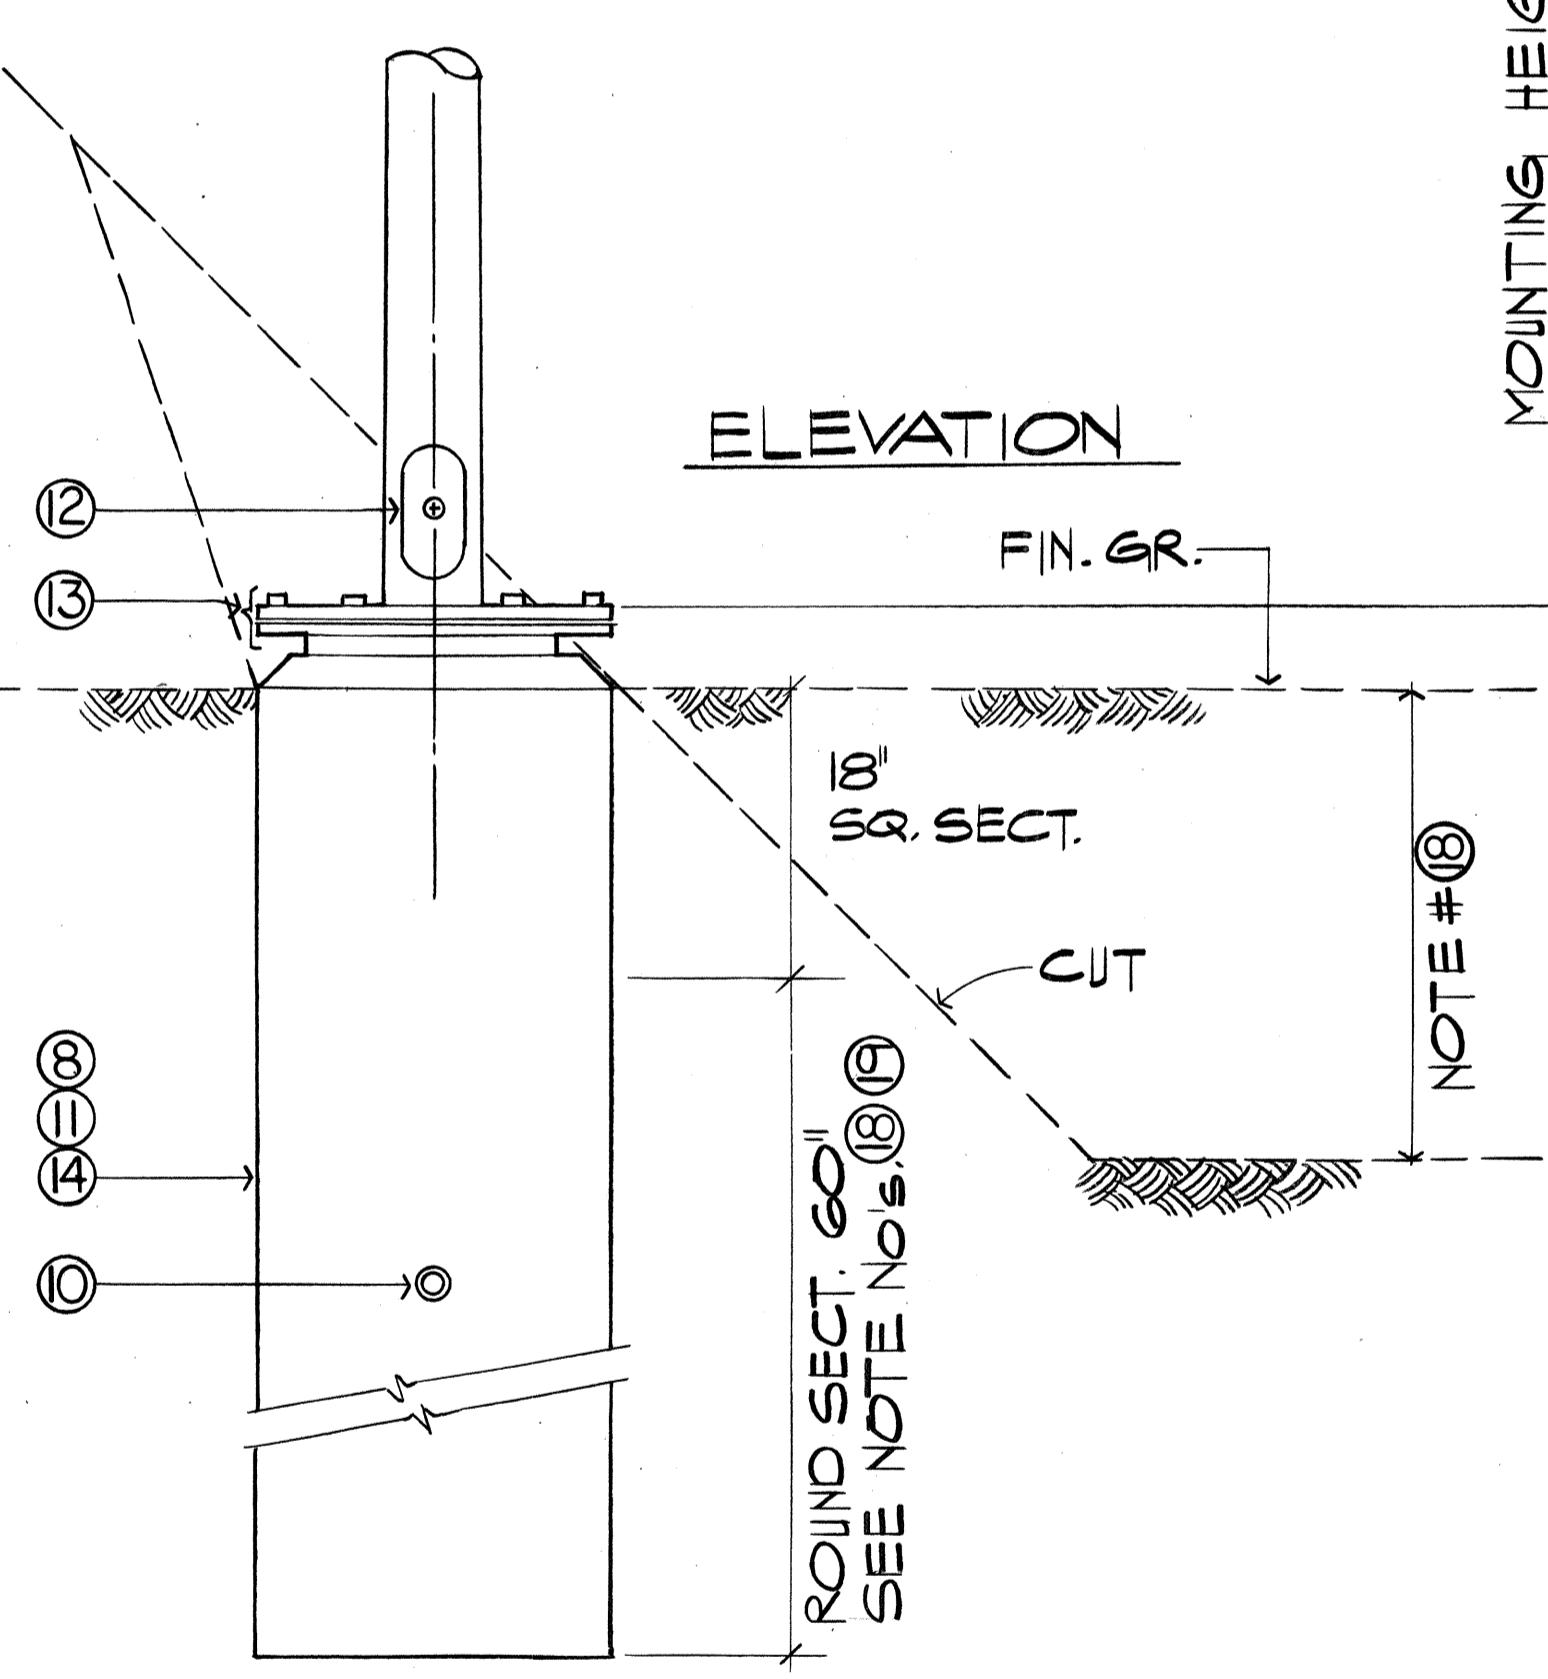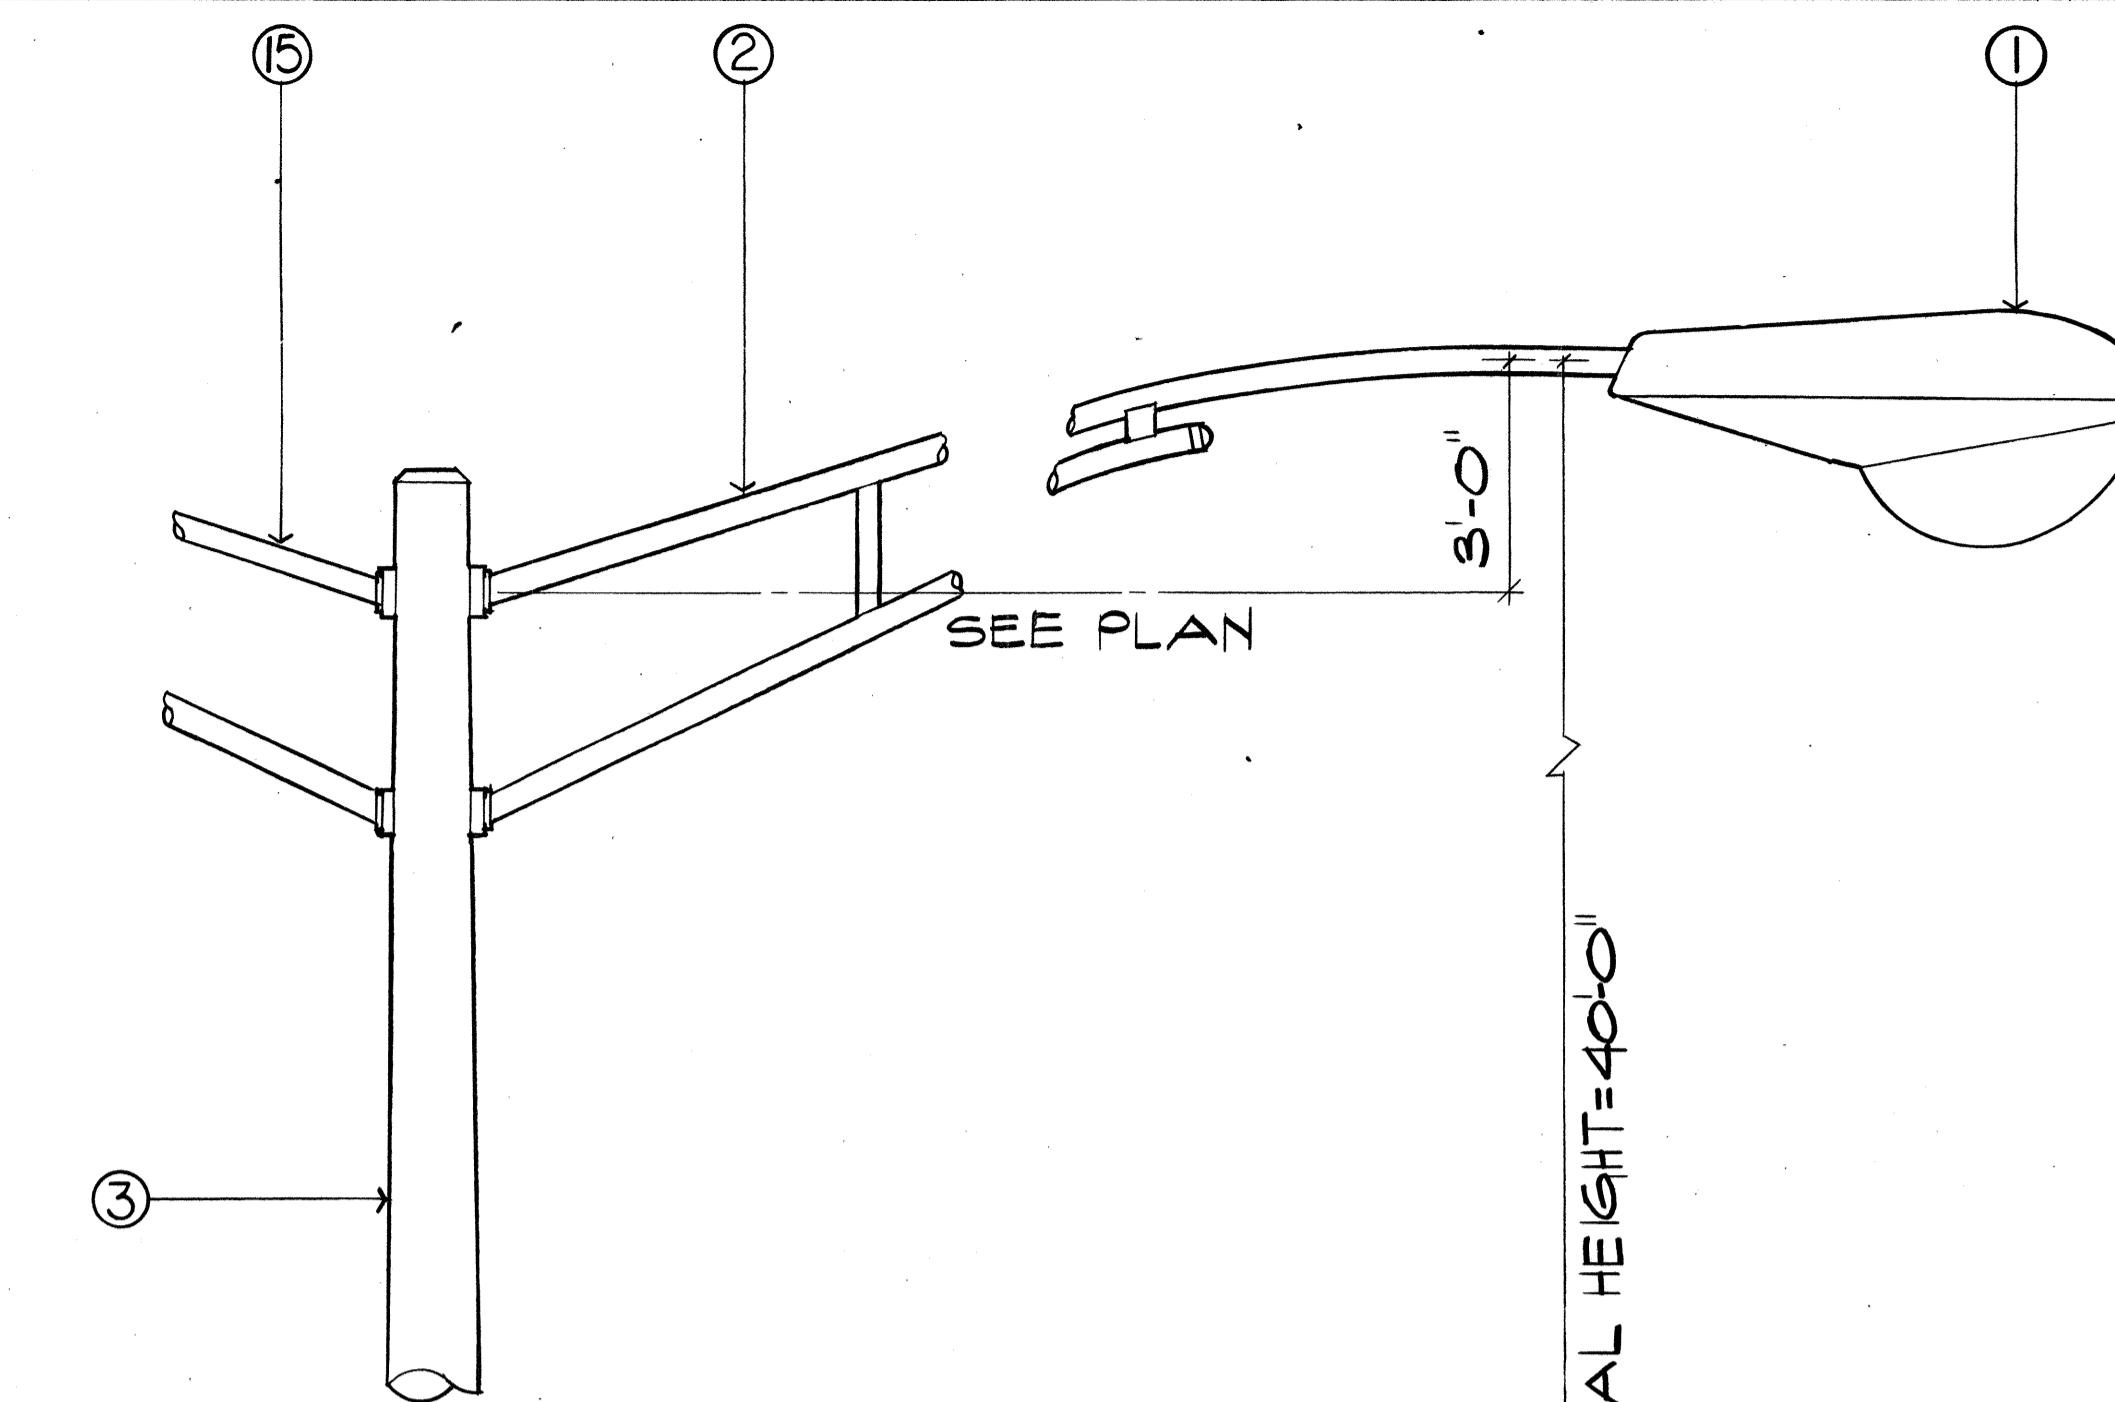

**HIGHWAY LIGHTING
STANDARD DETAIL
TYPE "B"**
SCALE : 1"=1'-0"
FOR USE IN CUT SLOPE

DAKOTA, KANNADA ASSOC., INC.
One Kapolei St., Suite 400
300 Kapiolani Boulevard
Honolulu, Hawaii 96813

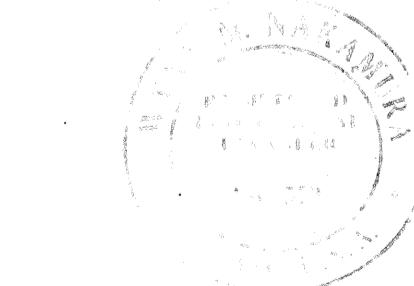


THIS DRAWING WAS PREPARED BY
JOHN NAKAMURA
F.A.I.


STATE OF HAWAII
DEPARTMENT OF TRANSPORTATION
LAND TRANSPORTATION FACILITIES DIVISION
**HIGHWAY LIGHTING
STANDARD DETAILS**
INTERSTATE H-1 IMPROVEMENTS
MIDDLE STREET TO KALIHI INTERCHANGE
EASTBOUND LANES
F.A.I. PROJECT NO. I - HI-I(178)

SHEET NO. 110 OF SHEETS




FED. ROAD DIST. NO.	STATE	FED. AID PROJ. NO.	FISCAL YEAR	HEET NO.	TOTAL SHEETS
HAWAII	HAW.	I -HI-1(178)	1982	III	165

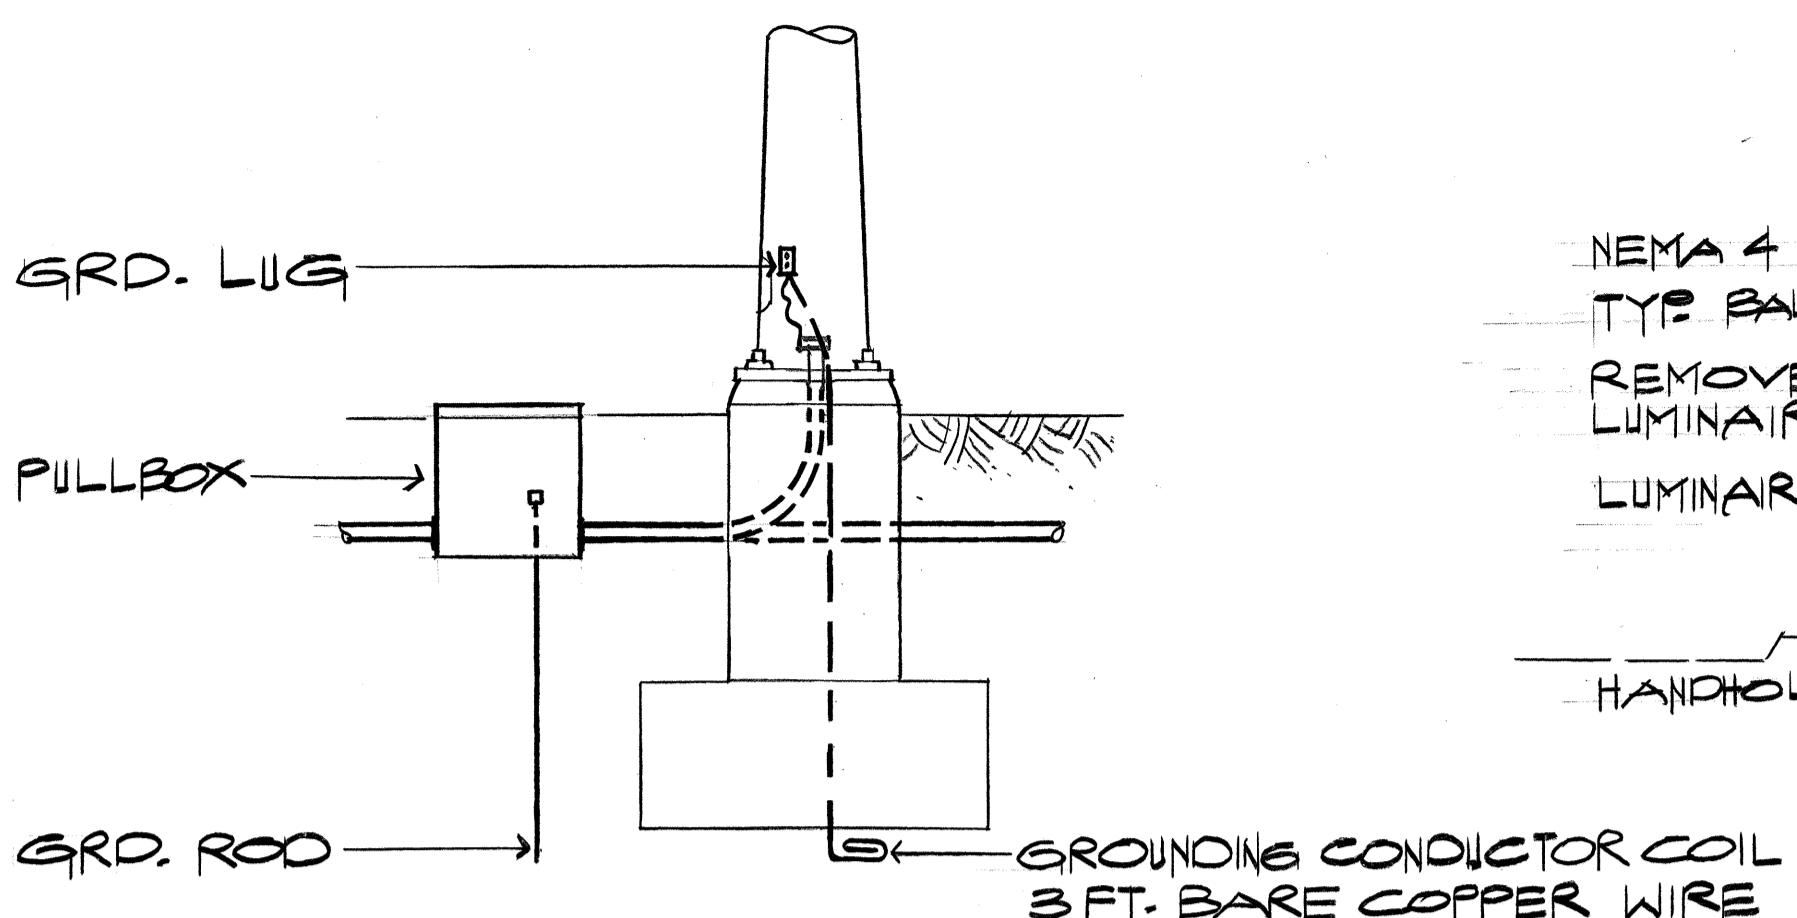



TYPICAL SIGN POLE CONDUIT
N.T.S.

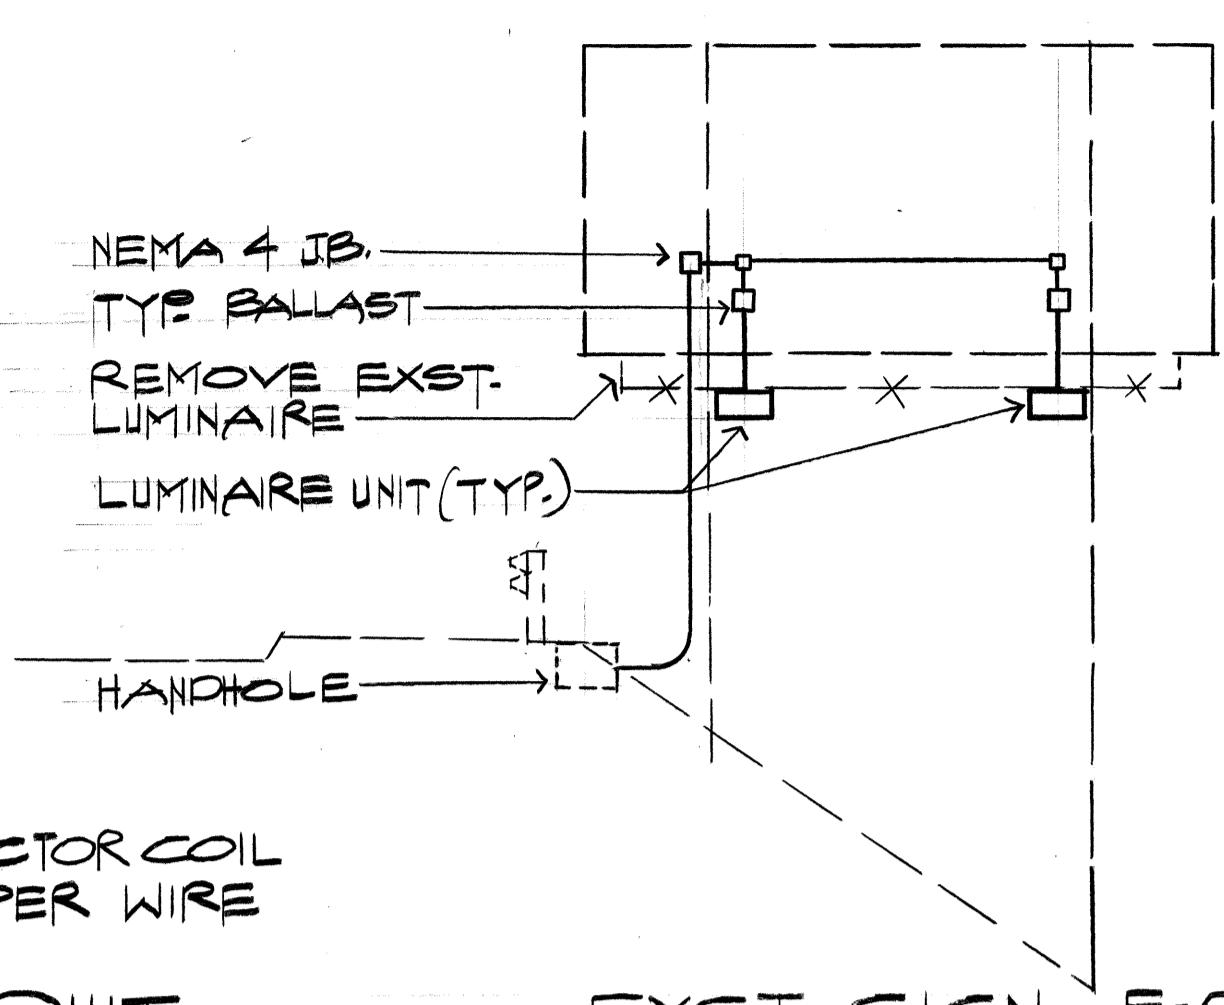

EXT. SIGN E-22
SEE SHT. 14L

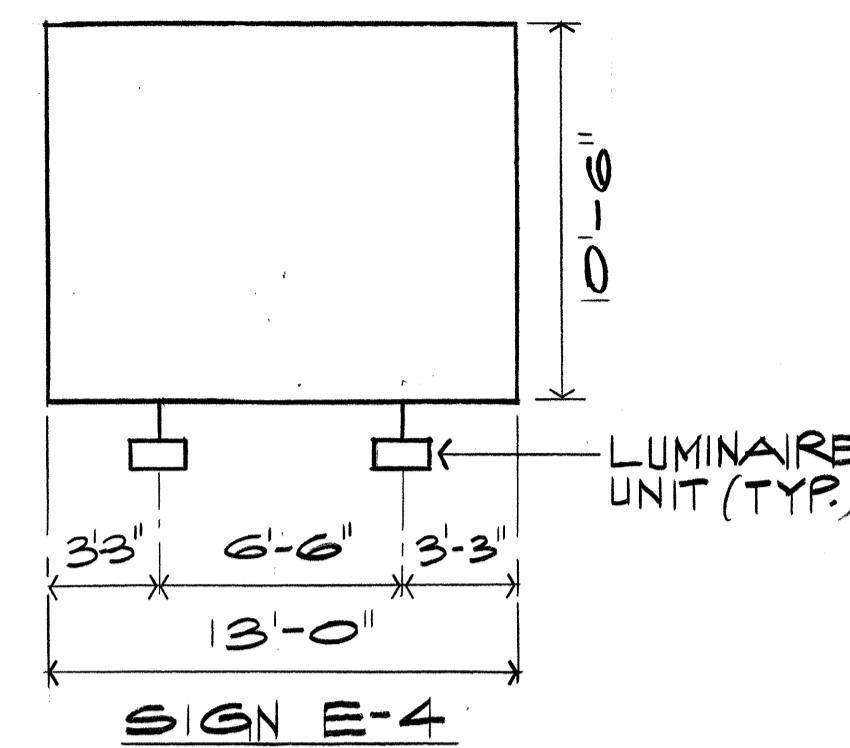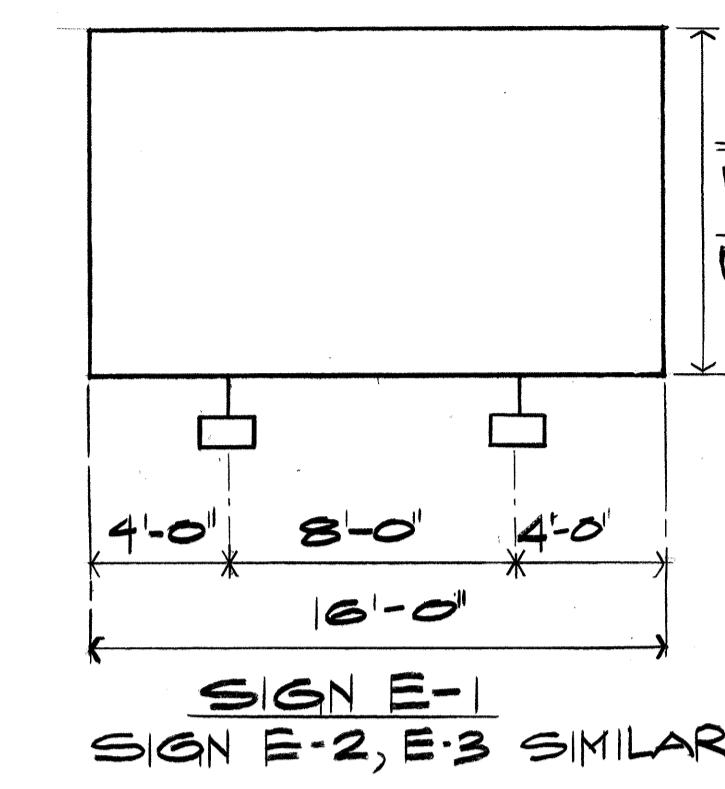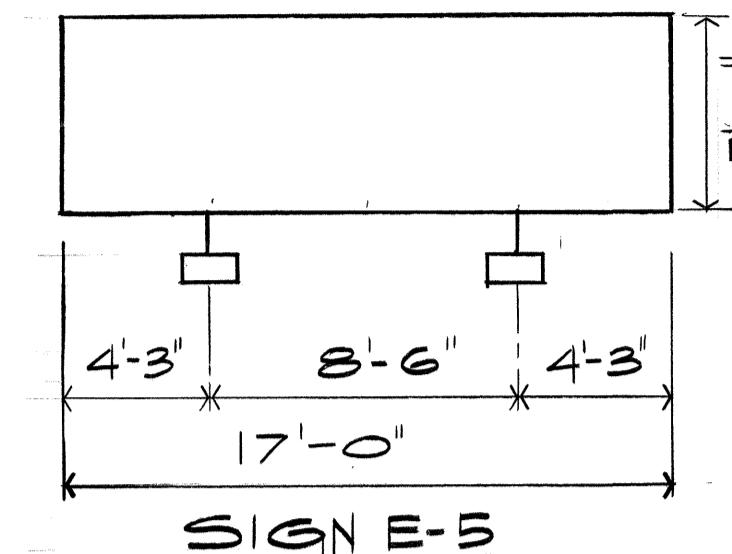


LUMINAIRE SPACING DETAIL
N.T.S.

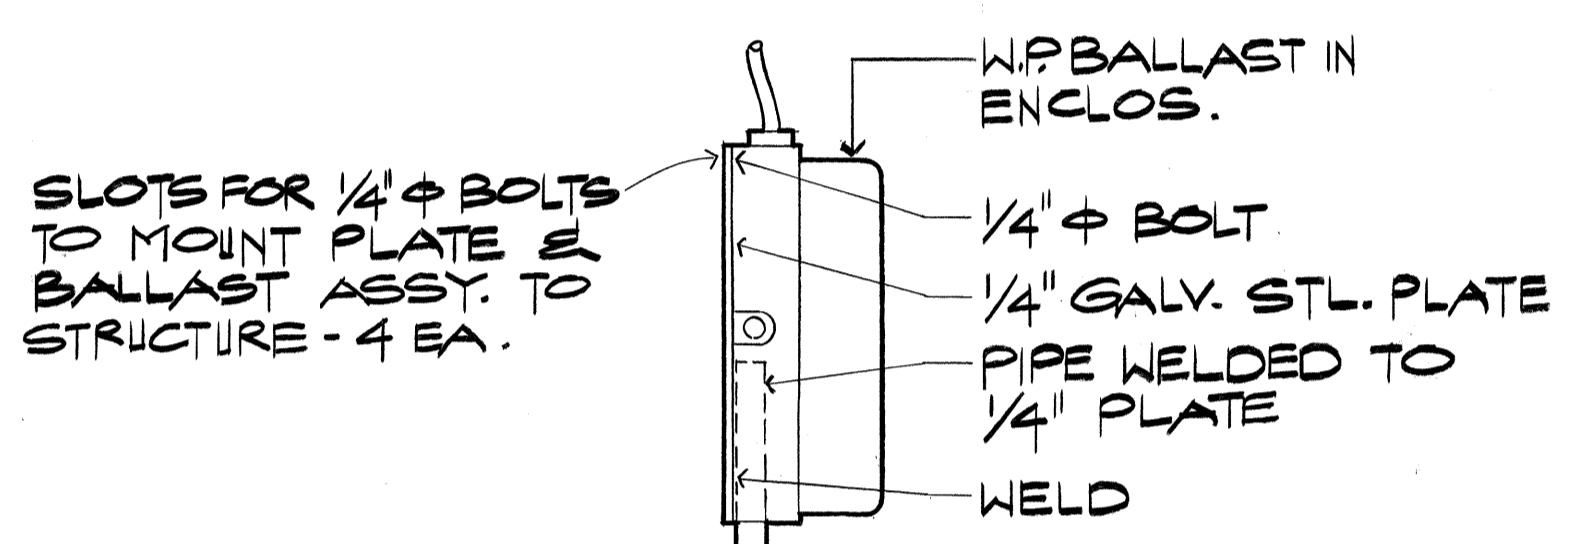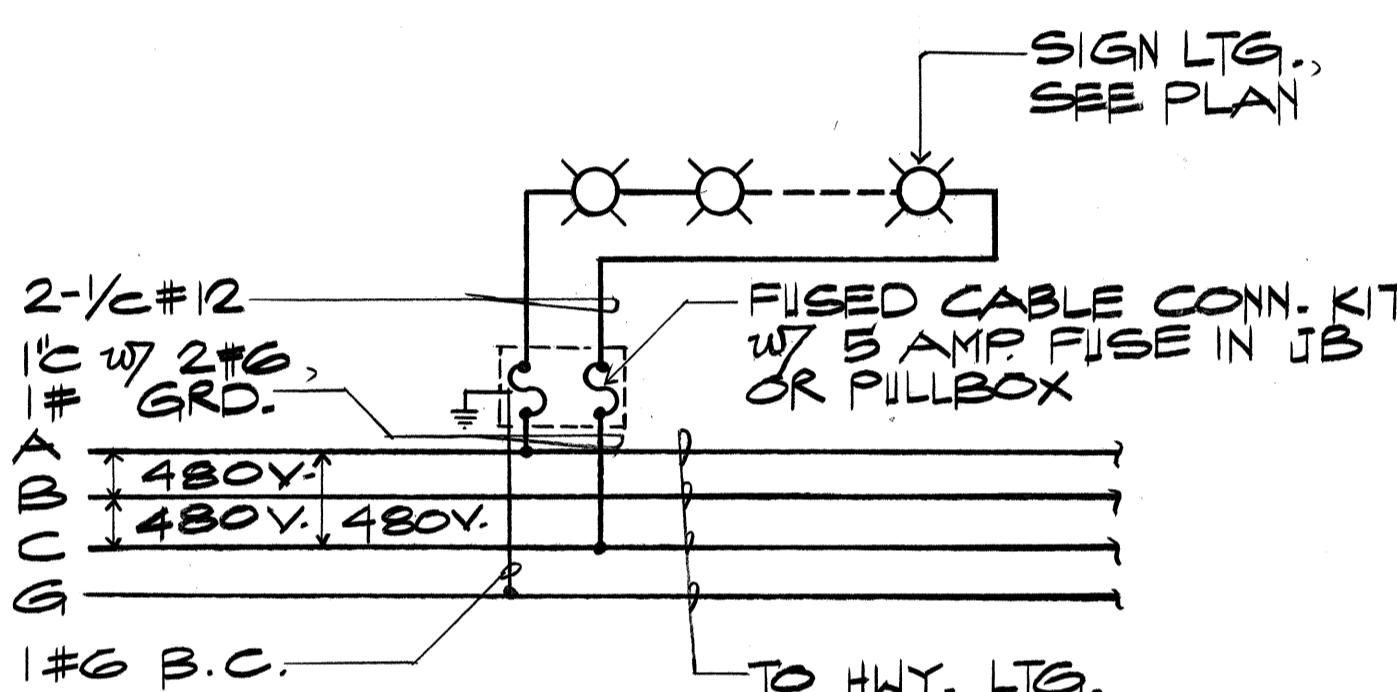


SIGN LIGHTING WIRING
N.T.S.

- NOTES:
1. SUPPORT CONDUITS AT 10'-0" ± MAX. INTERVALS.
 2. SUPPORT CONDUITS 3'-0" MAX. FROM JB.
 3. UNIFORMITY RATIO 3.1/1 WHEN SPACED 10'-0" O.C. WHEN RETROREFLECTING SIGN IS USED (1200' VIEWING DISTANCE) MIN. AVG. FT 17.
 4. PIPE & STL. PLATE ASSY. TO BE CAPABLE OF SUPPORTING LUMINAIRE & BALLAST TO W/ STAND 100 MPH WINDS. BOLTS ATTACHING BALLAST TO STL. PLATE & STL. PLATE TO STRUCTURE TO BE PER MFRS. RECOMMENDATIONS & SHALL SUPPORT THE LUMINAIRE, BALLAST PIPE & STL. PIPE & STL. ASSY. TO W/ STAND DAMAGE AGAINST 100 MPH WINDS.
 5. 4 CONDUITS TO BE 3/4" GALV. RIGID STL.
 6. ALL EQUIP. TO BE NEMA 3R OUTDOOR TYPE.
 7. FOR CONN. OF SIGN LTG. TO HWY. LTG. CKT. SEE SIGN LIGHTING WRING, NOTE 7. THIS SHT.
 8. LUMINAIRE ASSY. PRISMATIC REFRACTOR THERMAL SHOCK RESISTANT GLASS W/ RETRODISPERSING REFLECTOR FOR UNIFORM SIGN LUMINANCE.
 9. MAIN HSG. CAST ALUM. SLIPFITTER TYPE BALLAST BACK MTD. 480V, REGULATOR TYPE W/ HPF ABV. 90%, RIP SUPPRESSION TYPE.
 10. FOR APPLICABLE REQUIREMENTS, SEE SHT. 25L DT 208

BALLAST-STEEL PLATE DETAIL
N.T.S.

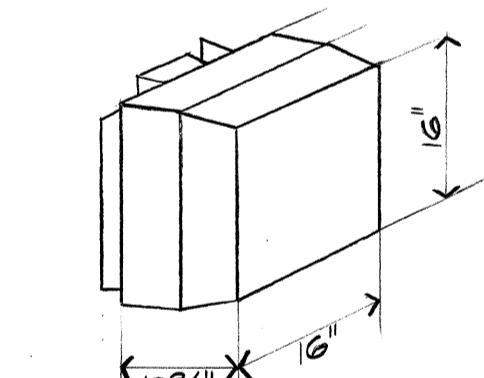

DATA BASED ON 400 WATT HPS
50,000 LUMEN LAMP @ 15' MOUNTING
HT. PROVIDE LAMP DESIGNATION
LU 400.
PROVIDE TRUNION WHERE
SHOWN.

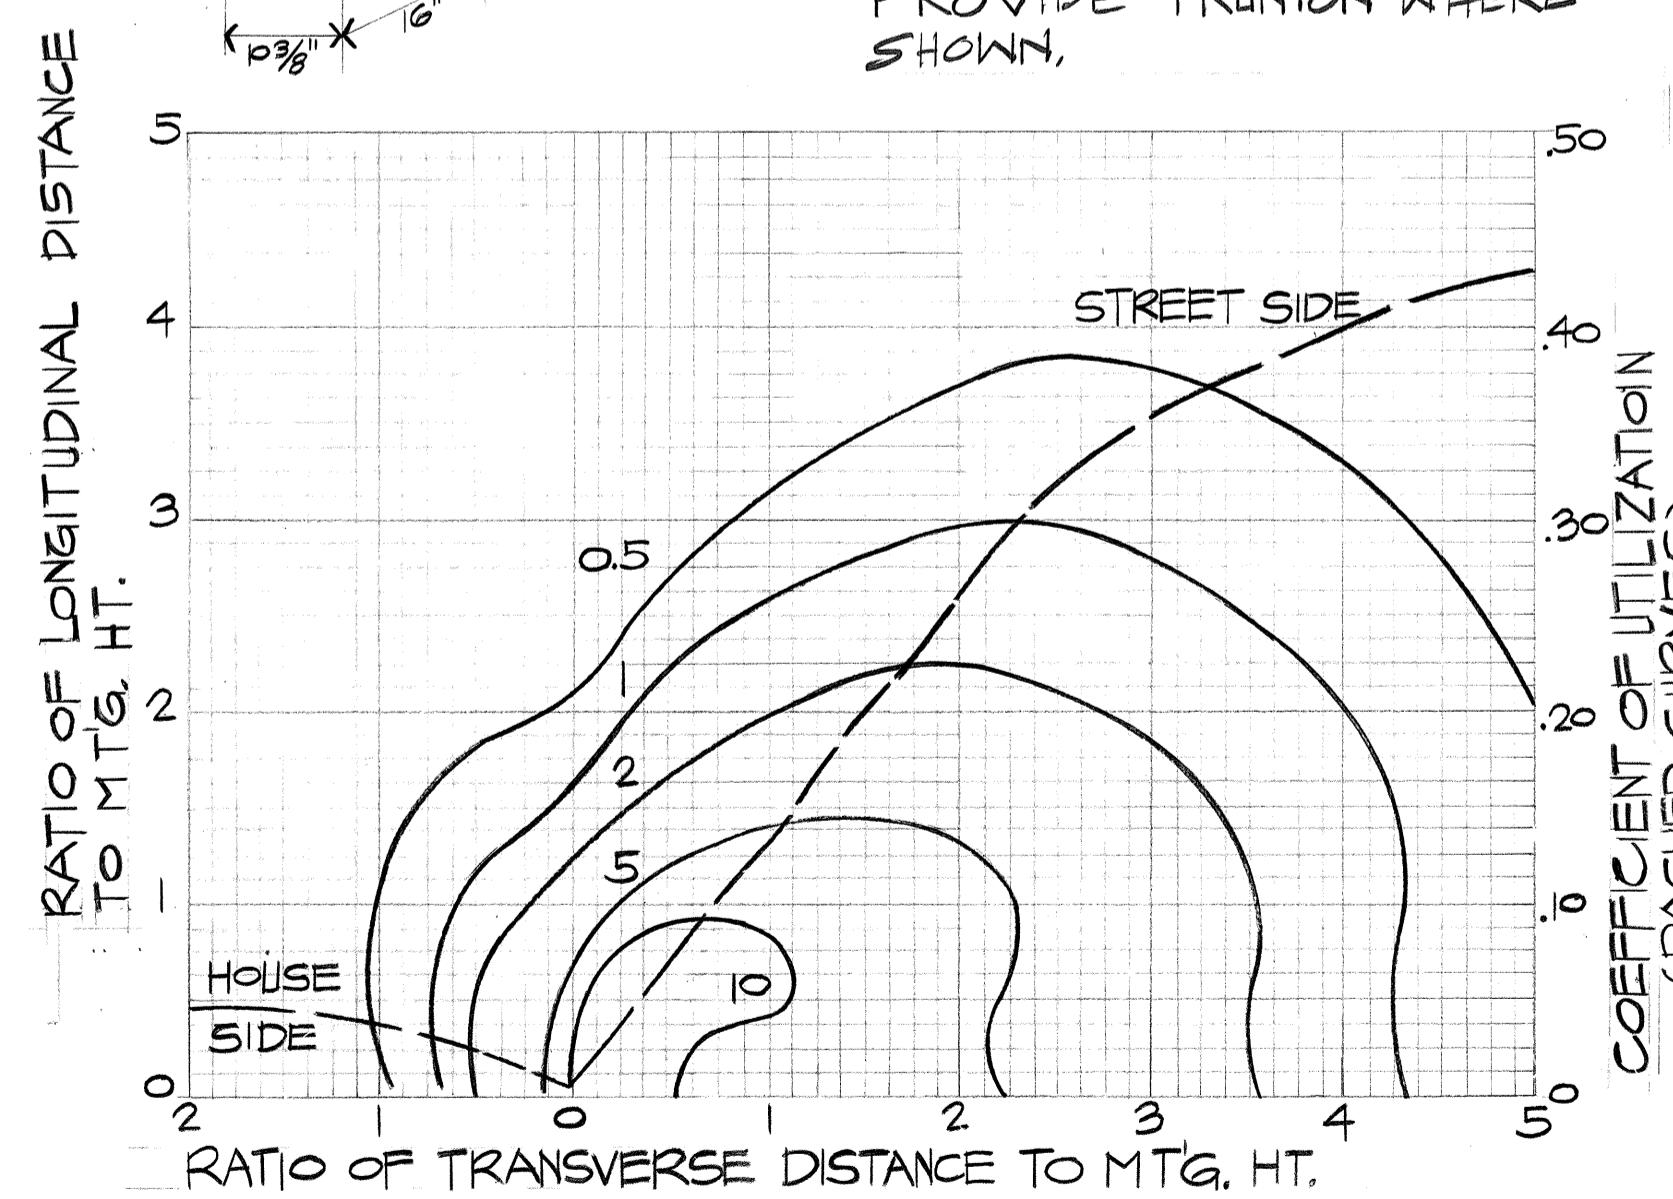

ISOFOOTCANDLE & UTILIZATION CURVES
Fixture Type "A" for Structures




MARSH, KAHANAKA & ASSOC., INC.
One Kamoku Street, Suite 400
800 Kaahoolawe Boulevard
Honolulu, Hawaii 96812



John Nakamura
F.I.C.E.

STATE OF HAWAII
DEPARTMENT OF TRANSPORTATION
LAND TRANSPORTATION FACILITIES DIVISION
SIGN LIGHTING DETAILS
INTERSTATE H-1 IMPROVEMENTS
MIDDLE STREET TO KALIHI INTERCHANGE
EASTBOUND LANES
F.A.I. PROJECT NO. I -HI-1(178)

FED. ROAD DIST. NO.	STATE	FED. AID PROJ. NO.	FISCAL YEAR	SHEET NO.	TOTAL SHEETS
HAWAII	HAW.	I - HI-I(178)	1982	112	165

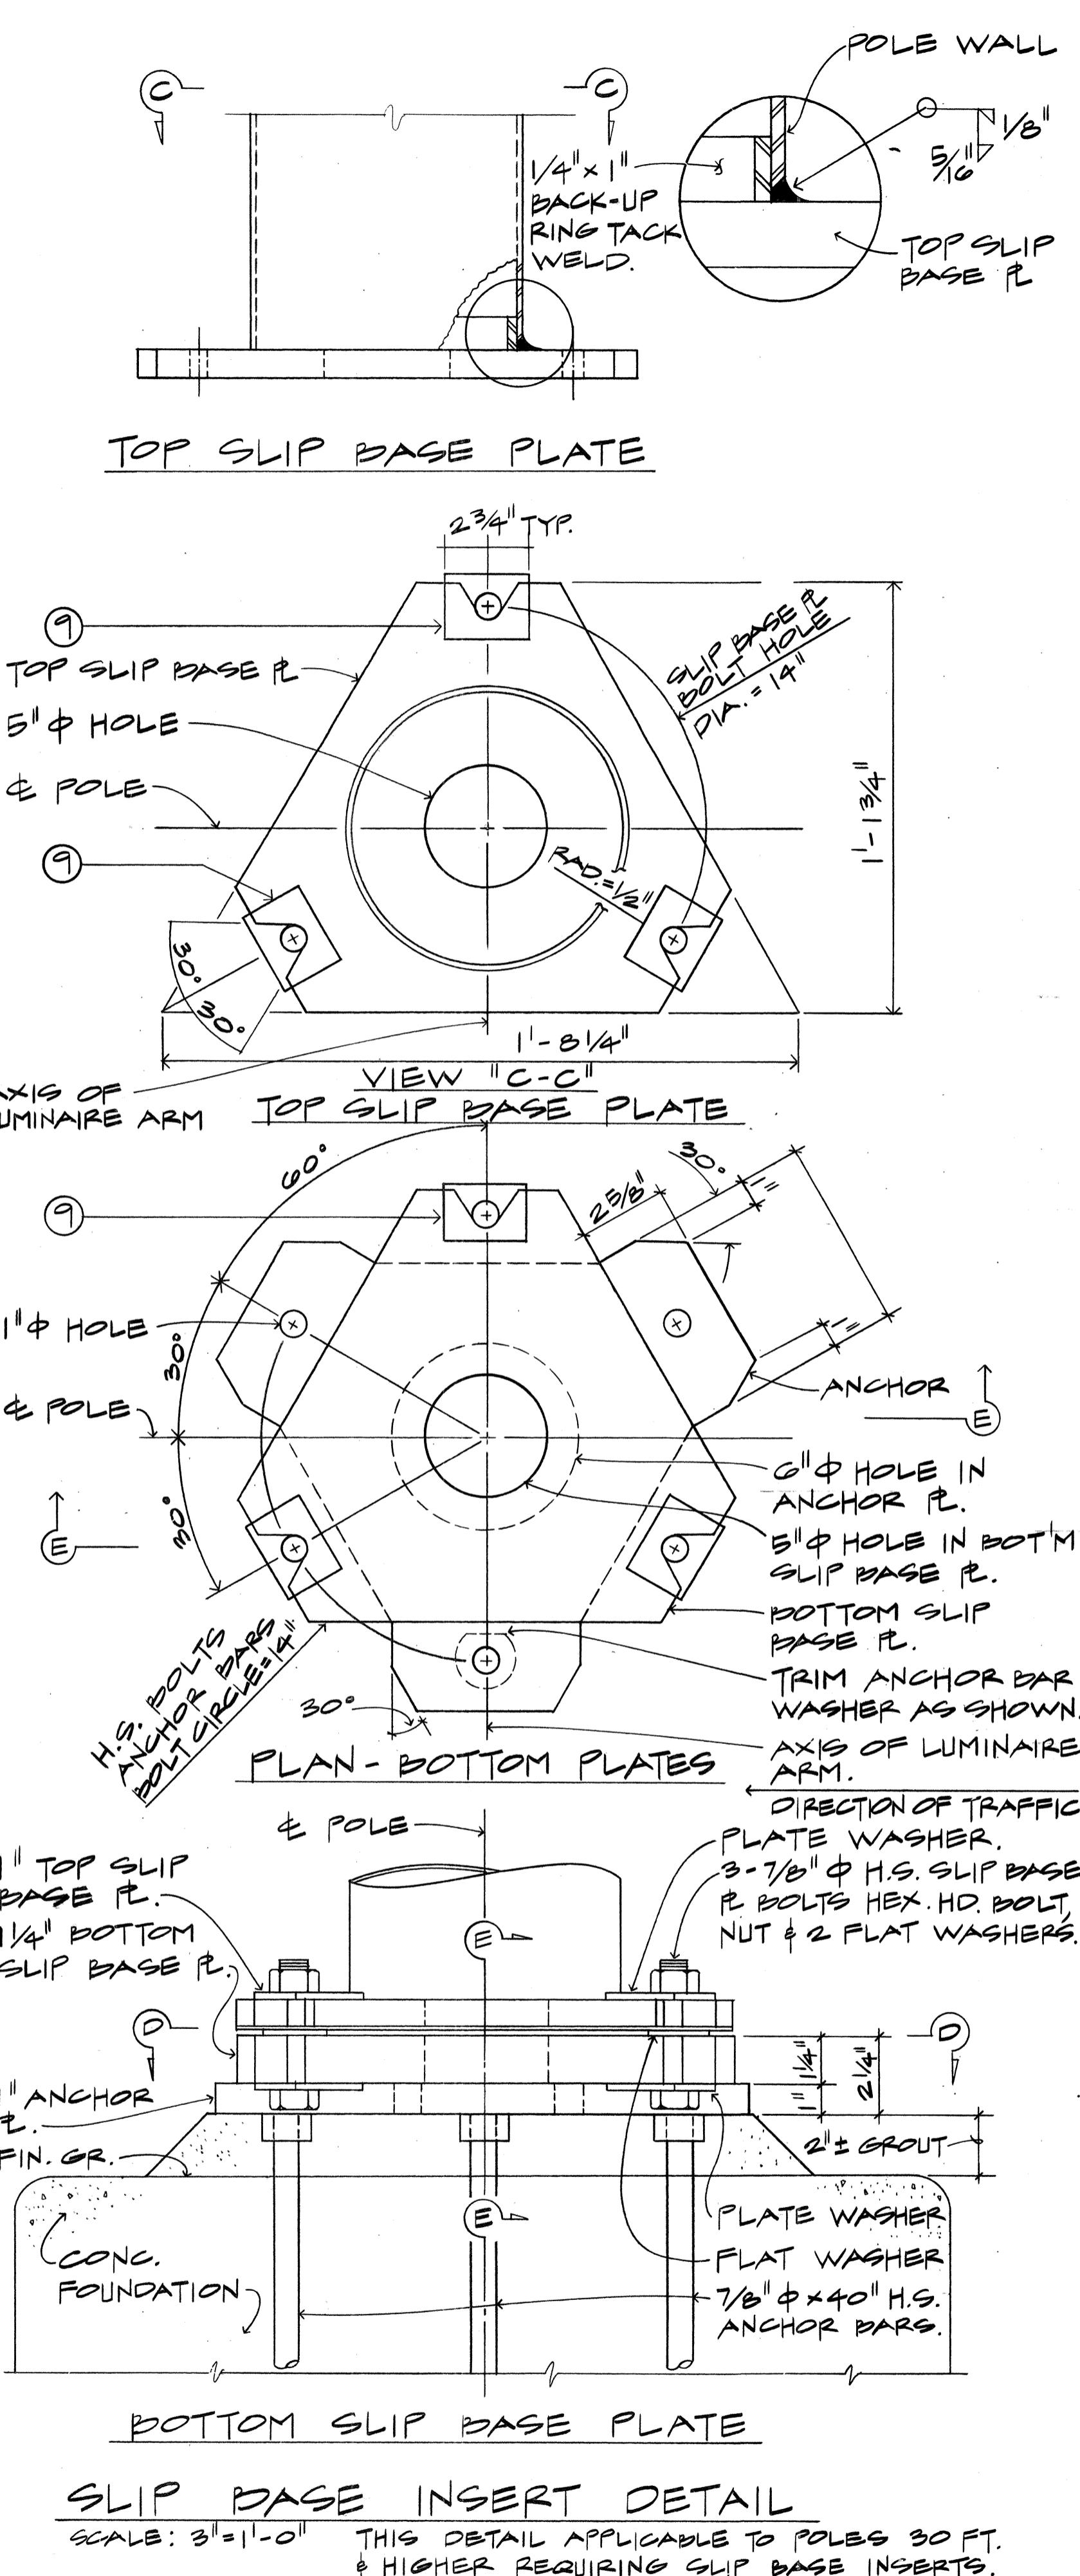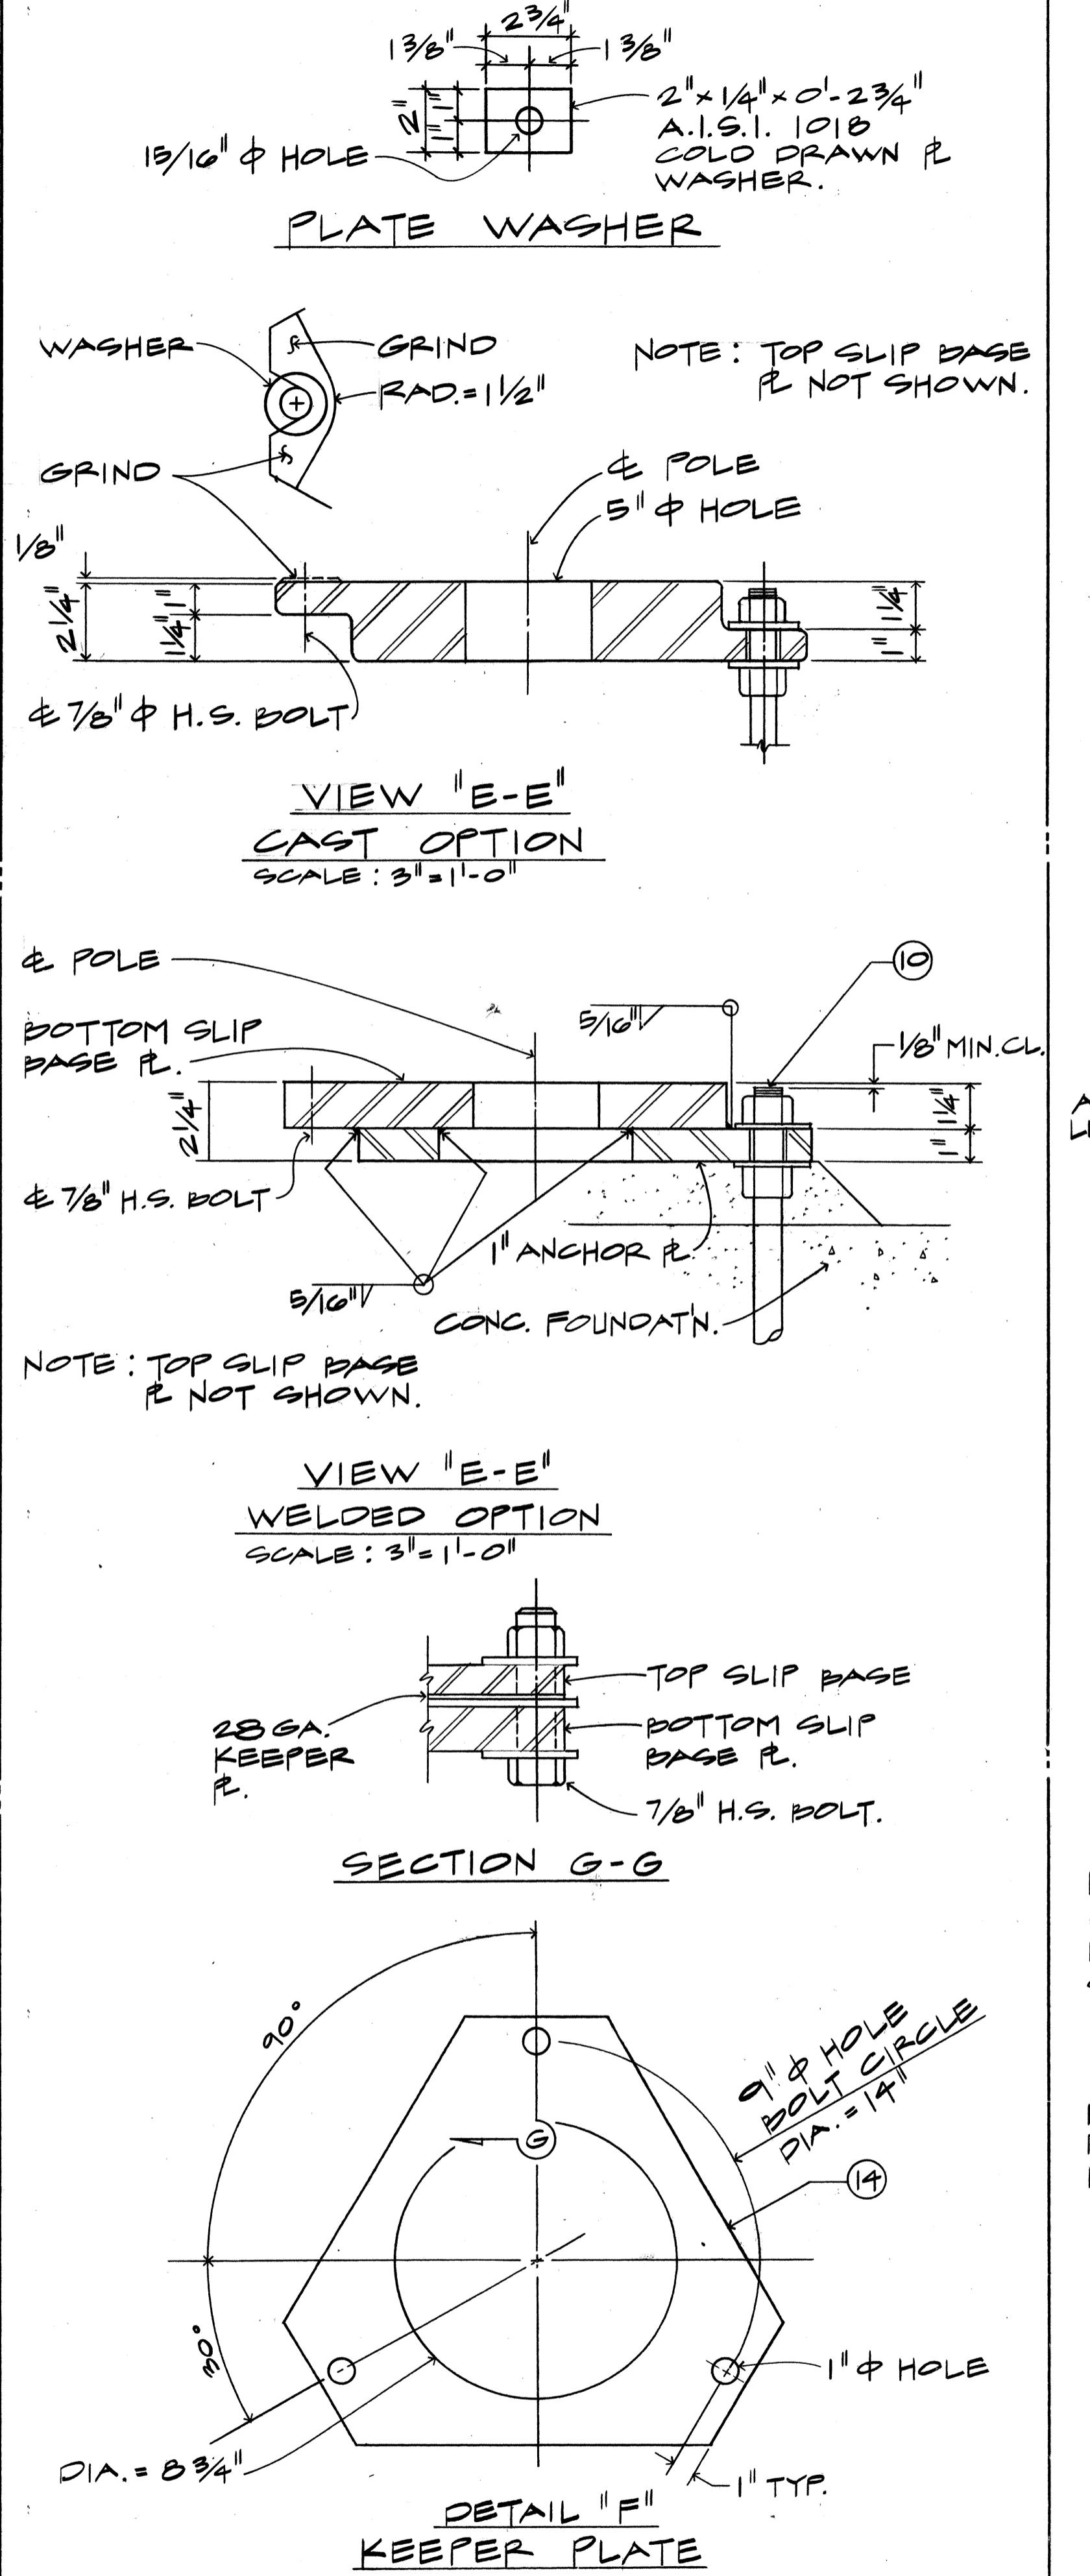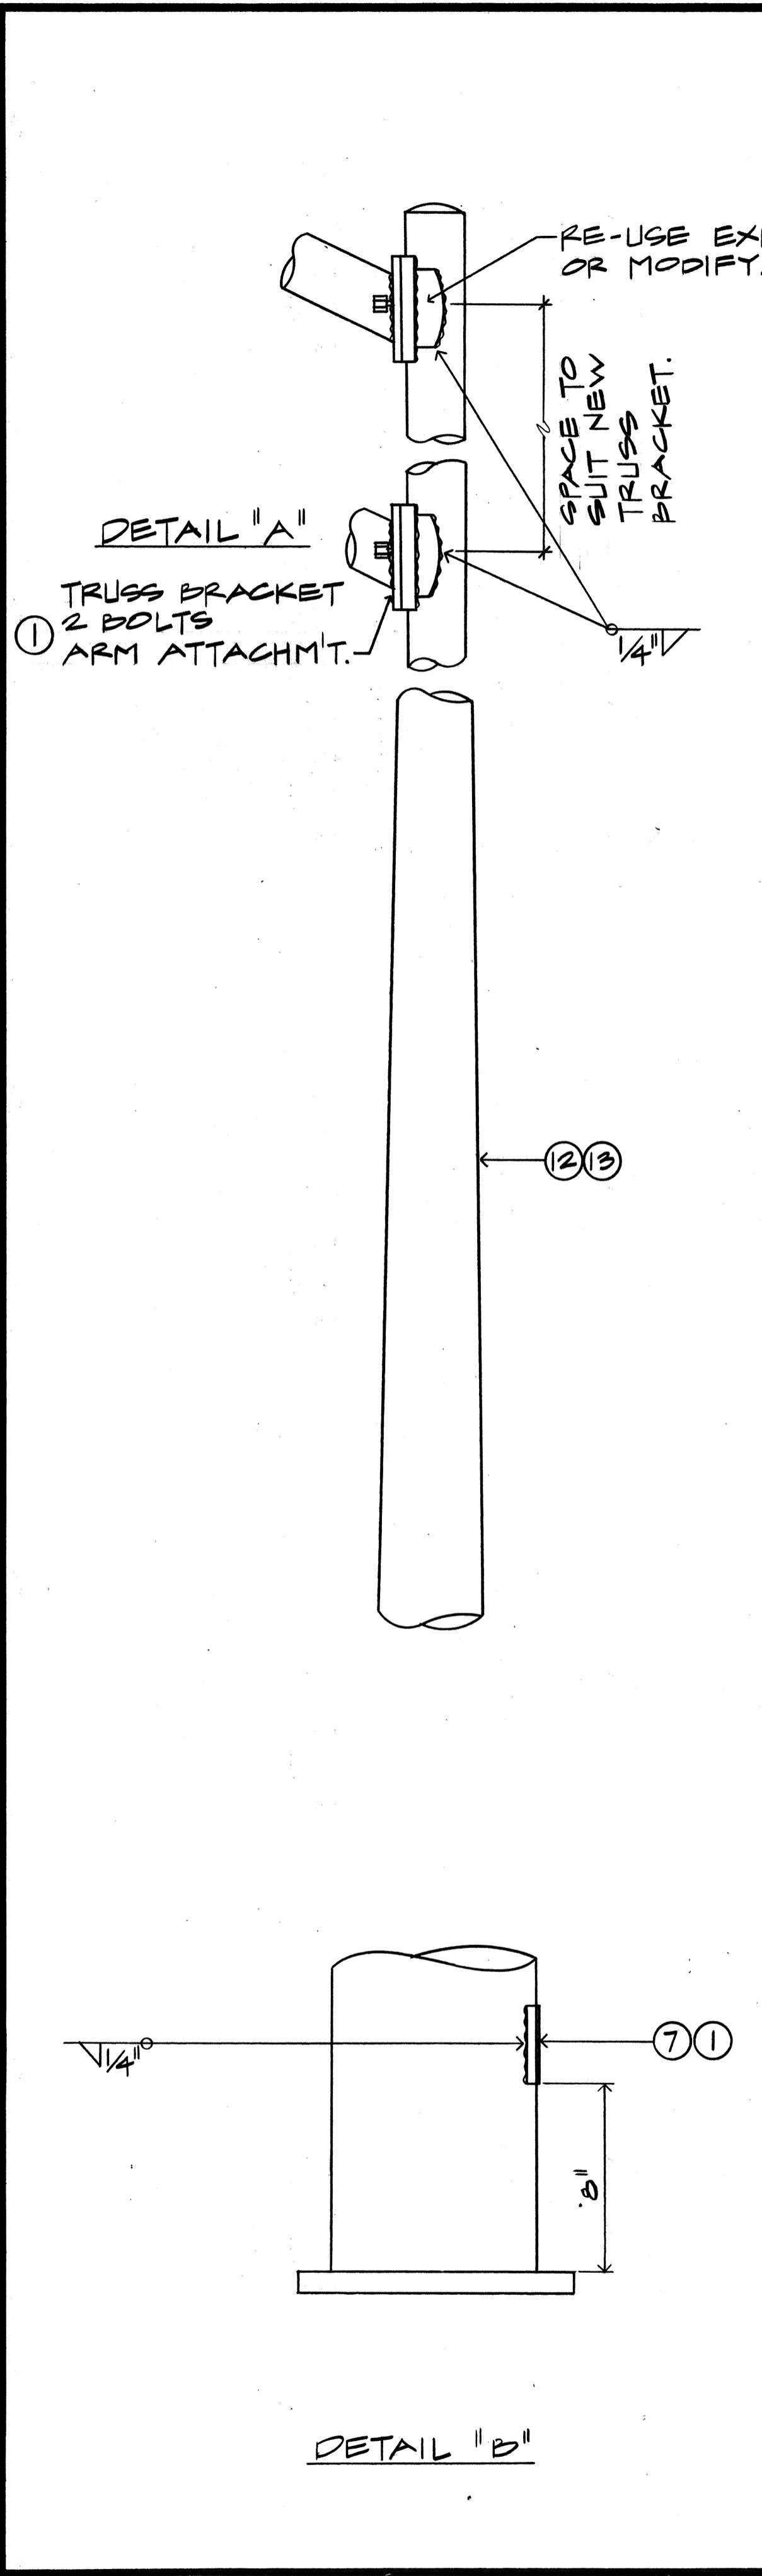


- NOTES:**
- ① ALL STEEL SHAFTS, PL'S, MAST ARMS, BOLTS, SCREWS, NUTS & WASHERS TO BE GALV. AFTER FAB. OR MODIFICATION.
 - ② PL'S TO CONFORM TO ASTM A-36.
 - ③ CAST OPTION TO CONFORM TO ASTM A-480 CL.90.
 - ④ TORQUE 7/8" H.S. SLIP BASE PL BOLTS TO 1000 INCH LBS.
 - ⑤ 7/8" H.S. ANCHOR BARS, WRENCH TIGHTEN-TORQUE REQ MT. WAIVED.
 - ⑥ FABRICATORS ELECTING LARGER THAN MIN. ARM DIAMETERS MUST ADJUST DETAILS AS REQ'D. TO PERMIT SOLID SEATING OF CAP SCREWS. IN LIEU OF TORQUE REQ'MTS. FOR H.S. BOLTS, CAP SCREWS SHALL BE TIGHTENED BY THE TURN-OFF-NUT METHOD 1/6 TURN FROM SNUG TIGHT CONDITION. NO WASHER WILL BE REQ'D.
 - ⑦ 4" x 6 1/2" HANOHOLE REINF. W/ #3 GA. RING 1 1/2" WIDE WELDED TO OUTSIDE OF POLE COVER OF 10 GA. PL LOCATE 90° OF MAST ARM UNLESS SHOWN OTHERWISE
 - ⑧ UNASSIGNED.
 - ⑨ PLATE WASHER
 - ⑩ 3-7/8" H.S. BARS, THREAD 6" & GALV. 10", W/ HEX. HD. NUT, LEVELING NUT & WASHER.
 - ⑪ HEX. HD. NUT SHOWN OR AS ALT. DET. ANCHOR PL'S MAY BE RETAINED W/ 5/16" FILLET WELDS ALL ROUND OR FORMED HEADS.
 - ⑫ ROUND TAPERED STEEL TUBE W/ MAX. TAPER OF 0.15" / FT.
 - ⑬ NO. 11 GA. SHT. STEEL OF WELDABLE GRADE ACCEPTABLE IF STEEL AFTER FAB. HAS A MIN. YIELD STRENGTH OF 40,000 PSI.
 - ⑭ 28 GA. KEEPER PL. PLACE ON TOP OF FLAT WASHER, ASTM A52G, 125 COMMERCIAL.
 - ⑮ SLIP BASE INSERT DET. ON THIS SHT. APPLICABLE FOR POLE STD'S. TALLER THAN 25'-0".

STATE OF HAWAII
DEPARTMENT OF TRANSPORTATION
LAND TRANSPORTATION FACILITIES DIVISION
SLIP BASE INSERT STANDARD
INTERSTATE H-I IMPROVEMENTS
MIDDLE STREET TO KALIHI INTERCHANGE
EASTBOUND LANES
F.A.I. PROJECT NO. I - HI-I(178)


SHEET NO. 21 LOF SHEETS

FED. ROAD DIST. NO.	STATE	FED. AID PROJ. NO.	FISCAL YEAR	SHEET NO.	TOTAL SHEETS
HAWAII	HAW.	I -HI-I(178)	1982	113	165

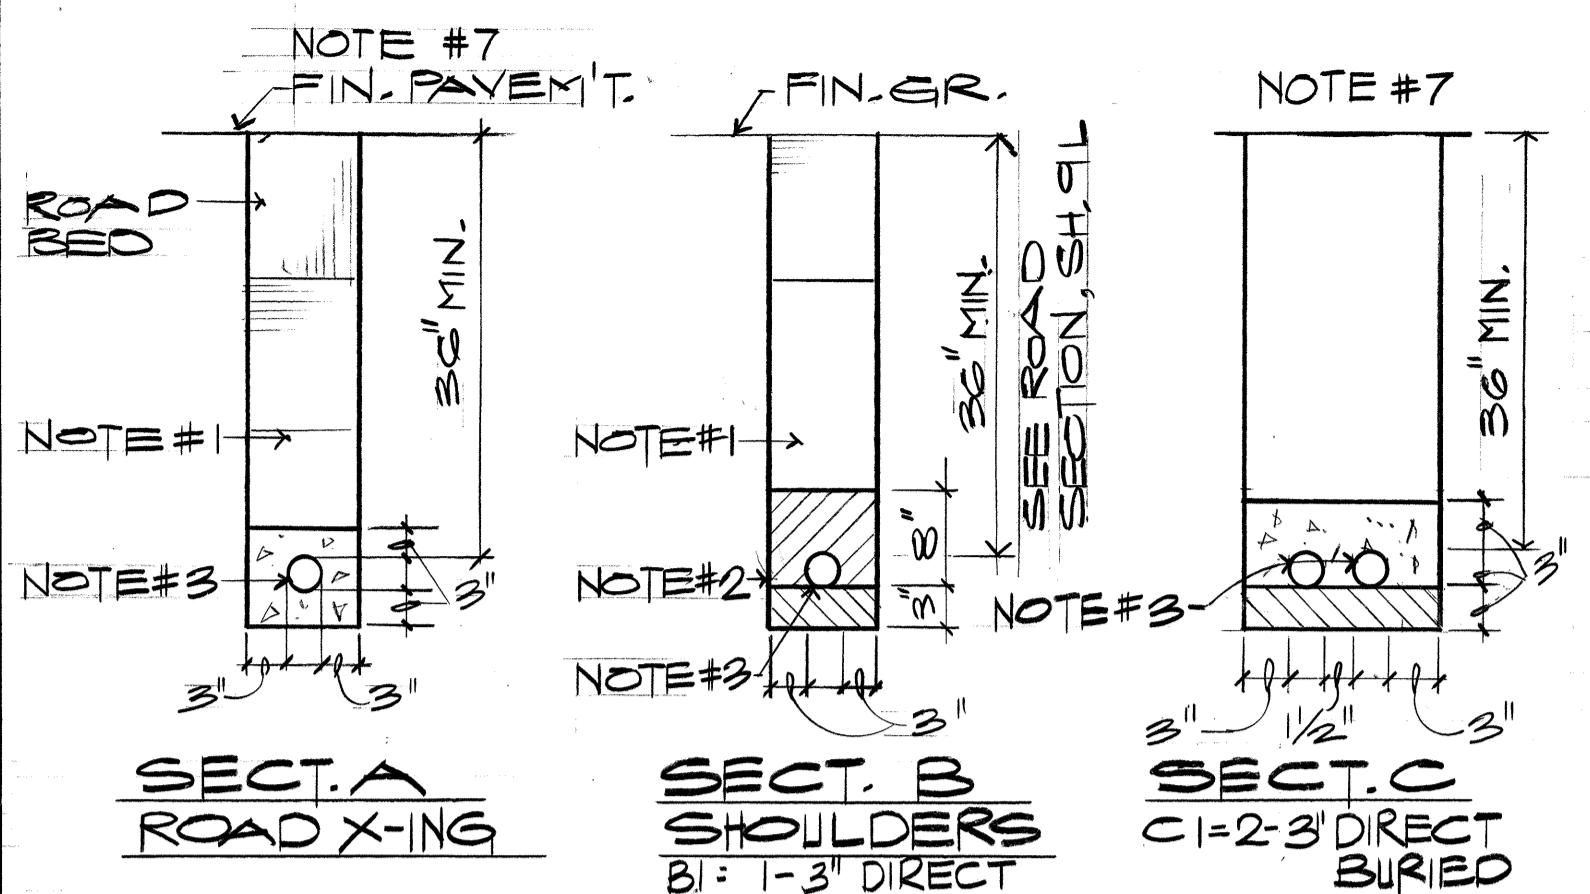


TYPICAL DUCT SECTIONS


NOTE #5

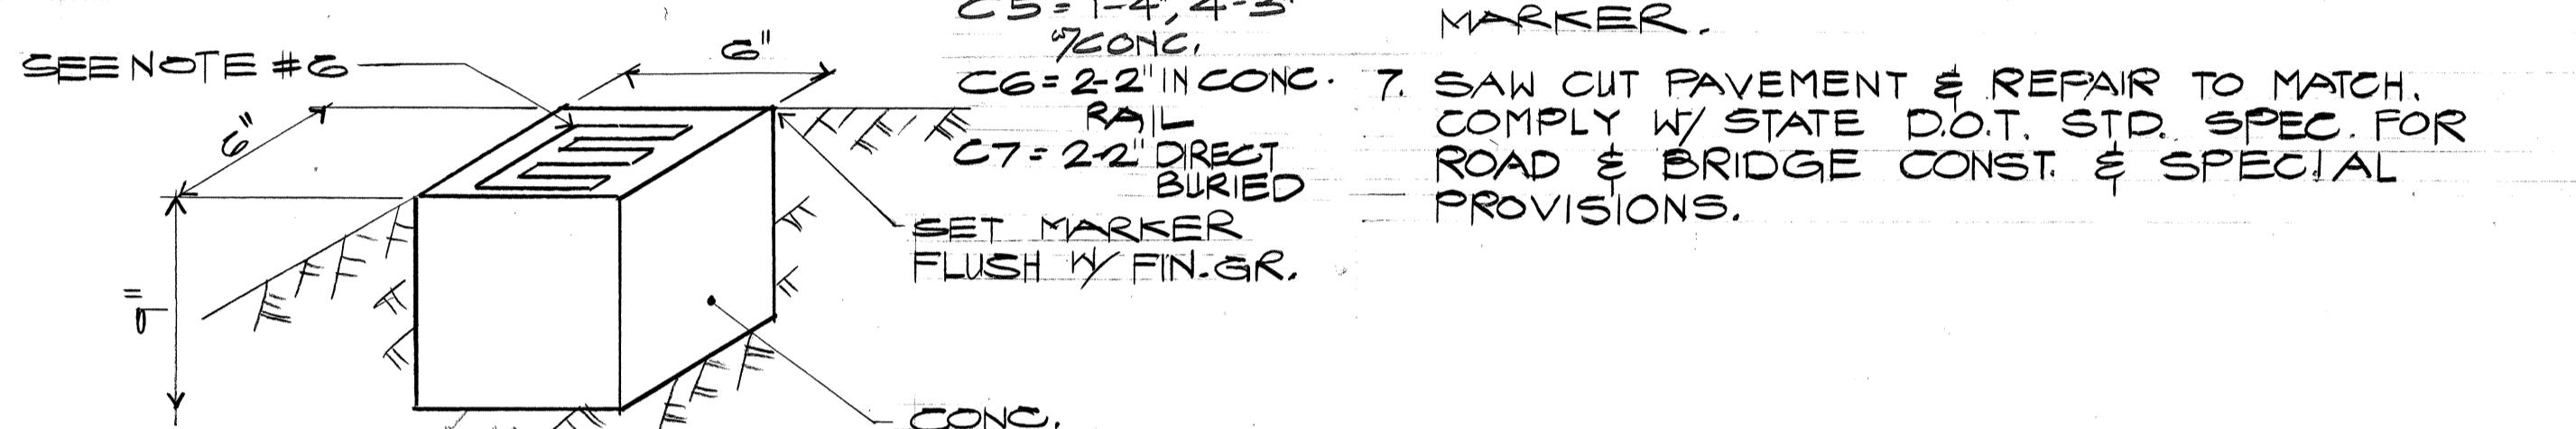

MARKER FOR STUB-OUT N.T.S.

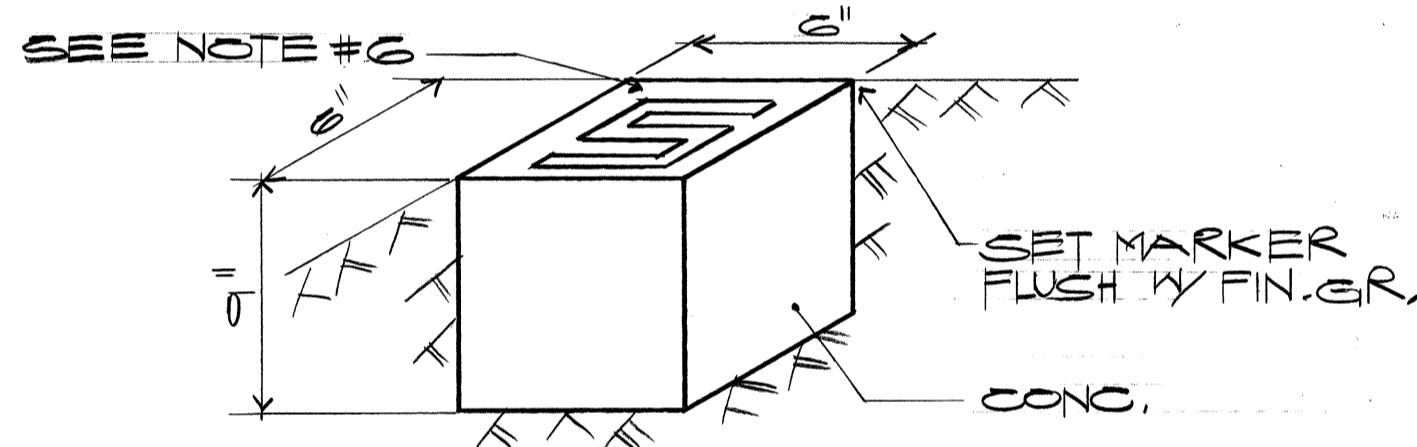

MARKER FOR CABLE SPLICE N.T.S.

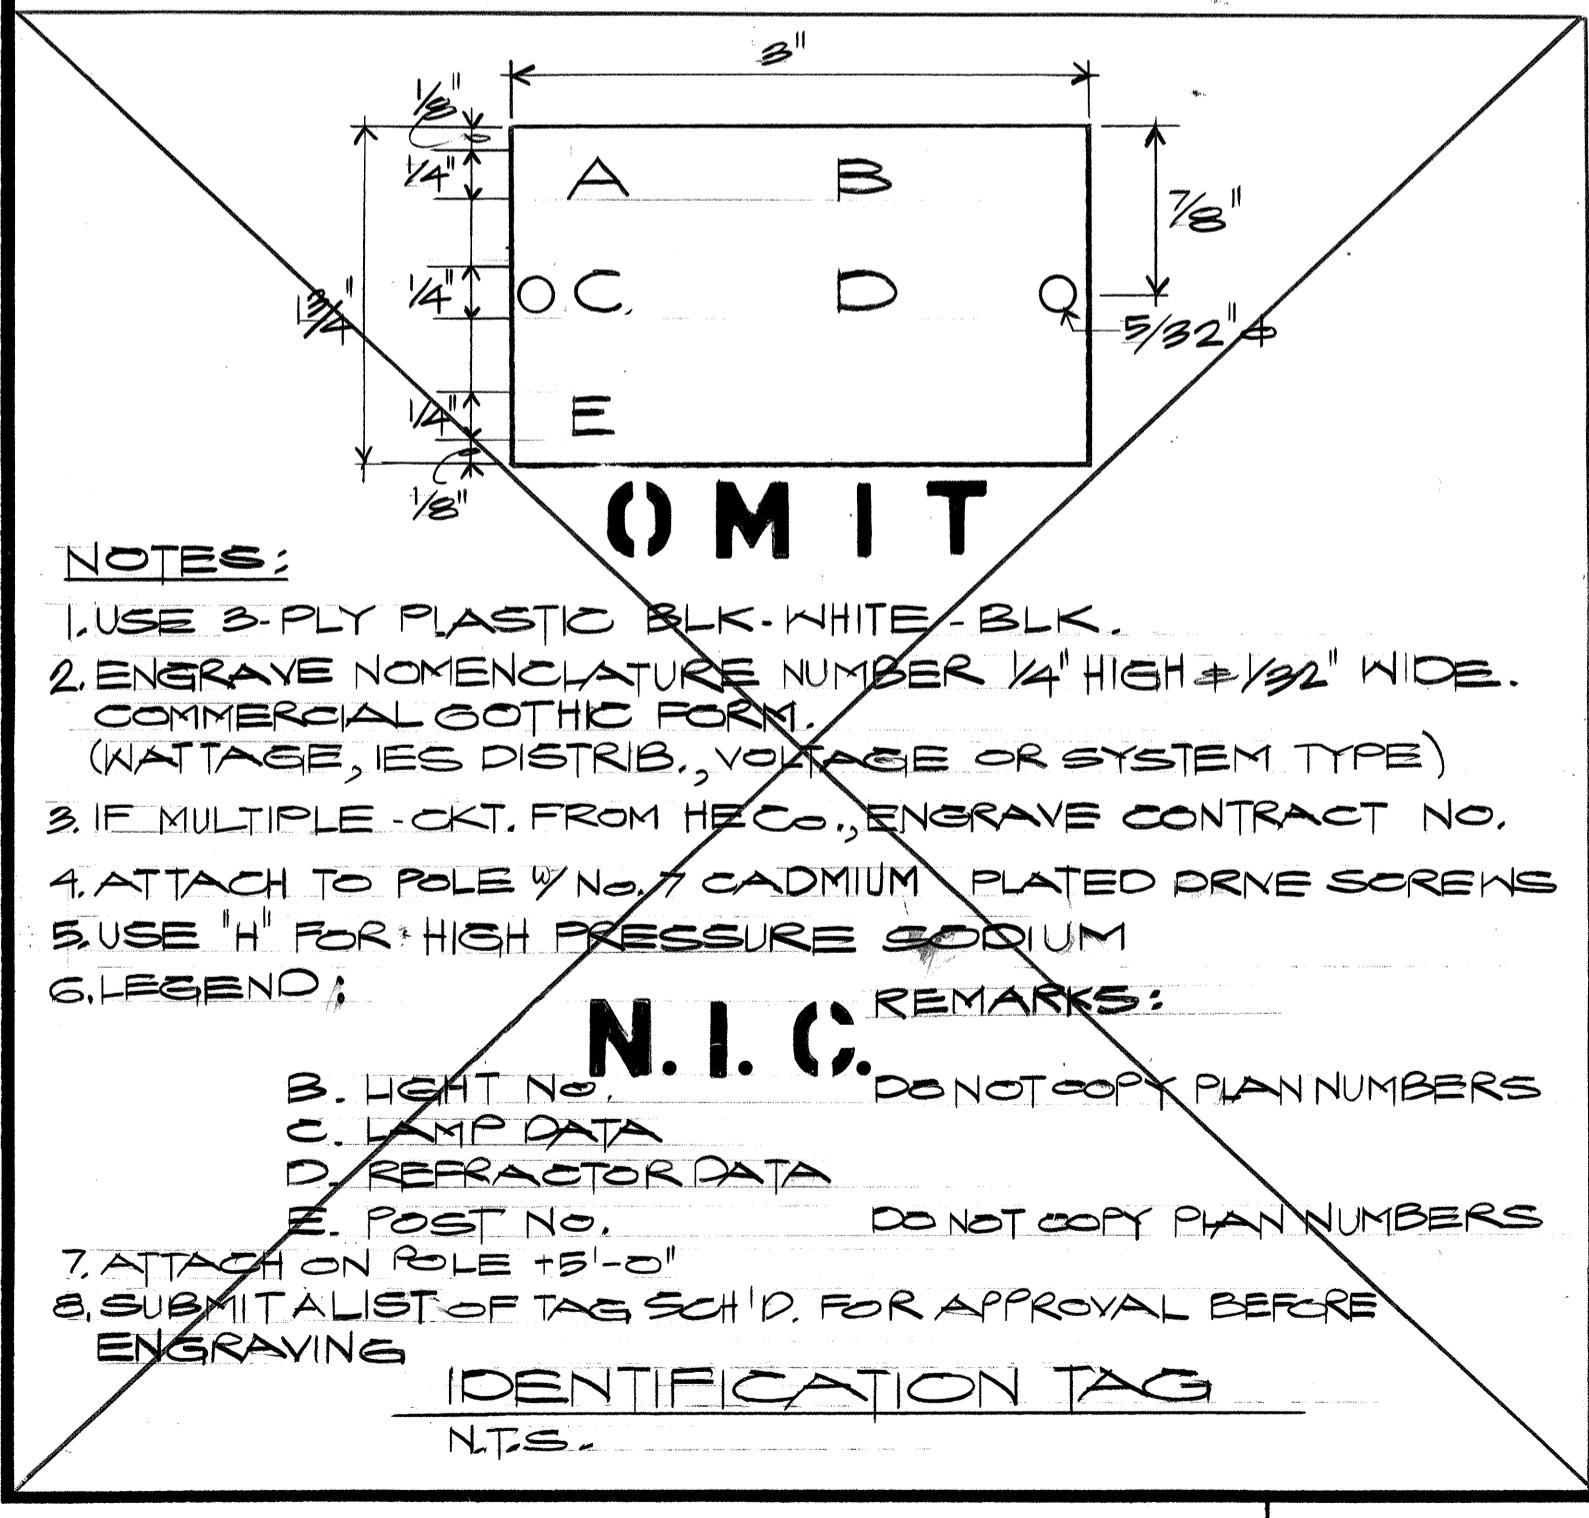

NOTES:

1. TYPE "A" BACKFILL, BEACH SAND, EARTH OR EARTH & GRAVEL. IF EARTH & GRAVEL THE MAX. ROCK SIZE SHALL BE 1" IN THE MIX. SHALL NOT CONTAIN MORE THAN 50% BY VOL. OF ROCK PARTICLES.

2. TYPE "B" BACKFILL, BEACH SAND, EARTH OR EARTH & GRAVEL, IF EARTH & GRAVEL THE MIX. MUST PASS A 1/2" MESH SCREEN & CONTAIN NOT MORE THAN 20% BY VOL. OF ROCK PARTICLES.

3. CONDUIT, 2" PVC, SCH 40
4. PRIM. CONN. USED ONLY BETWEEN BALLASTS & LUMINAIRE IN POLE SHAFT ACCESSIBLE VIA HANDHOLE


5. FOR CONDUIT POSITION, SEE SHT.
6. 2" HIGH X 1/2" DEEP LETTER ENGRAVED IN MARKER.

7. SAW CUT PAVEMENT & REPAIR TO MATCH, COMPLY W/ STATE D.O.T. STD. SPEC. FOR ROAD & BRIDGE CONST. & SPECIAL PROVISIONS.

HANDHOLES A, B & C

NOTE:

1. PROVIDE 5/8" X 8'-0" LONG COPPERCLAD GROUND ROD w/ BRONZE SQ. HEAD SET SCREW & CLAMP IN ALL PULLBOXES.

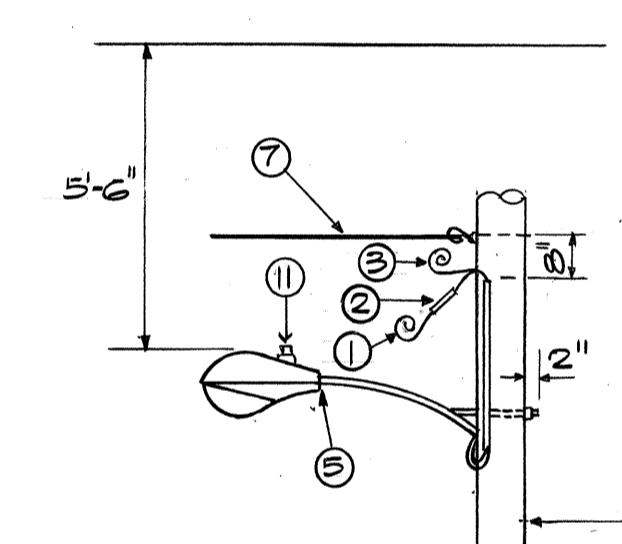

TANGENT

DEAD-END

ITEM DESCRIPTION

1. 1/0 NO.8AWG RHW - USE BLACK, STRANDED WIRE.
2. IN-LINE FUSE HOLDER & 5A FUSE FOR NO.8AWG COPPER WIRE.
3. 1/0 NO.8 AWG RHW - USE WHITE STRANDED WIRE.
4. 3/4" PVC SCH'D. 40 W/ NO.10 AWG CU. WIRE.
5. REPLACE FIXTURE LUMINAIRE & REUSE BRACKET.
6. EXST. WOOD POLE.
7. SEE PLAN.

MULTIPLE STREET LIGHT

ON WOOD POLE

N.T.S.














John Nakamura
Engr. Work was prepared by
for Under Contract


STATE OF HAWAII
DEPARTMENT OF TRANSPORTATION
LAND TRANSPORTATION FACILITIES DIVISION
MISCELLANEOUS ELECTRICAL DETAILS
INTERSTATE H-I IMPROVEMENTS
MIDDLE STREET TO KALIHI INTERCHANGE
EASTBOUND LANES
F.A.I. PROJECT NO. I -HI-I (178)

SHEET NO. 22 OF SHEETS



FED. ROAD DIST. NO.	STATE	FED. AID PROJ. NO.	FISCAL YEAR	SHEET NO.	TOTAL SHEETS
HAWAII	HAW.	I - HH078	1982	114	165

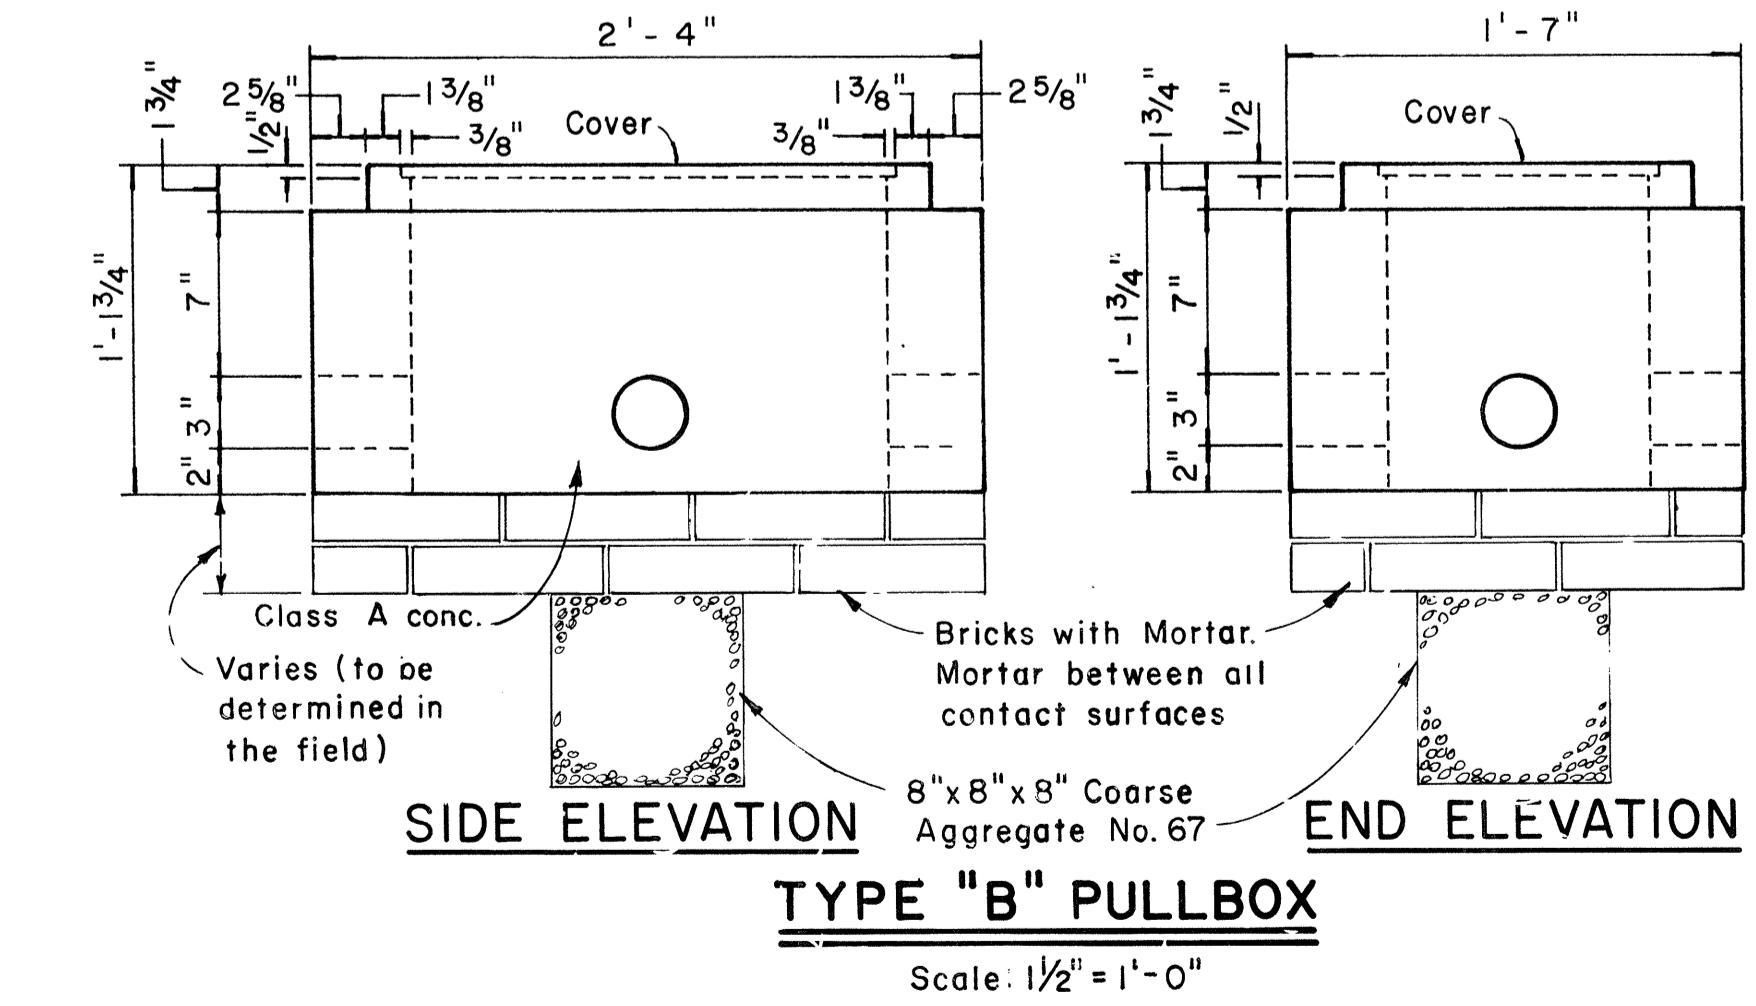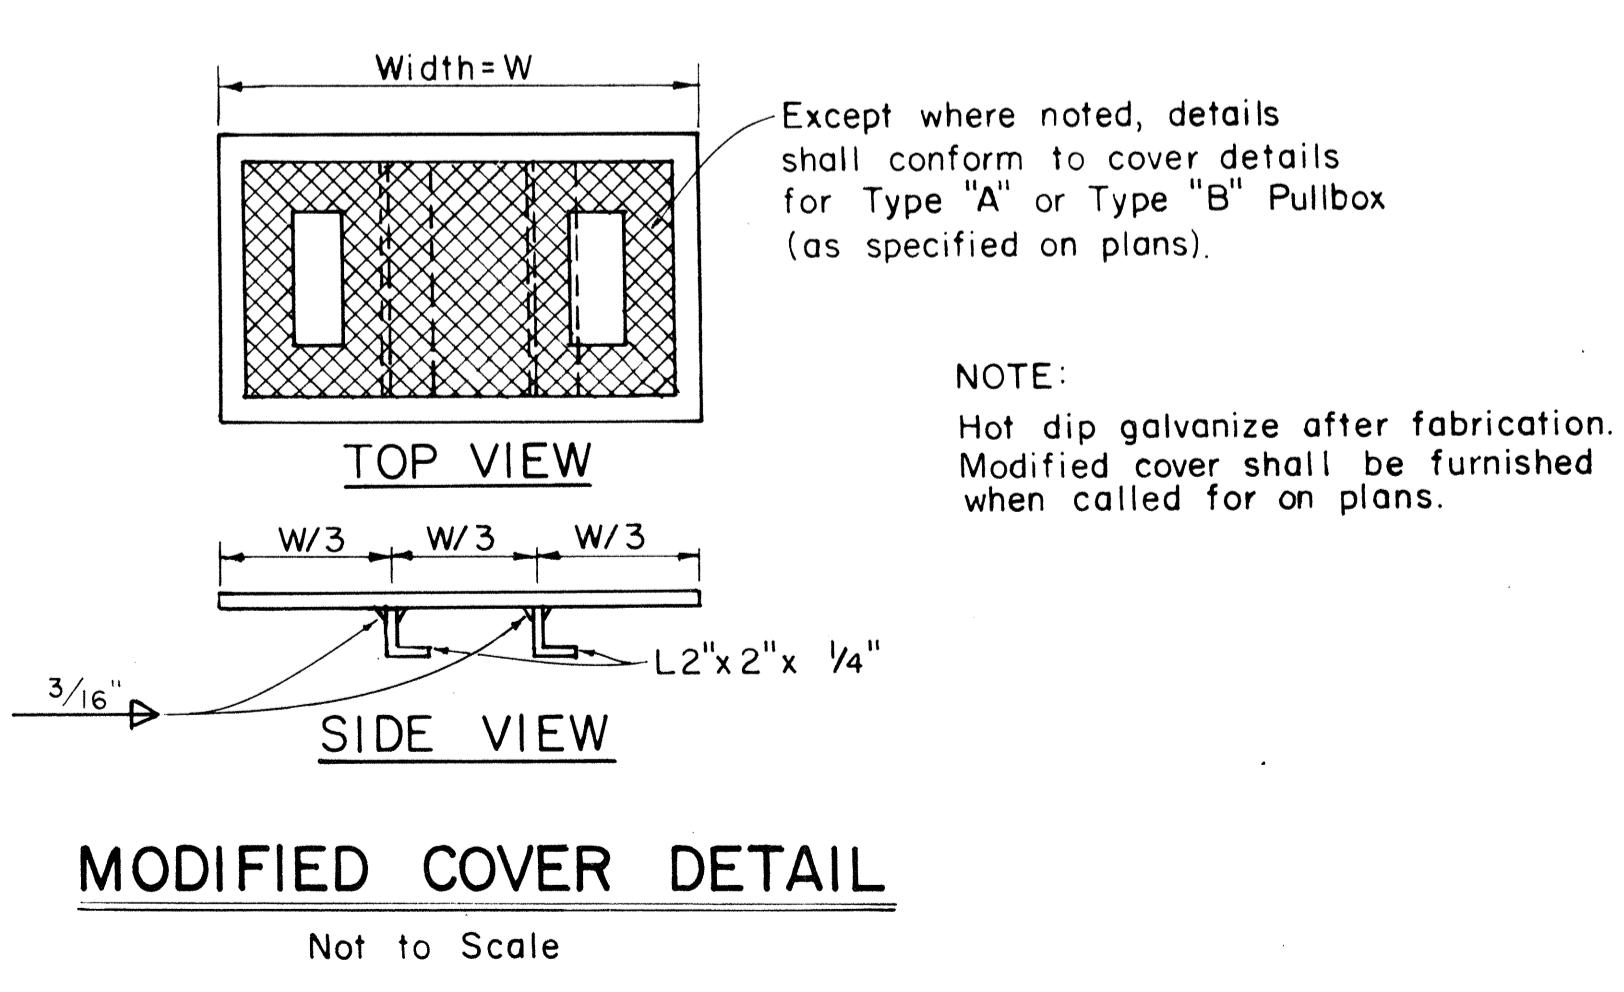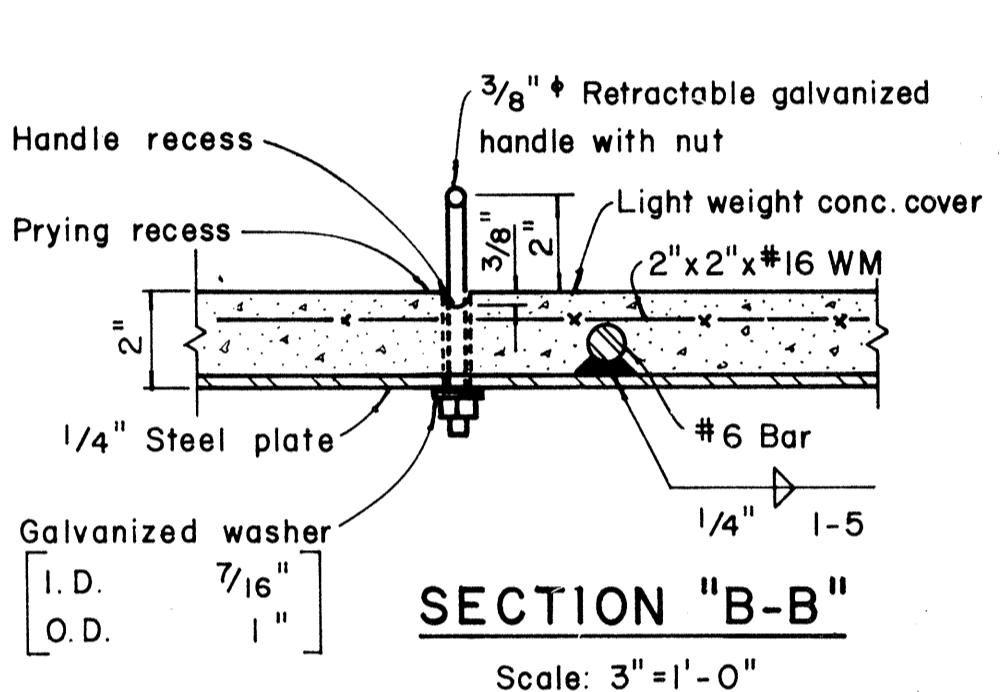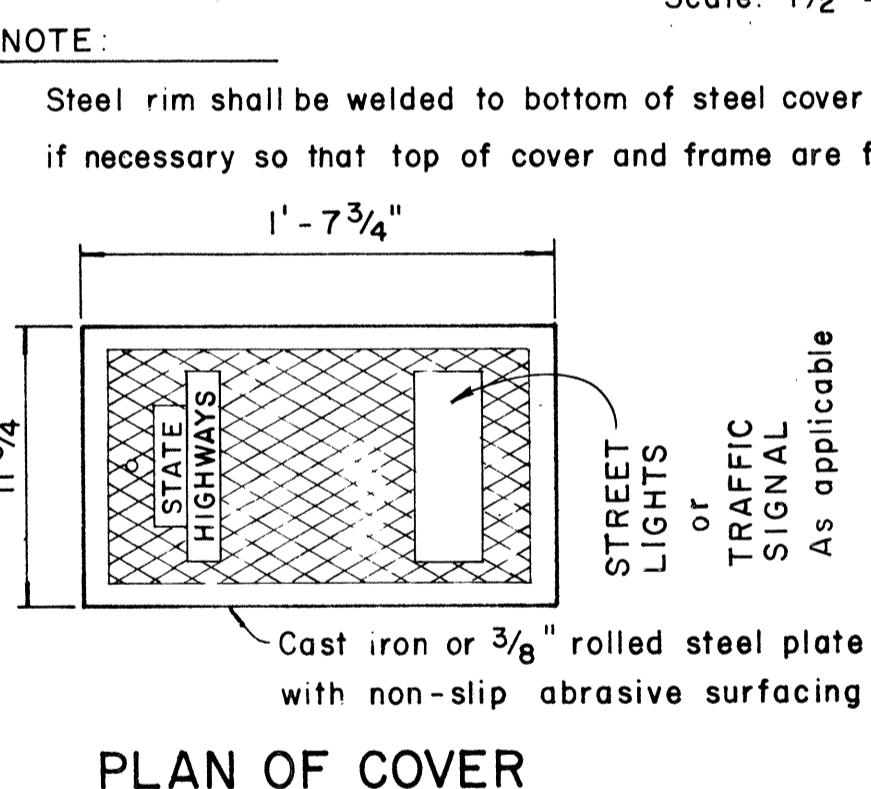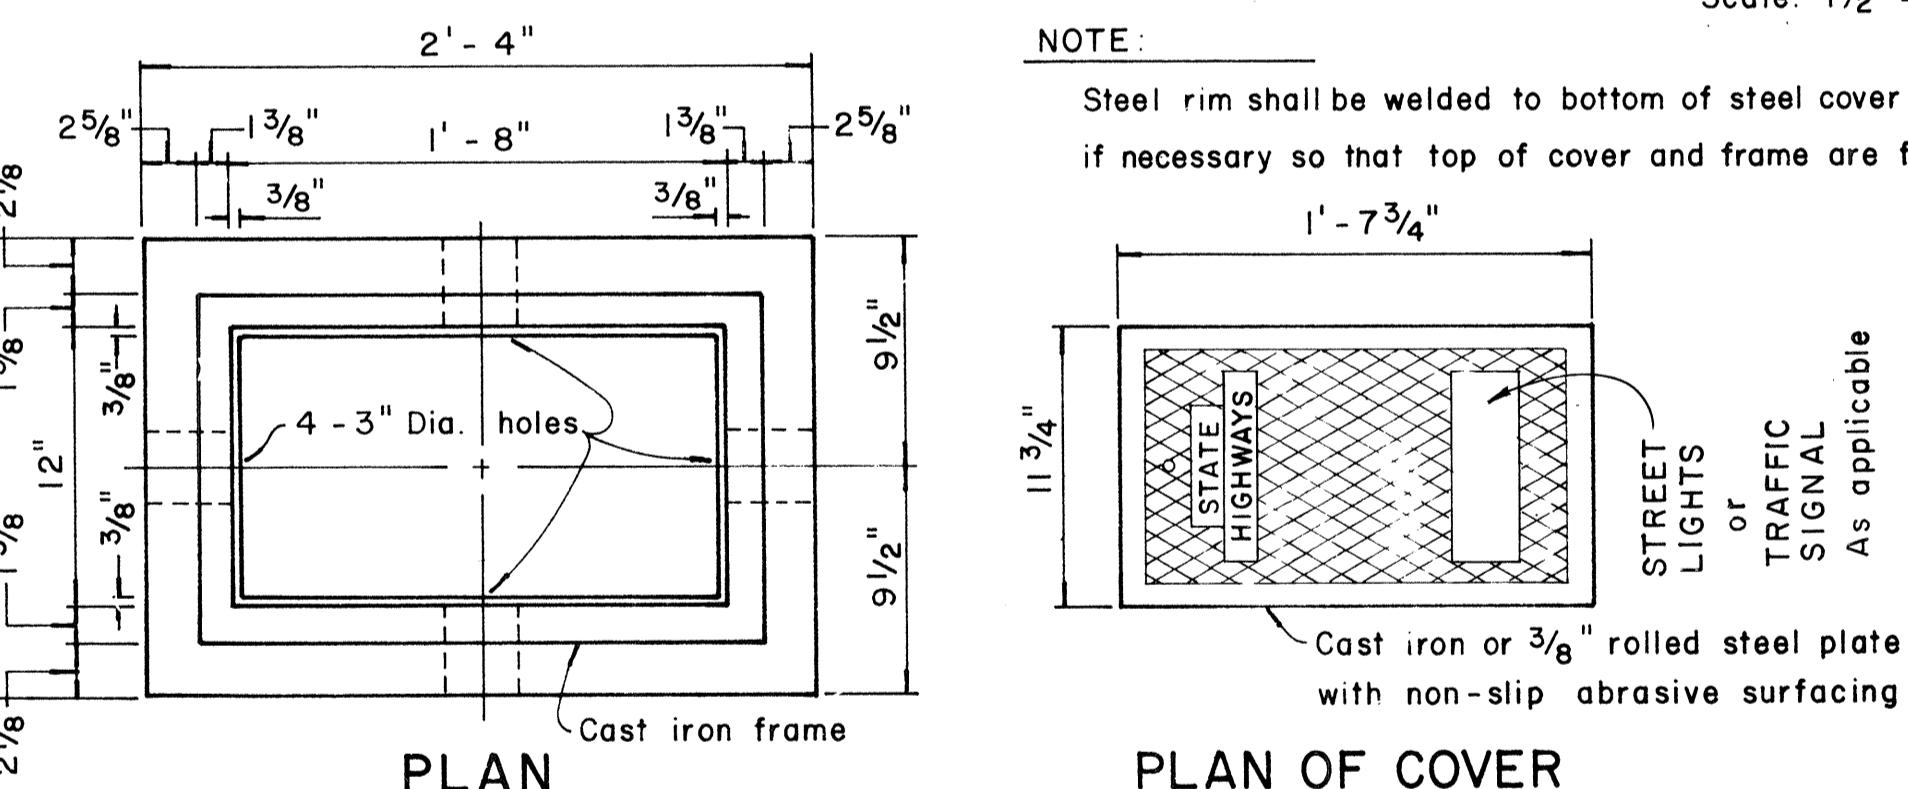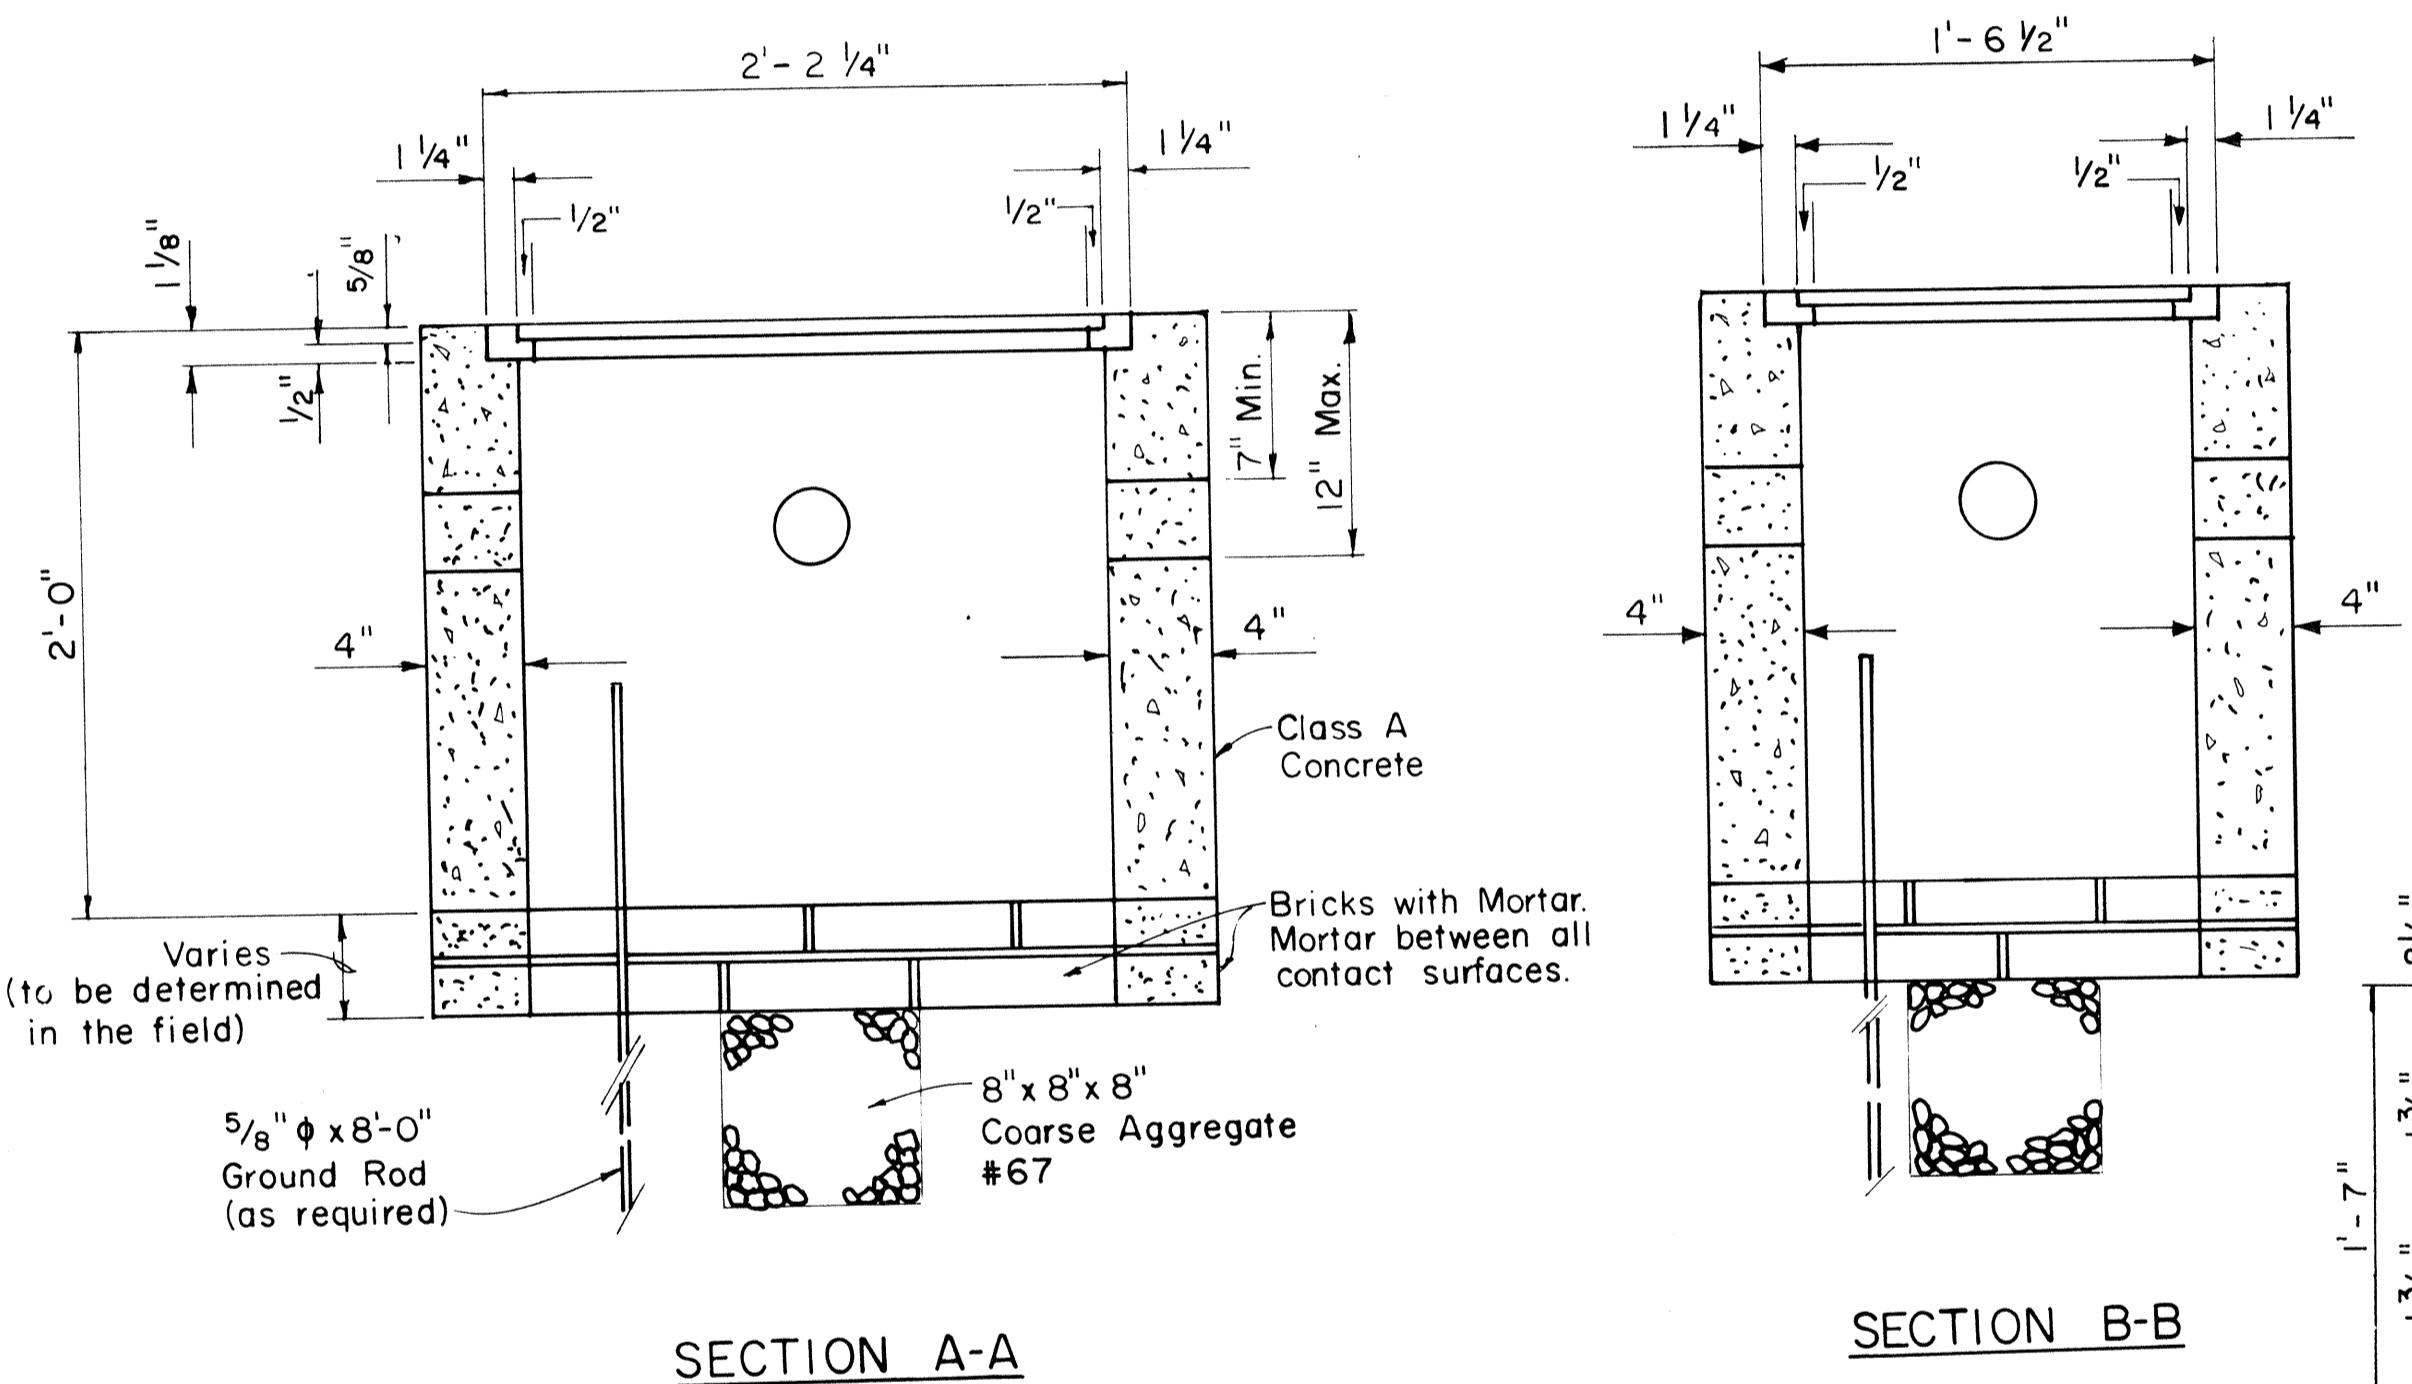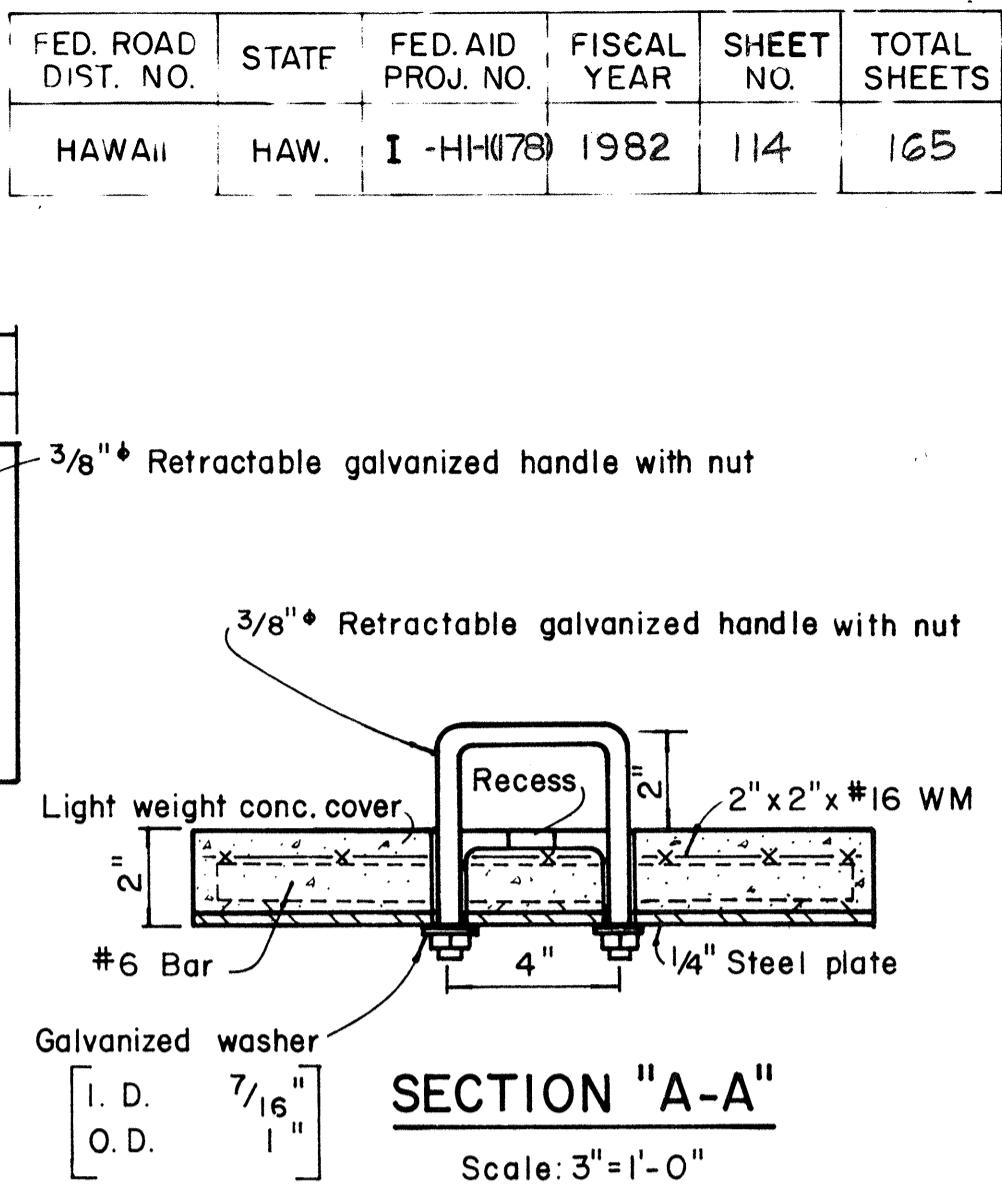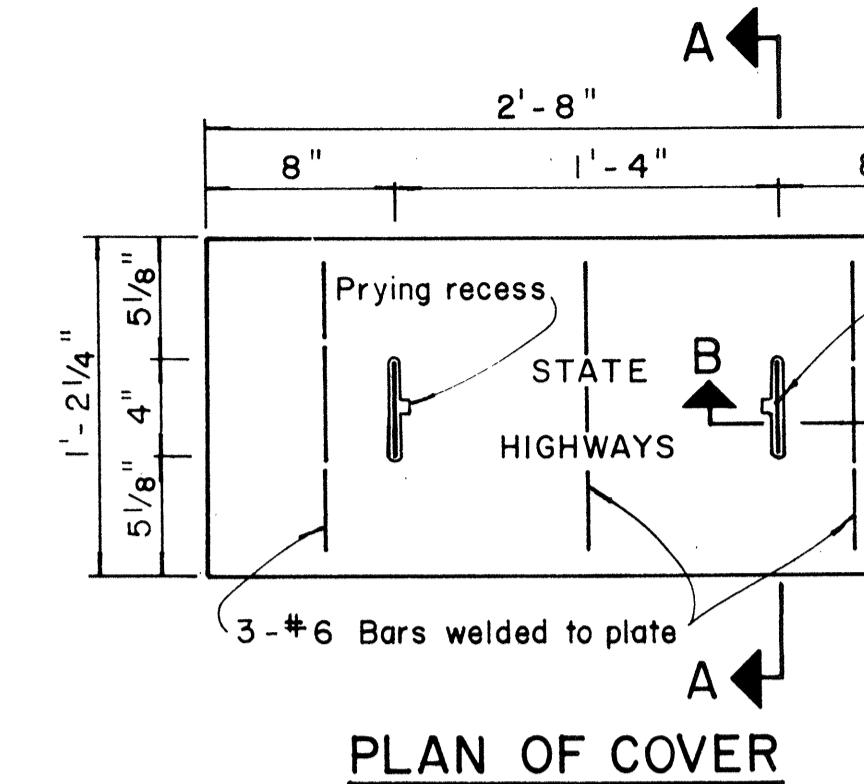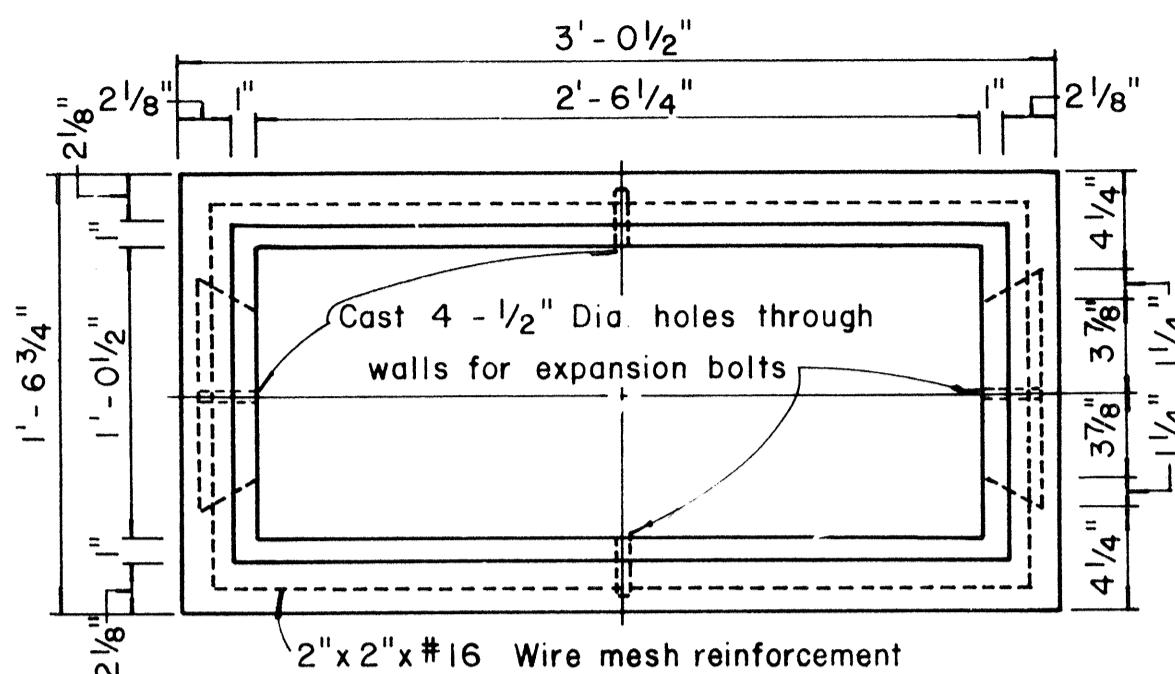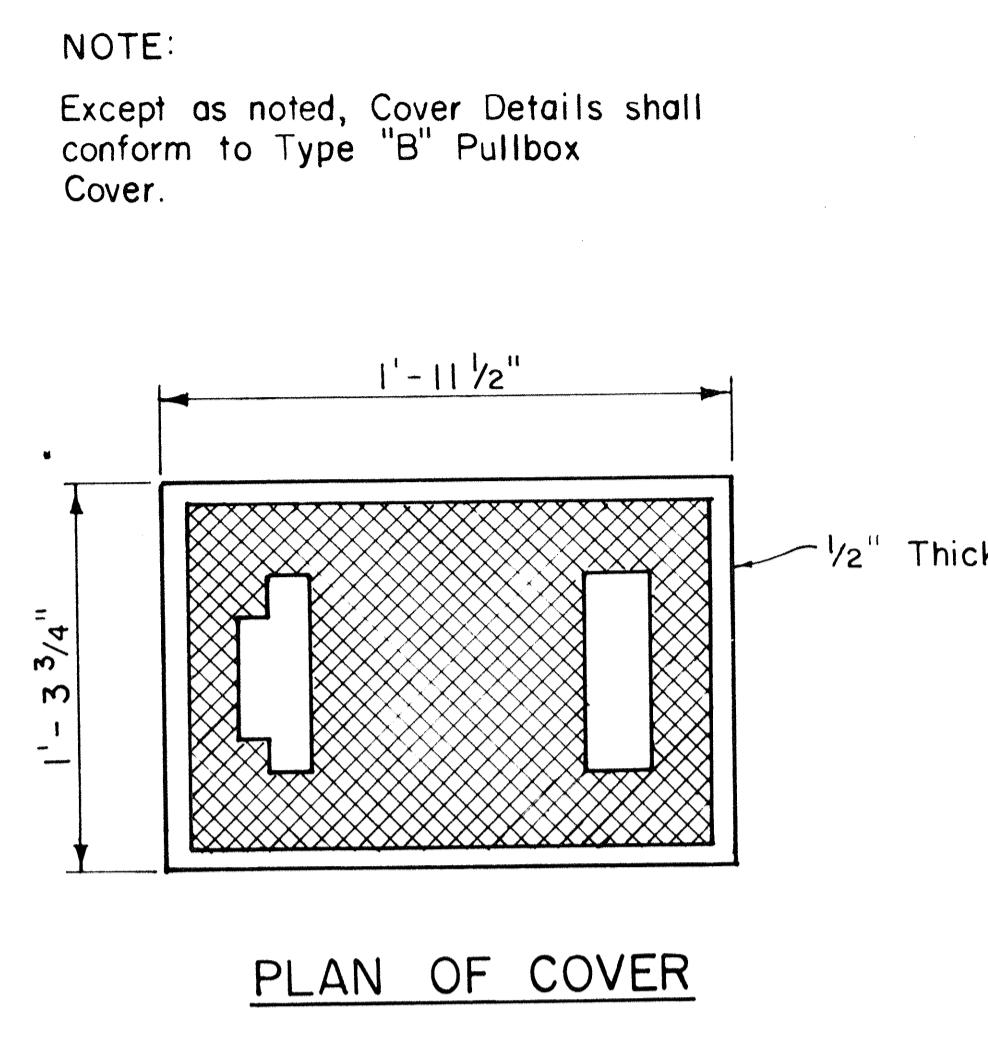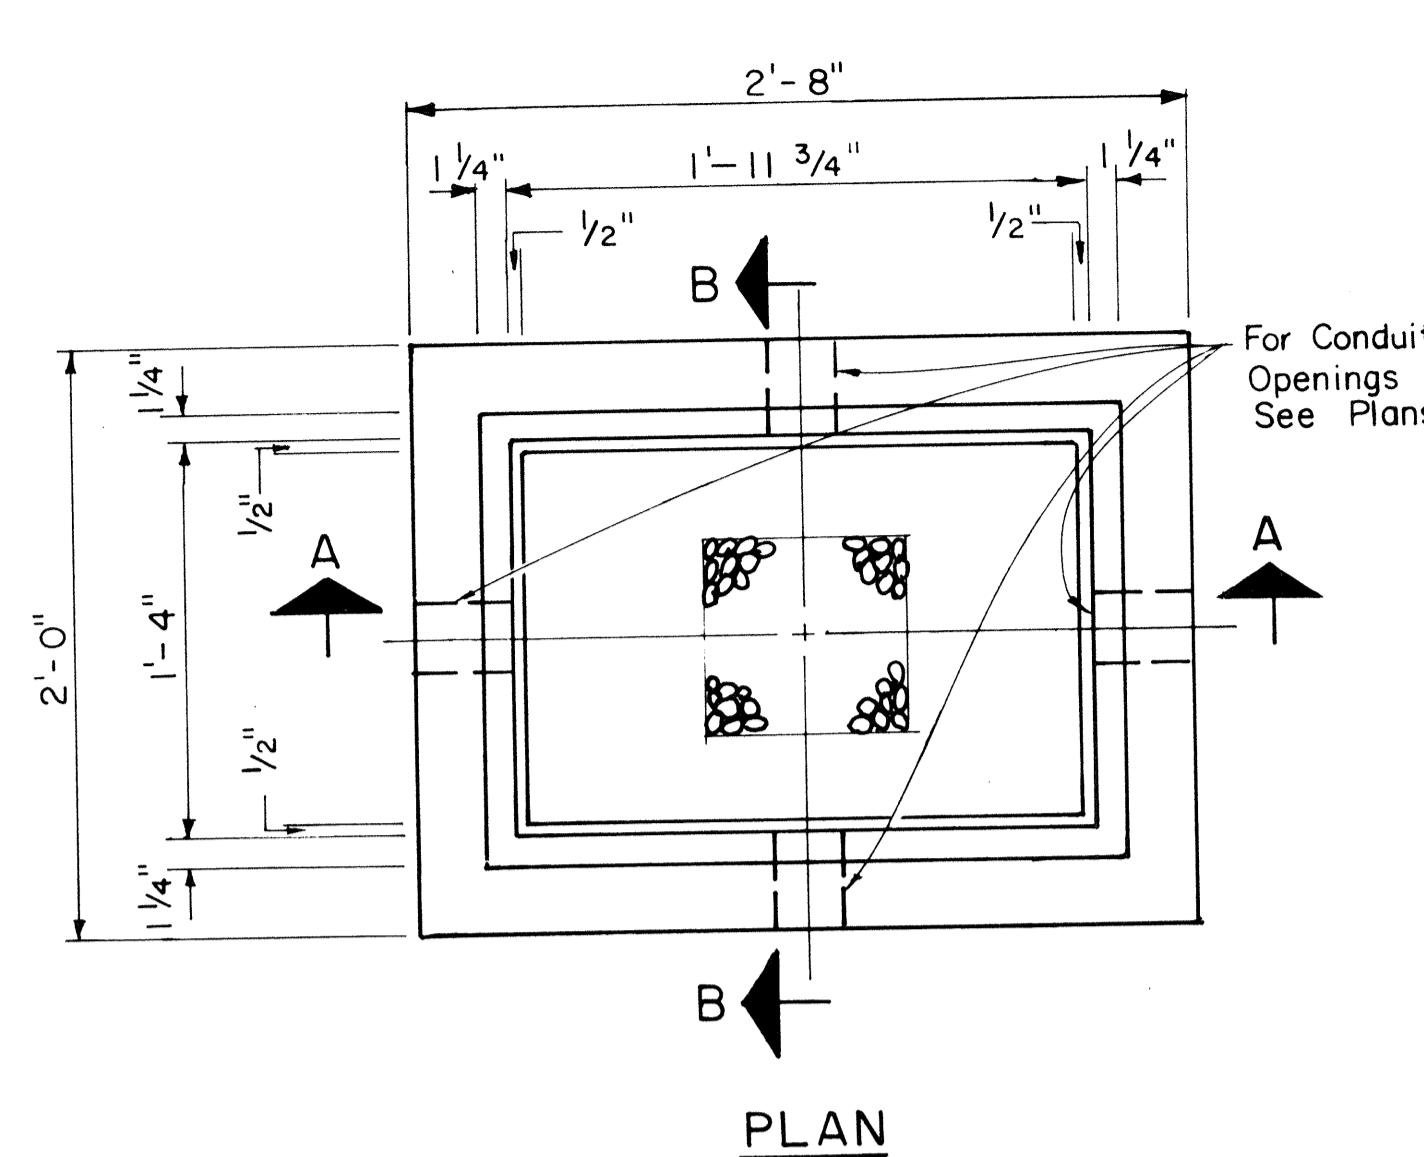


NO.	REVISION	APPROVED BY	DATE
1	Revised Type B & C Pullbox details	H.F.	3-5-80
2	Revised Type "A" Pullbox & Added Modified Cover.	H.F.	1-31-80

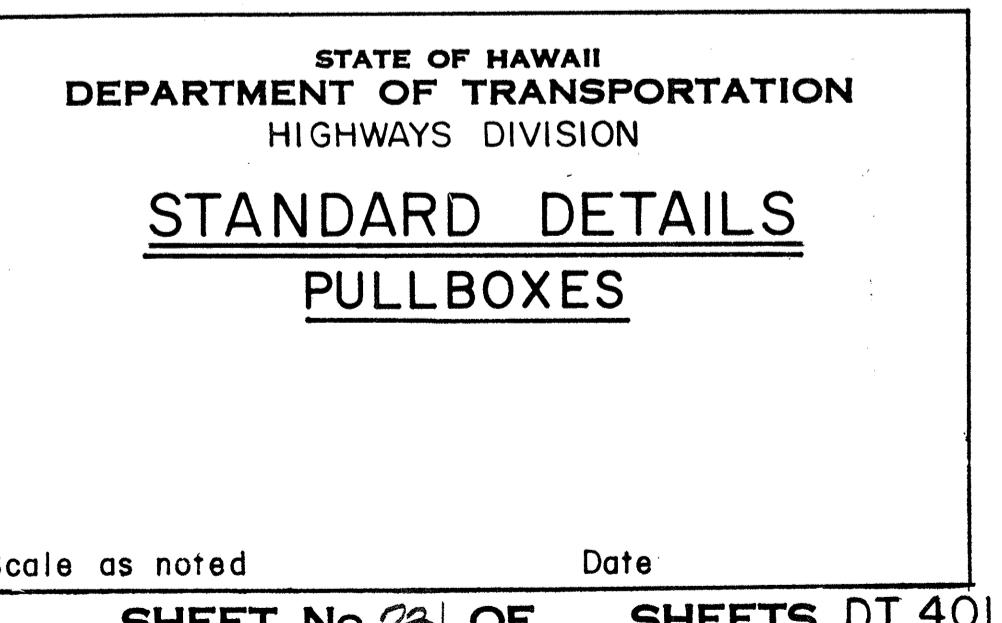

FED. ROAD DIST. NO.	STATE	FED. AID PROJ. NO.	FISCAL YEAR	SHEET NO.	TOTAL SHEETS
HAWAII	HAW.	I -HH(178)	1982	115	165

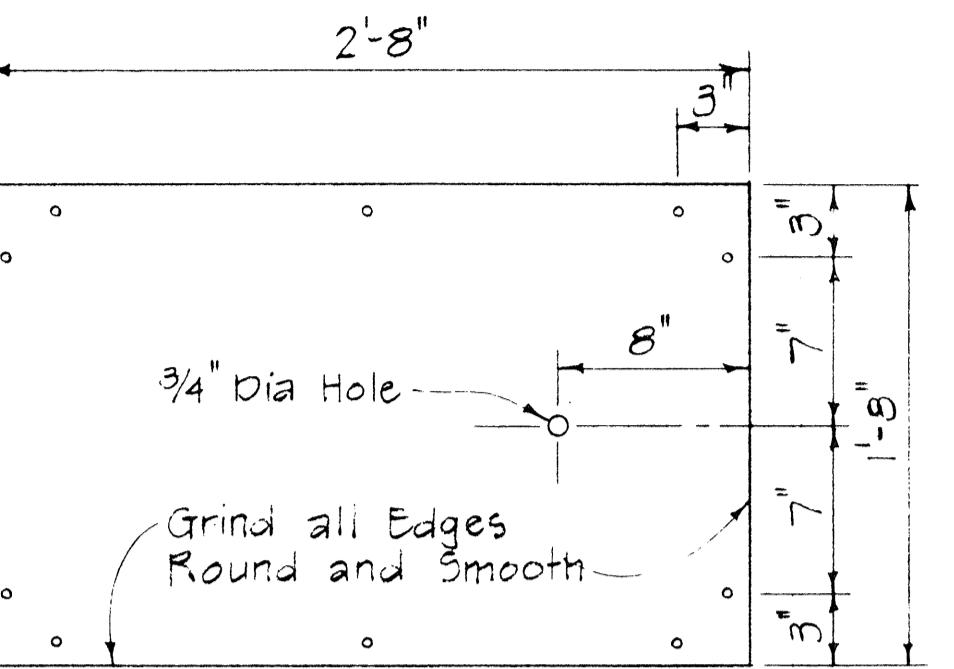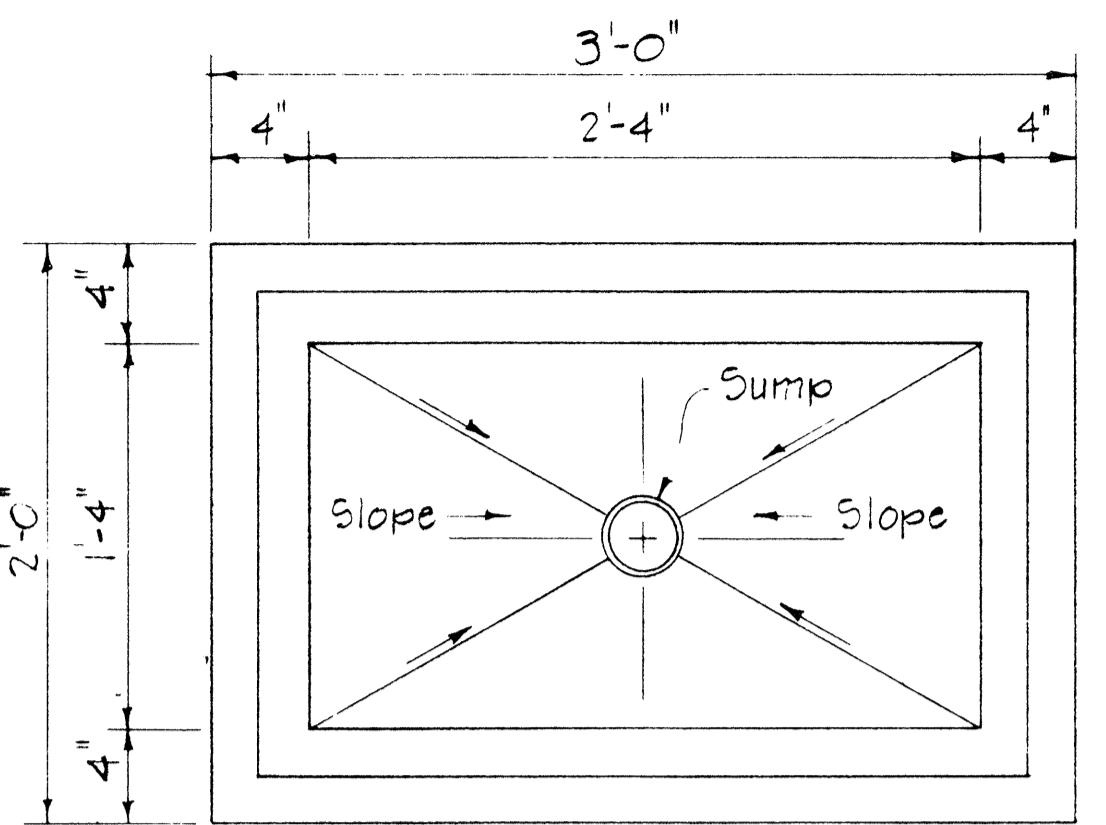


PLAN
Scale: 1/2" = 1'-0"

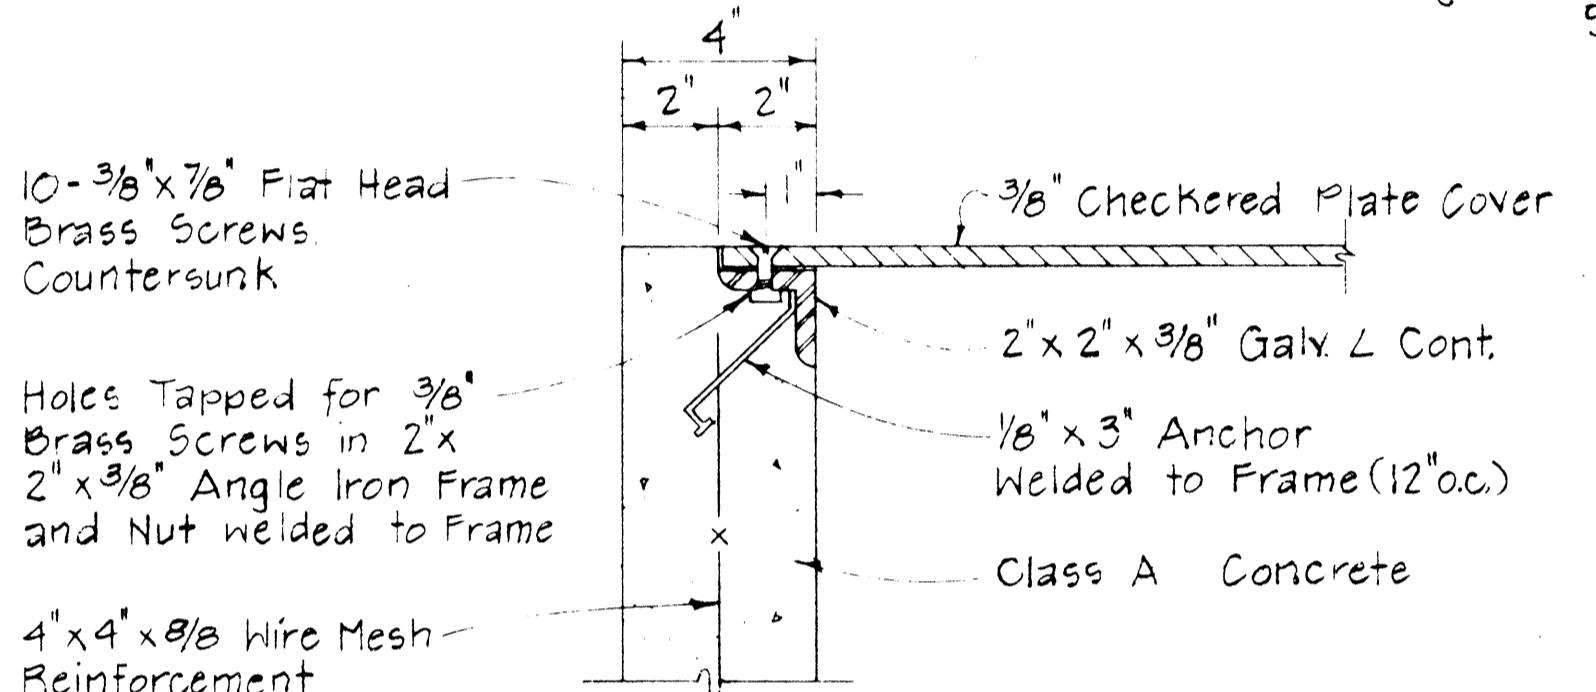

3/8" CHECKED PLATE COVER
(Hot Dip Galvanizing Checked Plate after
Drilling, Countersinking and Grinding Edge)
Scale: 1/2" = 1'-0"

DETAIL "A"
Scale: 3" = 1'-0"

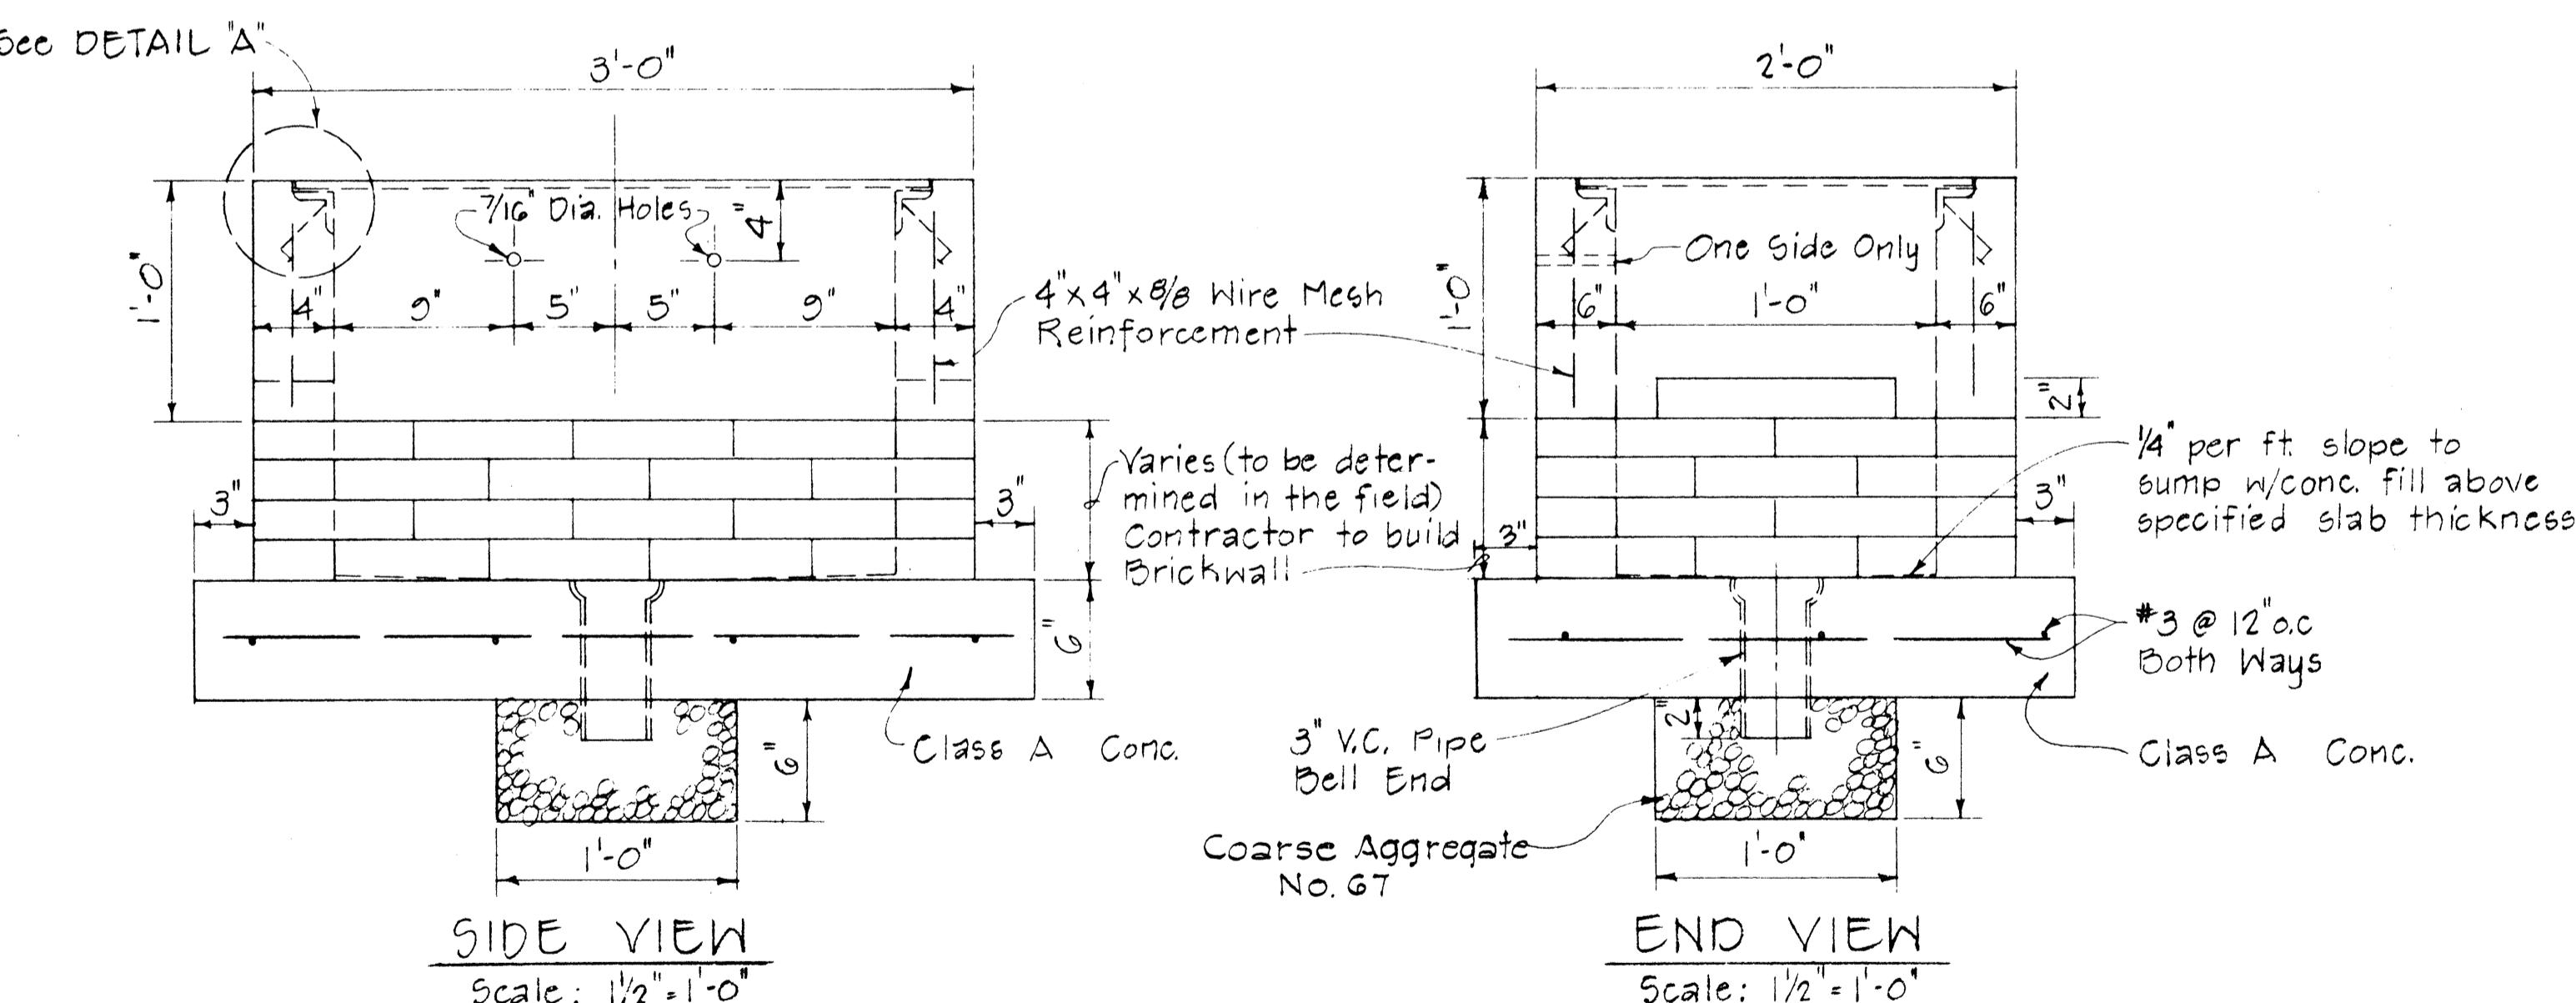

2'-0" x 3'-0" CONCRETE PULLBOX

NOTES:

1. Concrete Pullbox shall consist of all work necessary for constructing the Pullbox for the Highway Lighting System shall include furnishing & installing all materials, appurtenances and galvanizing as shown above.
2. A mounting bracket or a 10" x 10" x 6" high (minimum) shelf shall be provided in each Pullbox for the installation of an isolating transformer (Incidental to Highway Lighting System)

NO.	REVISION	APPROVED BY	DATE



APPROVAL RECOMMENDED:
Euchi Tanaka
TRAFFIC ENGINEER
DATE: 12/29/69

APPROVED:
Zulu S. Zulu
ASSISTANT CHIEF, ENGINEERING DATE: 12-30-69



STATE OF HAWAII DEPARTMENT OF TRANSPORTATION LAND TRANSPORTATION FACILITIES DIVISION			
<u>DETAIL OF 2' x 3' CONCRETE PULLBOX</u> SCALE AS SHOWN FEB. 1969 SHEET No. 24LOF SHEETS DT510			

ORIGINAL	PLANE
SURVEY PLOTTED BY	
DRAWN BY	
DESIGNED BY	
QUANTITY BY	
CHECKED BY	
NOTE BOOK	
NO.	

FED. ROAD DIST. NO.	STATE	FED. AID PROJ. NO.	FISCAL YEAR	SHEET NO.	TOTAL SHEETS
HAWAII	HAW.	I -HH(178	1982	116	165

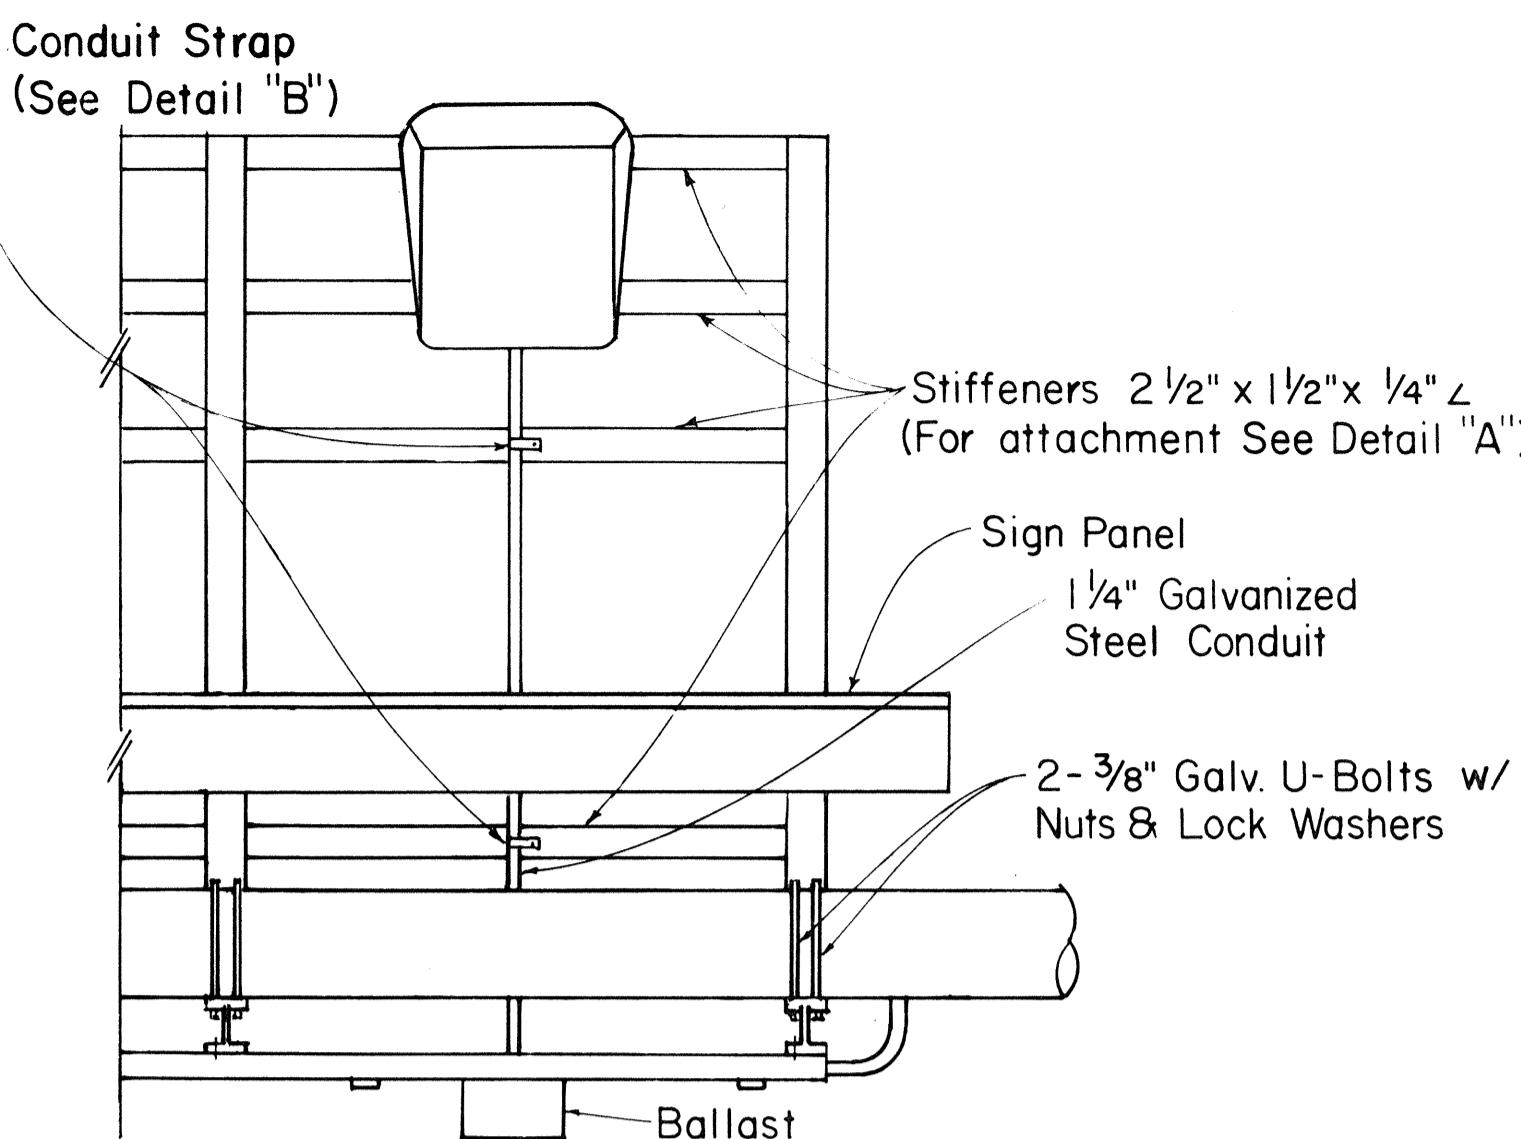
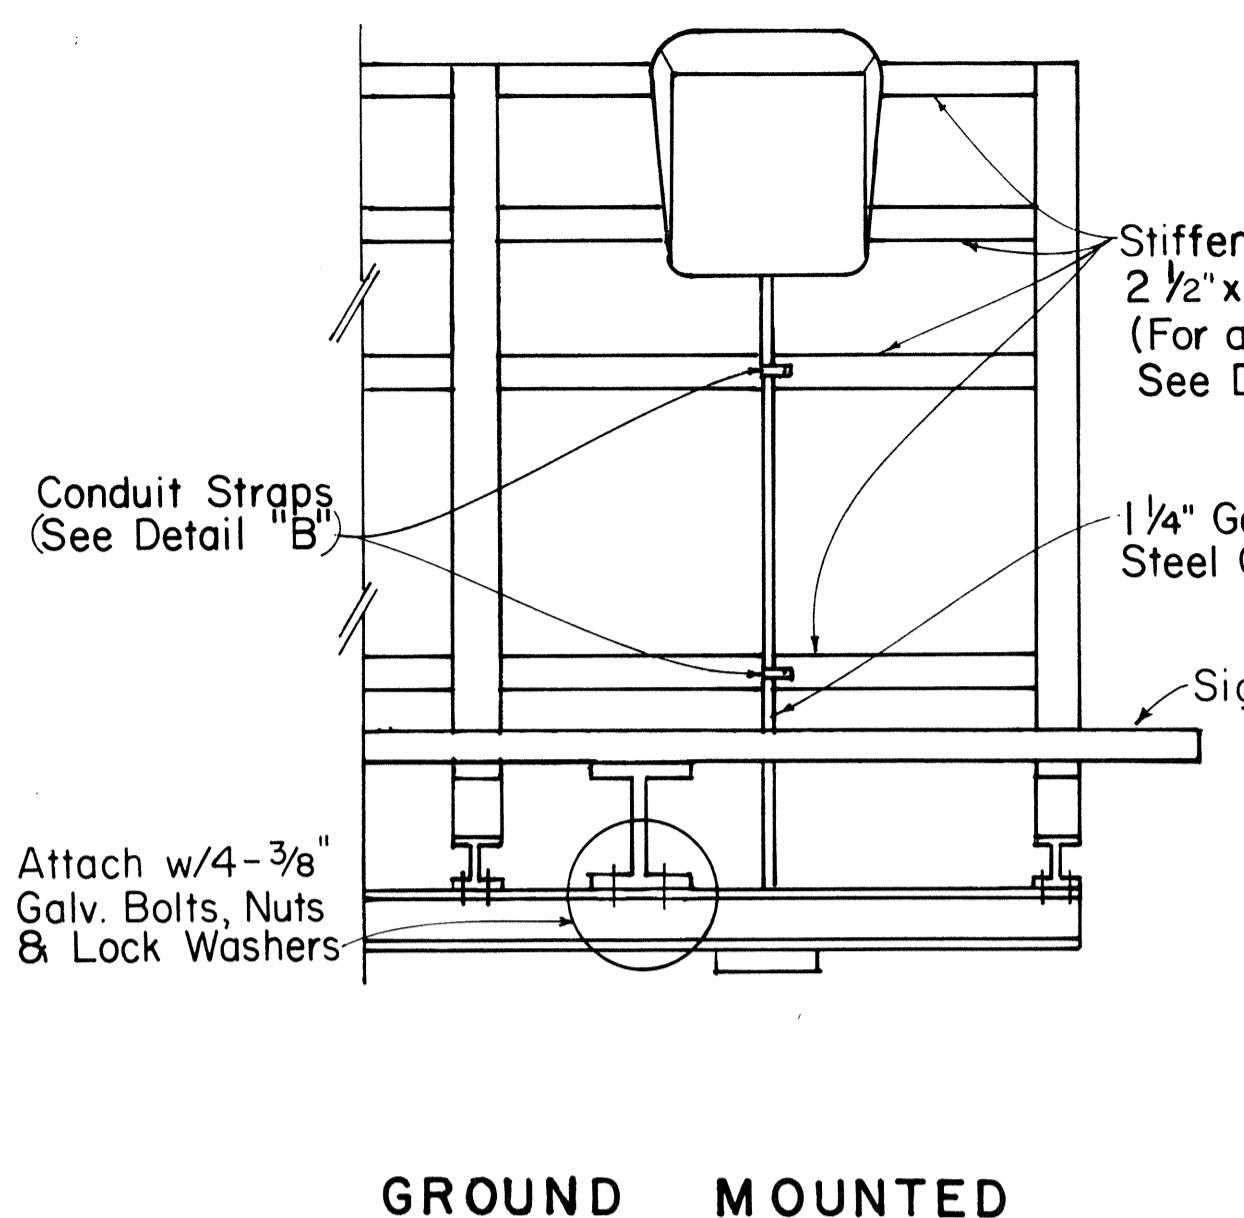


TOP VIEW

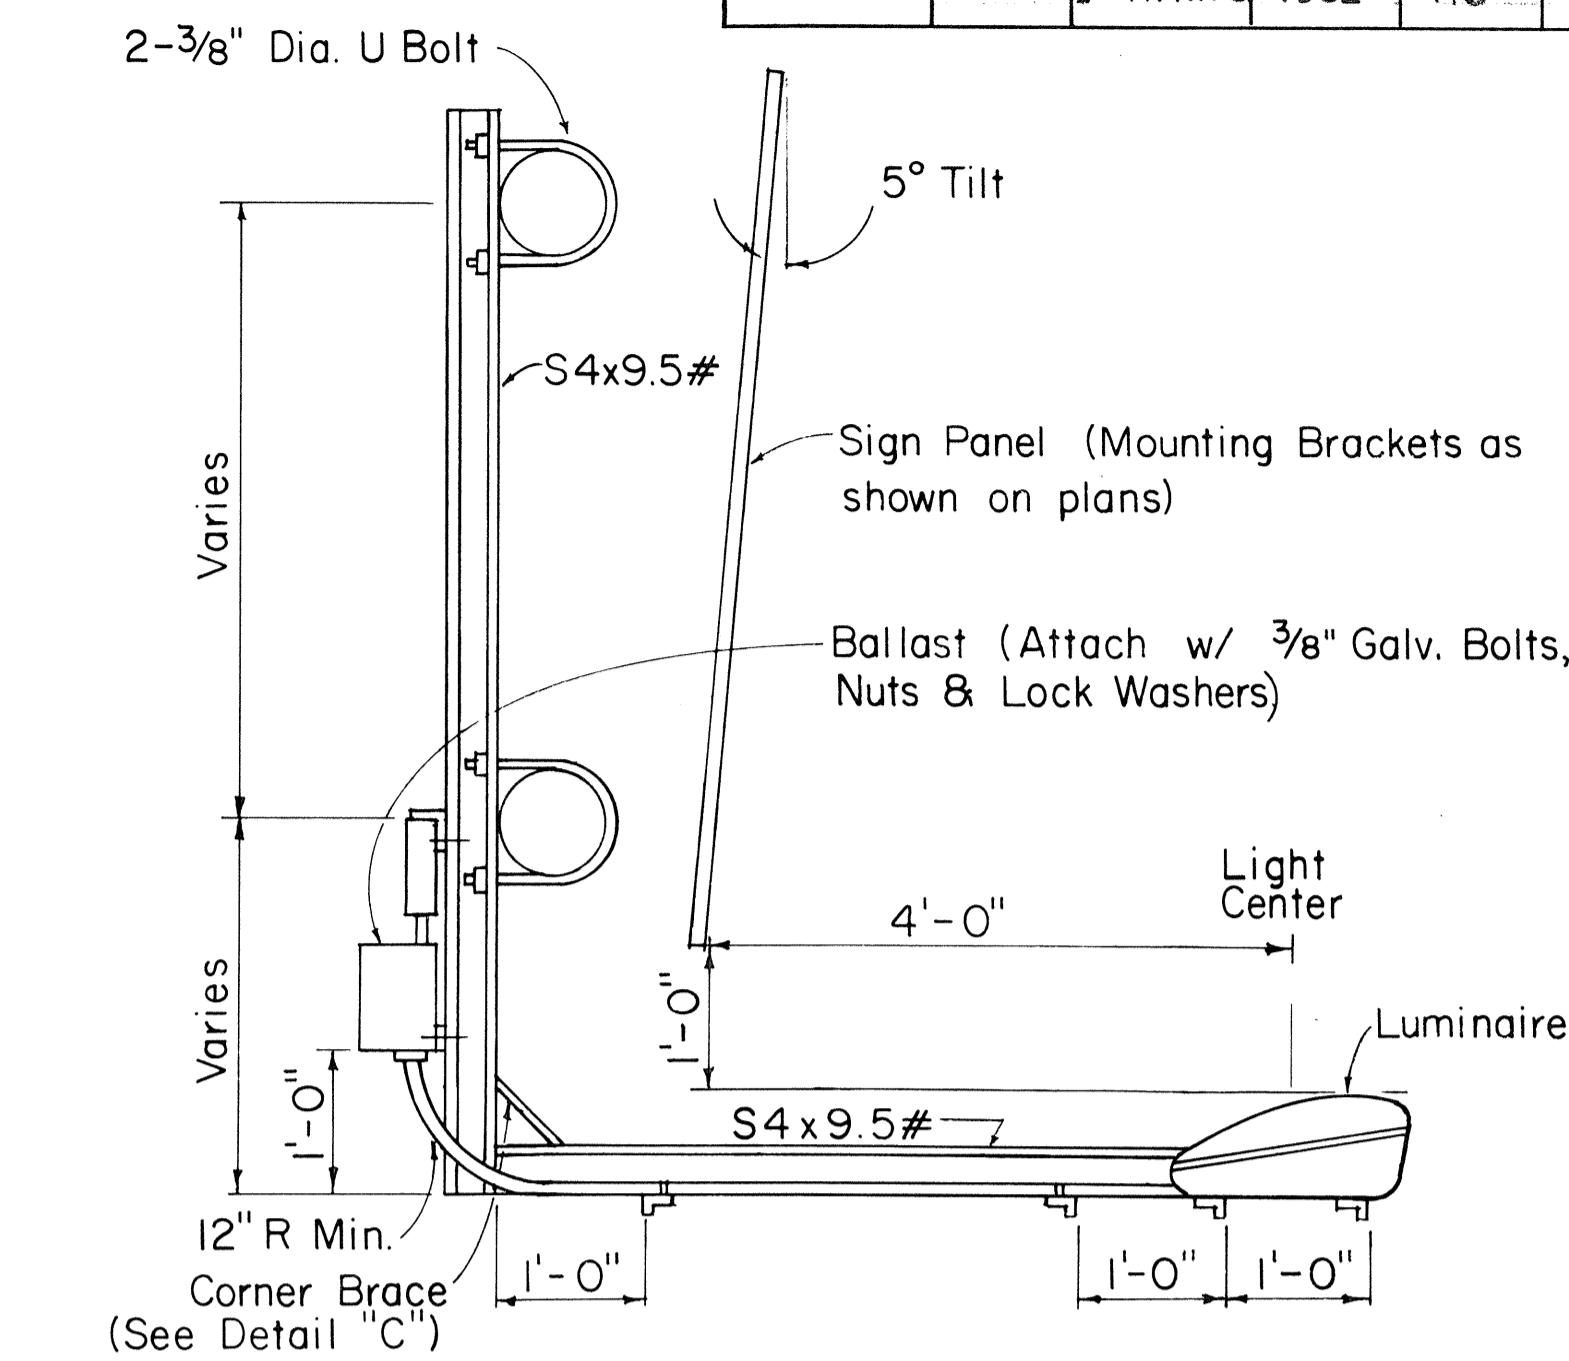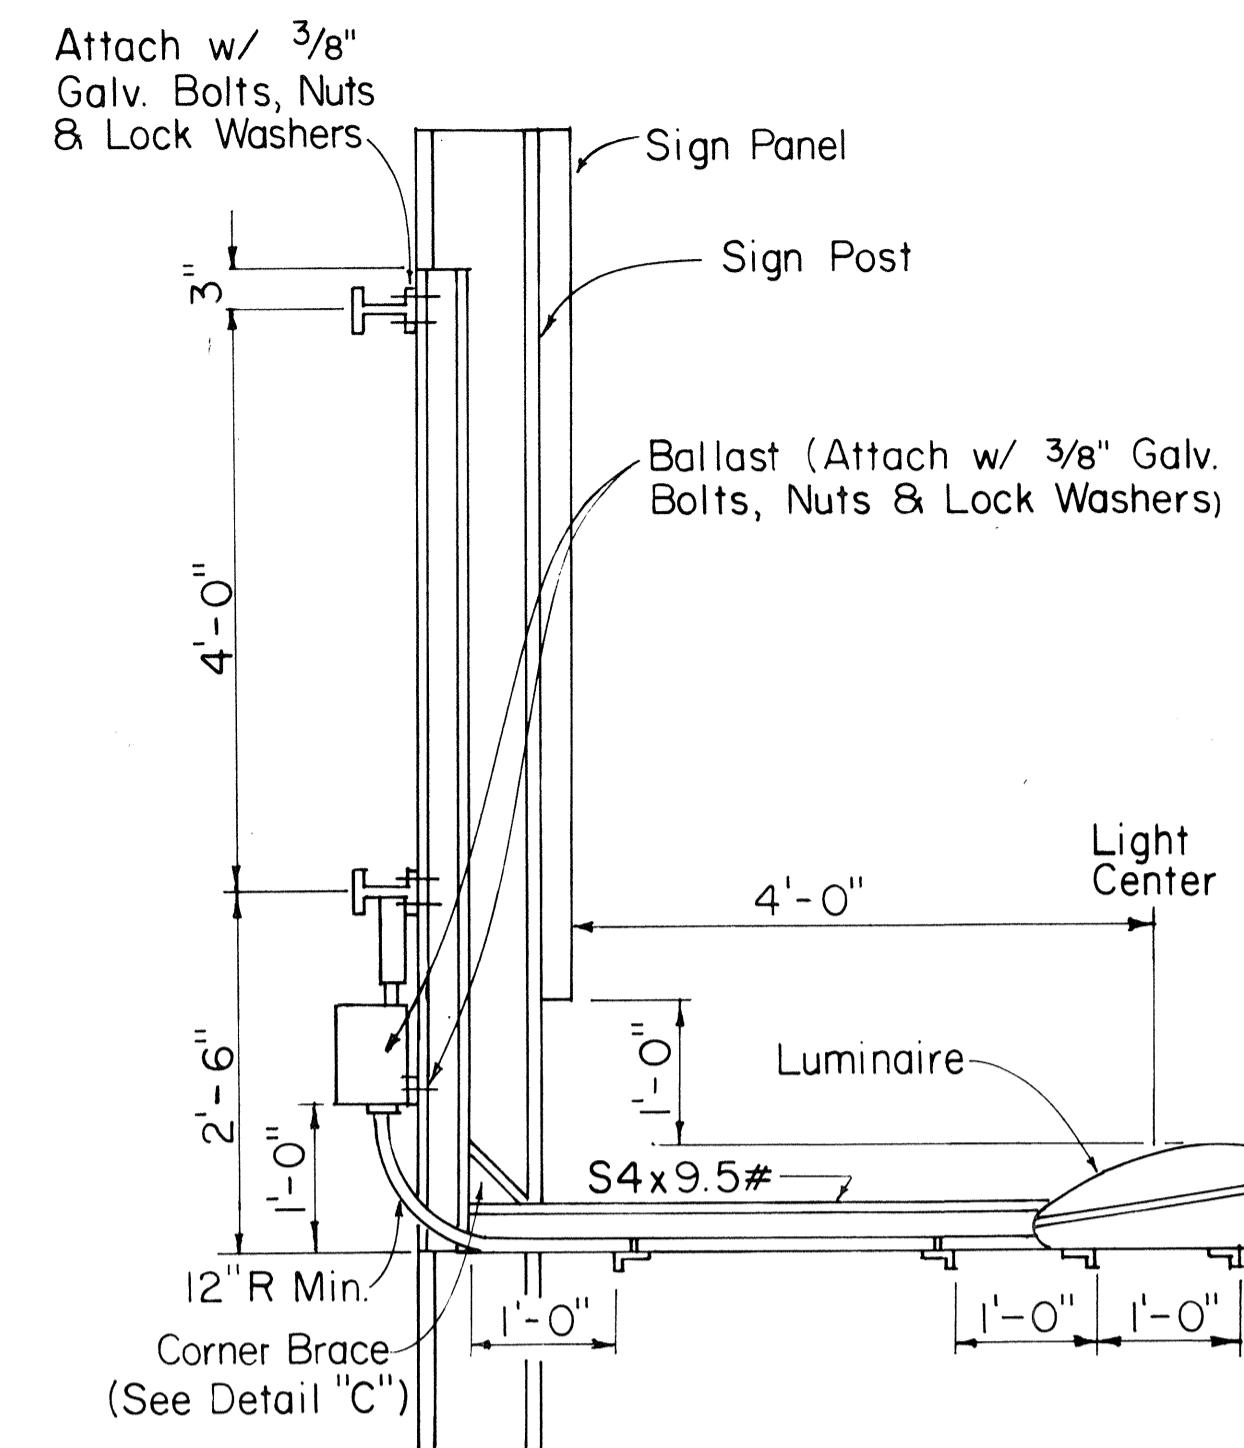

GENERAL NOTES:




- All parts of the Luminaire Mounting shall be Hot-Dip Galv., Prime Coated with a suitable Primer and Painted with Three Coats of Dark Green Enamel.
- Luminaire Mounting shall be adjusted as recommended by the manufacturer to provide optimum sign illumination.
- The Contractor shall insure that the luminaire supports do not conflict with the sign supports (see support spacing tables on sheets DT 205 and DT 206). Final spacing shall be approved by the Engineer.
- The Contractor shall determine the amount and spacing of luminaires per sign in accordance with the luminaire manufacturer's instructions, subject to approval by the Engineer. The maximum spacing shall be 10 feet on centers and the maximum height and width illuminated by a single luminaire shall be 10 feet, respectively.

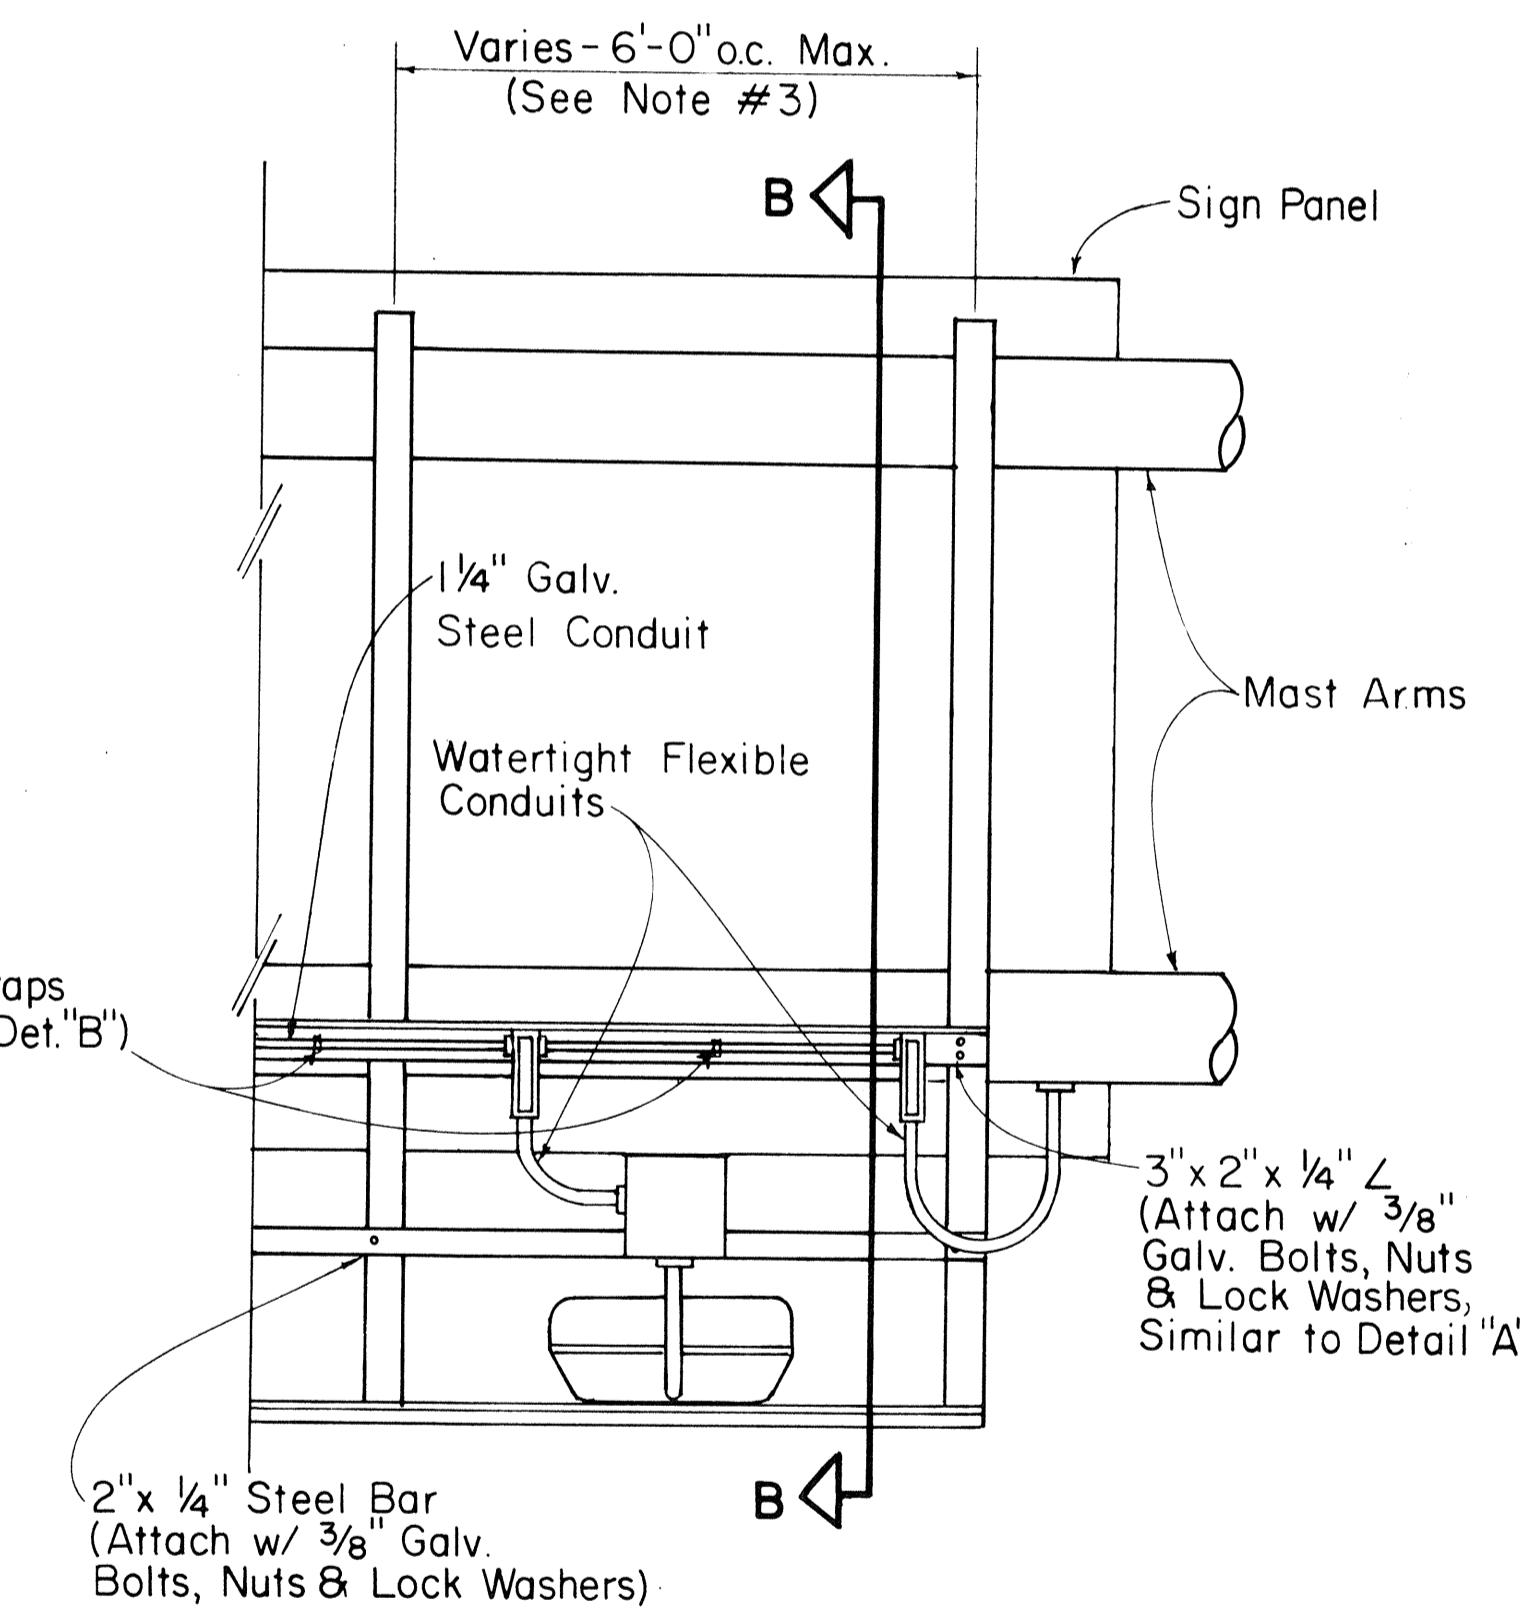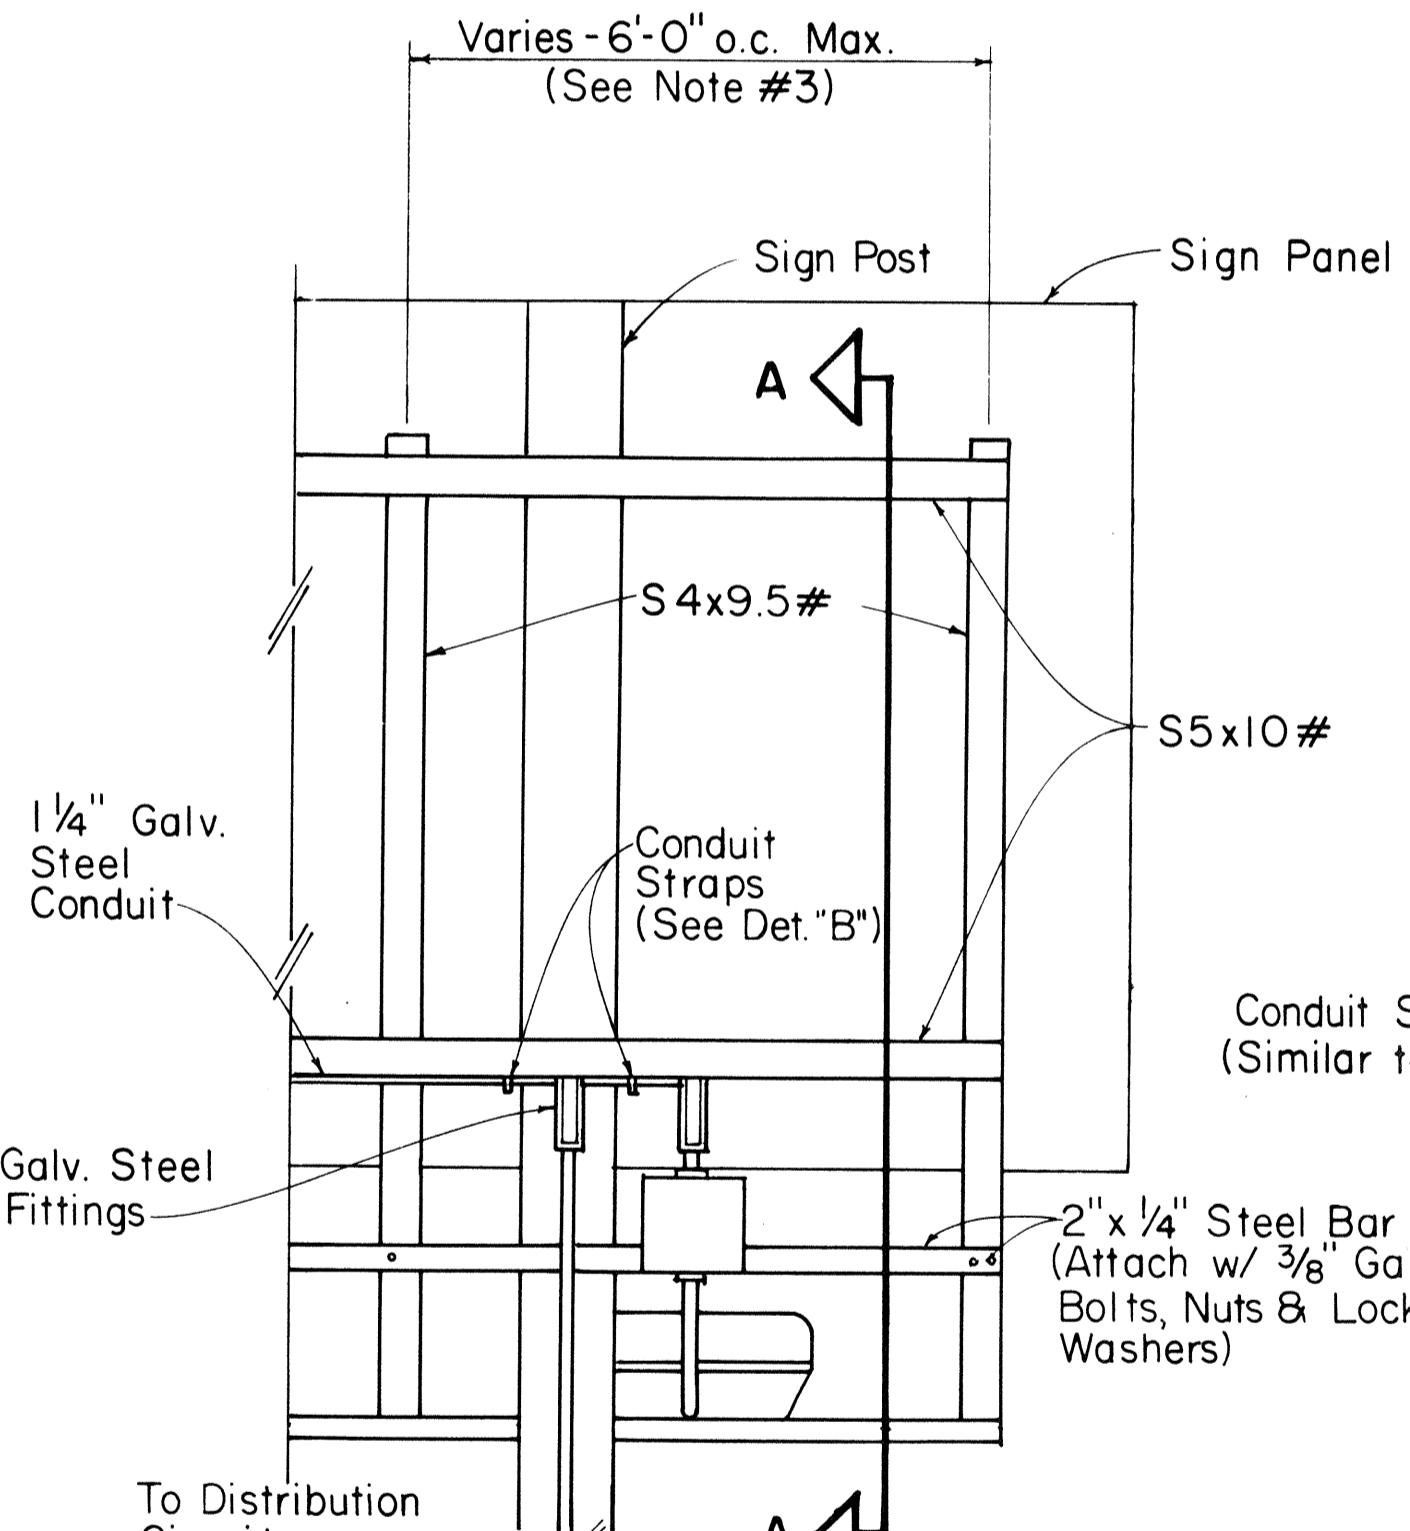

REAR VIEW

LUMINAIRE MOUNTING

Not to Scale

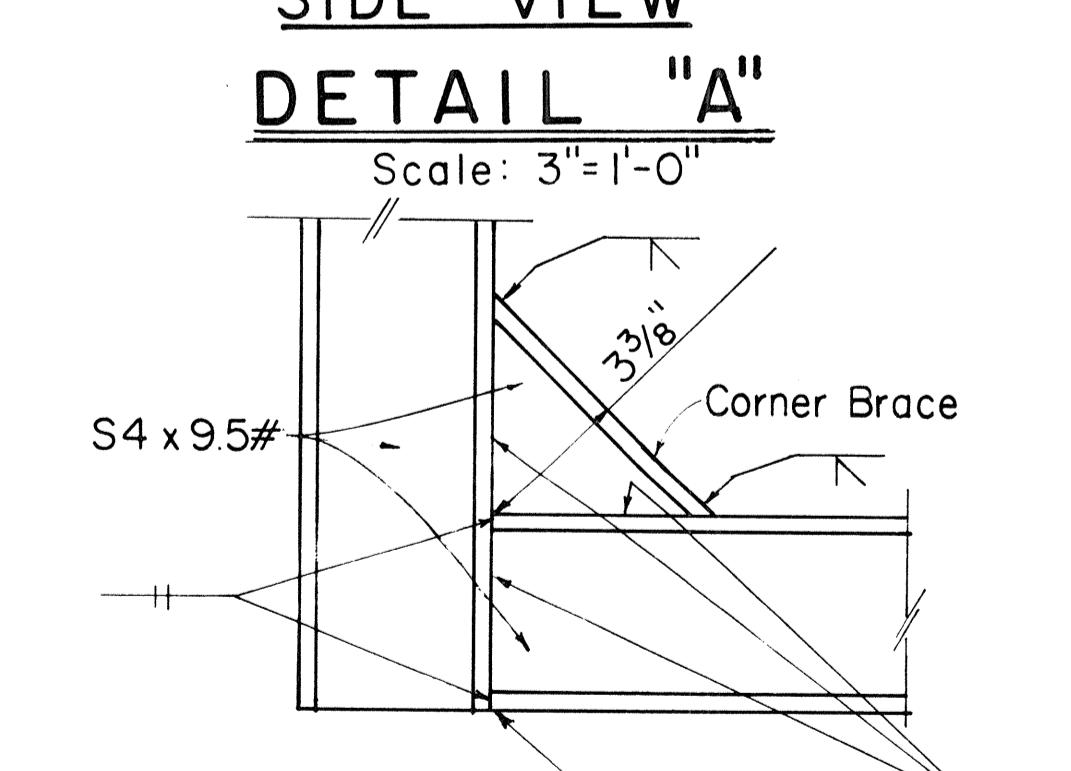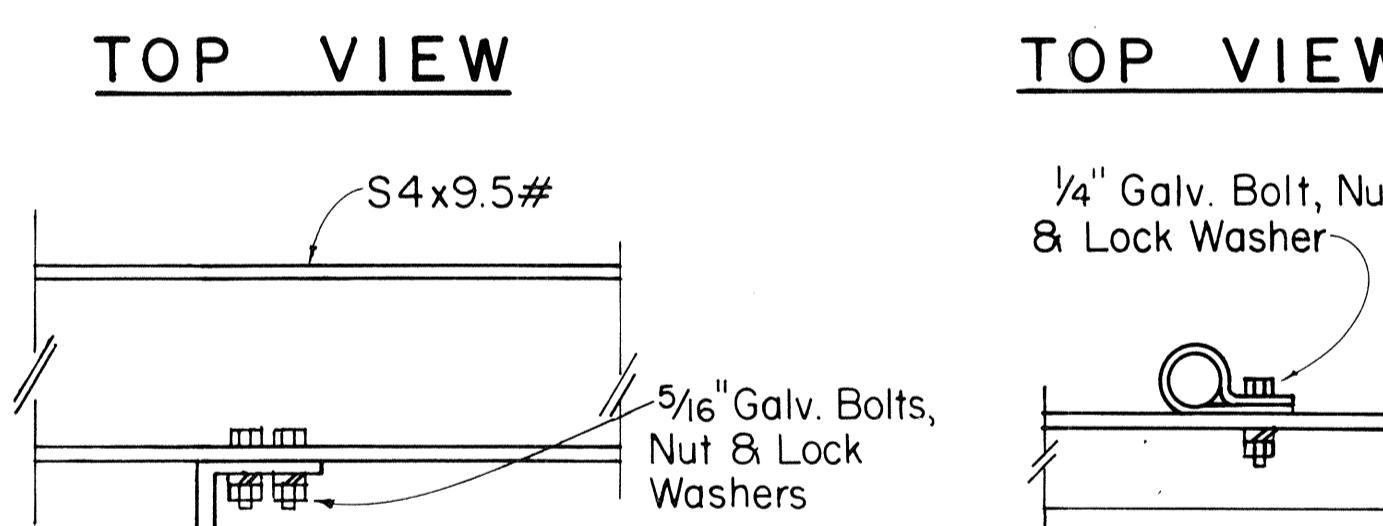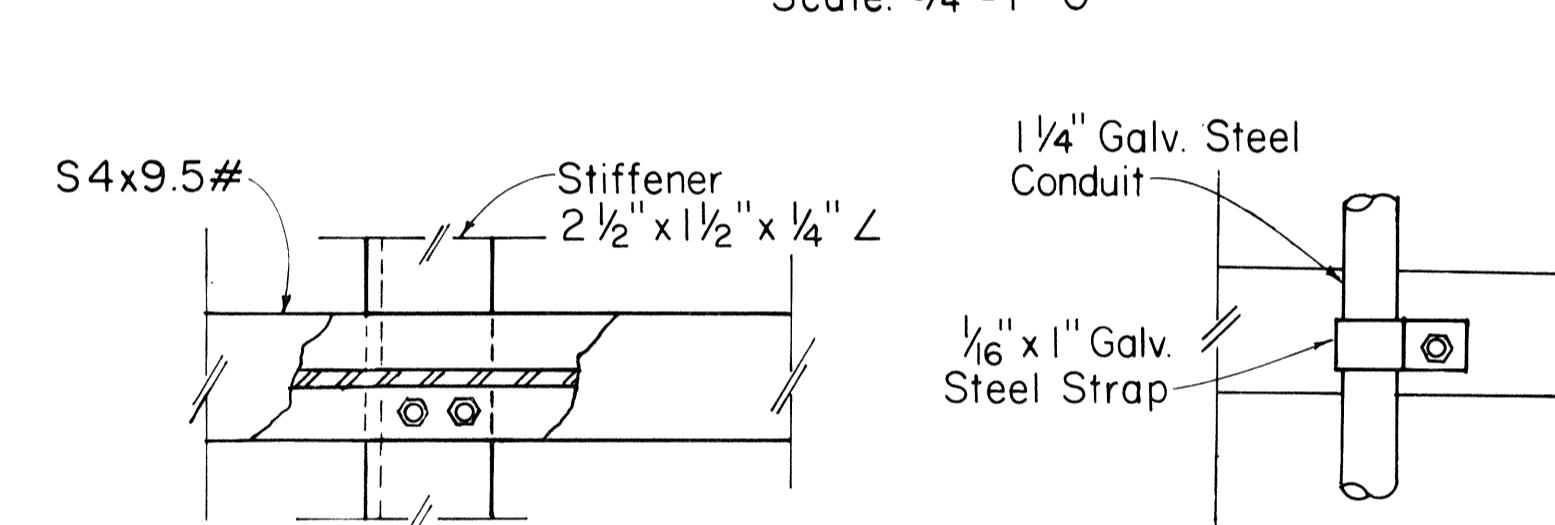

Scale: 3"=1'-0"

APPROVAL RECOMMENDED:
Euchi Tanaka
TRAFFIC ENGINEER

5/19/81
DATE

APPROVED:
Robert Balash
ASSISTANT CHIEF, ENGINEERING

5/20/81
DATE

STATE OF HAWAII
DEPARTMENT OF TRANSPORTATION
HIGHWAYS DIVISION

STANDARD DETAILS
GUIDE SIGNS
LUMINAIRE MOUNTINGS















Scale: As Shown

SHEET NO. 25 LOF SHEETS DT 208

FED. ROAD DIST. NO.	STATE	FED. AID PROJ. NO.	FISCAL YEAR	SHEET NO.	TOTAL SHEETS
HAWAII	HAW.	I-HI-1(178)	1982	117	165

NOTES:

- (1) SERIES CKT. TO REMAIN
- (2) REPLACE W/ 150W HPS FIXTURE
- & CONN. TO MULTIPLE CKT.
- (3) REMOVE SERIES CKT.
- (4) REPLACE W/ 250W HPS FIXTURE
- & CONN. TO MULTIPLE CKT.
- (5) PROVIDE MULTIPLE CKT AERIAL TRIPLEX
 $4\frac{1}{2}$ " x 2 RINJ W/ MESSENGER & HARDWARE.
COMPLY W/ CITY DOTS Dwg. No. B401
APPLICABLE REQUIREMENTS. SEE SHT. 22L
- (6) 2" C. RISER W/ SVC HEAD.

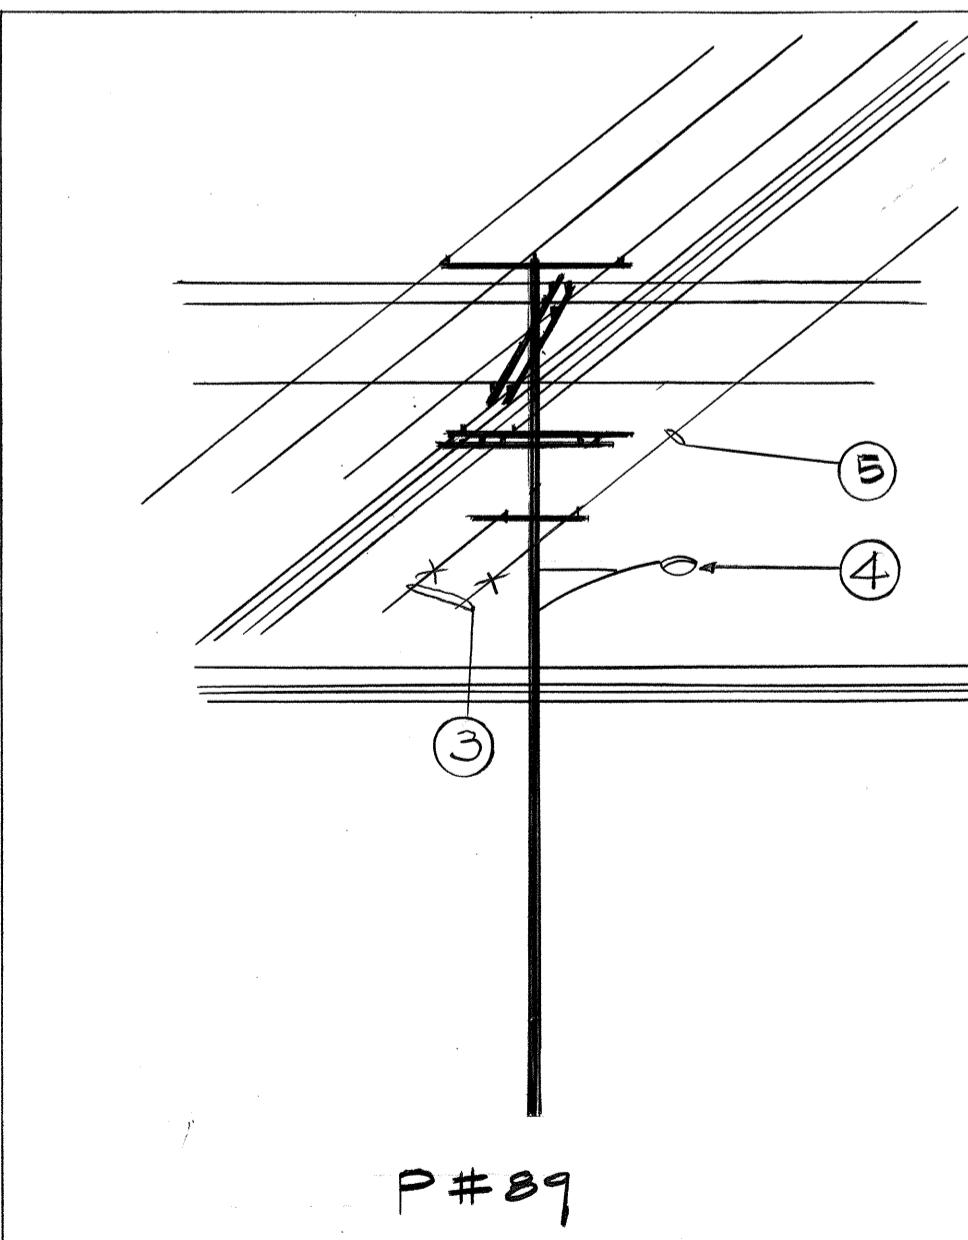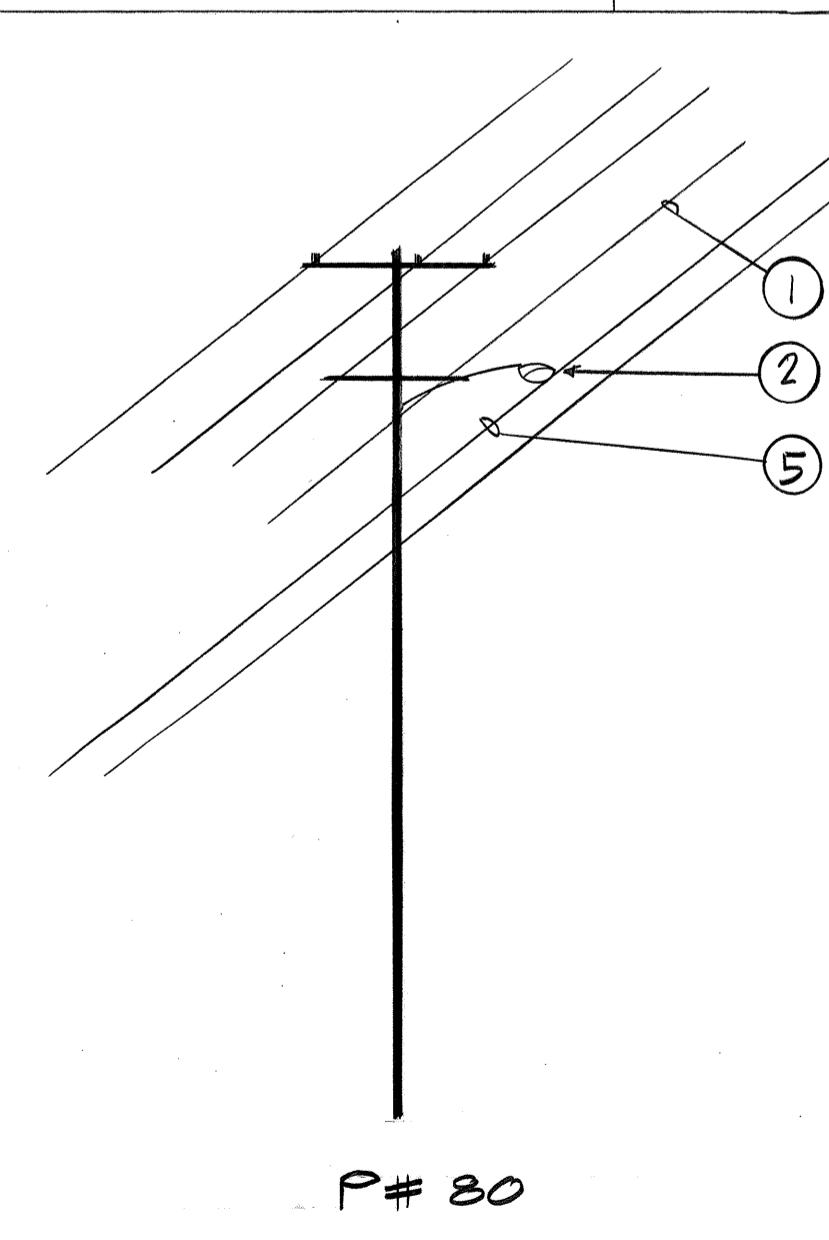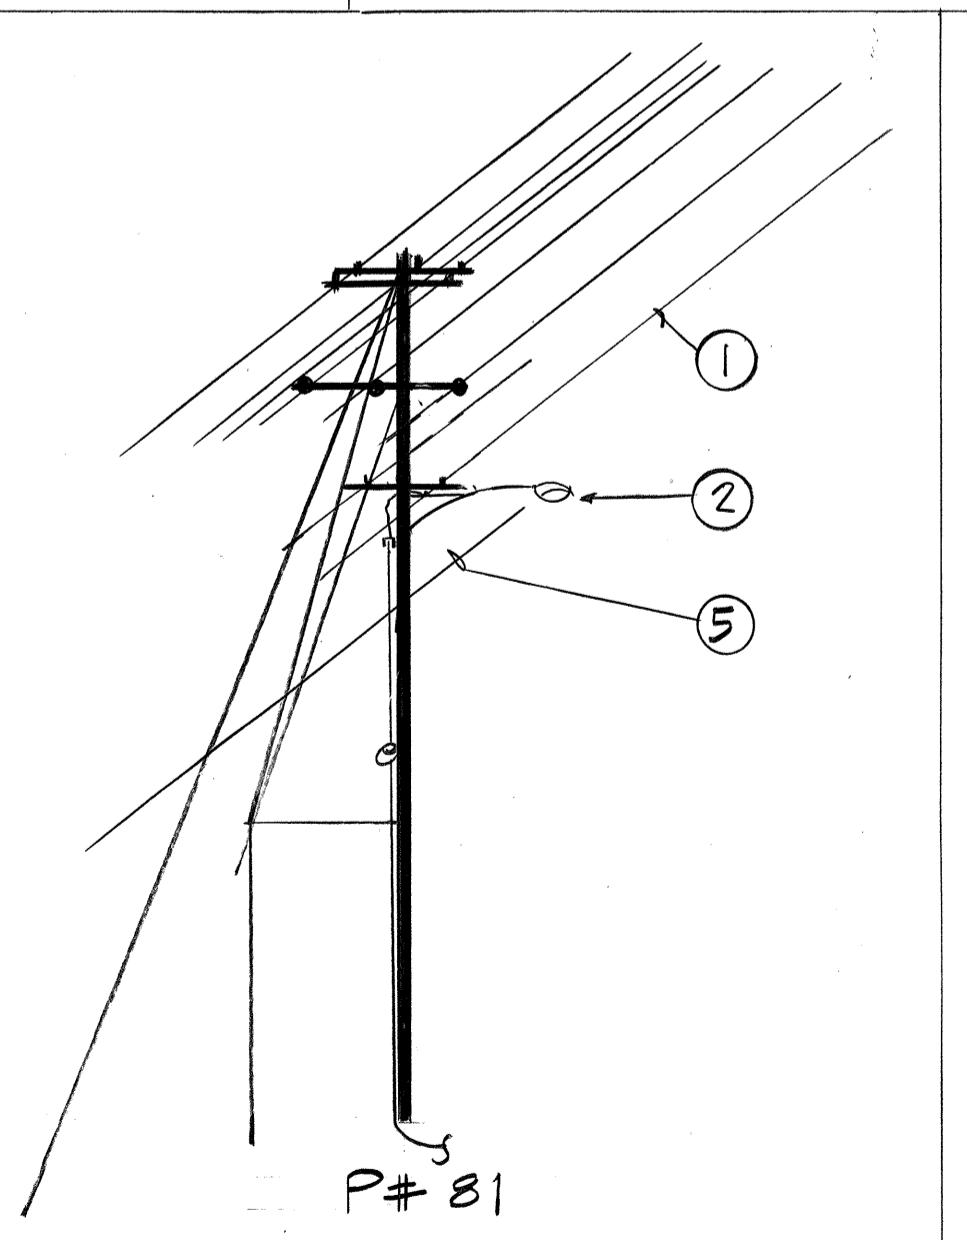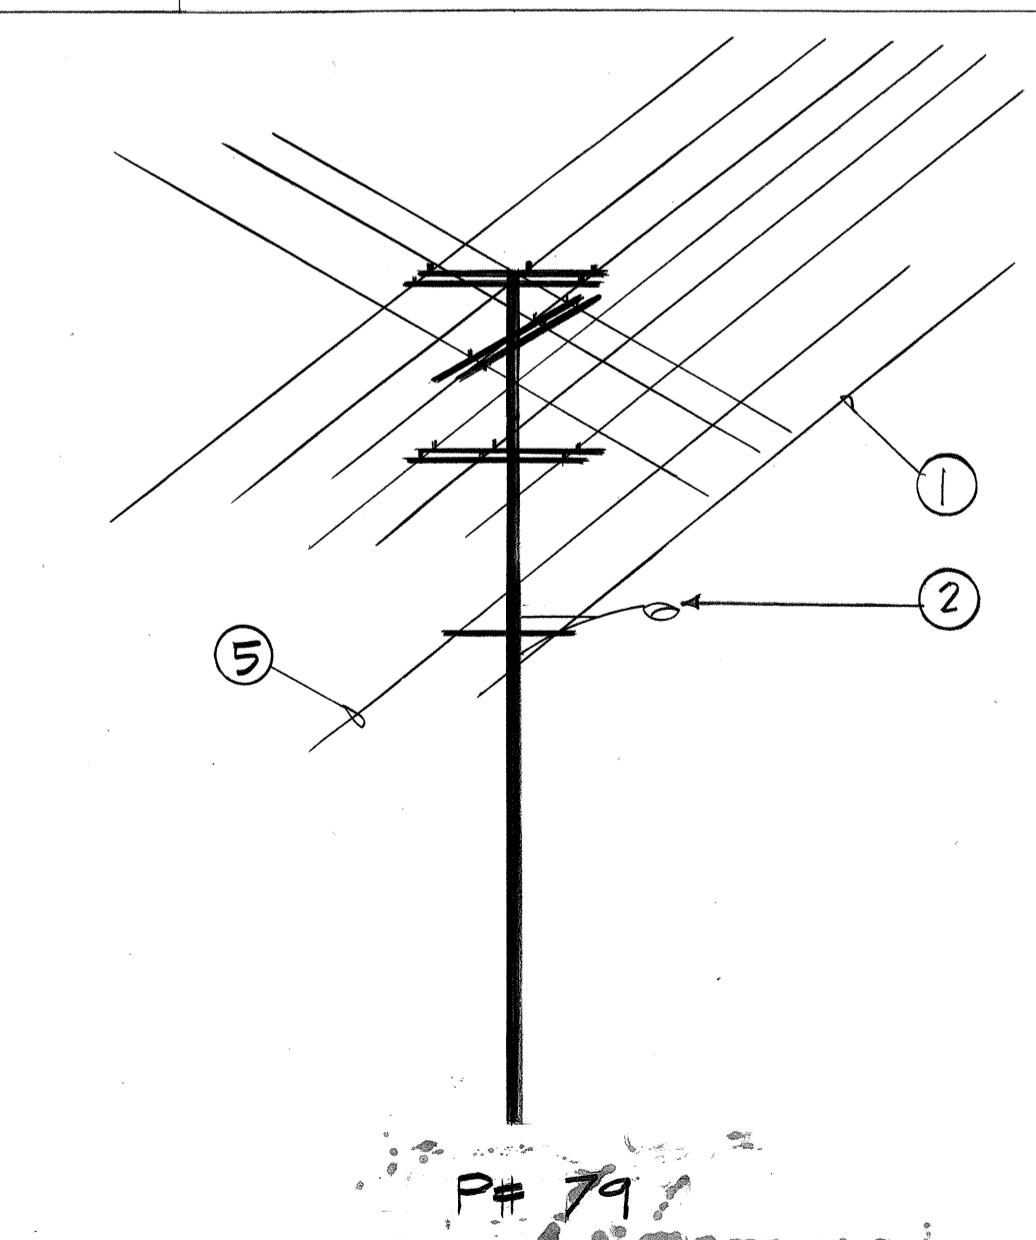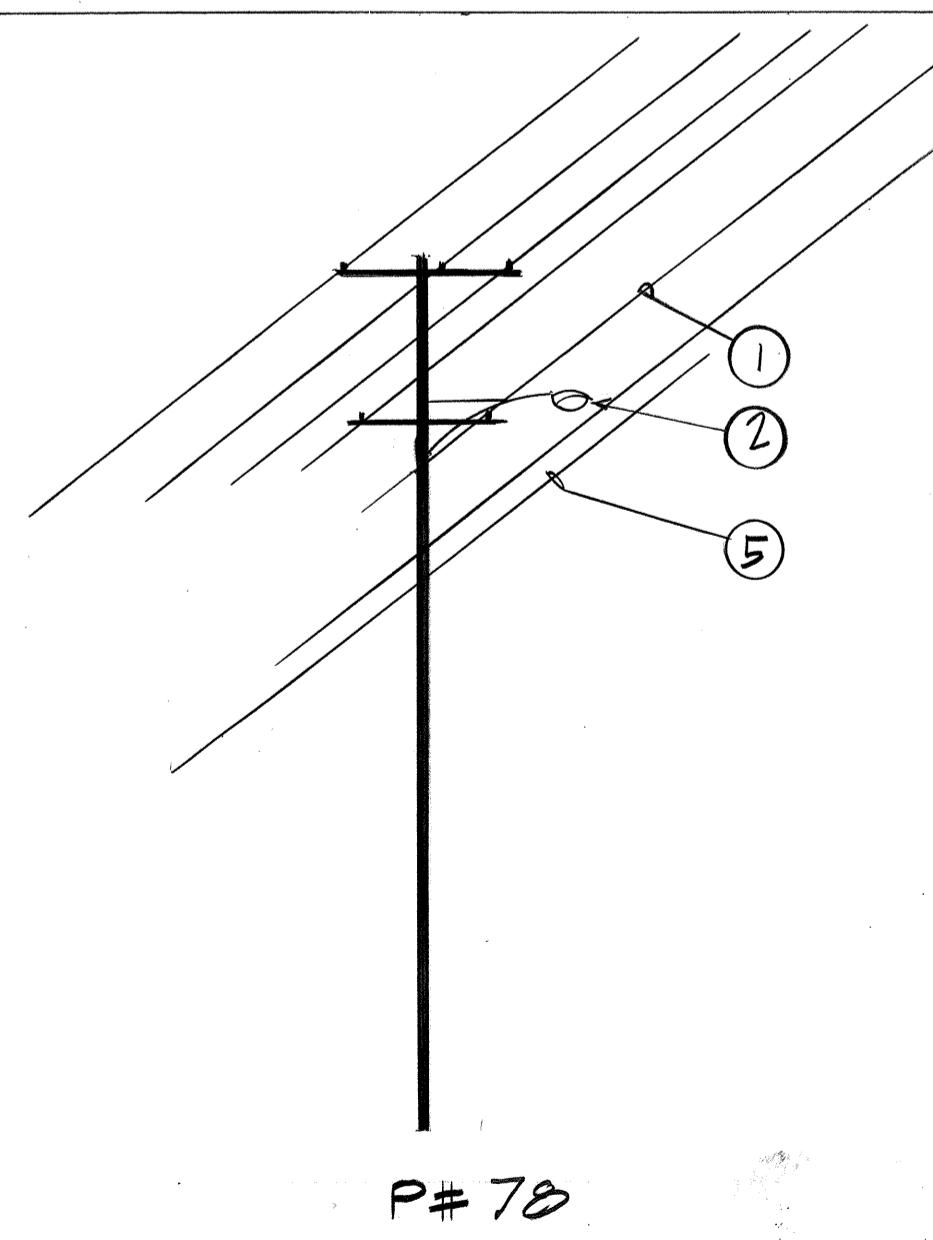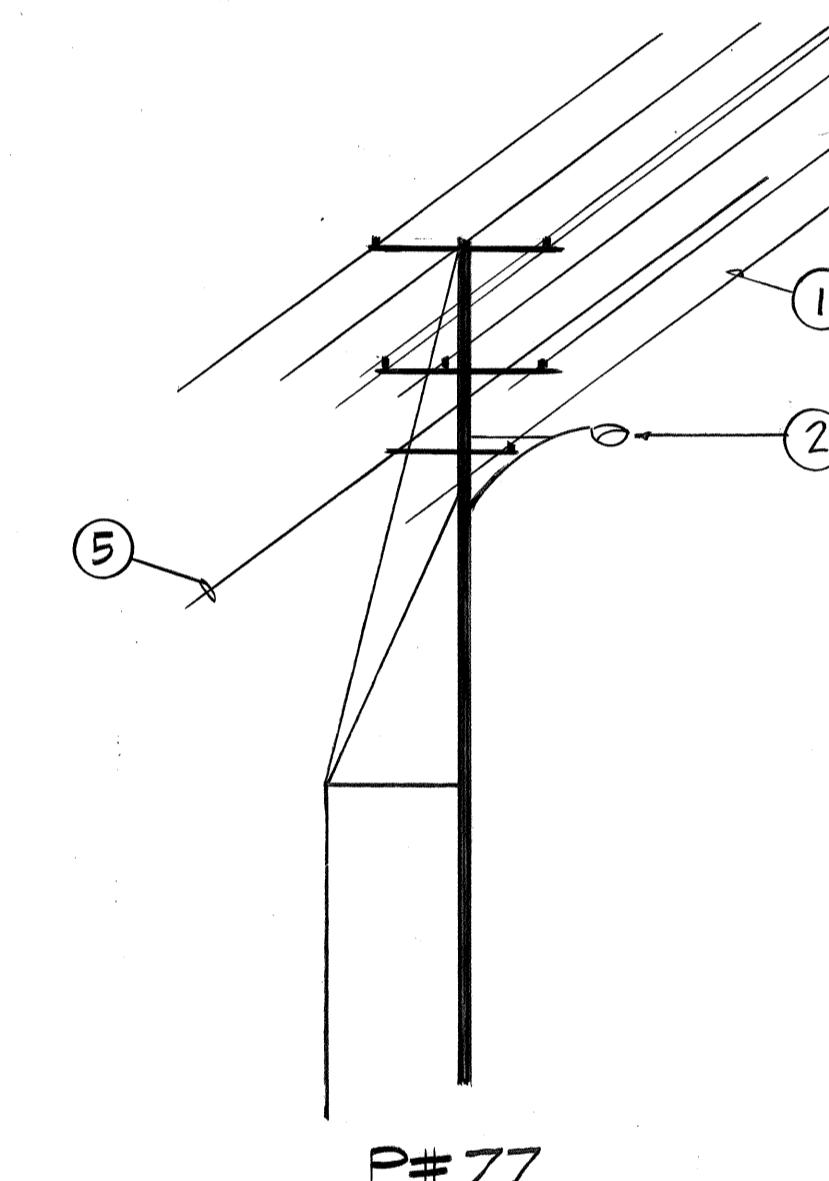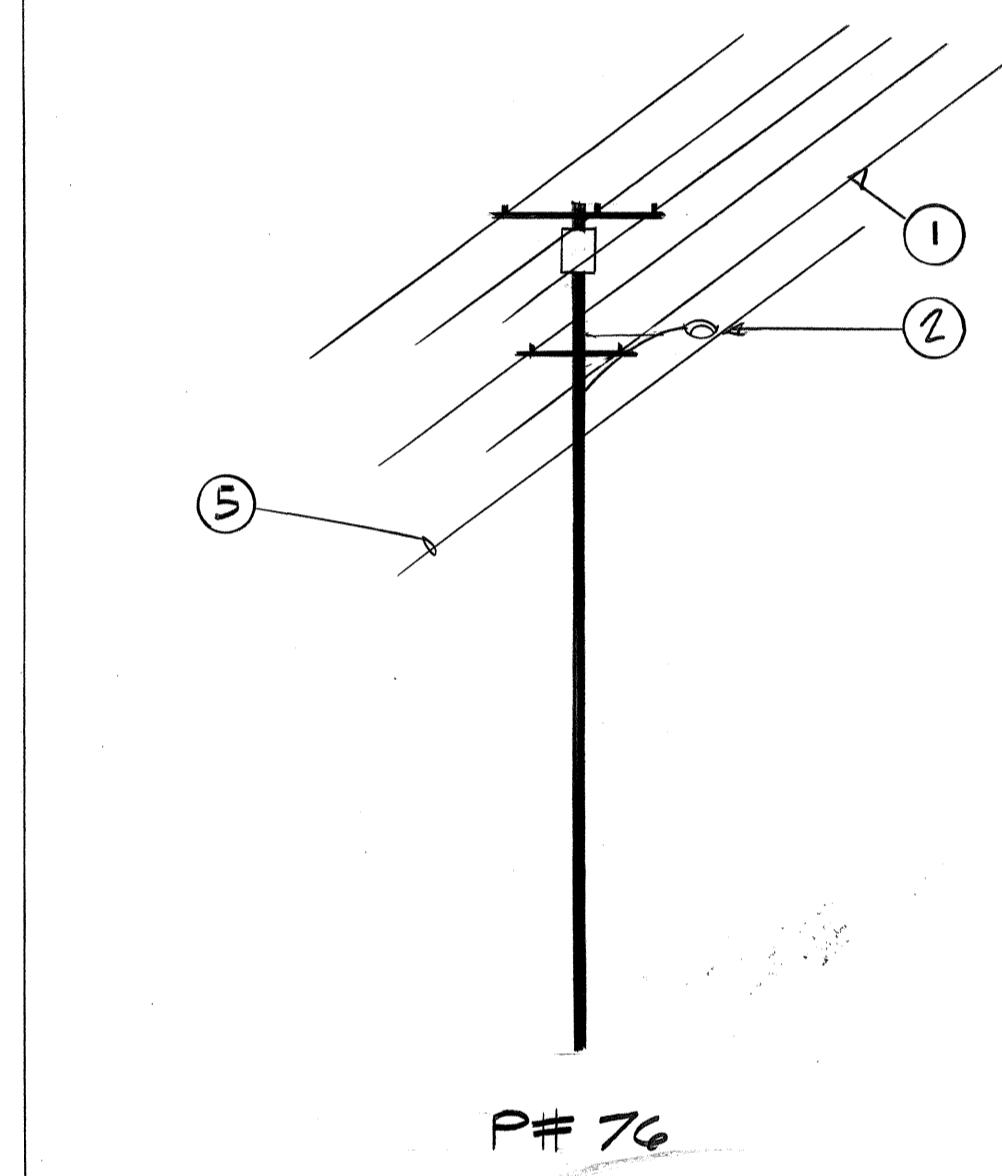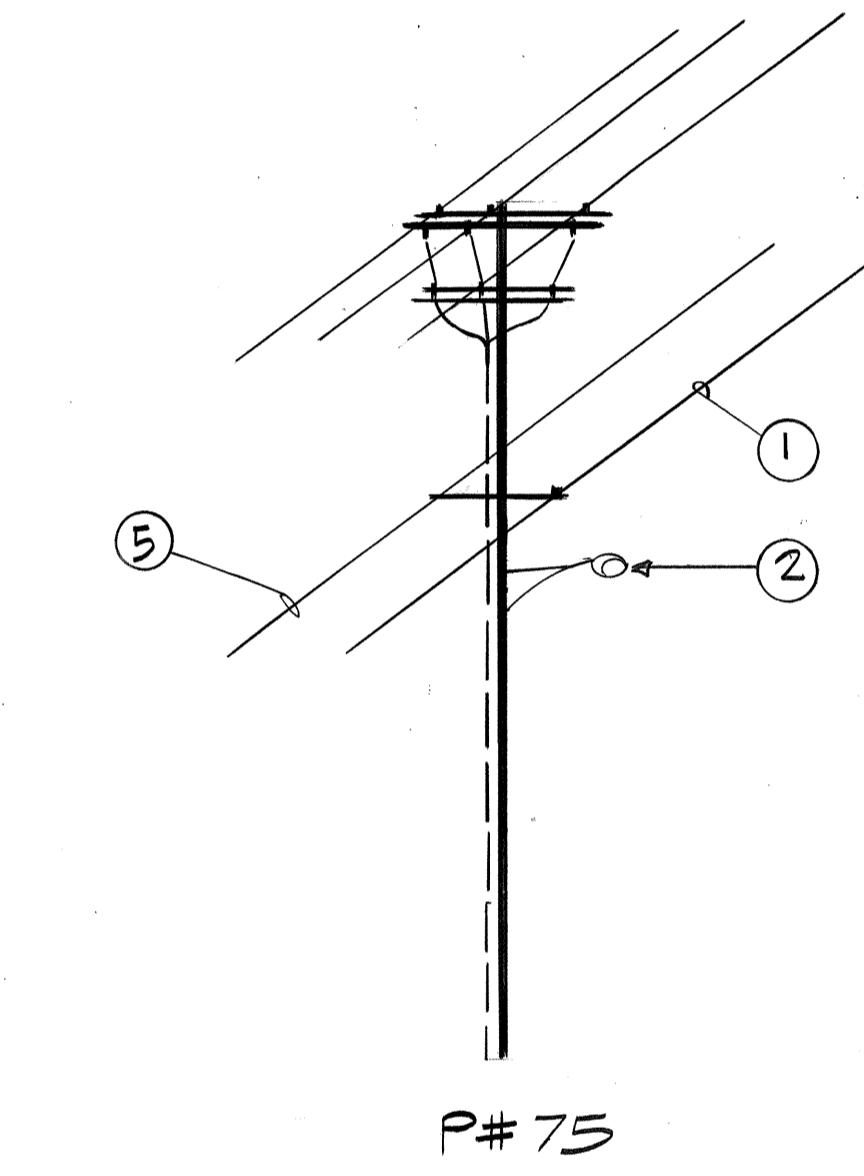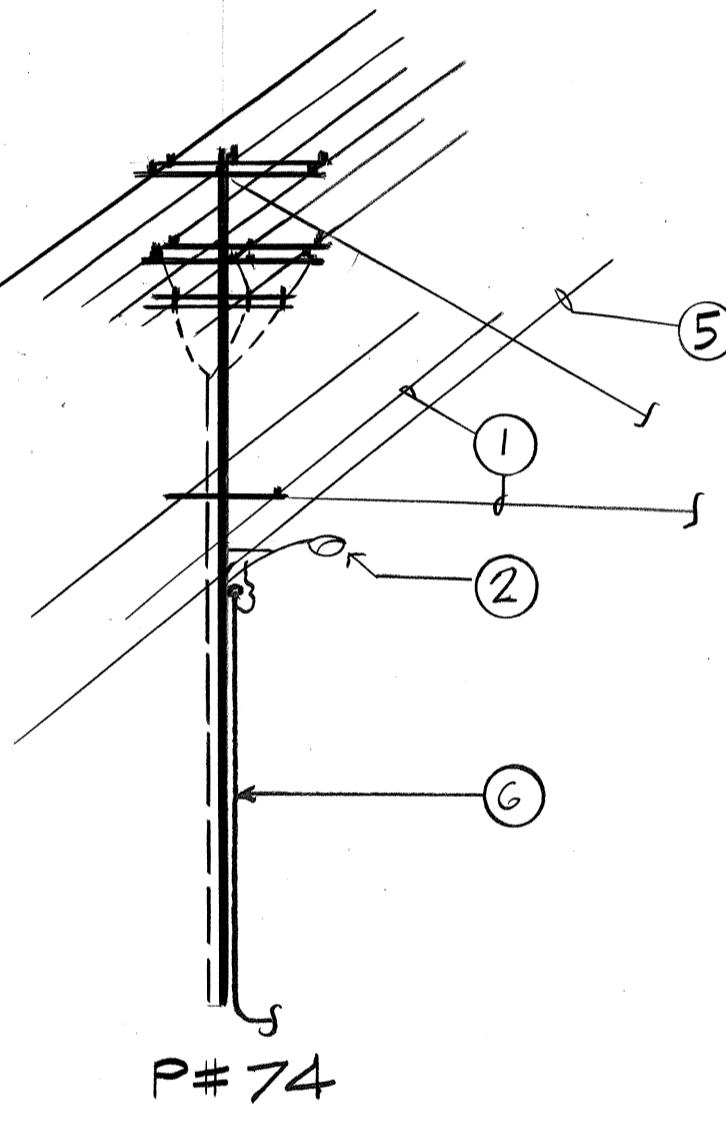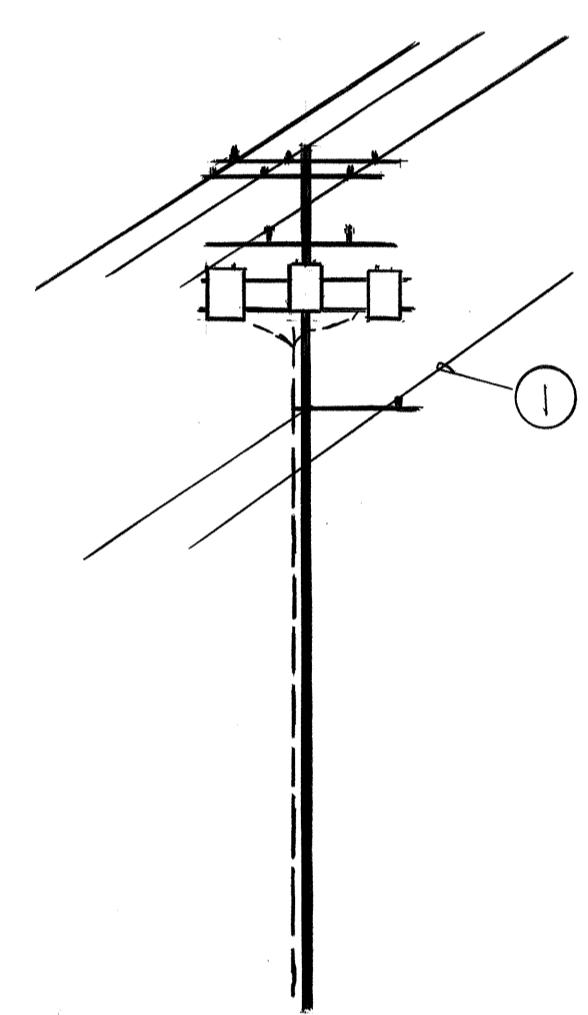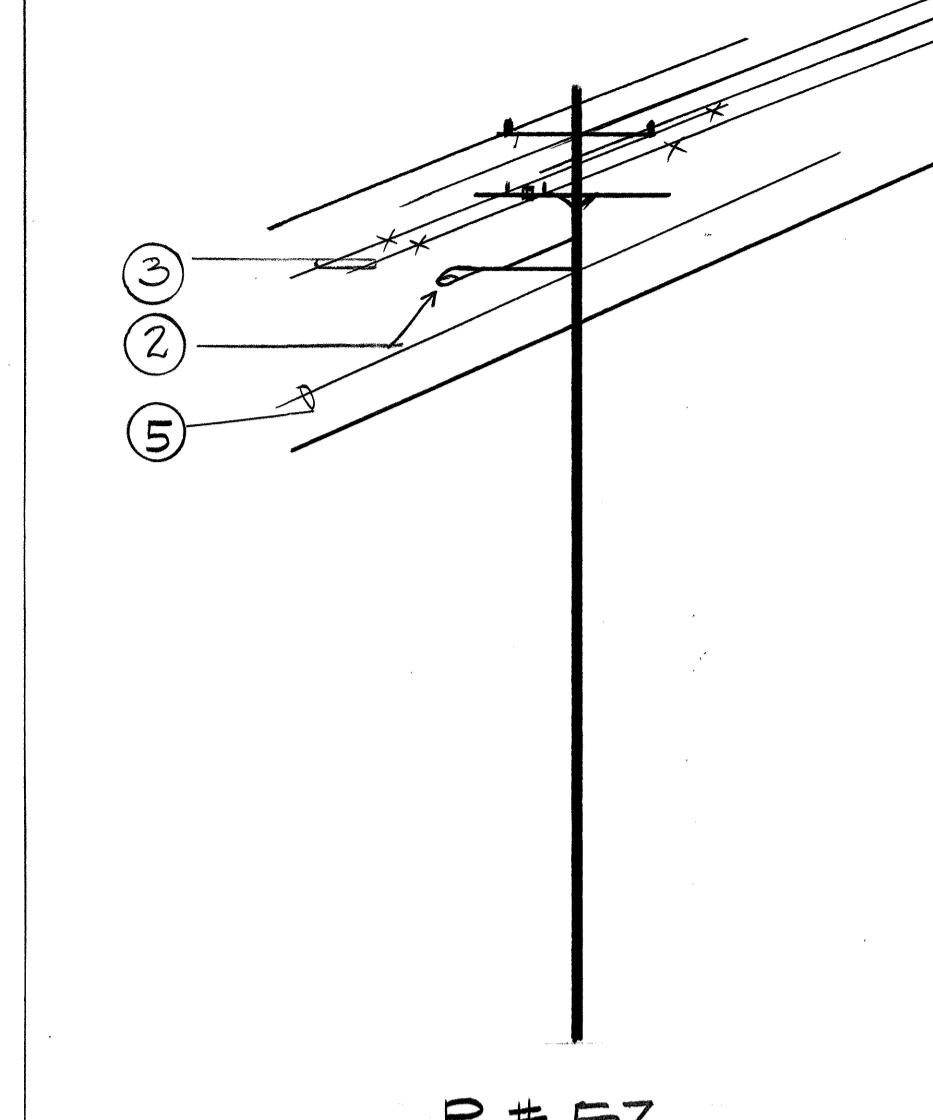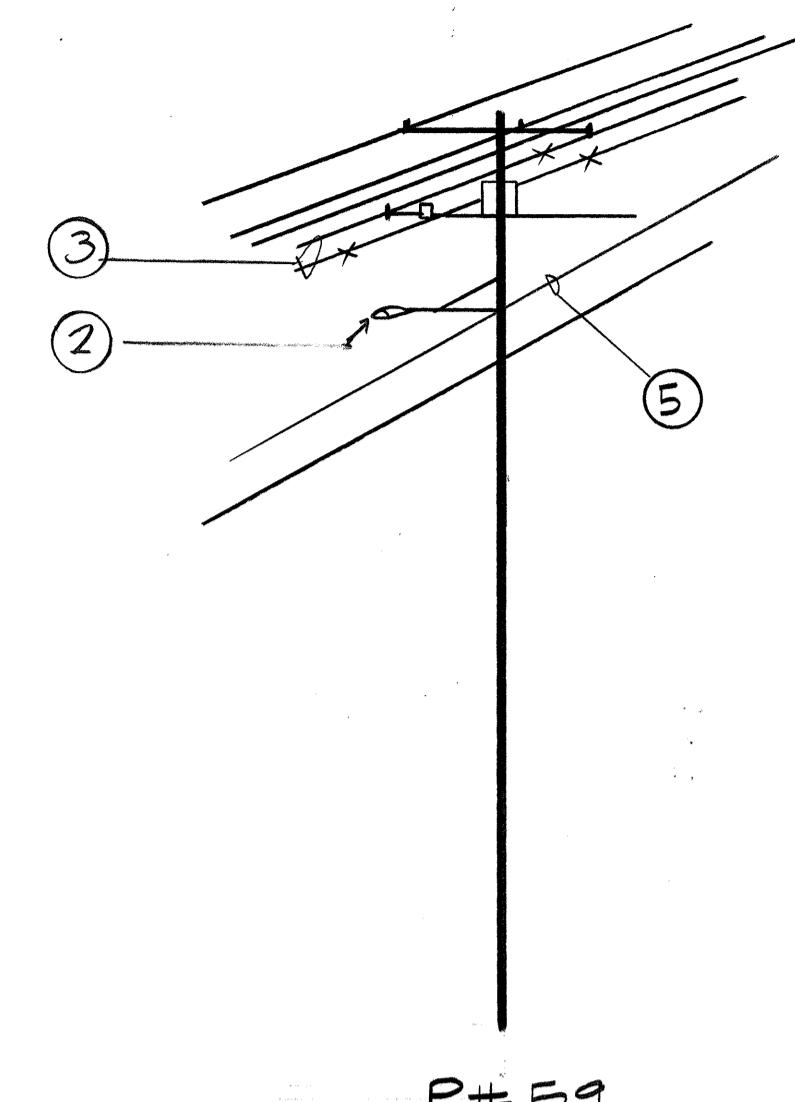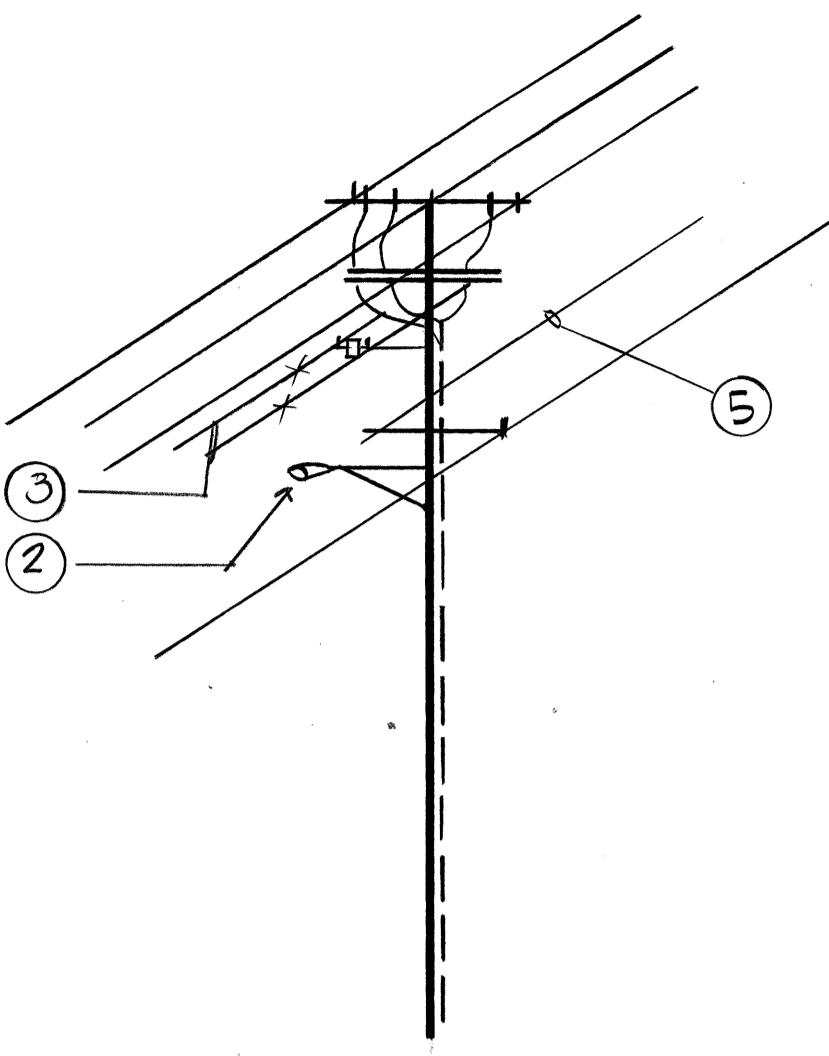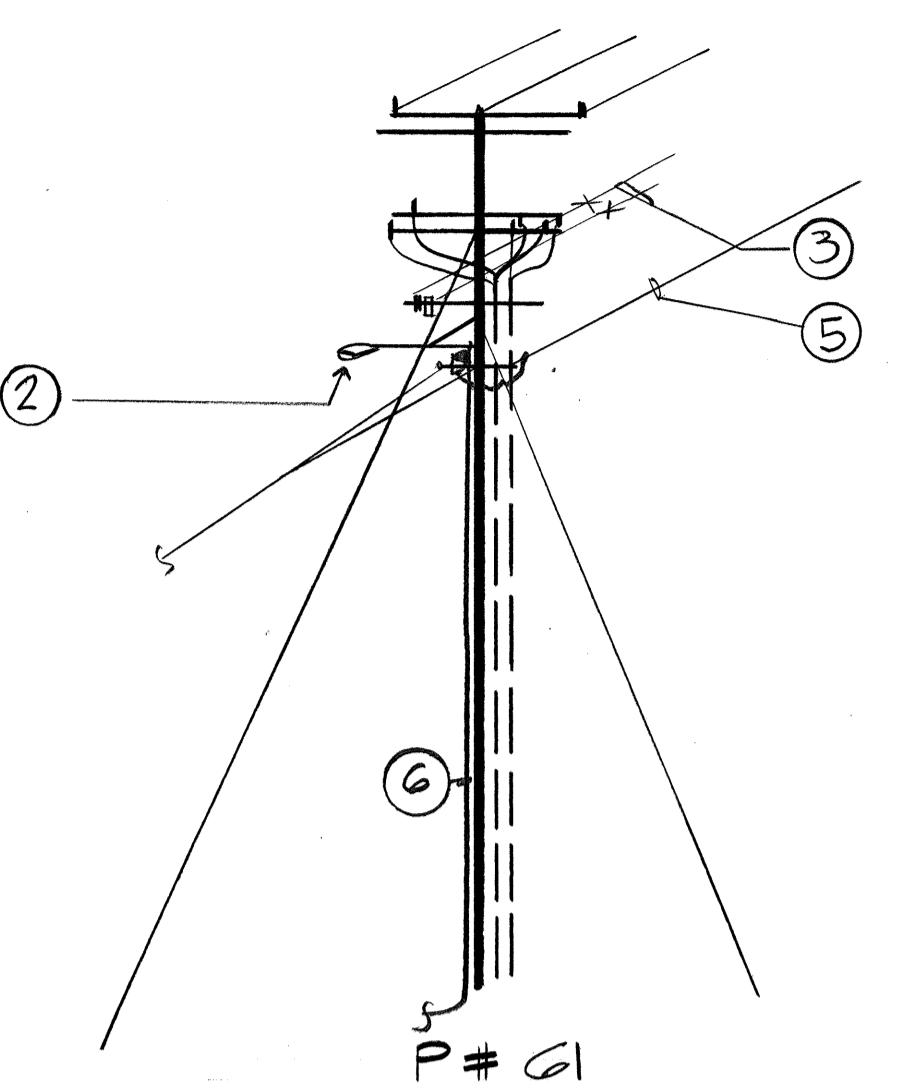

ORIGINAL SURVEY PLOTTED BY	DATE
PLAN DRAWN BY	
TRADED BY	
DESIGNED BY	
QUANTITIES BY	
CHECKED BY	
NOTE BOOK No.	

MAKAHILUA, KAHAWAHA STABCO, INC.
One Kapolei Street, Suite 403
200 Kapolei Boulevard
Honolulu, Hawaii 96813



THIS WORK WAS PREPARED IN
THE COURSE OF MY EMPLOYMENT

STATE OF HAWAII
DEPARTMENT OF TRANSPORTATION
LAND TRANSPORTATION FACILITIES DIVISION
KALIHI ST. EXTENSION
& KALIHI ST. LIGHTING
INTERSTATE H-I IMPROVEMENTS
MIDDLE STREET TO KALIHI INTERCHANGE
EASTBOUND LANES
F.A.I. PROJECT NO. I-HI-1(178)

SHEET NO. 26 OF SHEETS