

GENERAL NOTES

FED. ROAD DIST. NO.	STATE	FED. AID PROJ. NO.	FISCAL YEAR	SHEET NO.	TOTAL SHEETS
HAWAII	HAW.	I-HI-1(178)	1982	33	165

DRAINAGE NOTES:

1. Existing drainage system will be functional at all times during construction. Contractor is to furnish materials, equipment, labor, tools and incidentals necessary to accomplish maintenance of flow, the cost of which shall be incidental to the various contract items.
2. Demolishing and removing a portion or the entire existing structure shall not be paid for separately, but shall be considered incidental to the various contract items.
3. Culverts within the catch basins, grated drop intakes and storm drain manholes shall be cut flush with the inside face of the wall. Above work shall be considered incidental to the various contract items.
4. Manhole Rungs (12" o.c.) are required when "H" is greater than 4 feet 6 inches. Only one rung (16 inches from the bottom) is required if "H" is 4 feet 6 inches or less. Manhole Rungs may be placed at any location as ordered by the Engineer. Manhole Rungs shall be considered incidental to Class "A" Concrete.
5. Location of C.I. Frame and Cover for drain manholes or catch basins shall be determined by the Engineer in the field.
6. Contractor shall verify the locations of all culverts in the field. Any culvert damaged during construction shall be repaired or replaced by the Contractor at his expense.
7. Only non-pneumatic type of drill as approved by the Engineer will be permitted for drilling holes in concrete. Where indicated on plans, the approximate diameter of drilled holes for installation of dowels shall be 1½ inches, after installing dowels, the voids shall be filled with epoxy grout as directed by the Engineer. Above work shall be considered incidental to the various contract items.
8. Concrete for grated drop intakes, drain manholes and catch basins shall be Class "A".
9. Premolded joint filler shall be considered incidental to Class "A" Concrete.
10. Quantities for concrete gutter aprons shall be considered as part of structure.
11. Existing cast iron frame and covers shall be cleaned and painted before installation. Above work shall be considered incidental to the various contract items.
12. Salvaged C.I. Frame and Covers shall be cleaned, painted and returned to 727 Kakoi St, Honolulu, Hawaii 96819.

SPRINKLER NOTES:


1. Abandon sprinkler systems affected by the roadway construction and as noted on the plans shall be removed. Removal shall be incidental to Roadway Excavation.
2. Excavation for cut and plug work shall not be paid for but shall be considered incidental to the various contract items.
3. The removal of water meters shall be done by BWS. Contractor to notify BWS Customer Service at phone no. 548-6165, two weeks in advance for this work. Water Meter service numbers are as follows: 706-11753, 704-11602 and 704-11552.

ORIGINAL SURVEY PLOTTED BY	DATE
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REMOVED BY	
CHECKED BY	
NOTE BOOK	
PLAN No.	

STATE OF HAWAII
DEPARTMENT OF TRANSPORTATION
HIGHWAYS DIVISION
DRAINAGE AND SPRINKLER PLAN
INTERSTATE H-I IMPROVEMENTS
MIDDLE STREET TO KALIHI INTERCHANGE
EASTBOUND LANES
F.A.I. PROJECT NO. I-HI-K(178)

SHEET NO. 1 OF 33 SHEETS

FED. ROAD DIST. NO.	STATE	FED. AID PROJ. NO.	FISCAL YEAR	SHEET NO.	TOTAL SHEETS
HAWAII	HAW.	I-HI-I(178)	1982	34	165

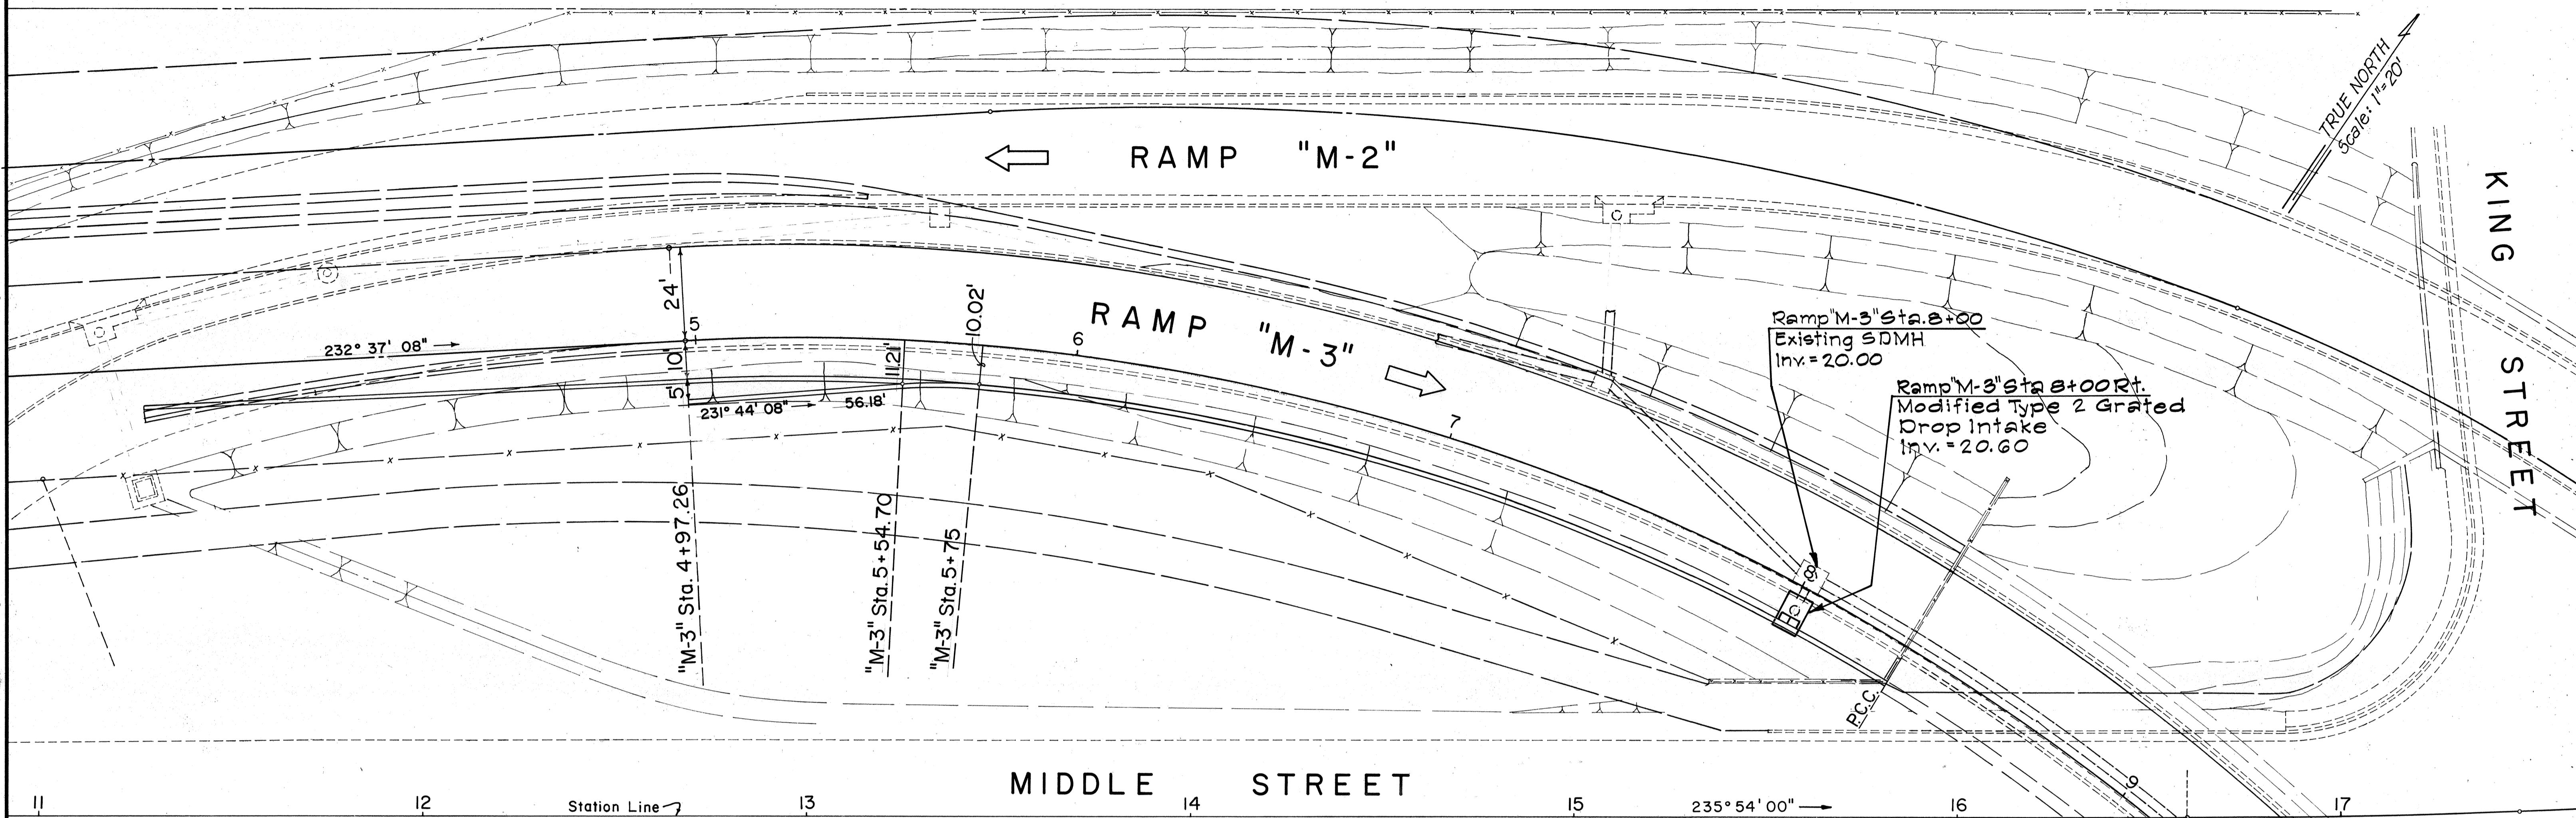

Ramp "M-3" Sta. 8+00
Construct: Adjust SDMH Framed Cover

Estimated Quantities
Adjust SDMH Framed Cover
0.10 feet to 0.50 feet = 1 ea.

Ramp "M-3" Sta. 8+00 Rt.
Reconstruct: Modified Type 2 Grated Drop Intake
(For details, see sh. no. 43)

Estimated Quantities
Modified Type 2 Grated Drop Intake
5.00 feet to 5.99 feet = 1 ea.
Salvage C.I. Frame & Cover = 1 ea.

STATE OF HAWAII
DEPARTMENT OF TRANSPORTATION
HIGHWAYS DIVISION

DRAINAGE AND SPRINKLER PLAN


INTERSTATE H-1 IMPROVEMENTS
MIDDLE STREET TO KALIHI INTERCHANGE
EASTBOUND LANES
F.A.I. PROJECT NO. I-HI-I(178)

SCALE: AS NOTED


SHEET No. 2 OF 33 SHEETS

ORIGINAL PLAN
SURVEY PLOTTED BY
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No. _____

FED. ROAD DIST. NO.	STATE	FED. AID PROJ. NO.	FISCAL YEAR	SHEET NO.	TOTAL SHEETS
HAWAII	HAW	I-HI-1(178)	1982	35	165

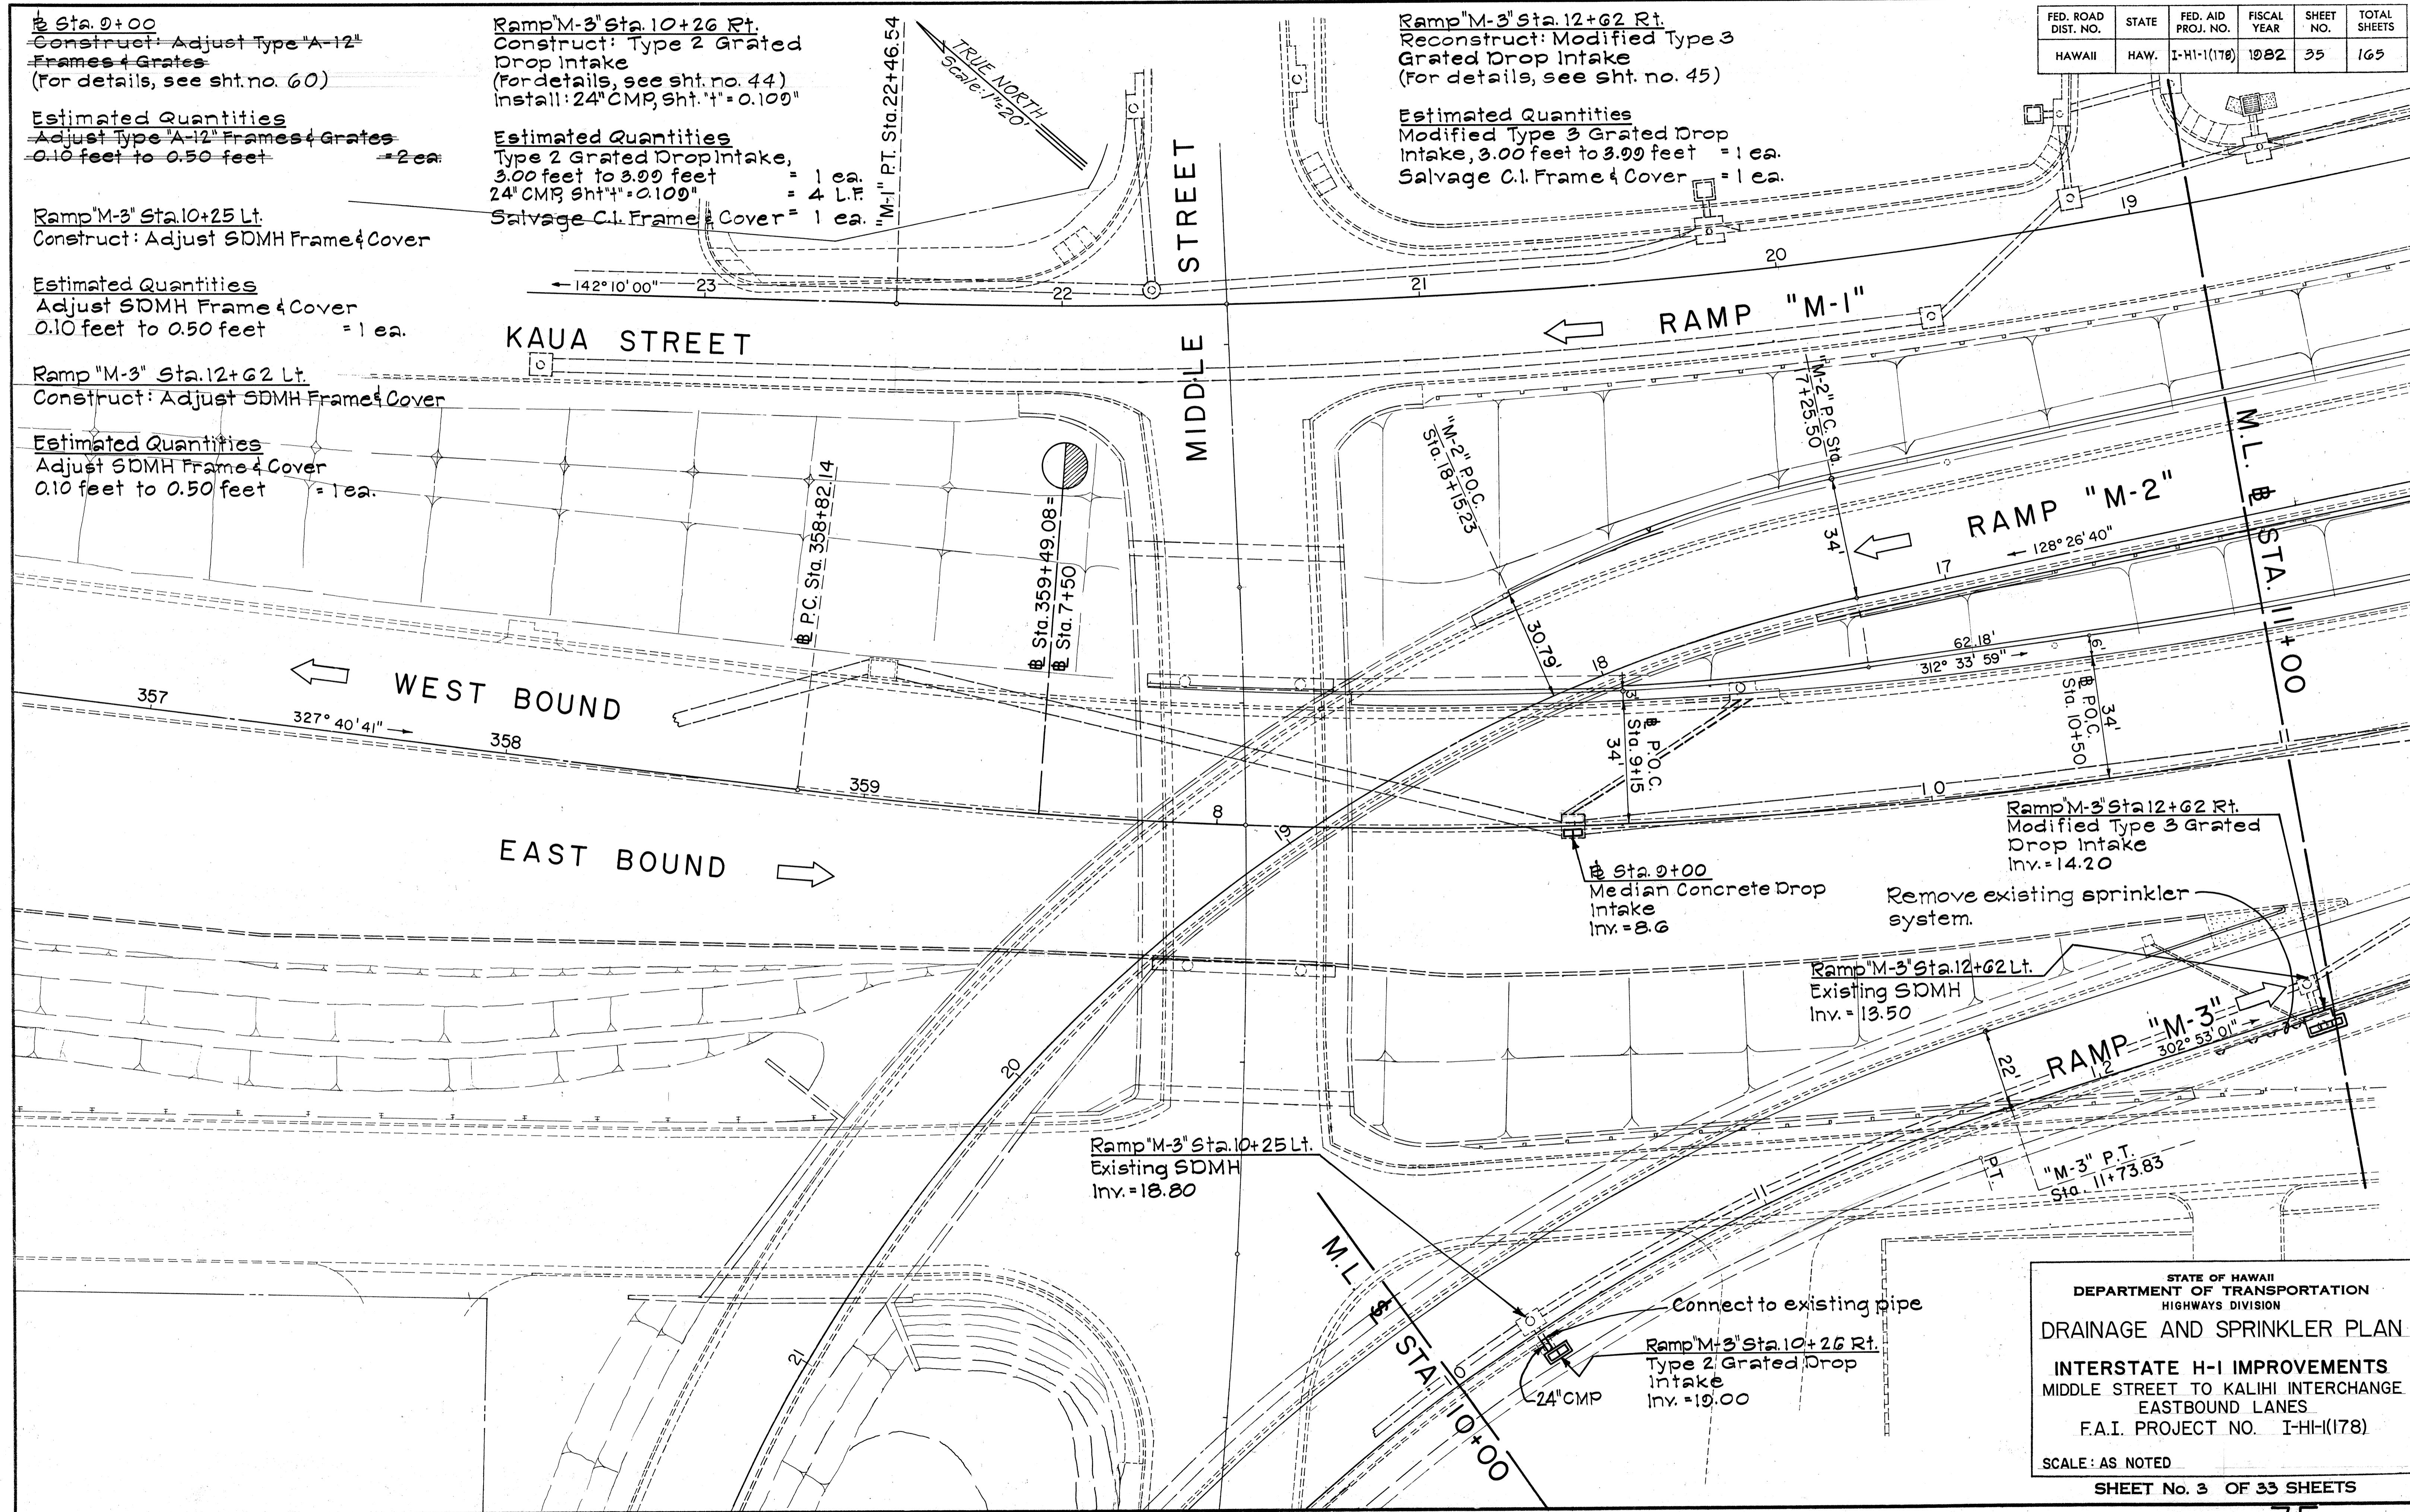

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STATE OF HAWAII
 DEPARTMENT OF TRANSPORTATION
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 DRAINAGE AND SPRINKLER PLAN
 INTERSTATE H-I IMPROVEMENTS
 MIDDLE STREET TO KALIHI INTERCHANGE
 EASTBOUND LANES
 F.A.I. PROJECT NO. I-HI-1(178)

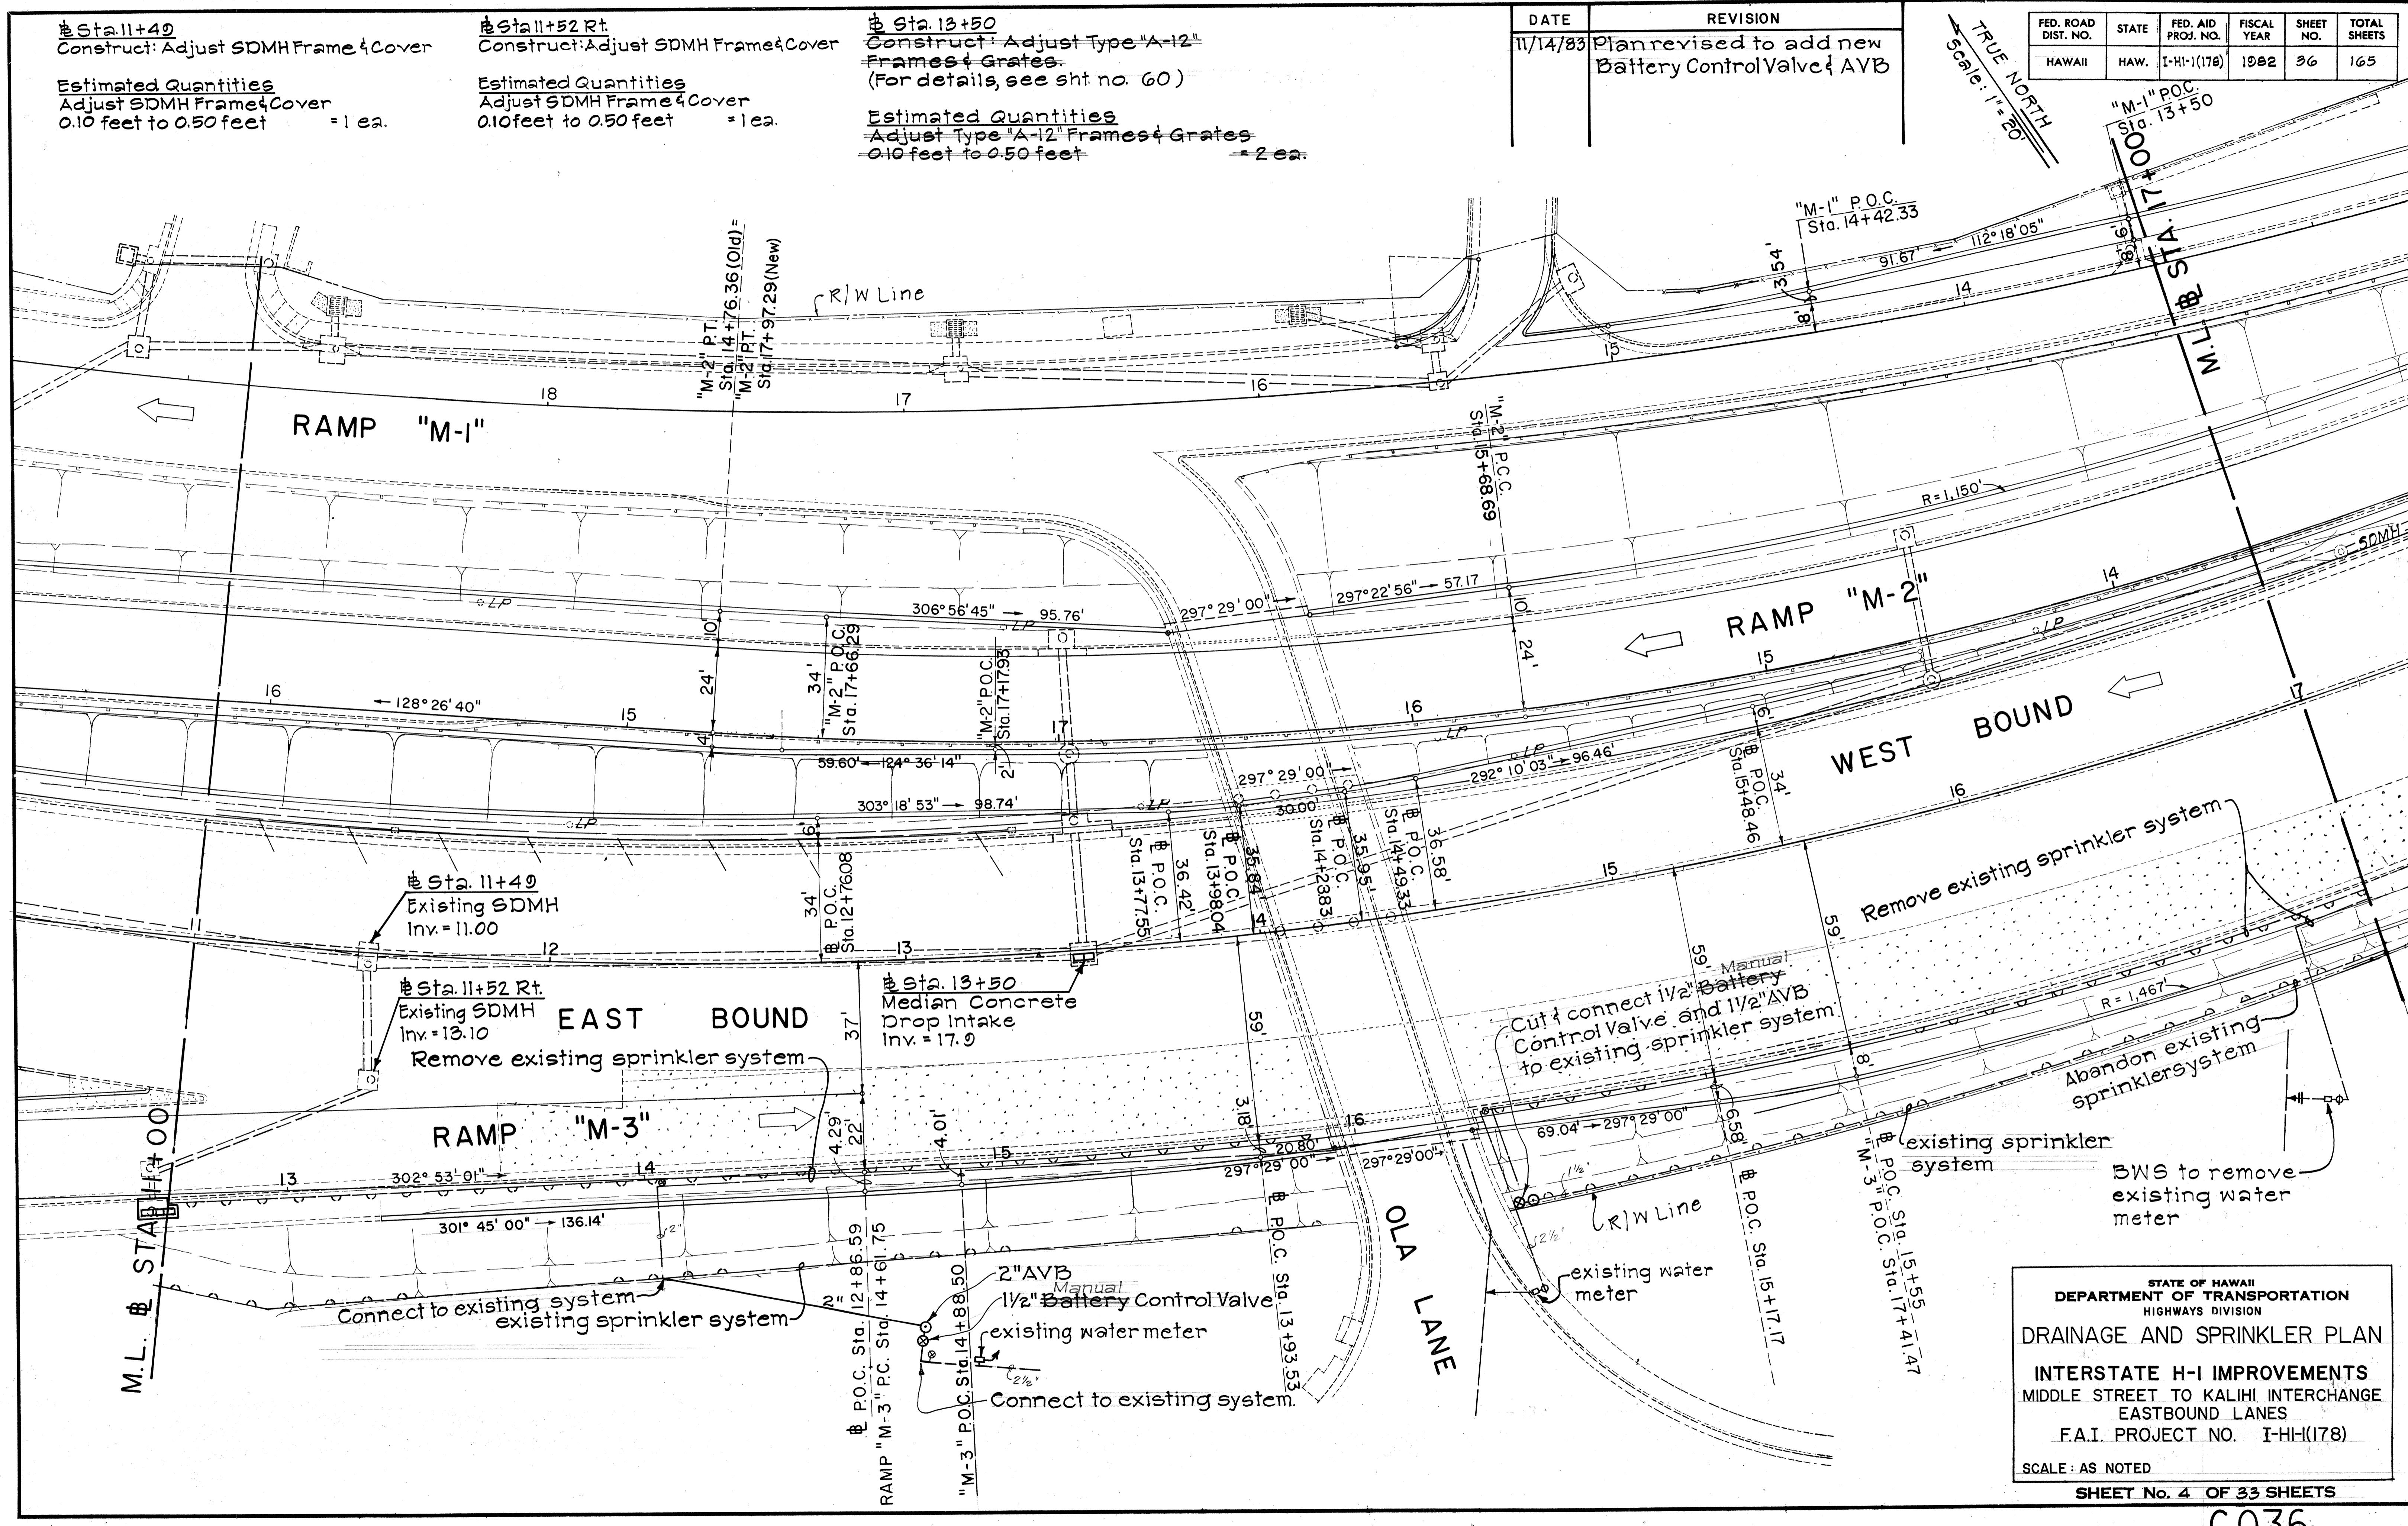
SCALE: AS NOTED

SHEET No. 4 OF 33 SHEETS

C.036

FED. ROAD DIST. NO.	STATE	FED. AID PROJ. NO.	FISCAL YEAR	HEET NO.	TOTAL SHEETS
HAWAII	HAW.	I-HI-1(178)	1982	37	165


M.L. B STA. 17+00

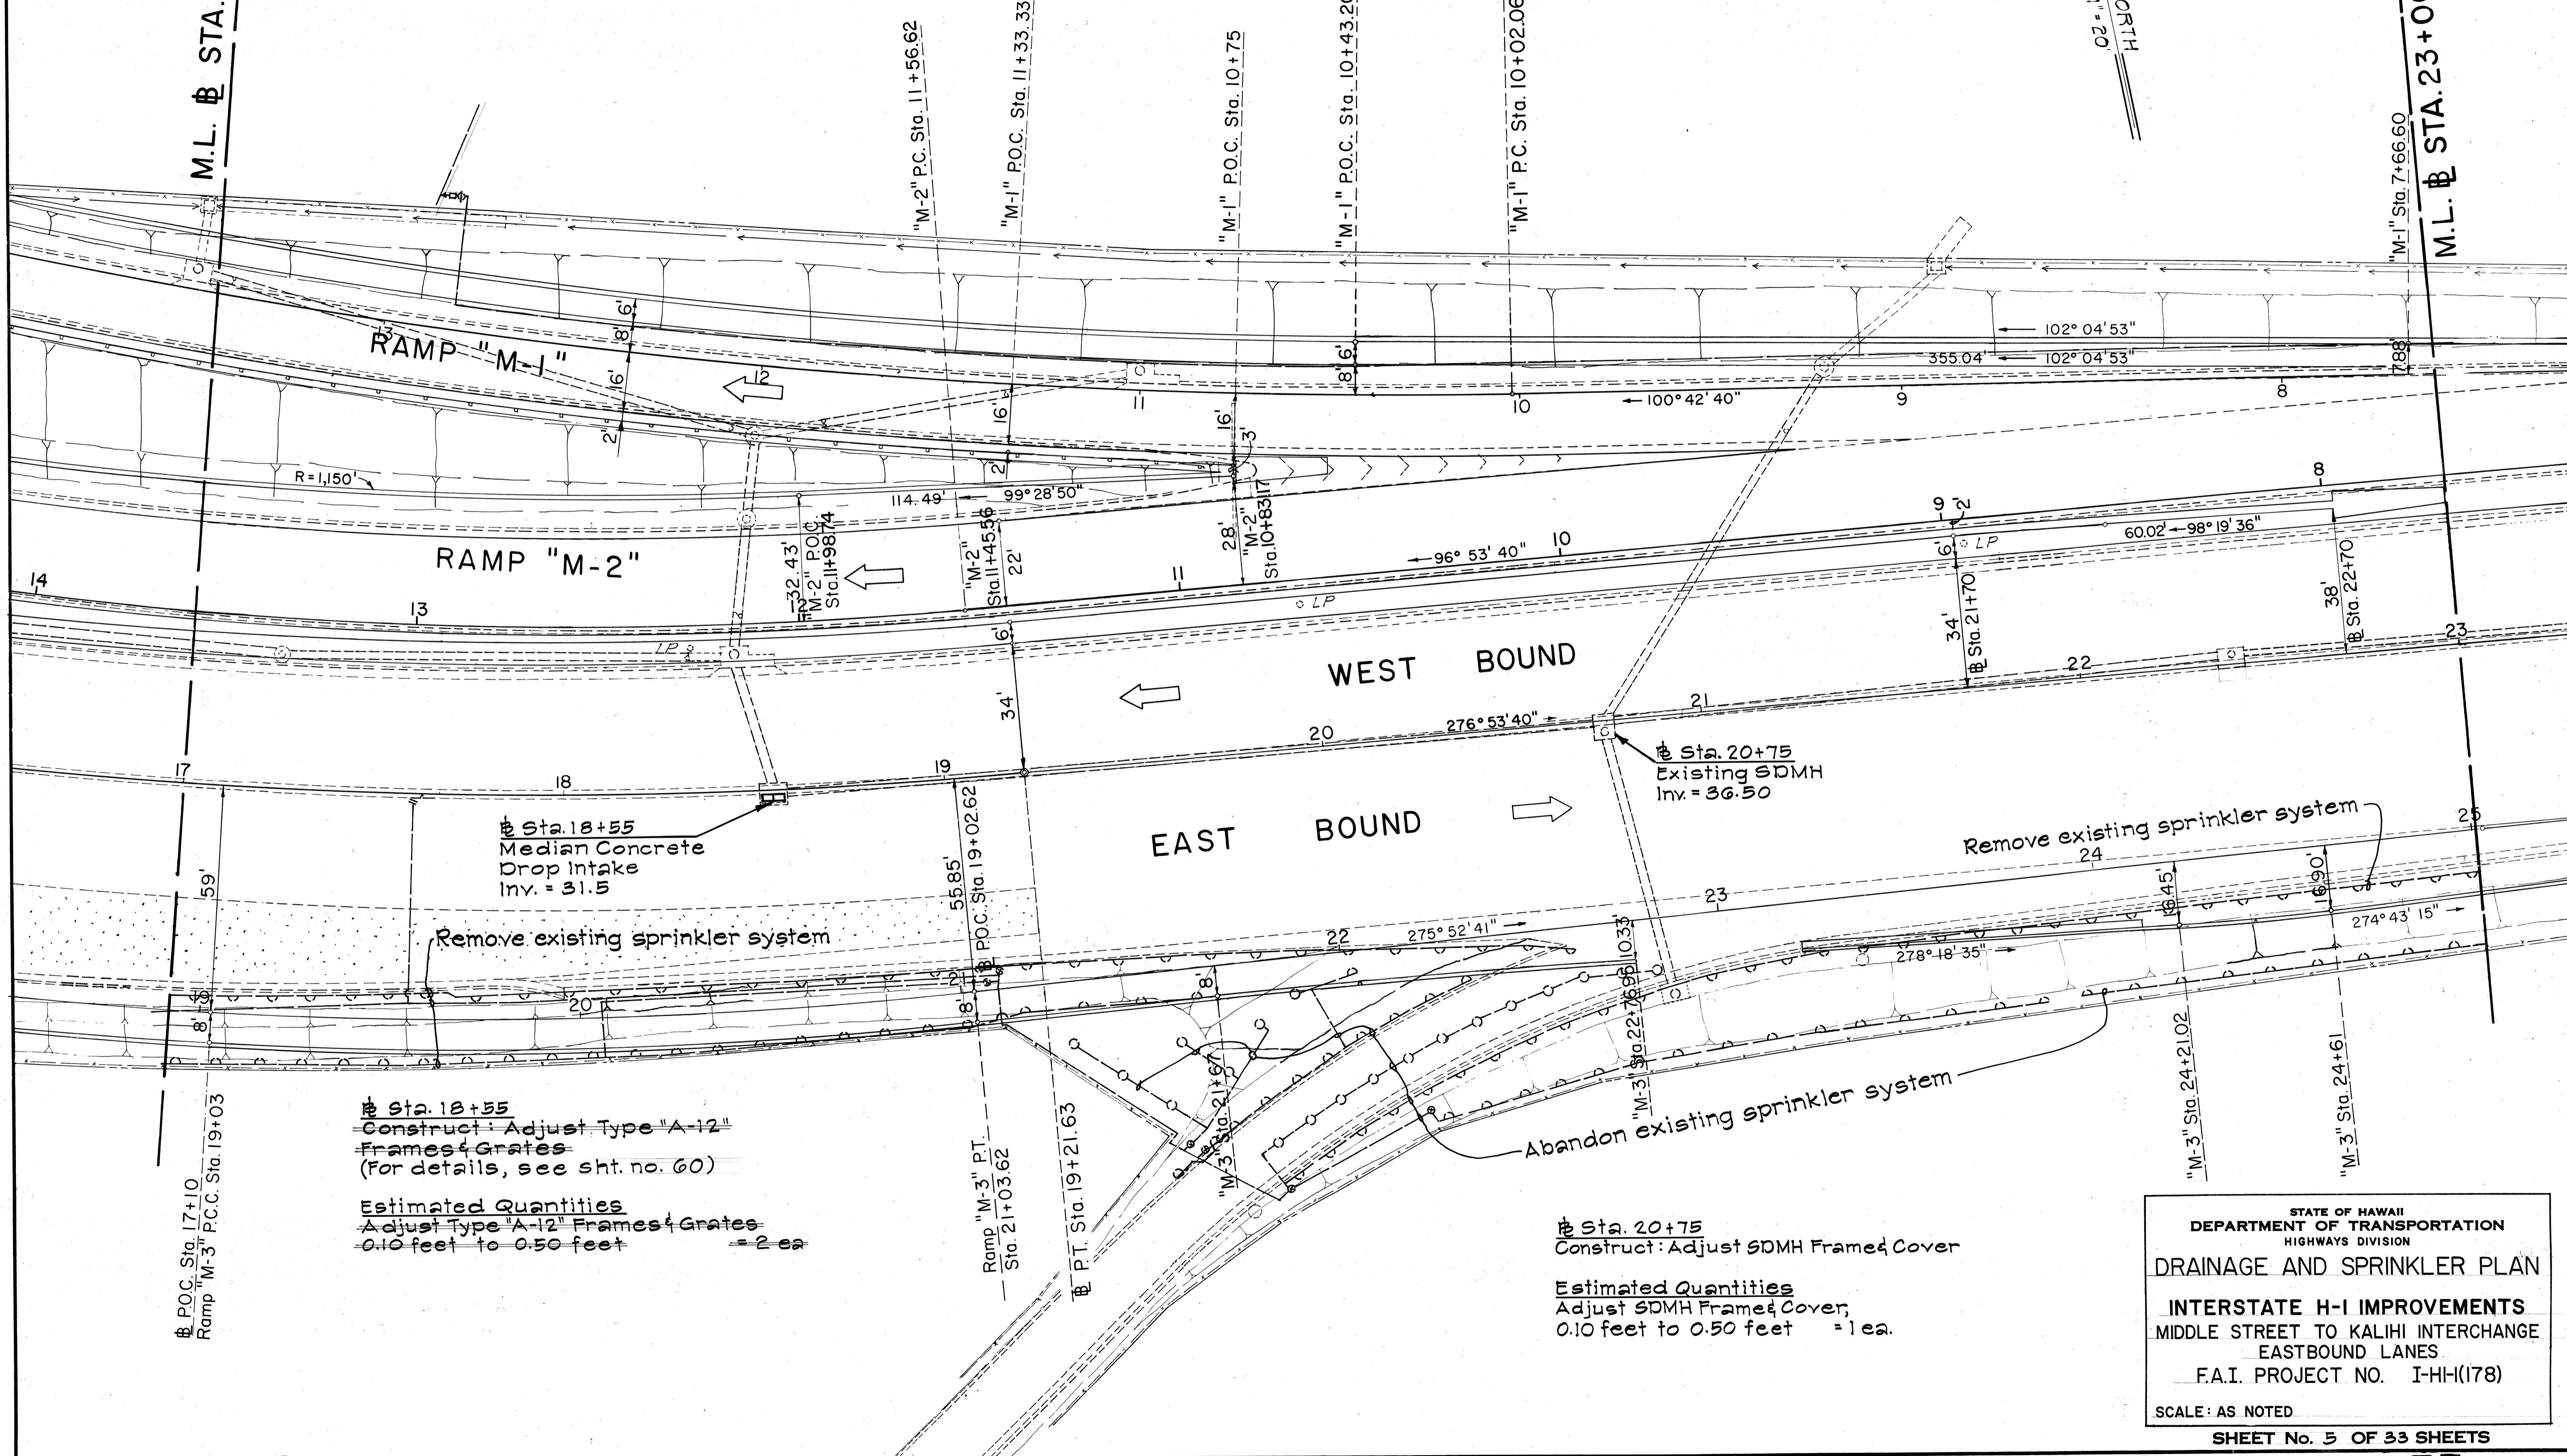

STATE OF HAWAII
DEPARTMENT OF TRANSPORTATION
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DRAINAGE AND SPRINKLER PLAN
INTERSTATE H-1 IMPROVEMENTS
MIDDLE STREET TO KALIHI INTERCHANGE
EASTBOUND LANES
F.A.I. PROJECT NO. I-HI-1(178)

SCALE: AS NOTED
SHEET No. 5 OF 33 SHEETS


FED. ROAD DIST. NO.	STATE	FED. AID PROJ. NO.	FISCAL YEAR	SHEET NO.	TOTAL SHEETS
HAWAII	HAW.	I-HI-1(I78)	1982	38	165

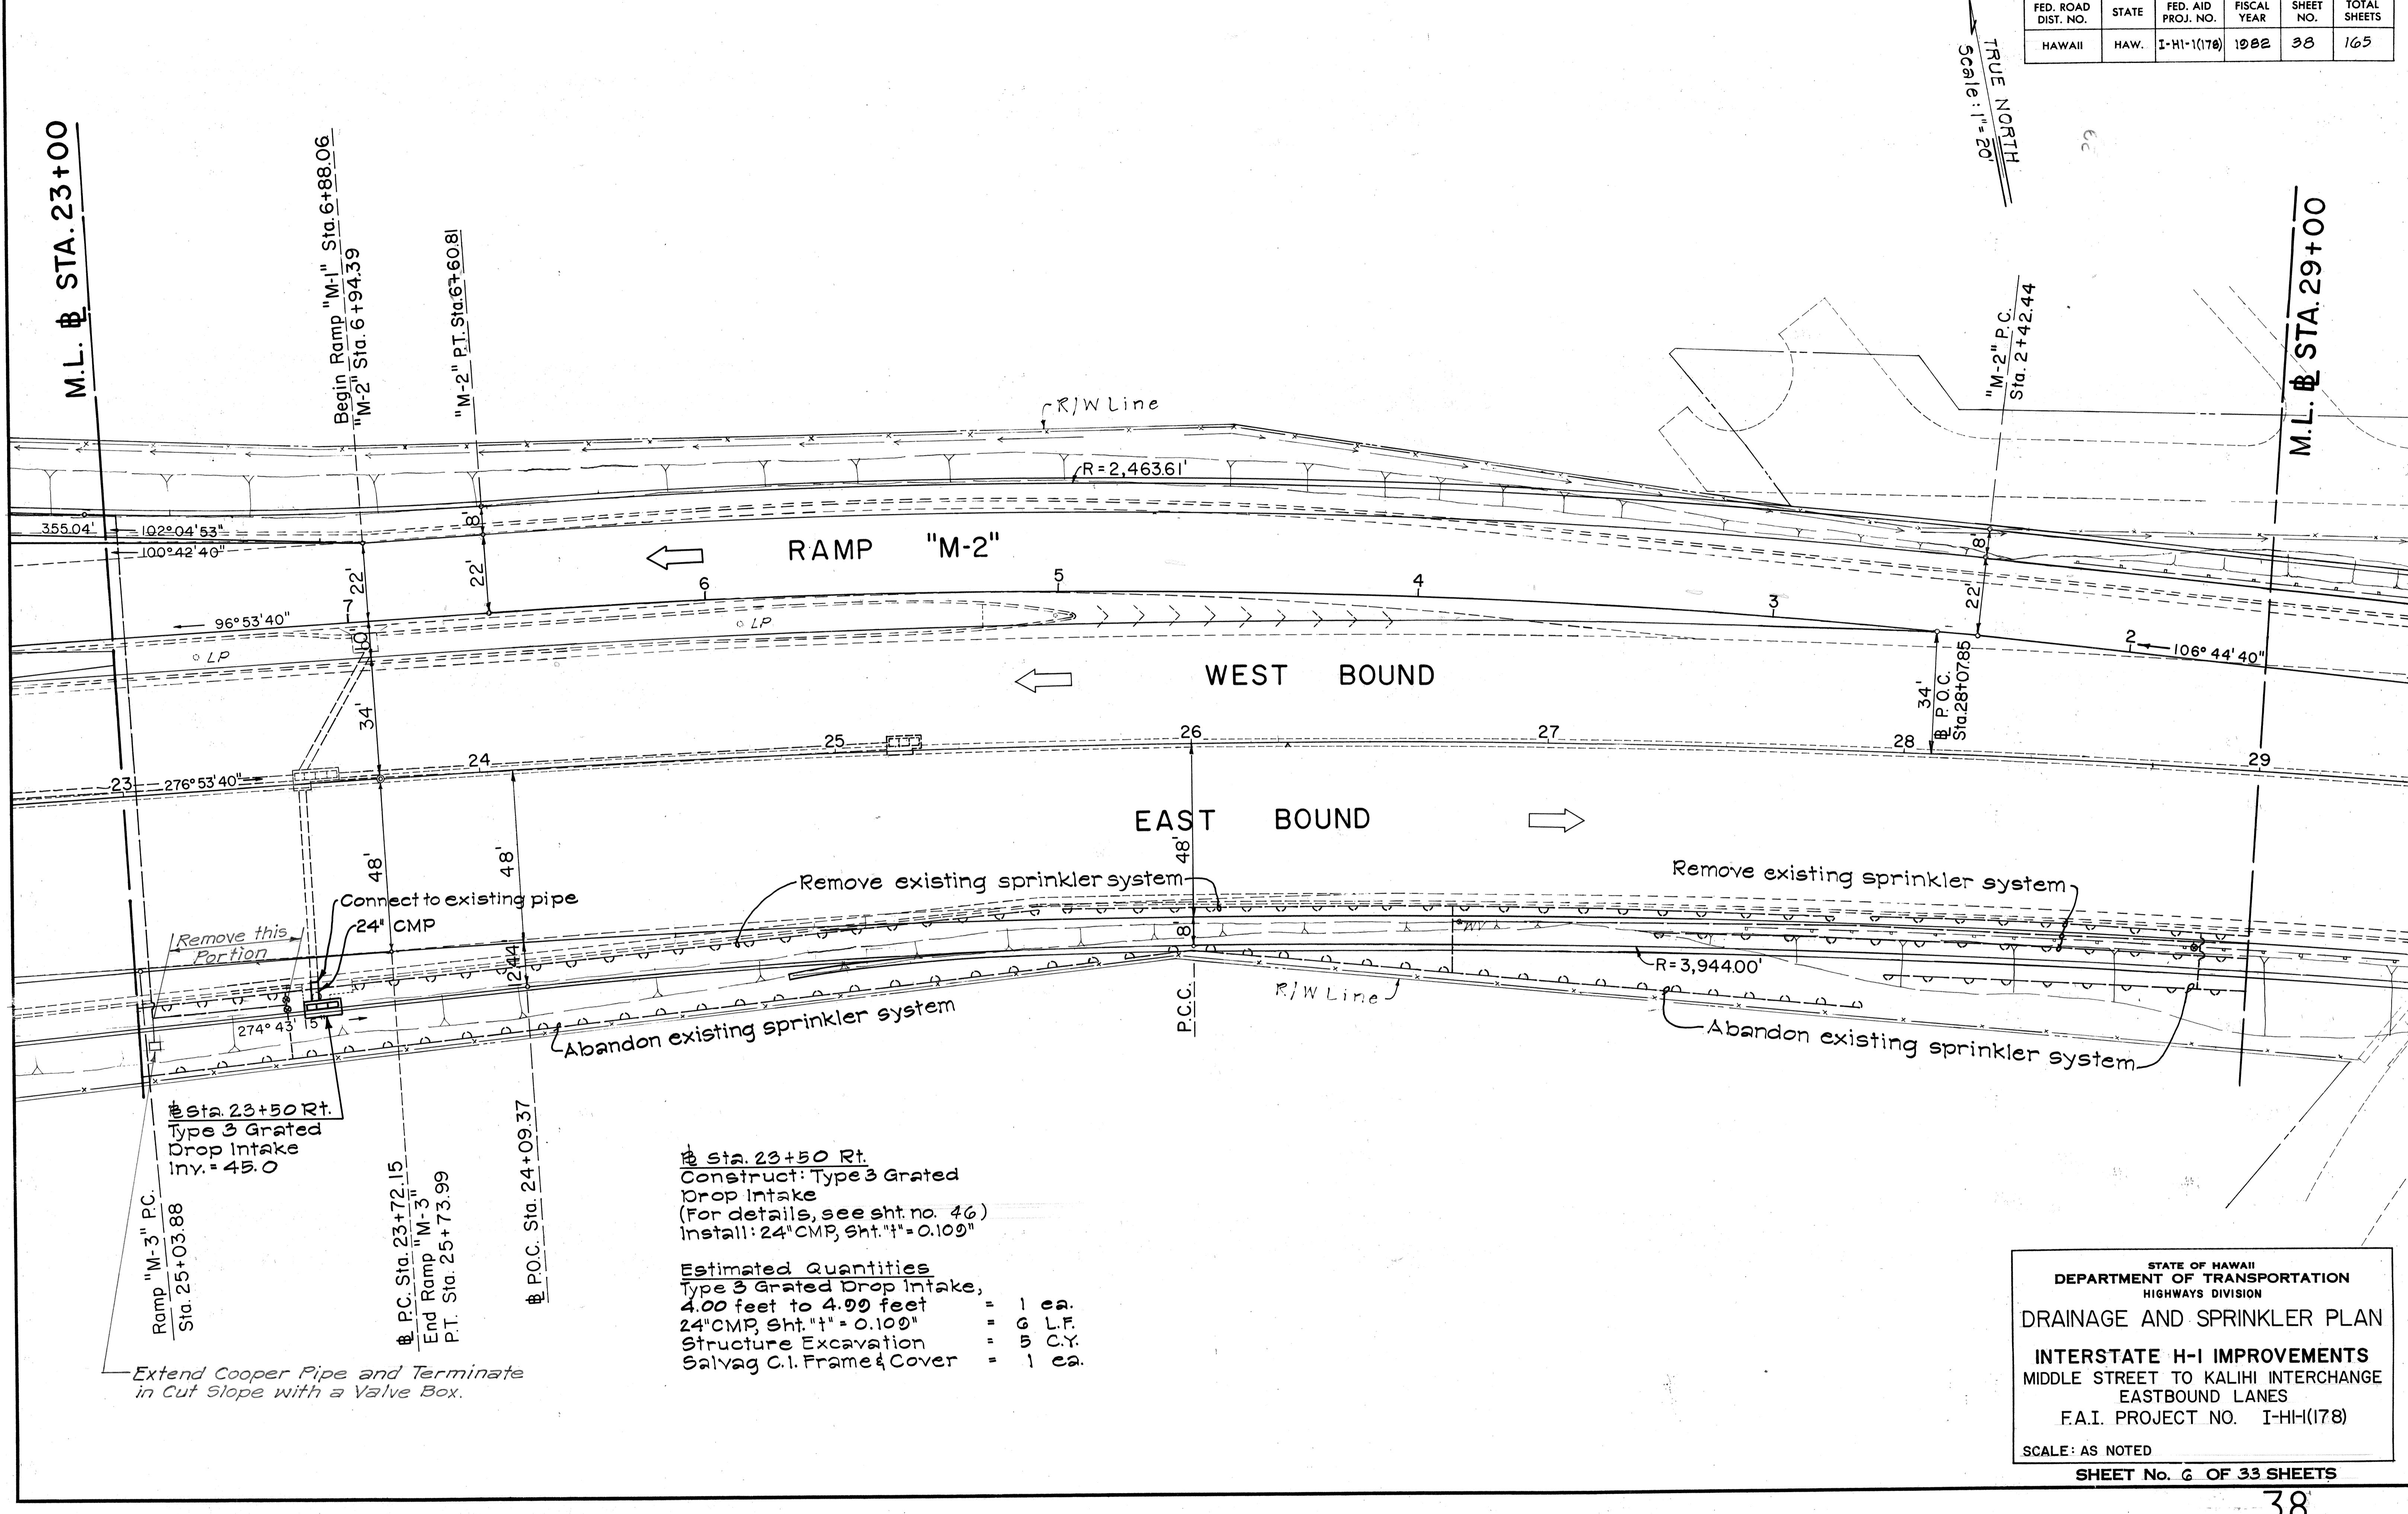


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FED. ROAD DIST. NO.	STATE	FED. AID PROJ. NO.	FISCAL YEAR	SHEET NO.	TOTAL SHEETS
HAWAII	HAW.	I-HI-1(178)	1982	39	165

M.L. # STA. 29 +00



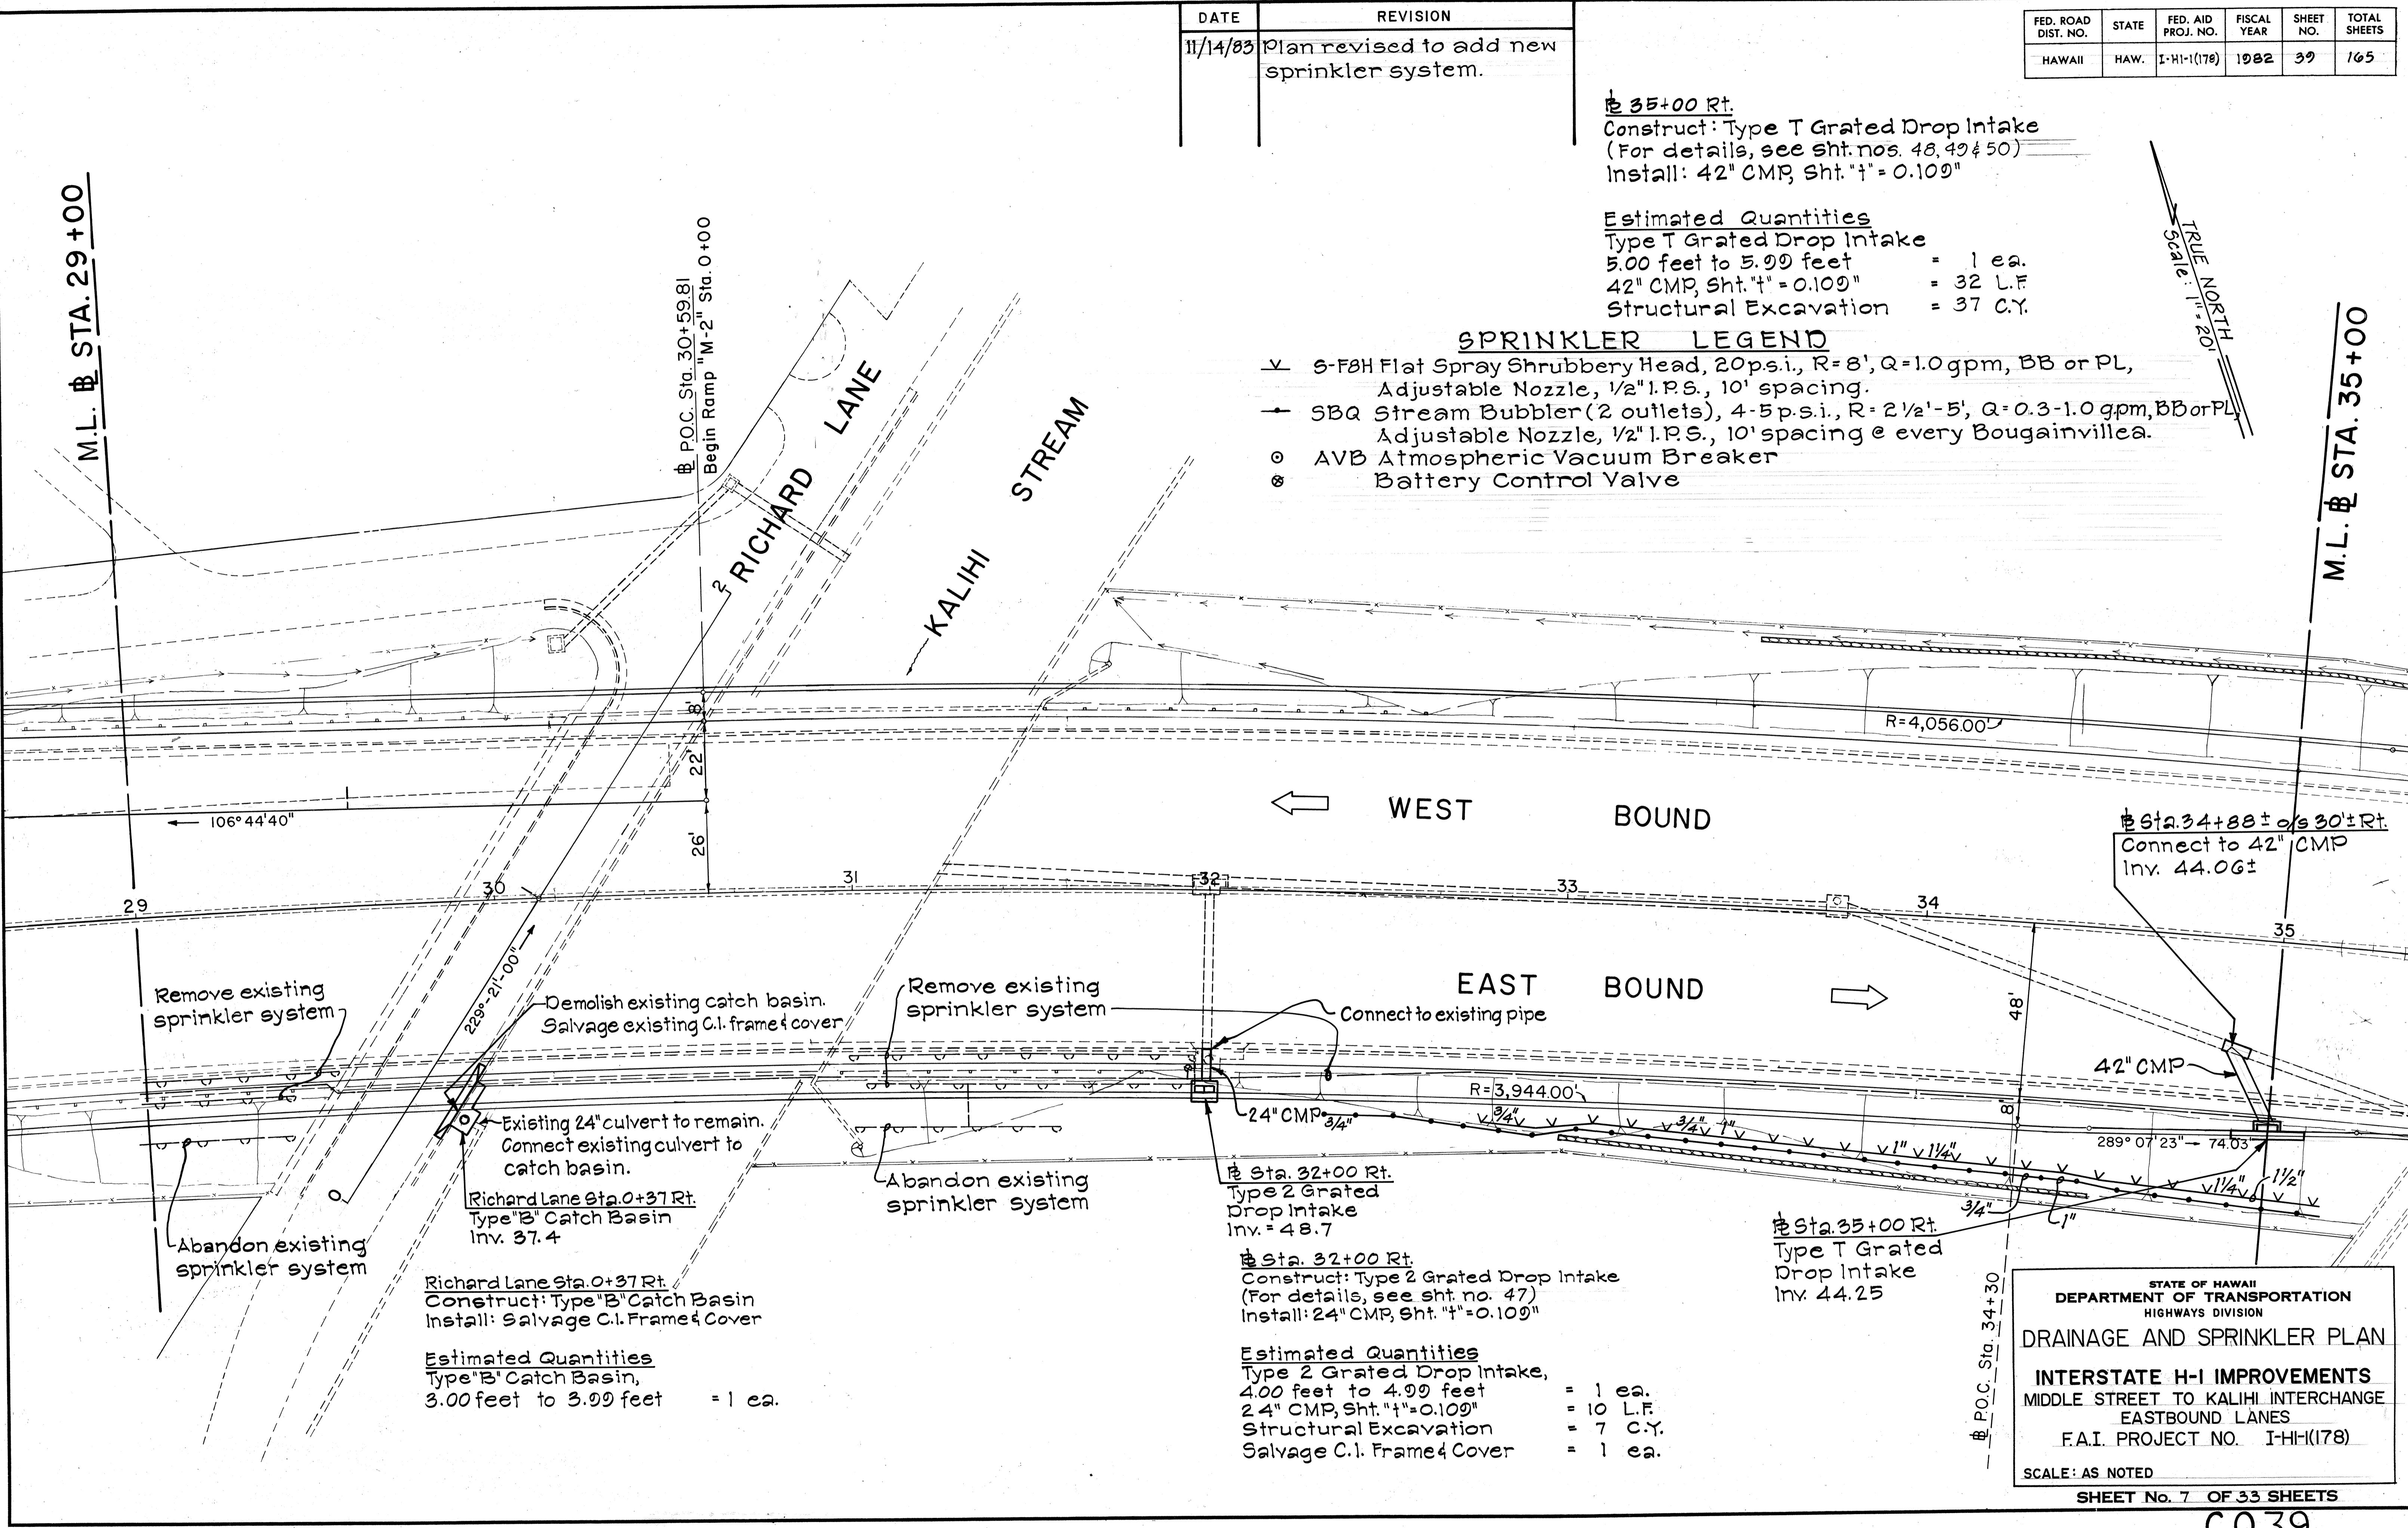

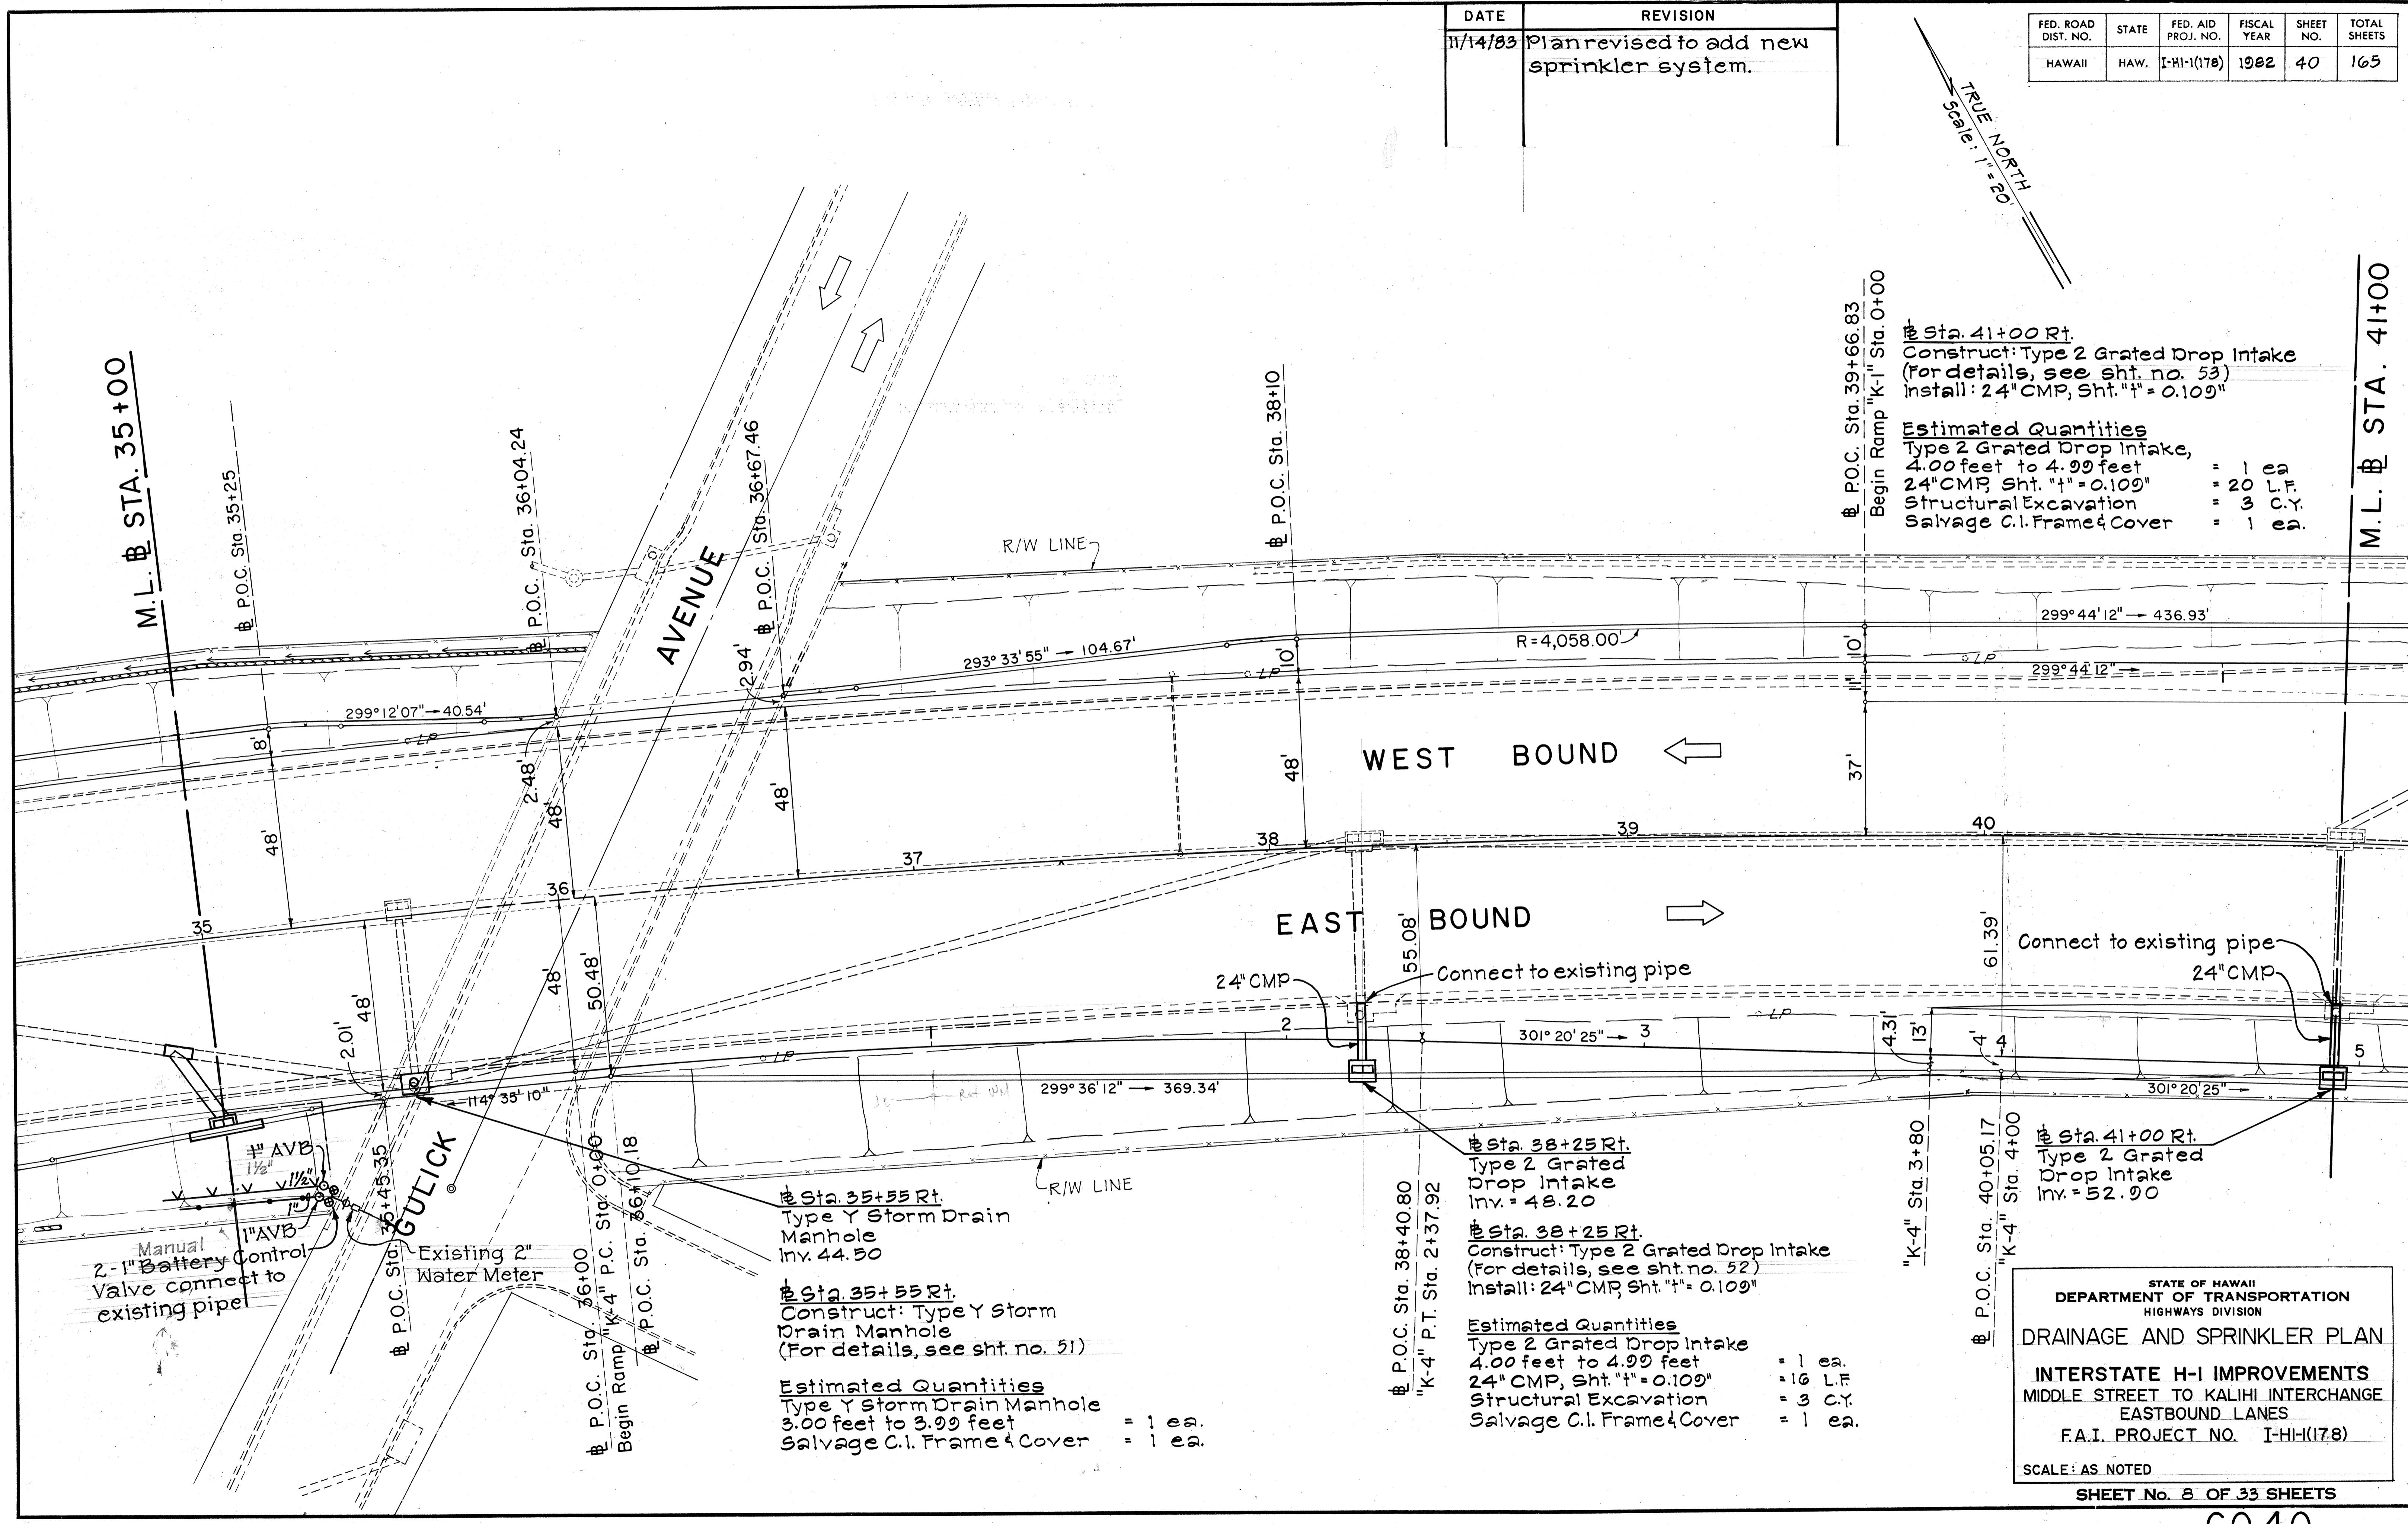
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FED. ROAD DIST. NO.	STATE	FED. AID PROJ. NO.	FISCAL YEAR	SHEET NO.	TOTAL SHEETS
HAWAII	HAW.	I-HI-1(178)	1982	41	165

M.L. @ STA. 41+00

Approx. location of existing
6"dia waterline. Exact location
shall be verified in field.

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DRAINAGE AND SPRINKLER PLAN
INTERSTATE H-I IMPROVEMENTS
MIDDLE STREET TO KALIHI INTERCHANGE
EASTBOUND LANES
FAI PROJECT NO. I-HI-1(178)
SCALE: AS NOTED

SHEET No. 9 OF 33 SHEETS

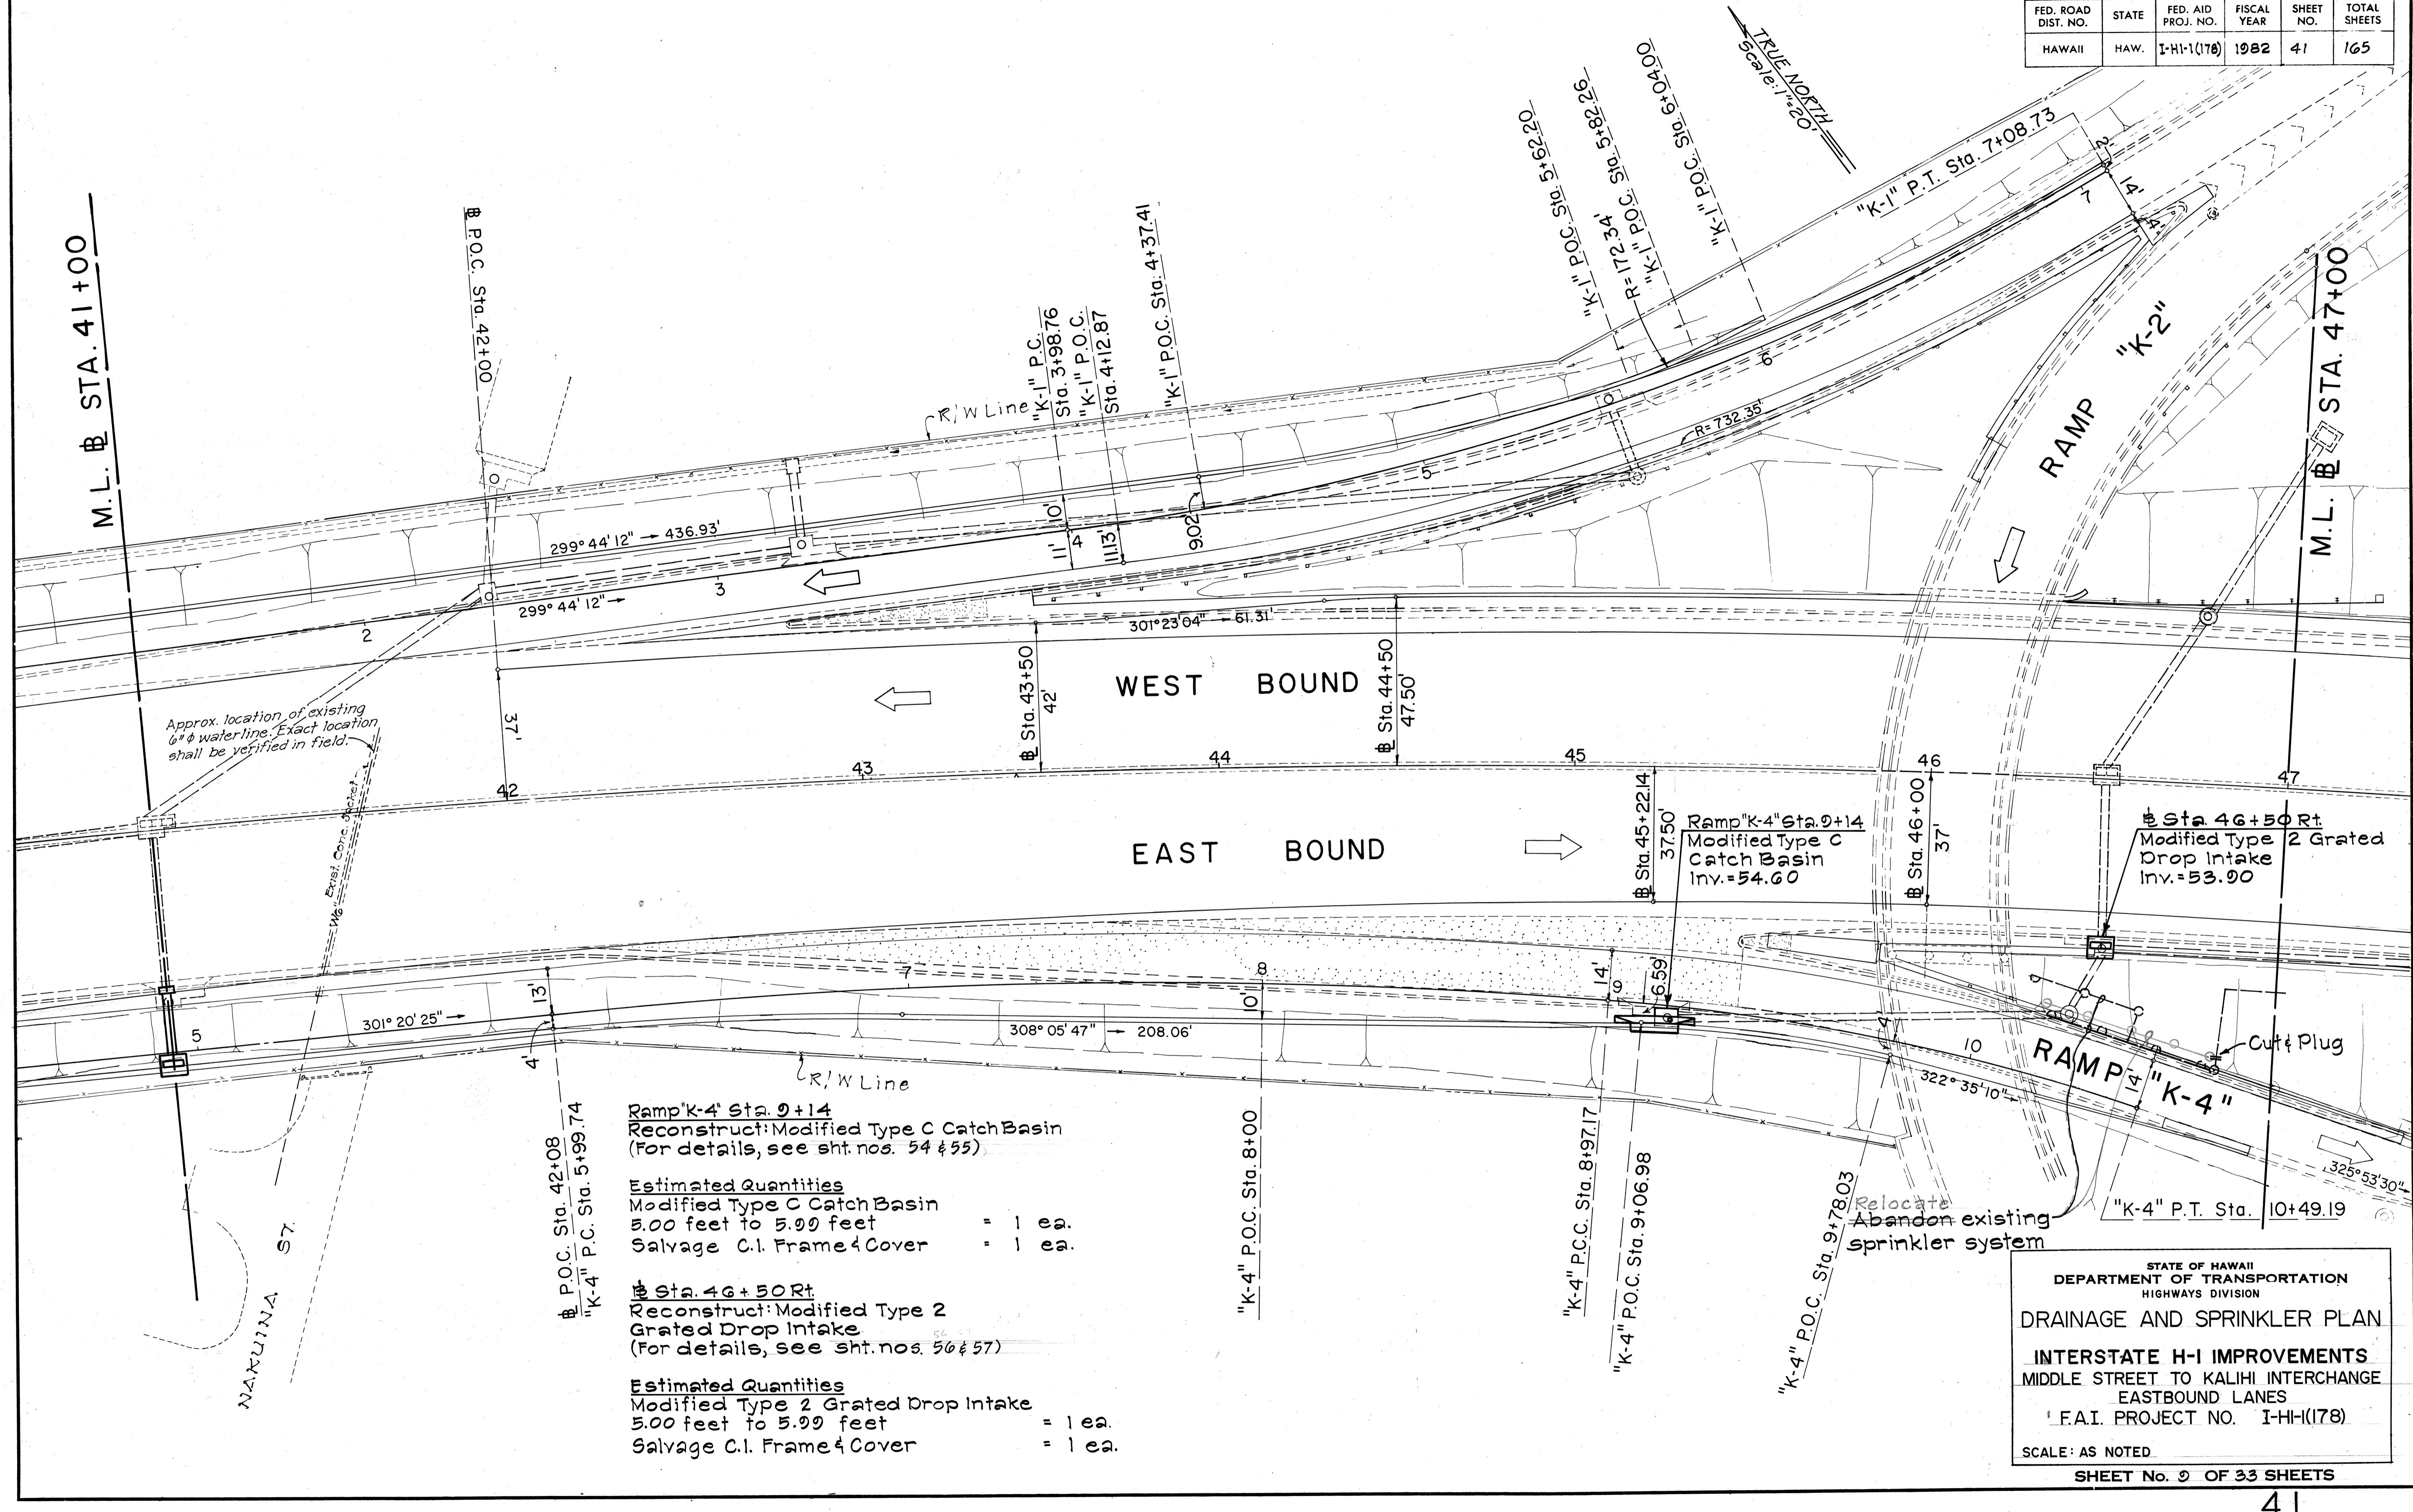
FED. ROAD DIST. NO.	STATE	FED. AID PROJ. NO.	FISCAL YEAR	SHEET NO.	TOTAL SHEETS
HAWAII	HAW.	I-HI-1(178)	1982	42	165

• Sta. 47+53.75 Rt.
Construct: Type Z Storm Drain Manhole
(For details, see sh. no. 58)

Estimated Quantities
Type Z Storm Drain Manhole,
5.00 feet to 5.00 feet = 1 ea.
Salvage C.I. Frame & Cover = 1 ea.

• Sta. 48+55 Rt.
Reconstruct: Modified Type 3
Grated Drop Intake
(For details, see sh. no. 59)

Estimated Quantities
Modified Type 3 Grated Drop
Intake, 5.00 feet to 5.00 feet = 1 ea.
Salvage C.I. Frame & Cover = 1 ea.

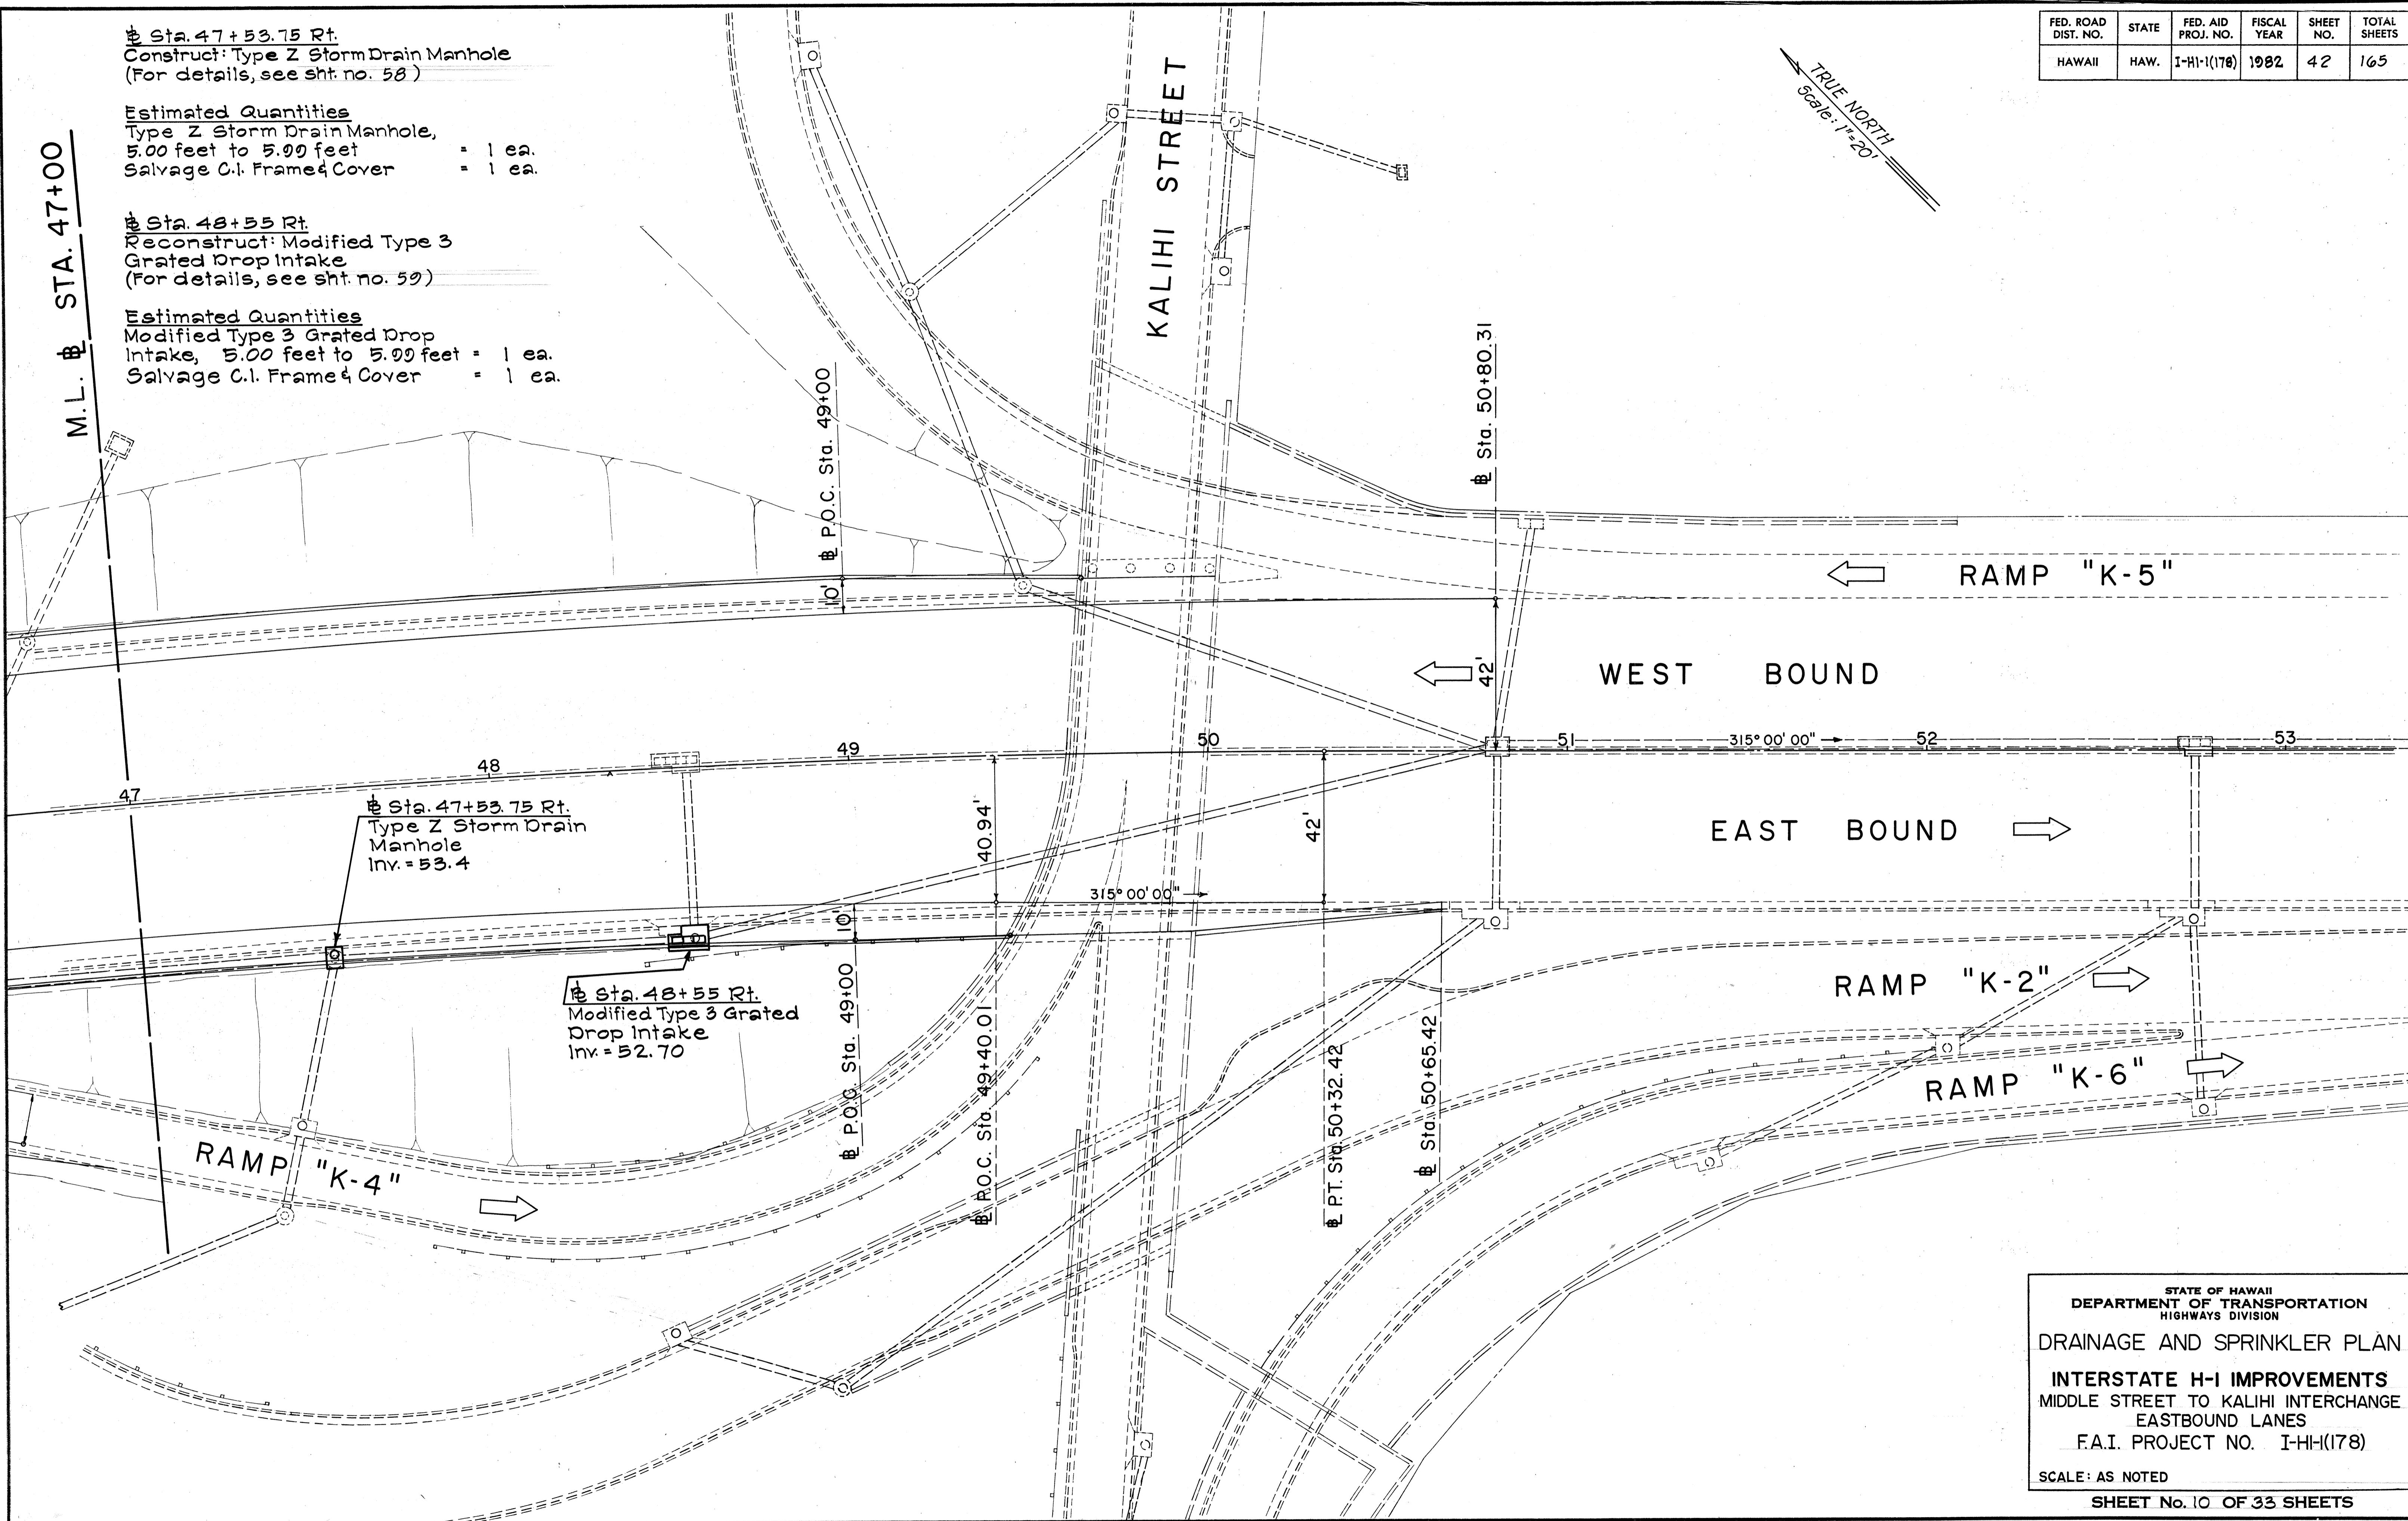


STATE OF HAWAII
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HIGHWAYS DIVISION
DRAINAGE AND SPRINKLER PLAN
INTERSTATE H-I IMPROVEMENTS
MIDDLE STREET TO KALIHI INTERCHANGE
EASTBOUND LANES
F.A.I. PROJECT NO. I-HI-(178)
SCALE: AS NOTED

SHEET No. 10 OF 33 SHEETS

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NOTE BOOK	DESIGNED BY
PLATE	QUANTITIES BY
NO.	CHECRED BY




FED. ROAD DIST. NO.	STATE	FED. AID PROJ. NO.	FISCAL YEAR	SHEET NO.	TOTAL SHEETS
HAWAII	HAW.	I-HI-1(178)	1982	43	105

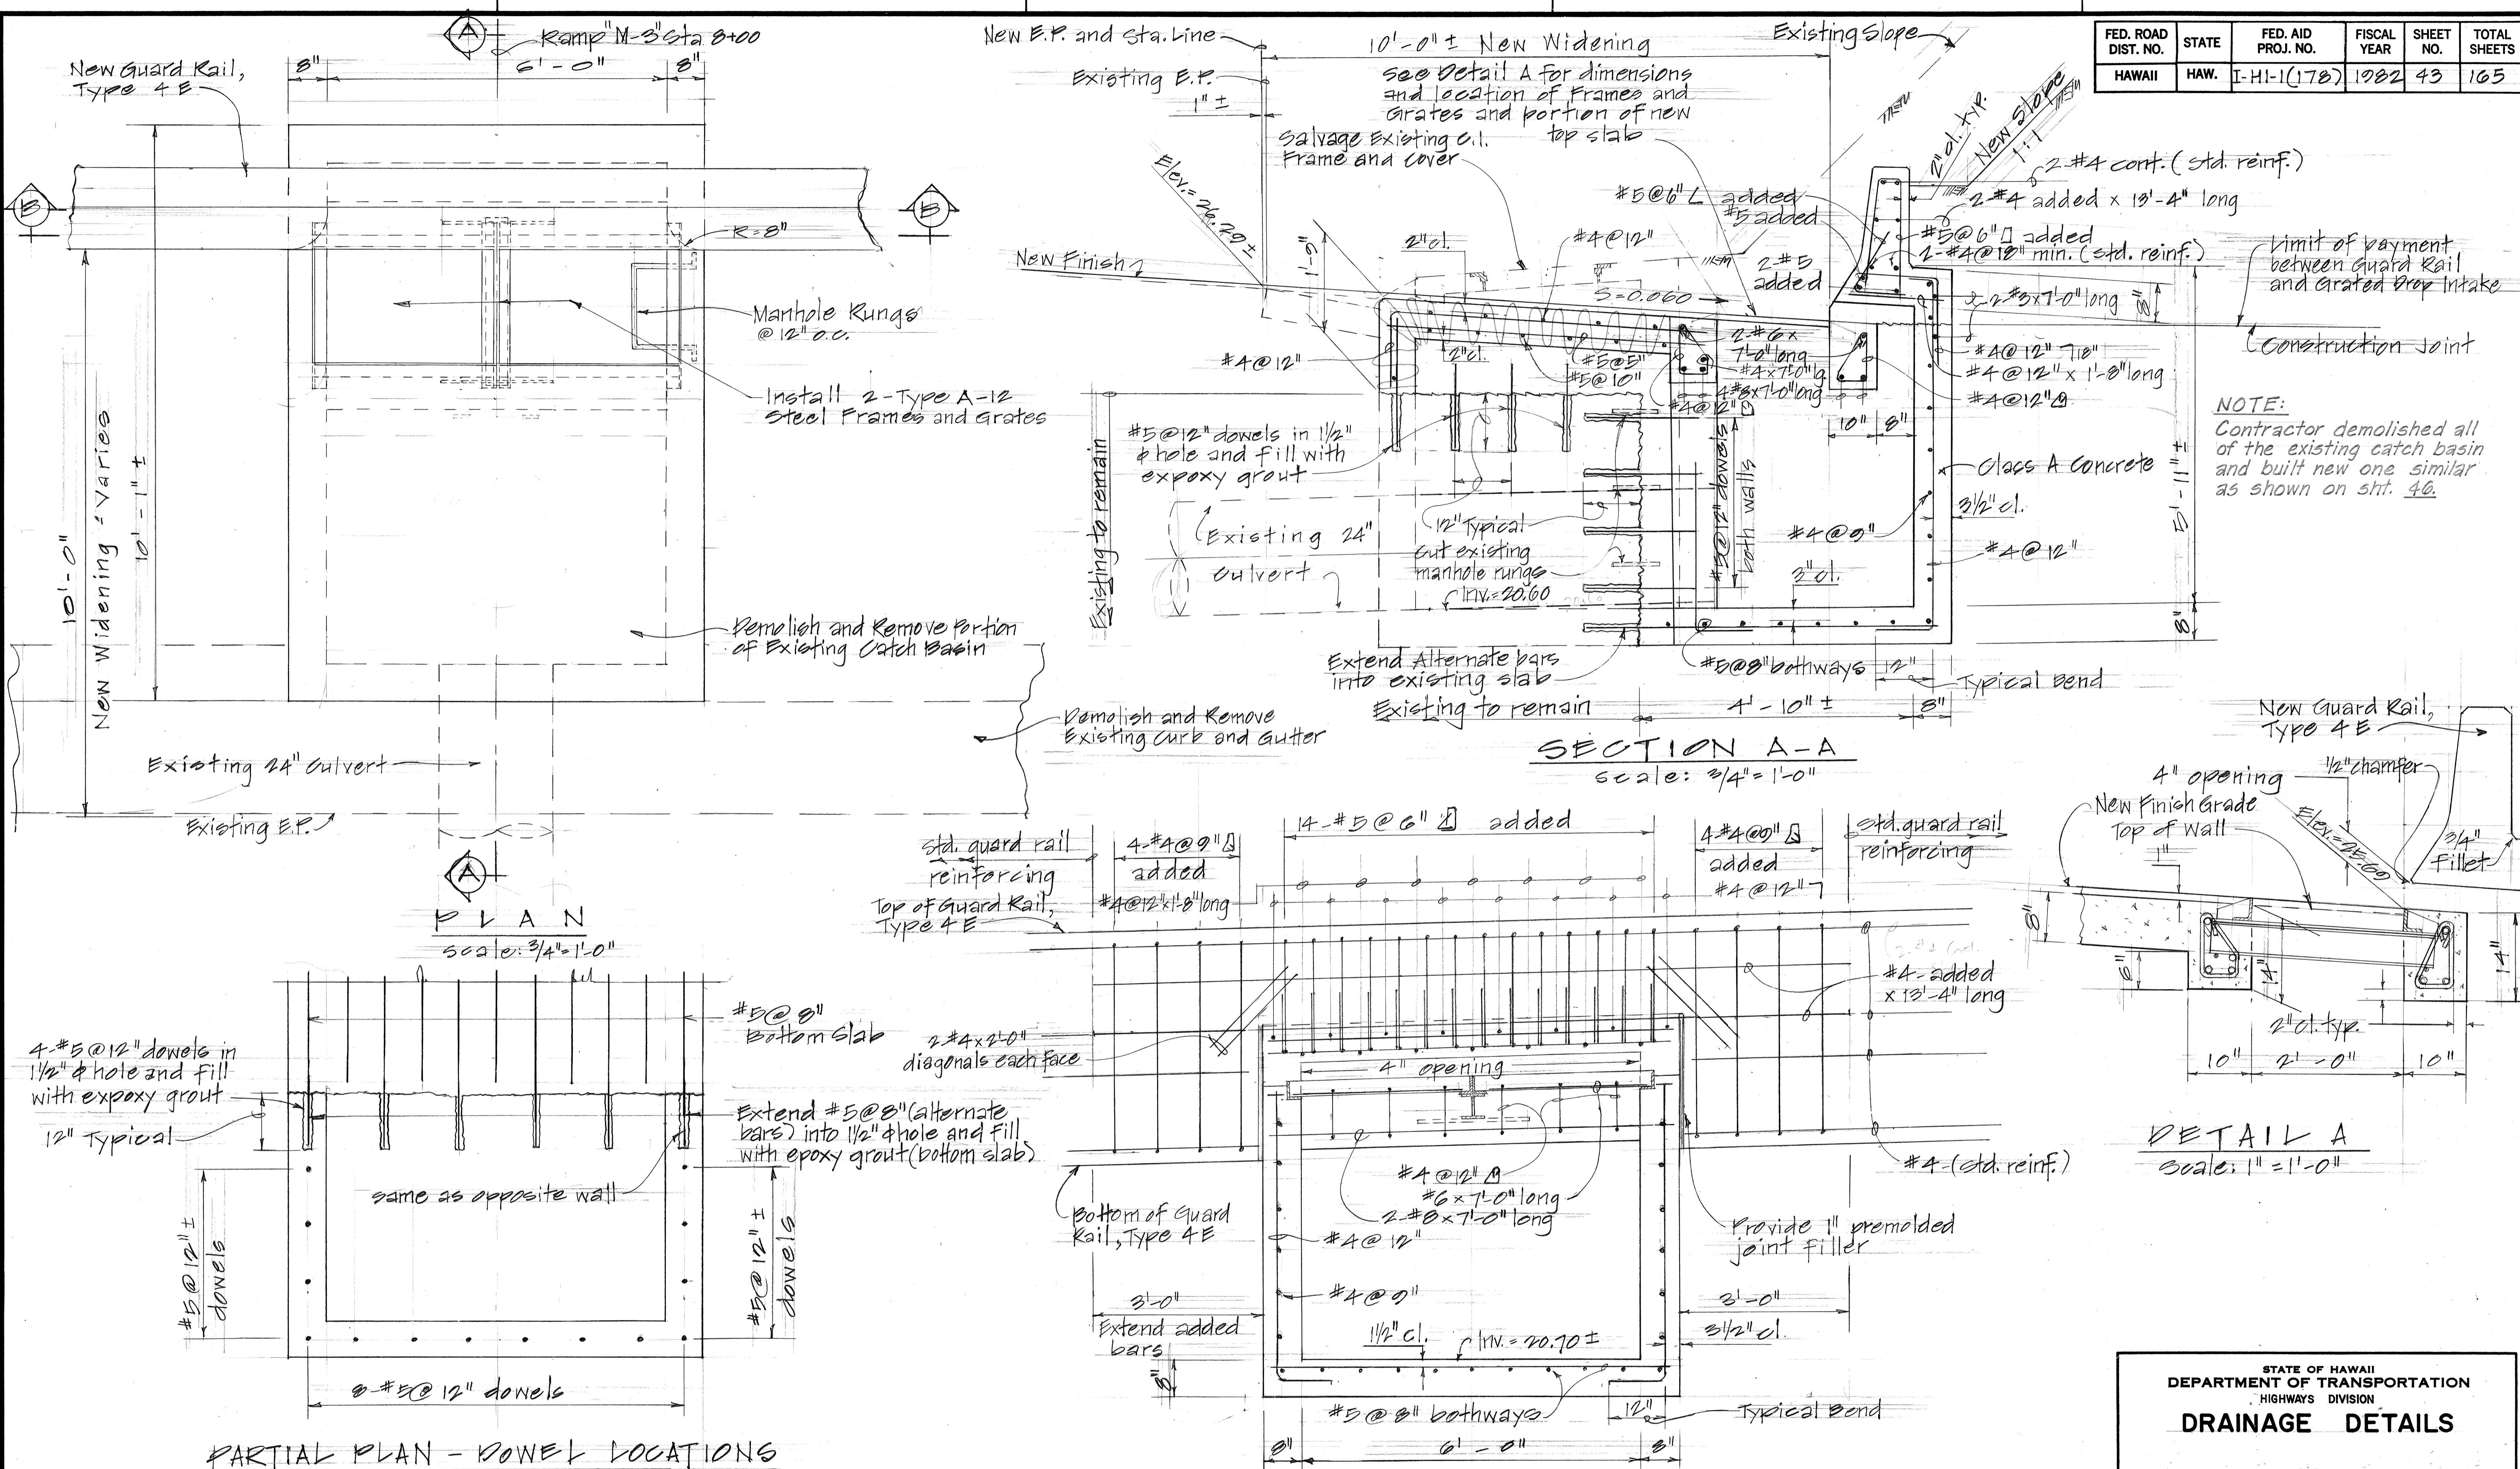

STATE OF HAWAII
DEPARTMENT OF TRANSPORTATION
HIGHWAYS DIVISION
DRAINAGE DETAILS
INTERSTATE H-I IMPROVEMENTS
MIDDLE STREET TO KALIHI INTERCHANGE
EASTBOUND LANES
F.A.I. PROJECT NO. I-HI-1(178)
SCALE: AS NOTED
SHEET NO. 11 OF 33 SHEETS

DETAILS OF MODIFIED TYPE 2 GRATED DROP INTAKE AT RAMP "M-3" STA. 8+00 RT.



FED. ROAD DIST. NO.	STATE	FED. AID PROJ. NO.	FISCAL YEAR	SHEET NO.	TOTAL SHEETS
HAWAII	HAW.	I-HI-1(178)	1982	44	105

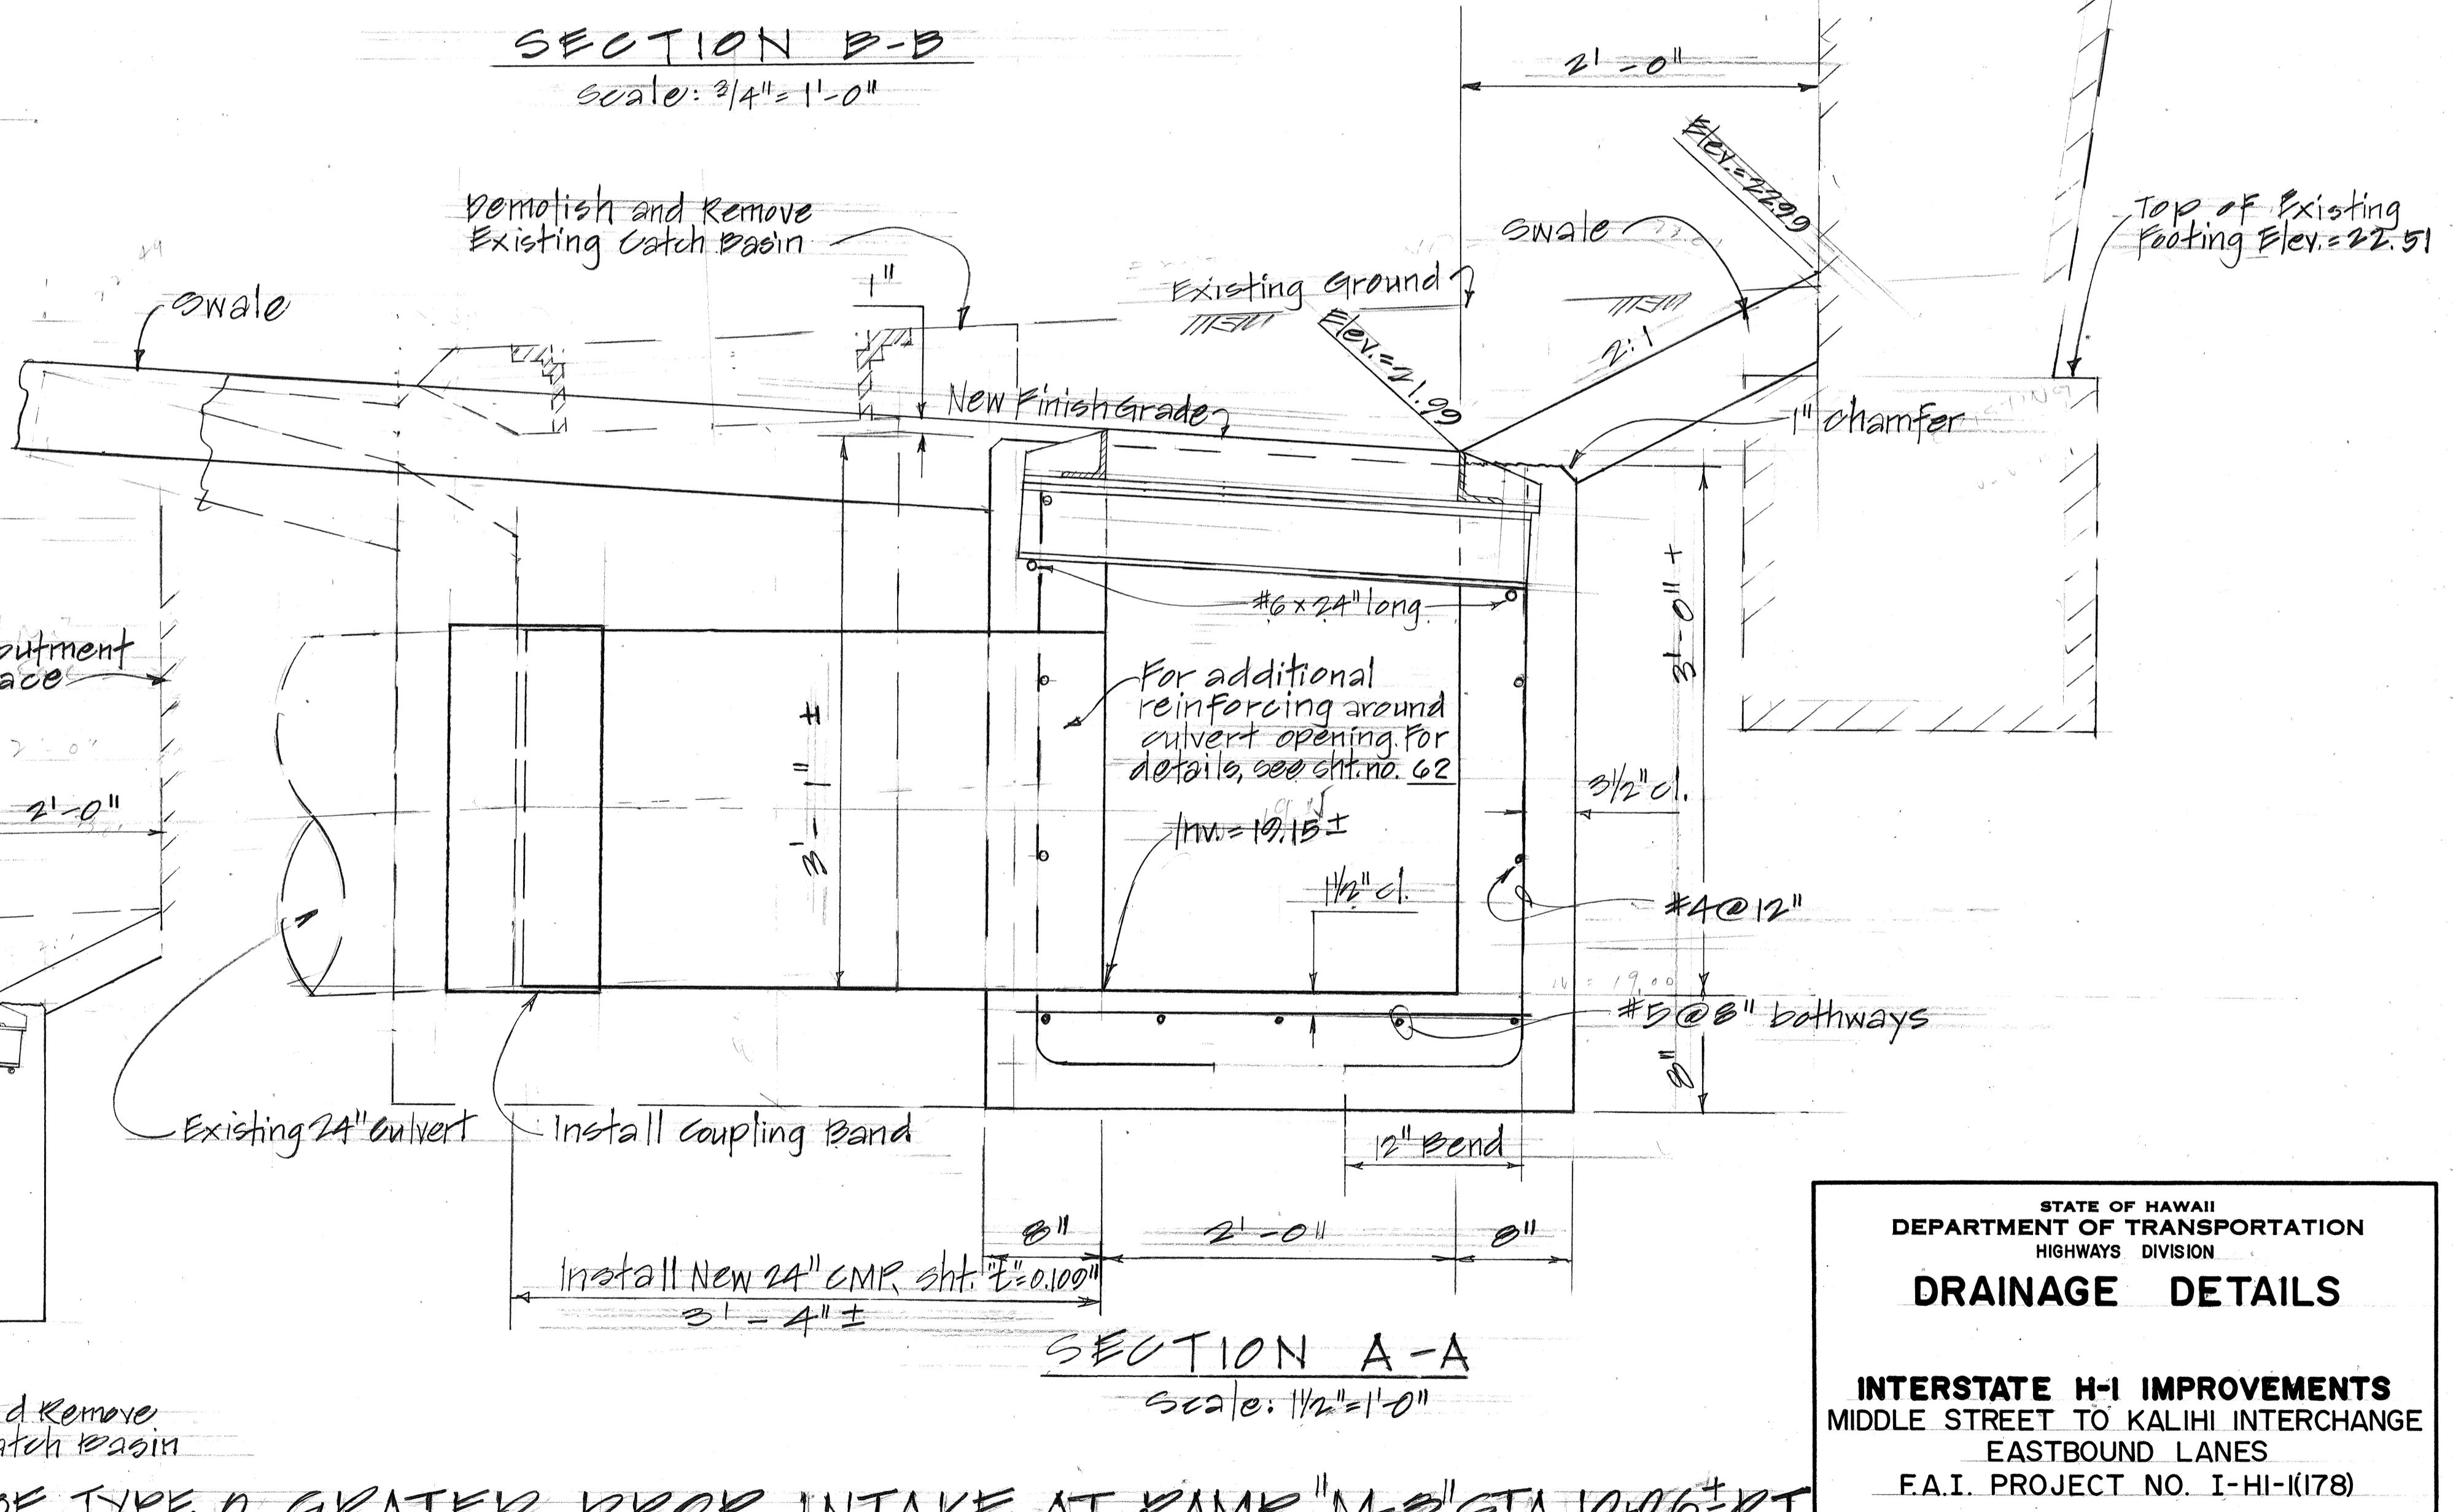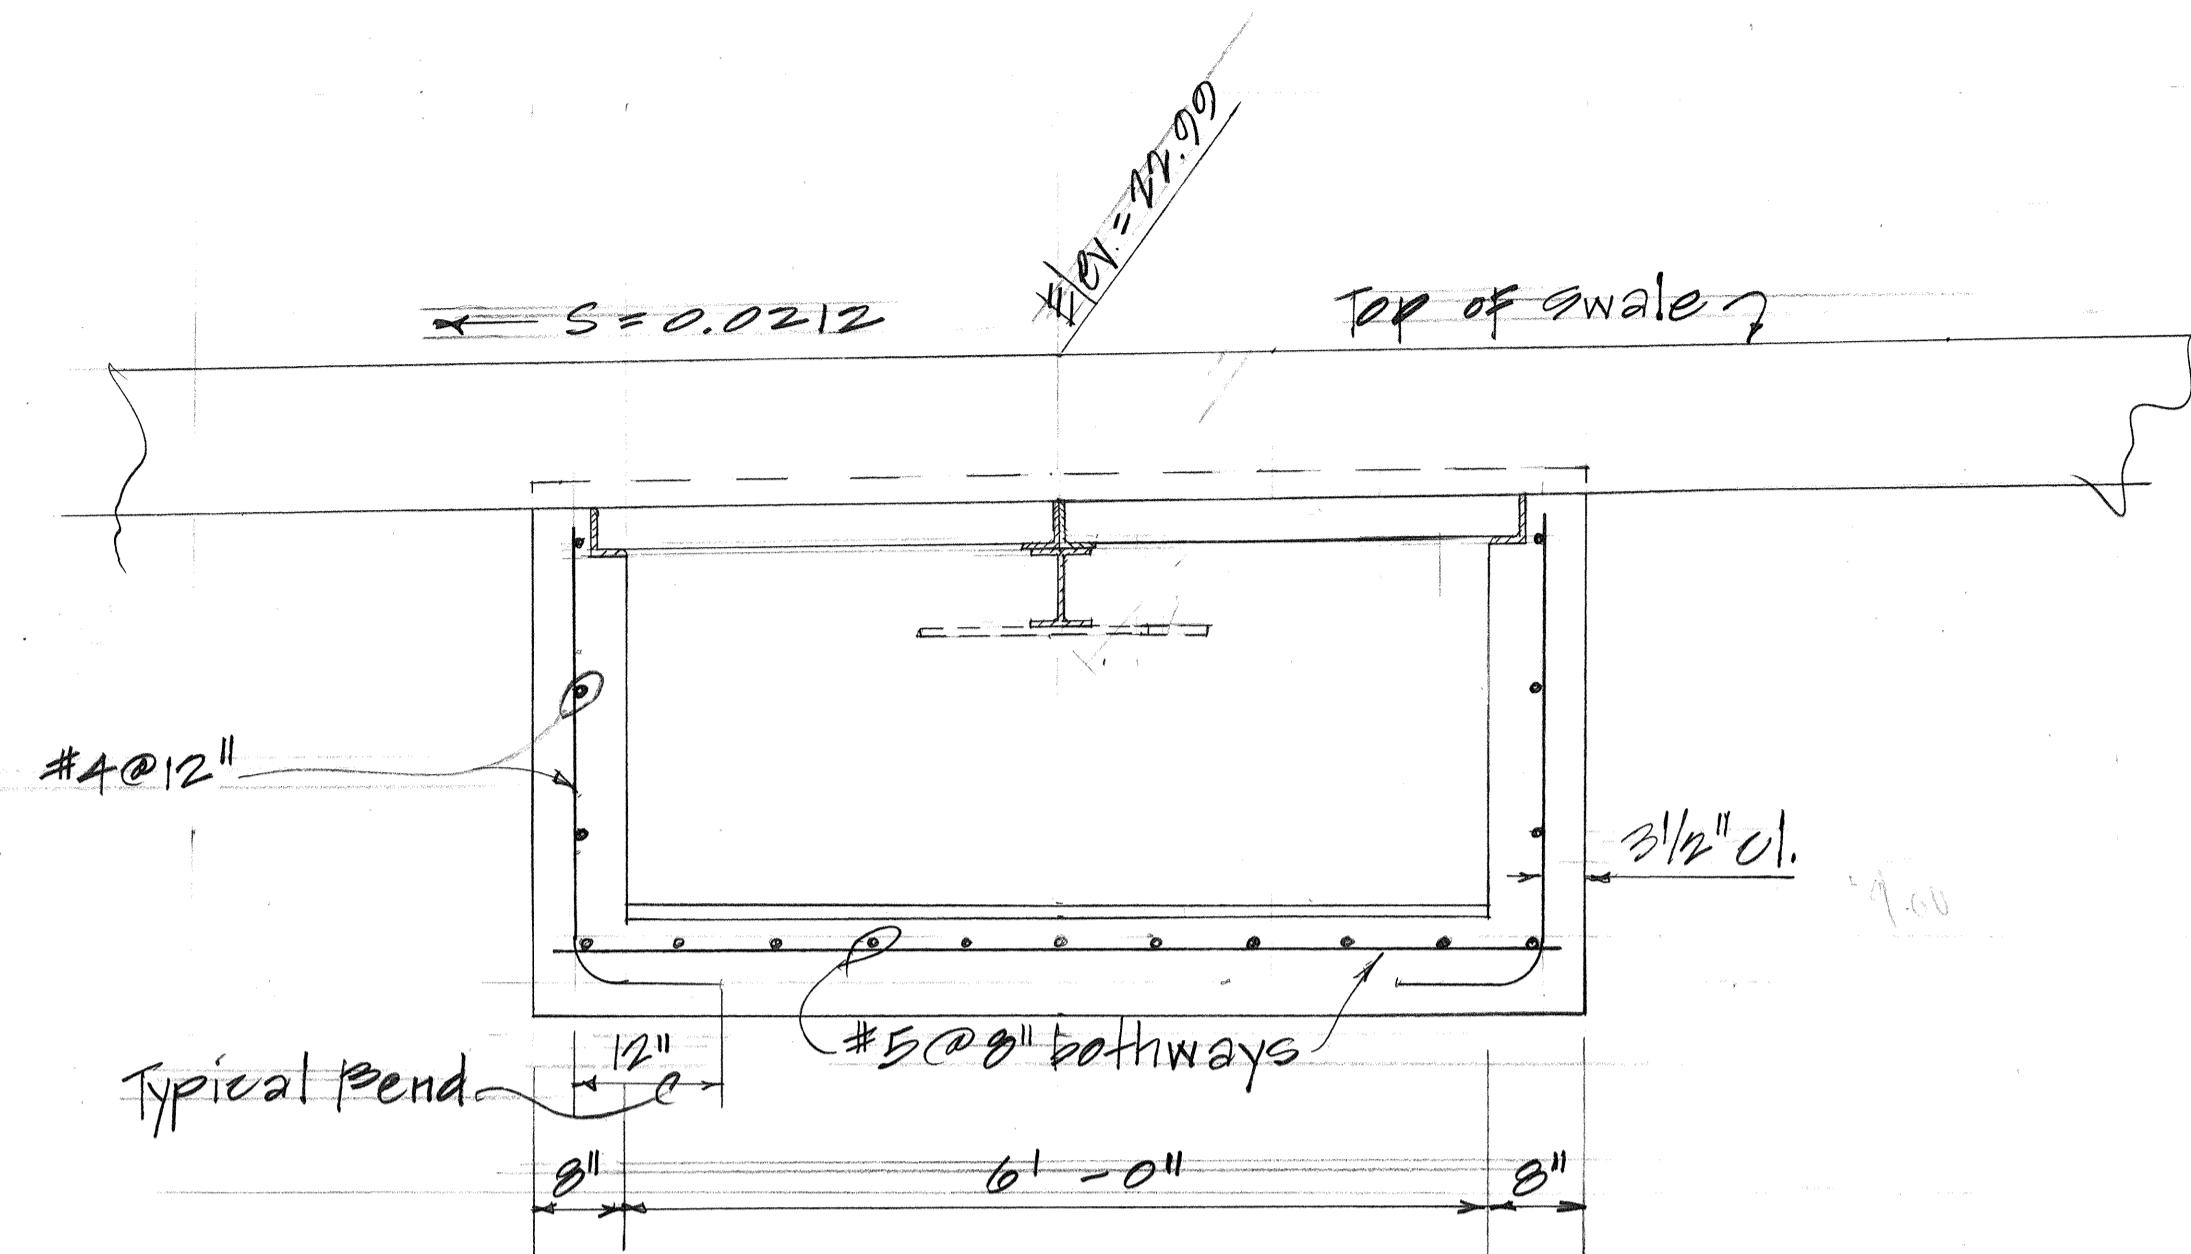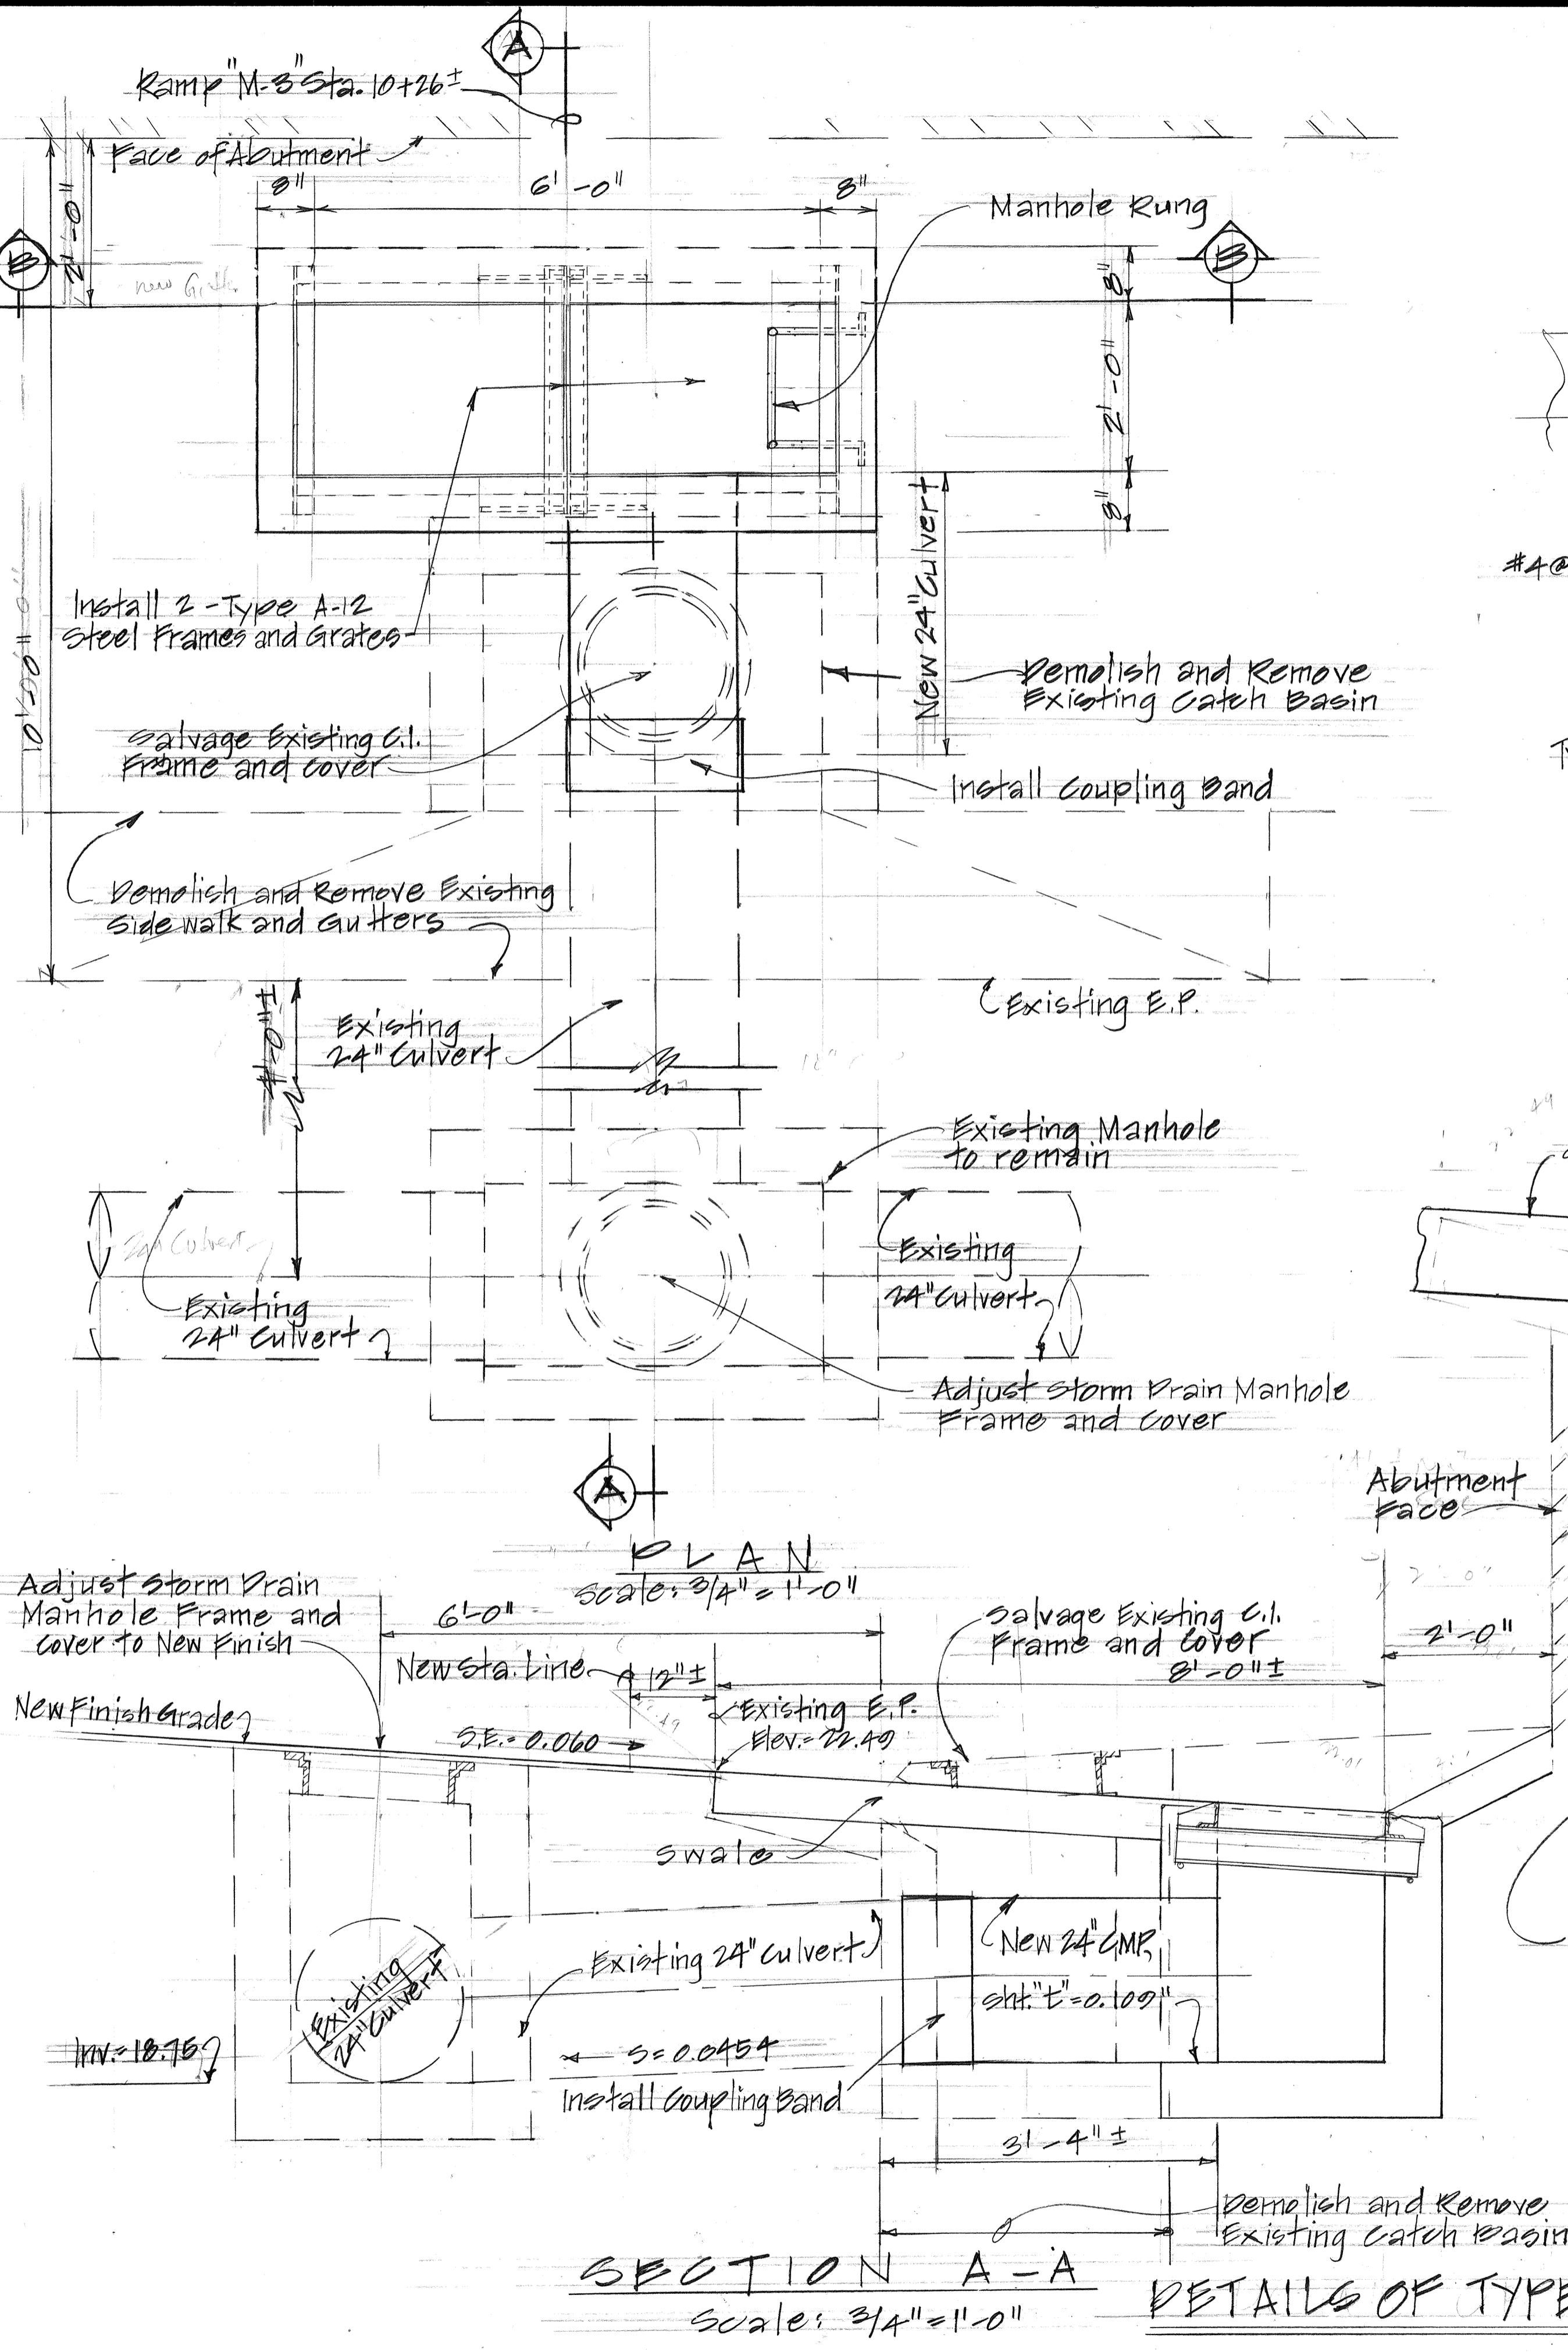

ORIGINAL SURVEY PLOTTED BY DATE
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NOTE BOOK NO.


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MIDDLE STREET TO KALIHI INTERCHANGE
EASTBOUND LANES
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SCALE: AS NOTED
SHEET NO. 12 OF 33 SHEETS

FED. ROAD DIST. NO.	STATE	FED. AID PROJ. NO.	FISCAL YEAR	SHEET NO.	TOTAL SHEETS
HAWAII	HAW.	I-HI-1(178)	1982	45	165

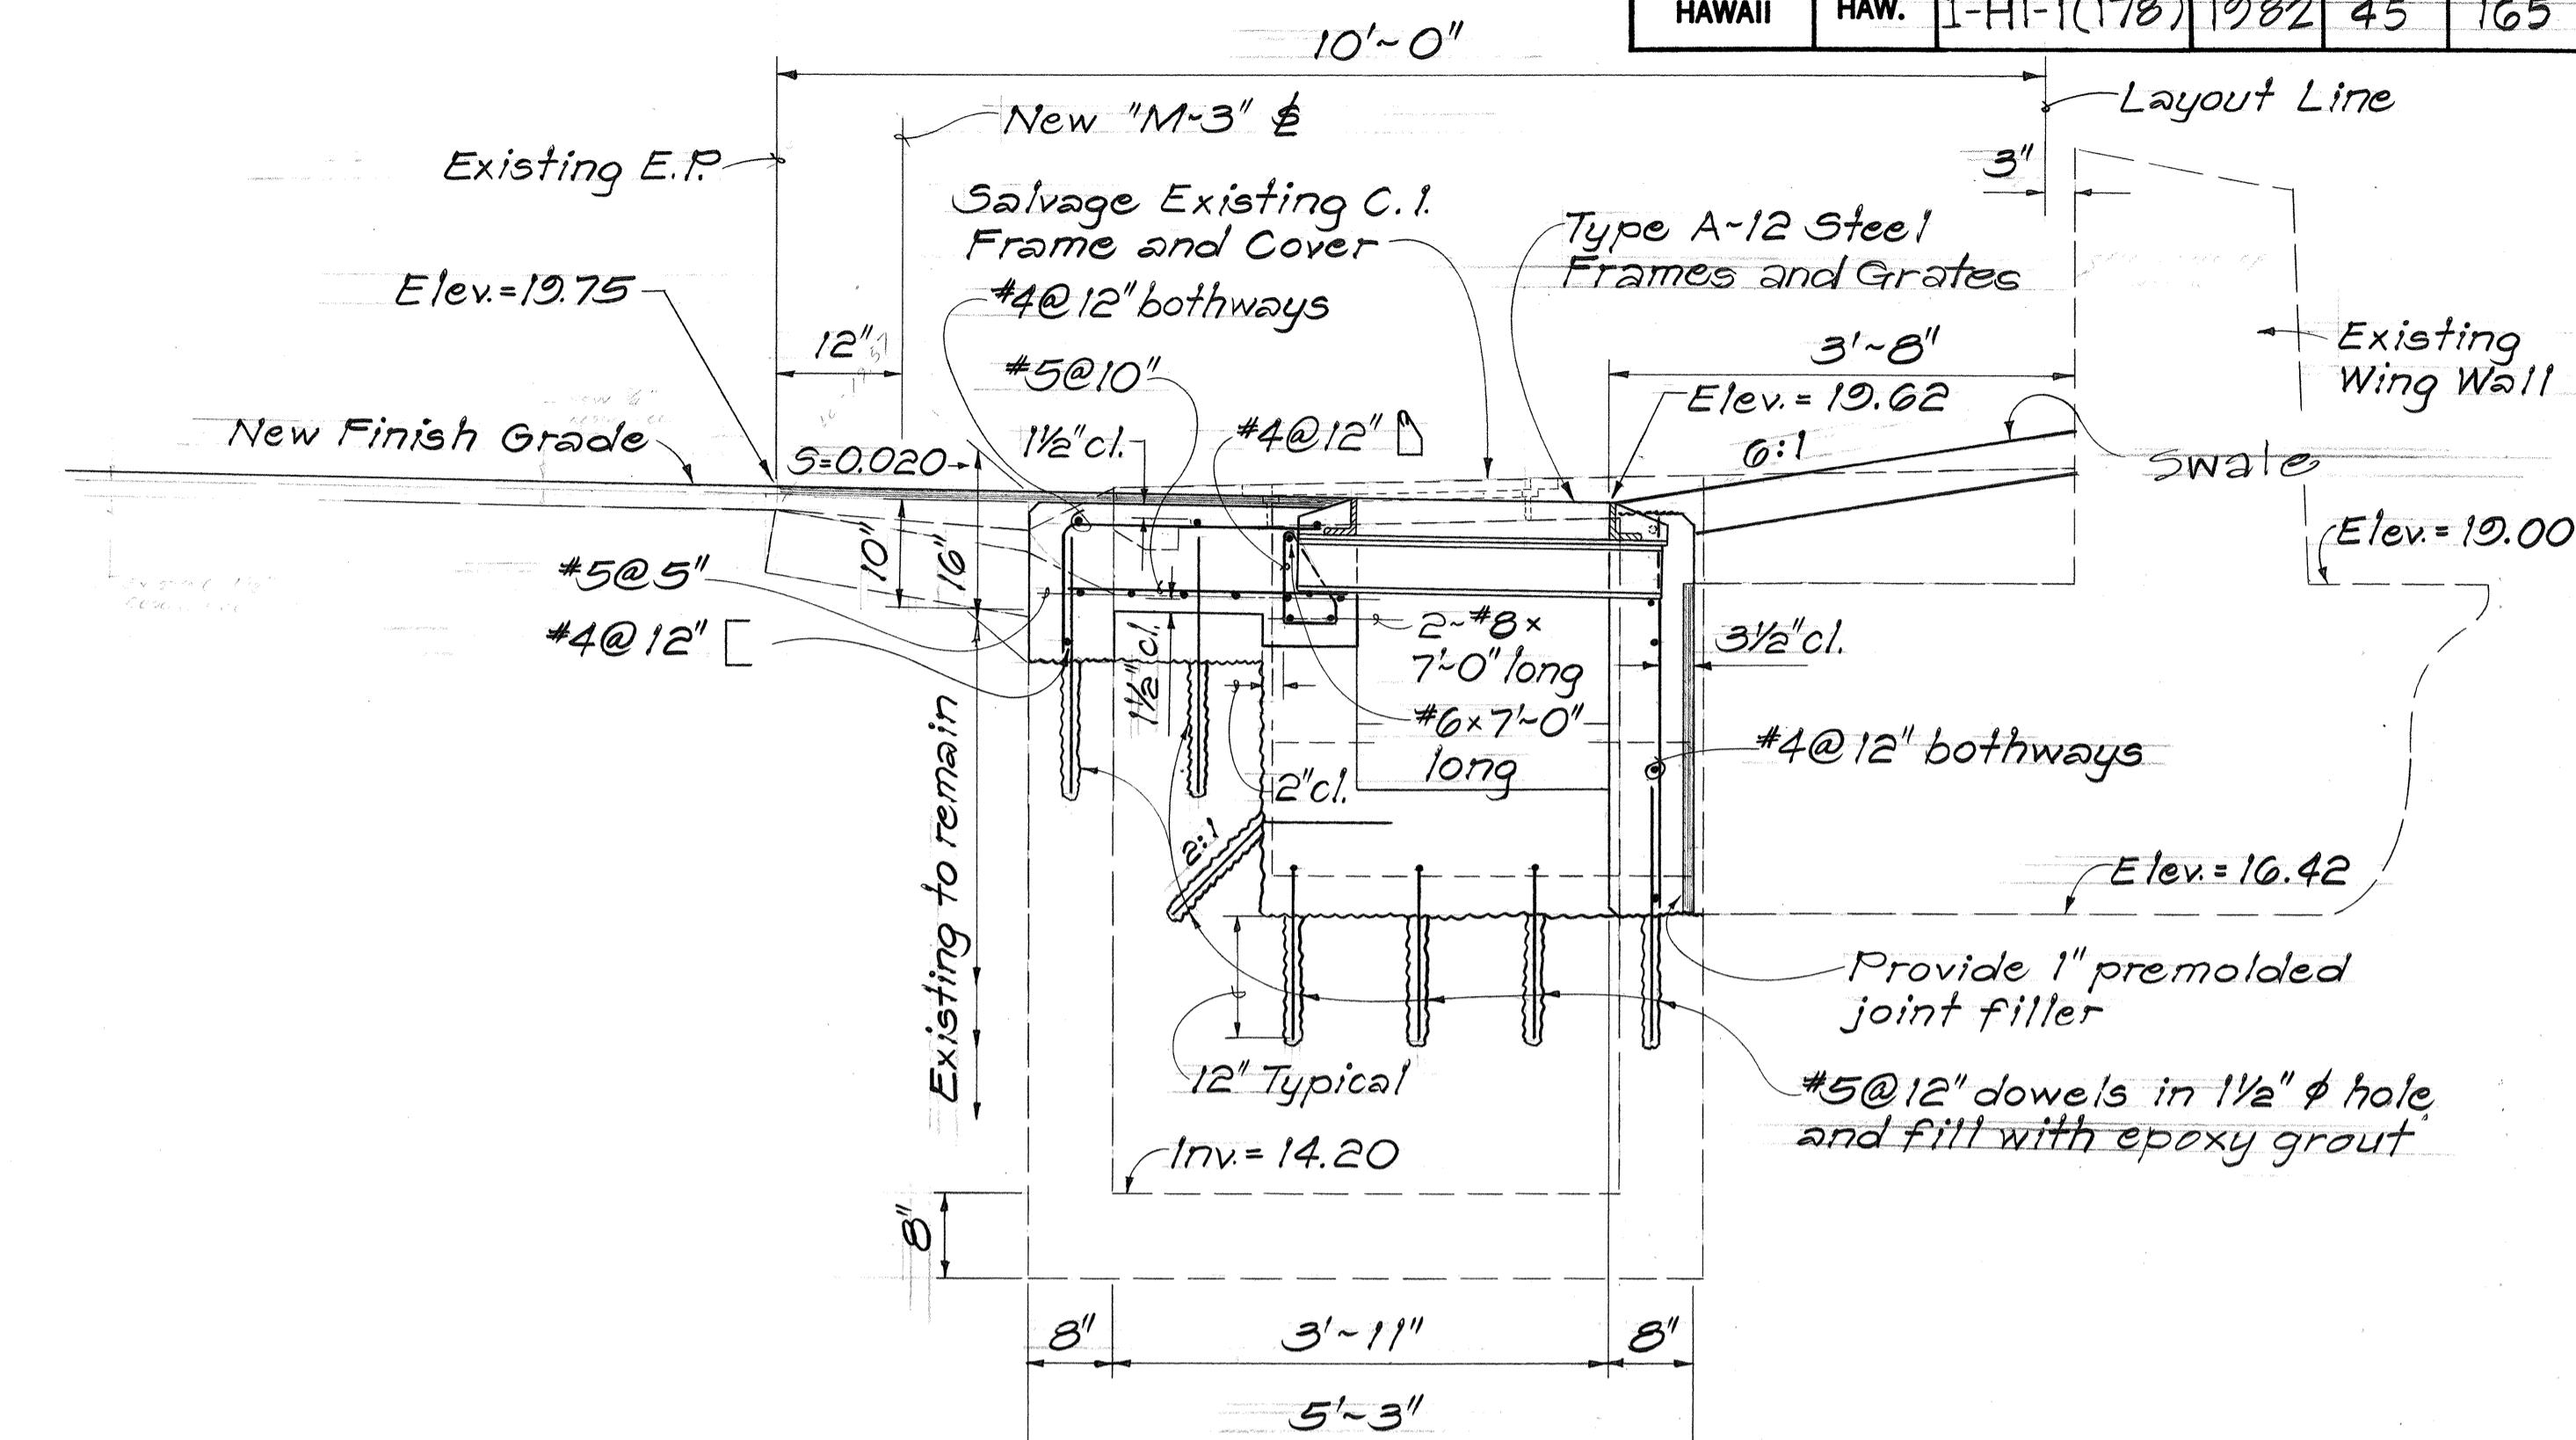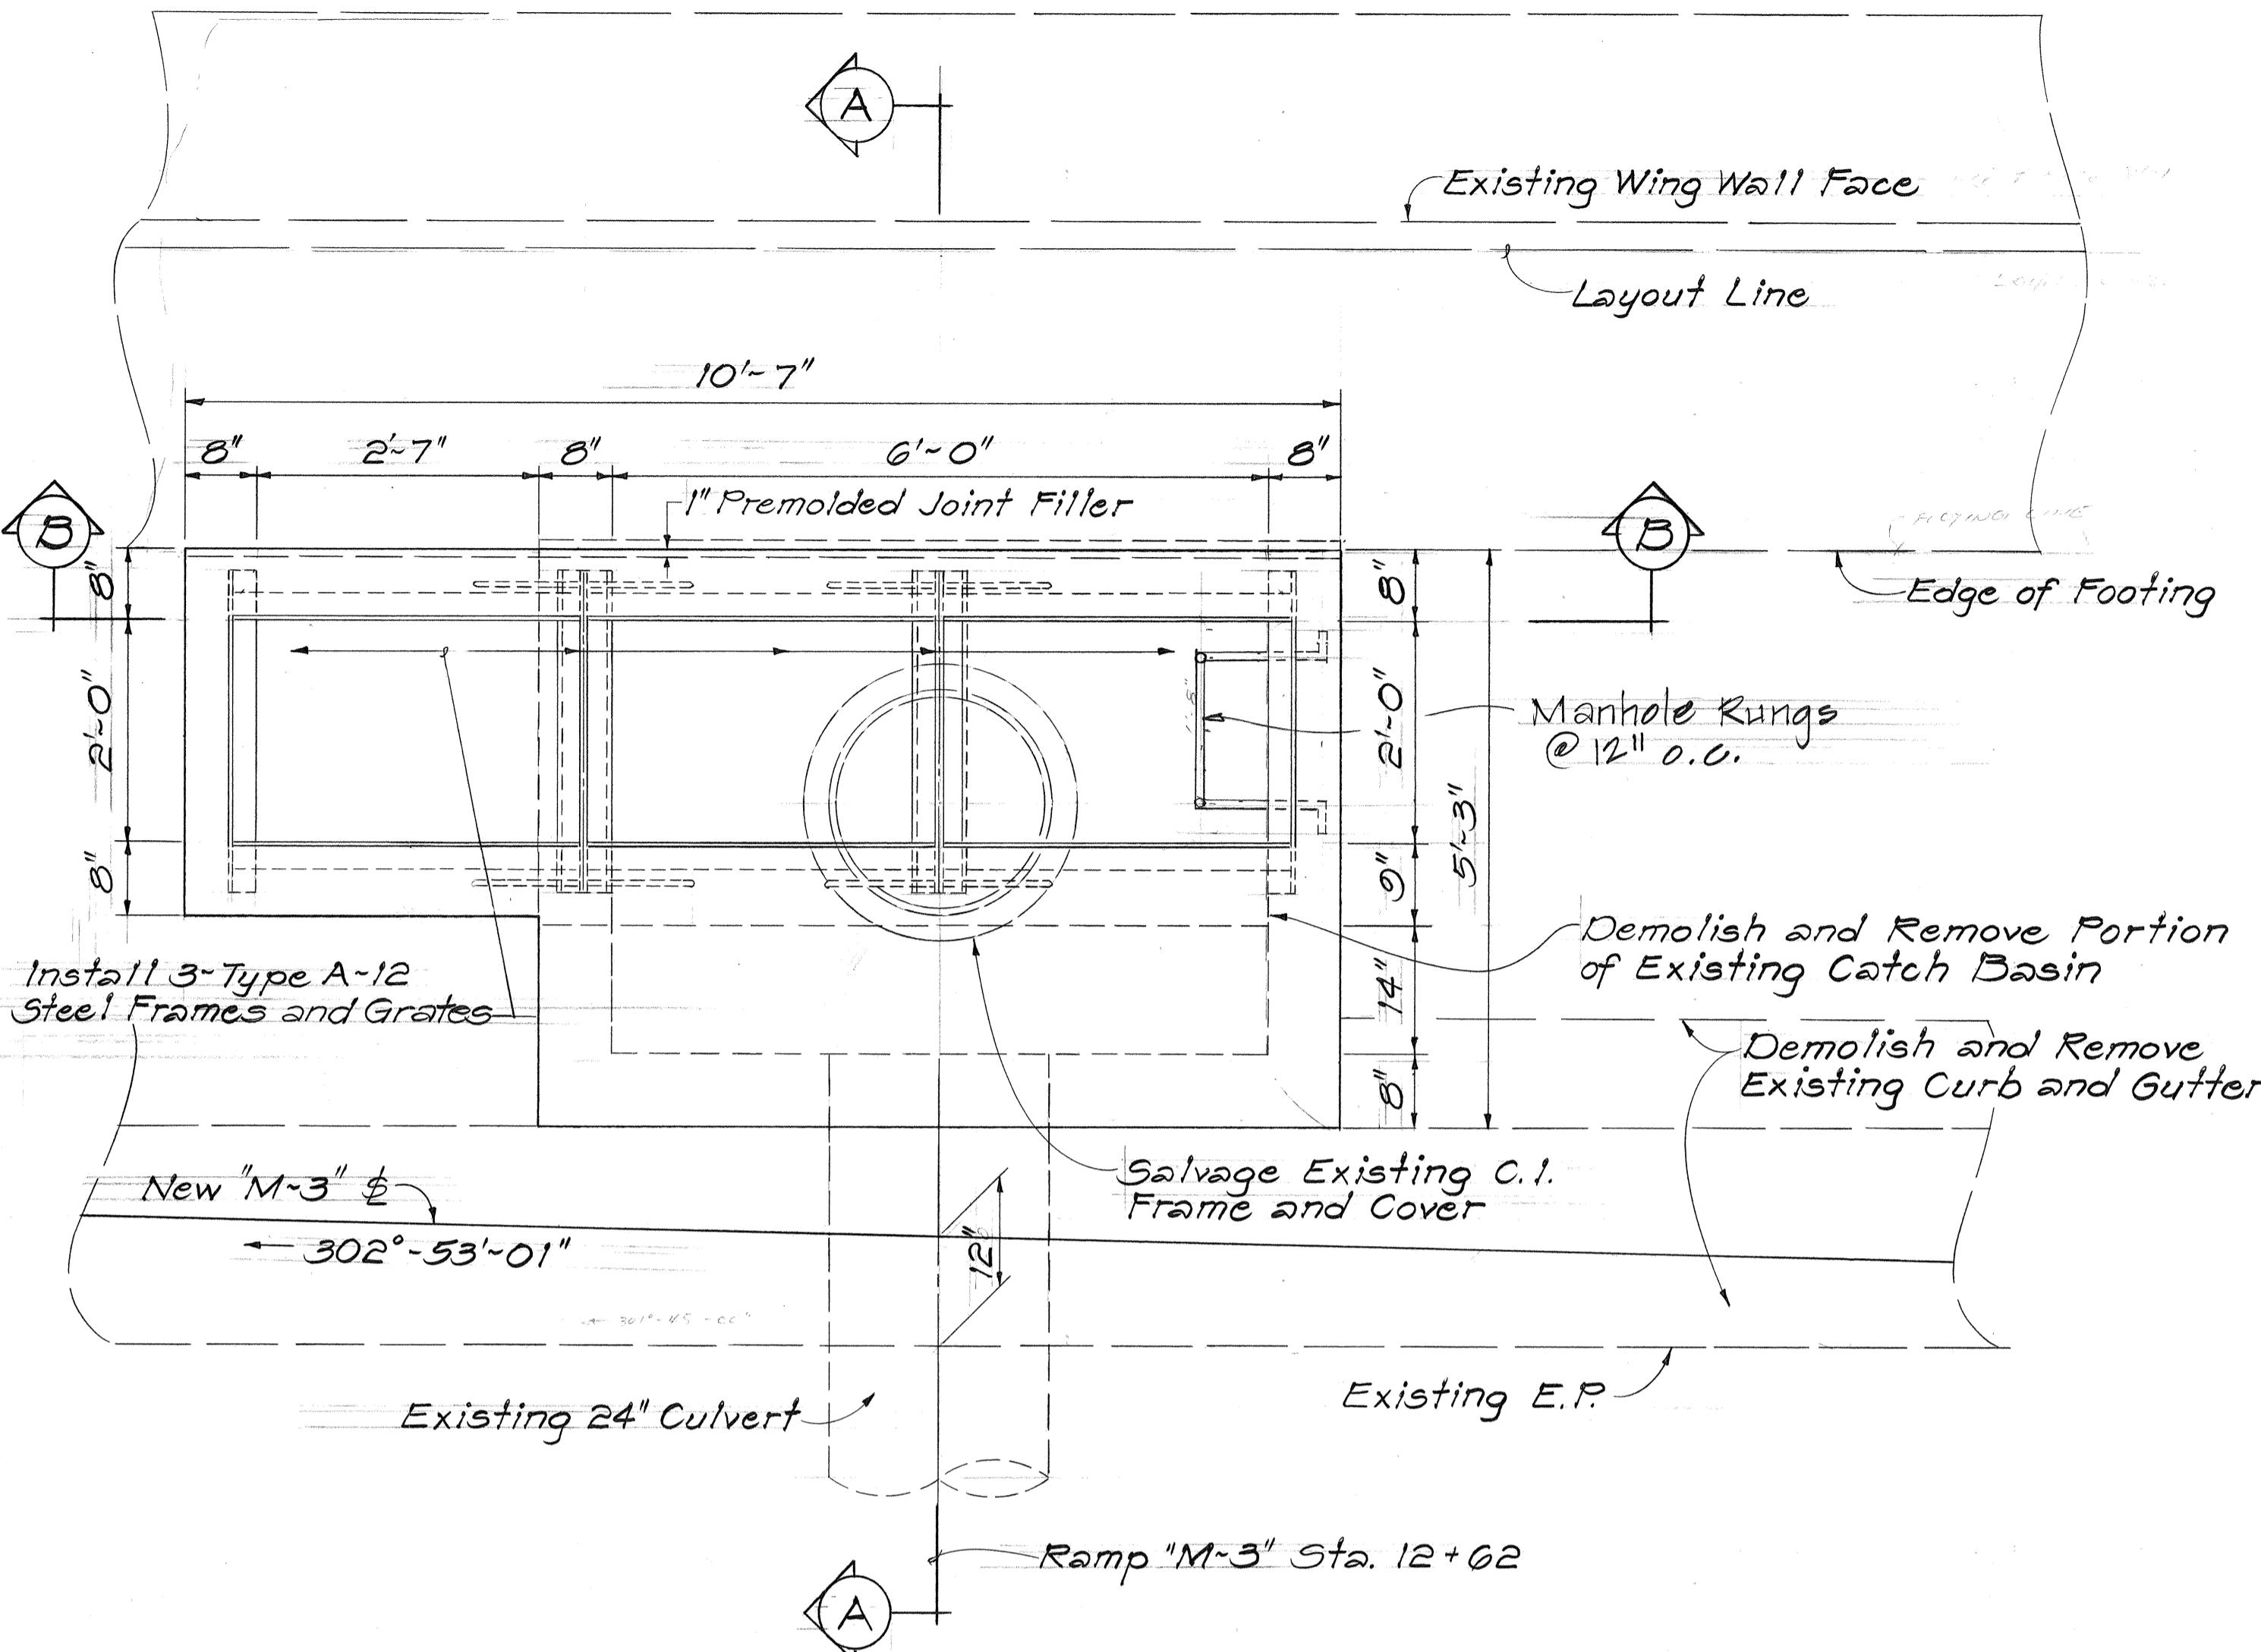


SECTION A-A

Scale: 3/4" = 1'-0"

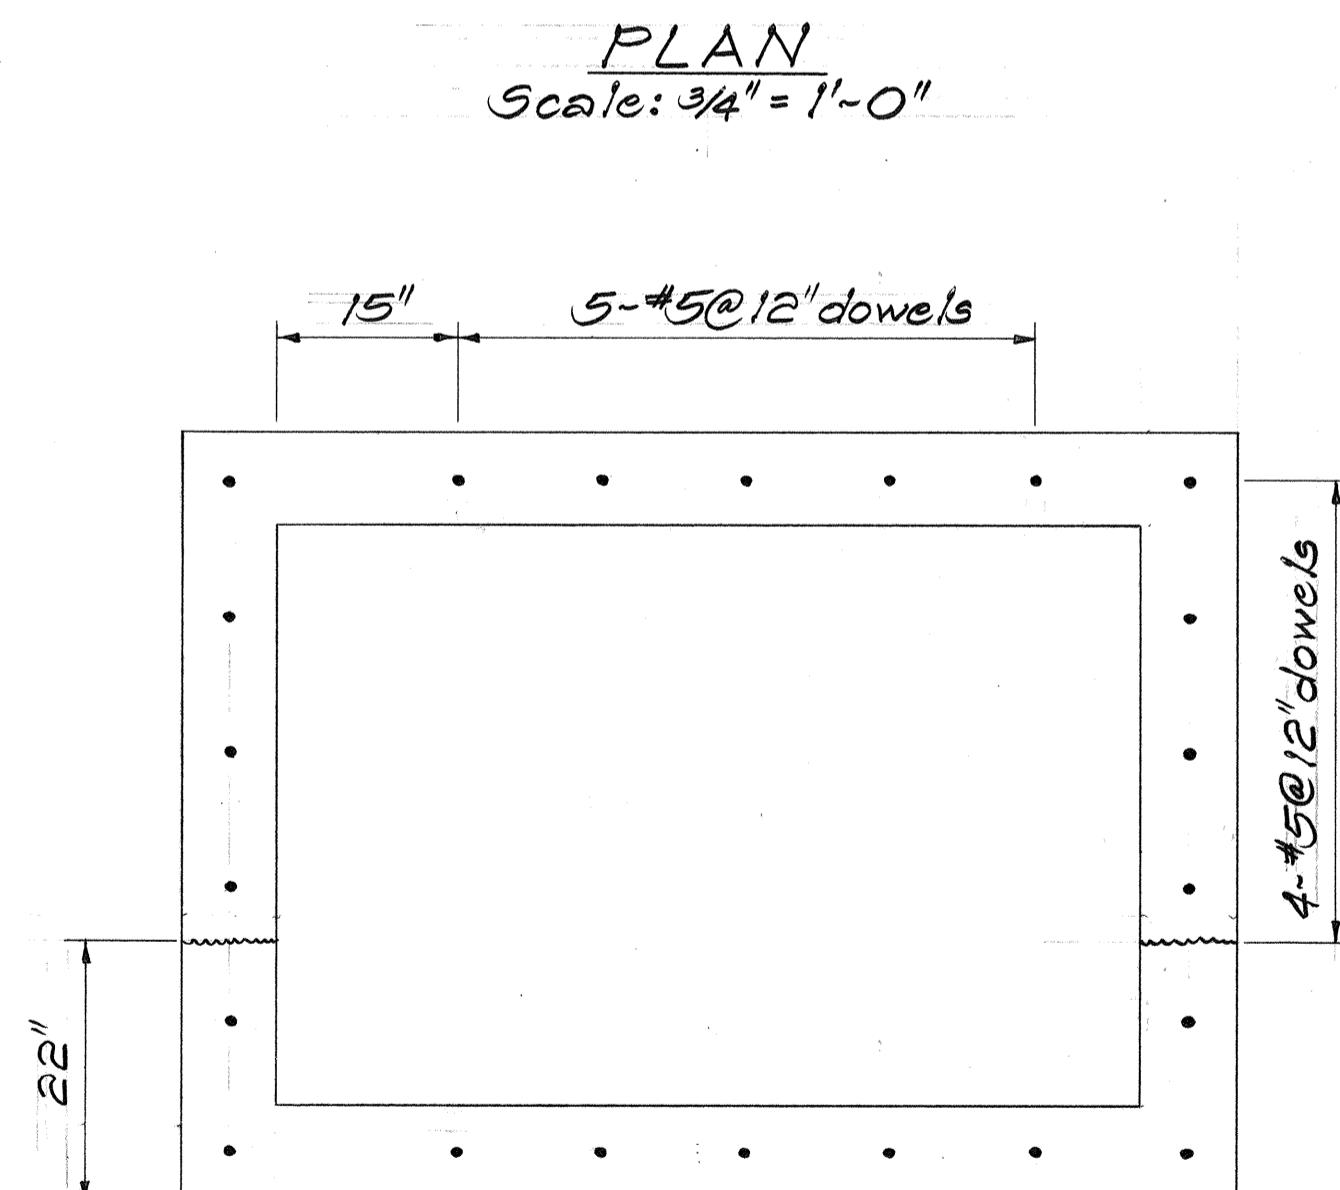

PARTIAL PLAN ~ DOWEL LOCATION

Scale: 3/4" = 1'-0"

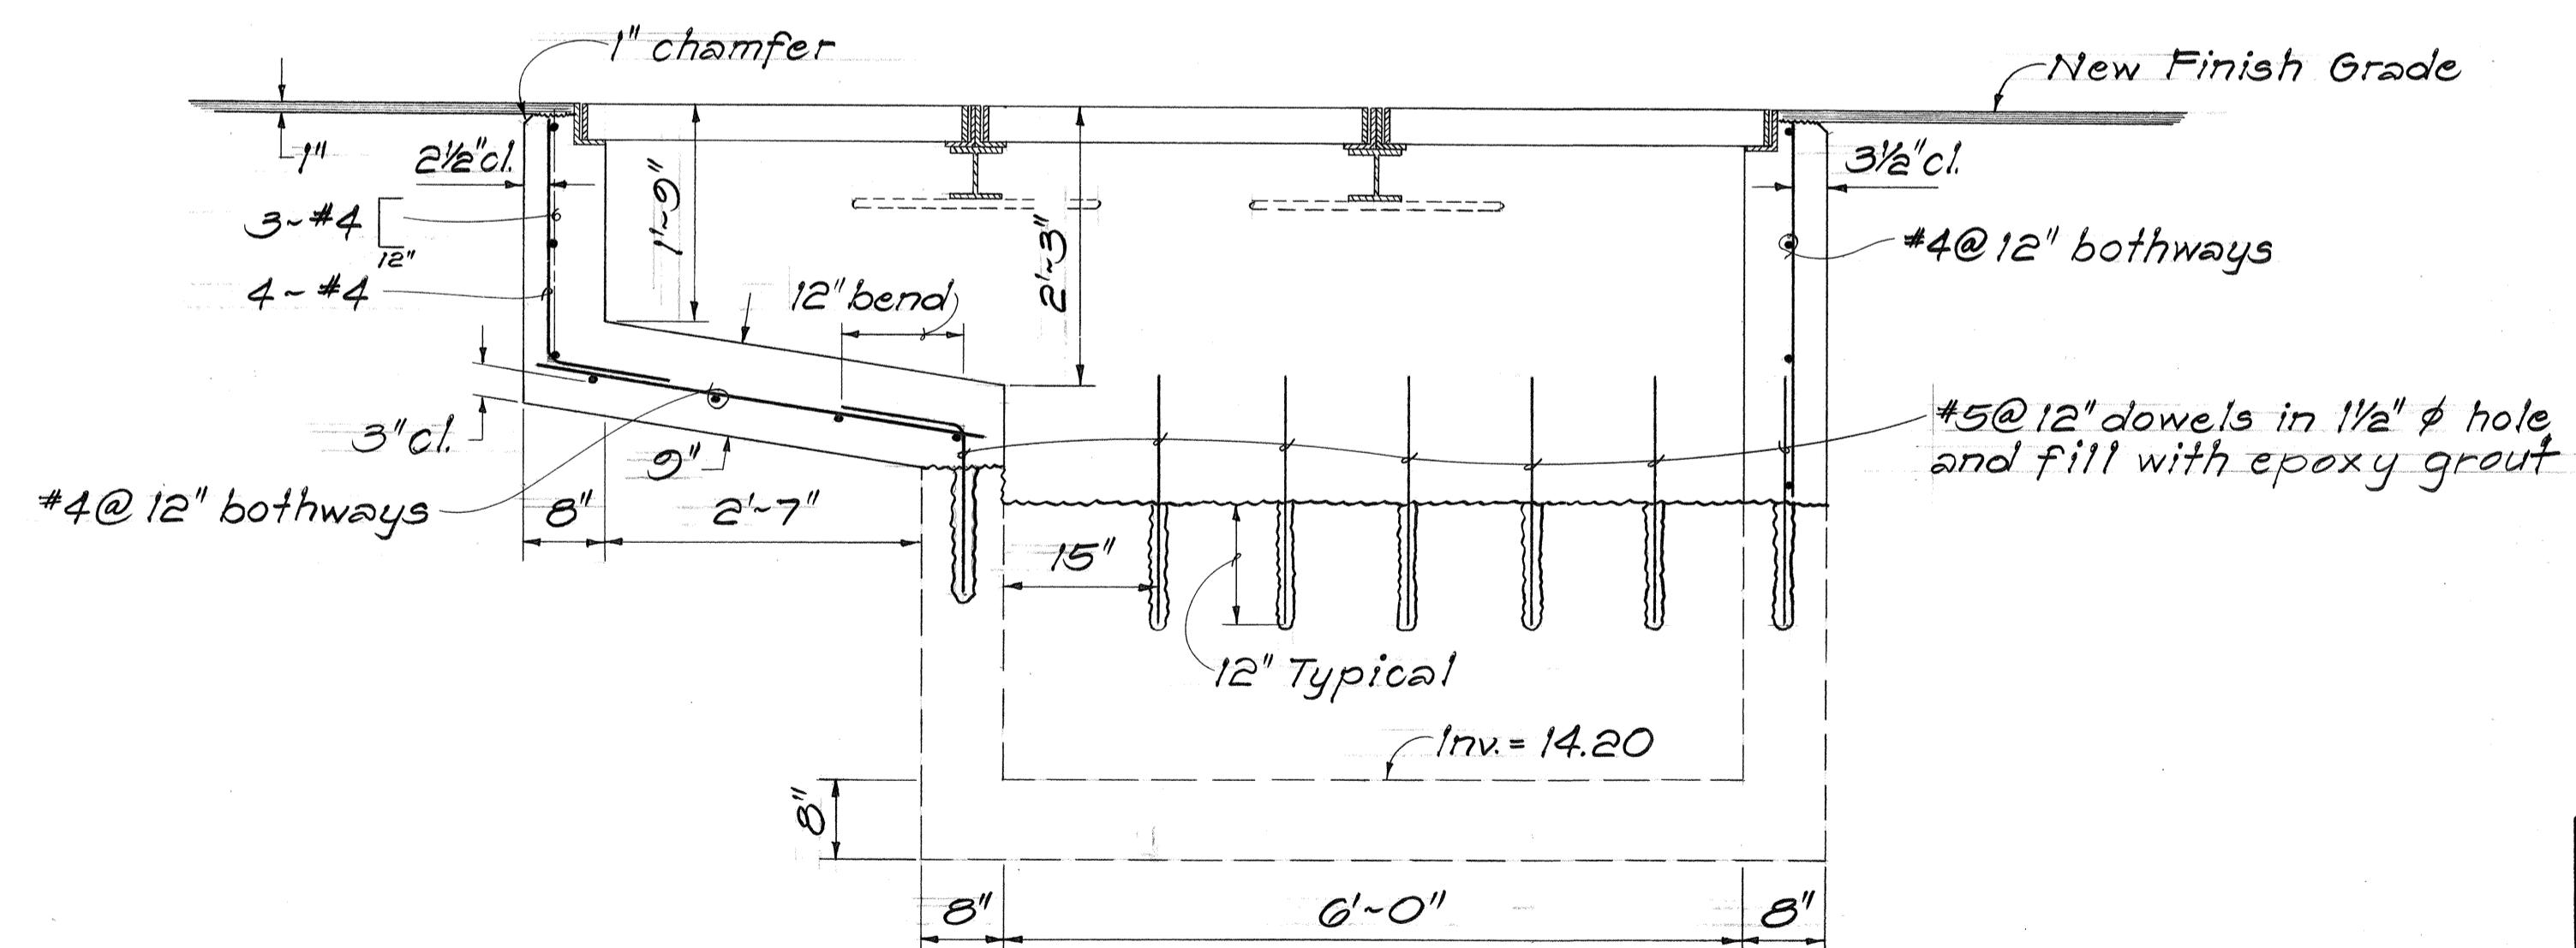





SECTION B-B

Scale: 3/4" = 1'-0"

DETAILS OF MODIFIED TYPE 3 GRATED DROP INTAKE AT RAMP "M-3" STA. 12+02 RT.


STATE OF HAWAII
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MIDDLE STREET TO KALIHI INTERCHANGE
EASTBOUND LANES
F.A.I. PROJECT NO. I-HI-1(178)
SCALE: AS NOTED
SHEET NO. 13 OF 33 SHEETS

FED. ROAD DIST. NO.	STATE	FED. AID PROJ. NO.	FISCAL YEAR	SHEET NO.	TOTAL SHEETS
HAWAII	HAW.	I-HI-1(178)	1982	46	105

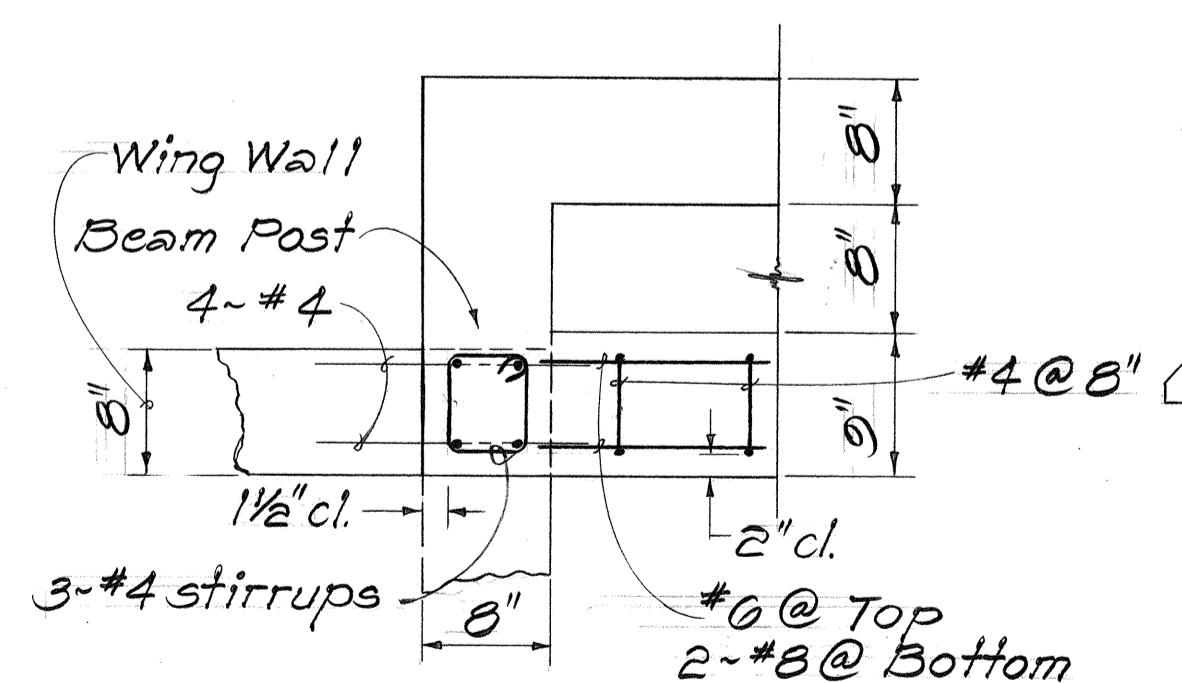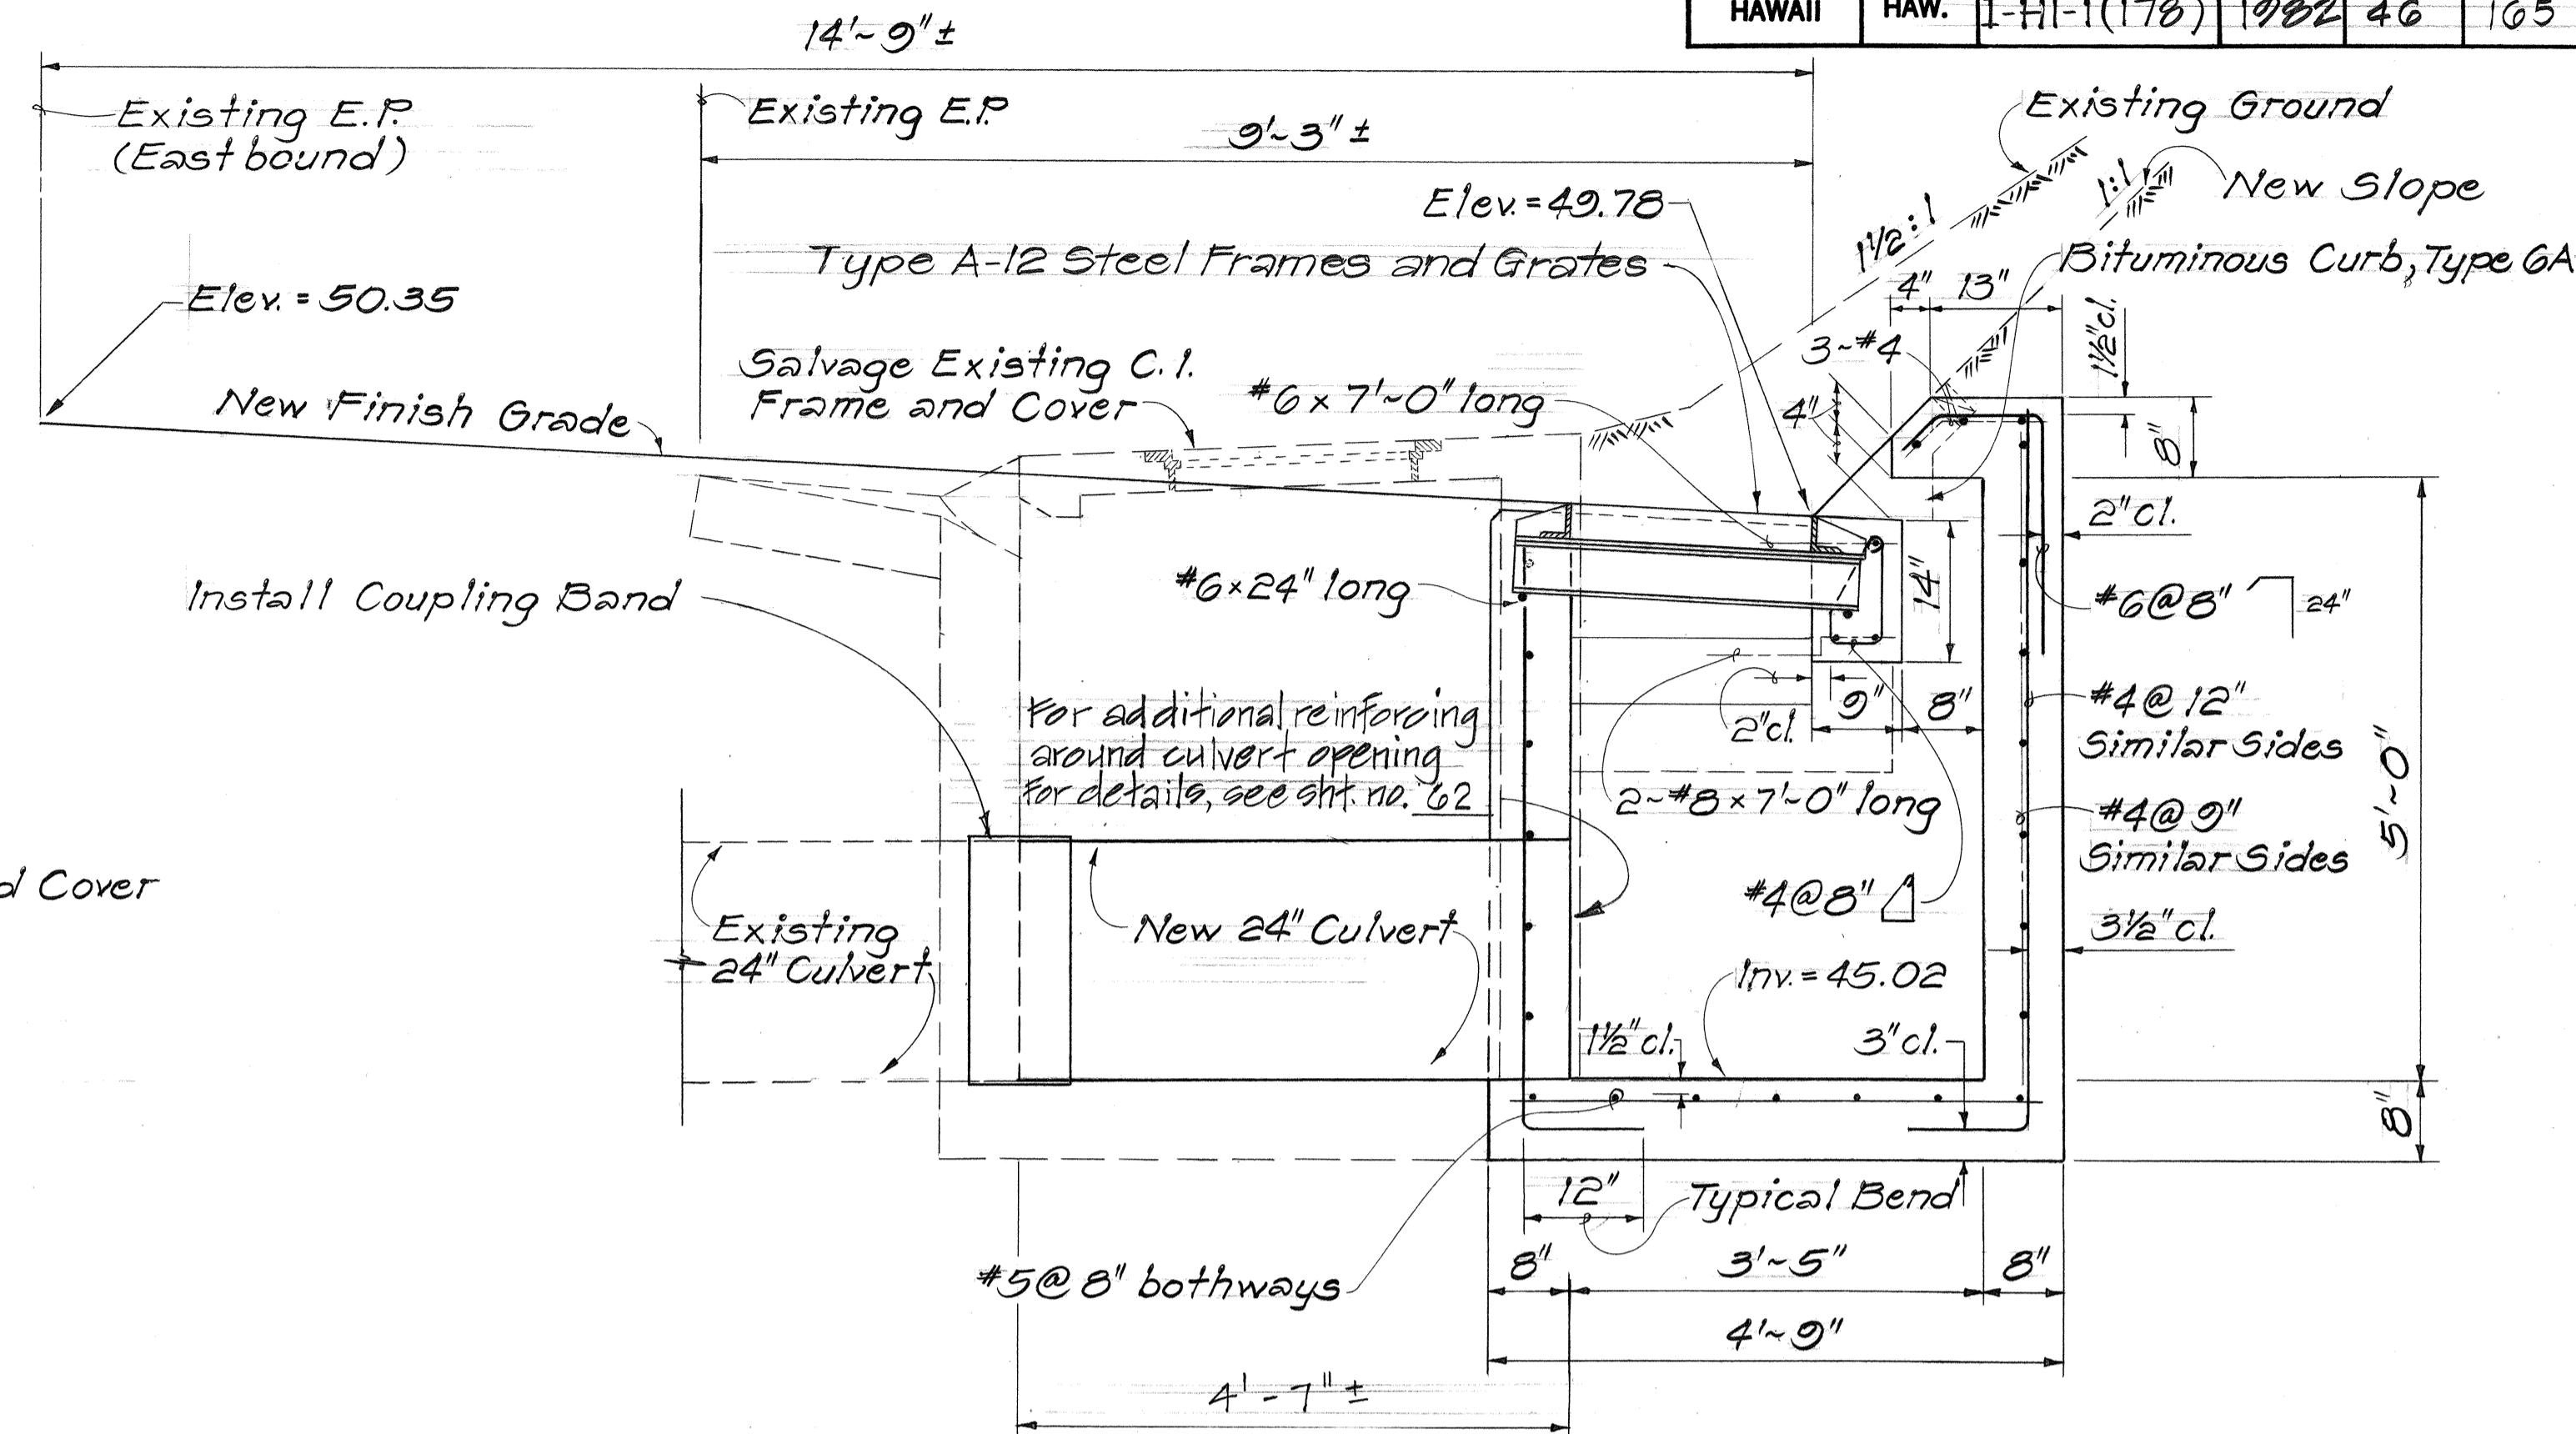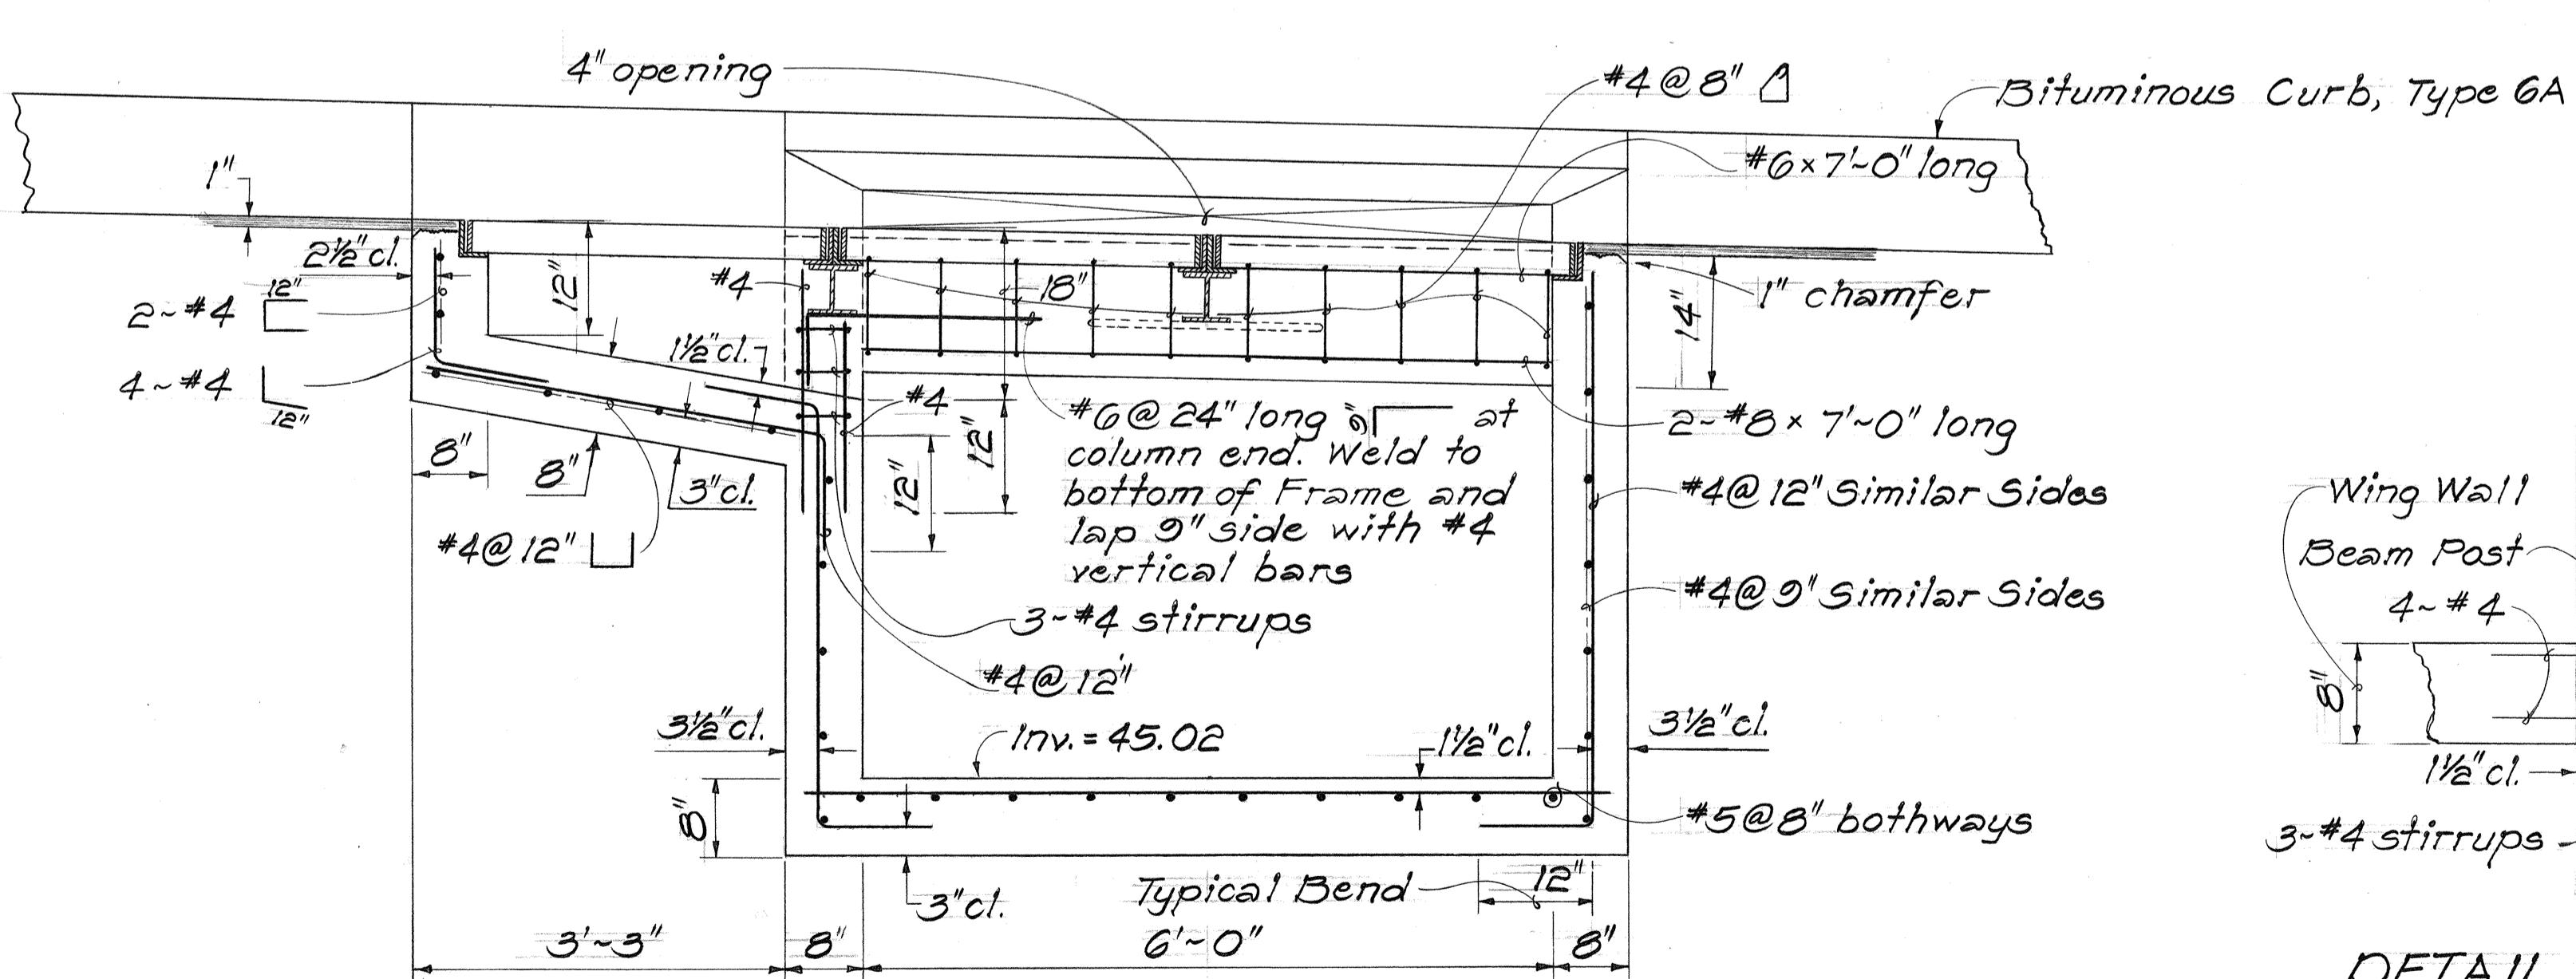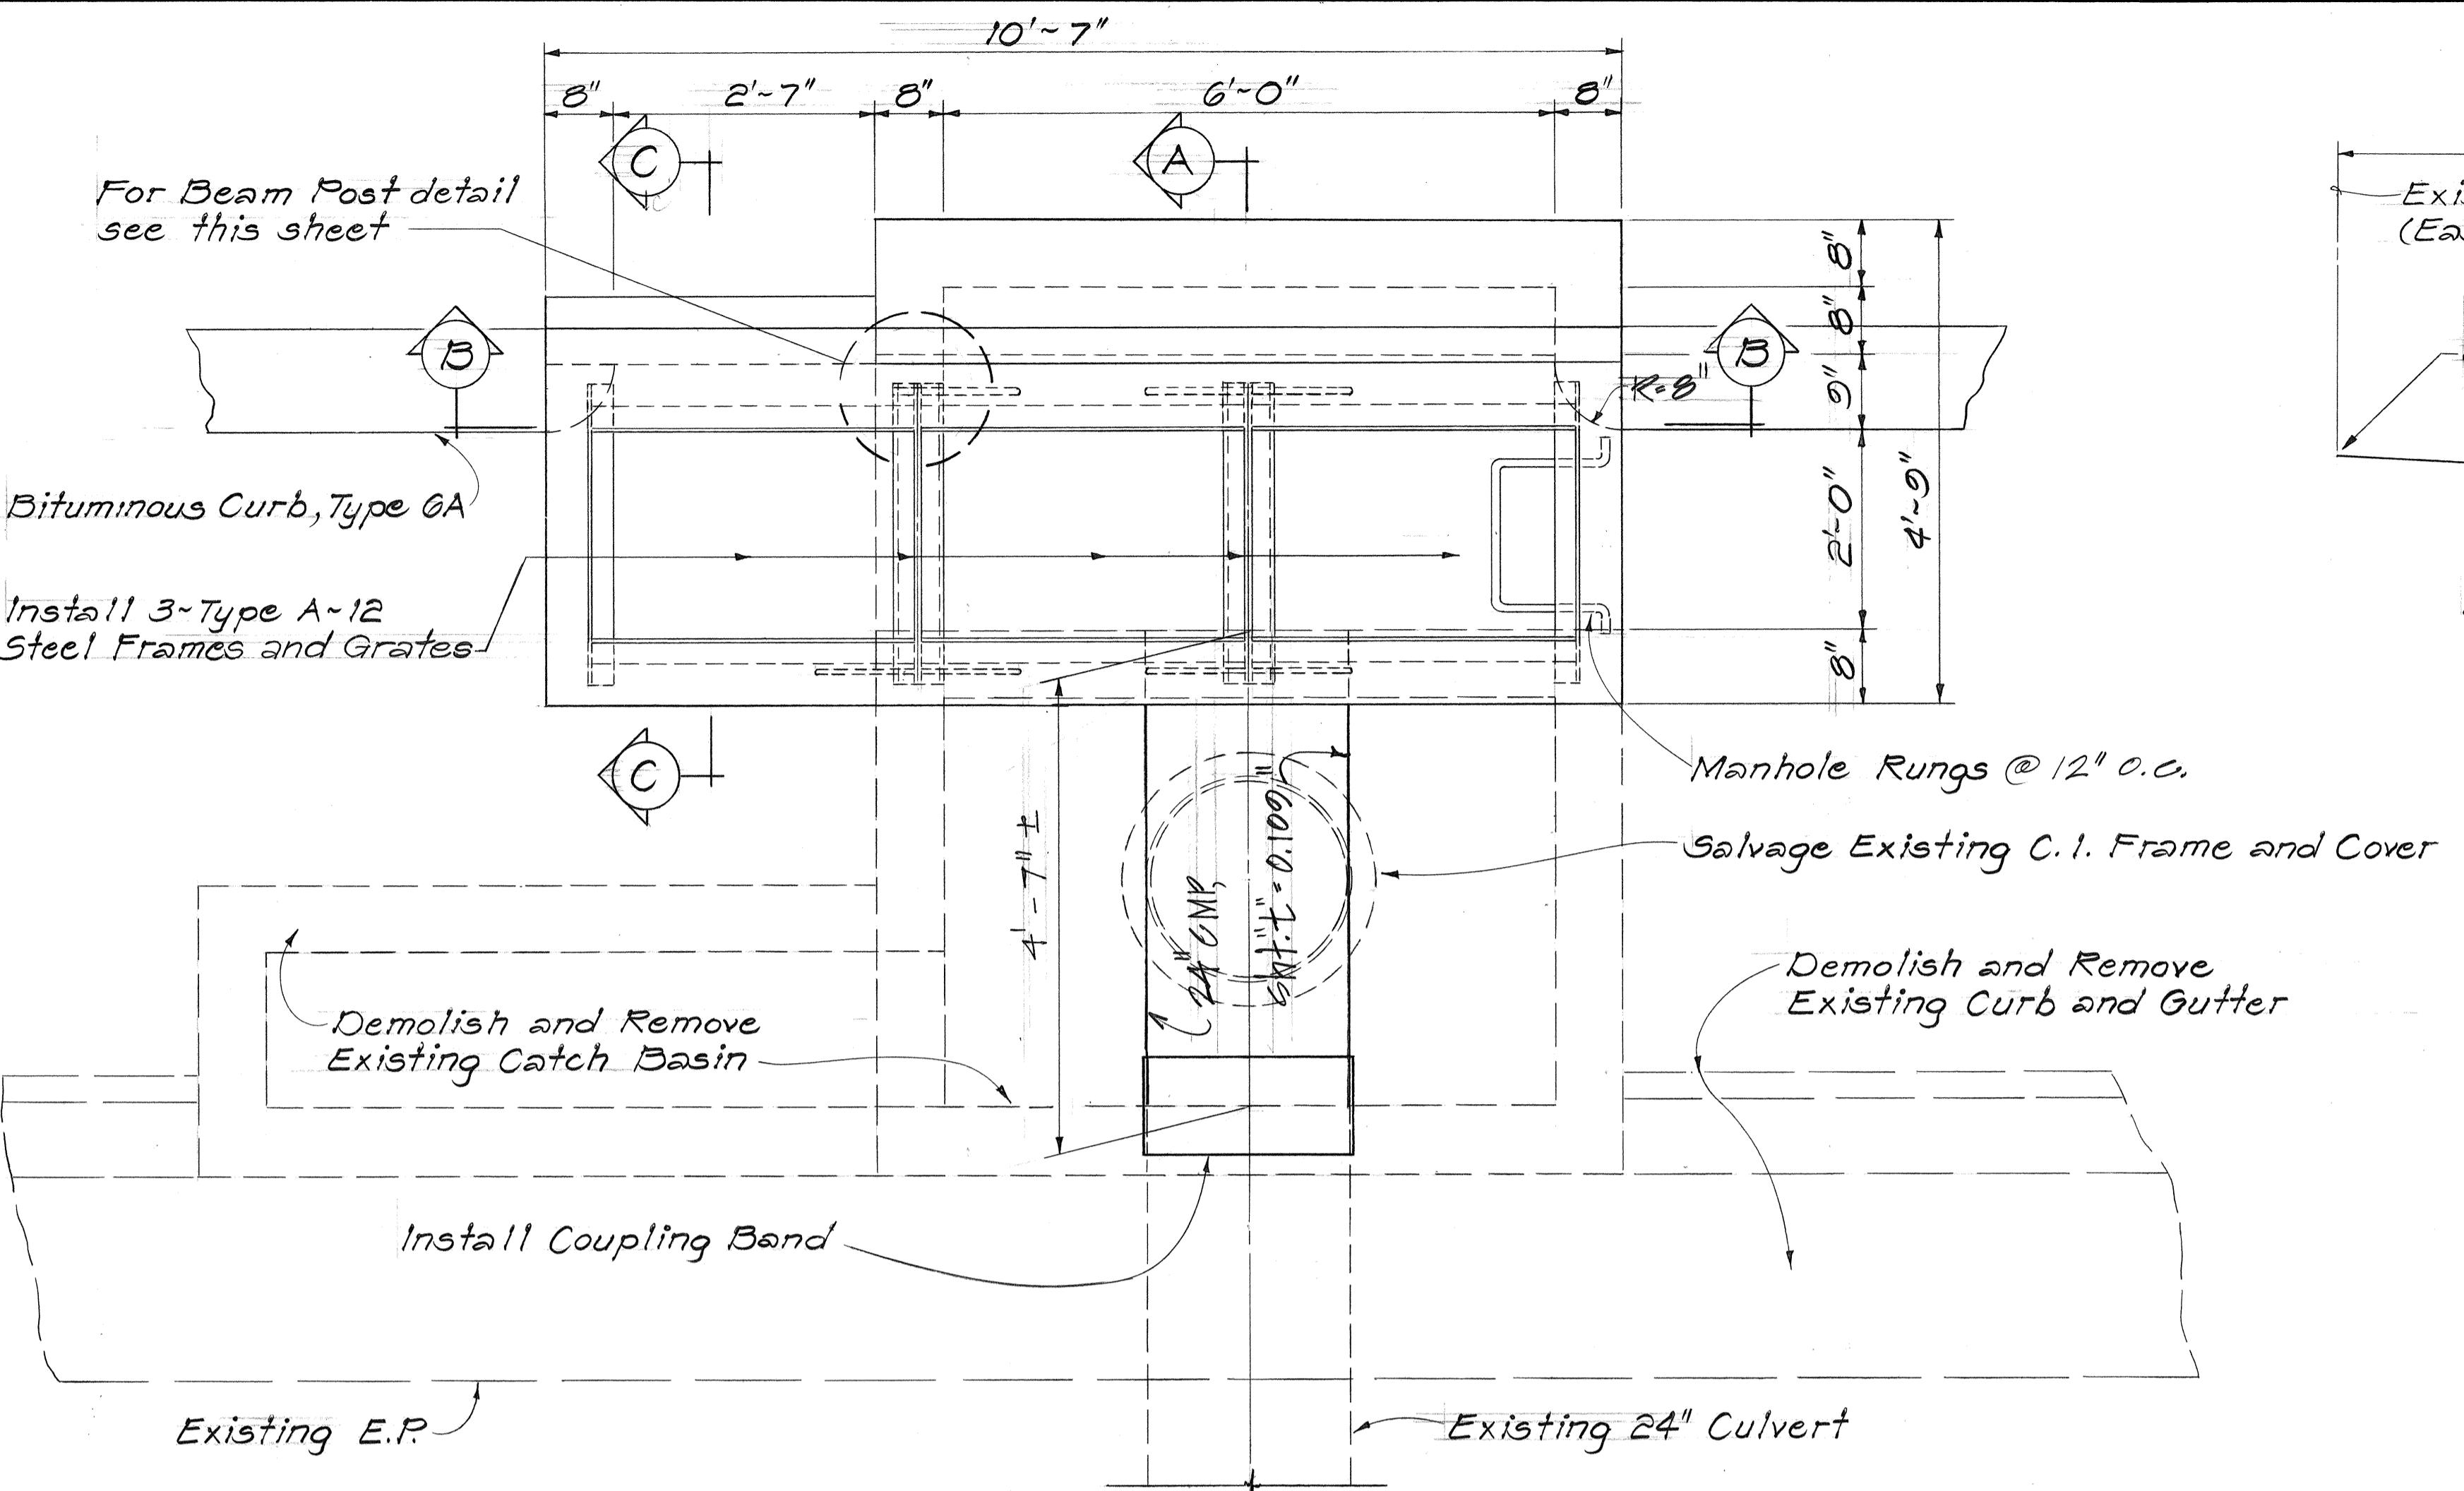


DETAIL OF BEAM POST
Scale: 1" = 1'-0"

DETAILS OF TYPE 3 GRATED DROP INTAKE AT STA. 23+50 RT.



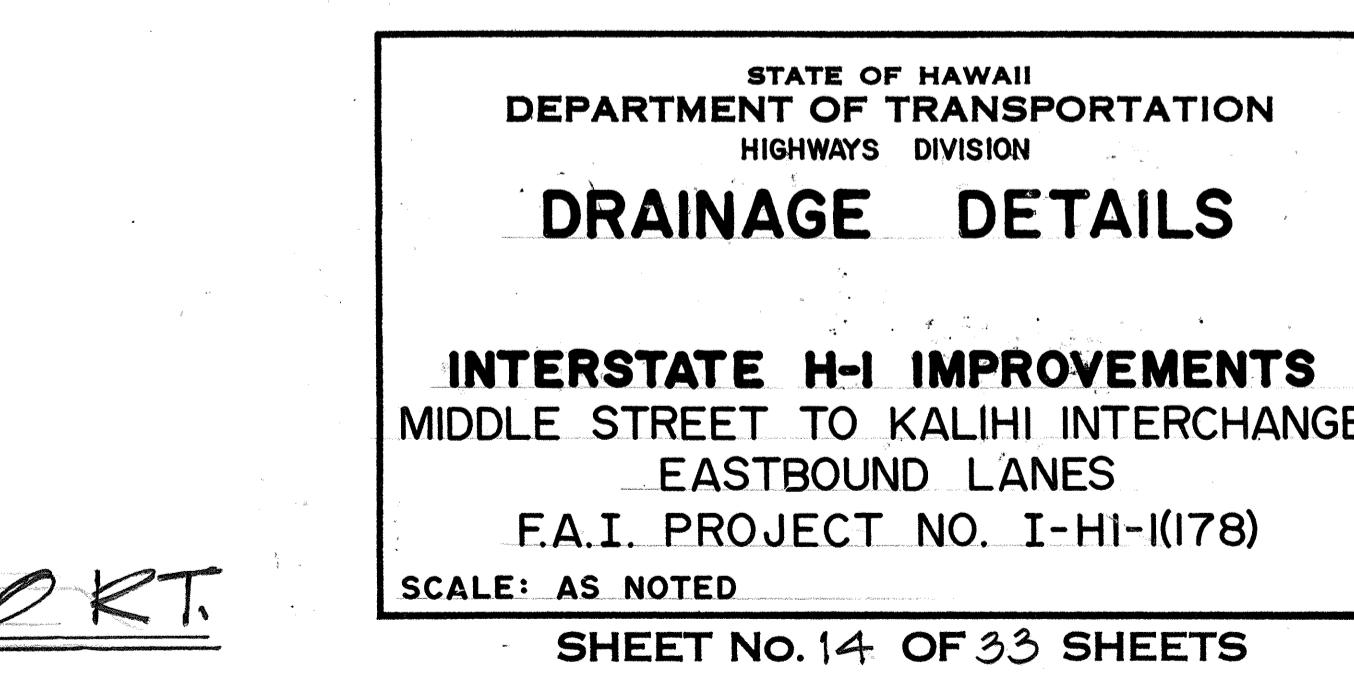


FED. ROAD DIST. NO.	STATE	FED. AID PROJ. NO.	FISCAL YEAR	SHEET NO.	TOTAL SHEETS
HAWAII	HAW.	I-HI-1(178)	1982	47	165

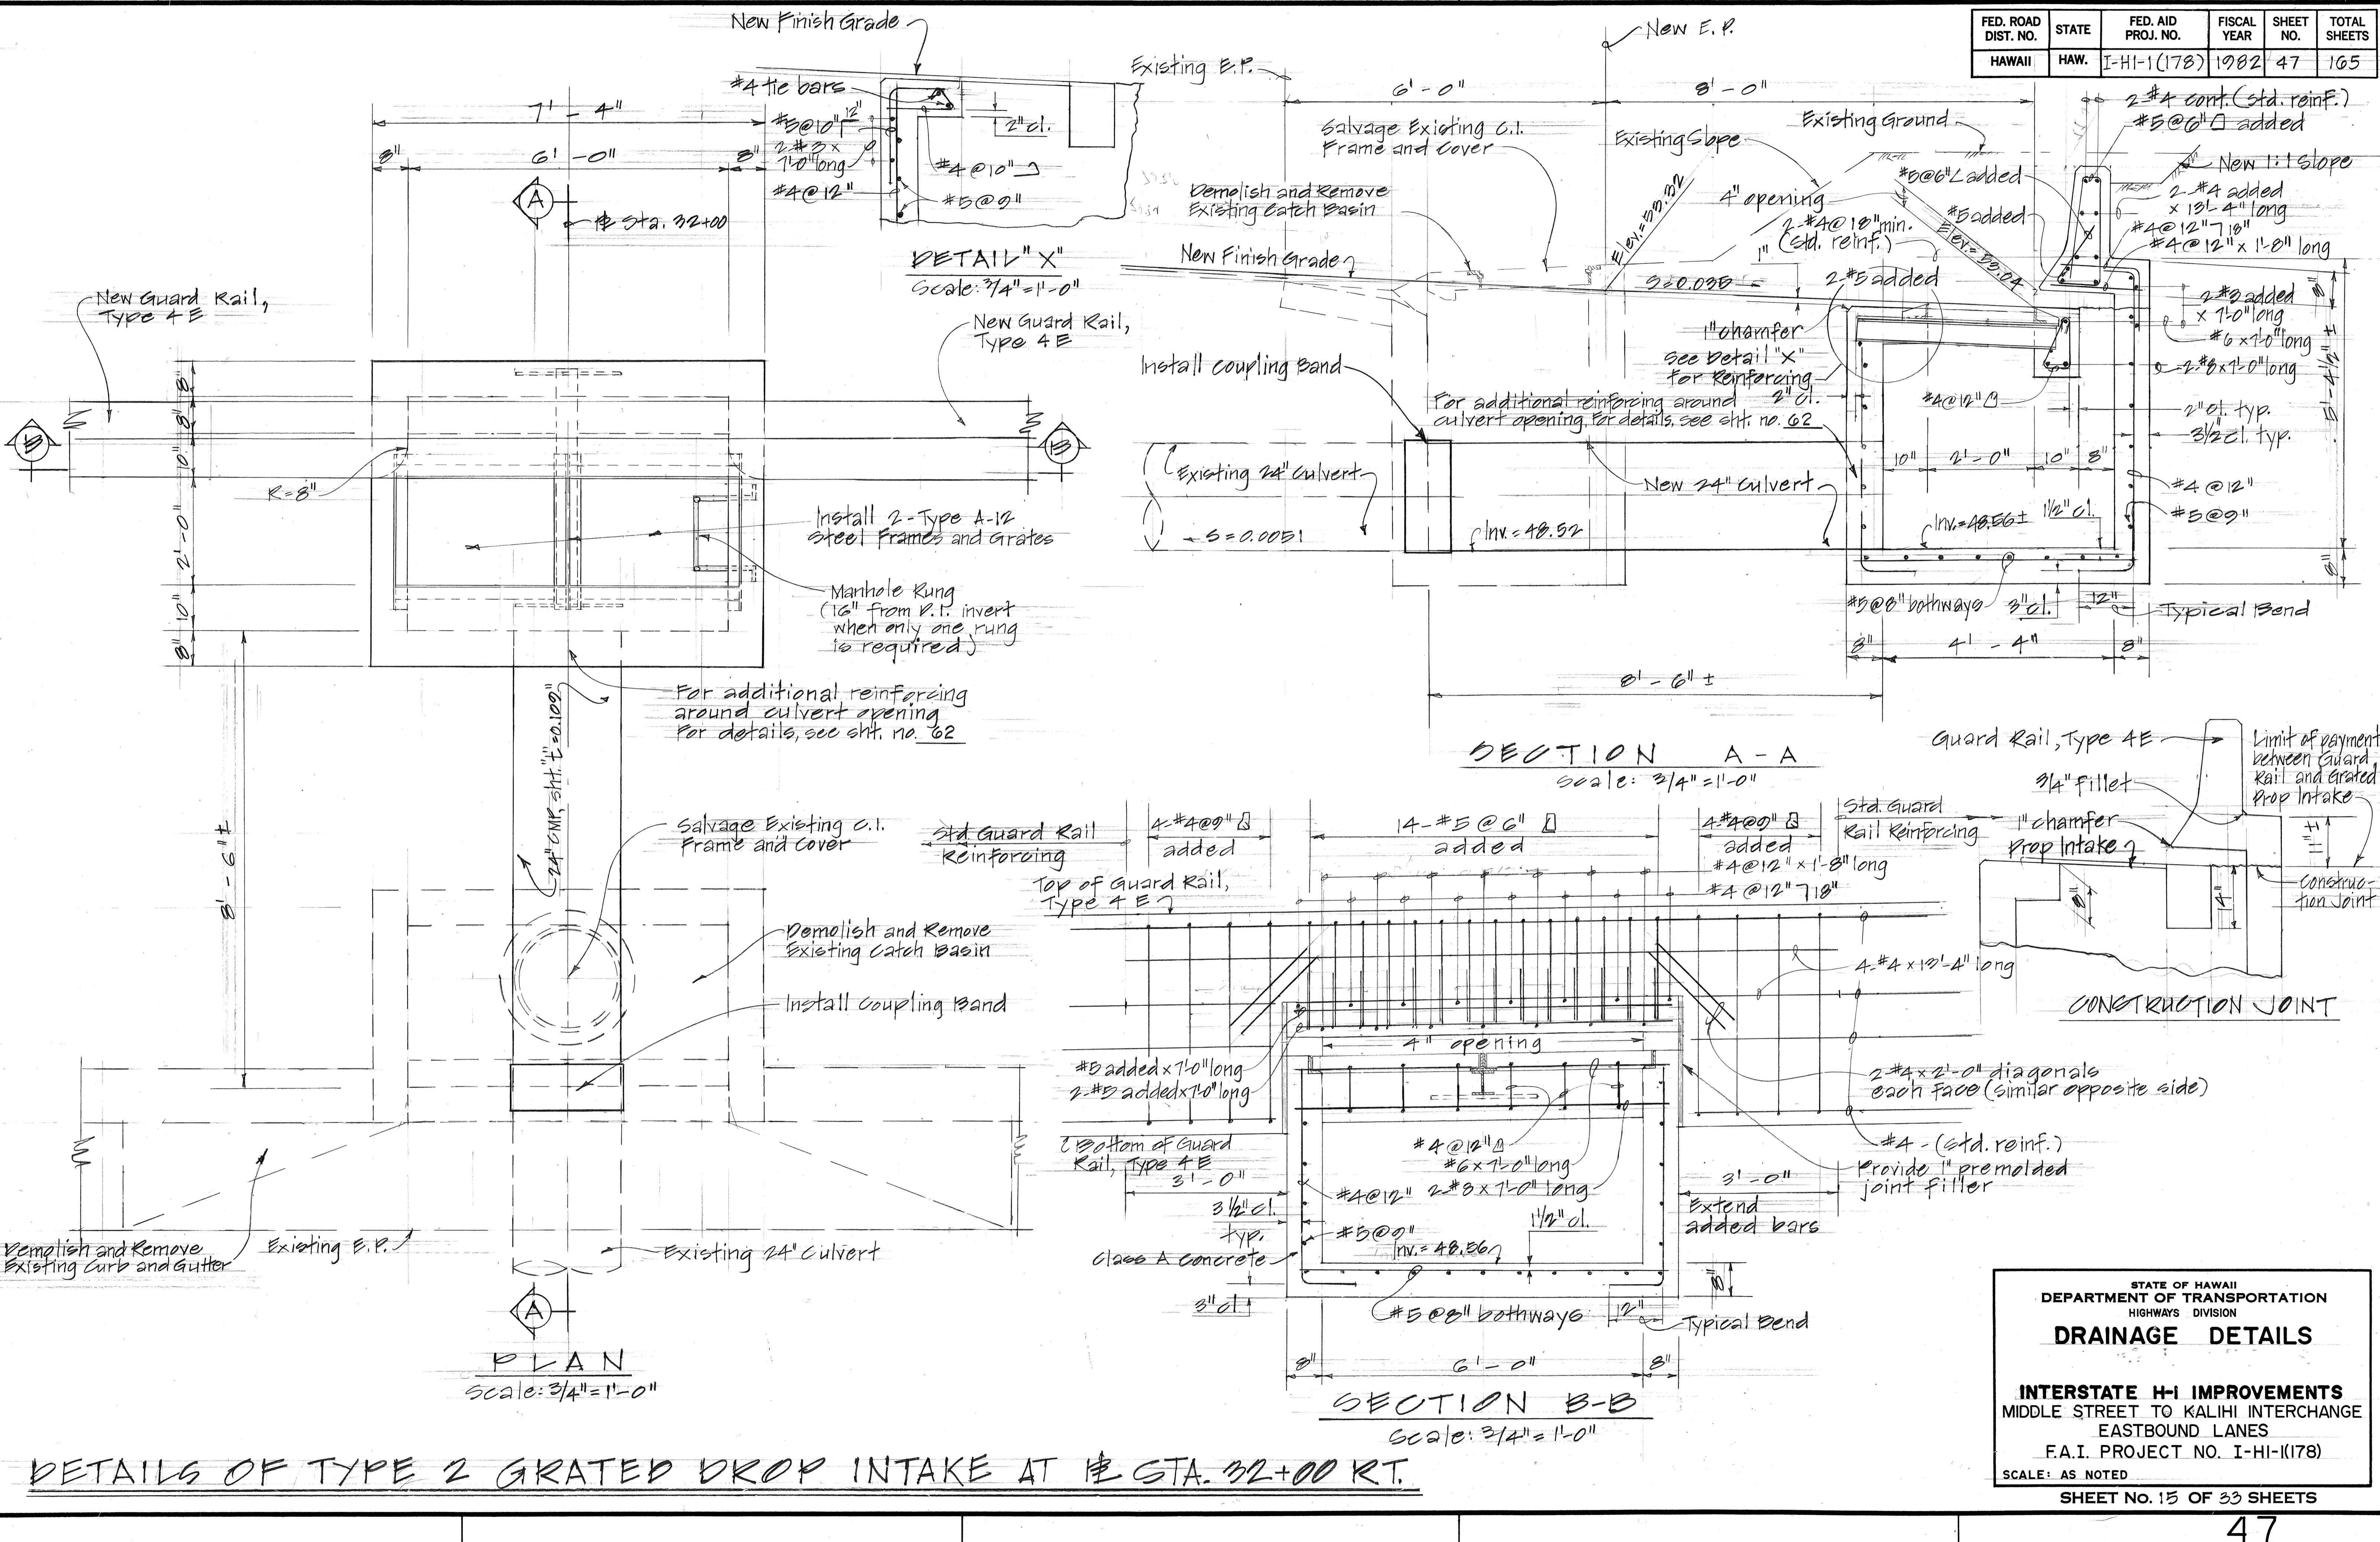

STATE OF HAWAII
DEPARTMENT OF TRANSPORTATION
HIGHWAYS DIVISION
DRAINAGE DETAILS
INTERSTATE H-I IMPROVEMENTS
MIDDLE STREET TO KALIHI INTERCHANGE
EASTBOUND LANES
F.A.I. PROJECT NO. I-HI-1(178)
SCALE: AS NOTED
SHEET NO. 15 OF 33 SHEETS


FED. ROAD DIST. NO.	STATE	FED. AID PROJ. NO.	FISCAL YEAR	SHEET NO.	TOTAL SHEETS
HAWAII	HAW.	I-HI-1(178)	1982	48	165

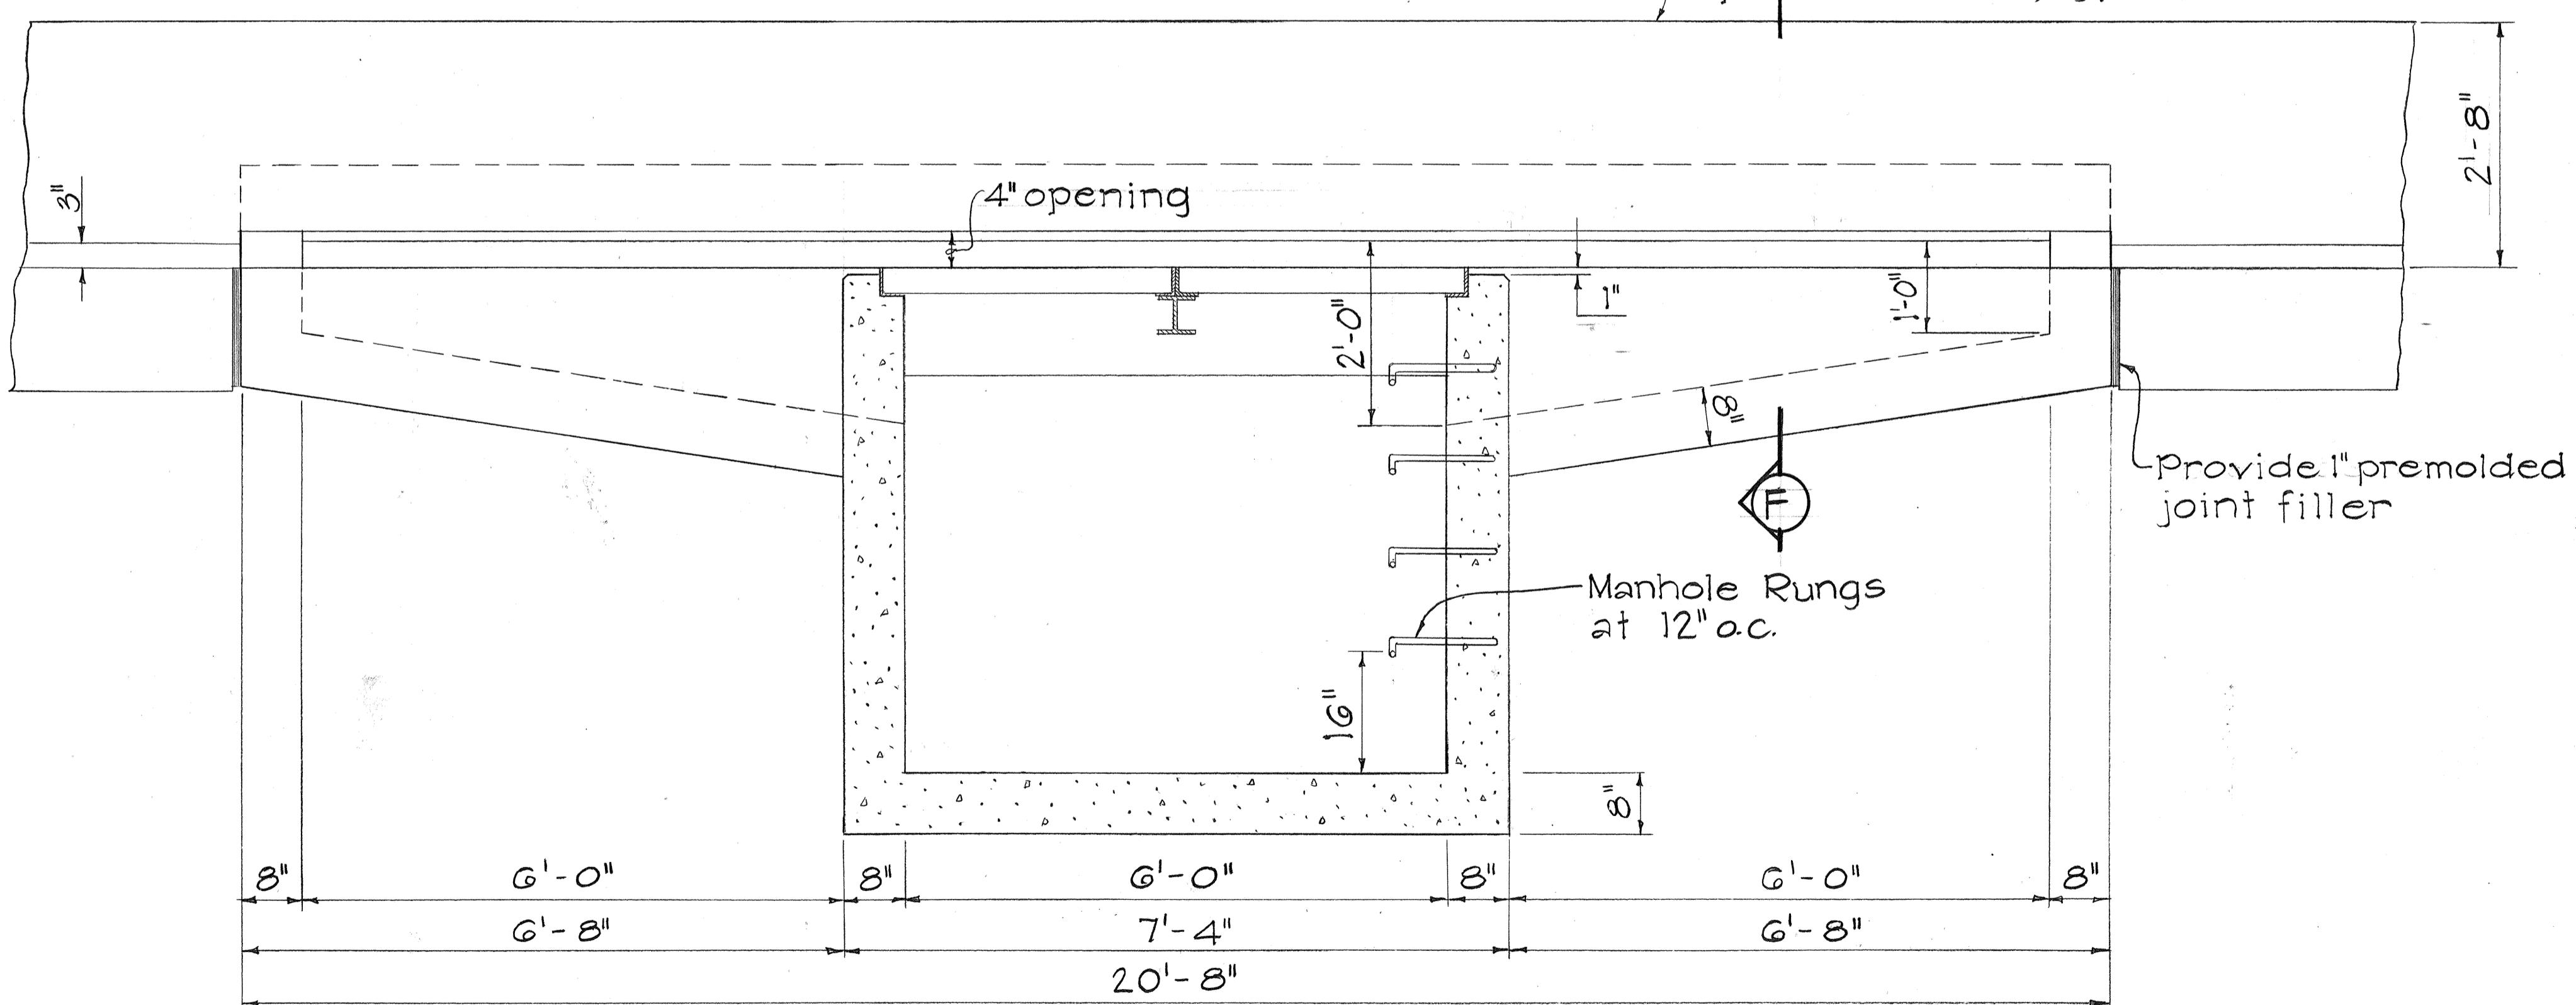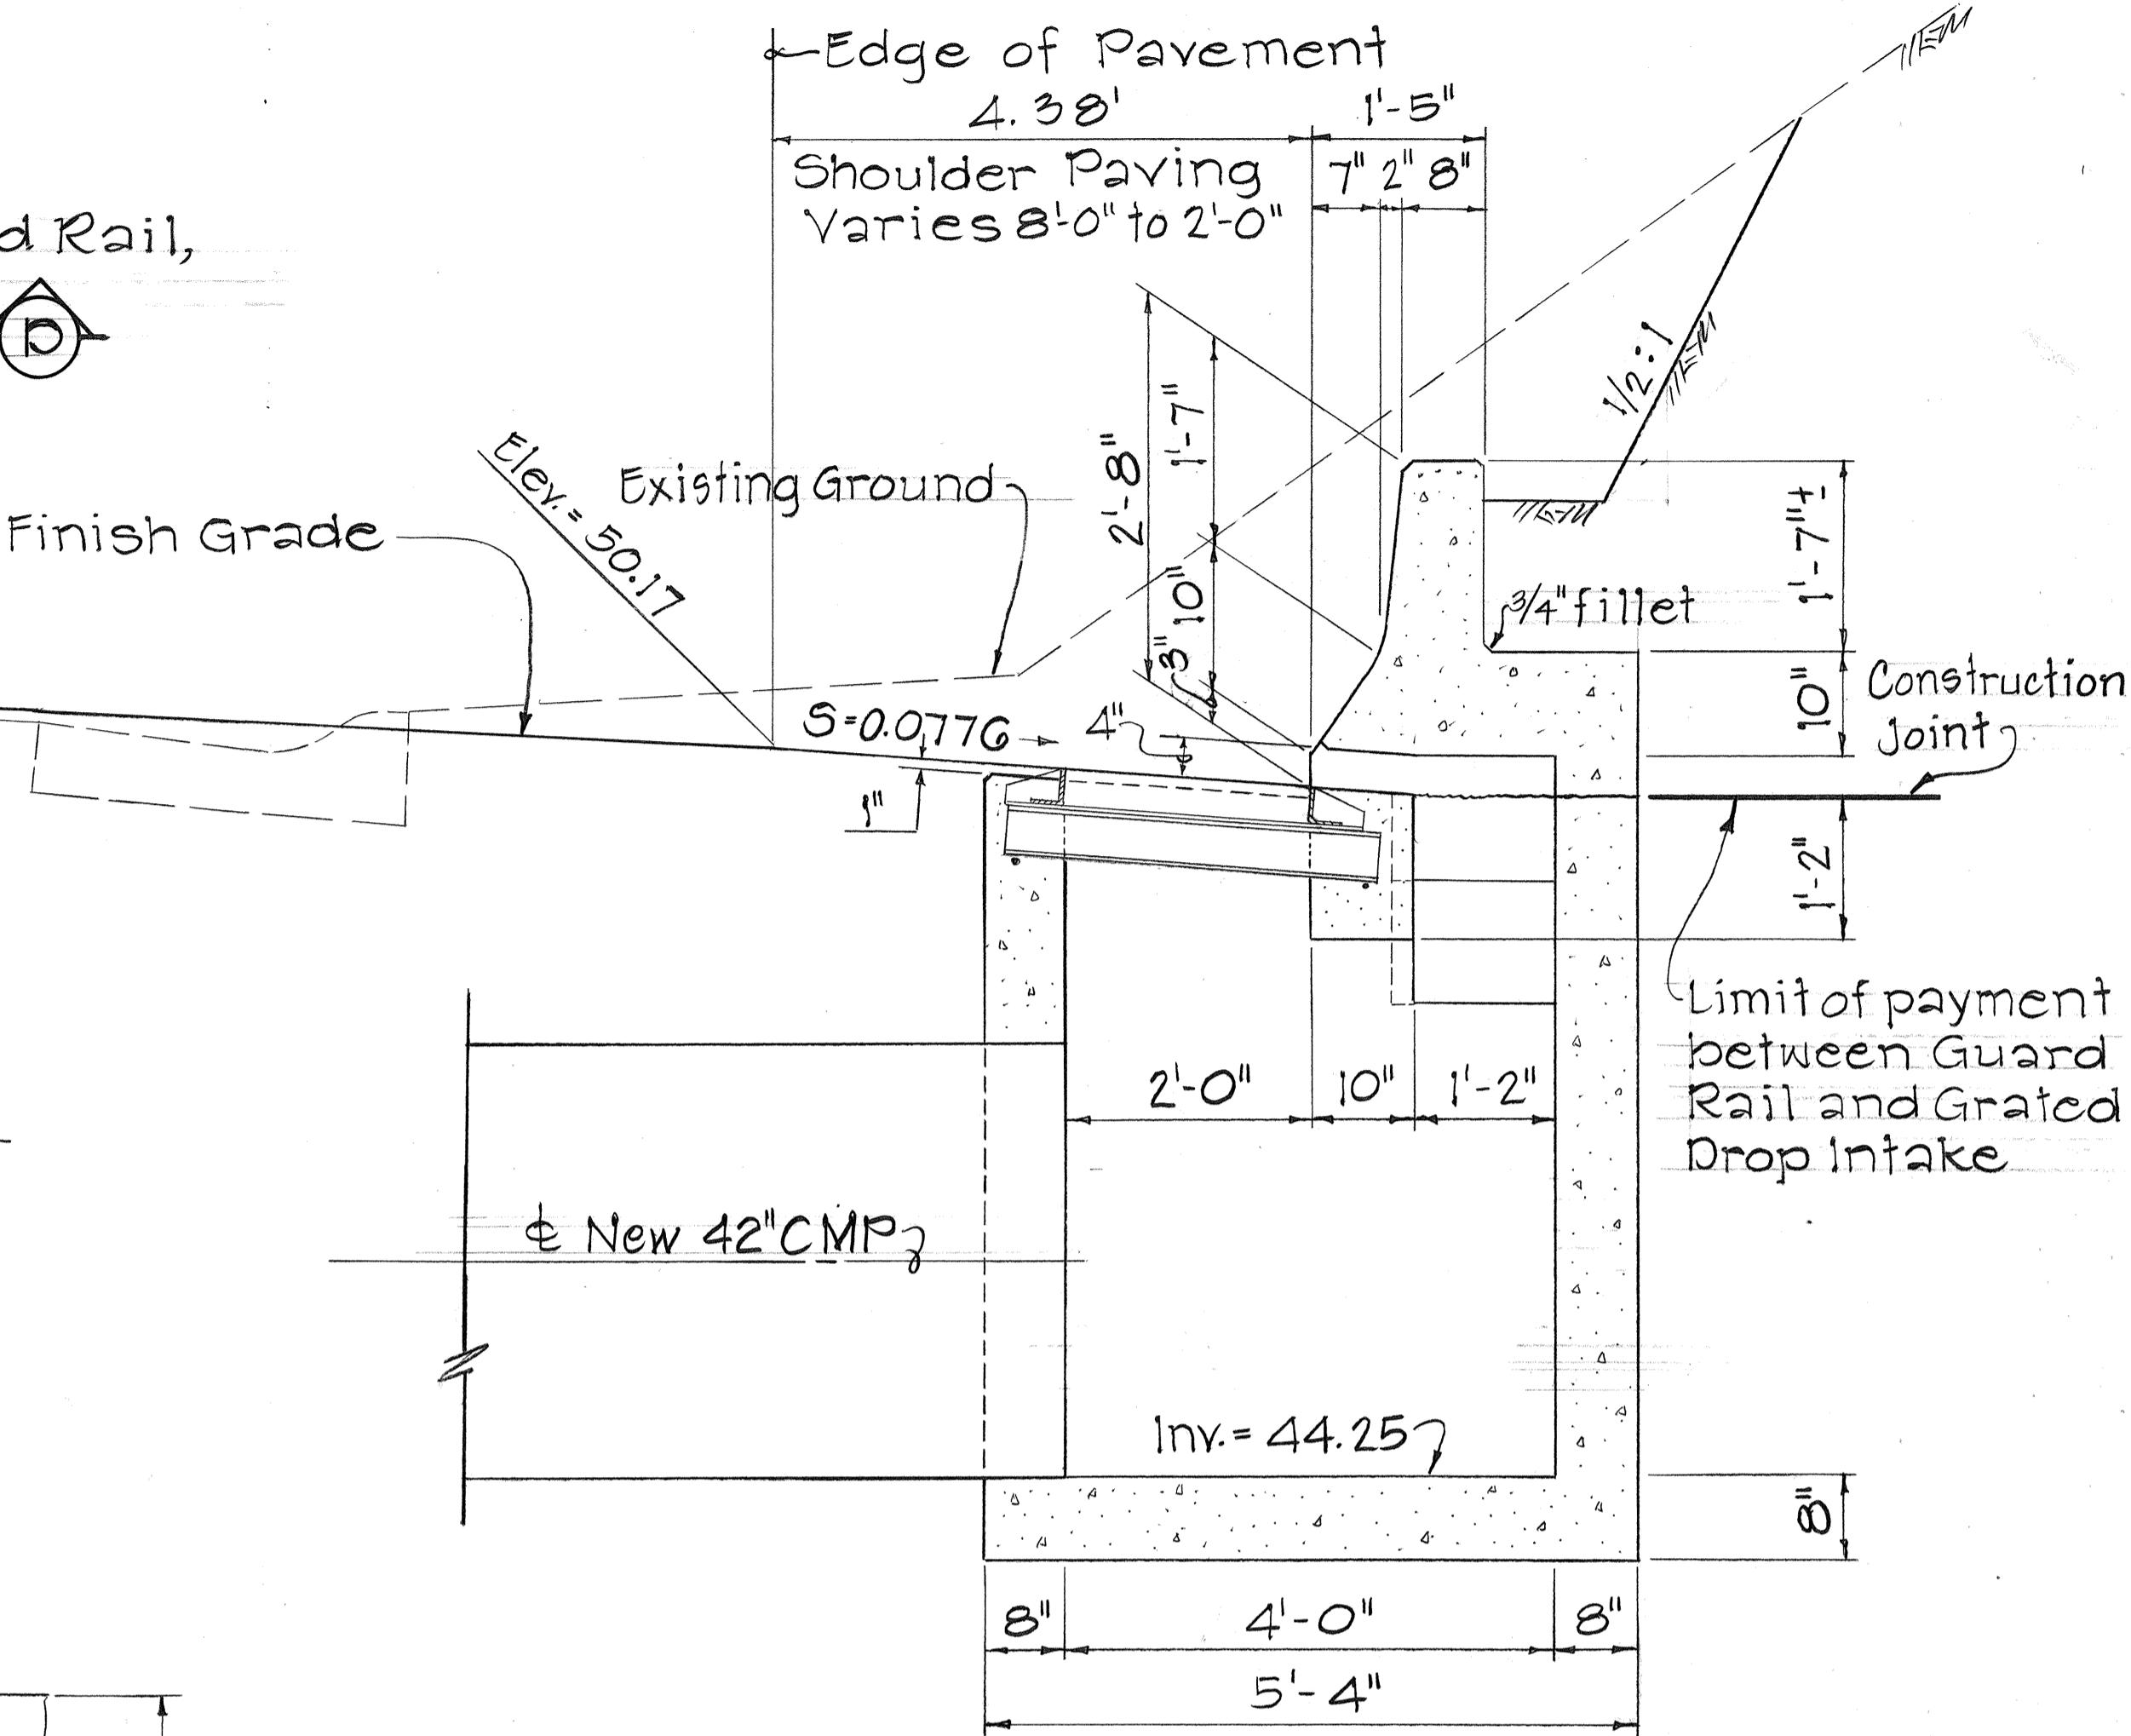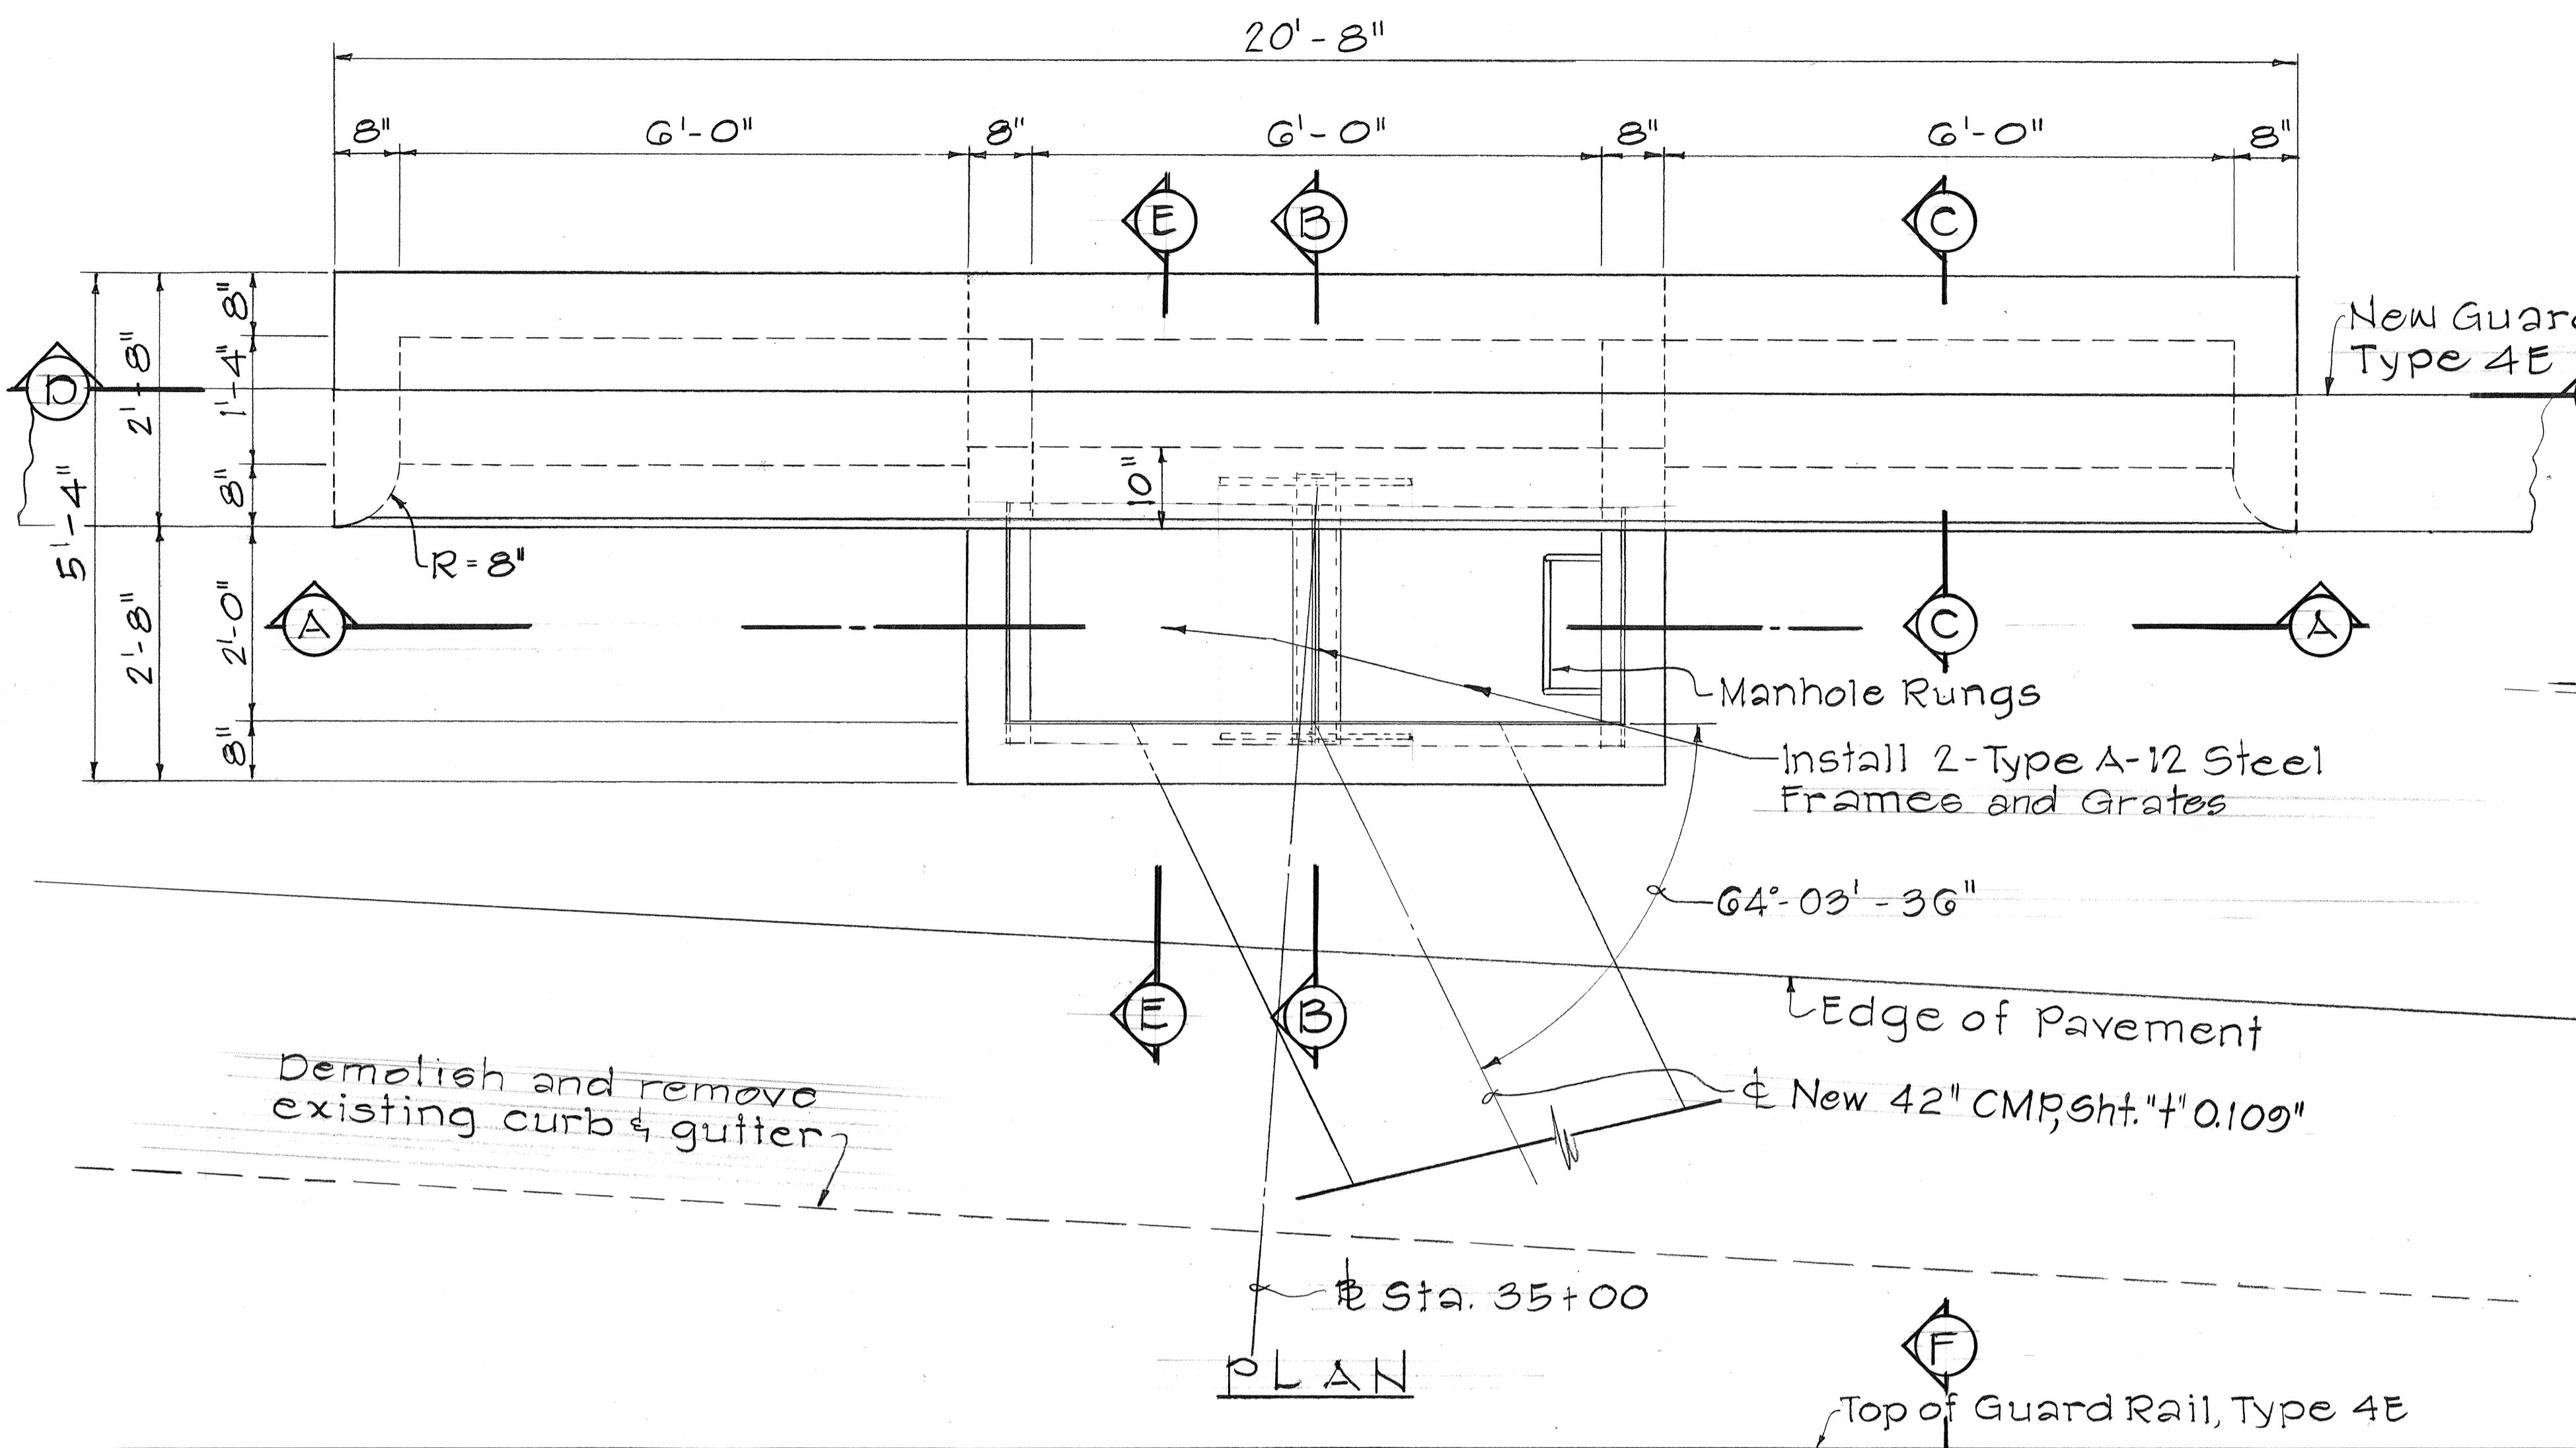

DETAILS OF TYPE T GRATED DROP INTAKE AT B STA. 35+00 RT.

Scale: 3/4" = 1'-0"

SECTION "C-C"

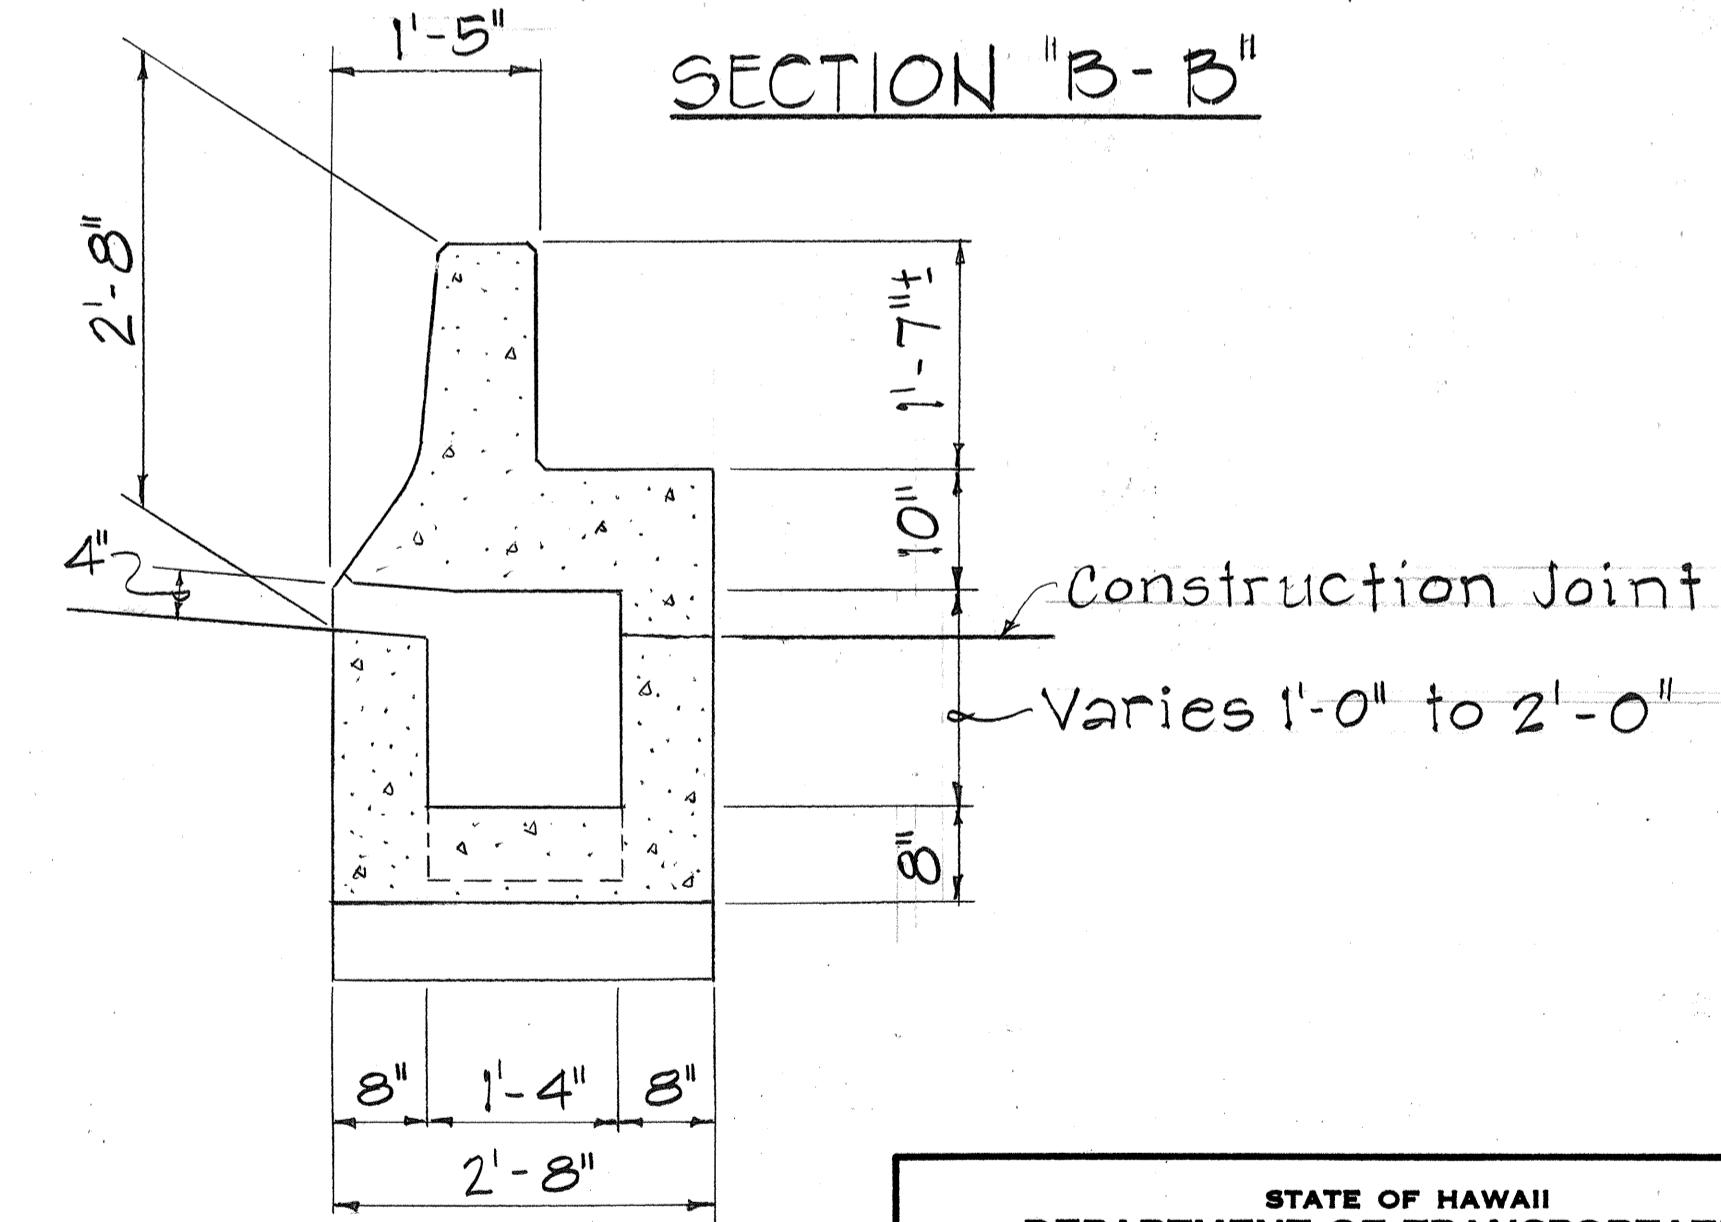

STATE OF HAWAII
DEPARTMENT OF TRANSPORTATION
HIGHWAYS DIVISION




DRAINAGE DETAILS

INTERSTATE H-I IMPROVEMENTS
MIDDLE STREET TO KALIHI INTERCHANGE
EASTBOUND LANES
F.A.I. PROJECT NO. I-HI-1(178)


SCALE: AS NOTED

SHEET NO. 16 OF 33 SHEETS

FED. ROAD DIST. NO.	STATE	FED. AID PROJ. NO.	FISCAL YEAR	SHEET NO.	TOTAL SHEETS
HAWAII	HAW.	I-HI-1(178)	1982	49	165

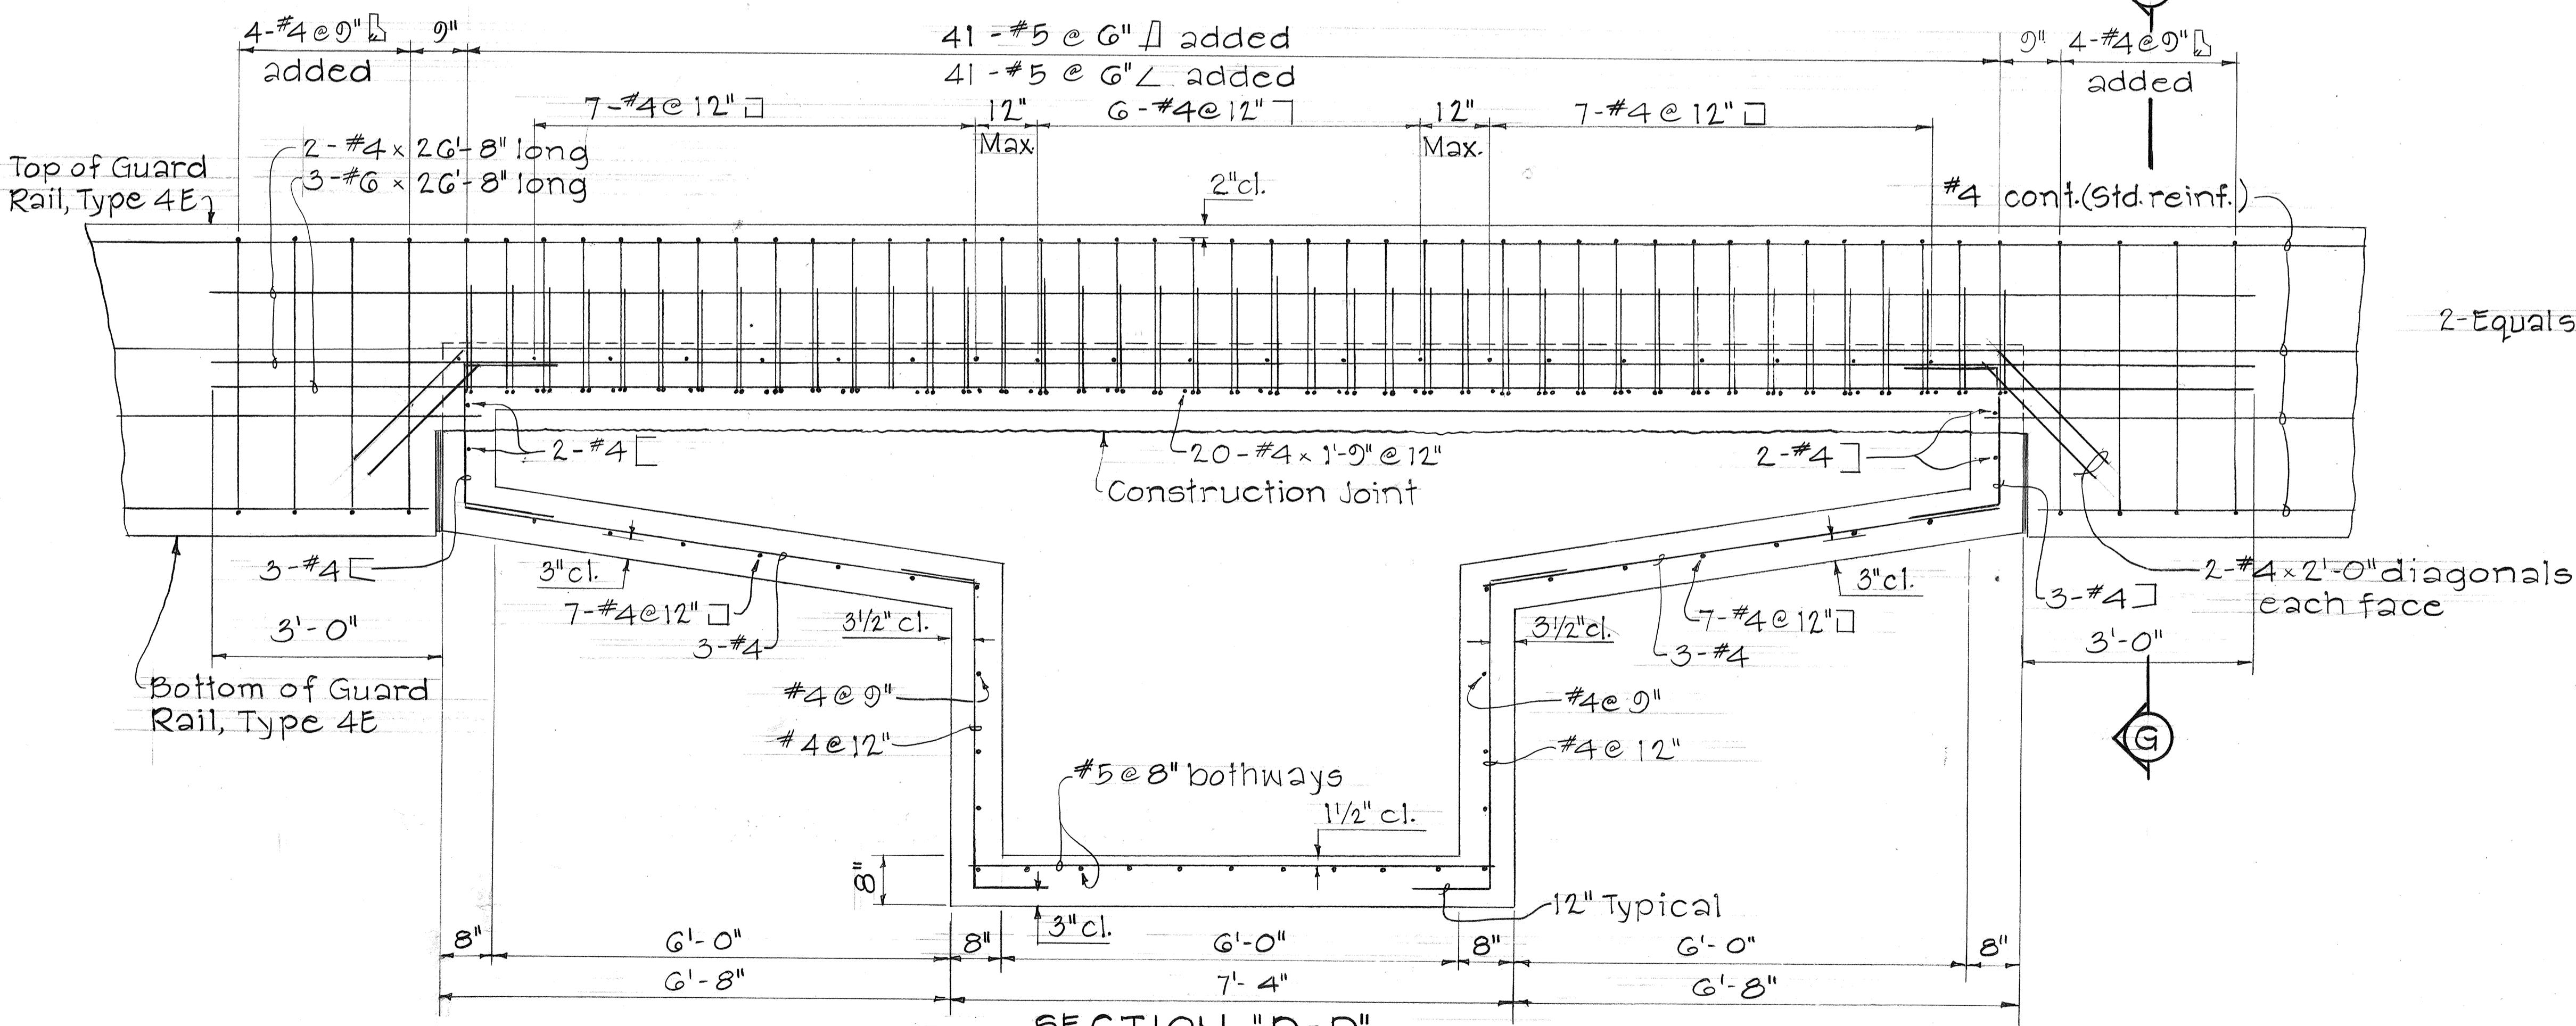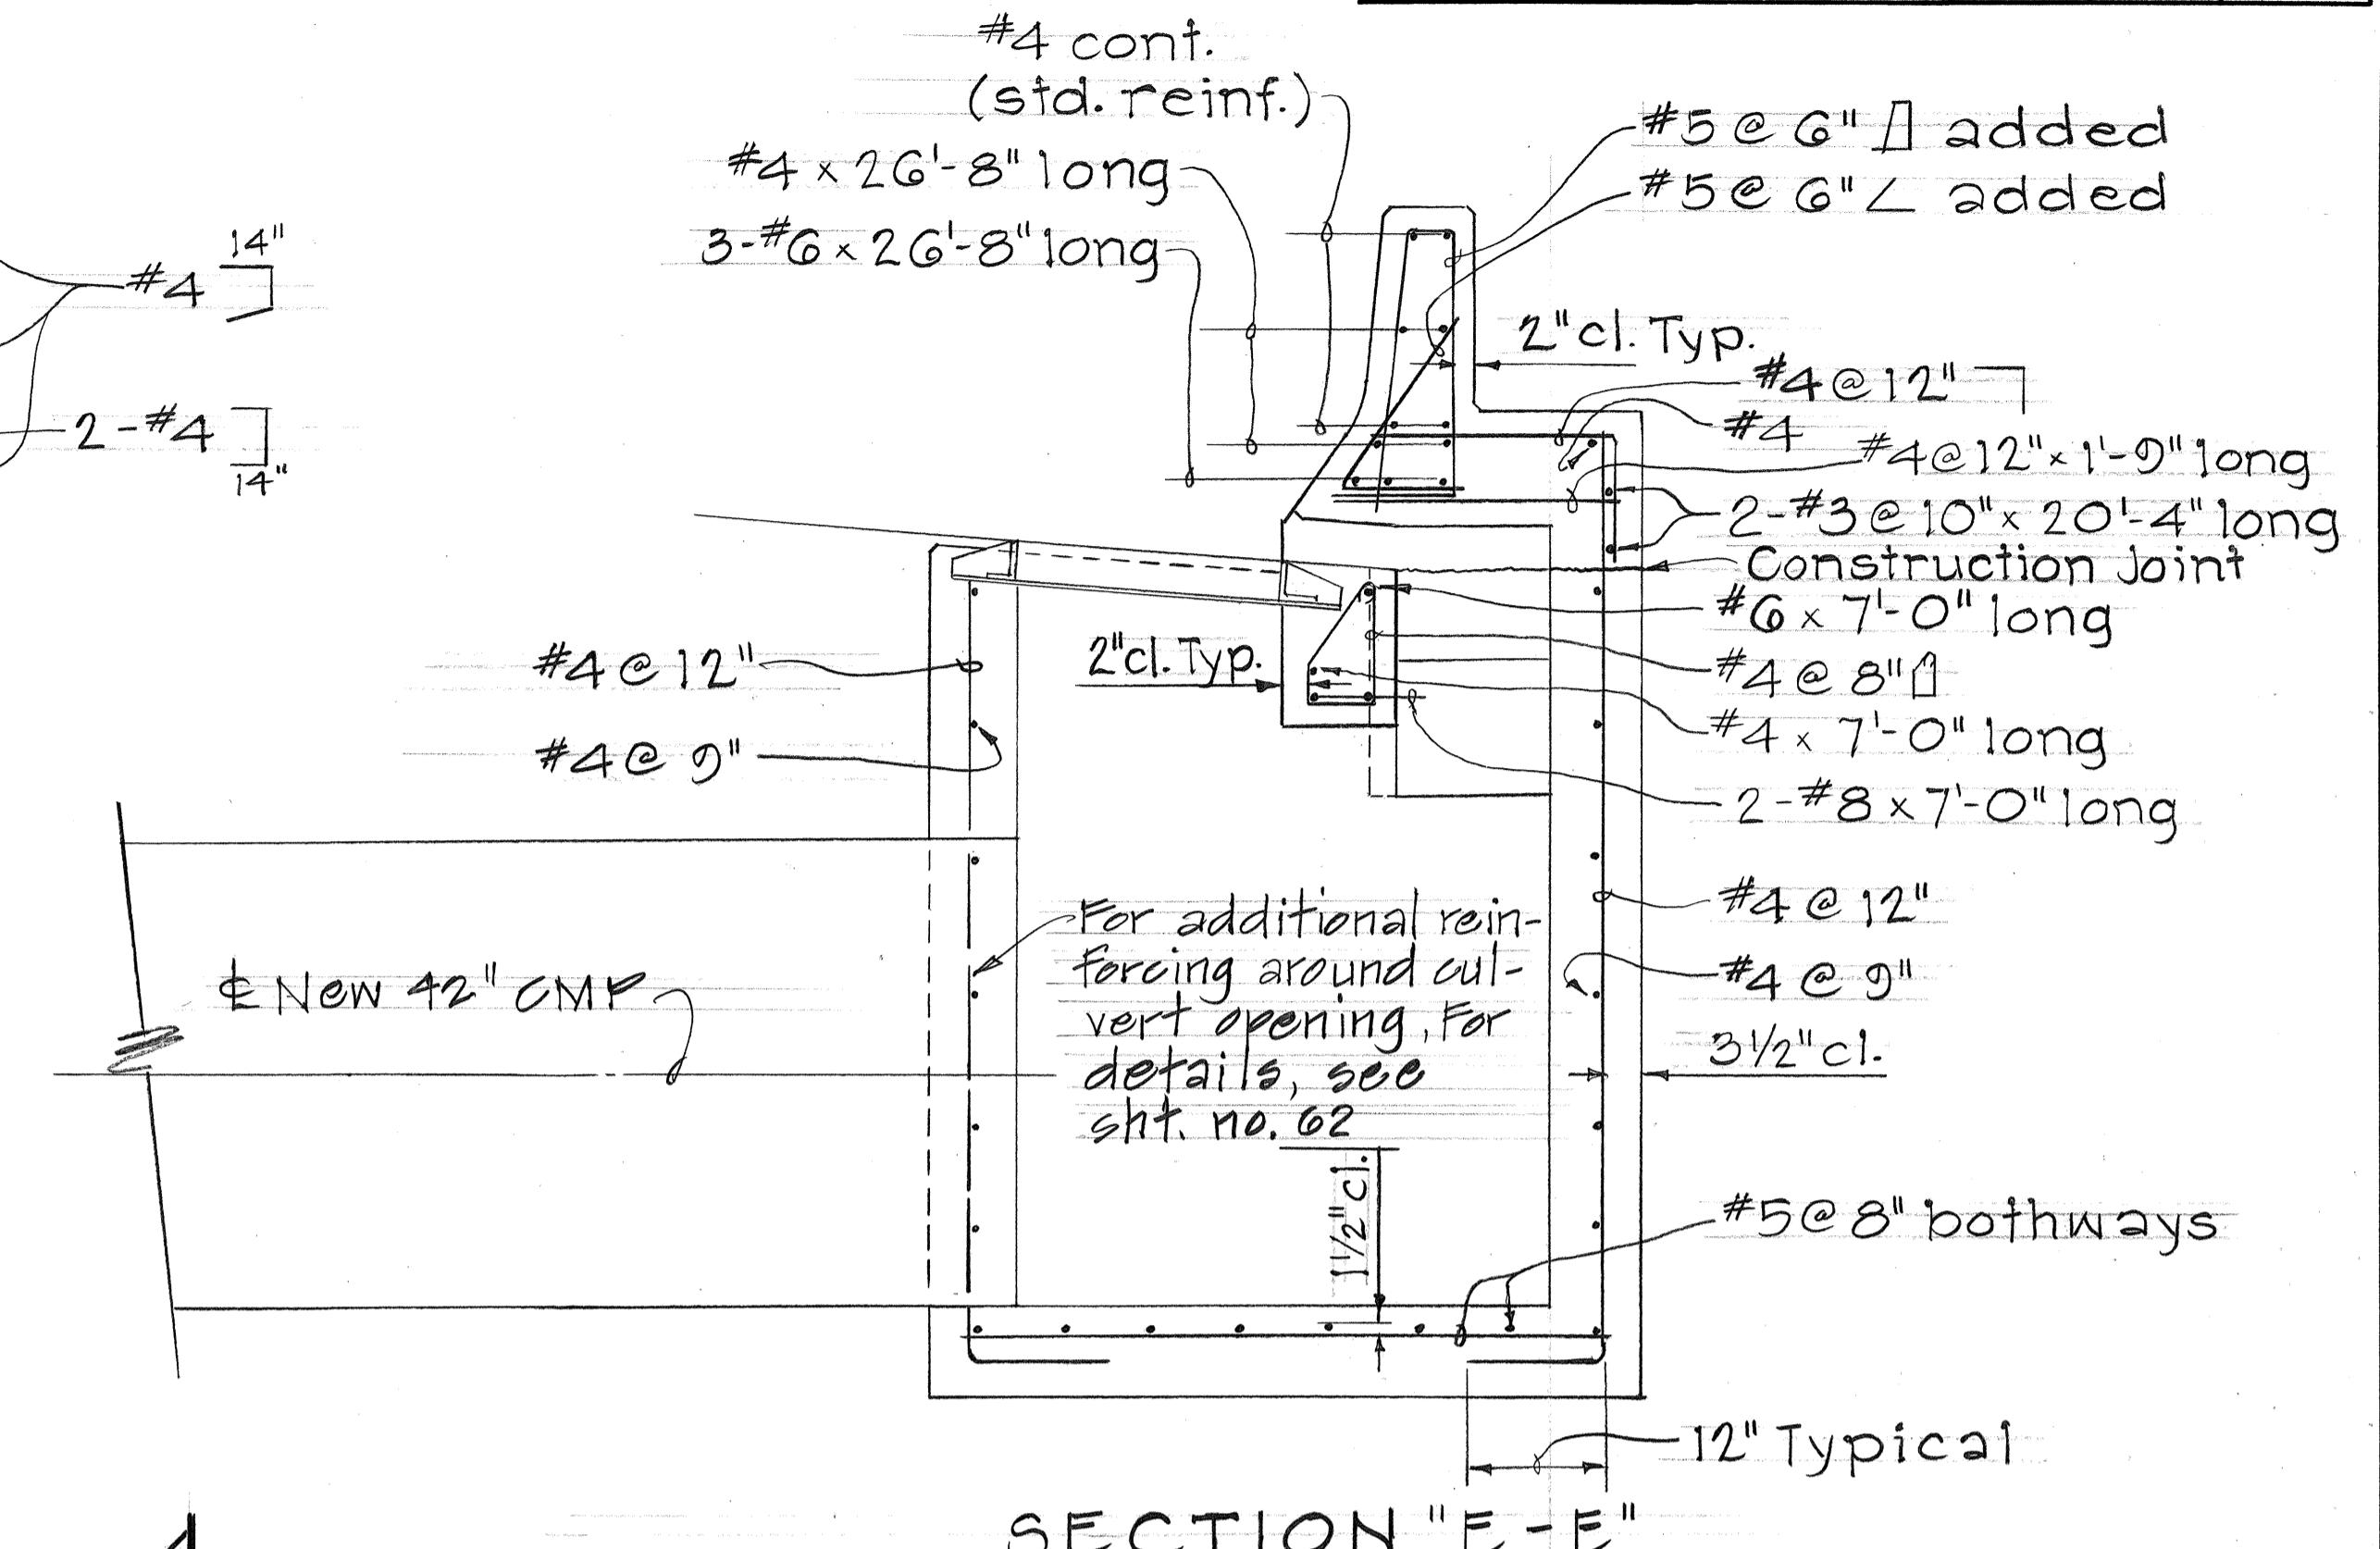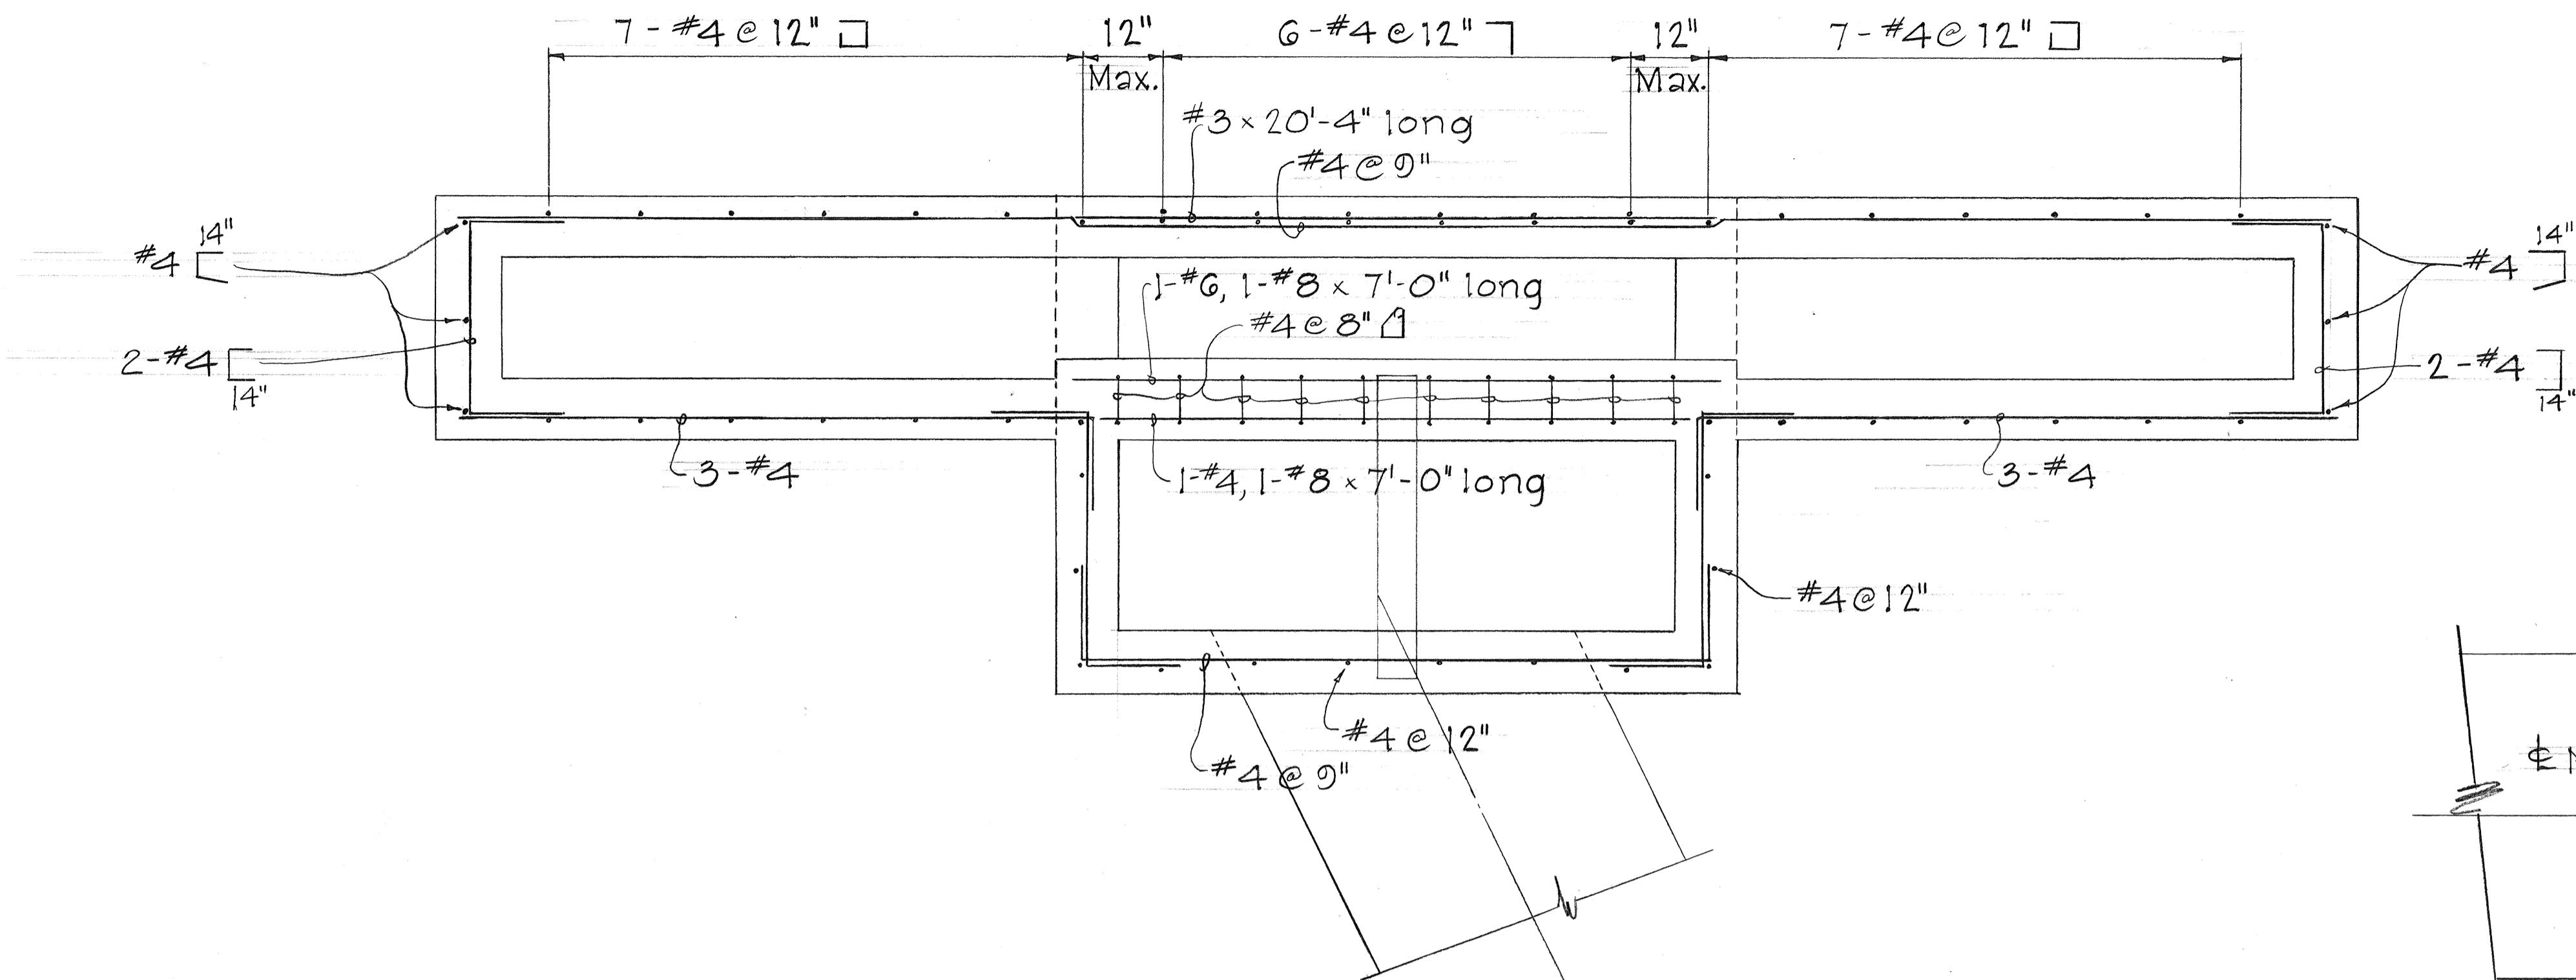


DETAILS OF TYPE T GRATED DROP INTAKE AT STA. 35+00 RT.
Scale: 3/4" = 1'-0"

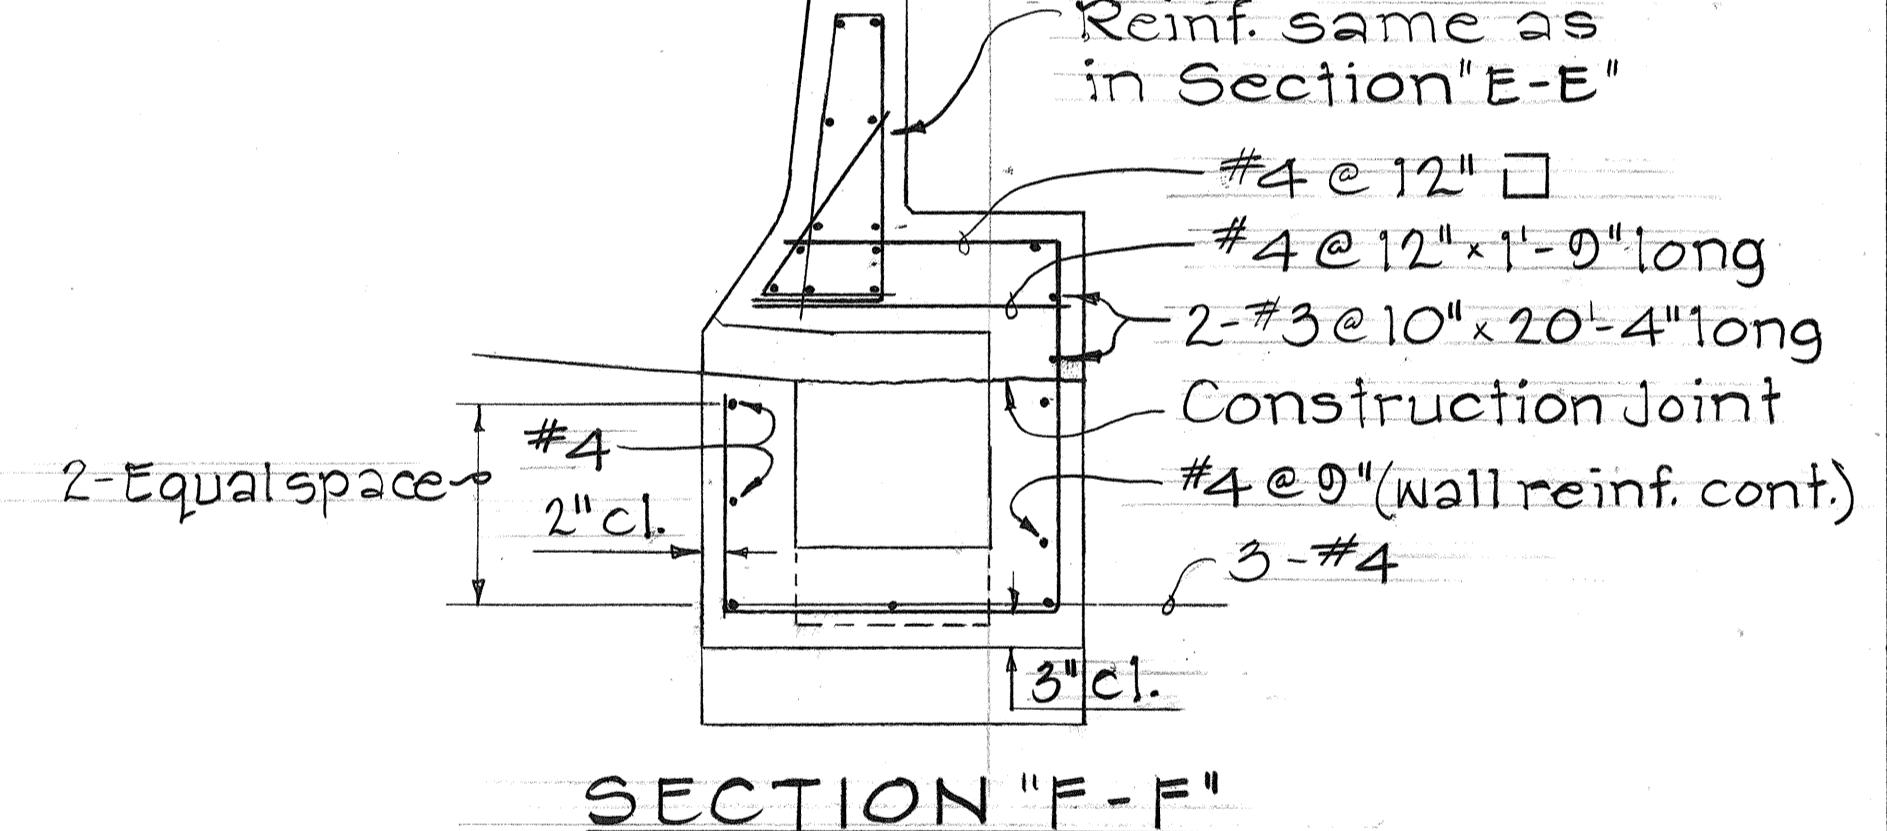


STATE OF HAWAII
DEPARTMENT OF TRANSPORTATION
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DRAINAGE DETAILS
INTERSTATE H-I IMPROVEMENTS
MIDDLE STREET TO KALIHI INTERCHANGE
EASTBOUND LANES
F.A.I. PROJECT NO. I-HI-1(178)
SCALE: AS NOTED
SHEET NO. 17 OF 33 SHEETS

FED. ROAD DIST. NO.	STATE	FED. AID PROJ. NO.	FISCAL YEAR	HEET NO.	TOTAL SHEETS
HAWAII	HAW.	I-HI-1(178)	1982	50	105

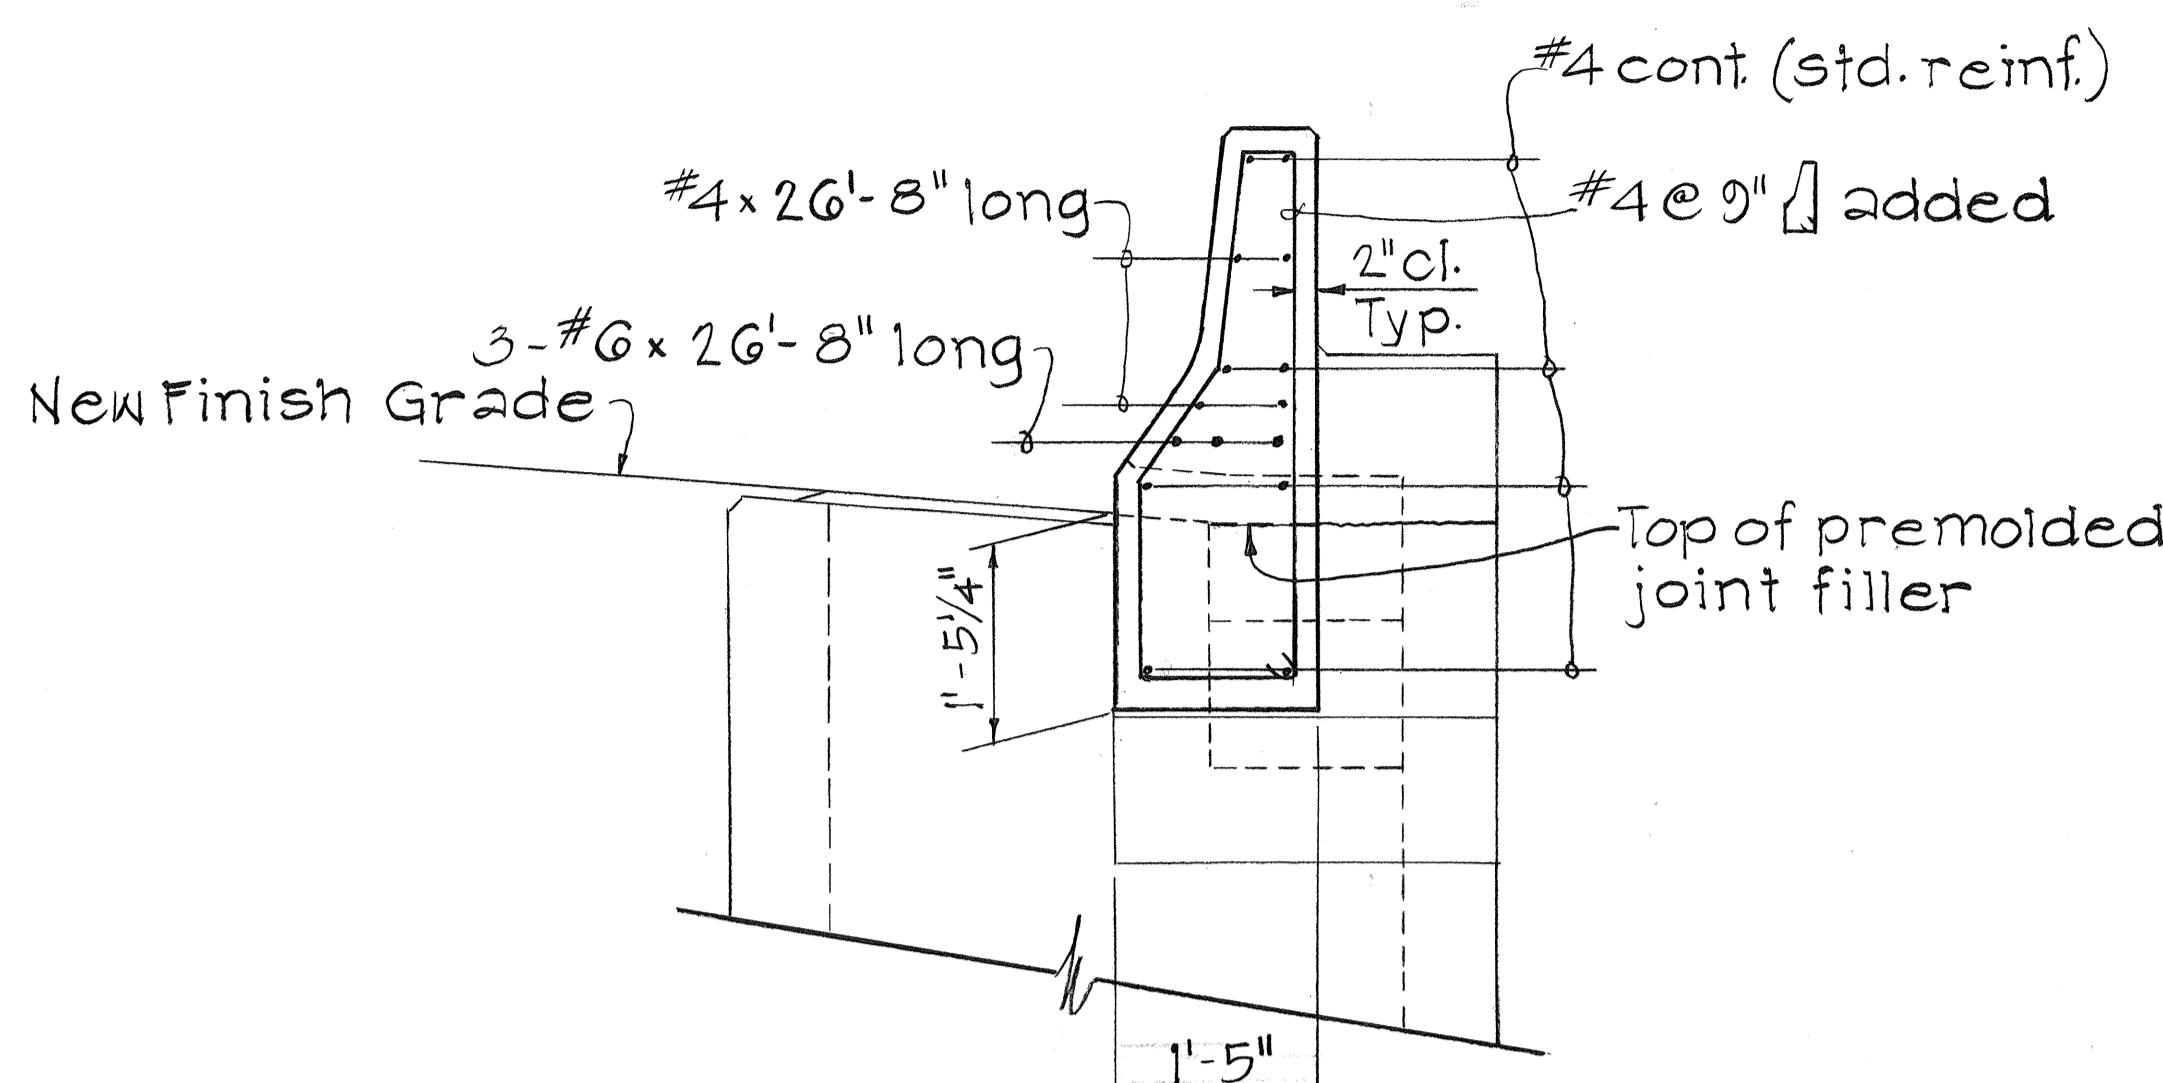


SECTION "G-G"

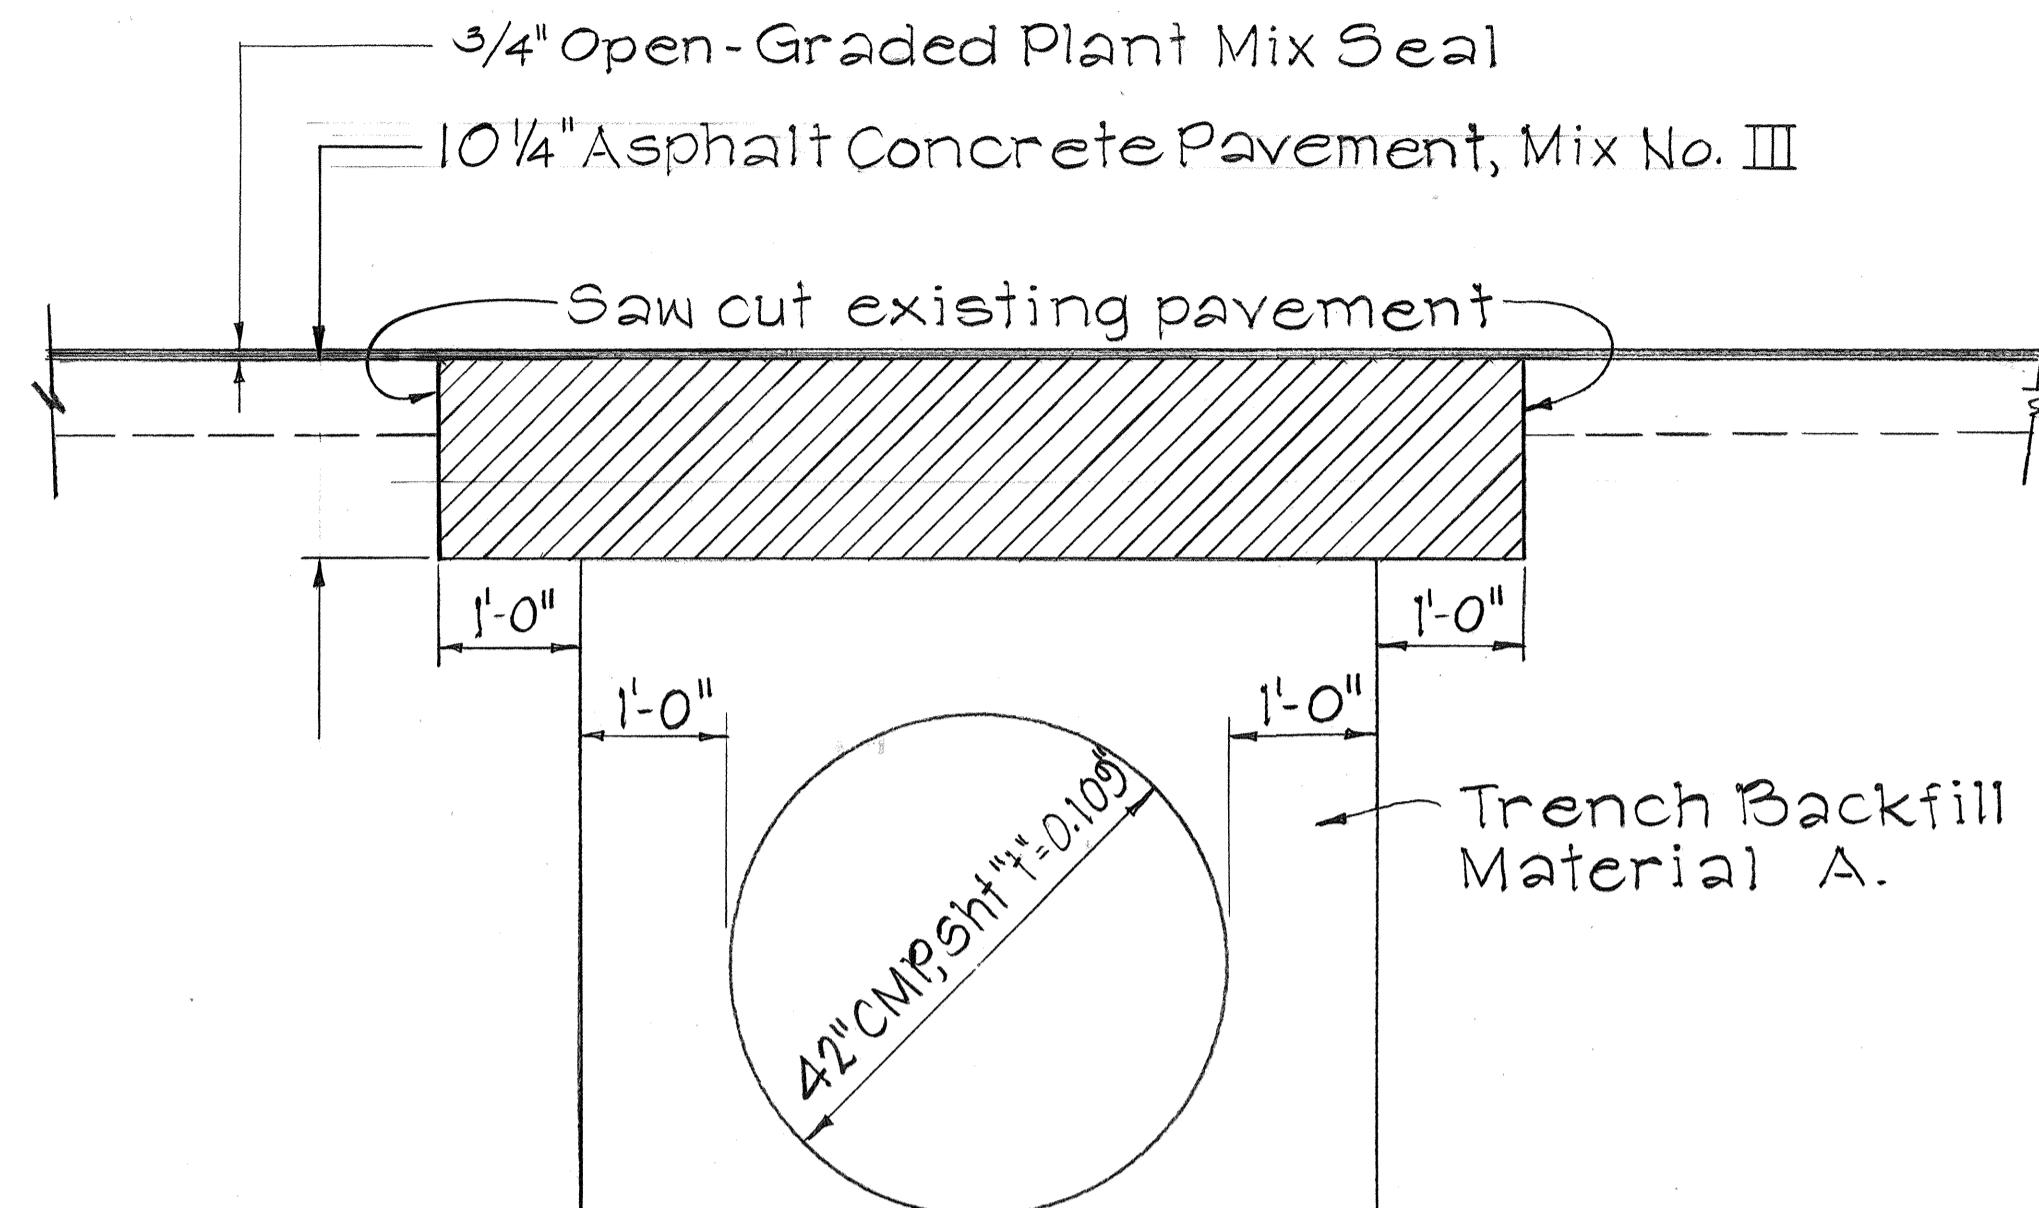


NOTE:

The materials and construction requirements for pavement restoration shall conform to the applicable sections of the Standard Specifications. Payment for pavement restoration and other improvements shall be considered incidental to the various contract items.

TRENCH DETAIL FOR 42" CULVERT

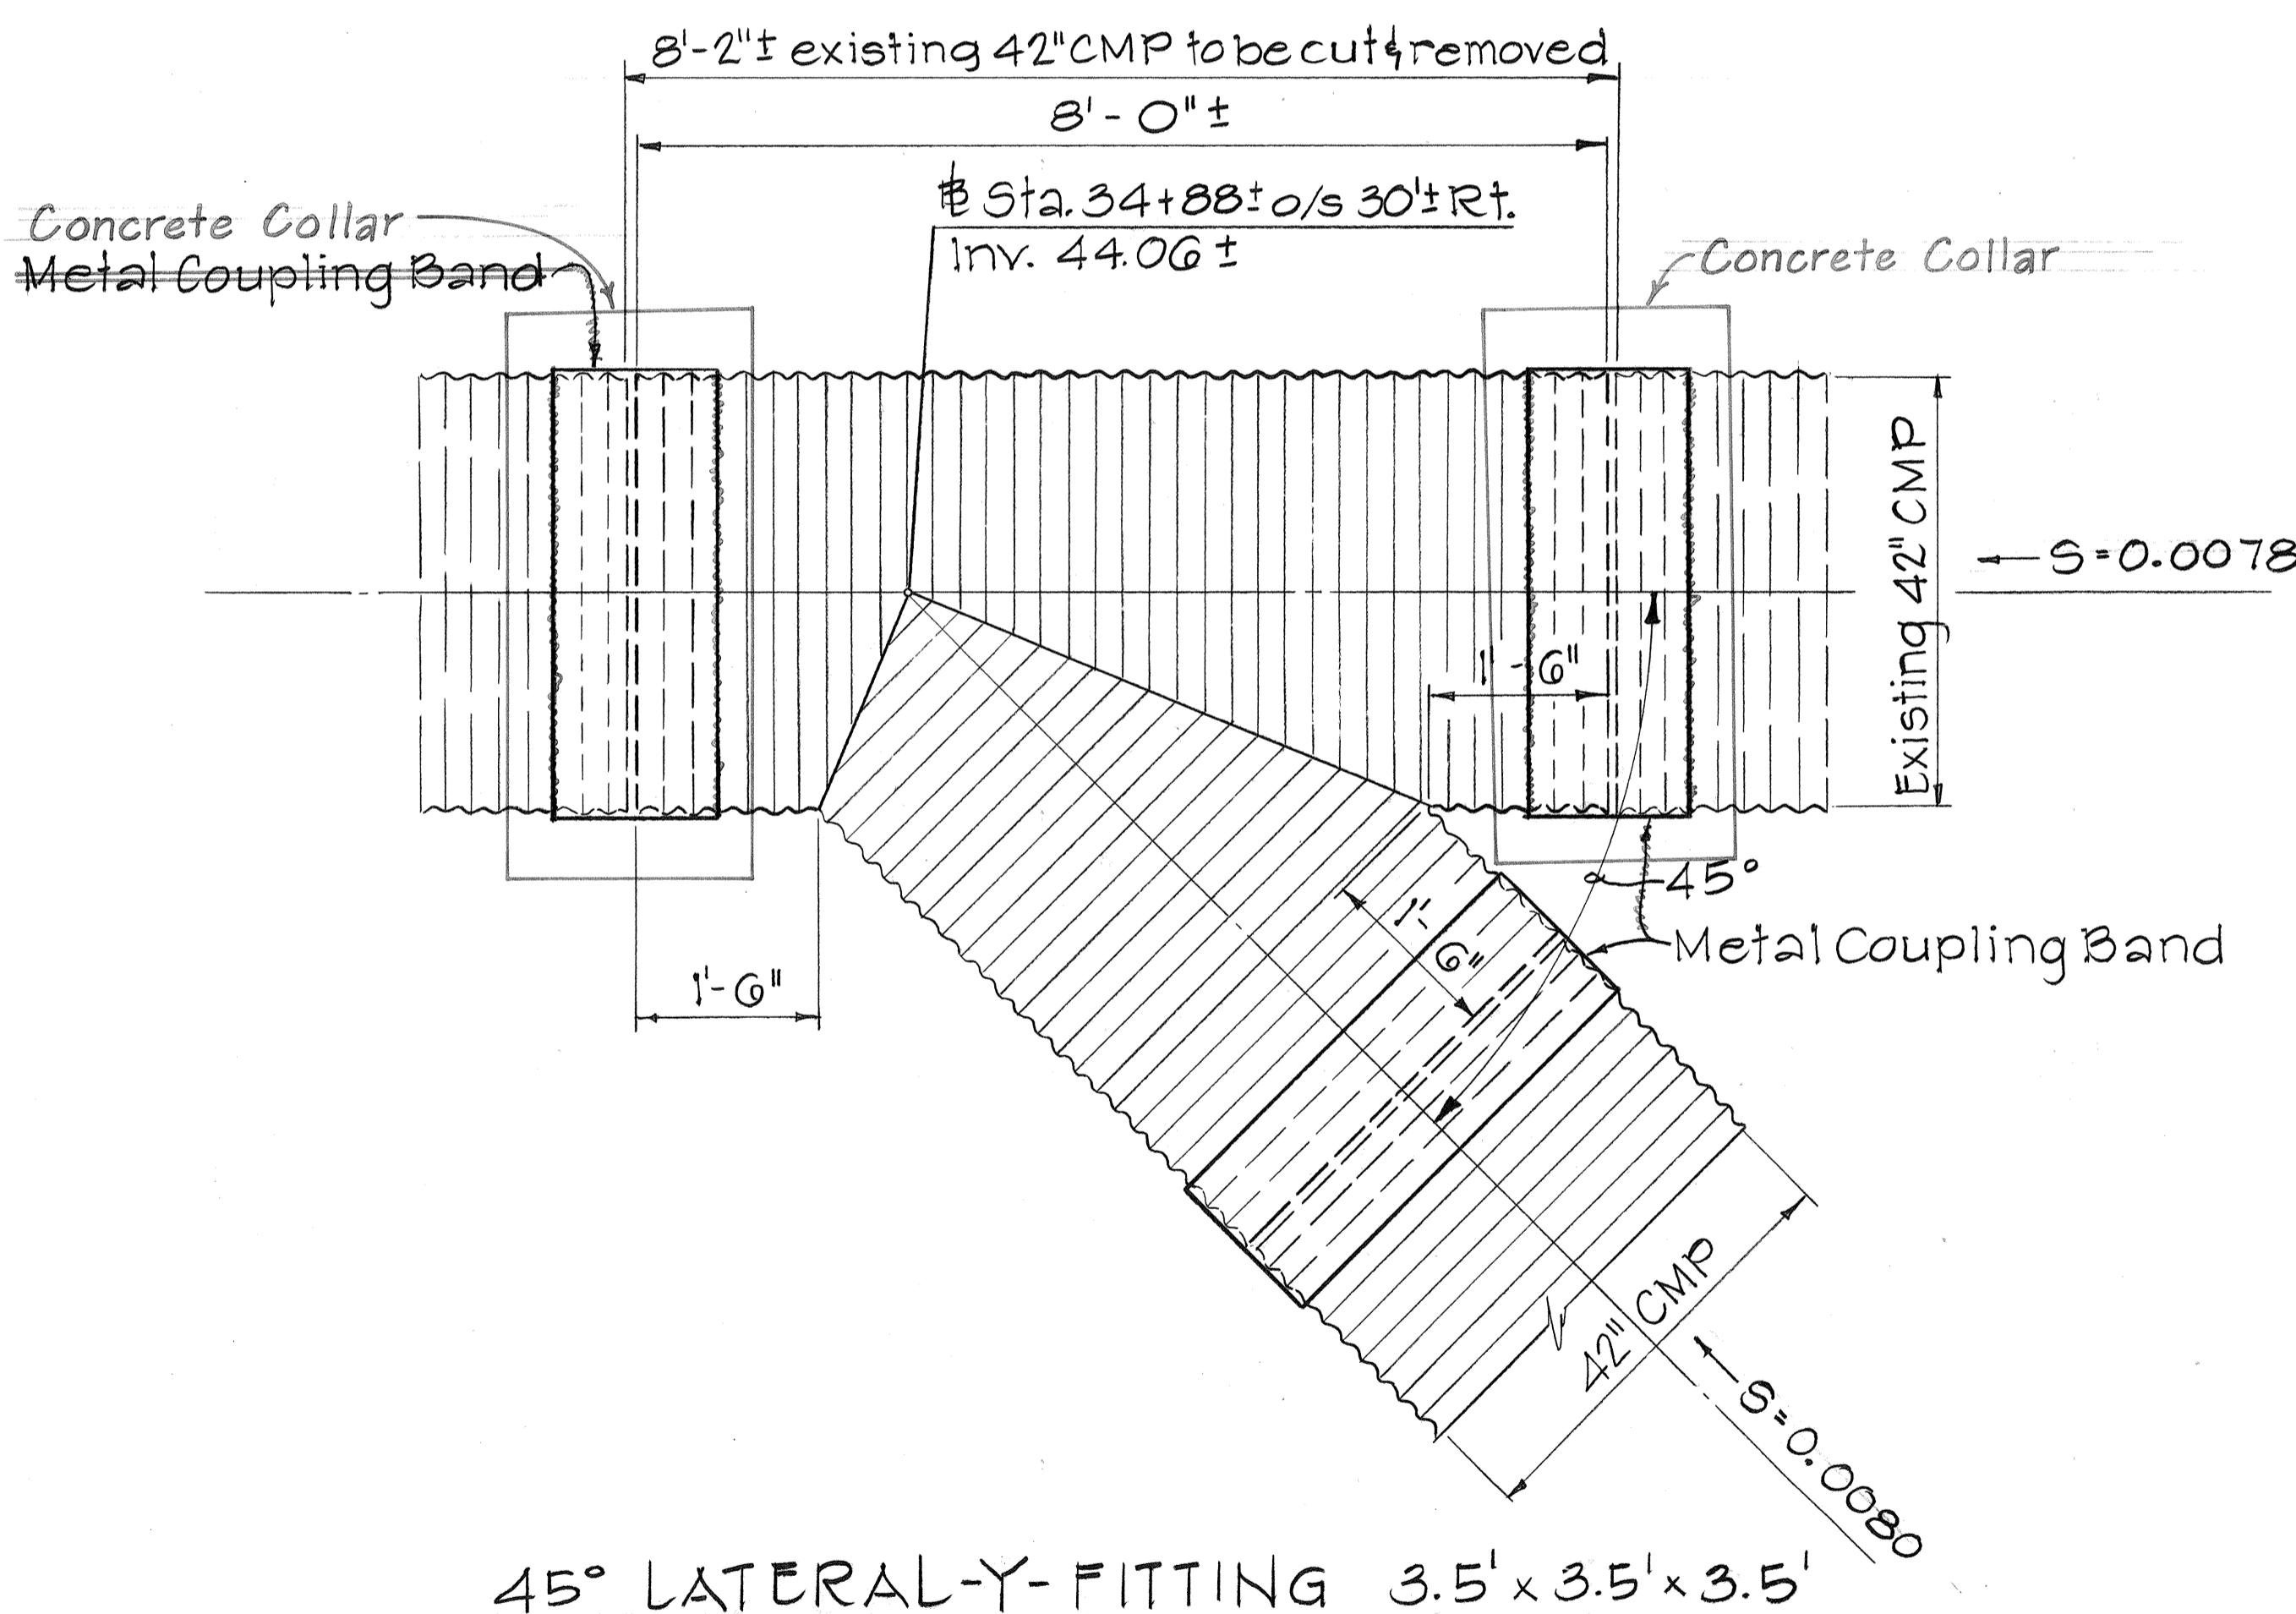

45° LATERAL-Y-FITTING 3.5' x 3.5' x 3.5'

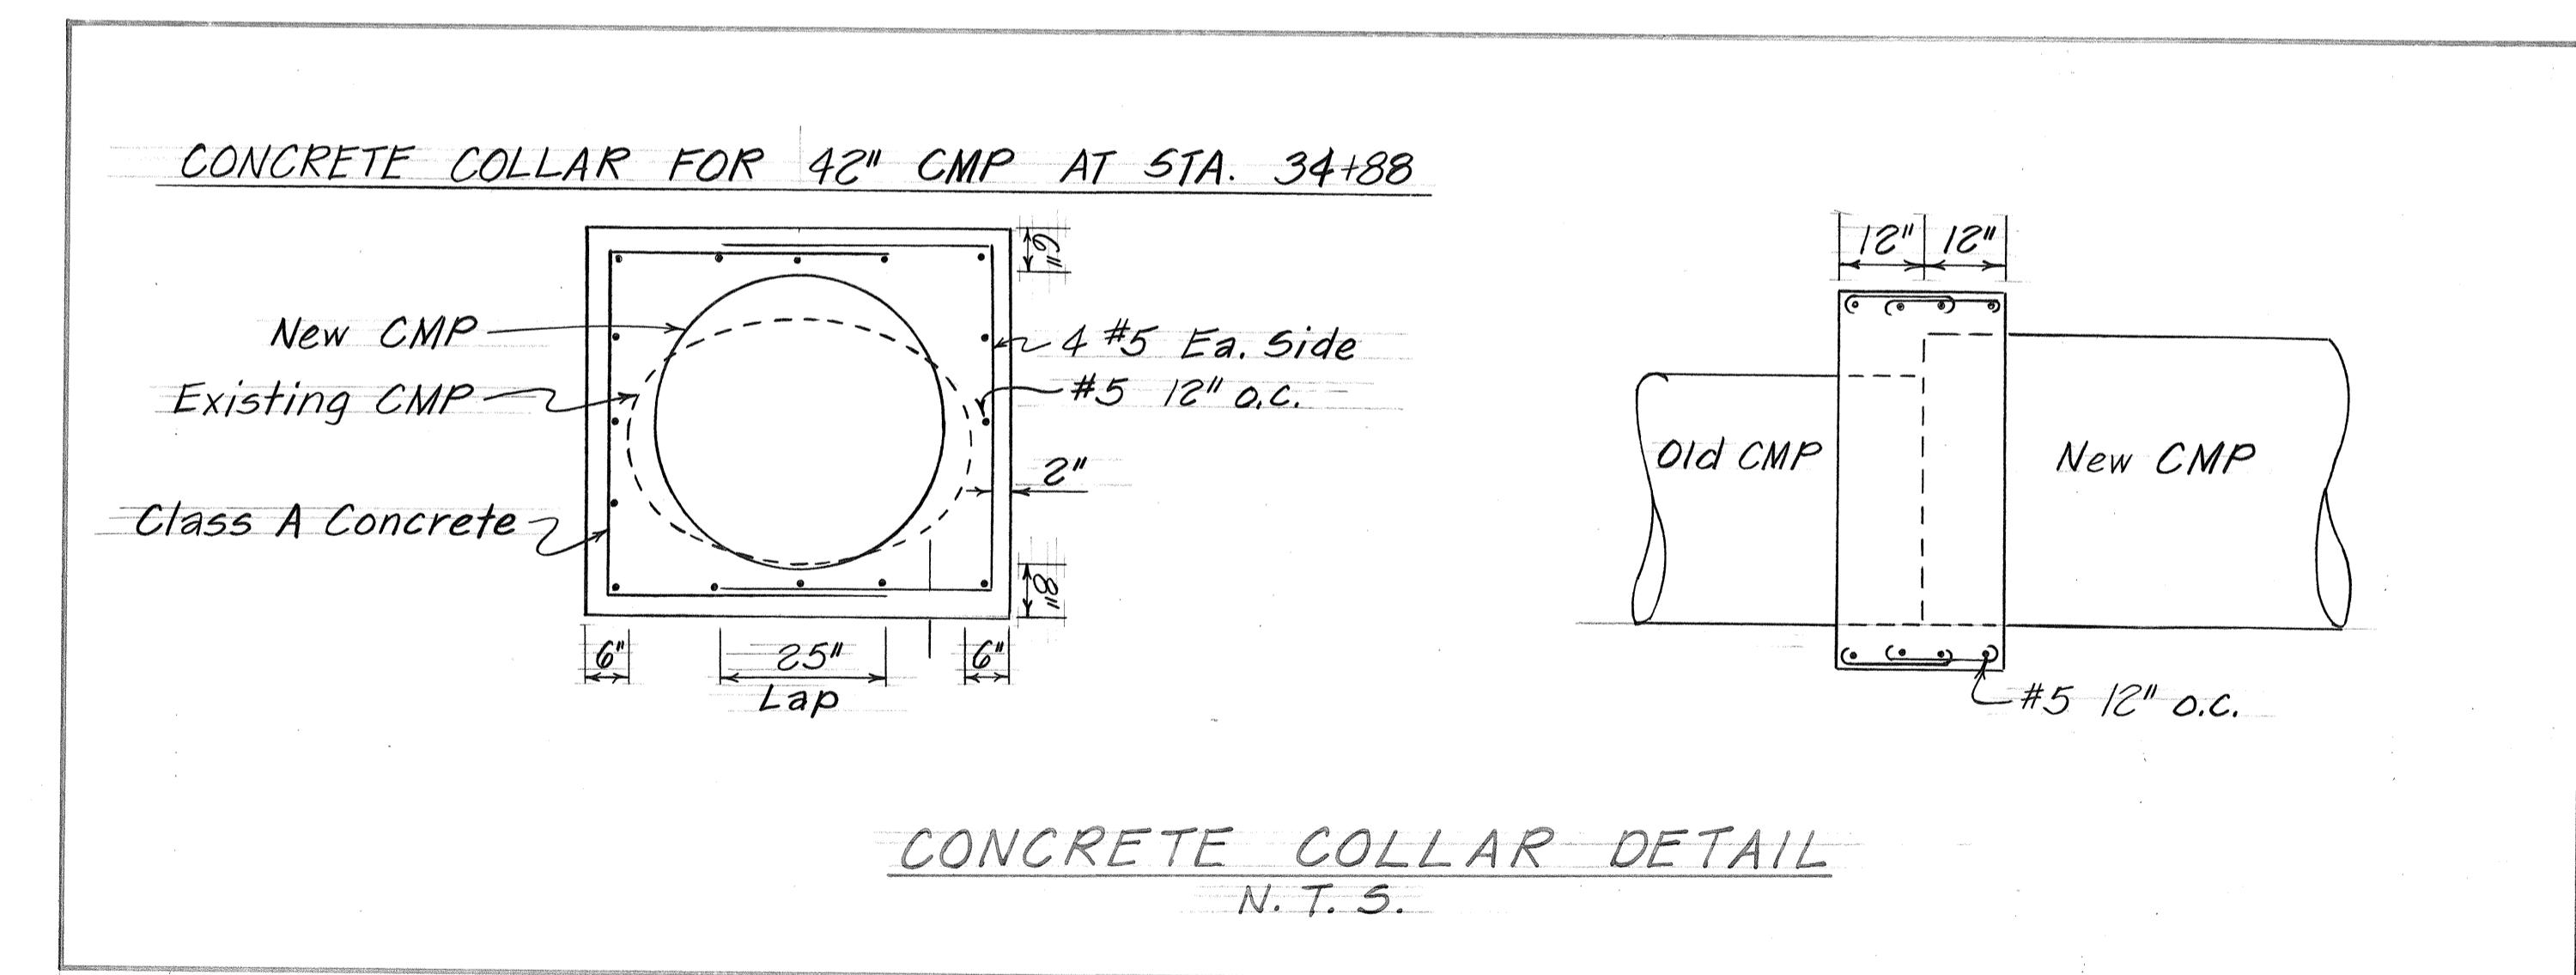

CONCRETE COLLAR DETAIL
N.T.S.

DETAILS OF TYPE T GRATED DROP INTAKE AT STA. 35+00 RT.

Scale: 3/4" = 1' - 0"

STATE OF HAWAII
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MIDDLE STREET TO KALIHI INTERCHANGE
EASTBOUND LANES
F.A.I. PROJECT NO. I-HI-1(178)
SCALE: AS NOTED
SHEET NO. 18 OF 33 SHEETS

FED. ROAD DIST. NO.	STATE	FED. AID PROJ. NO.	FISCAL YEAR	SHEET NO.	TOTAL SHEETS
HAWAII	HAW.	I-HI-1(178)	1982	51	165

& Type "P" C.I. Frame and Cover

Existing Abutment Face

Mortar

New Construction



Varies see below

Existing to remain

Conform to slope

Mortar

New Finish Grade

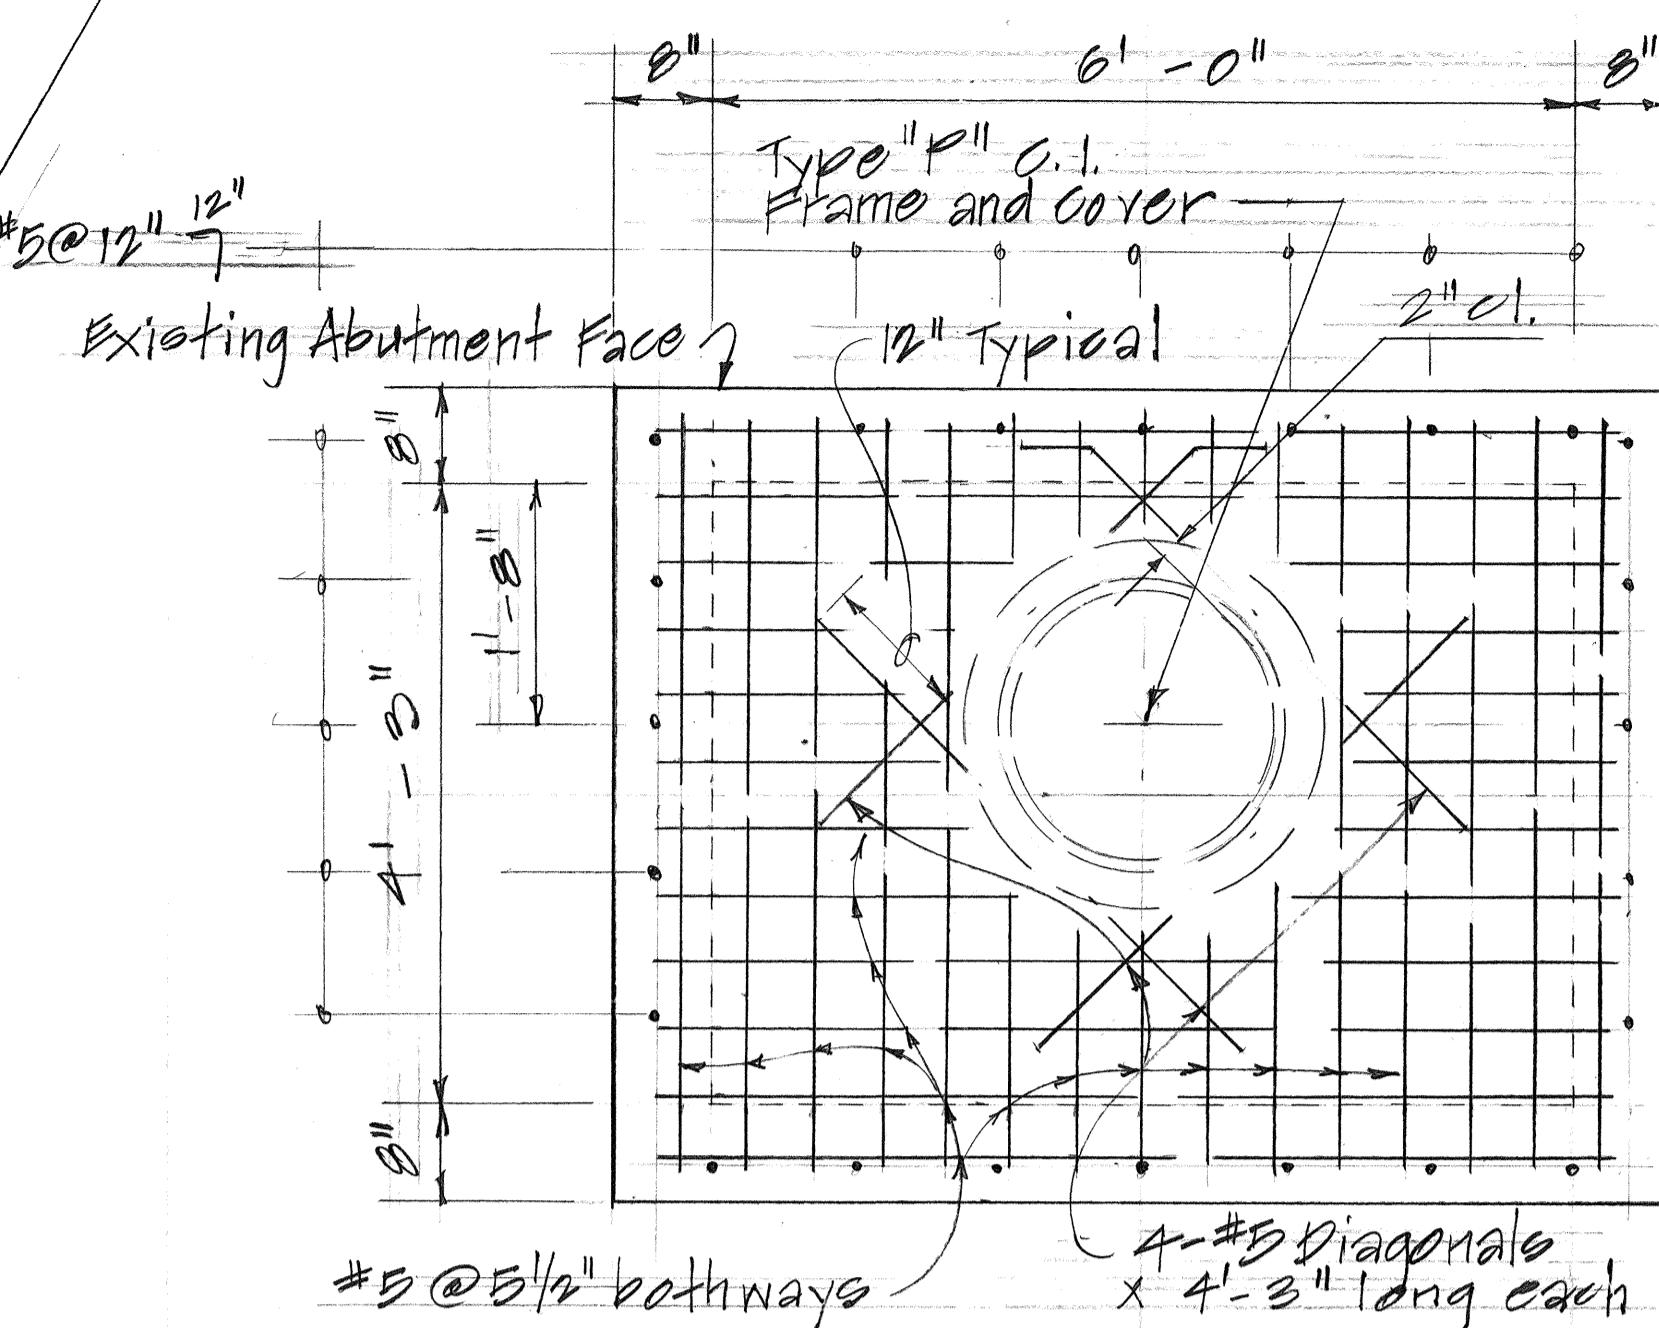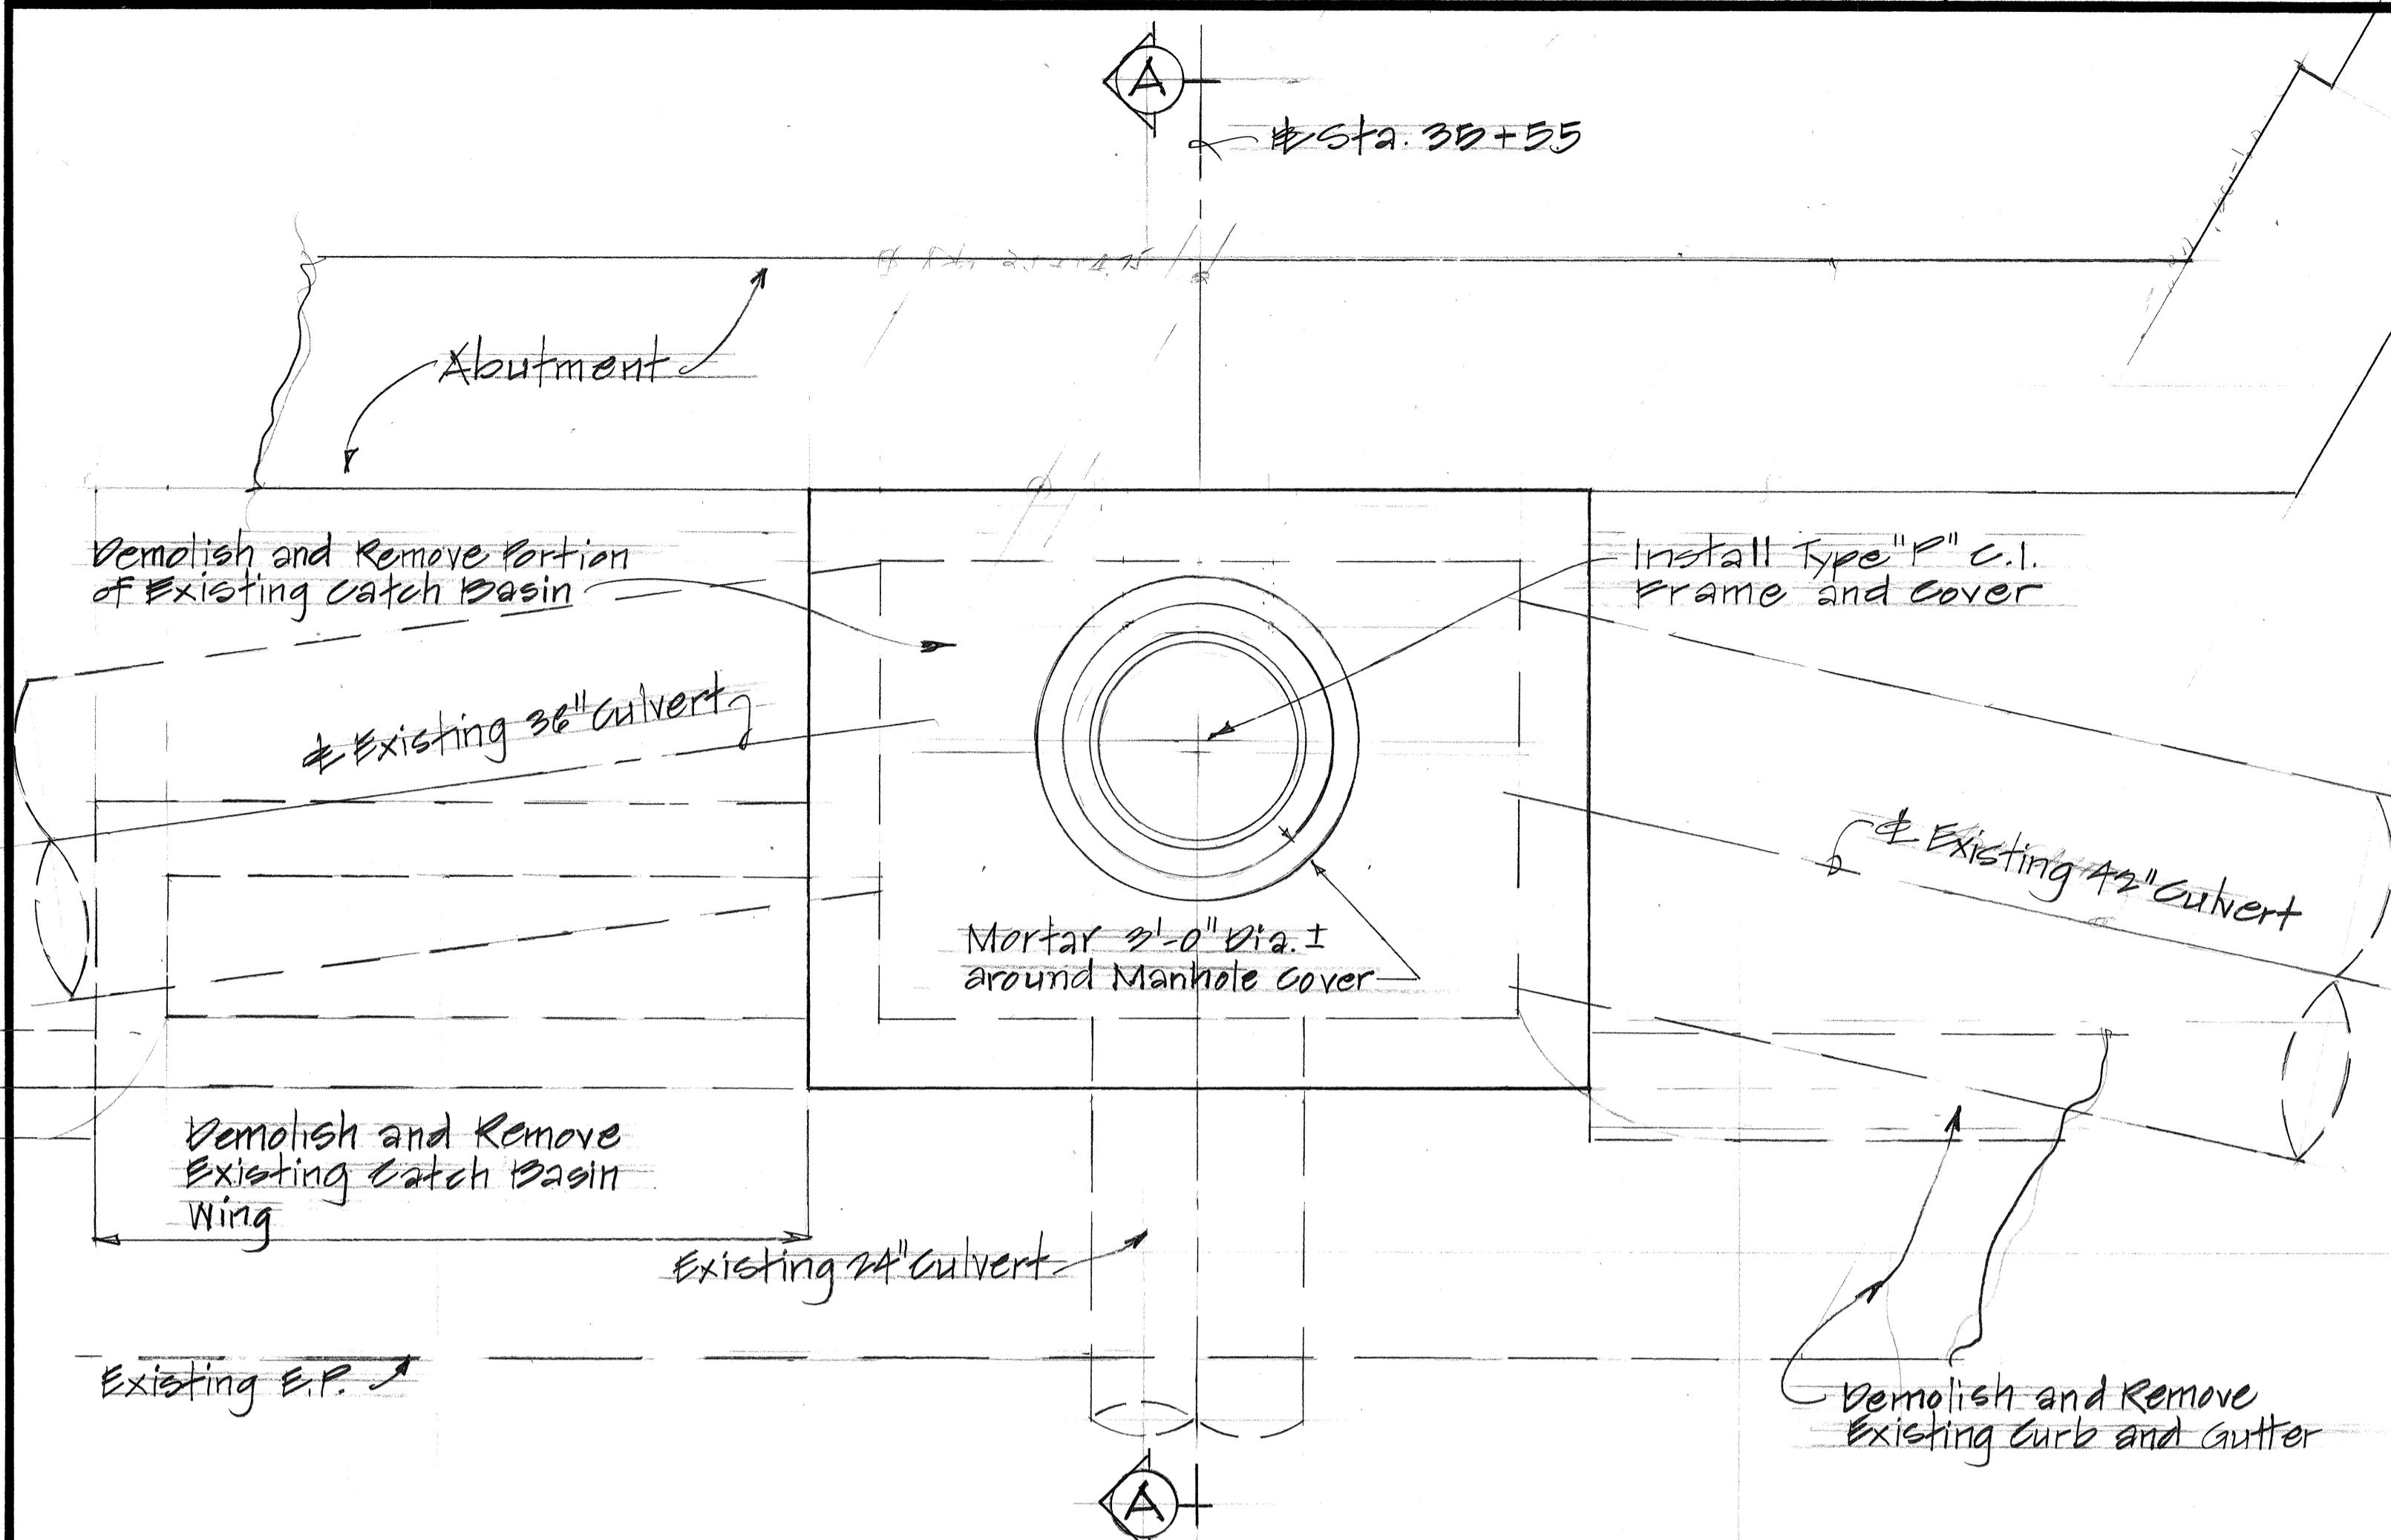


TOP SLAB REINFORCEMENT

scale: 3/4" = 1'-0"

PARTIAL SECTION VIEW

(SHOWING MODIFICATIONS)


scale: 1" = 1'-0"

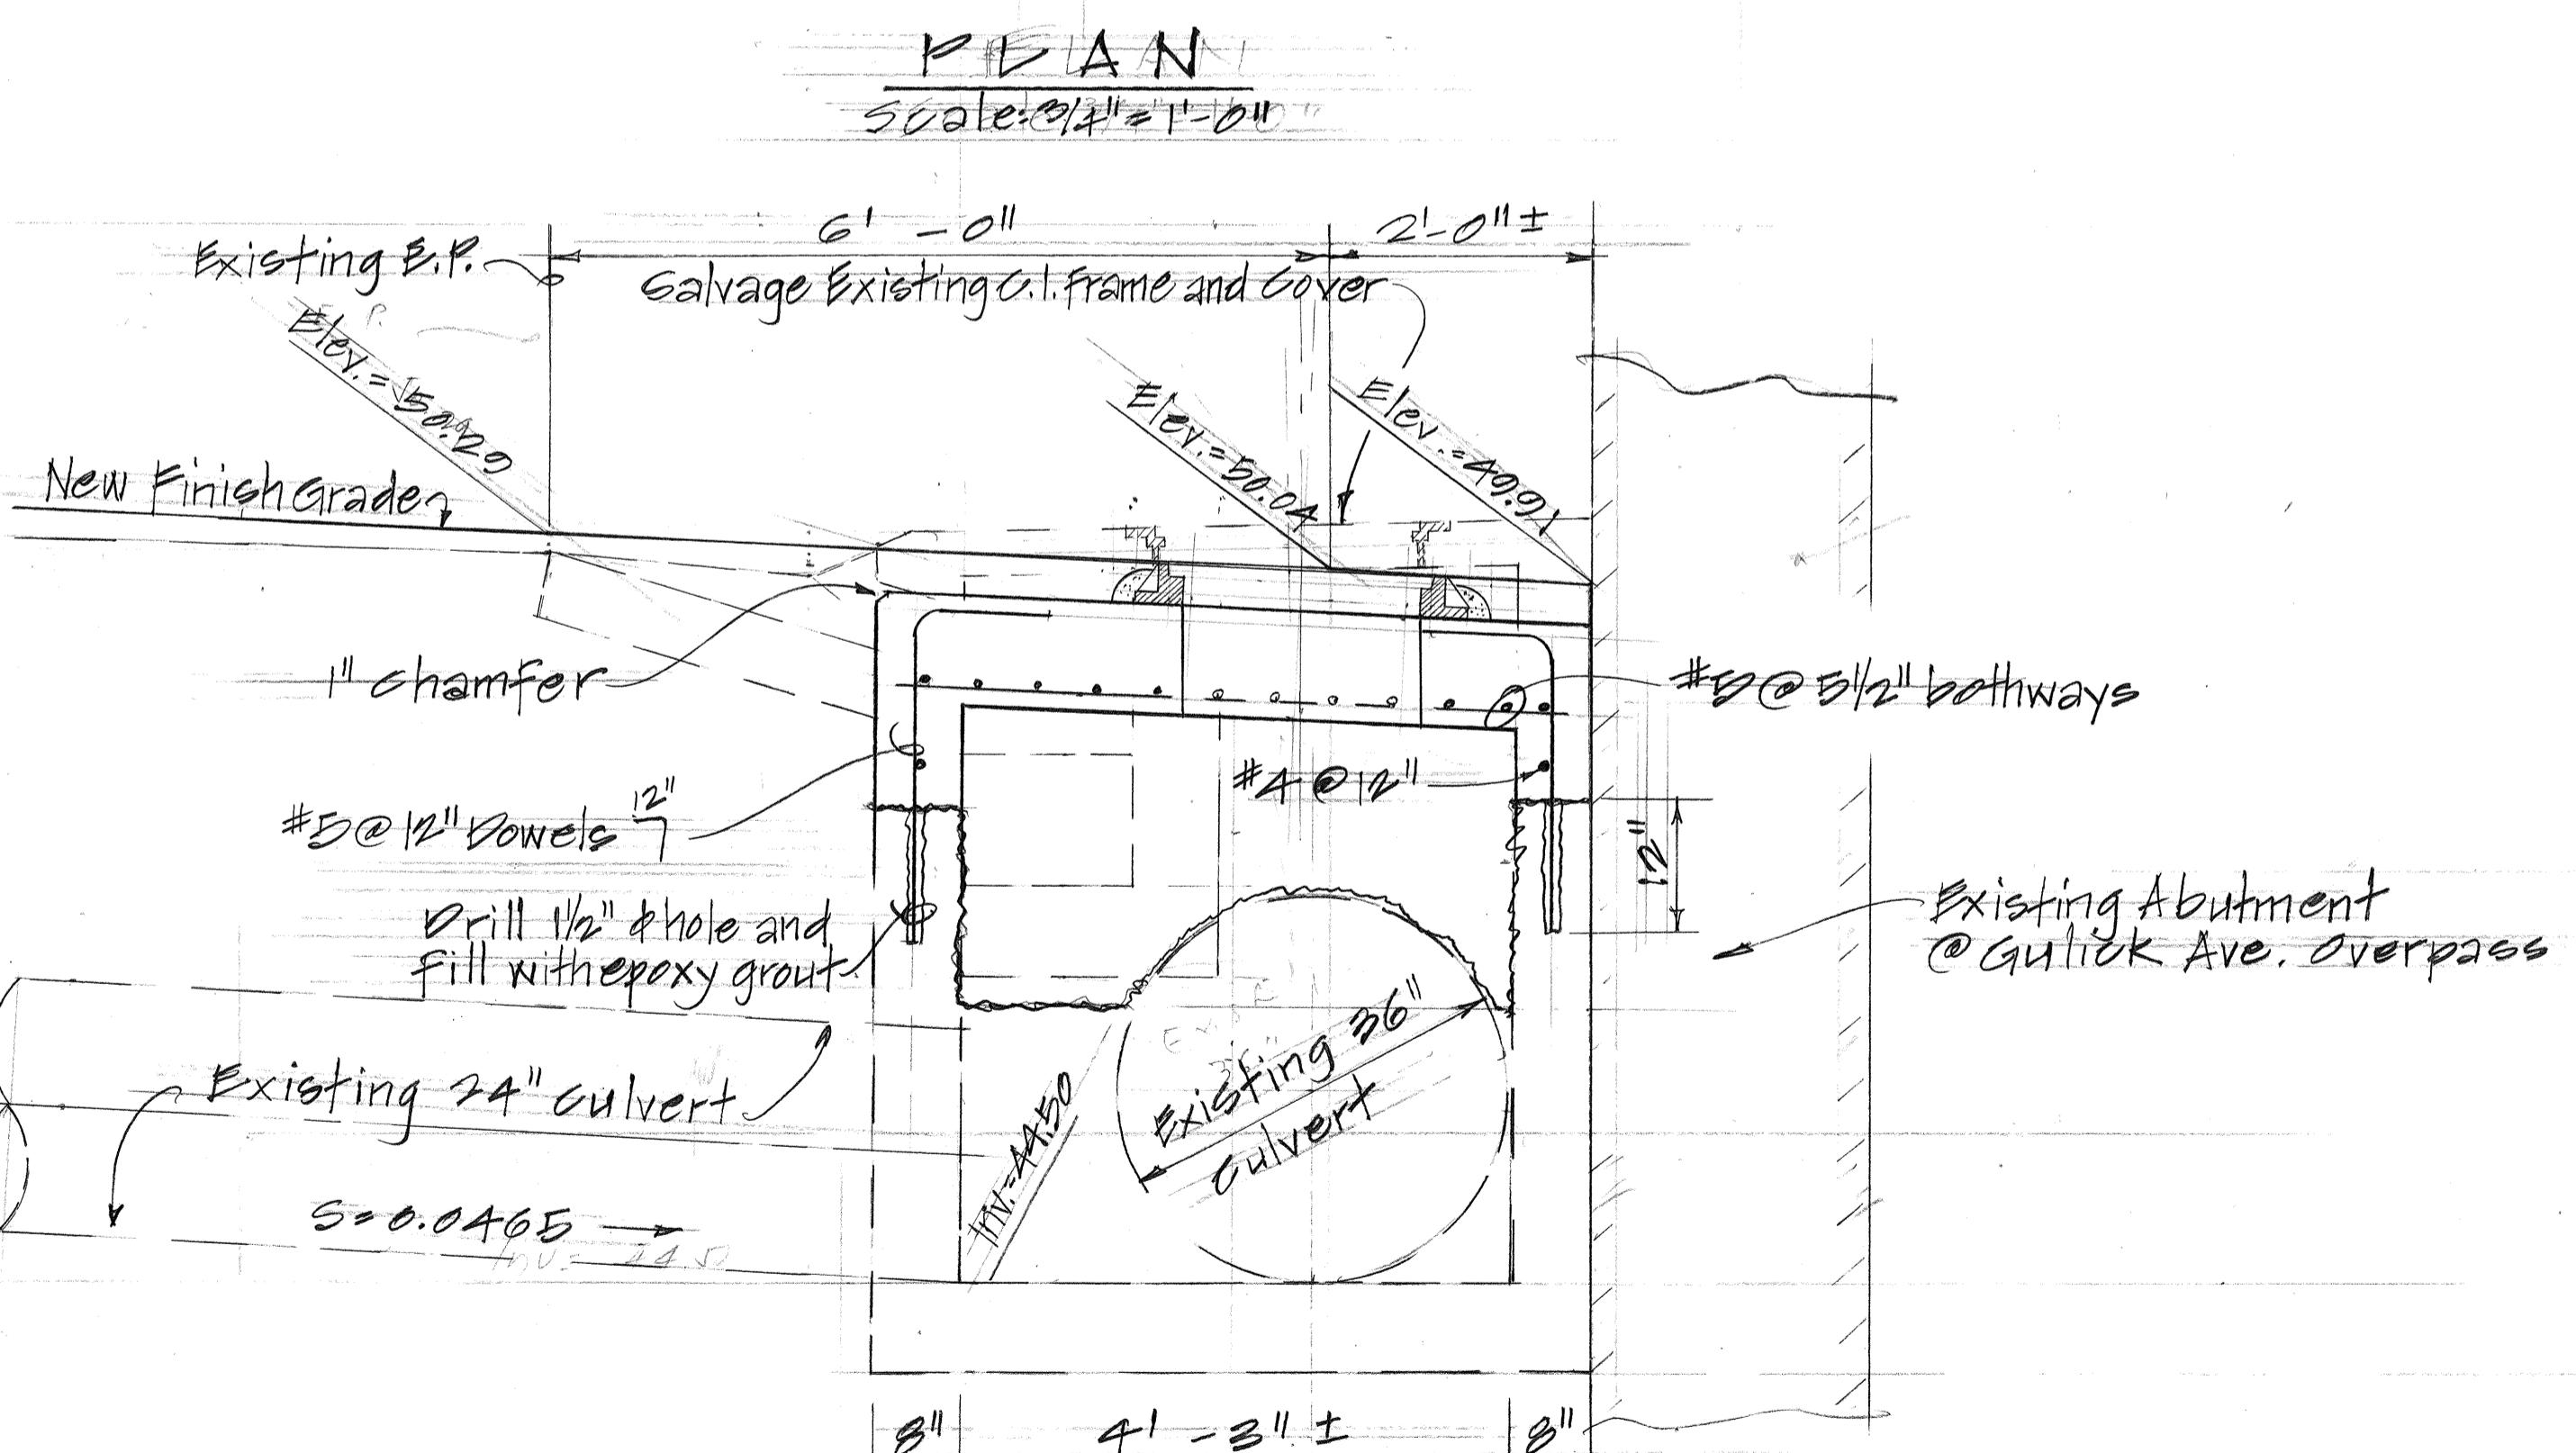

SECTION A - A


Scale: 3/4" = 1'-0"

DETAILS OF TYPE Y STORM DRAIN MANHOLE AT STA. 35+55 RT.



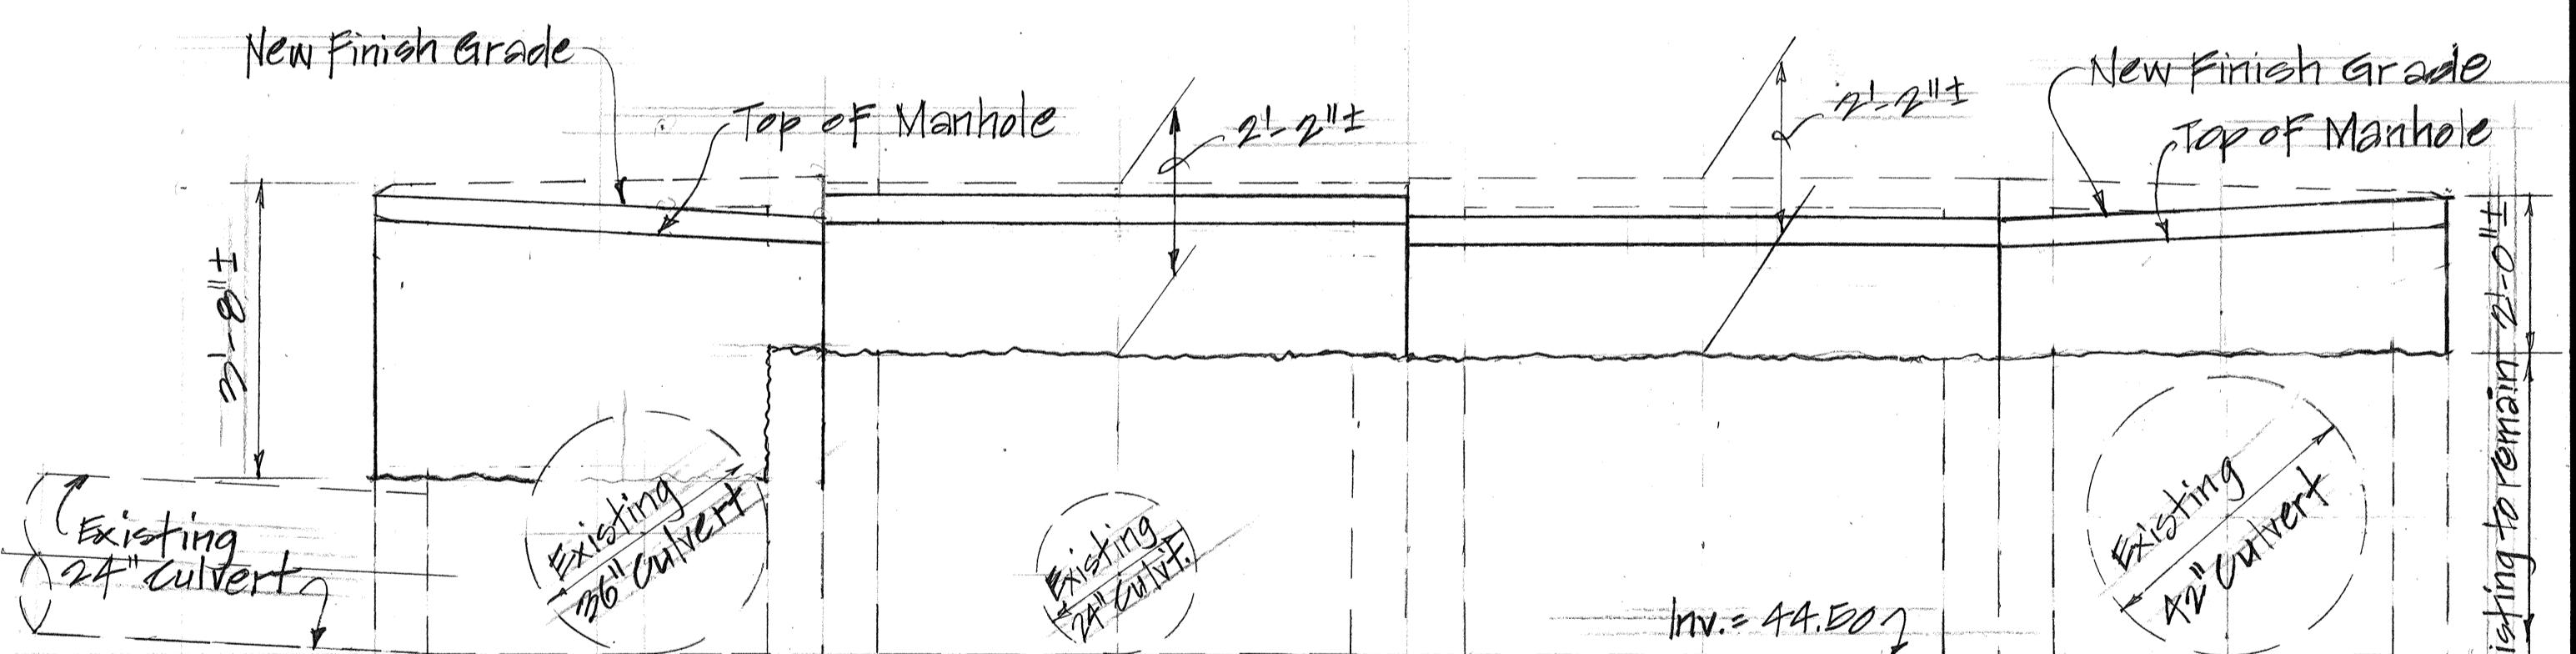


RECONSTRUCTED TOP SLAB AND SIDE WALLS

scale: 1/2" = 1'-0"

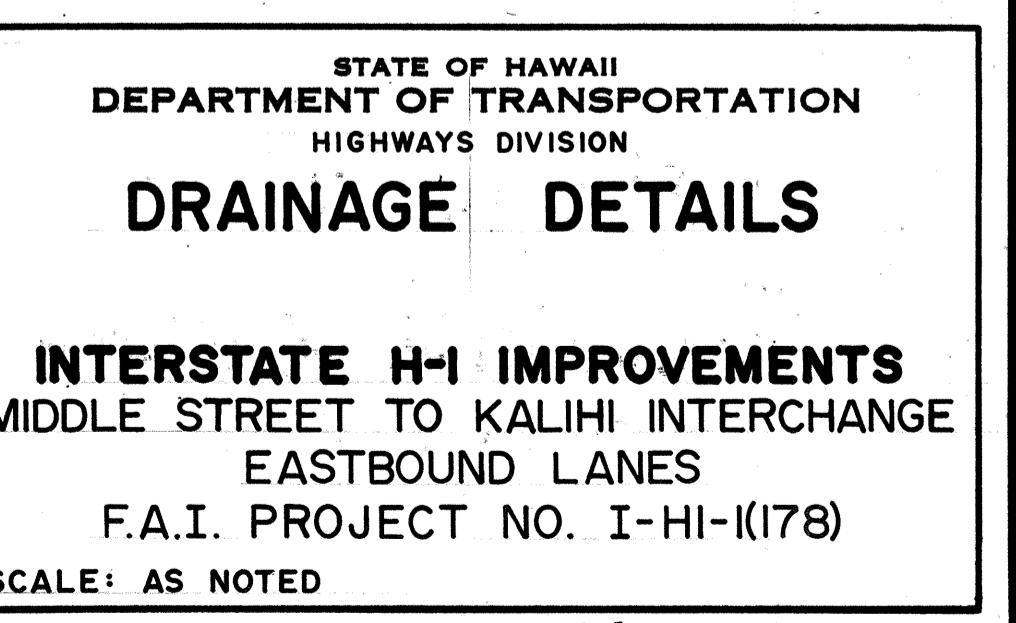



FED. ROAD DIST. NO.	STATE	FED. AID PROJ. NO.	FISCAL YEAR	SHEET NO.	TOTAL SHEETS
HAWAII	HAW.	I-HI-1(178)	1982	52	165

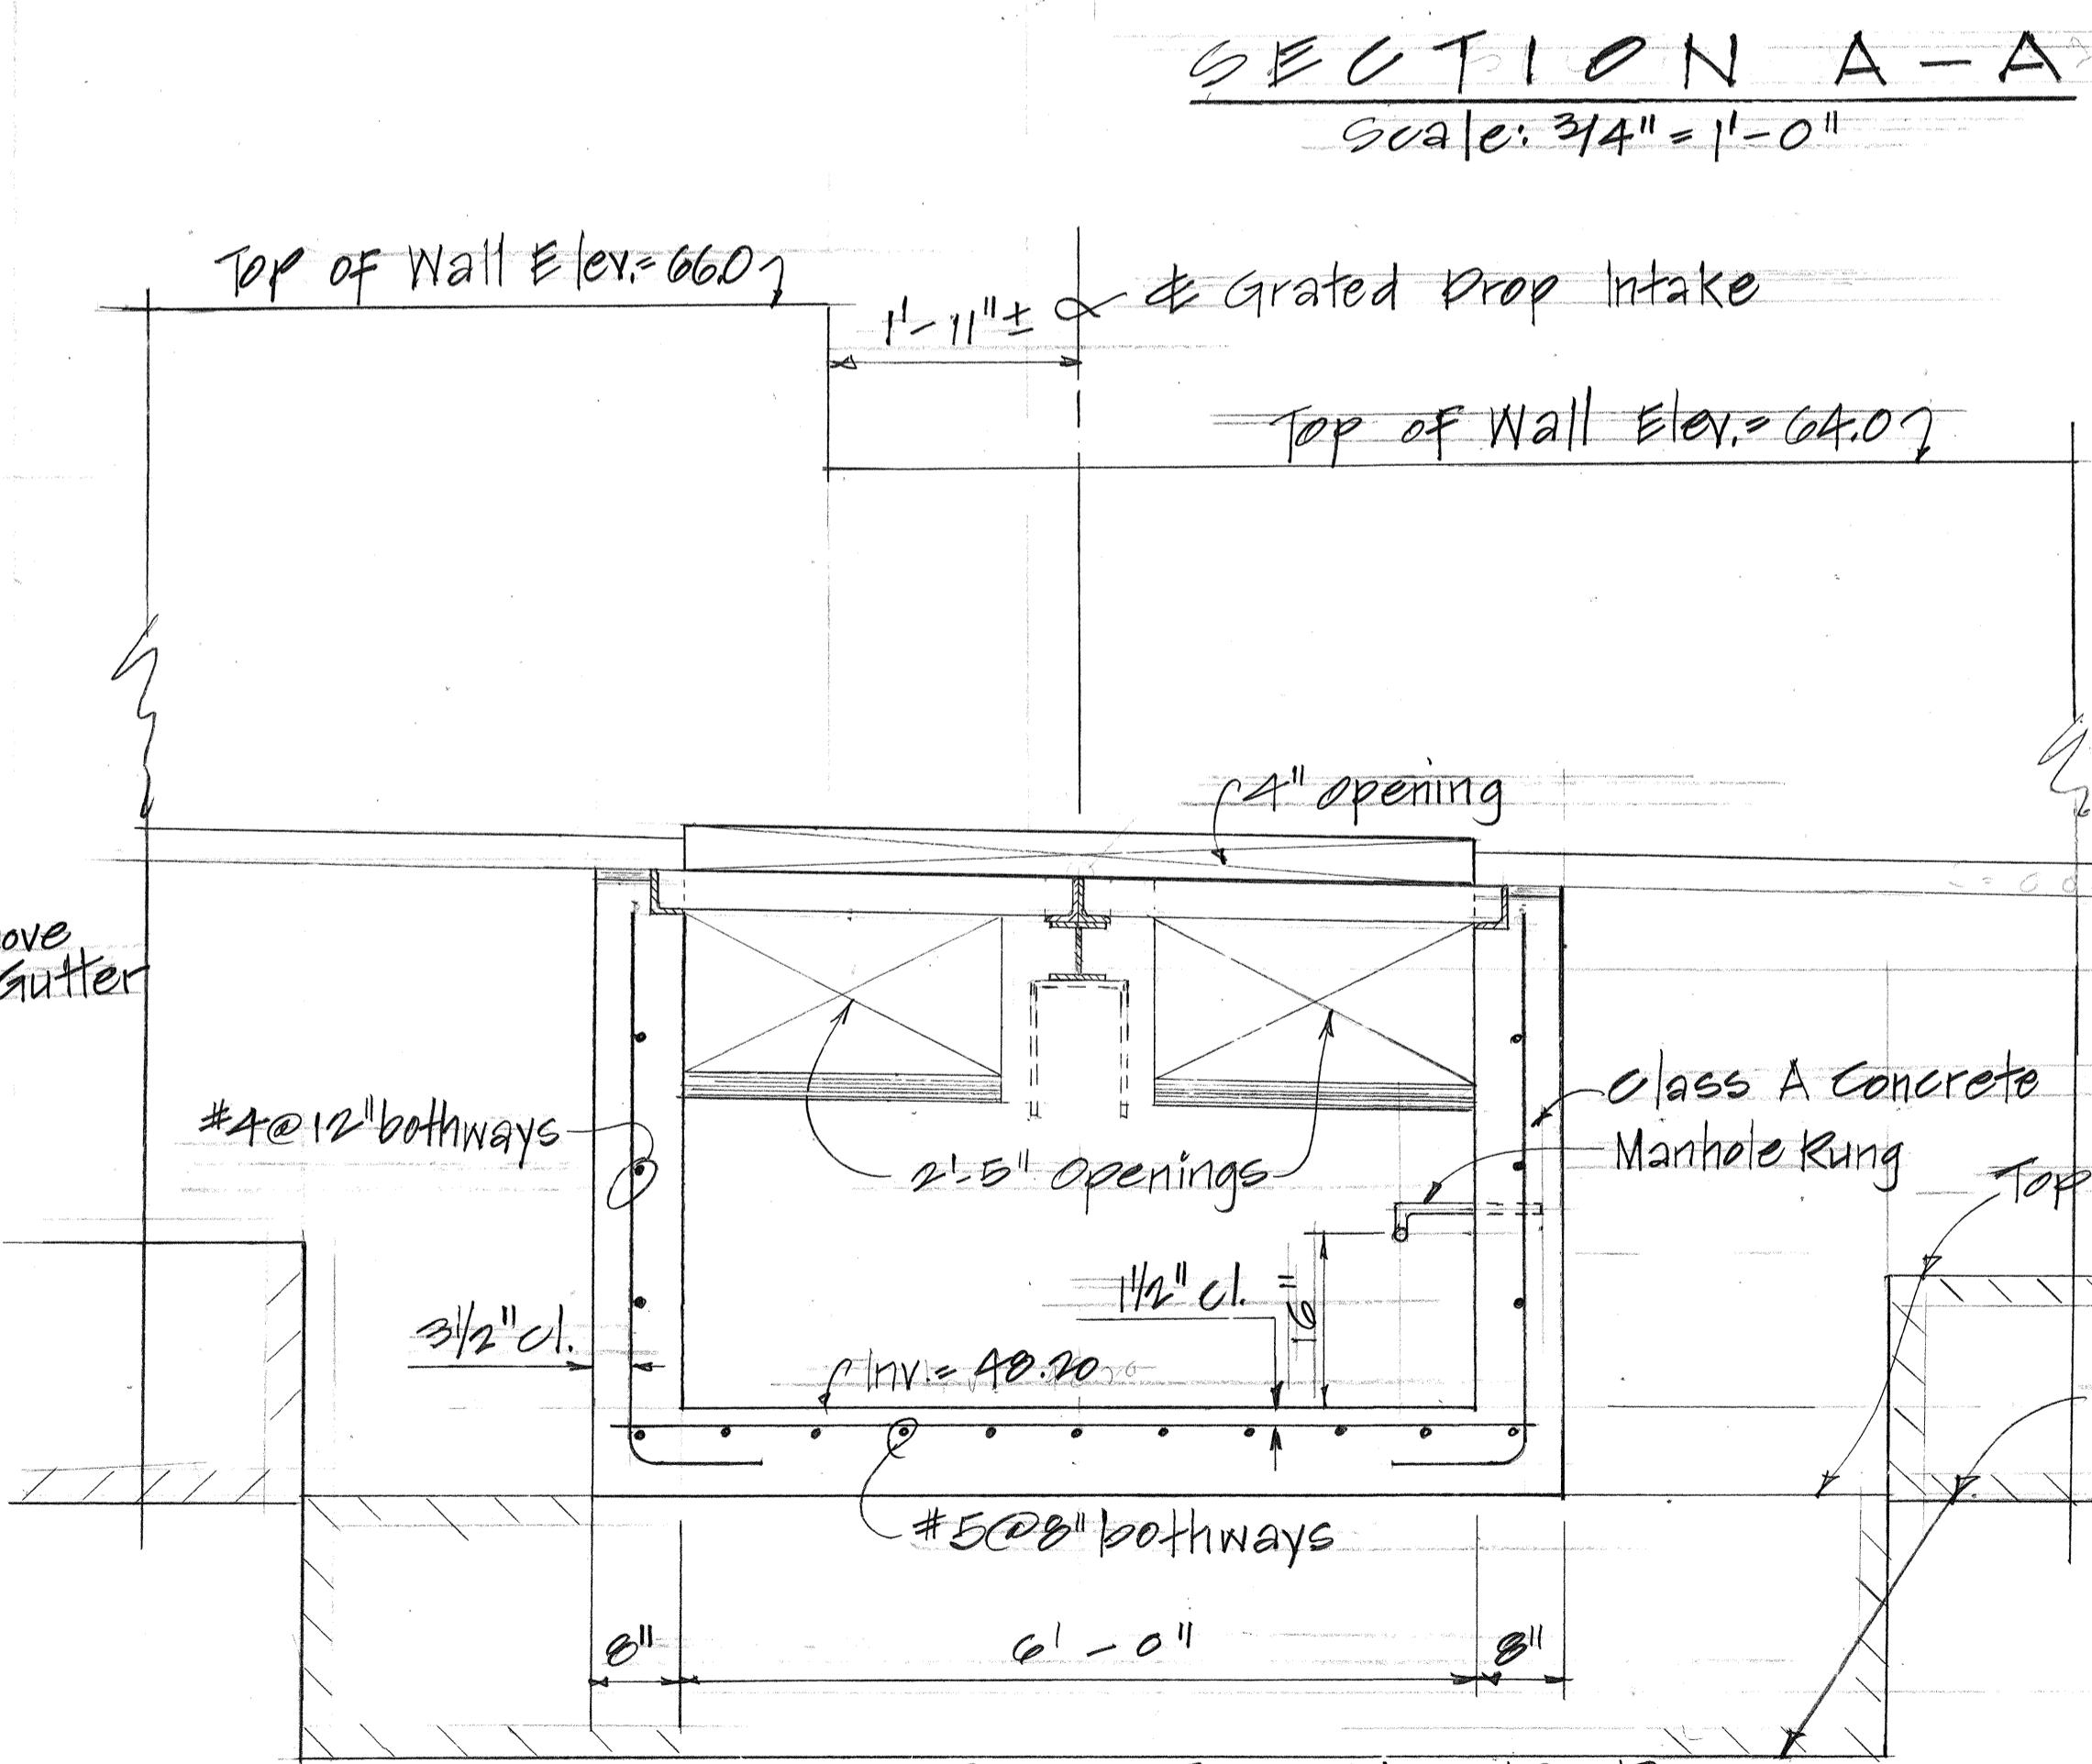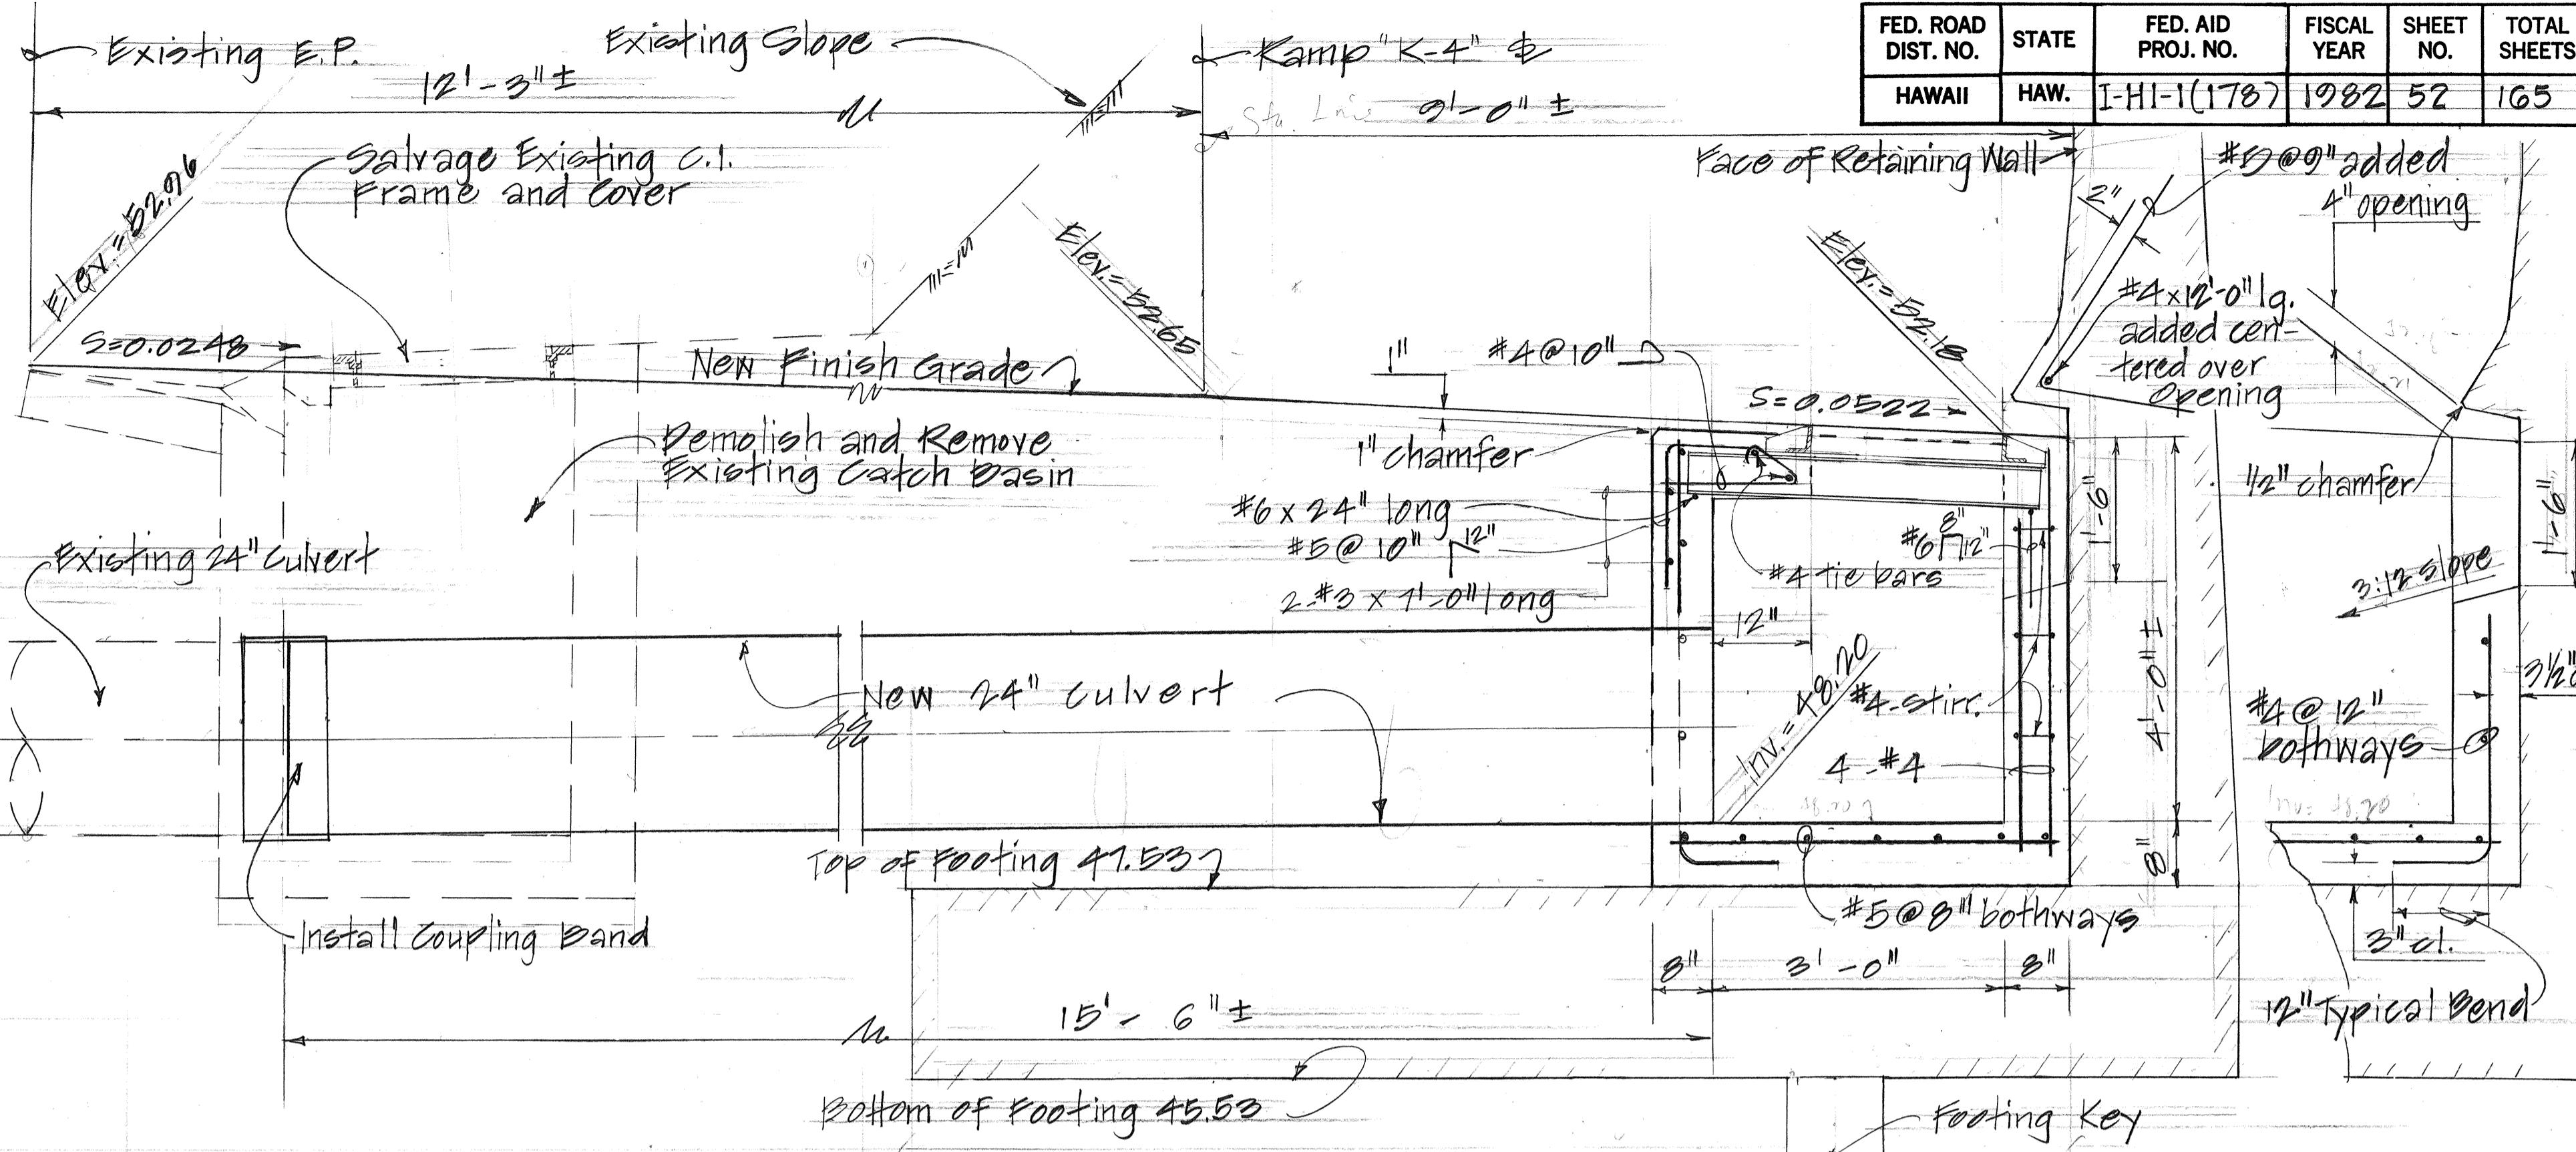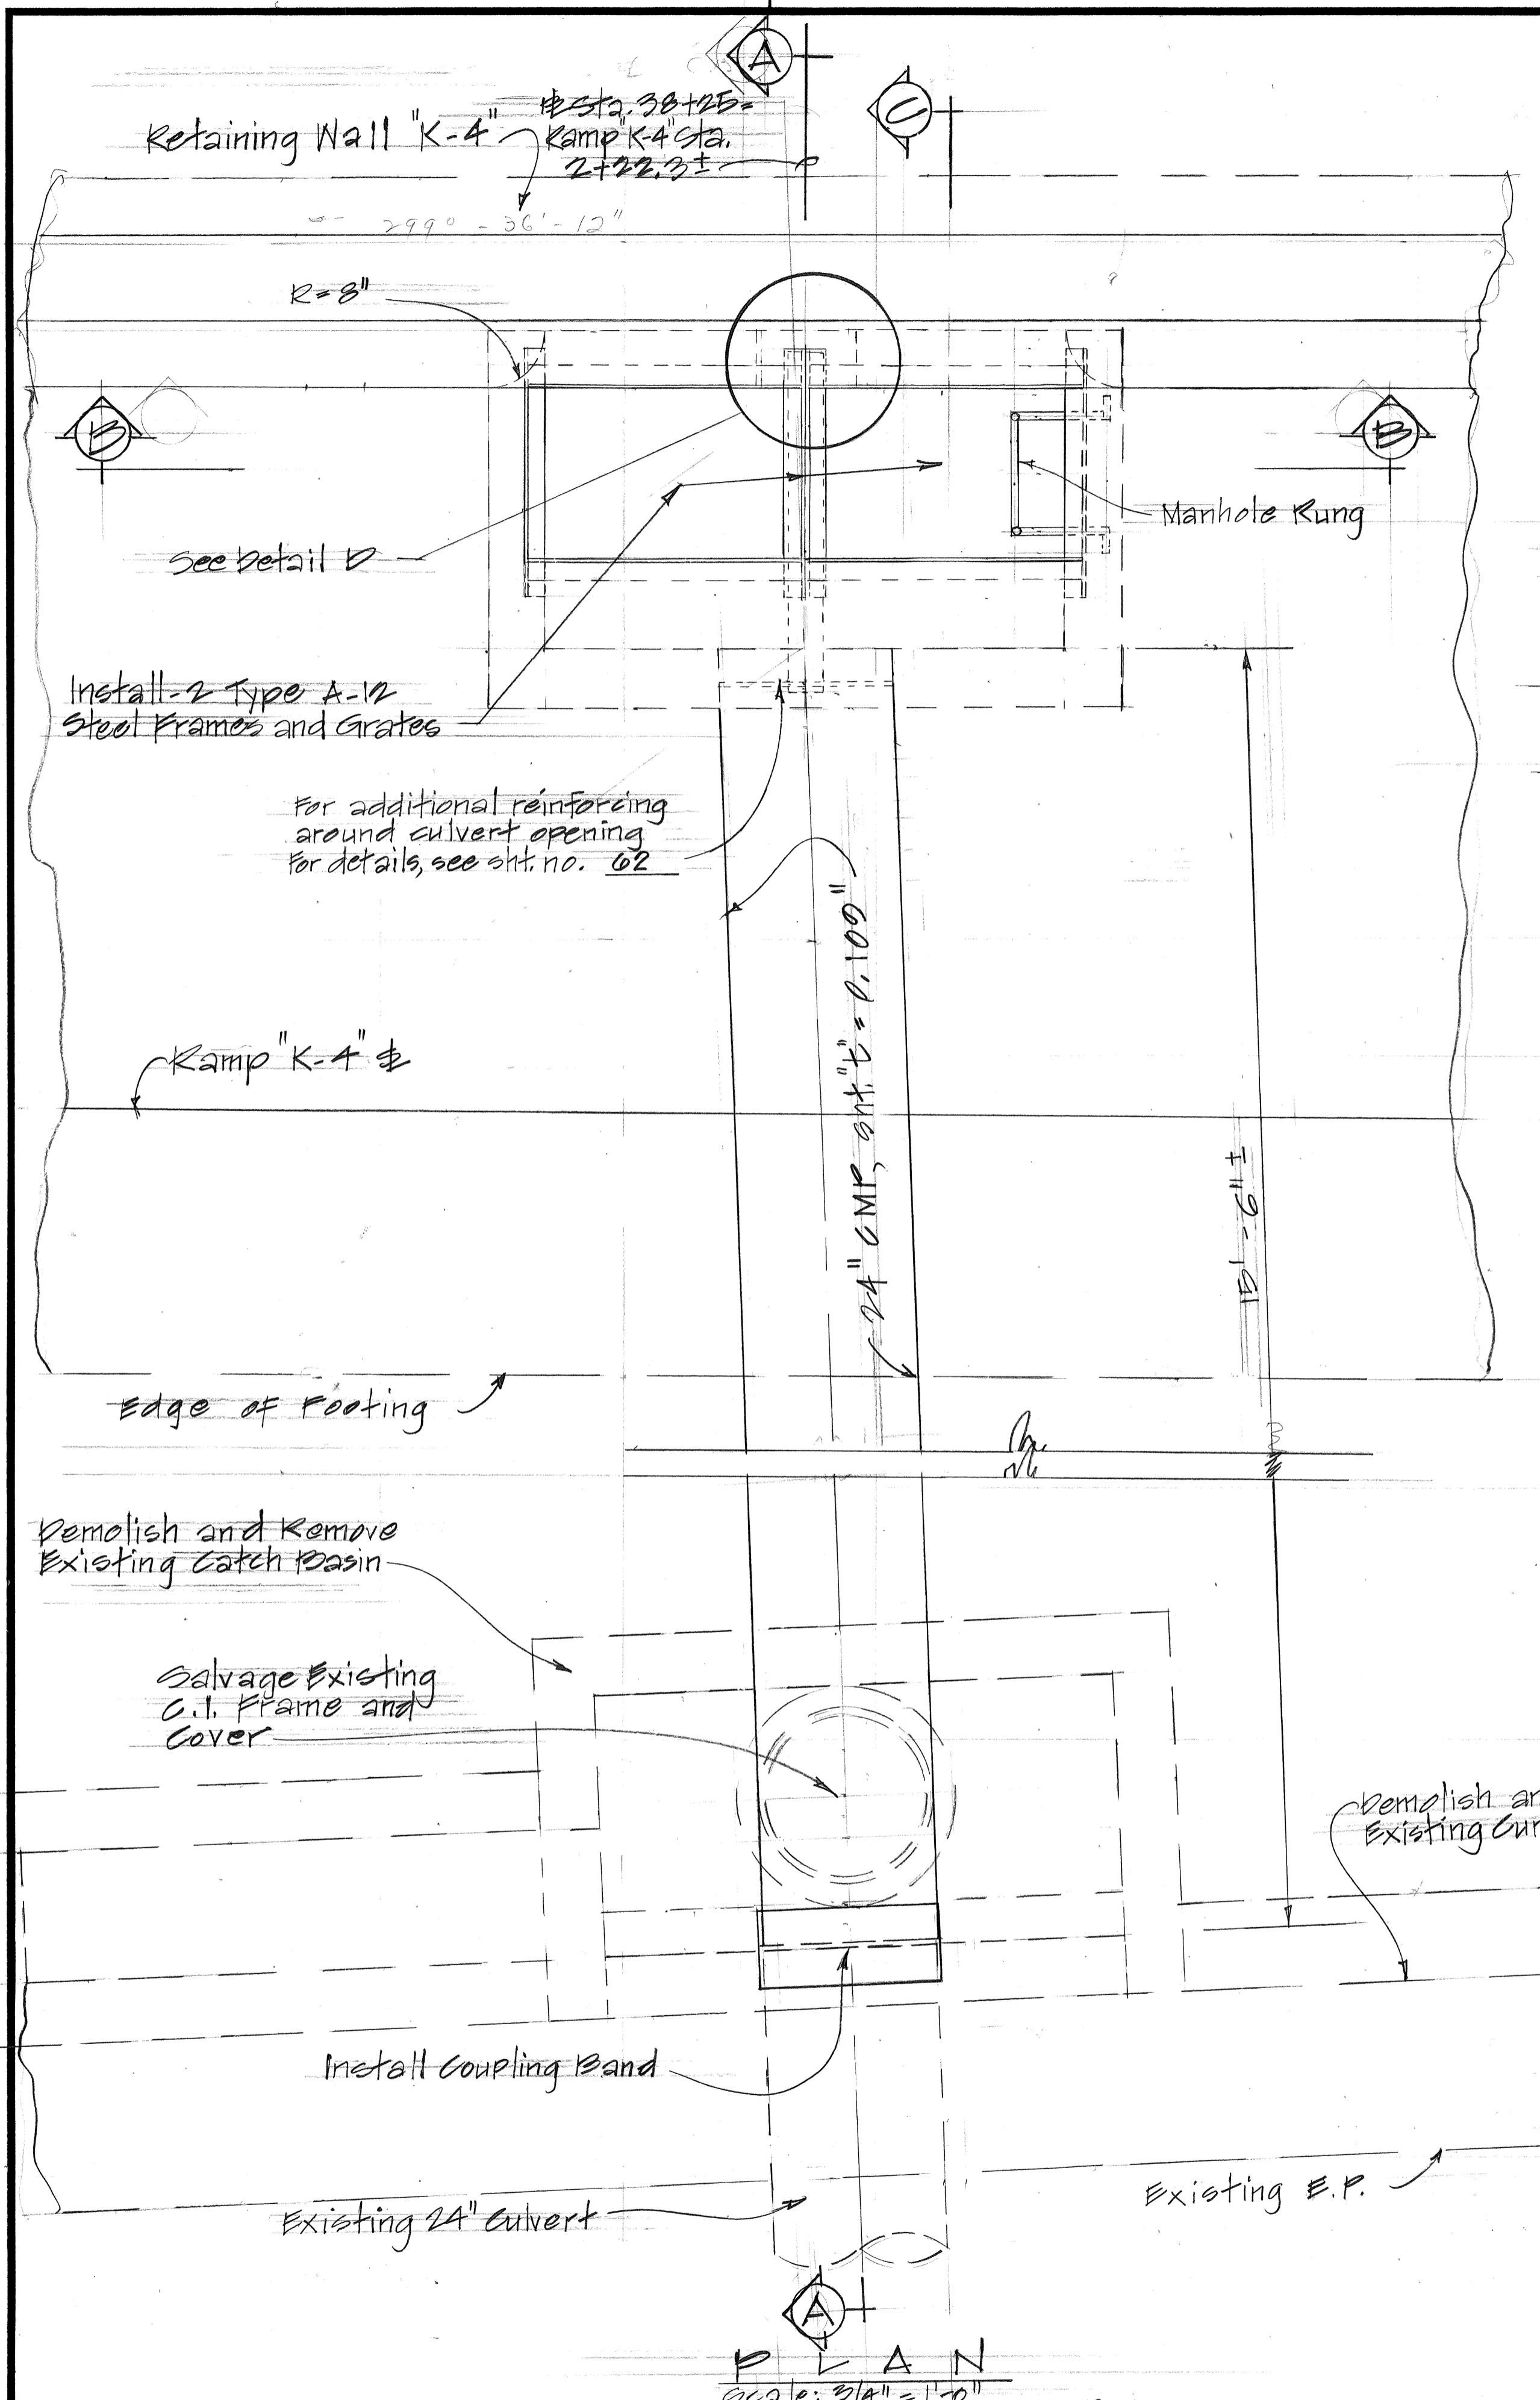

DETAILS OF TYPE 2 GRATED DROP INTAKE AT STA. 38+25 RT.





ORIGINAL SURVEY PLOTTED BY	DESIGNER
PLAN DRAWN BY	
NOTE BOOK	QUANTITY BY
No. CHECKED BY	

FED. ROAD DIST. NO.	STATE	FED. AID PROJ. NO.	FISCAL YEAR	SHEET NO.	TOTAL SHEETS
HAWAII	HAW.	I-HI-1(178)	1982	53	165

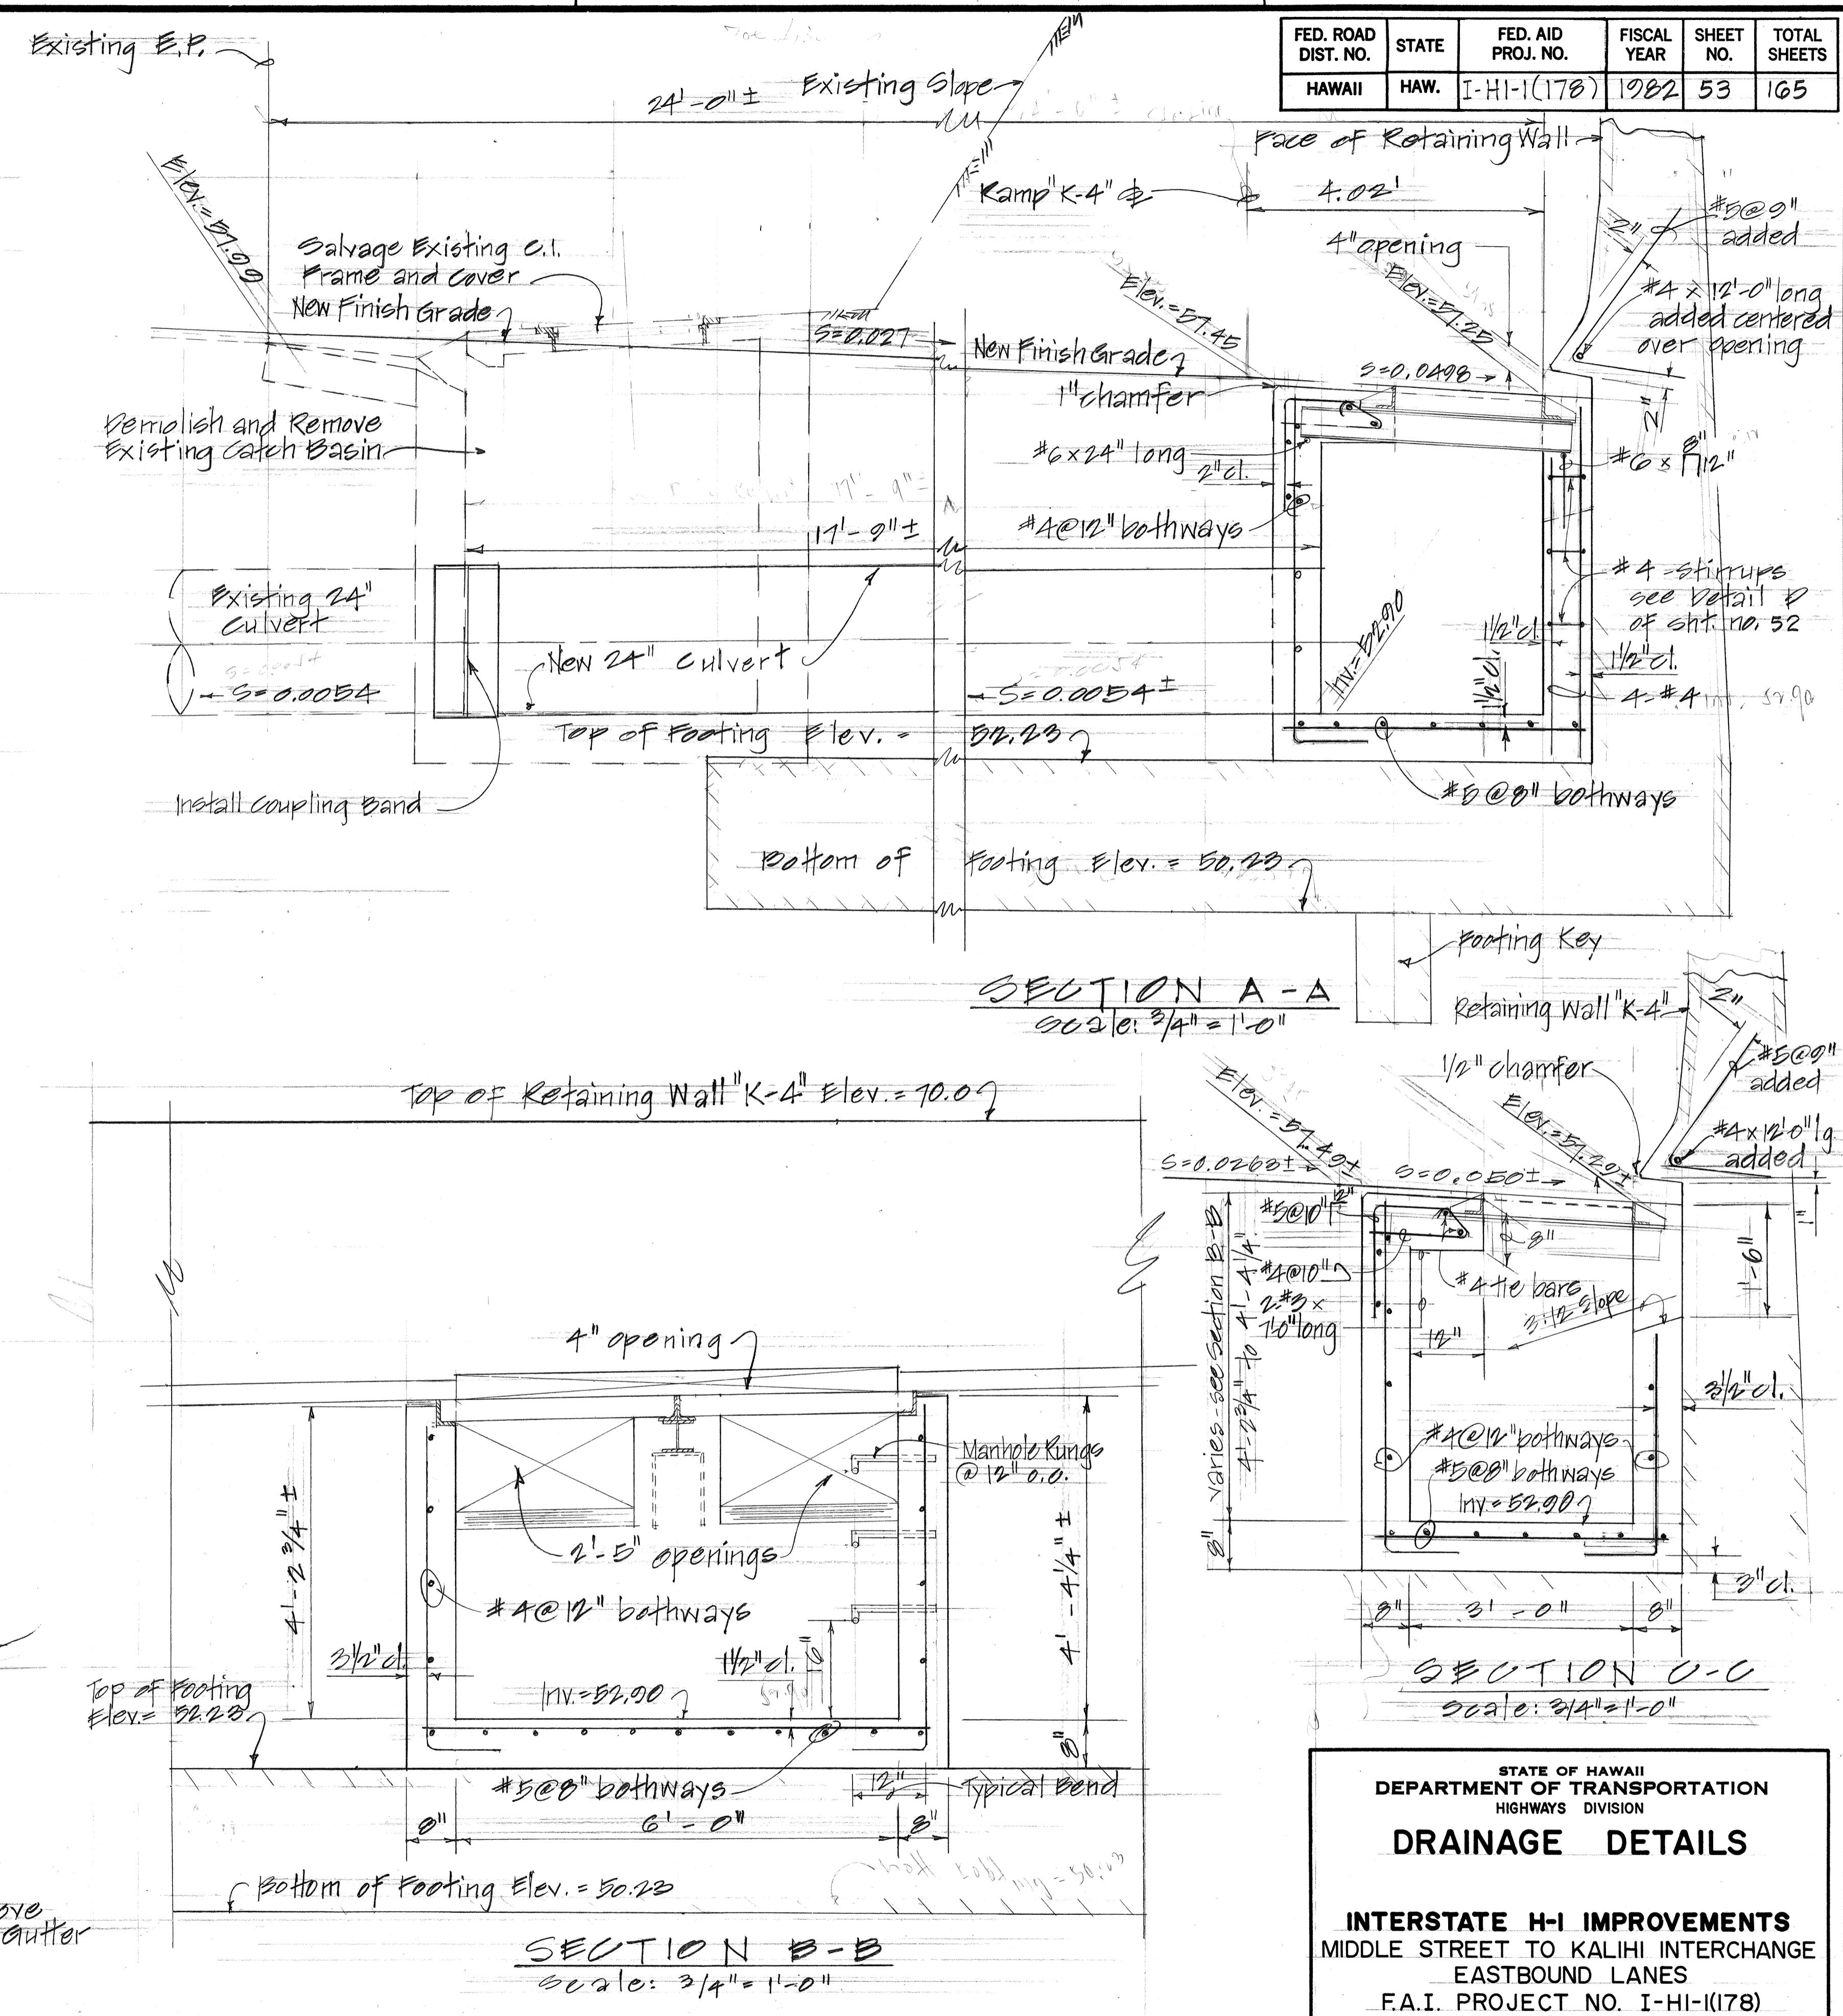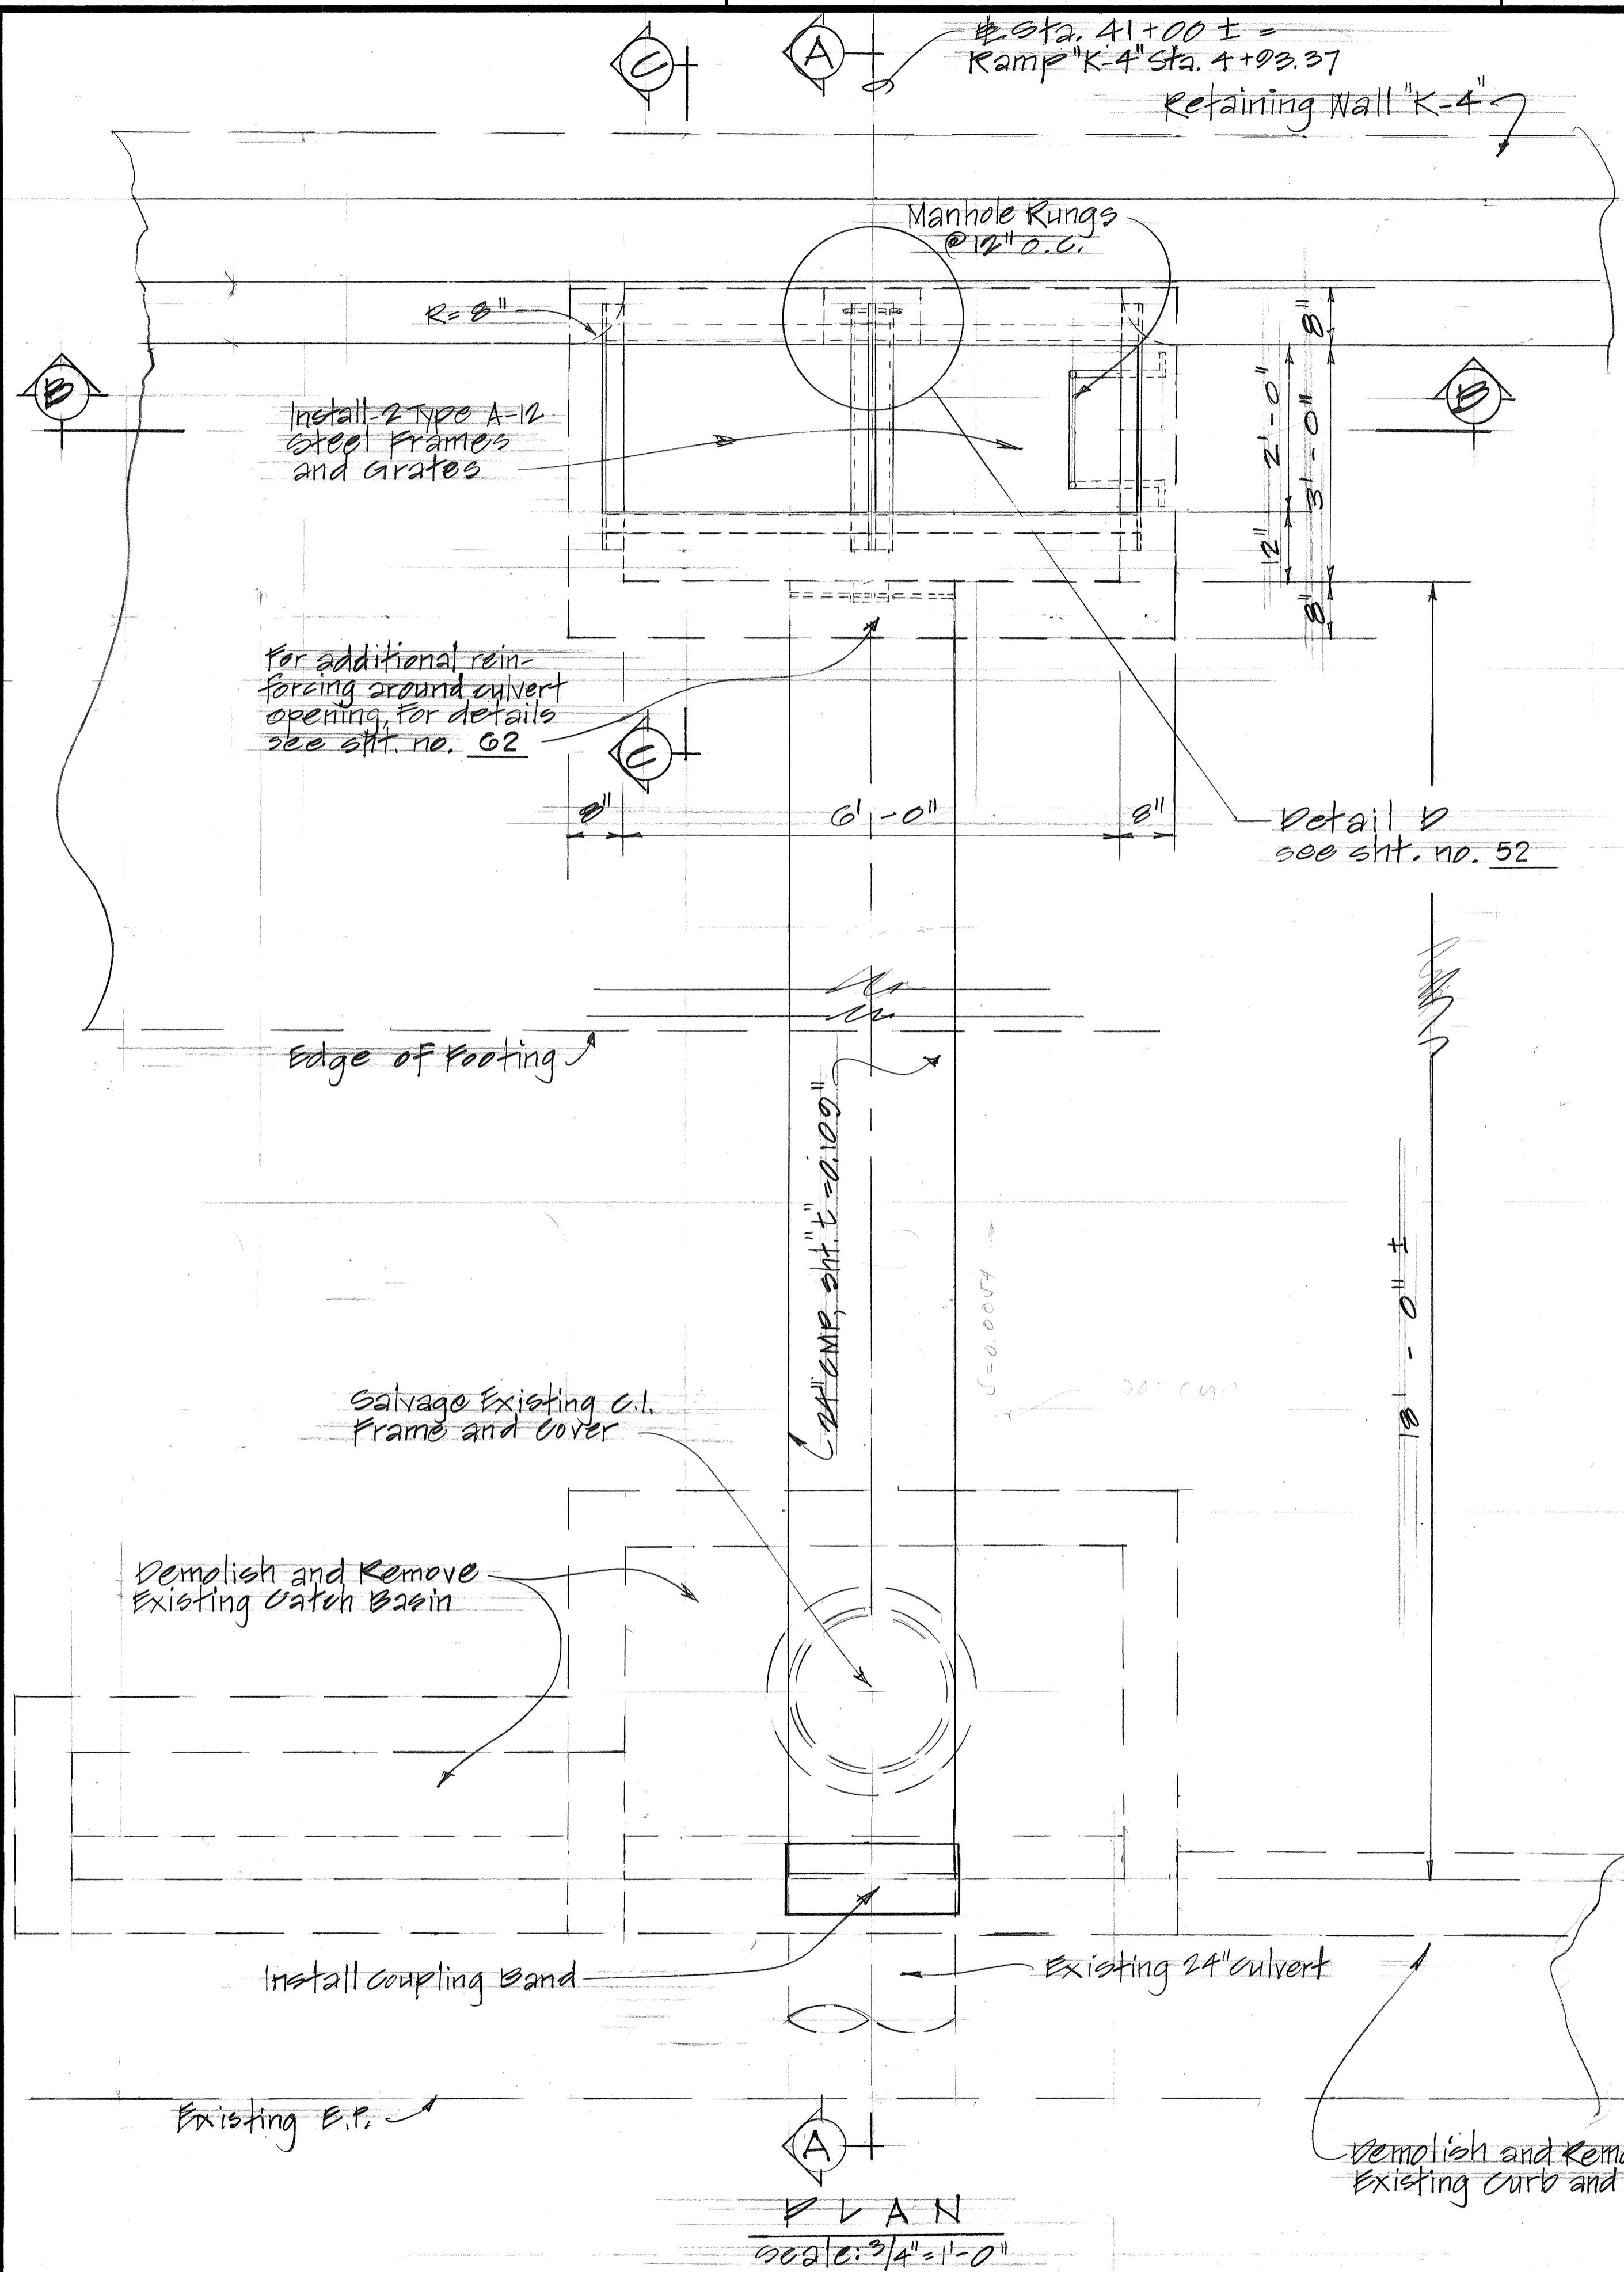

DETAILS OF TYPE 2 GRATED DROP INTAKE AT STA. 41+00 RT.


FED. ROAD DIST. NO.	STATE	FED. AID PROJ. NO.	FISCAL YEAR	SHEET NO.	TOTAL SHEETS
HAWAII	HAW.	I-HI-1(178)	1982	55	165

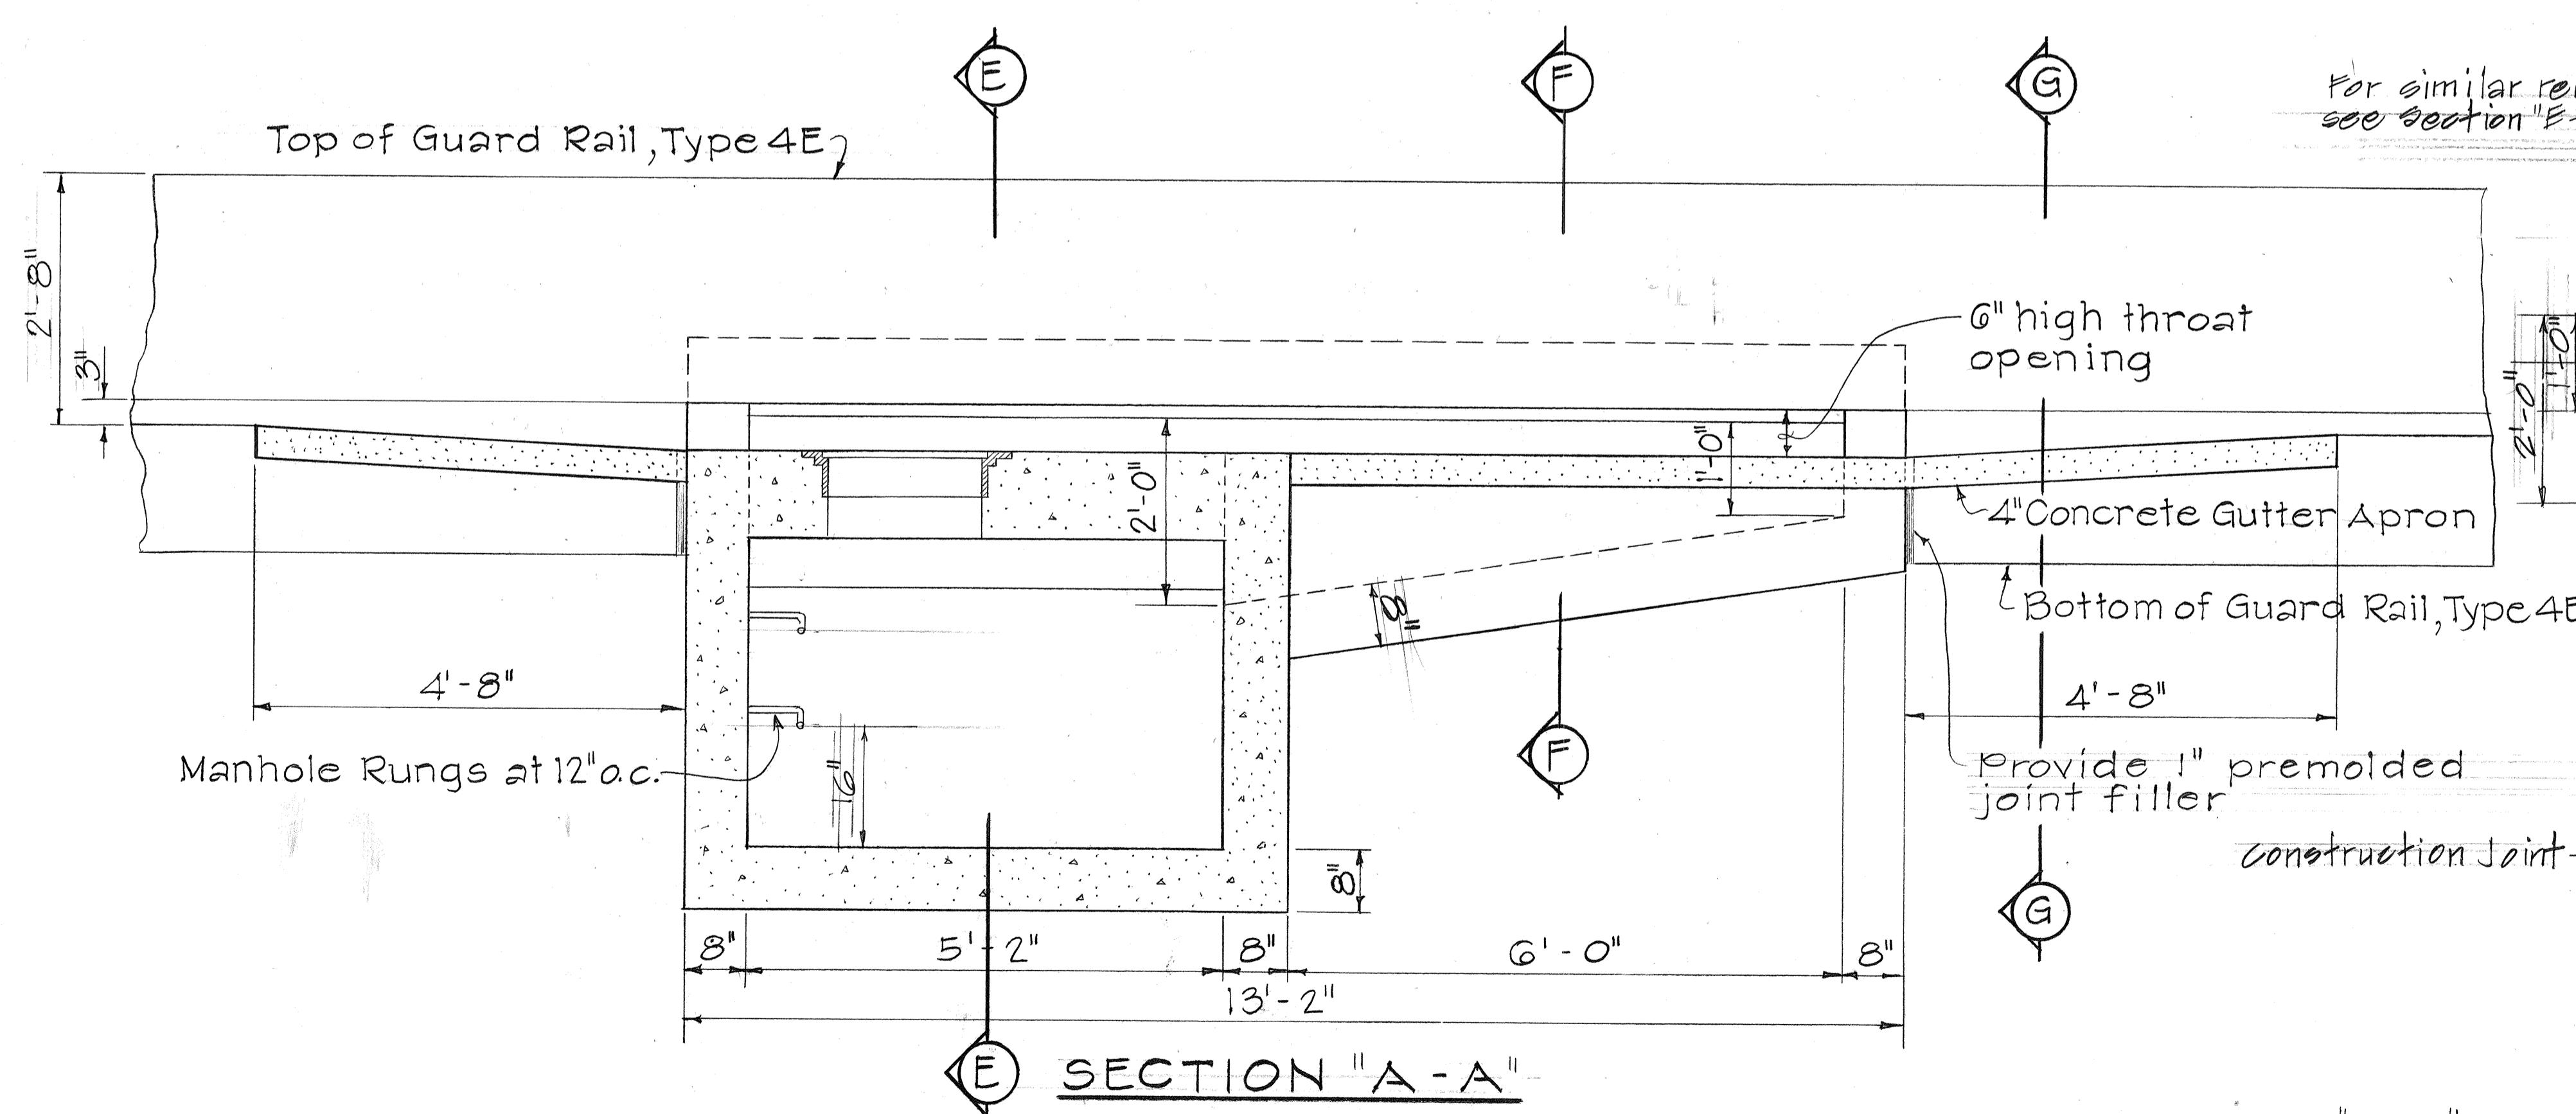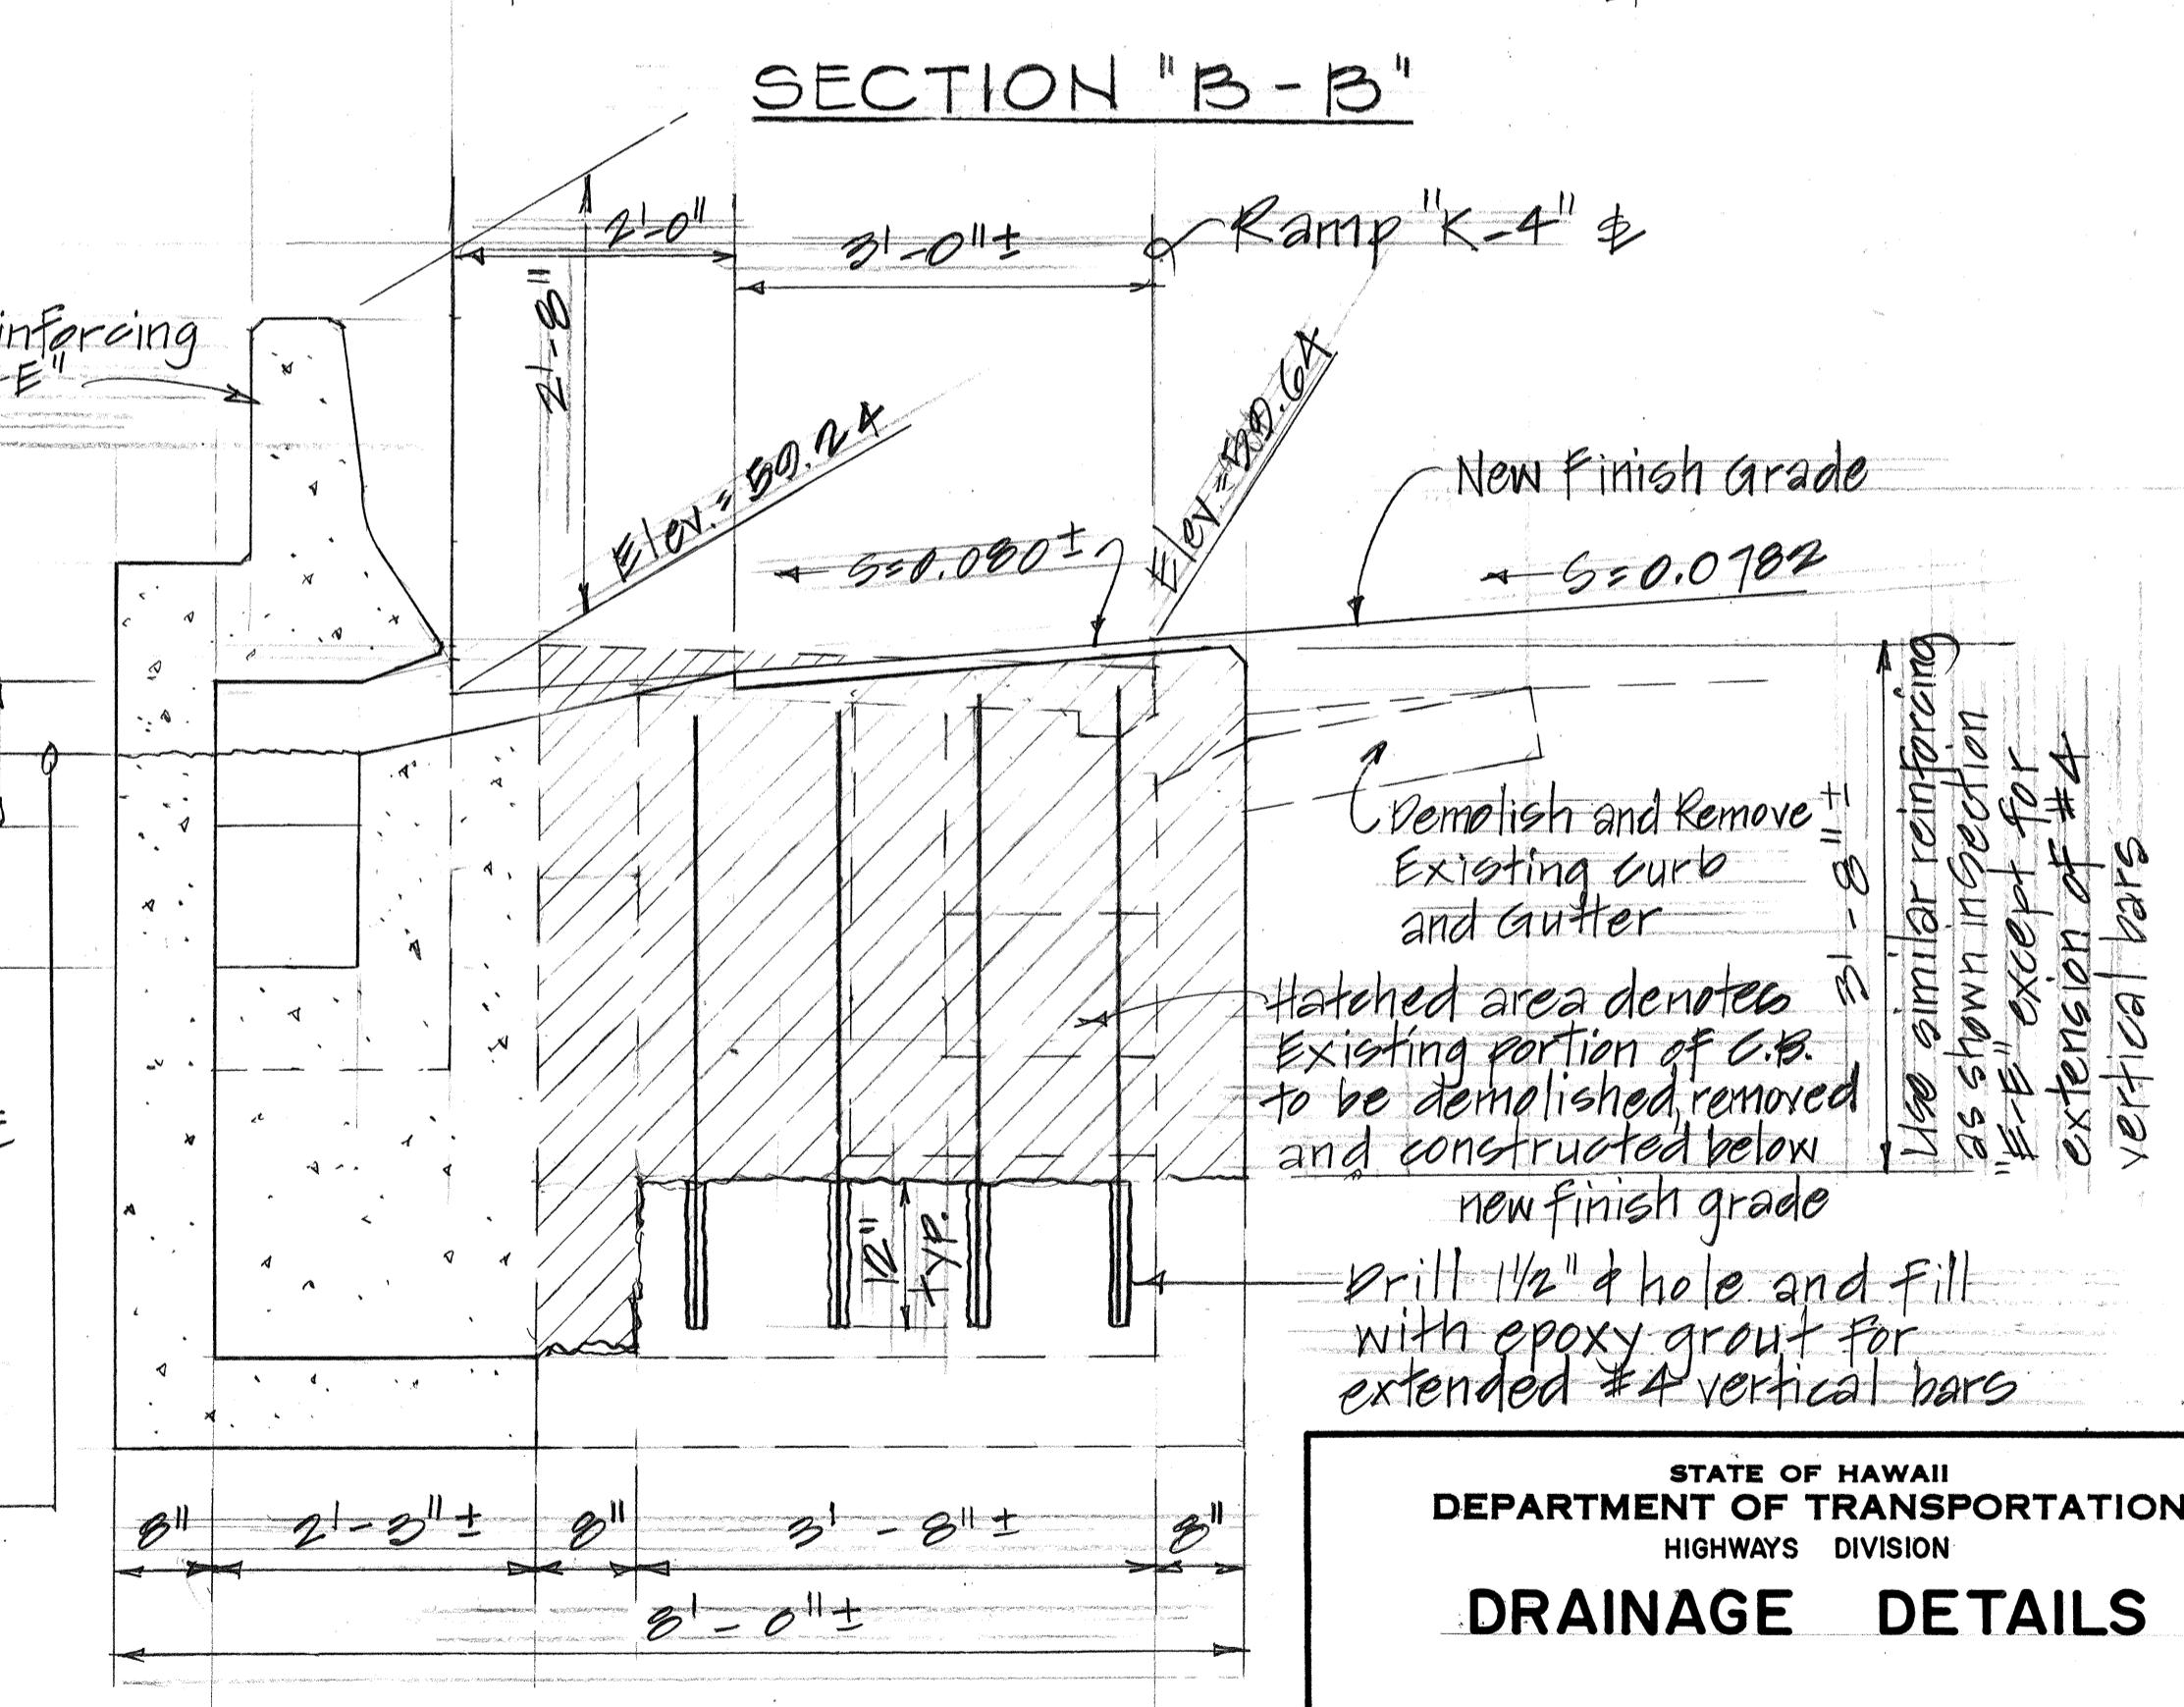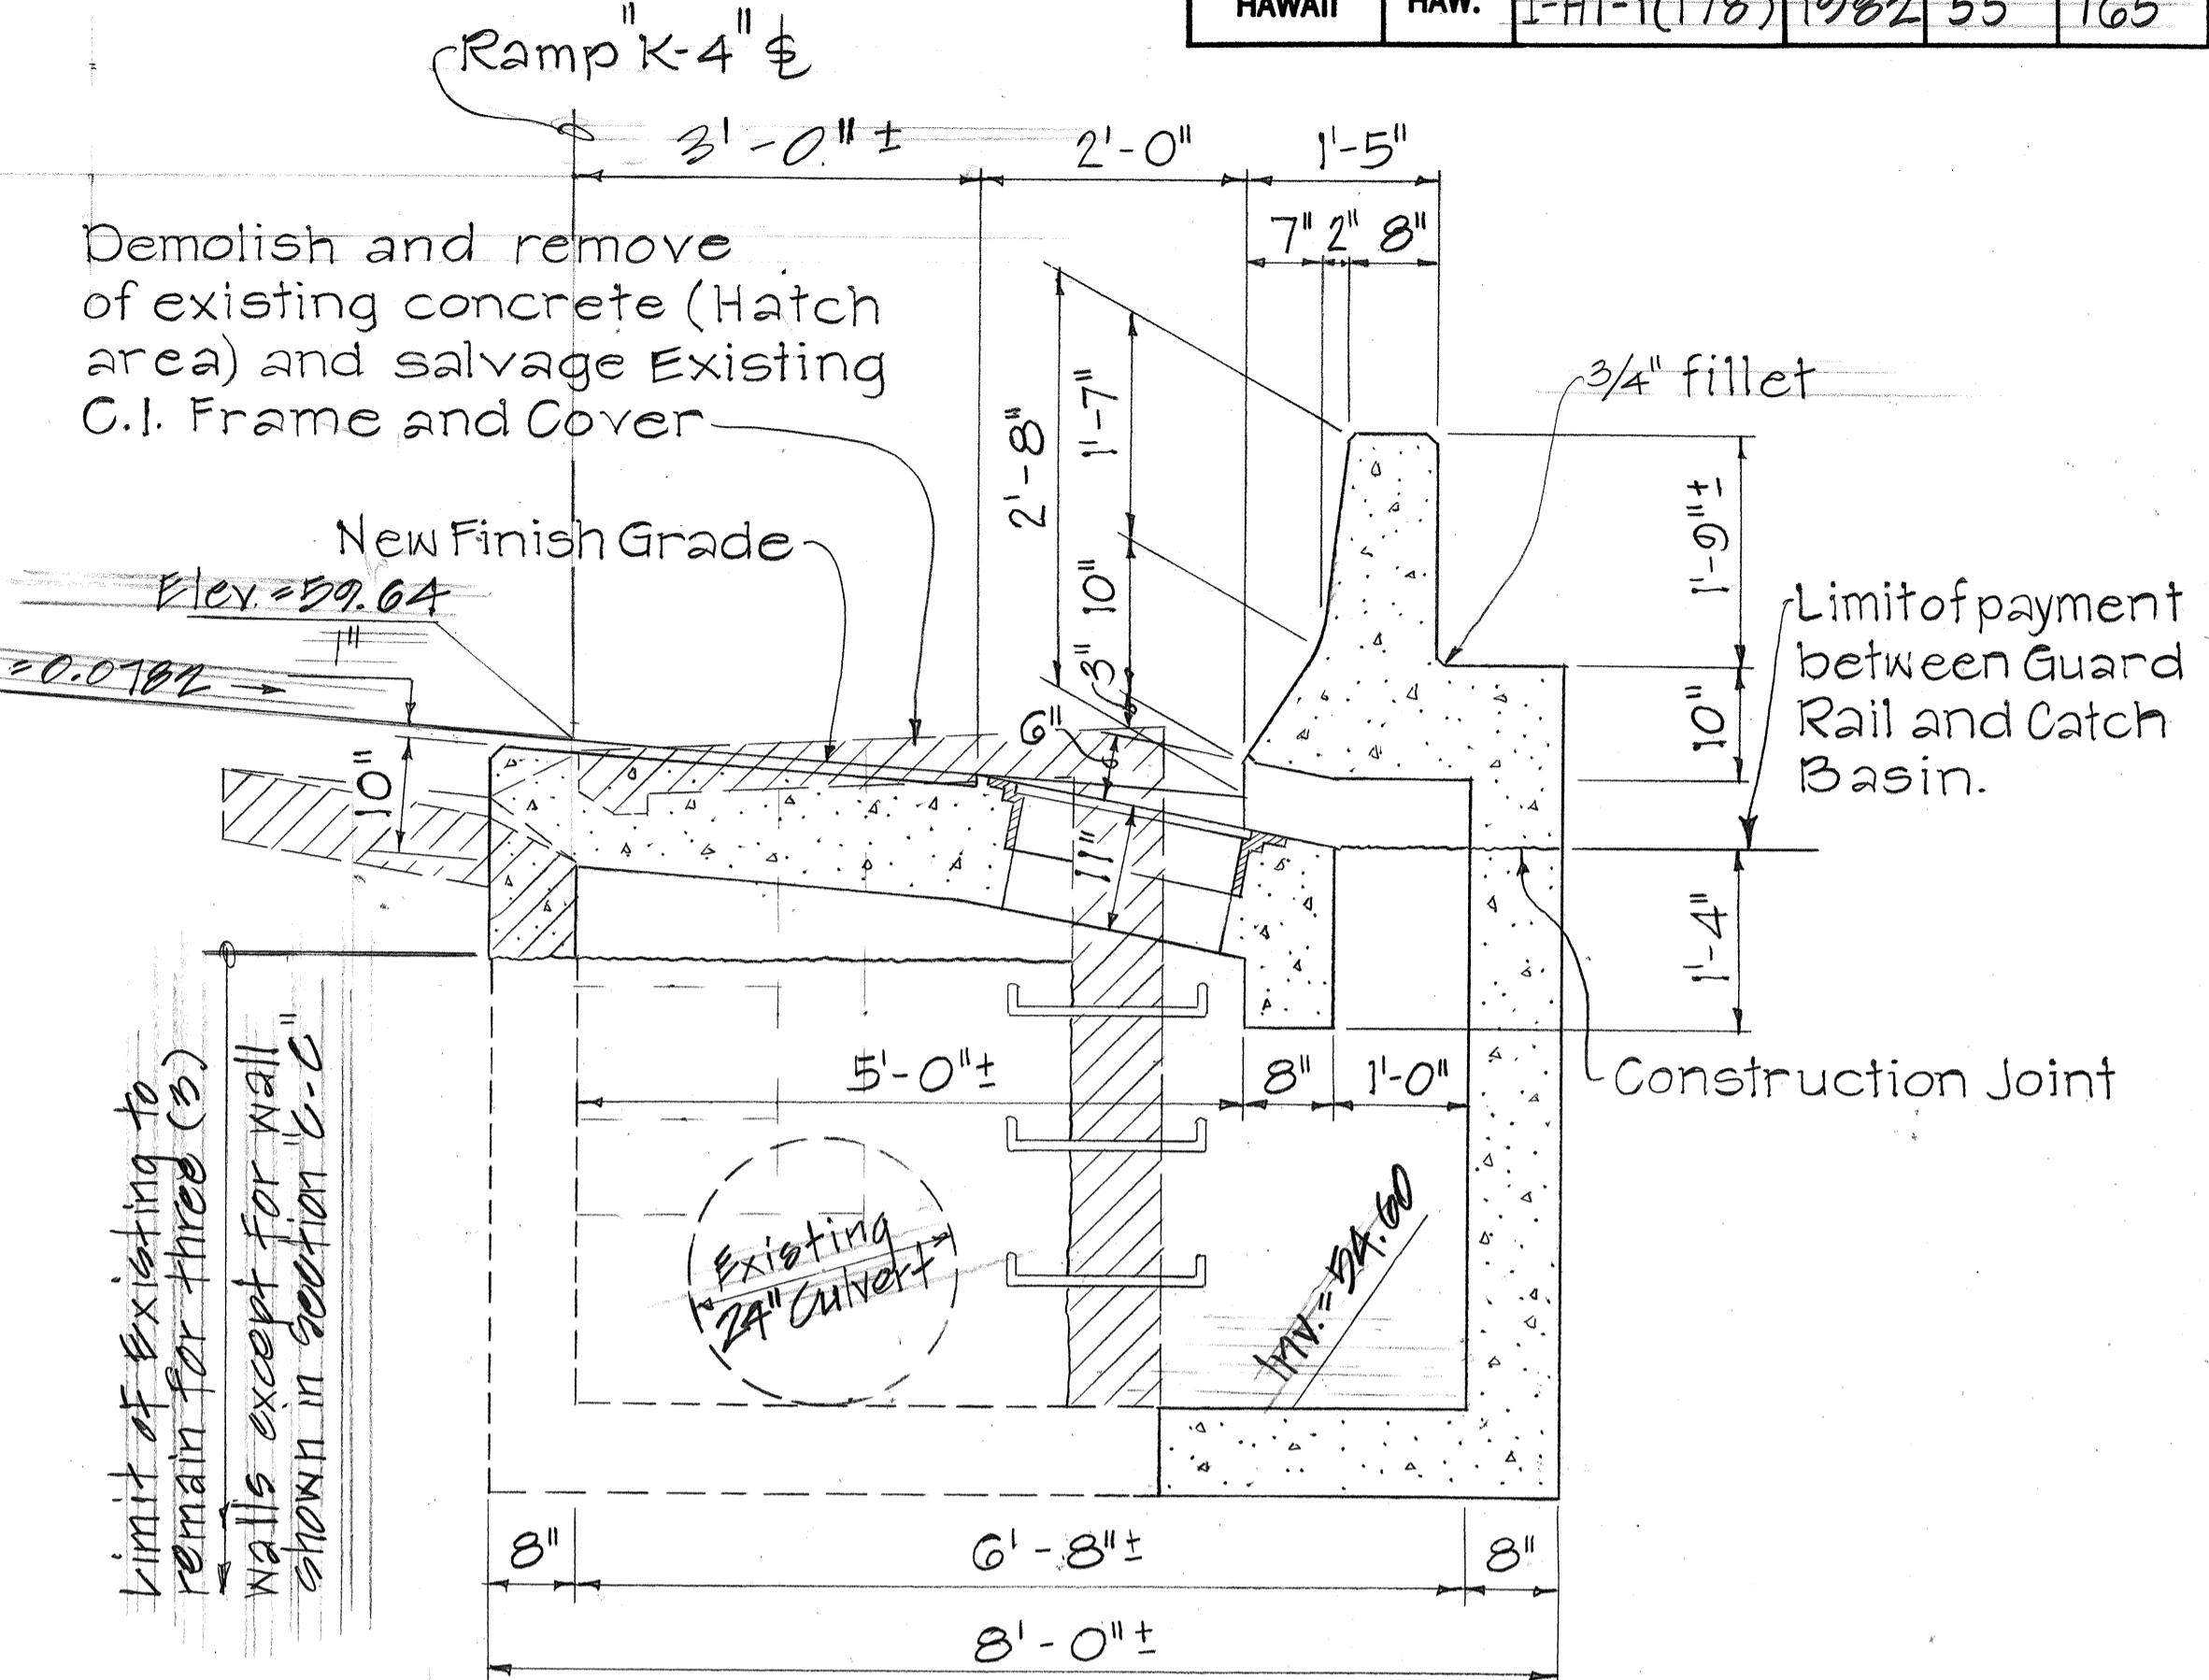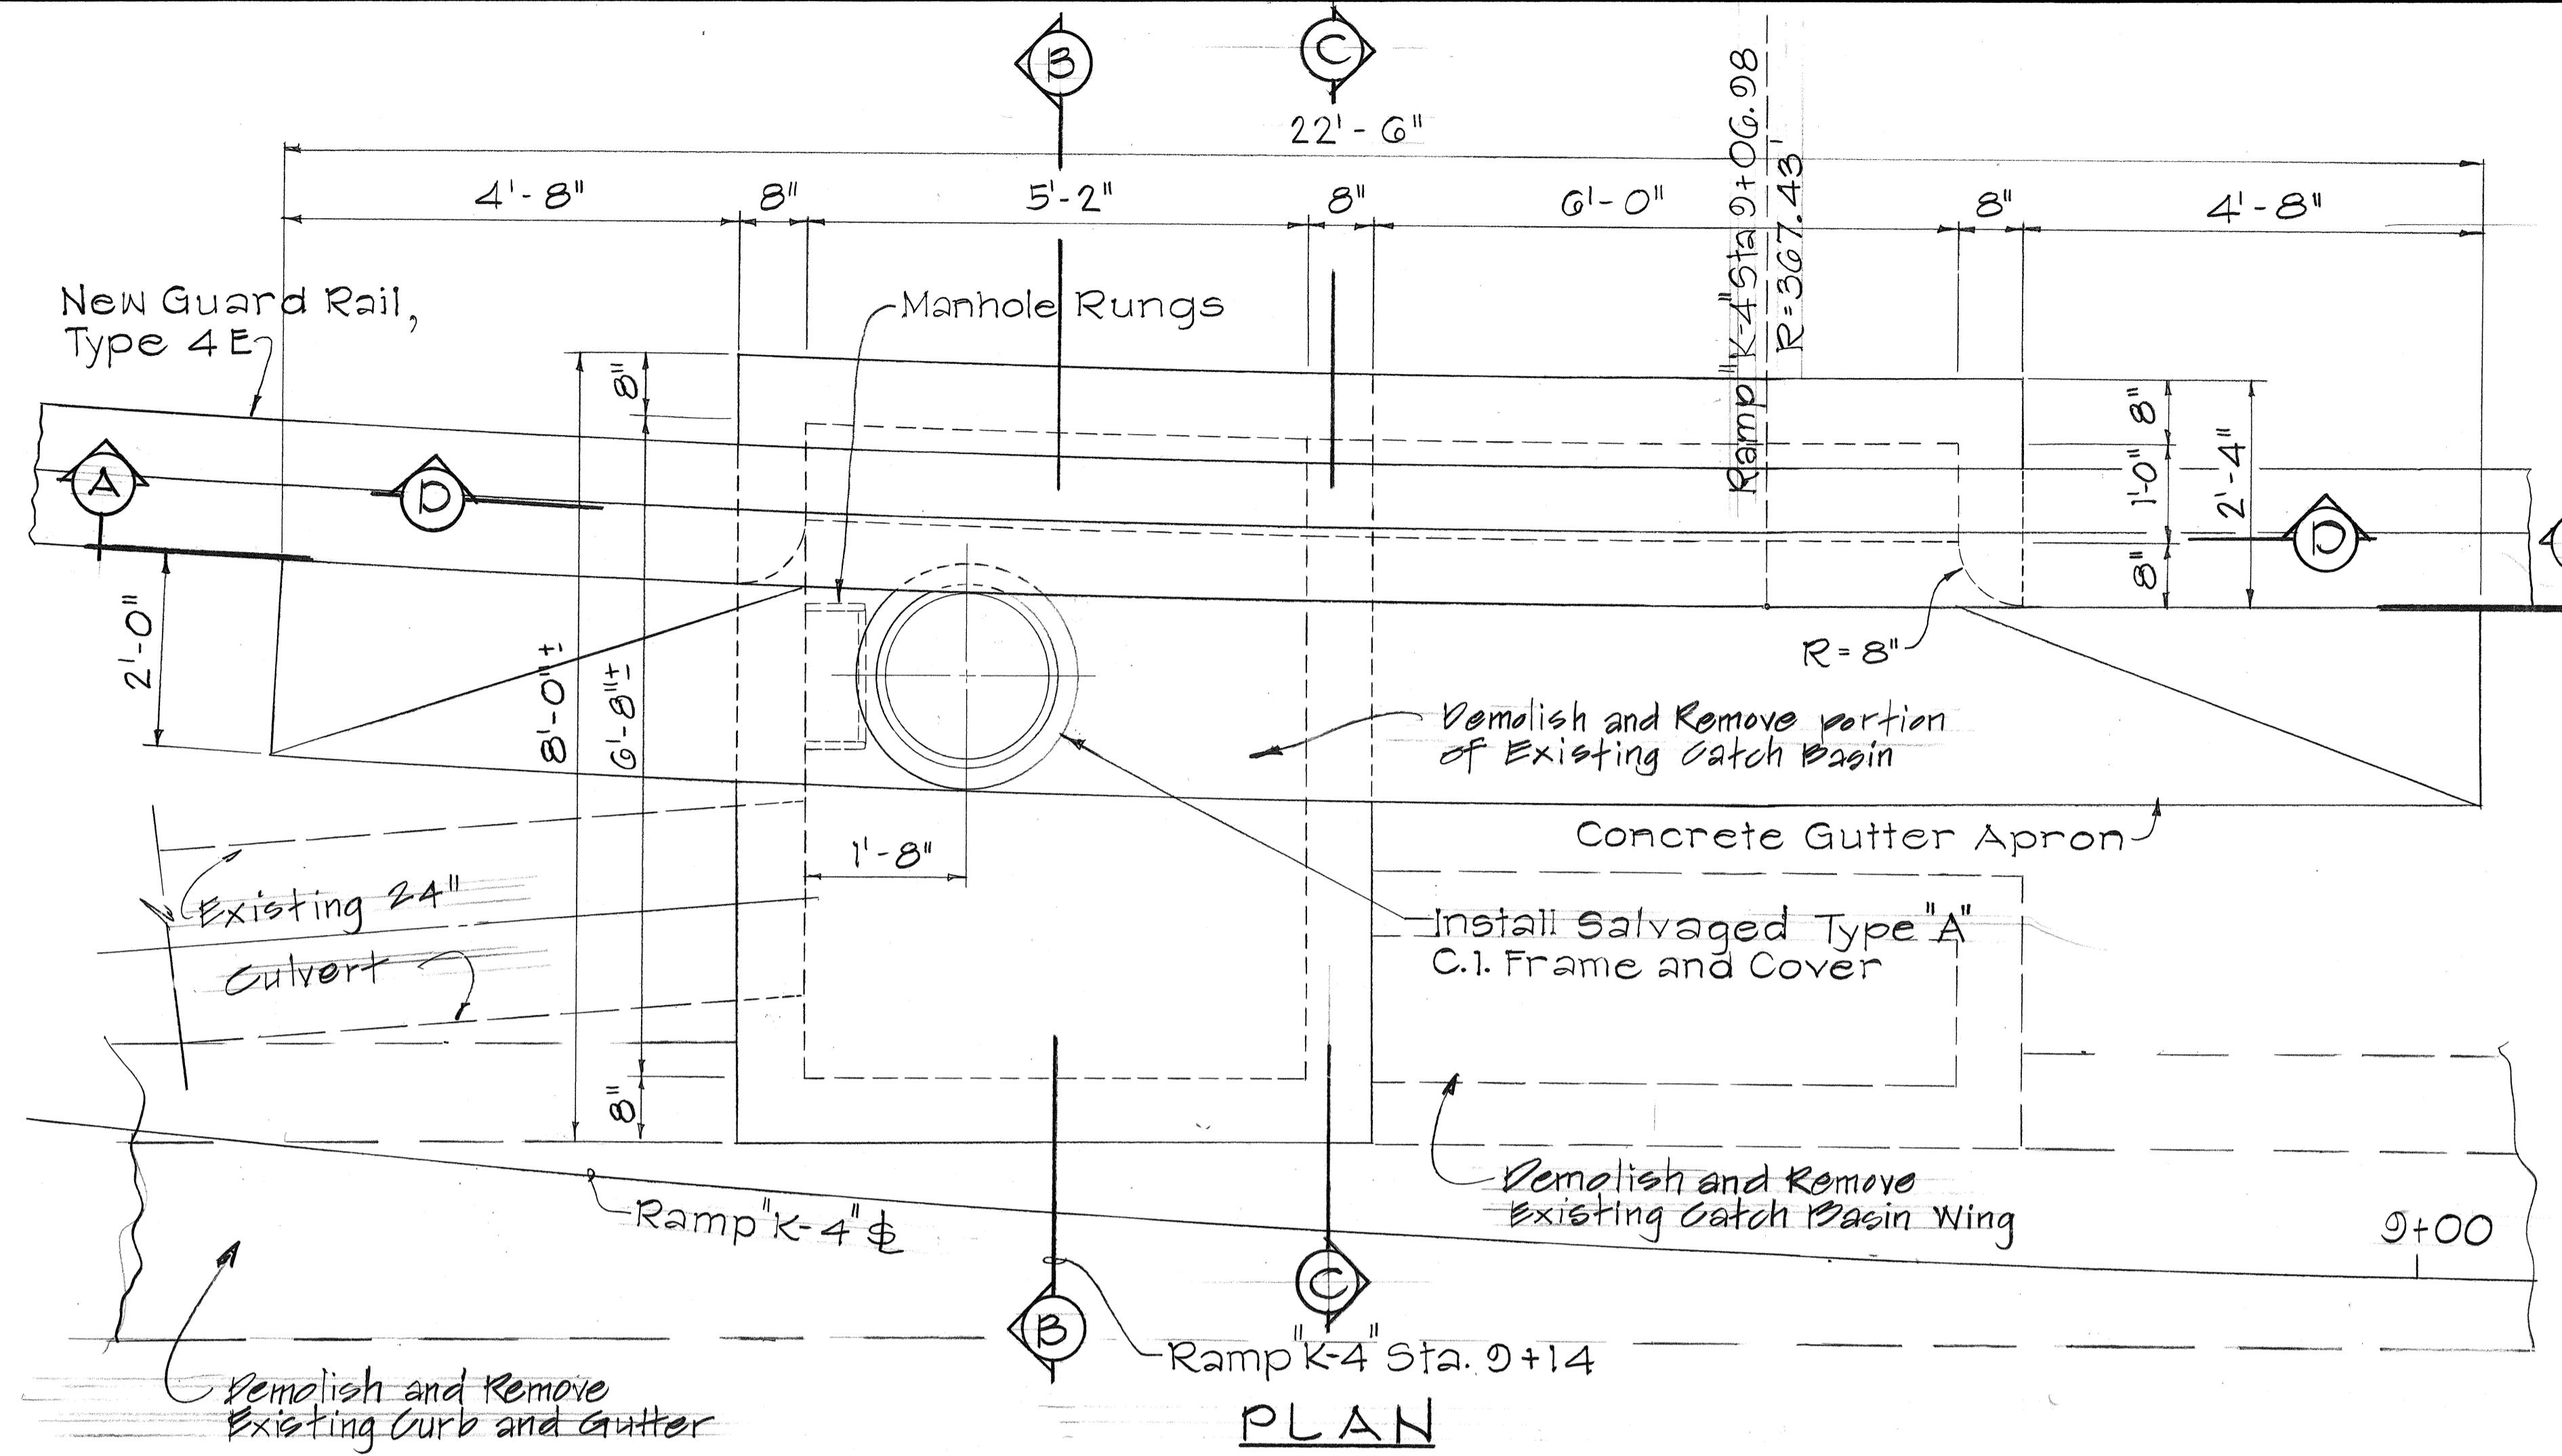


DETAILS OF MODIFIED TYPE "C" CATCH BASIN AT RAMP K-4 STA. 9+14
Scale: 3/4" = 1'-0"

STATE OF HAWAII
DEPARTMENT OF TRANSPORTATION
HIGHWAYS DIVISION
DRAINAGE DETAILS
INTERSTATE H-I IMPROVEMENTS
MIDDLE STREET TO KALIHI INTERCHANGE
EASTBOUND LANES
F.A.I. PROJECT NO. I-HI-1(178)
SCALE: AS NOTED
SHEET NO. 22 OF 33 SHEETS

FED. ROAD DIST. NO.	STATE	FED. AID PROJ. NO.	FISCAL YEAR	SHEET NO.	TOTAL SHEETS
HAWAII	HAW.	I-HI-1(178)	1982	54	165

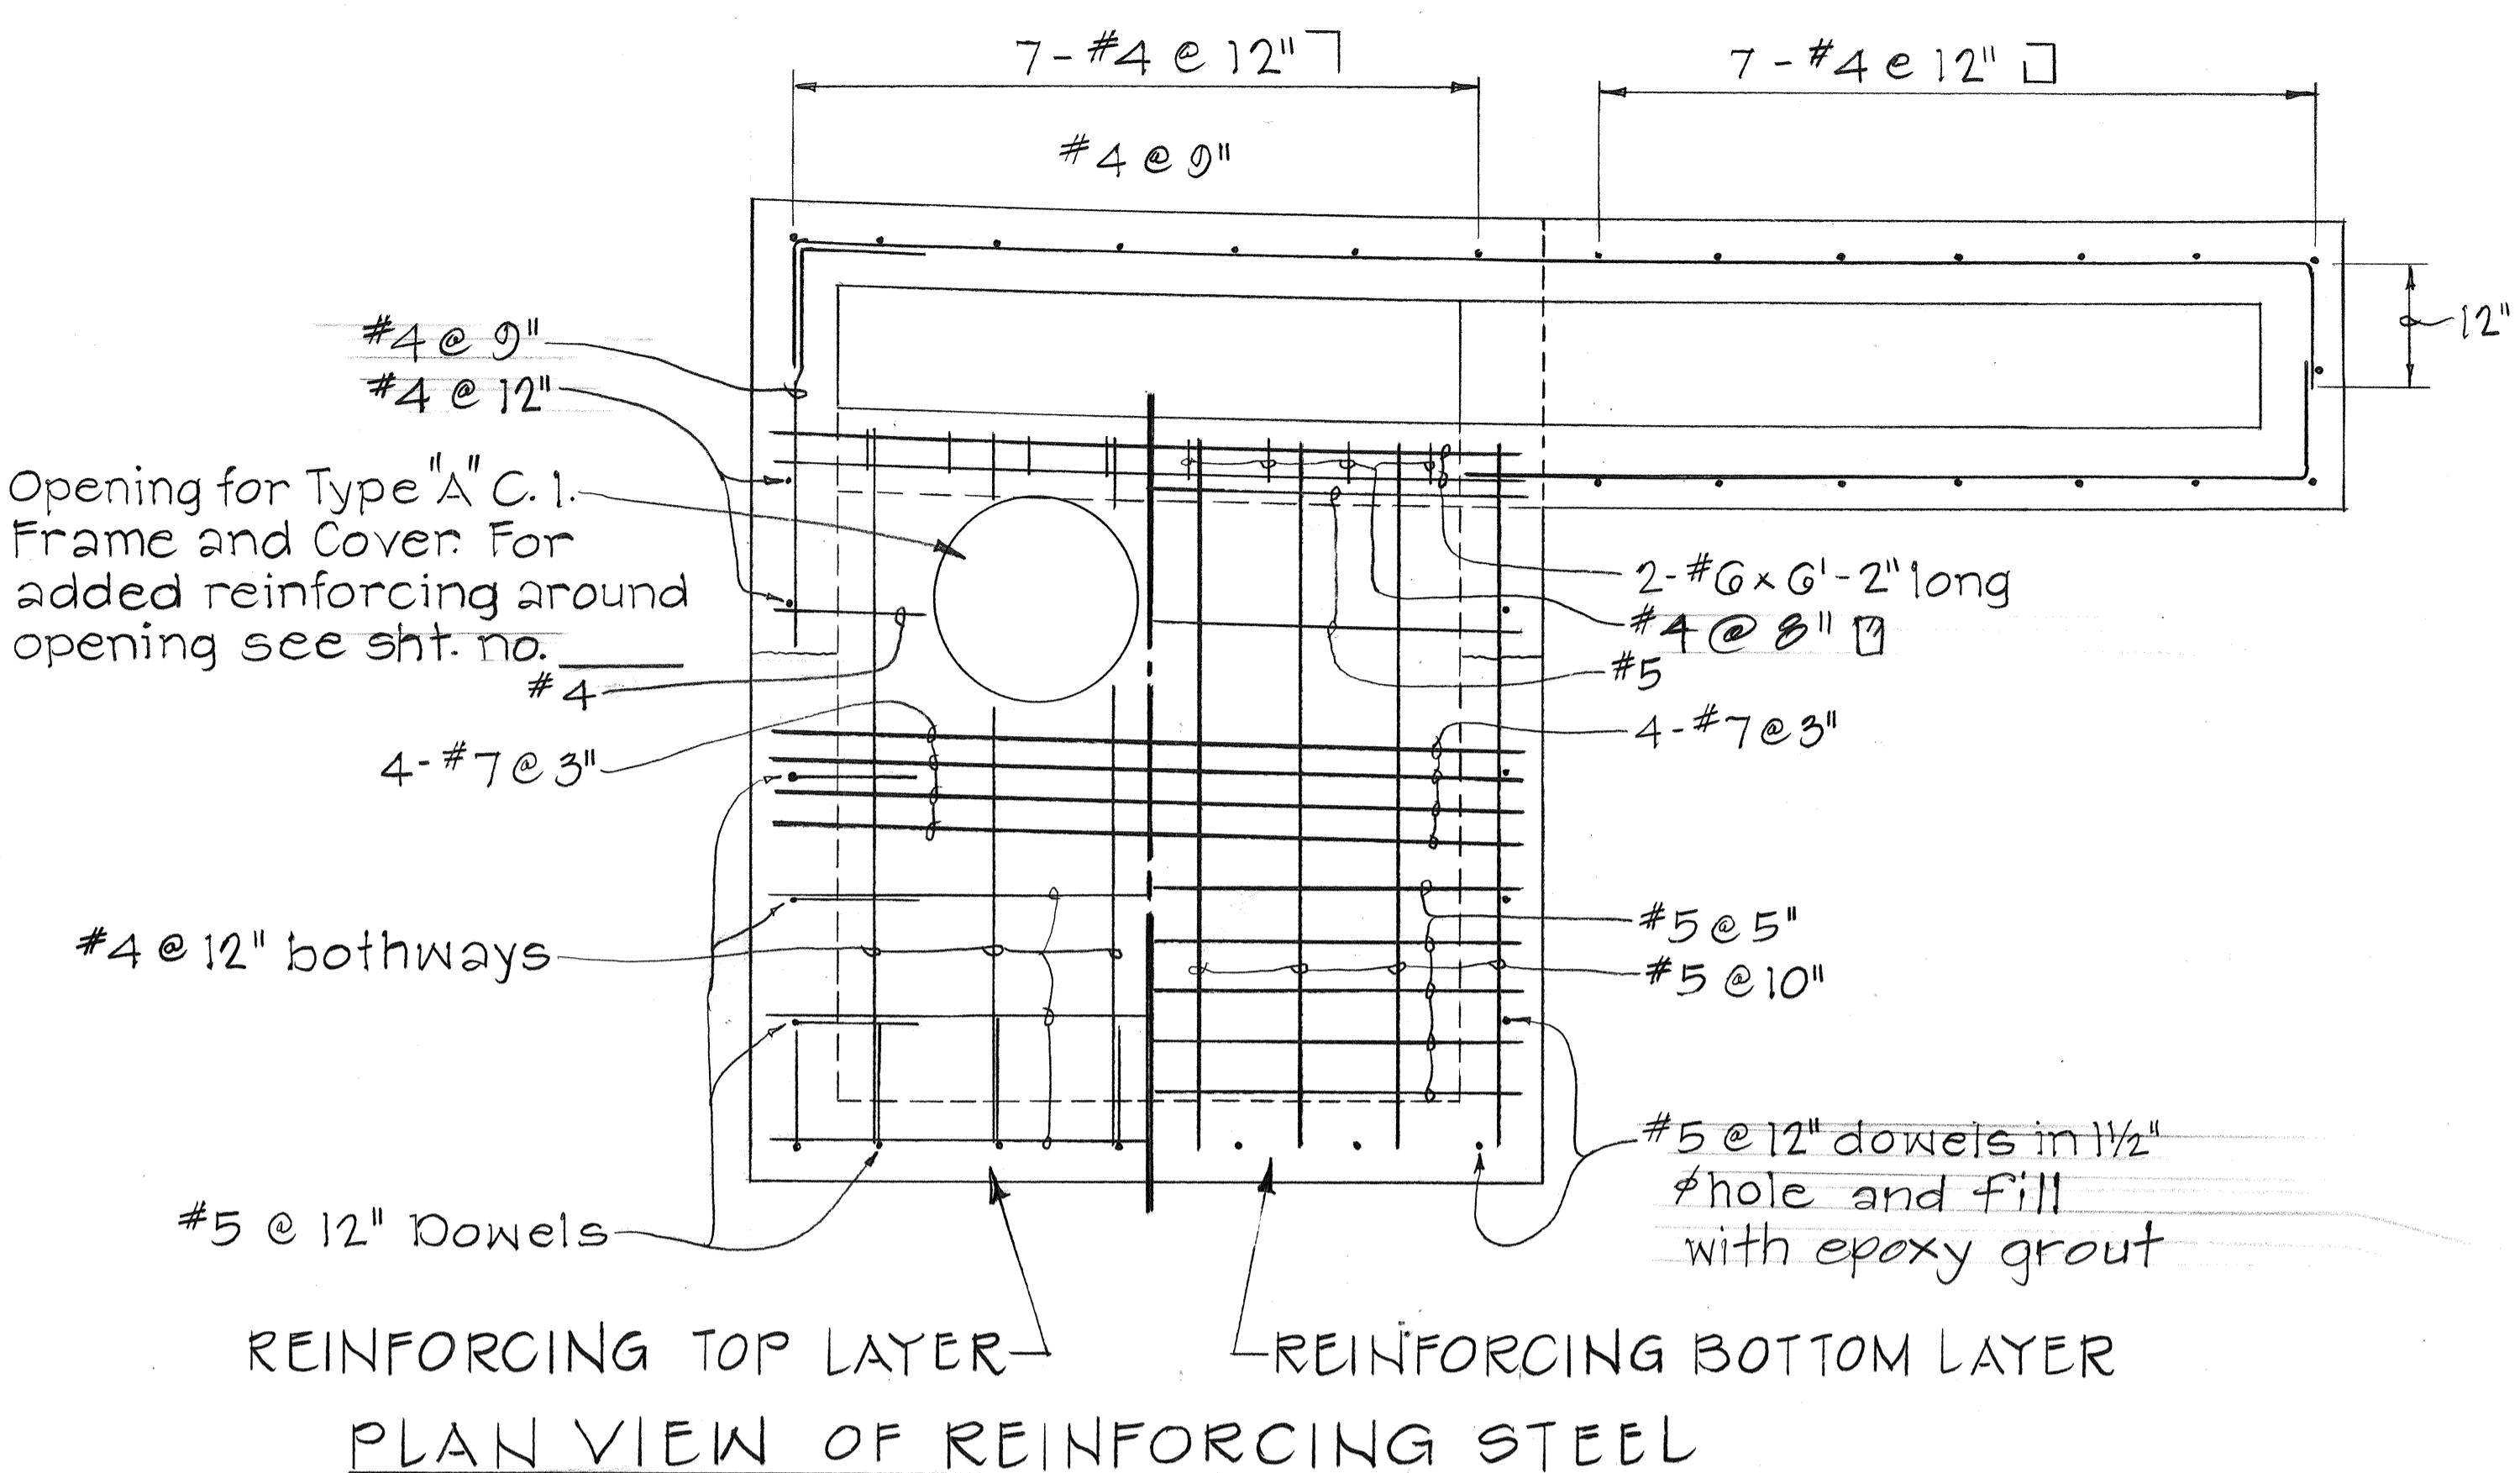


PLAN VIEW OF REINFORCING STEEL

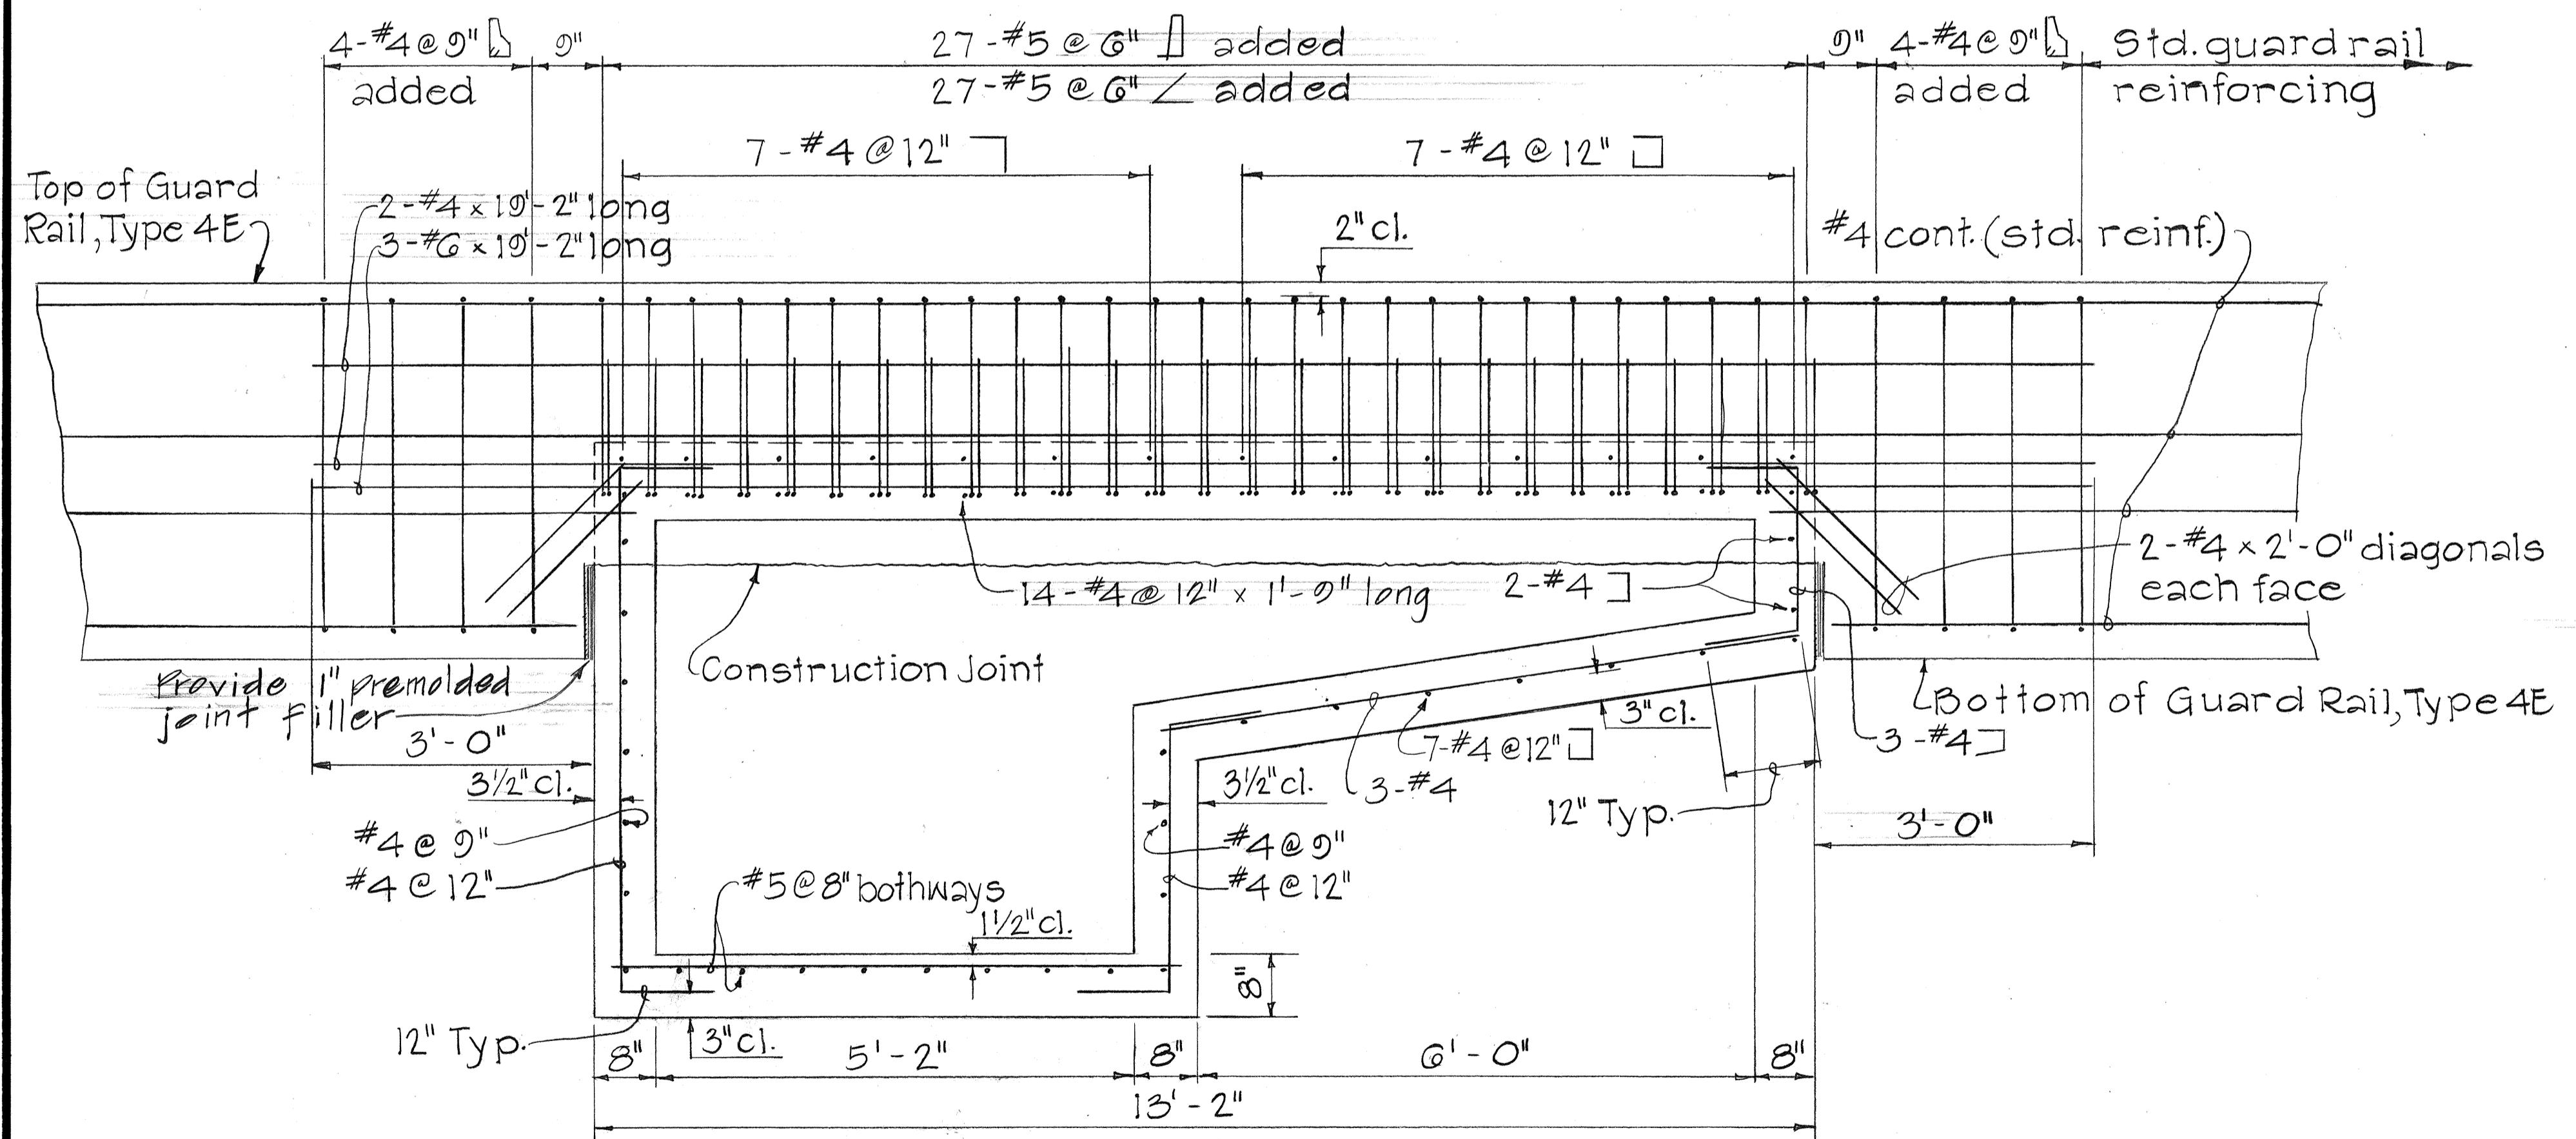


SECTION "D-D"

DETAILS OF MODIFIED TYPE "C" CATCH BASIN AT RAMP "K-4" STA. 0+14


Scale: 3/4" = 1'-0"

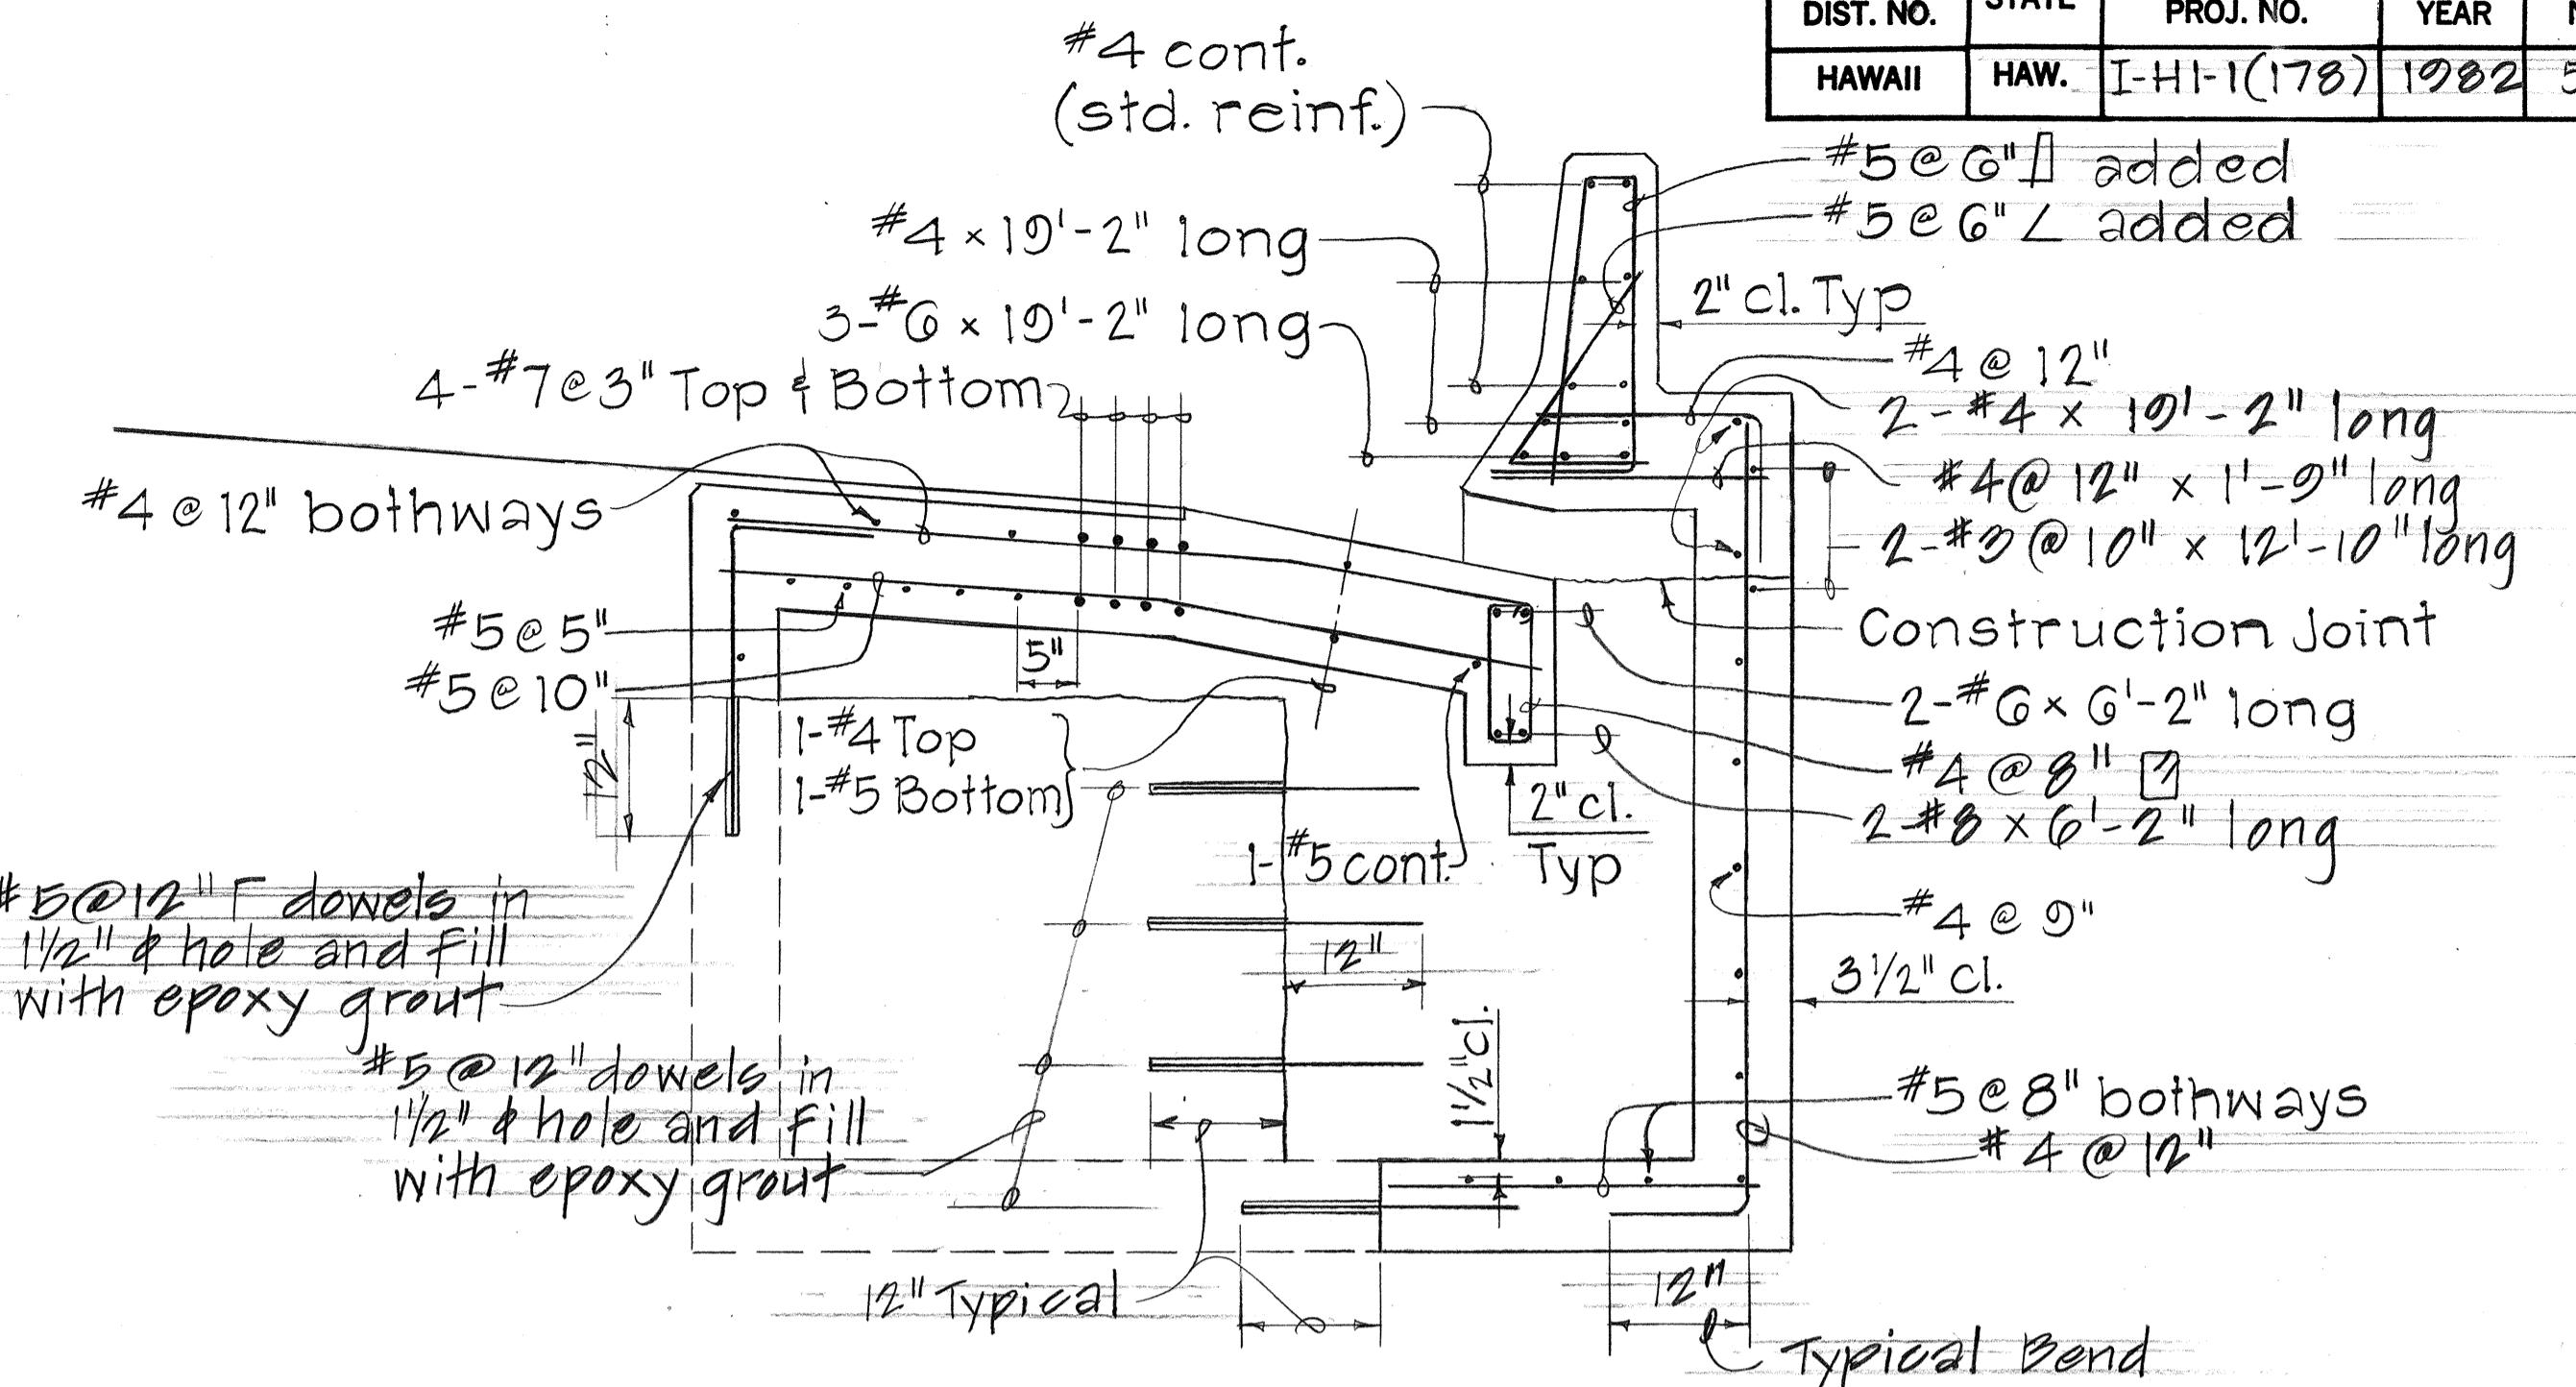

SECTION "E-E"

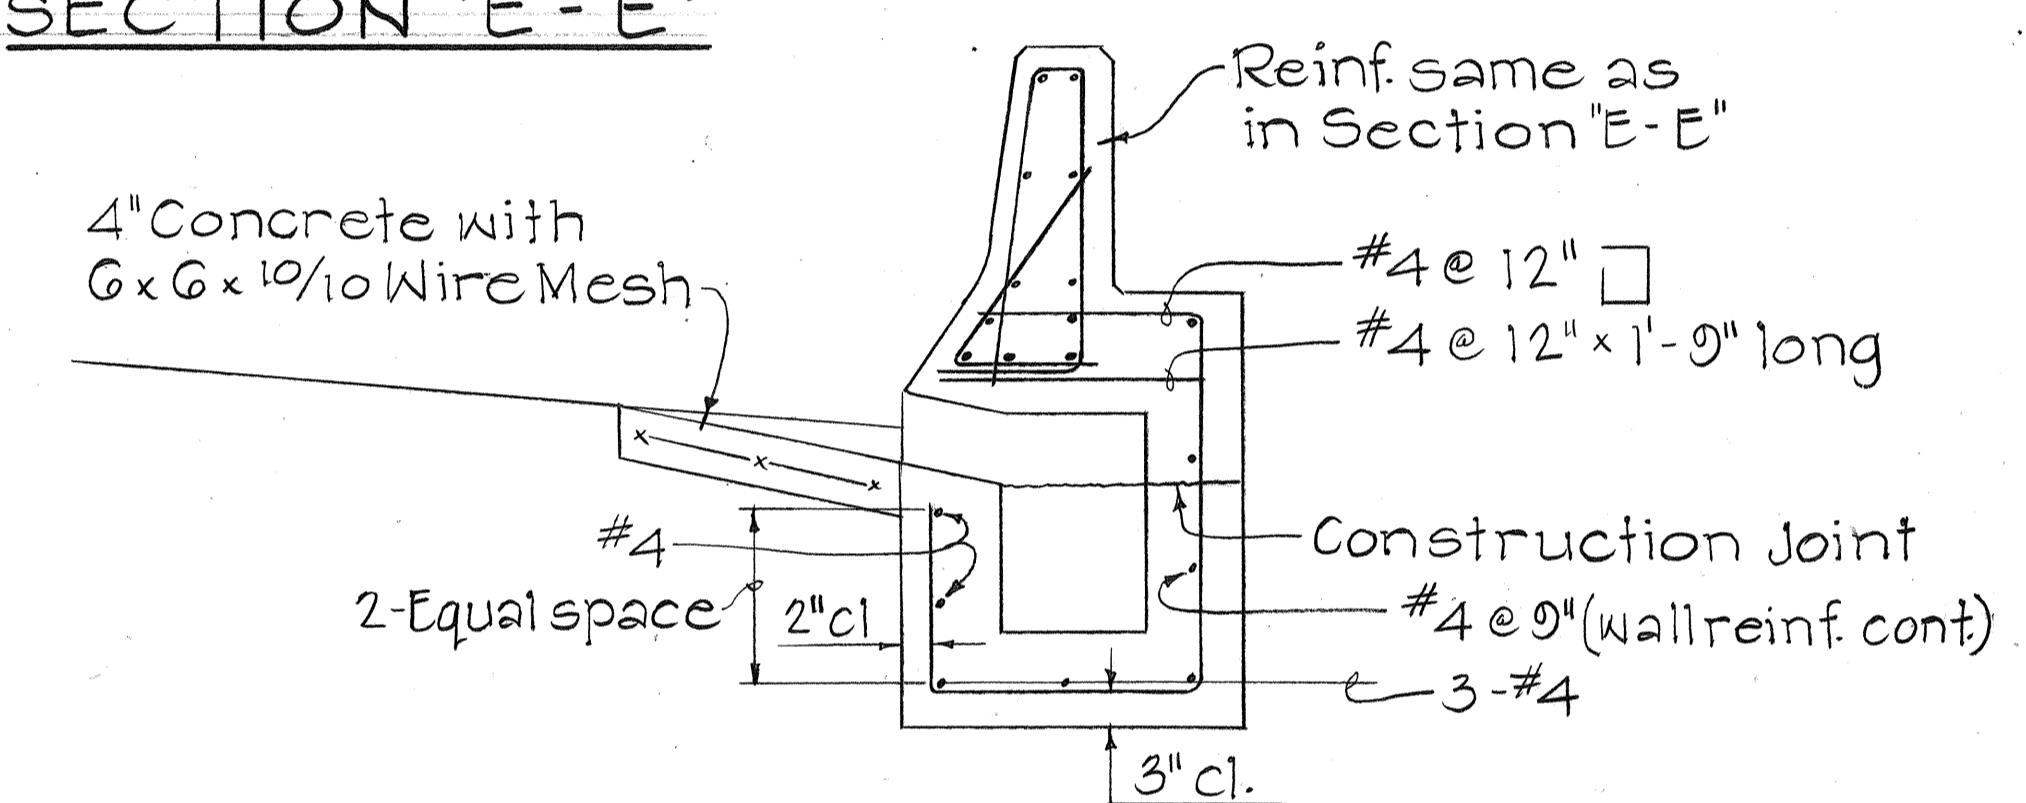



SECTION "F-F"

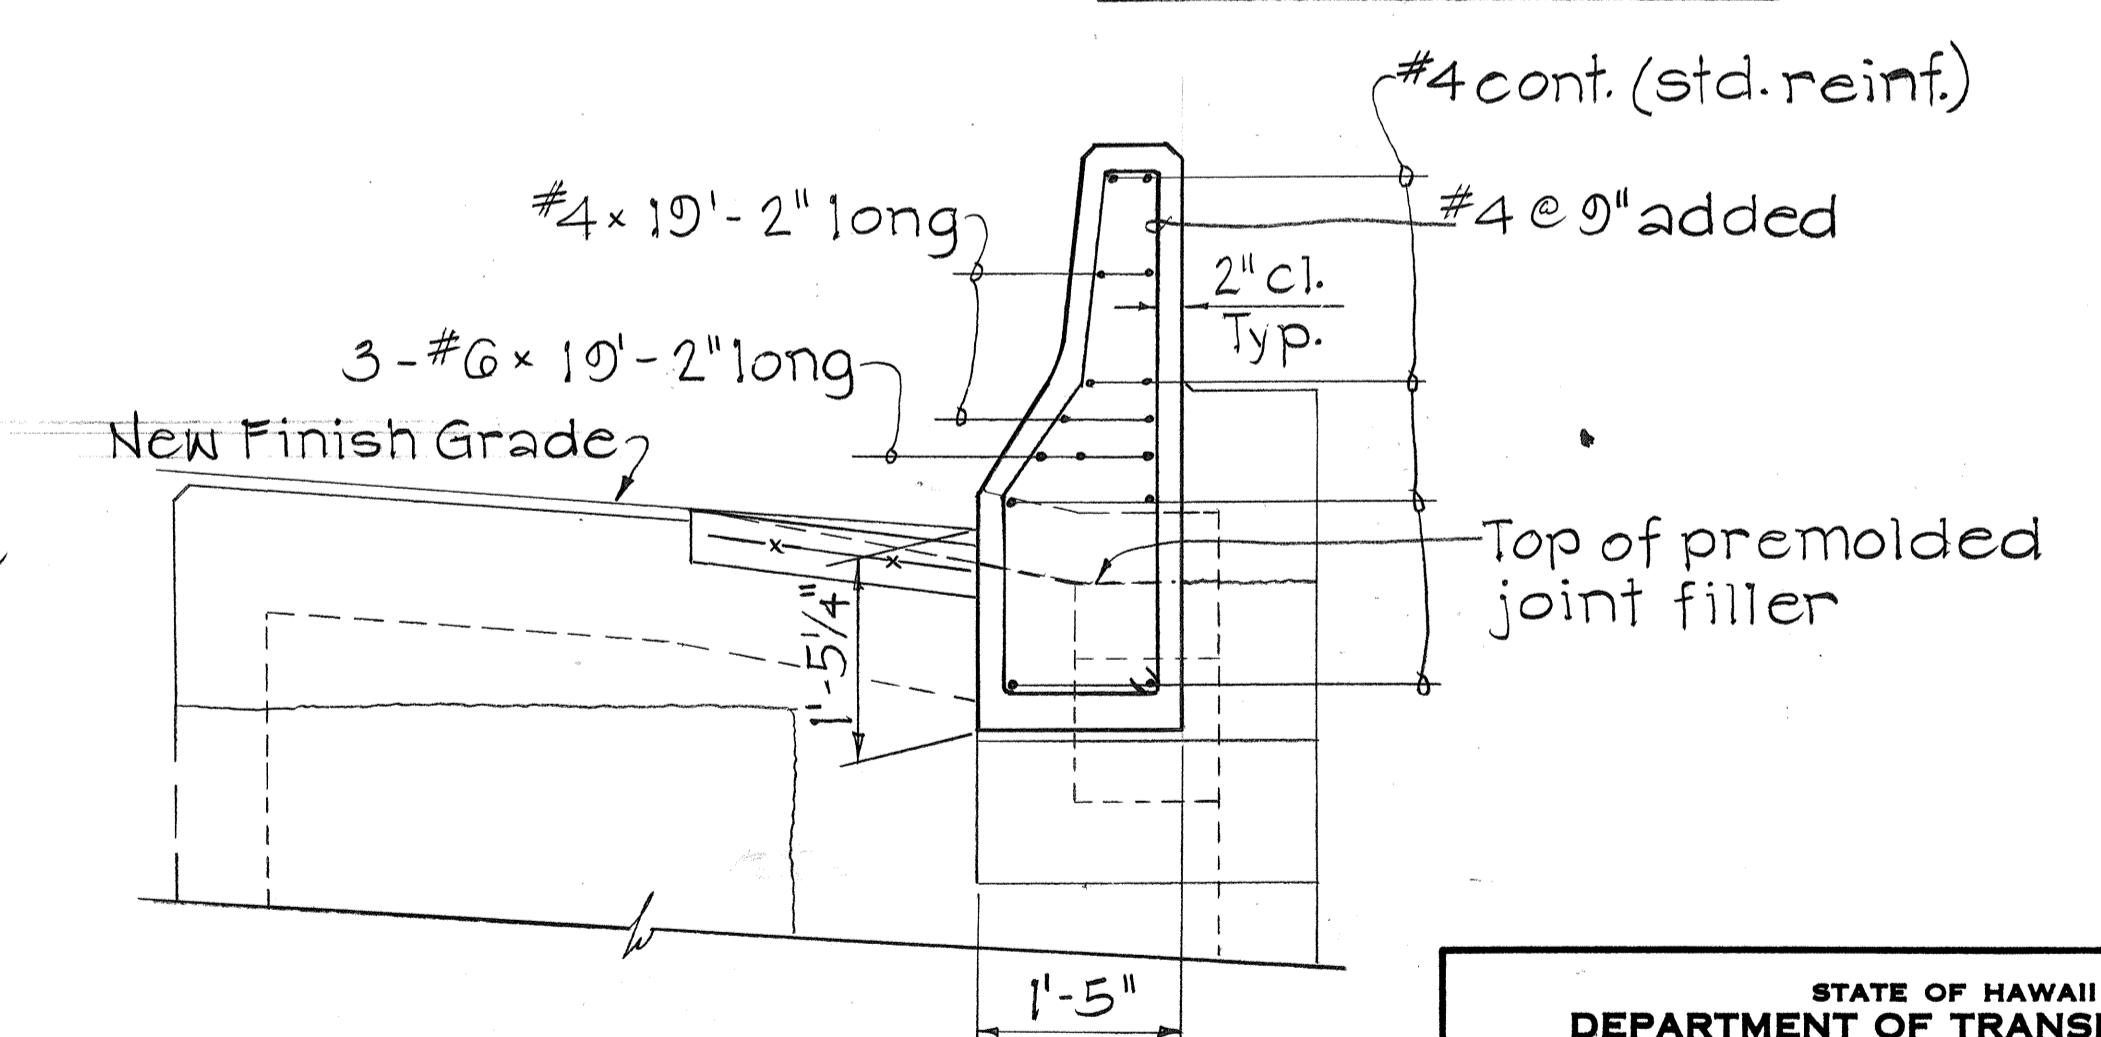


SECTION "G-G"

STATE OF HAWAII
DEPARTMENT OF TRANSPORTATION
HIGHWAYS DIVISION
DRAINAGE DETAILS
INTERSTATE H-I IMPROVEMENTS
MIDDLE STREET TO KALIHI INTERCHANGE
EASTBOUND LANES
F.A.I. PROJECT NO. I-HI-1(178)
SCALE: AS NOTED
SHEET NO. 23 OF 33 SHEETS

FED. ROAD DIST. NO.	STATE	FED. AID PROJ. NO.	FISCAL YEAR	SHEET NO.	TOTAL SHEETS
HAWAII	HAW.	I-HI-1(178)	1982	56	105

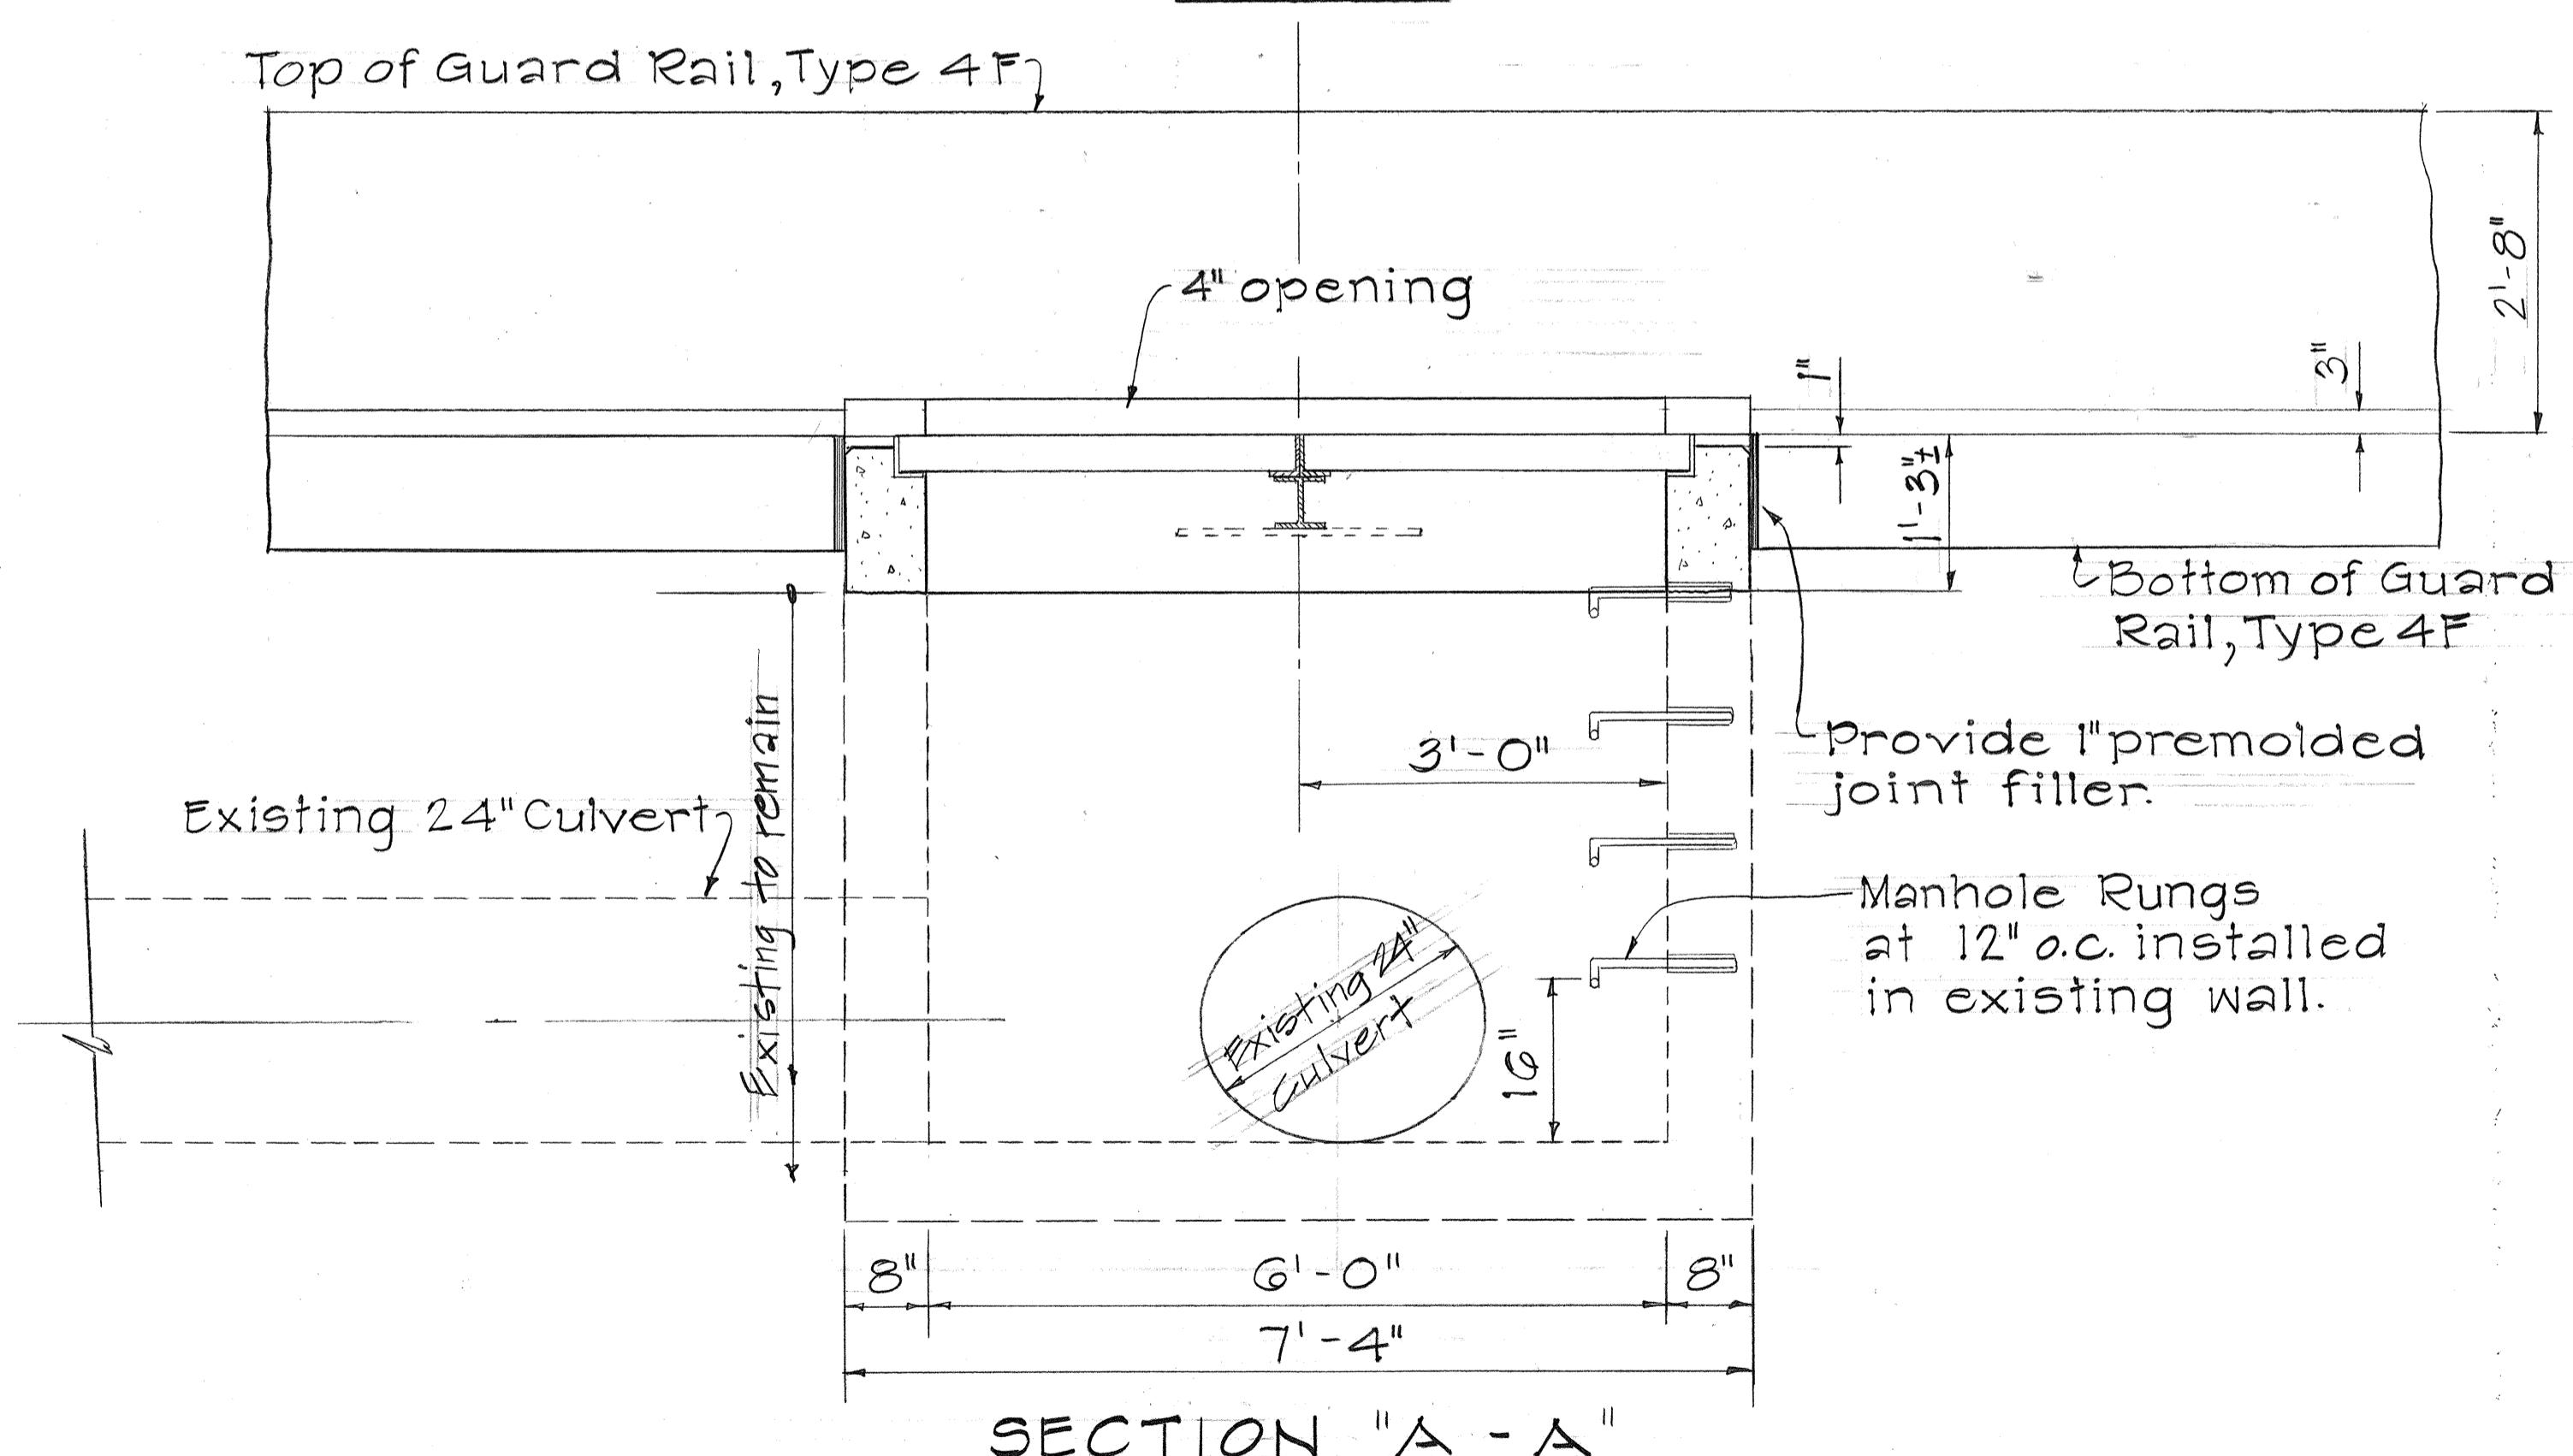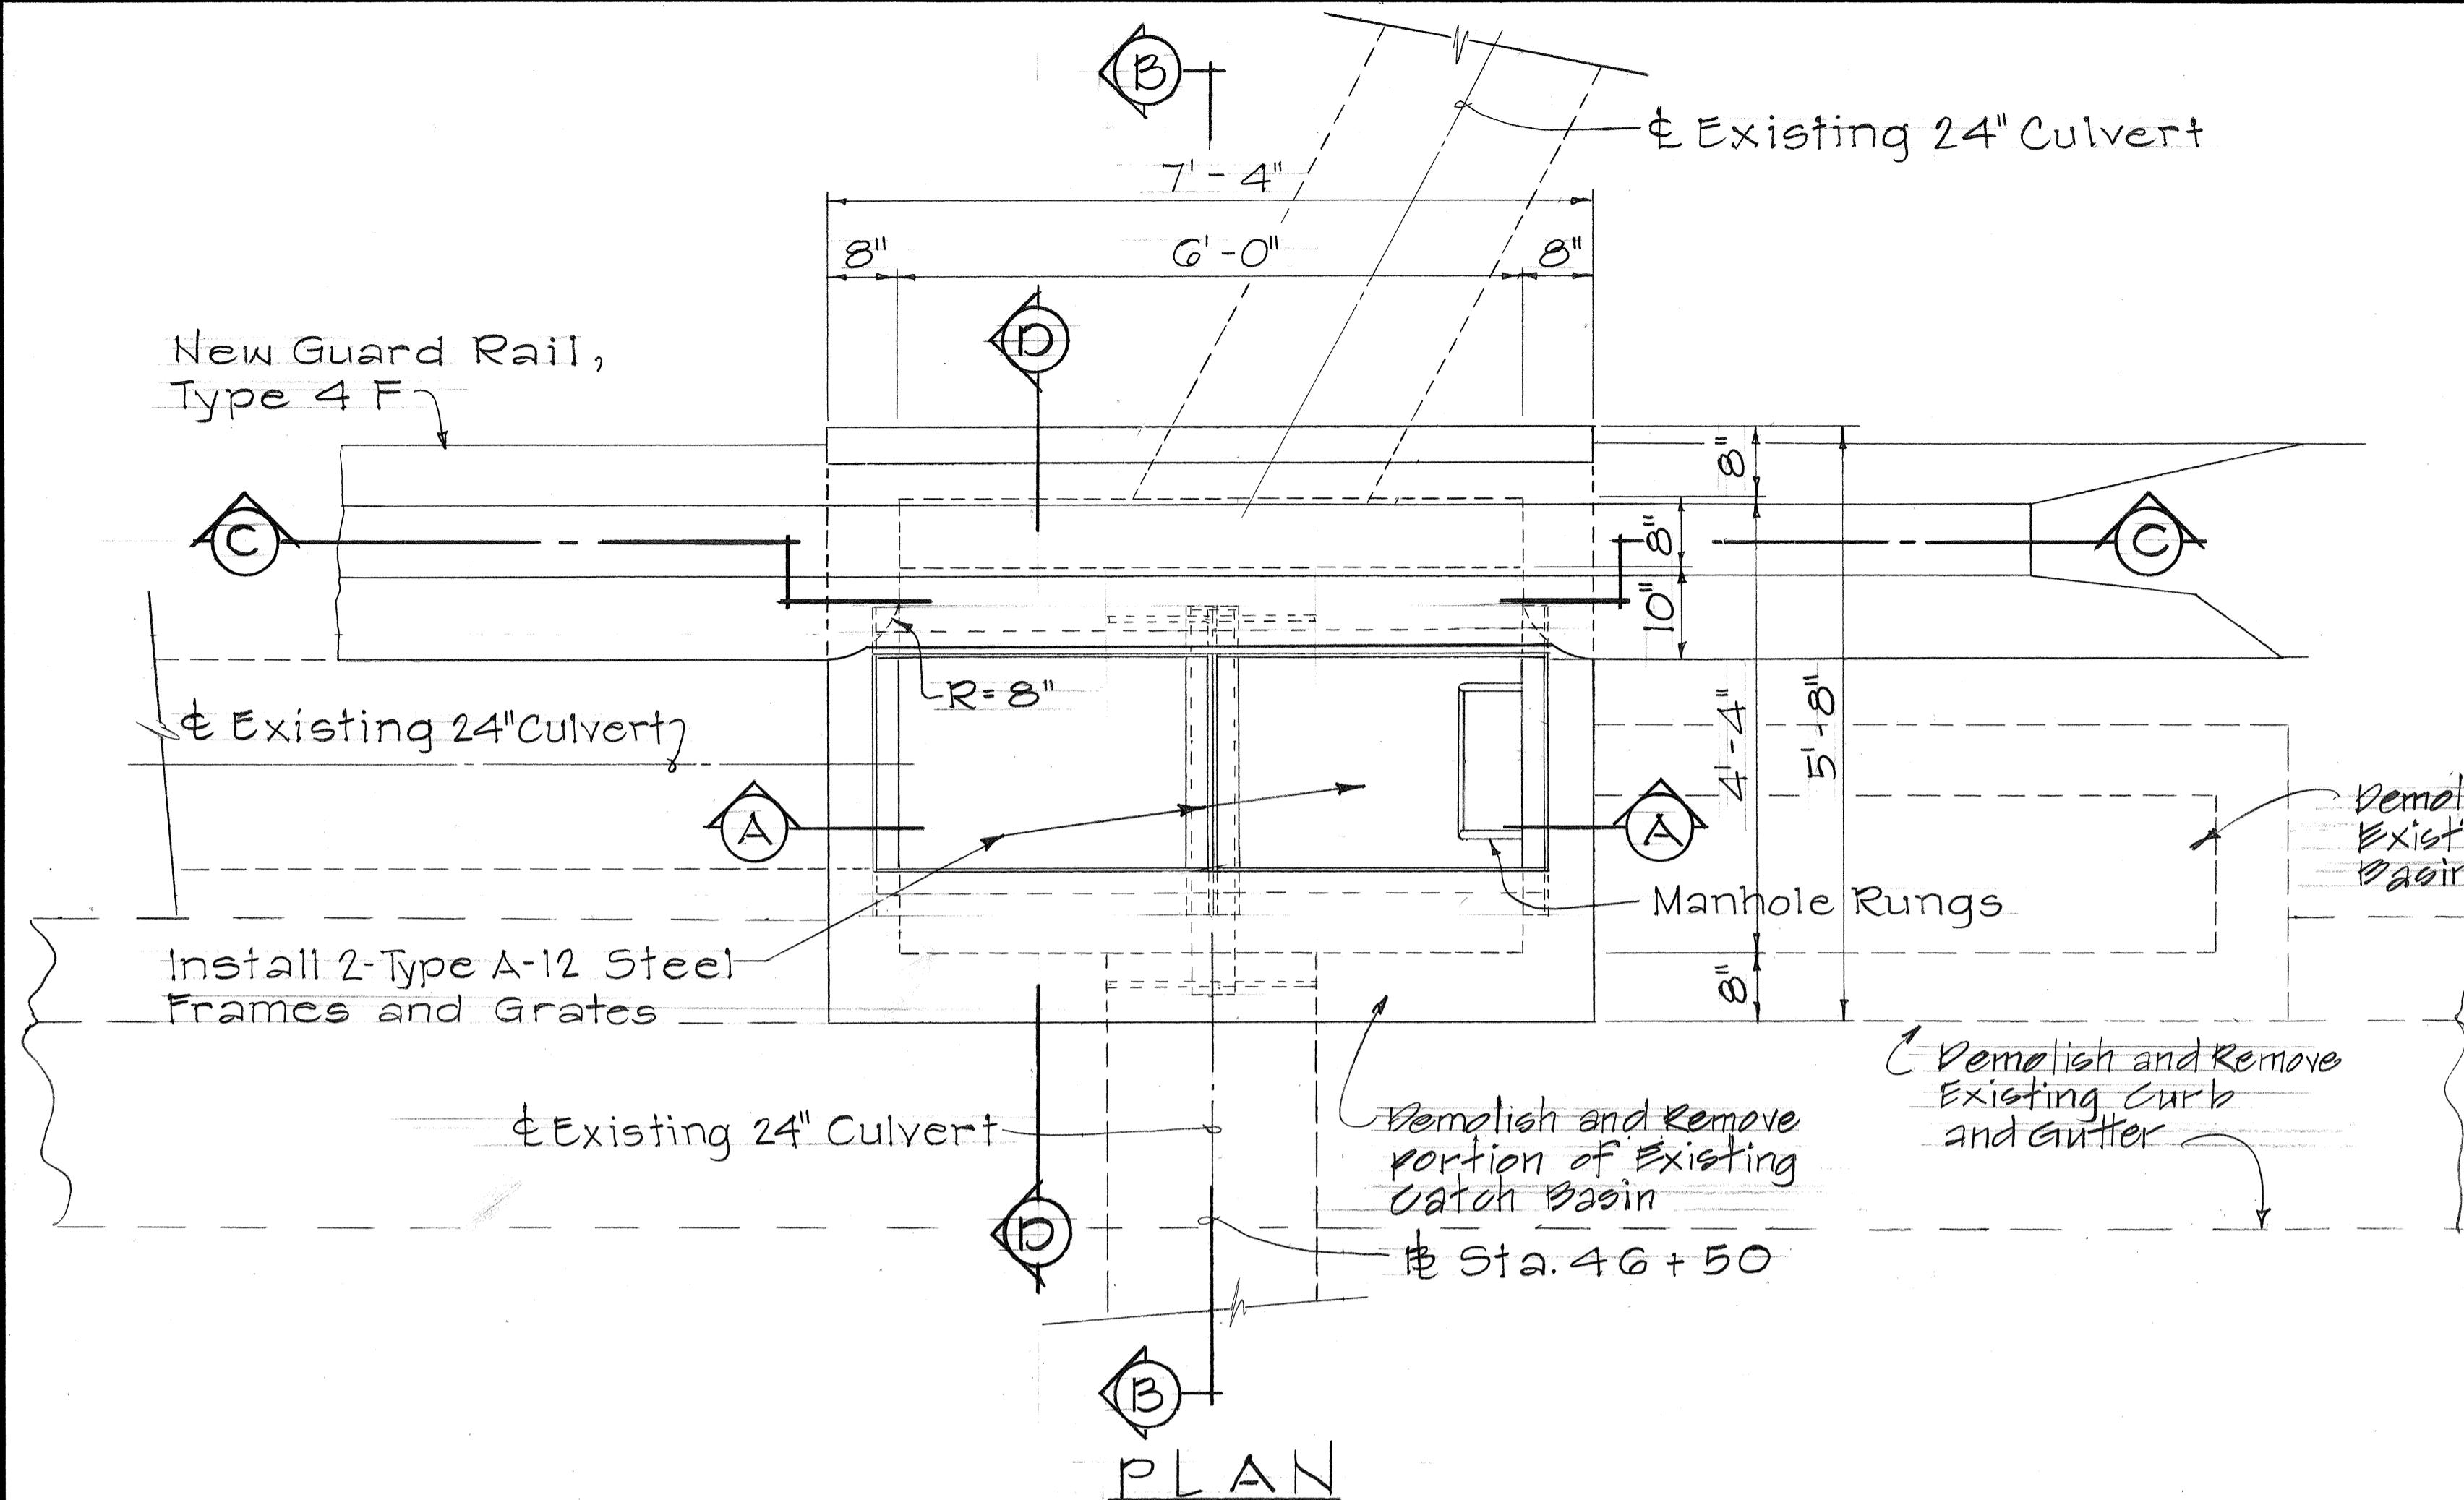



DETAILS OF MODIFIED TYPE 2 GRATED DROP INTAKE AT STA. 4G + 50 RT.
Scale: 3/4" = 1'-0"

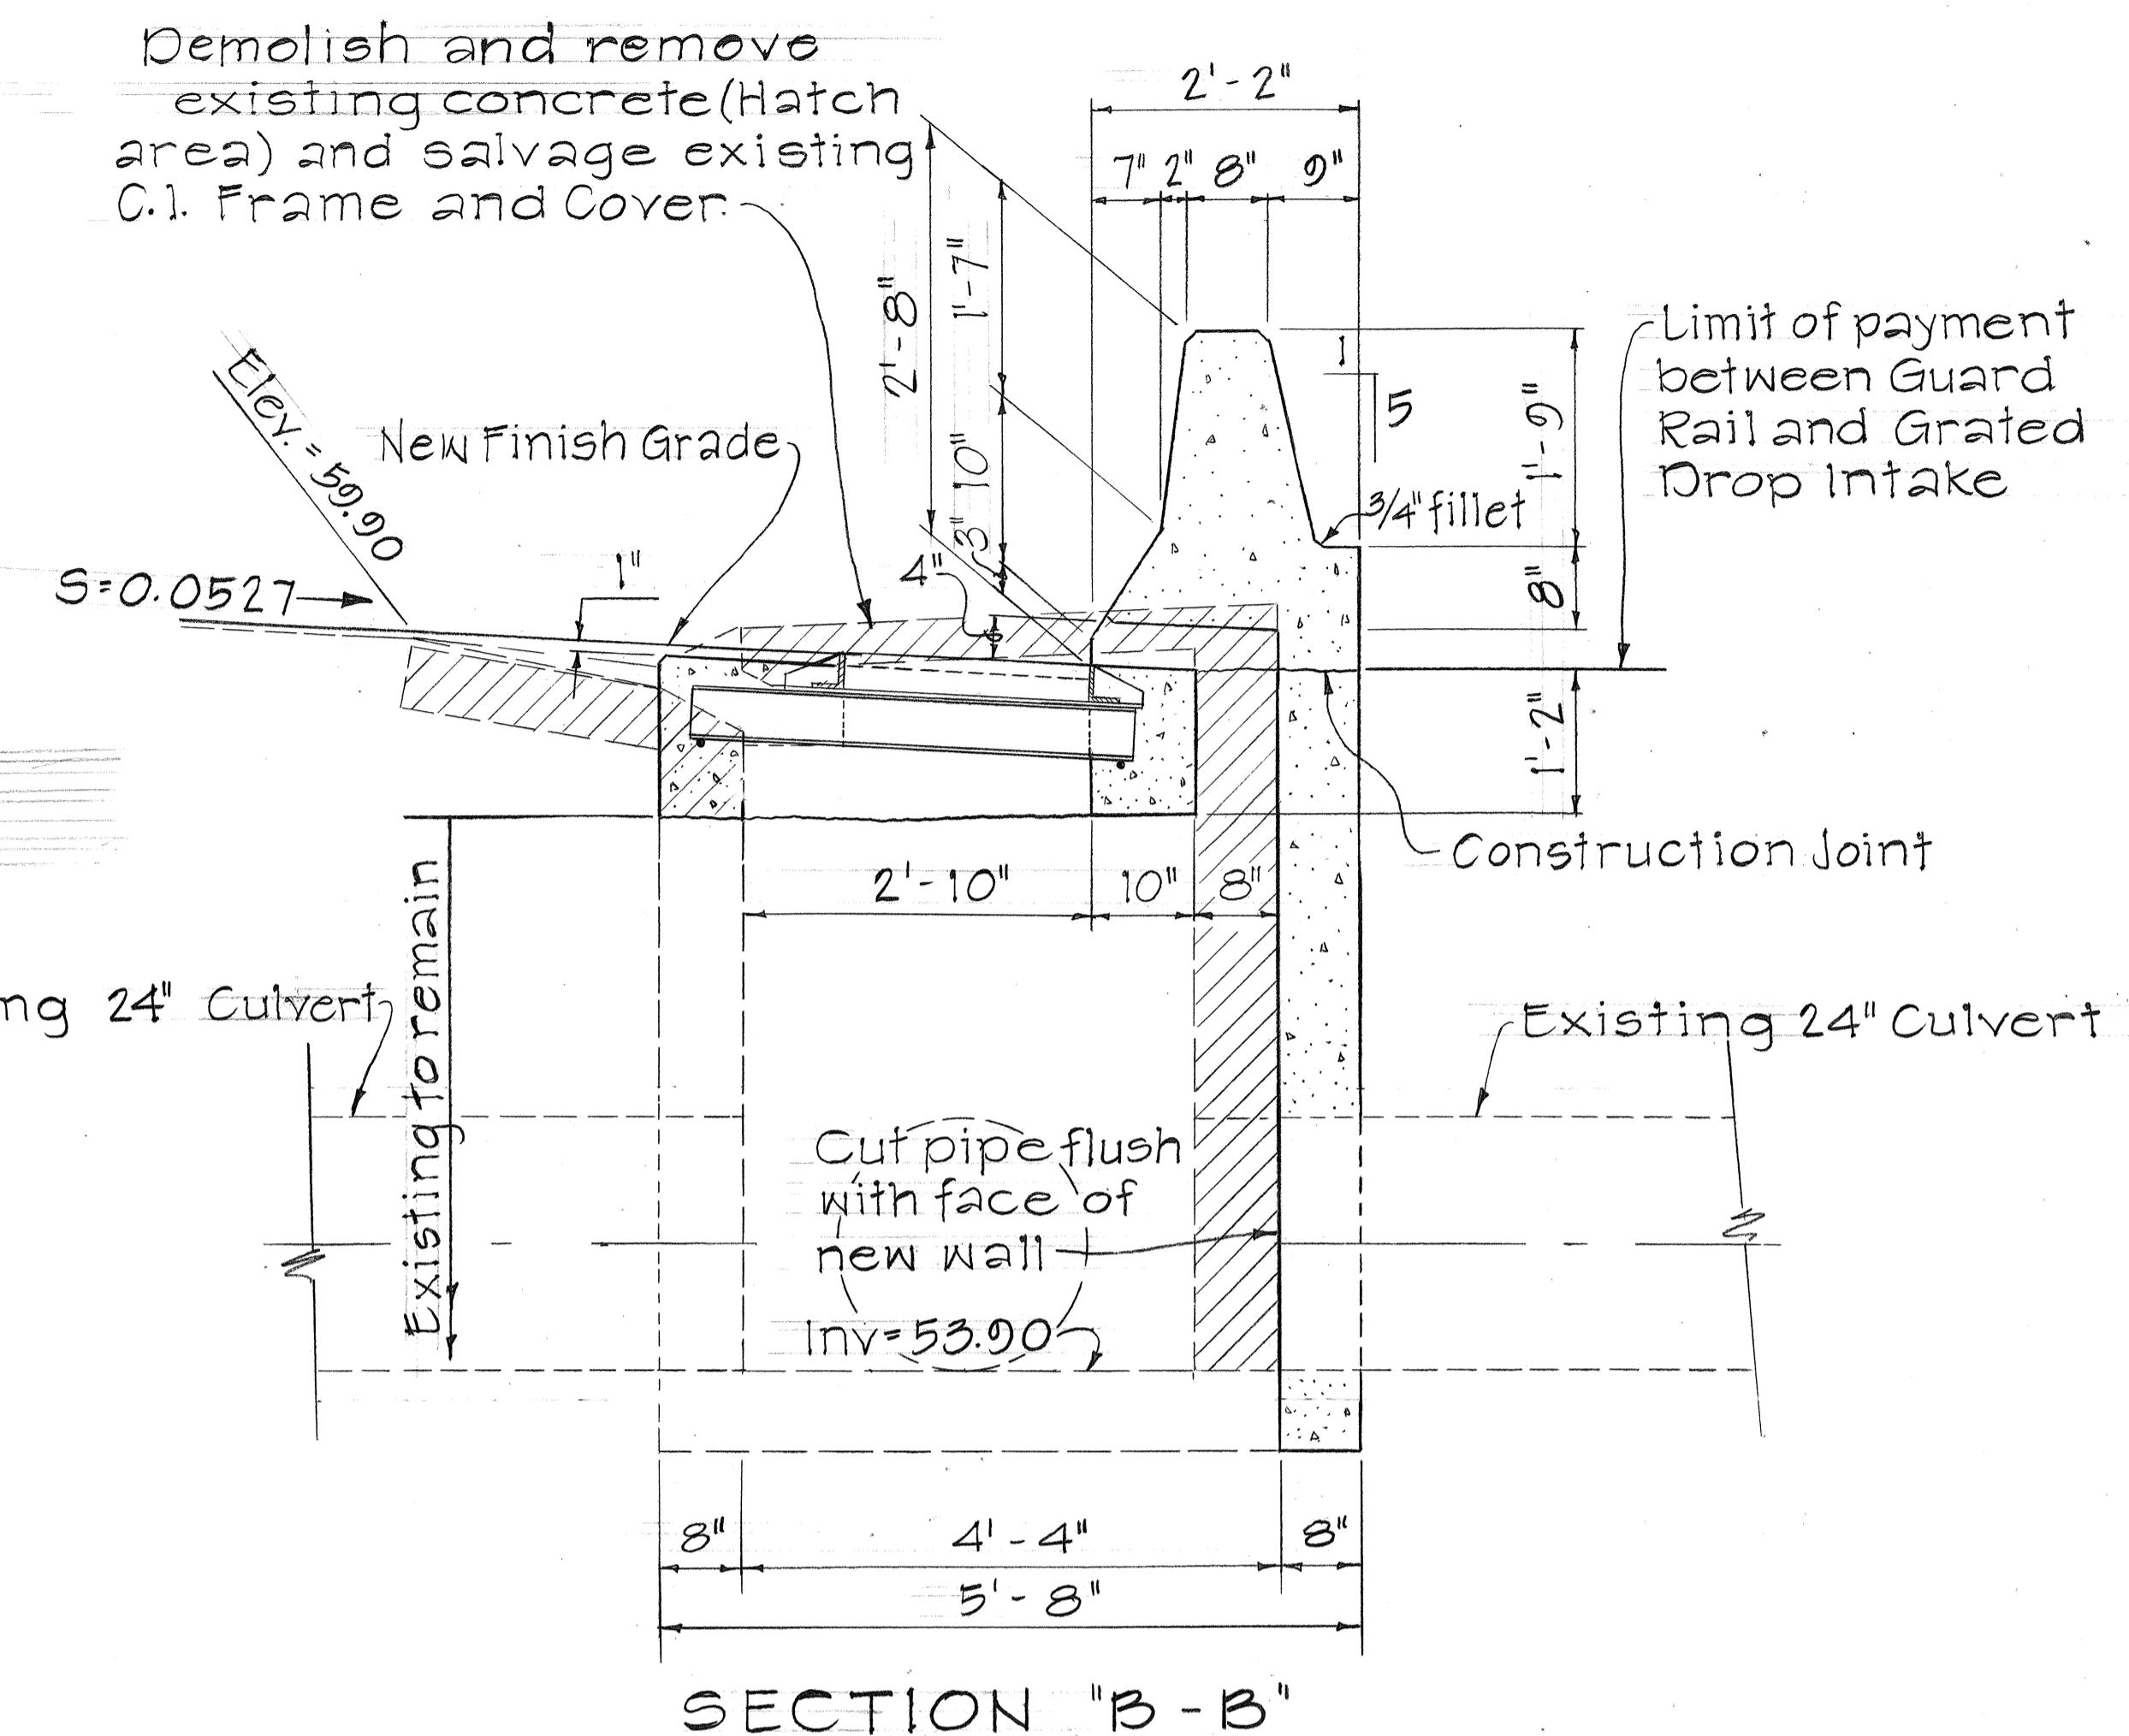

STATE OF HAWAII
DEPARTMENT OF TRANSPORTATION
HIGHWAYS DIVISION
DRAINAGE DETAILS
INTERSTATE H-I IMPROVEMENTS
MIDDLE STREET TO KALIHI INTERCHANGE
EASTBOUND LANES
F.A.I. PROJECT NO. I-HI-K178
SCALE: AS NOTED
SHEET NO. 24 OF 33 SHEETS



ORIGINAL SURVEY PLOTTED BY	DATE
PLAN DRAWN BY	
NOTES ADDED BY	
QUANTITIES BY	
CHECKED BY	
NOTE BOOK No.	

FED. ROAD DIST. NO.	STATE	FED. AID PROJ. NO.	FISCAL YEAR	HEET NO.	TOTAL SHEETS
HAWAII	HAW.	I-HI-1(178)	1982	57	165

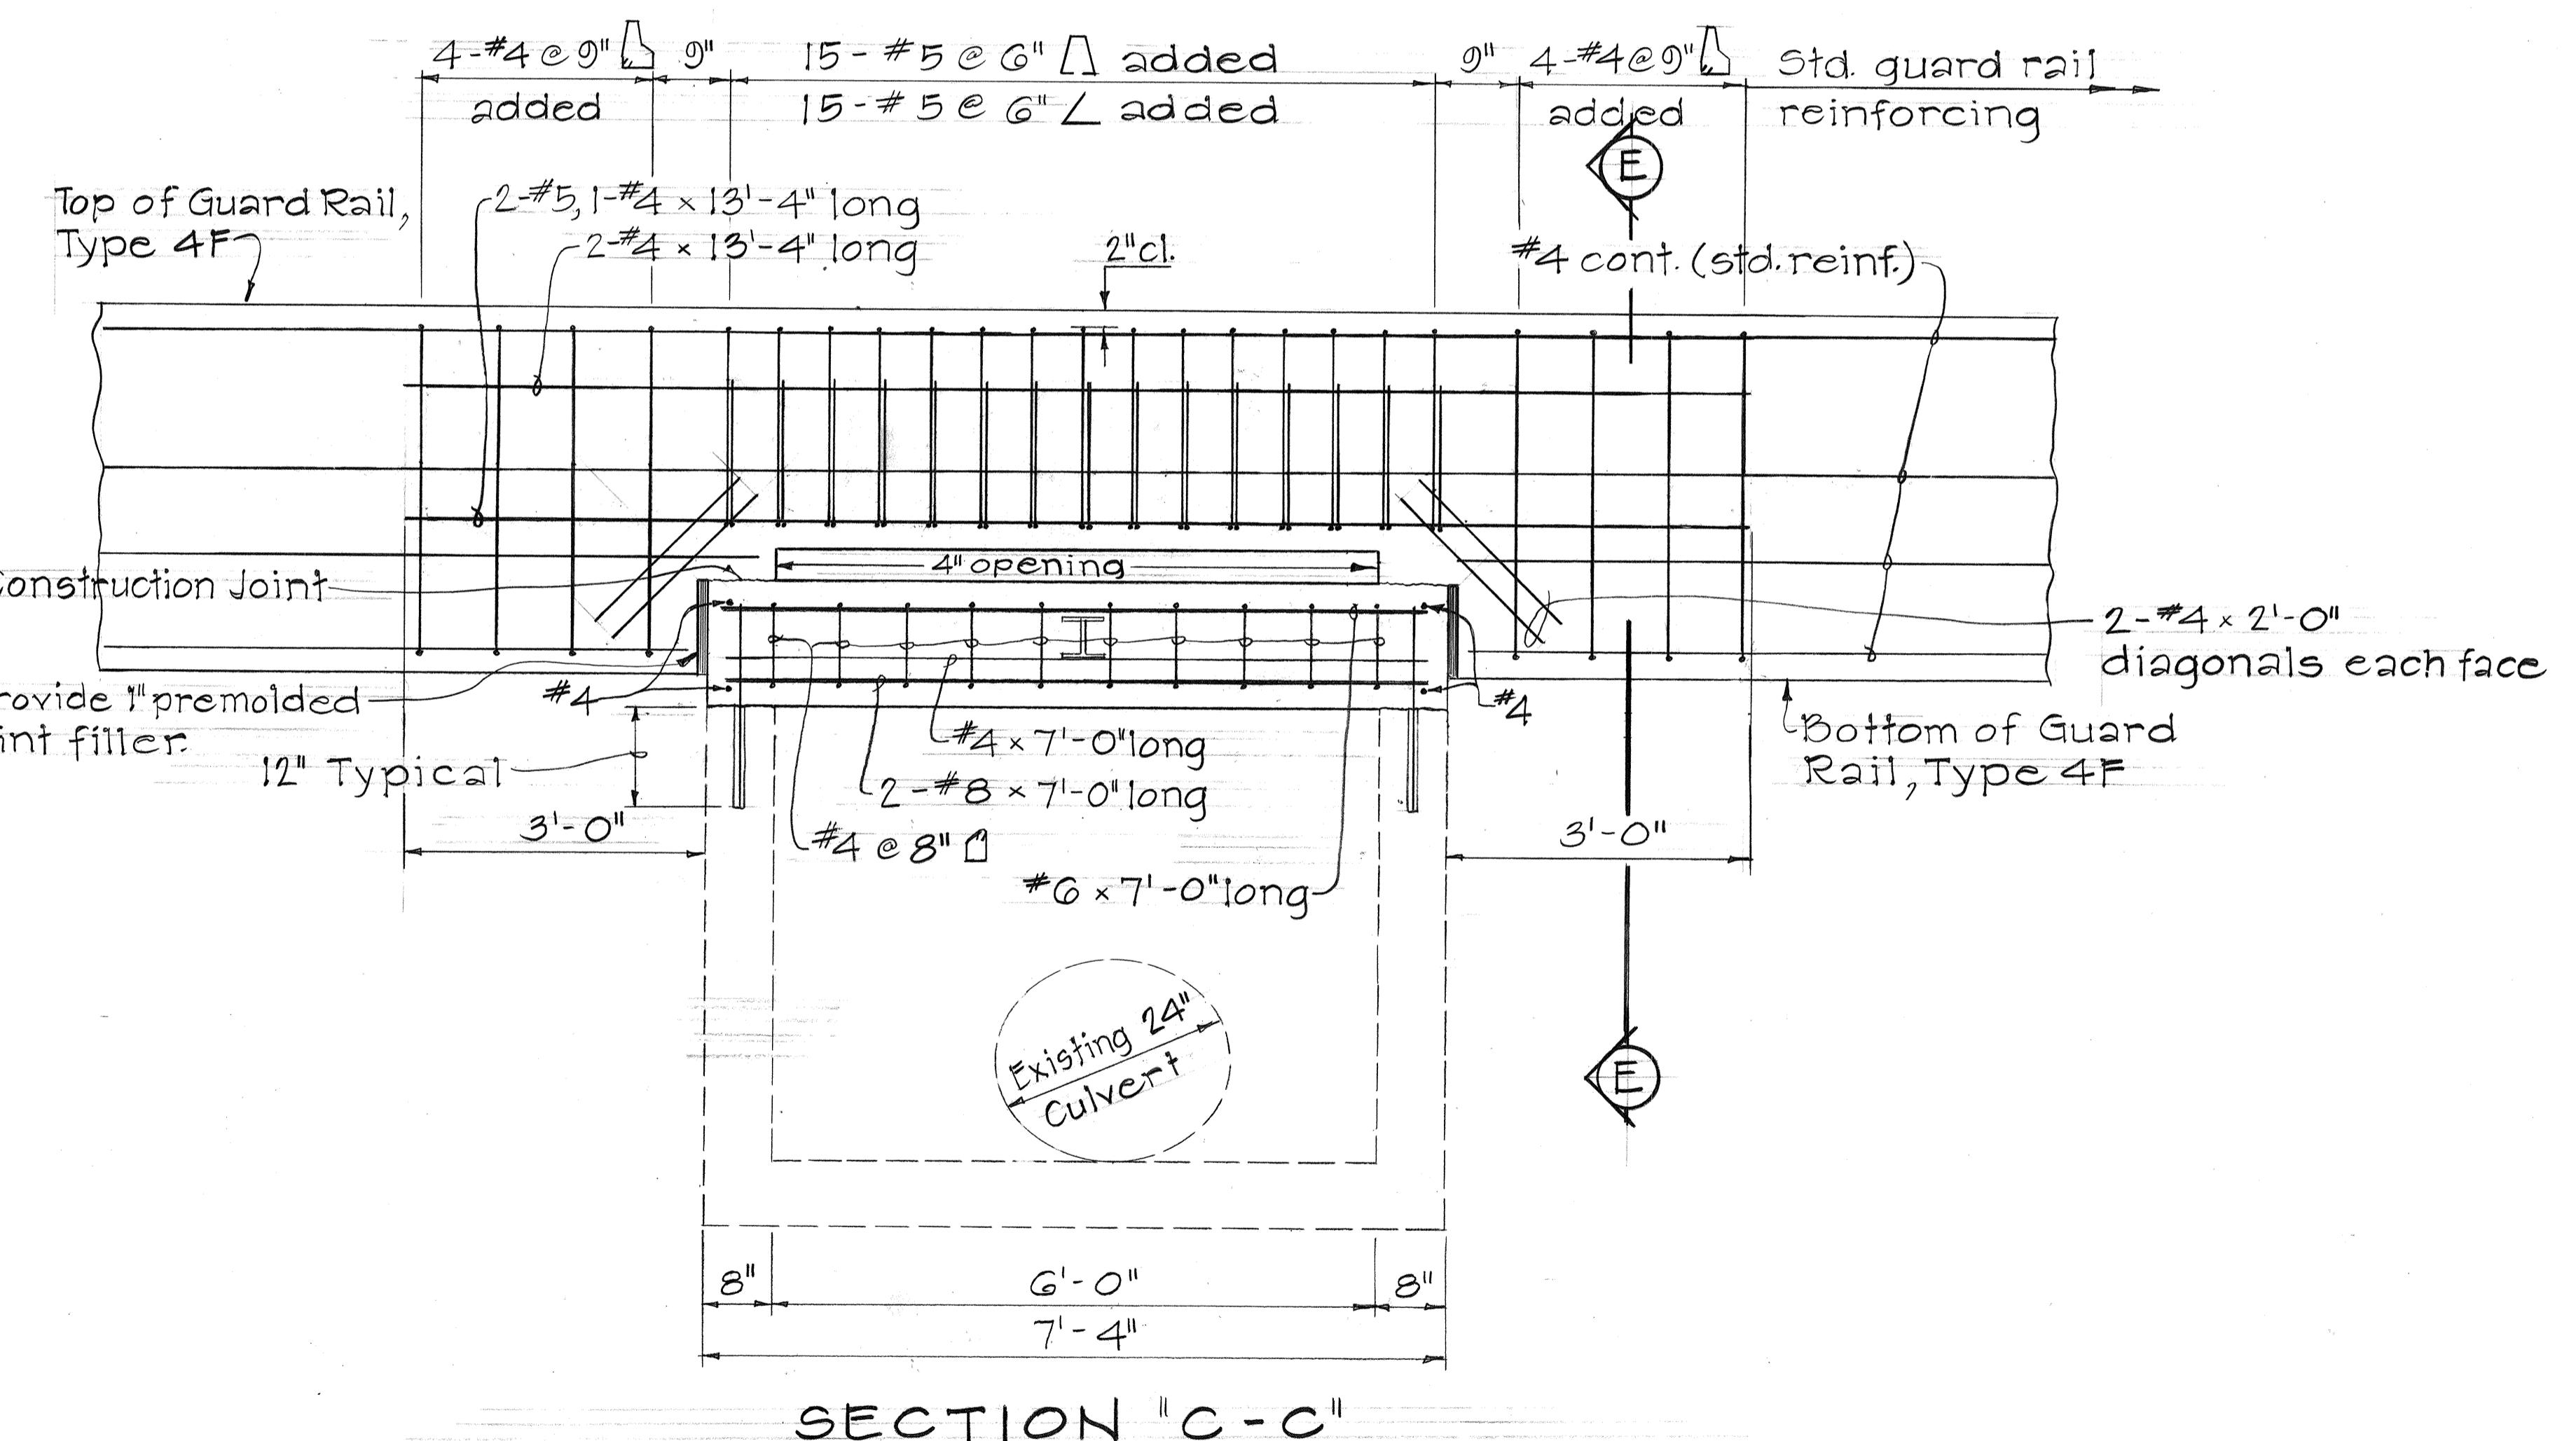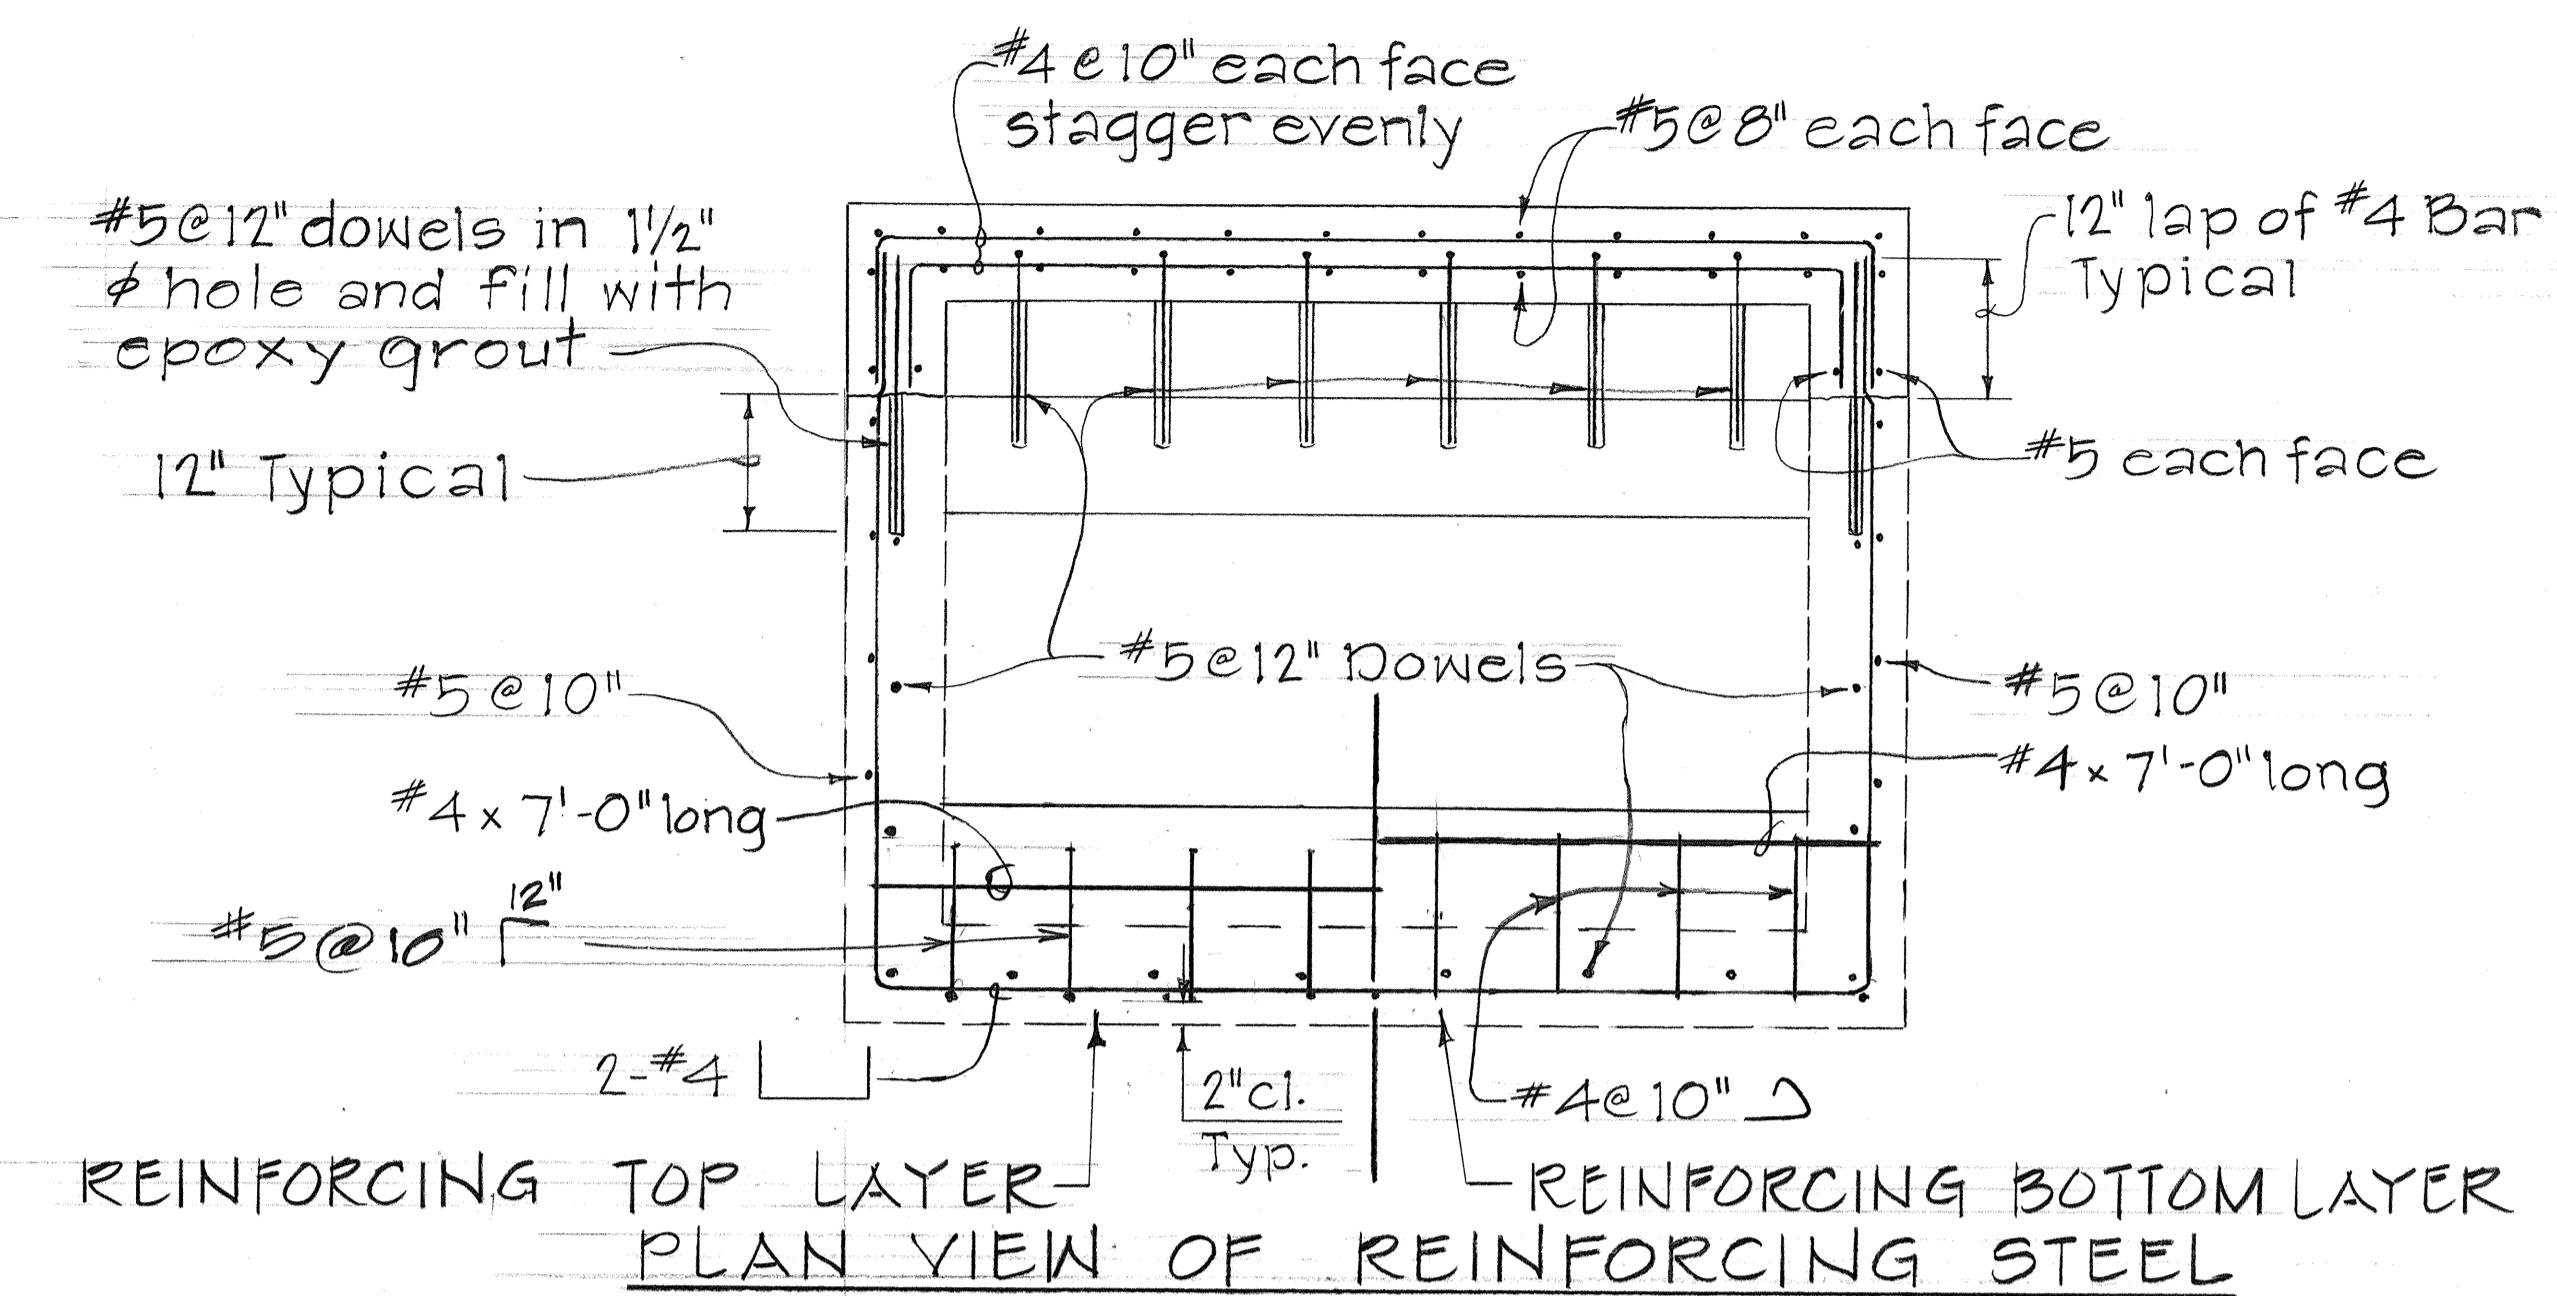

DETAILS OF MODIFIED TYPE 2 GRATED DROP INTAKE AT STA. 46+50 RT.

Scale: 3/4" = 1'-0"

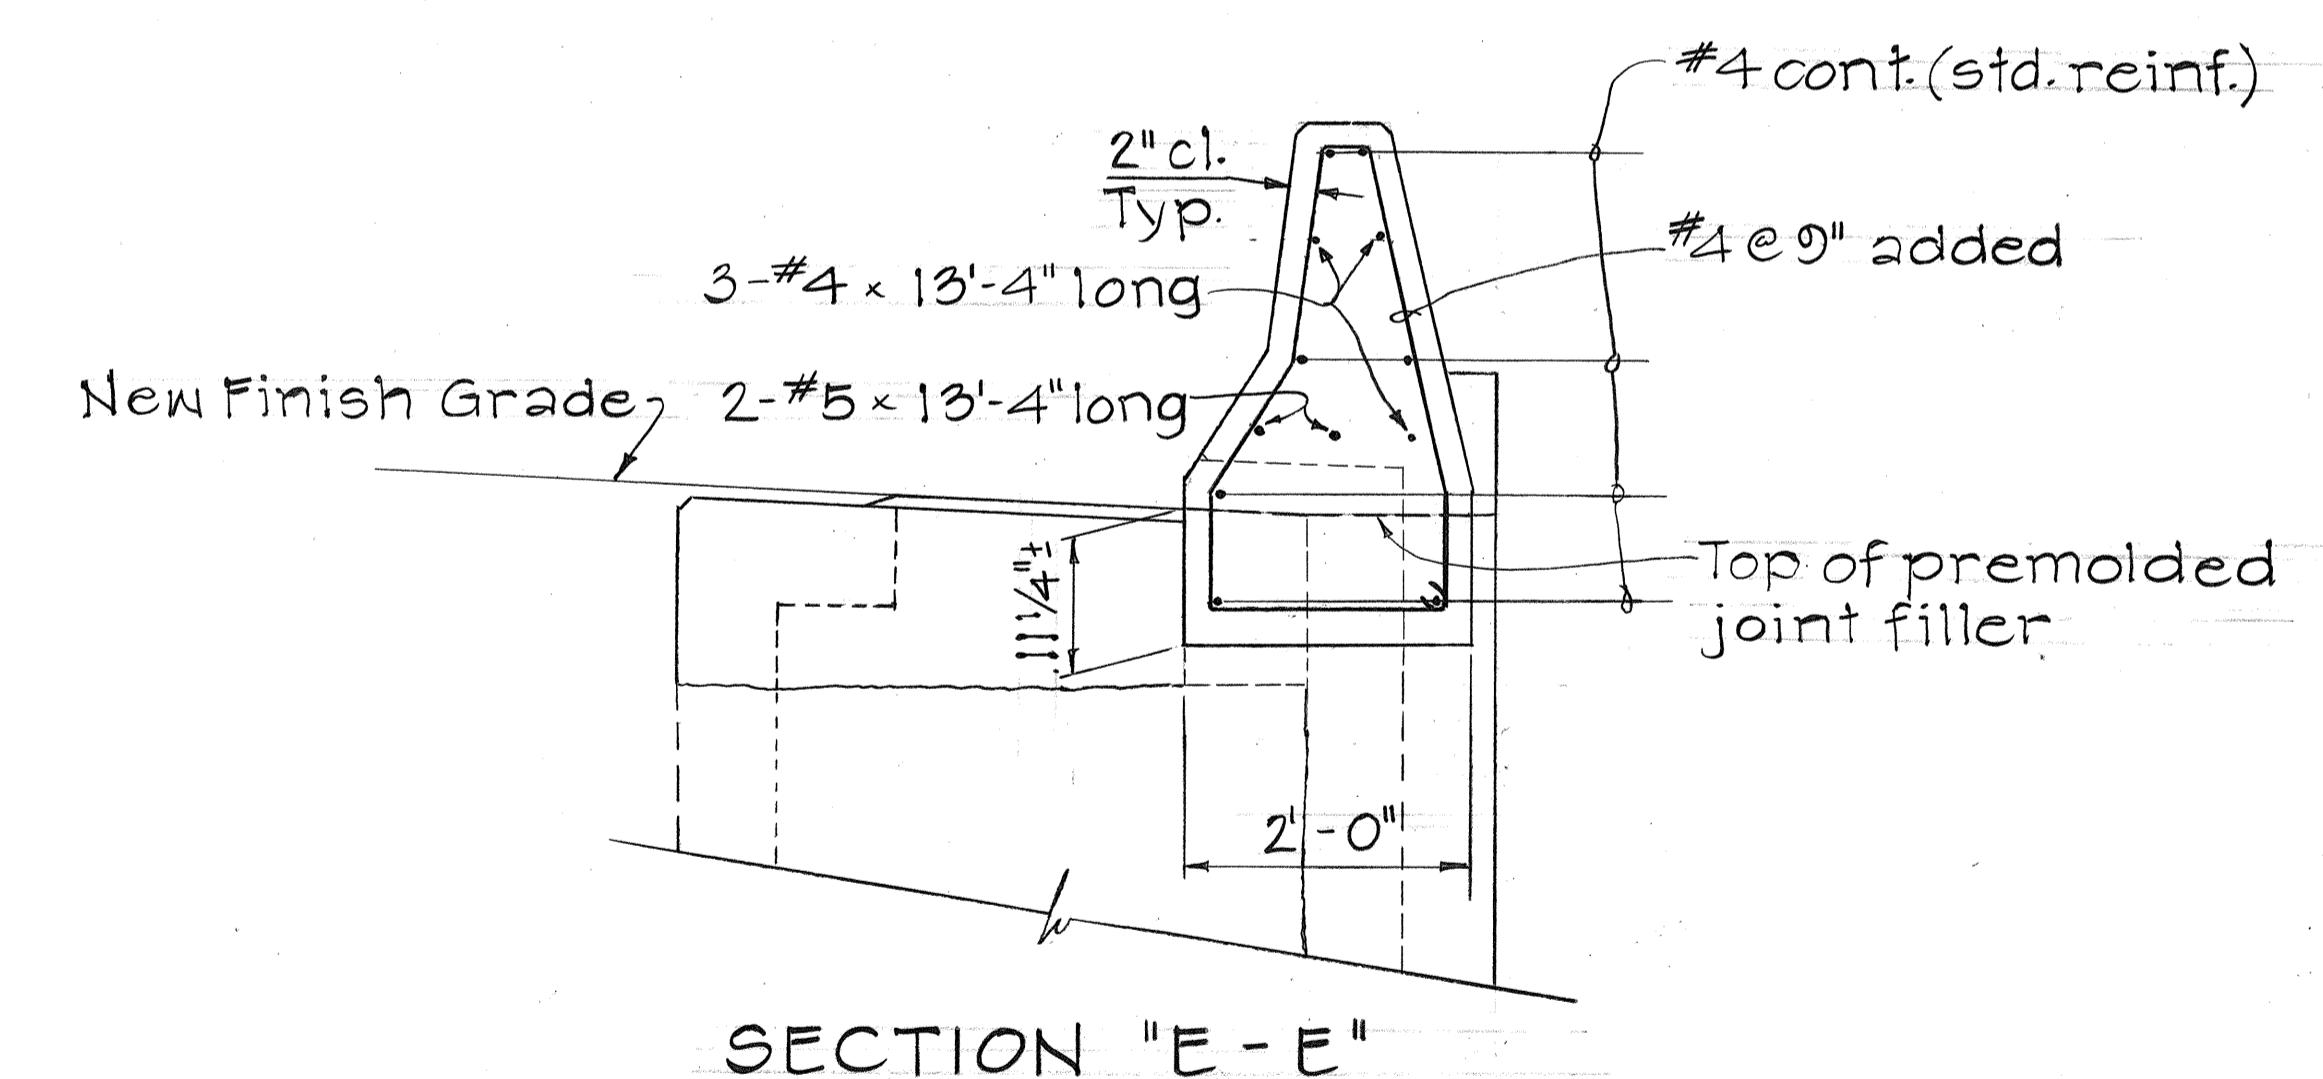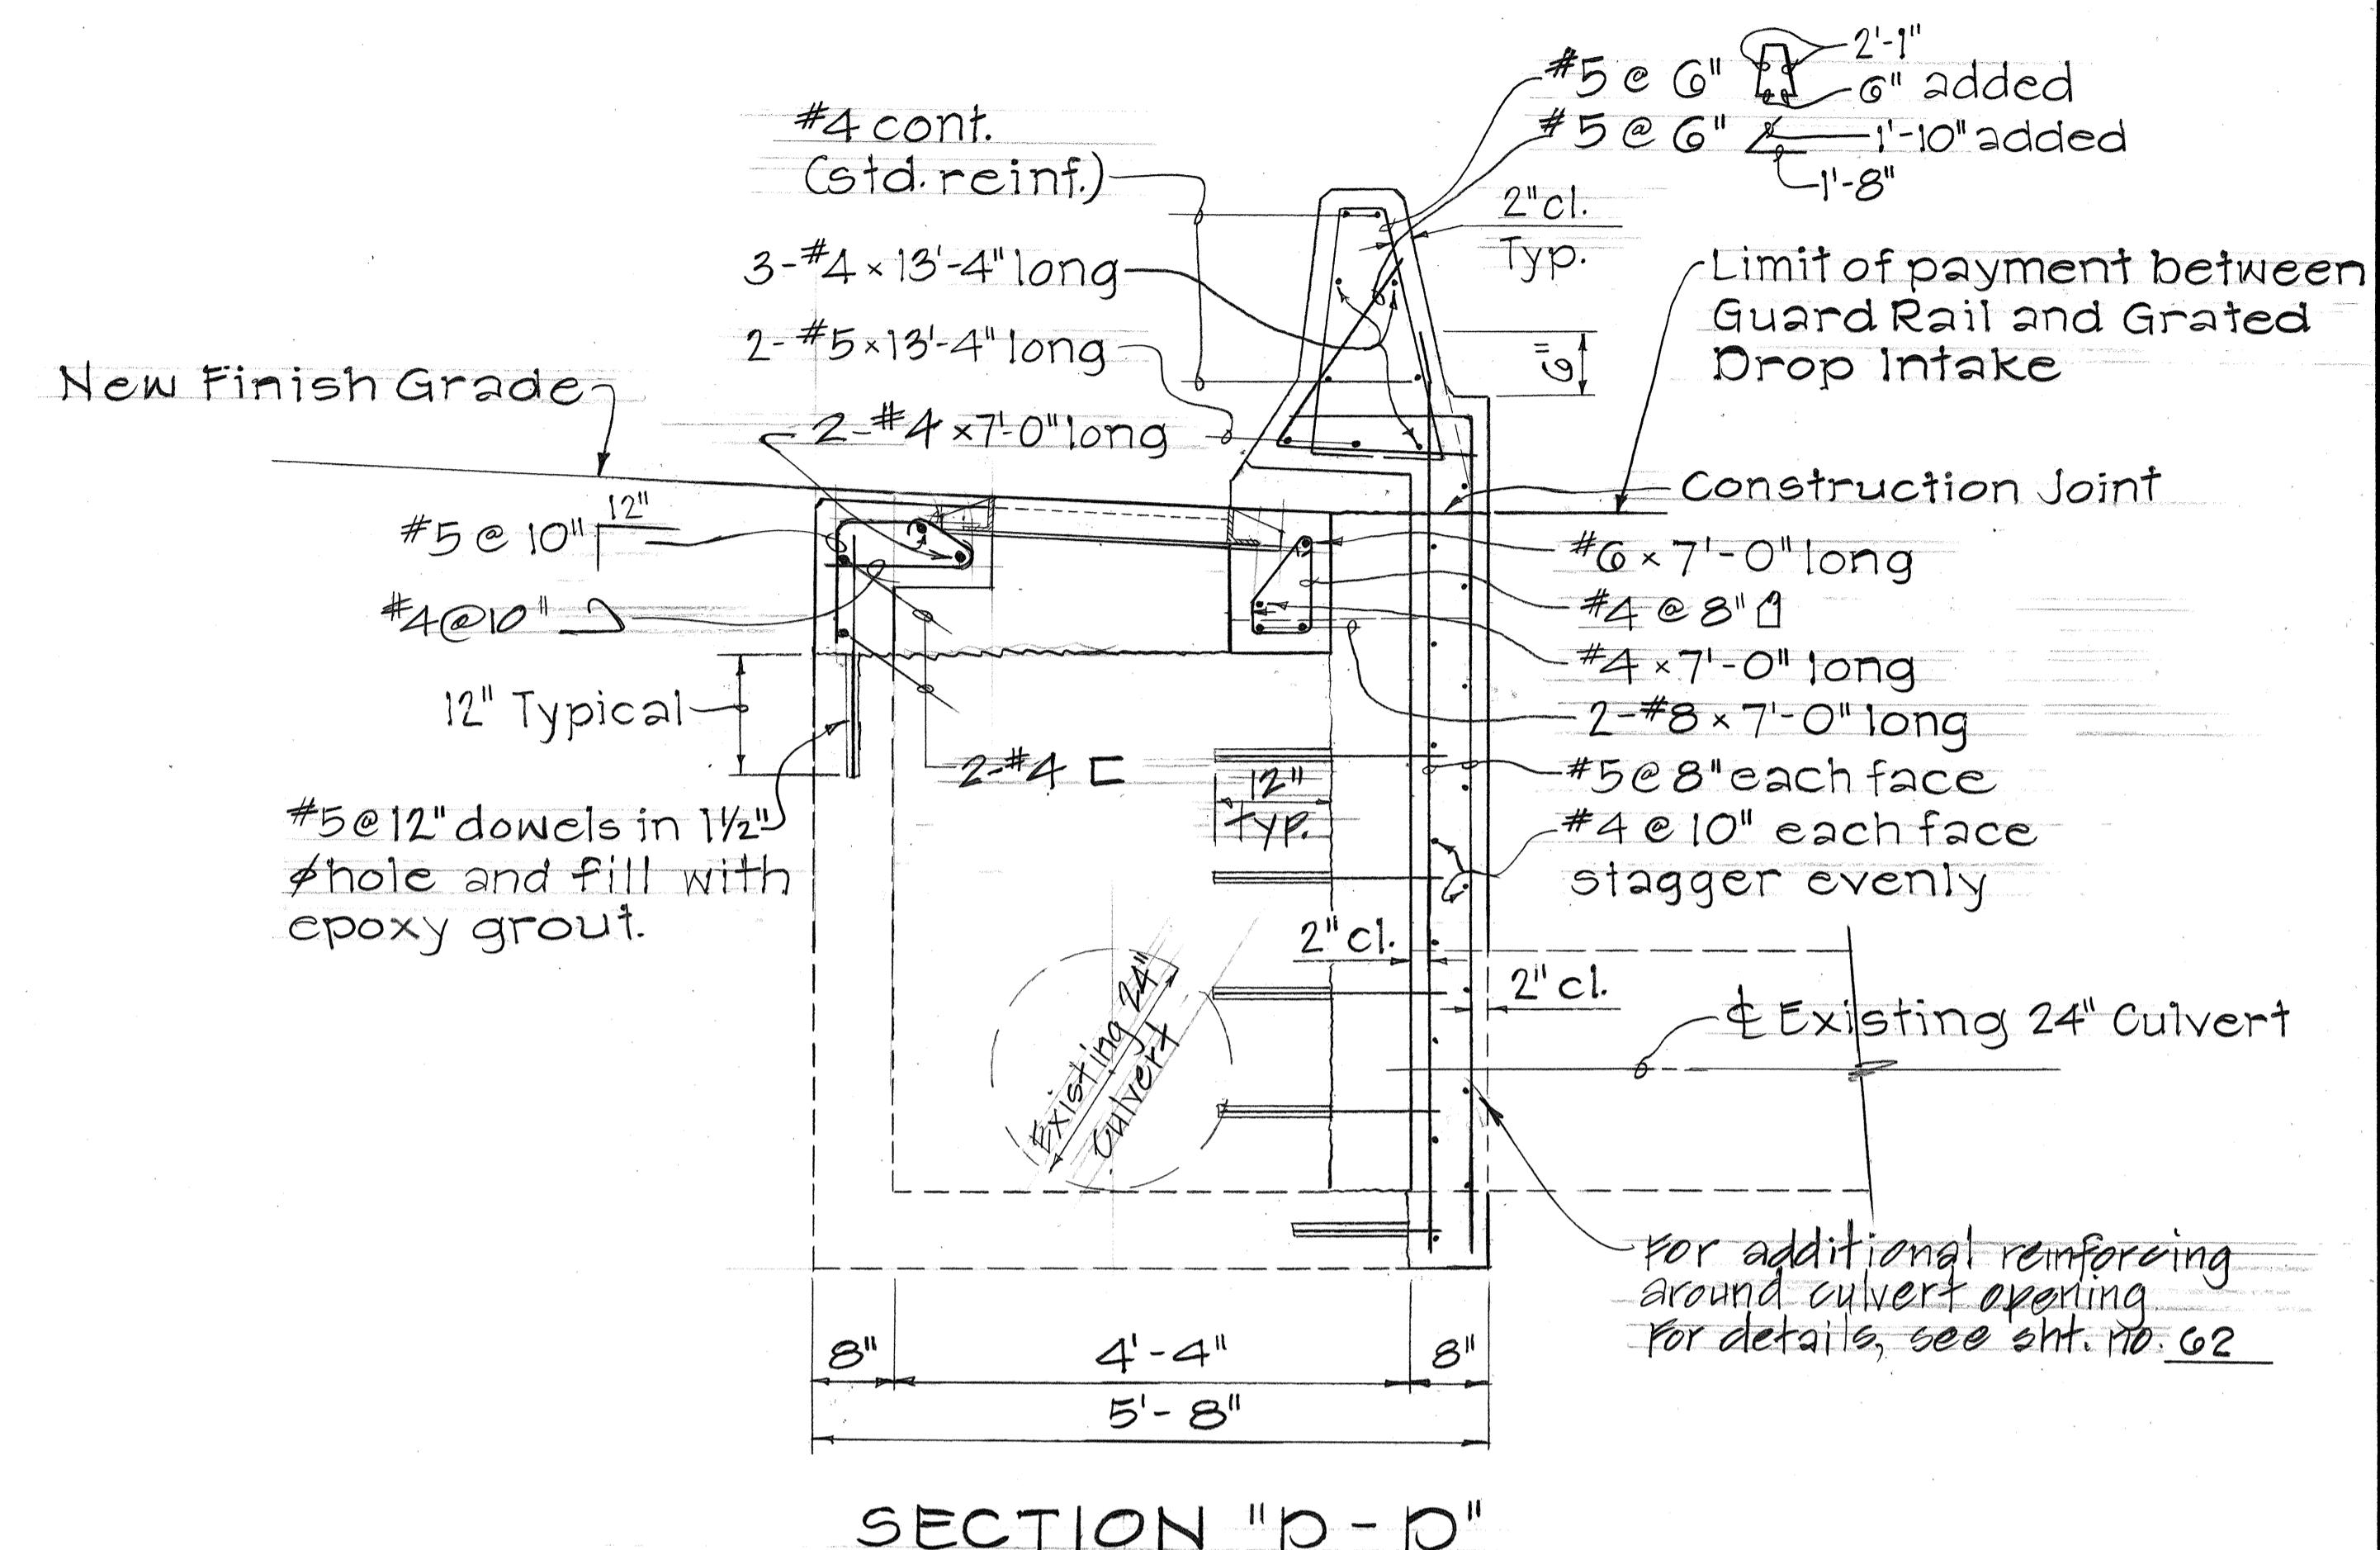

STATE OF HAWAII
DEPARTMENT OF TRANSPORTATION
HIGHWAYS DIVISION
DRAINAGE DETAILS
INTERSTATE H-I IMPROVEMENTS
MIDDLE STREET TO KALIHI INTERCHANGE
EASTBOUND LANES
F.A.I. PROJECT NO. I-HI-1(178)
SCALE: AS NOTED
SHEET NO. 25 OF 33 SHEETS

FED. ROAD DIST. NO.	STATE	FED. AID PROJ. NO.	FISCAL YEAR	SHEET NO.	TOTAL SHEETS
HAWAII	HAW.	I-HI-1(178)	1982	58	165

NOTE

Provide additional reinforcing around manhole cover and culvert openings. For details, see sheet no. 02

Demolish and Remove Existing Manhole

Cut pipe flush with inside wall

Existing 24" Culvert

Demolish and Remove Existing Curb and Gutter

Manhole Rungs

Existing 24" Culvert


Salvage Existing C.I. Frame and Cover

Bituminous Curb, Type GA

Install Type "P" Cast Iron Frame and Cover


Existing E.P.

PLAN
Scale: $\frac{1}{4}$ " = 1'-0"

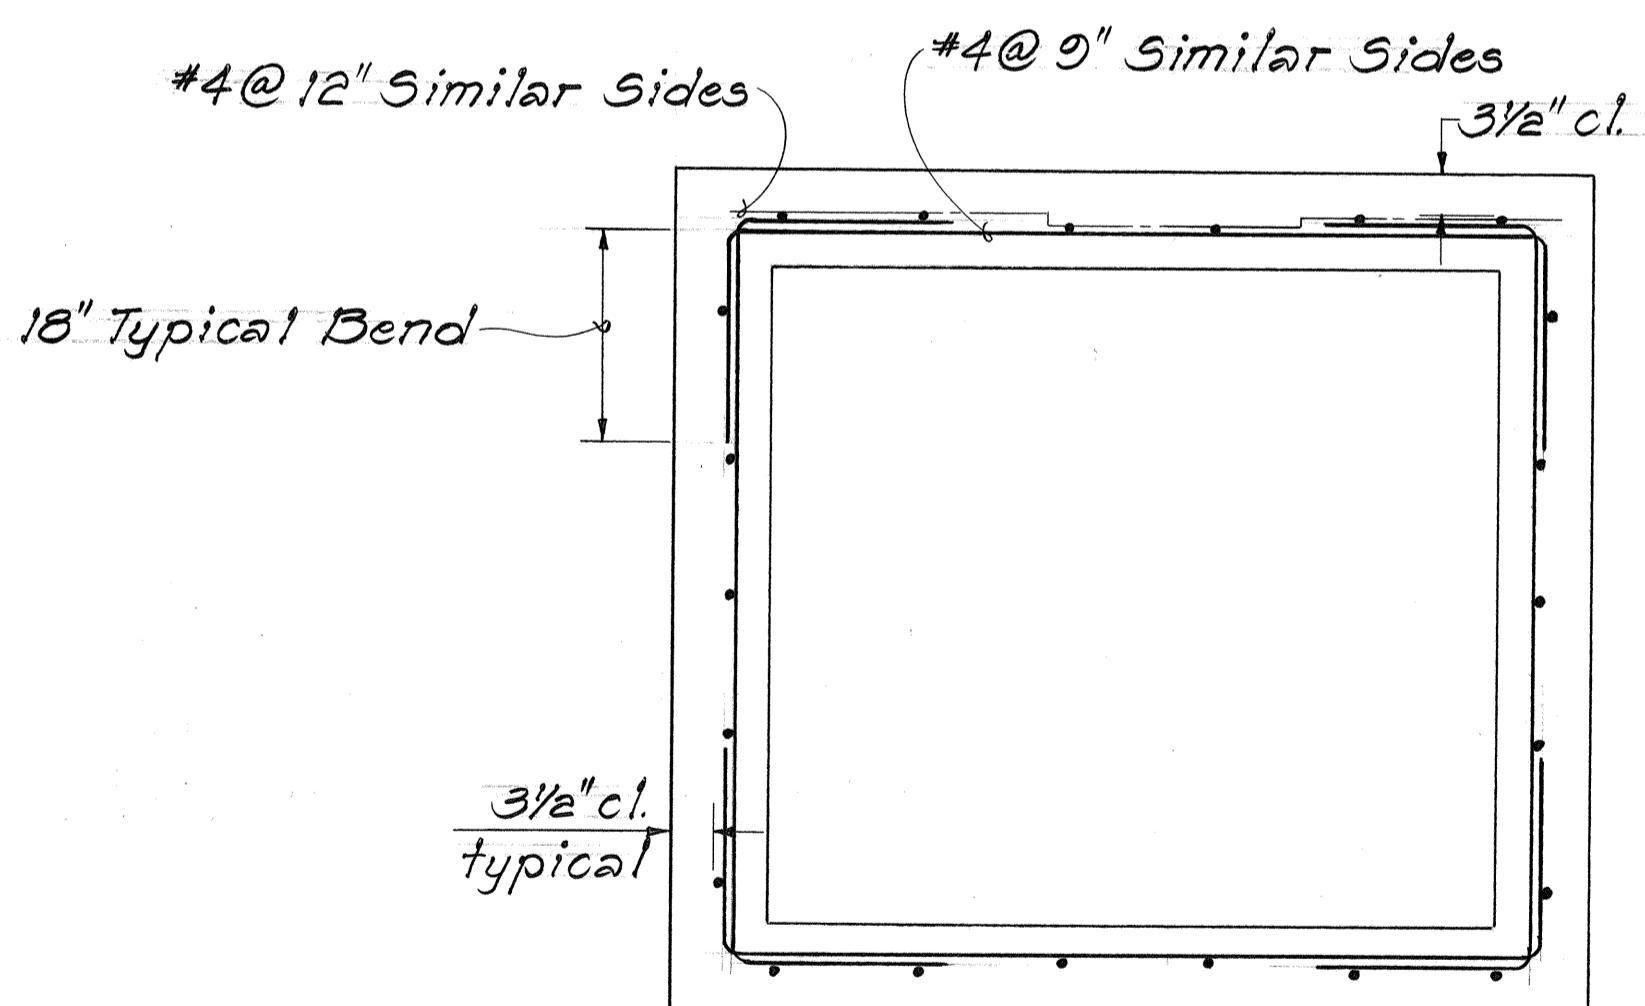

PLAN VIEW OF WALL SECTION
Scale: $\frac{1}{4}$ " = 1'-0"

DETAILS OF TYPE Z STORM DRAIN MANHOLE AT STA. 47+53.75 RT.

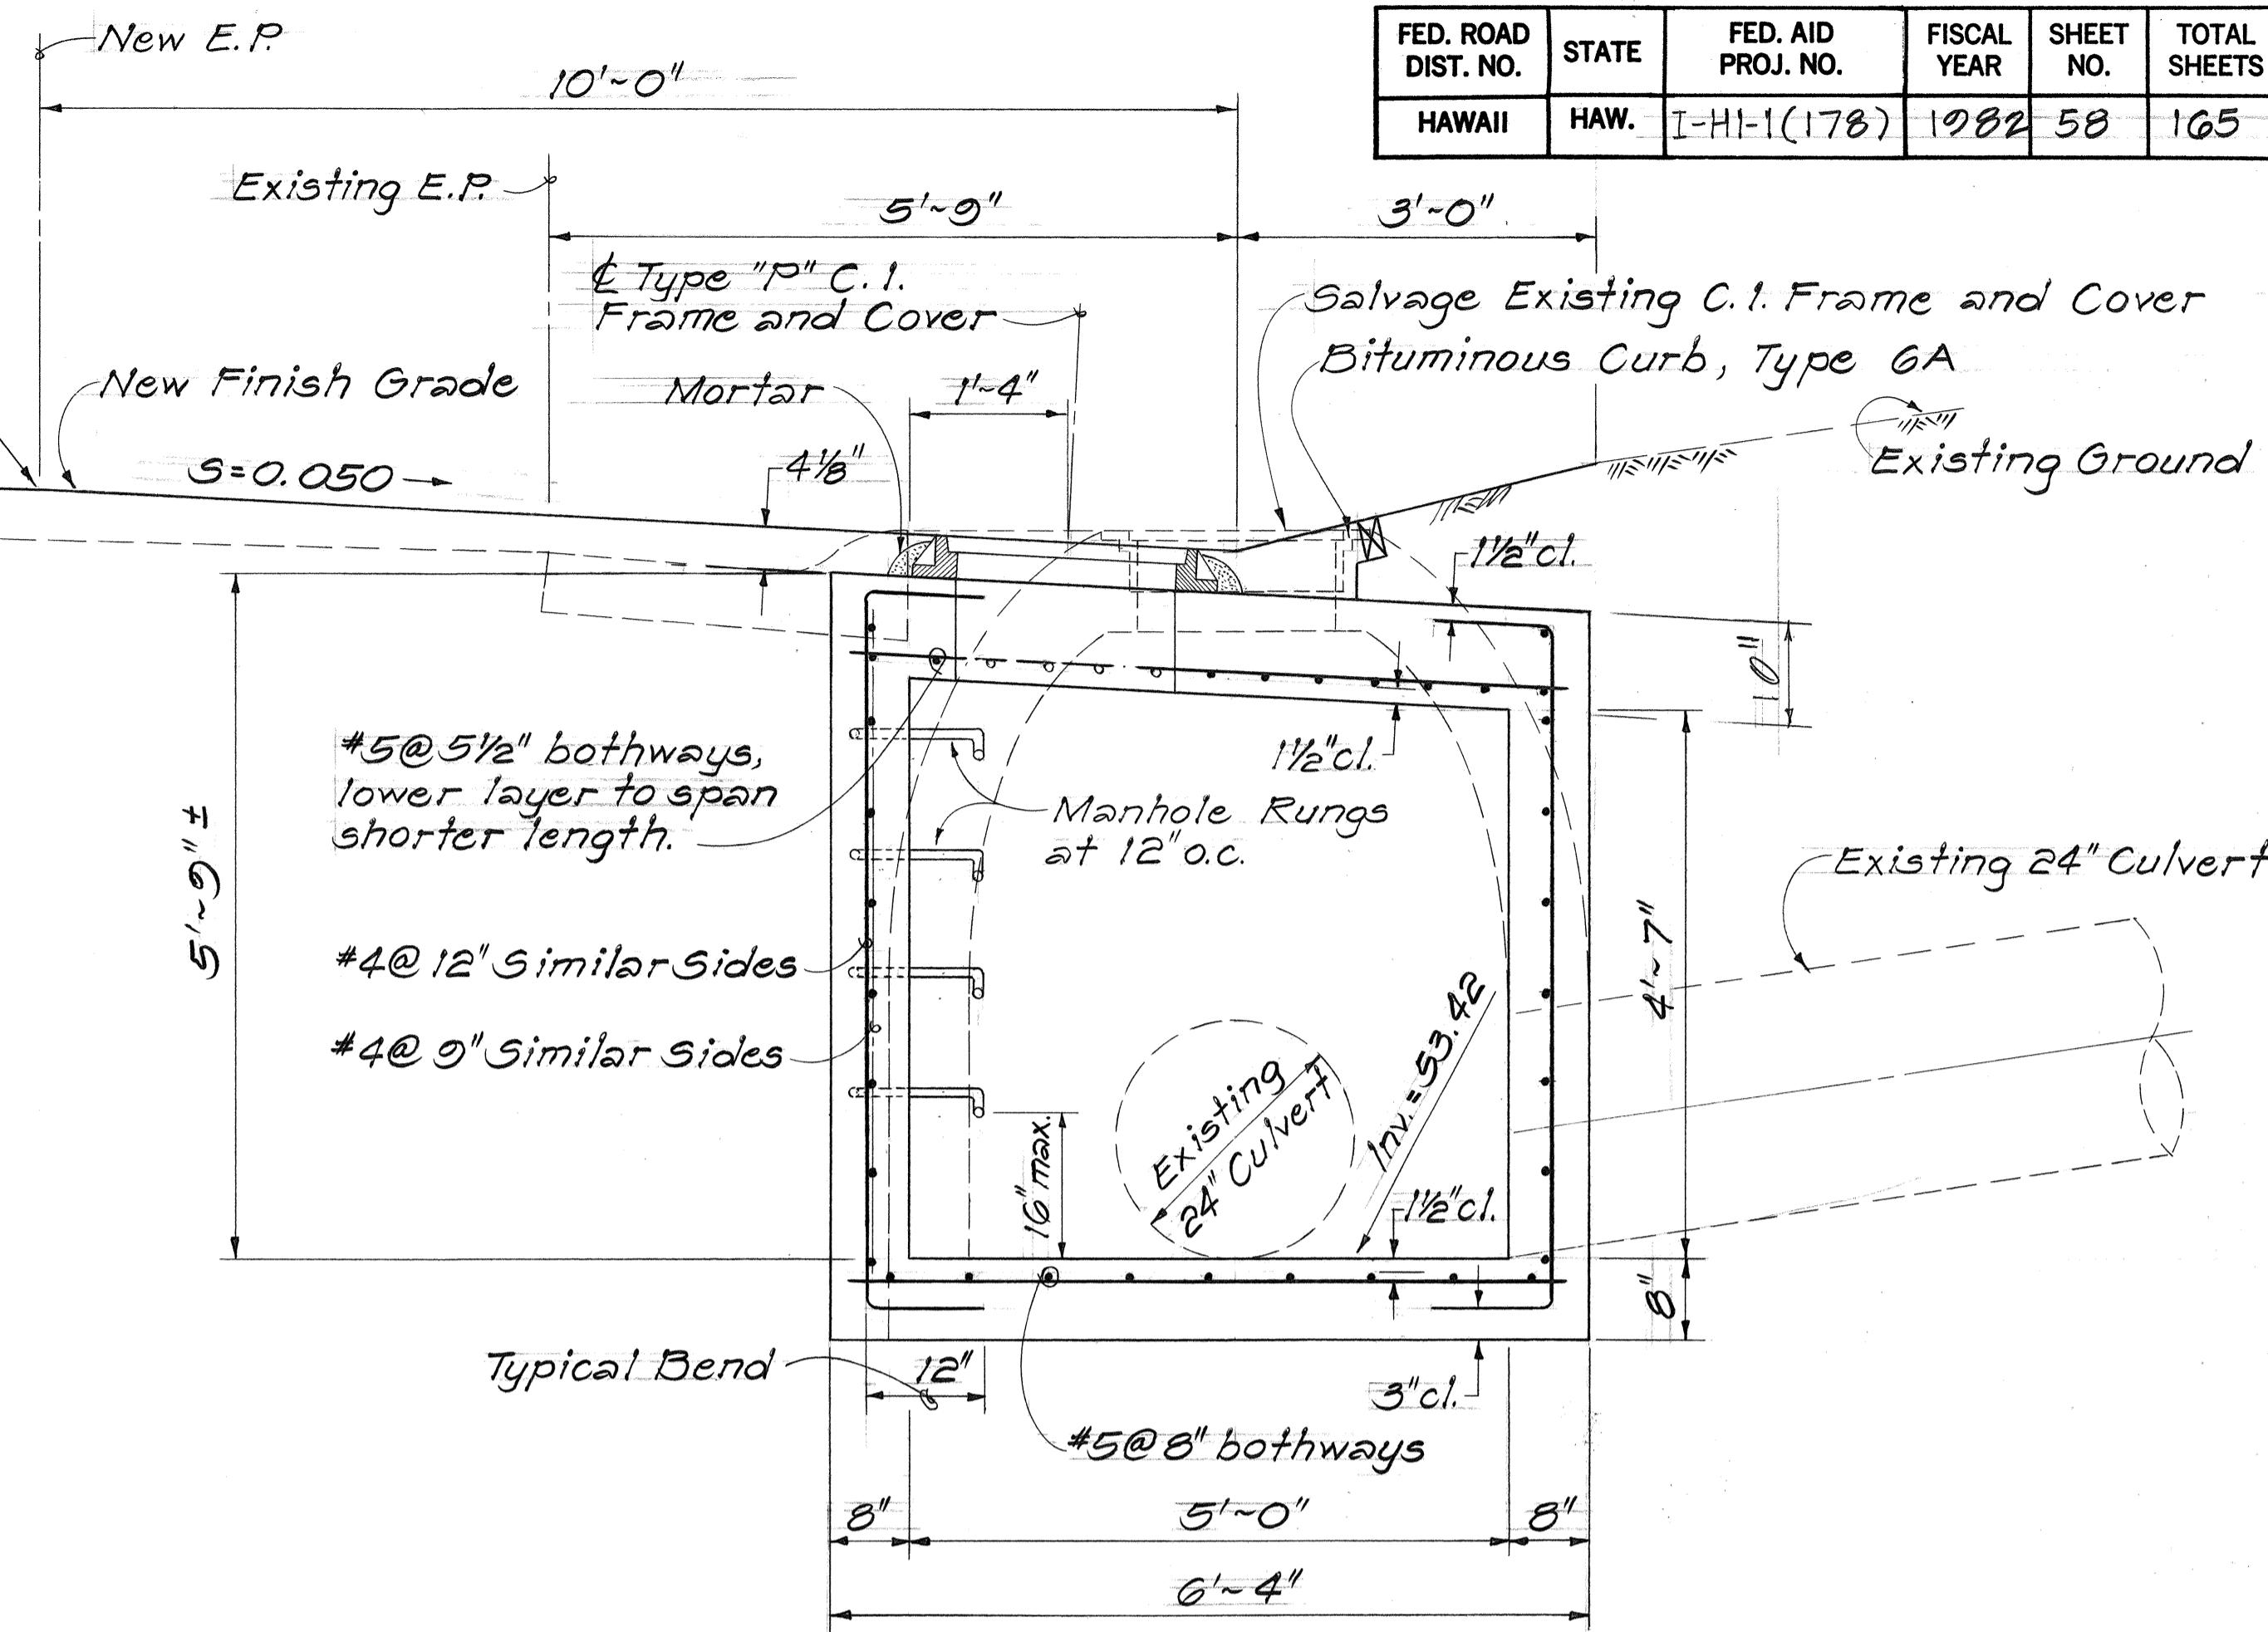

SECTION A-A
Scale: $\frac{1}{4}$ " = 1'-0"

ORIGINAL SURVEY PLOTTED BY	DATA
DRAWN BY	
TRACED BY	
DESIGNED BY	
QUANTITIES BY	
CHECKED BY	No.

STATE OF HAWAII
DEPARTMENT OF TRANSPORTATION
HIGHWAYS DIVISION




DRAINAGE DETAILS

INTERSTATE H-I IMPROVEMENTS
MIDDLE STREET TO KALIHI INTERCHANGE
EASTBOUND LANES
F.A.I. PROJECT NO. I-HI-1(178)

SCALE: AS NOTED


SHEET NO. 26 OF 33 SHEETS

FED. ROAD DIST. NO.	STATE	FED. AID PROJ. NO.	FISCAL YEAR	SHEET NO.	TOTAL SHEETS
HAWAII	HAW.	I-HI-1(178)	1982	60	105

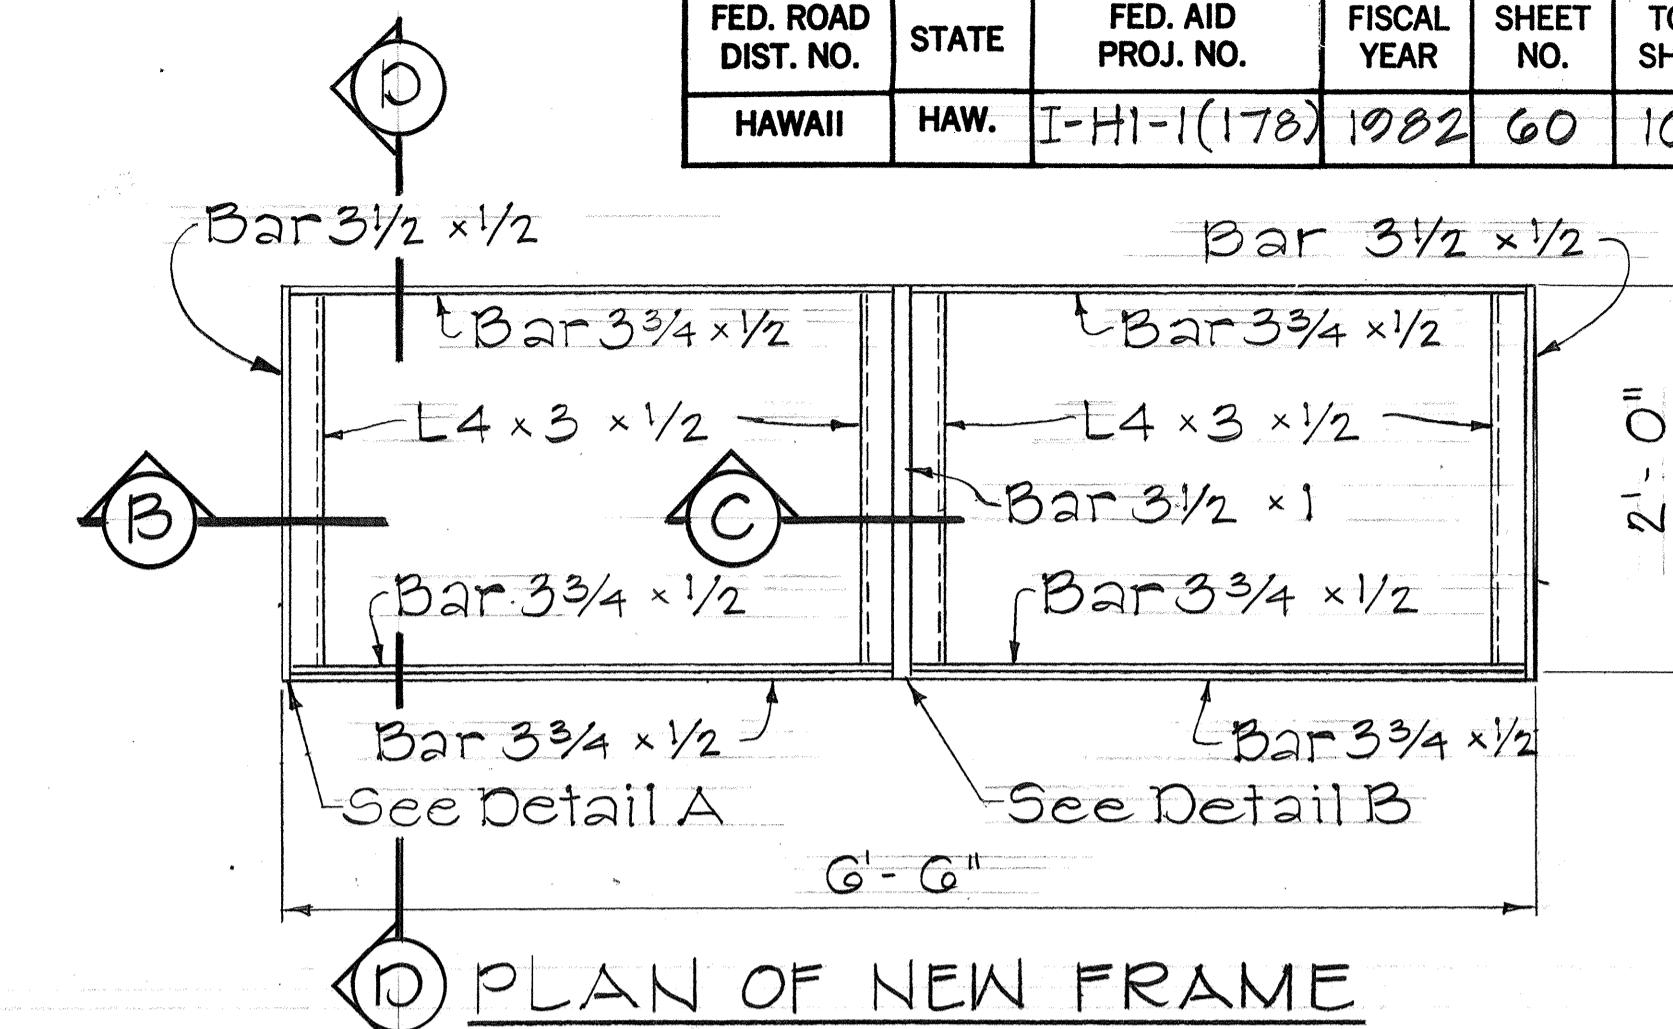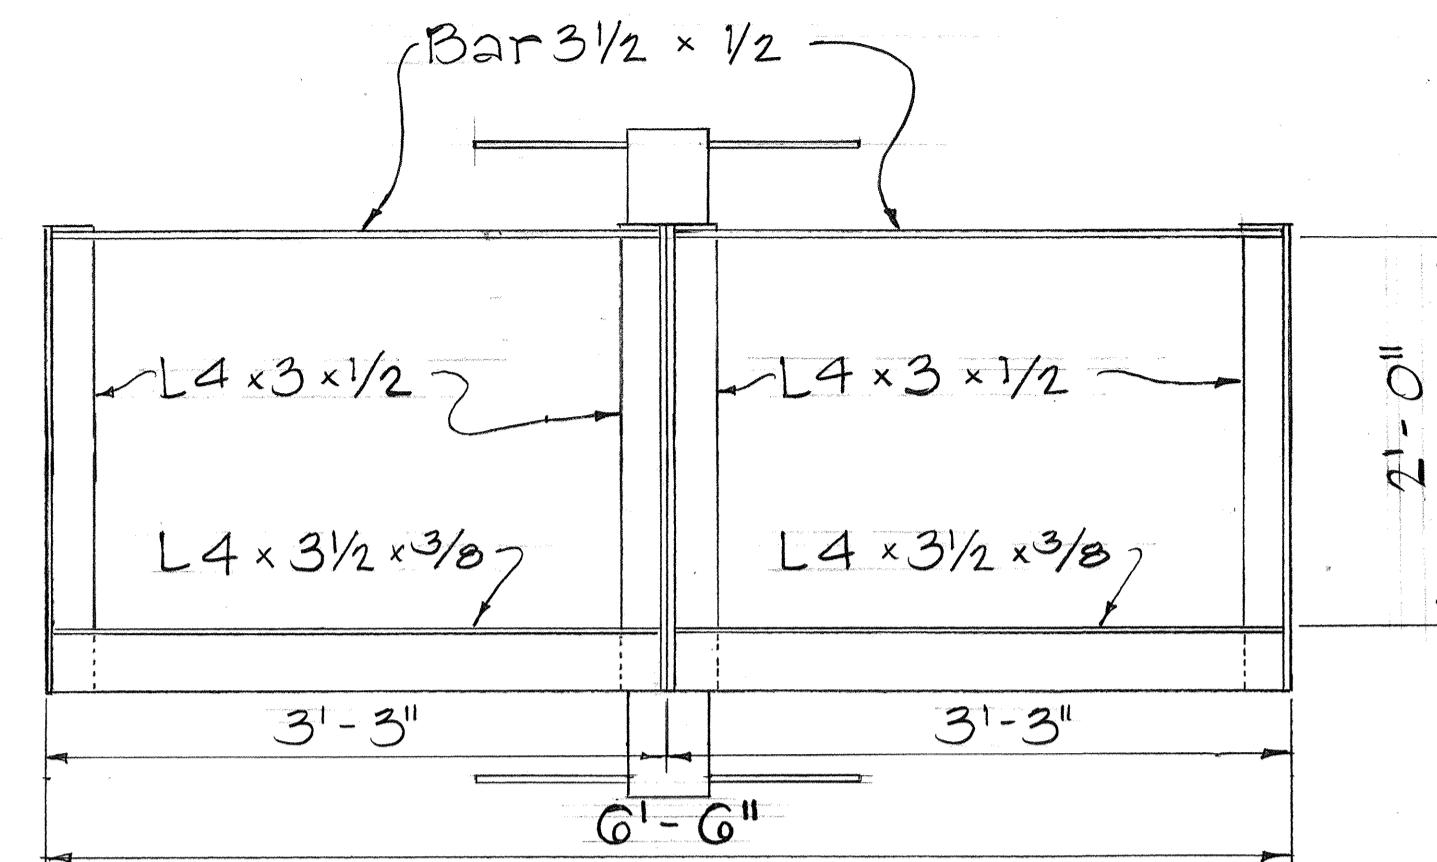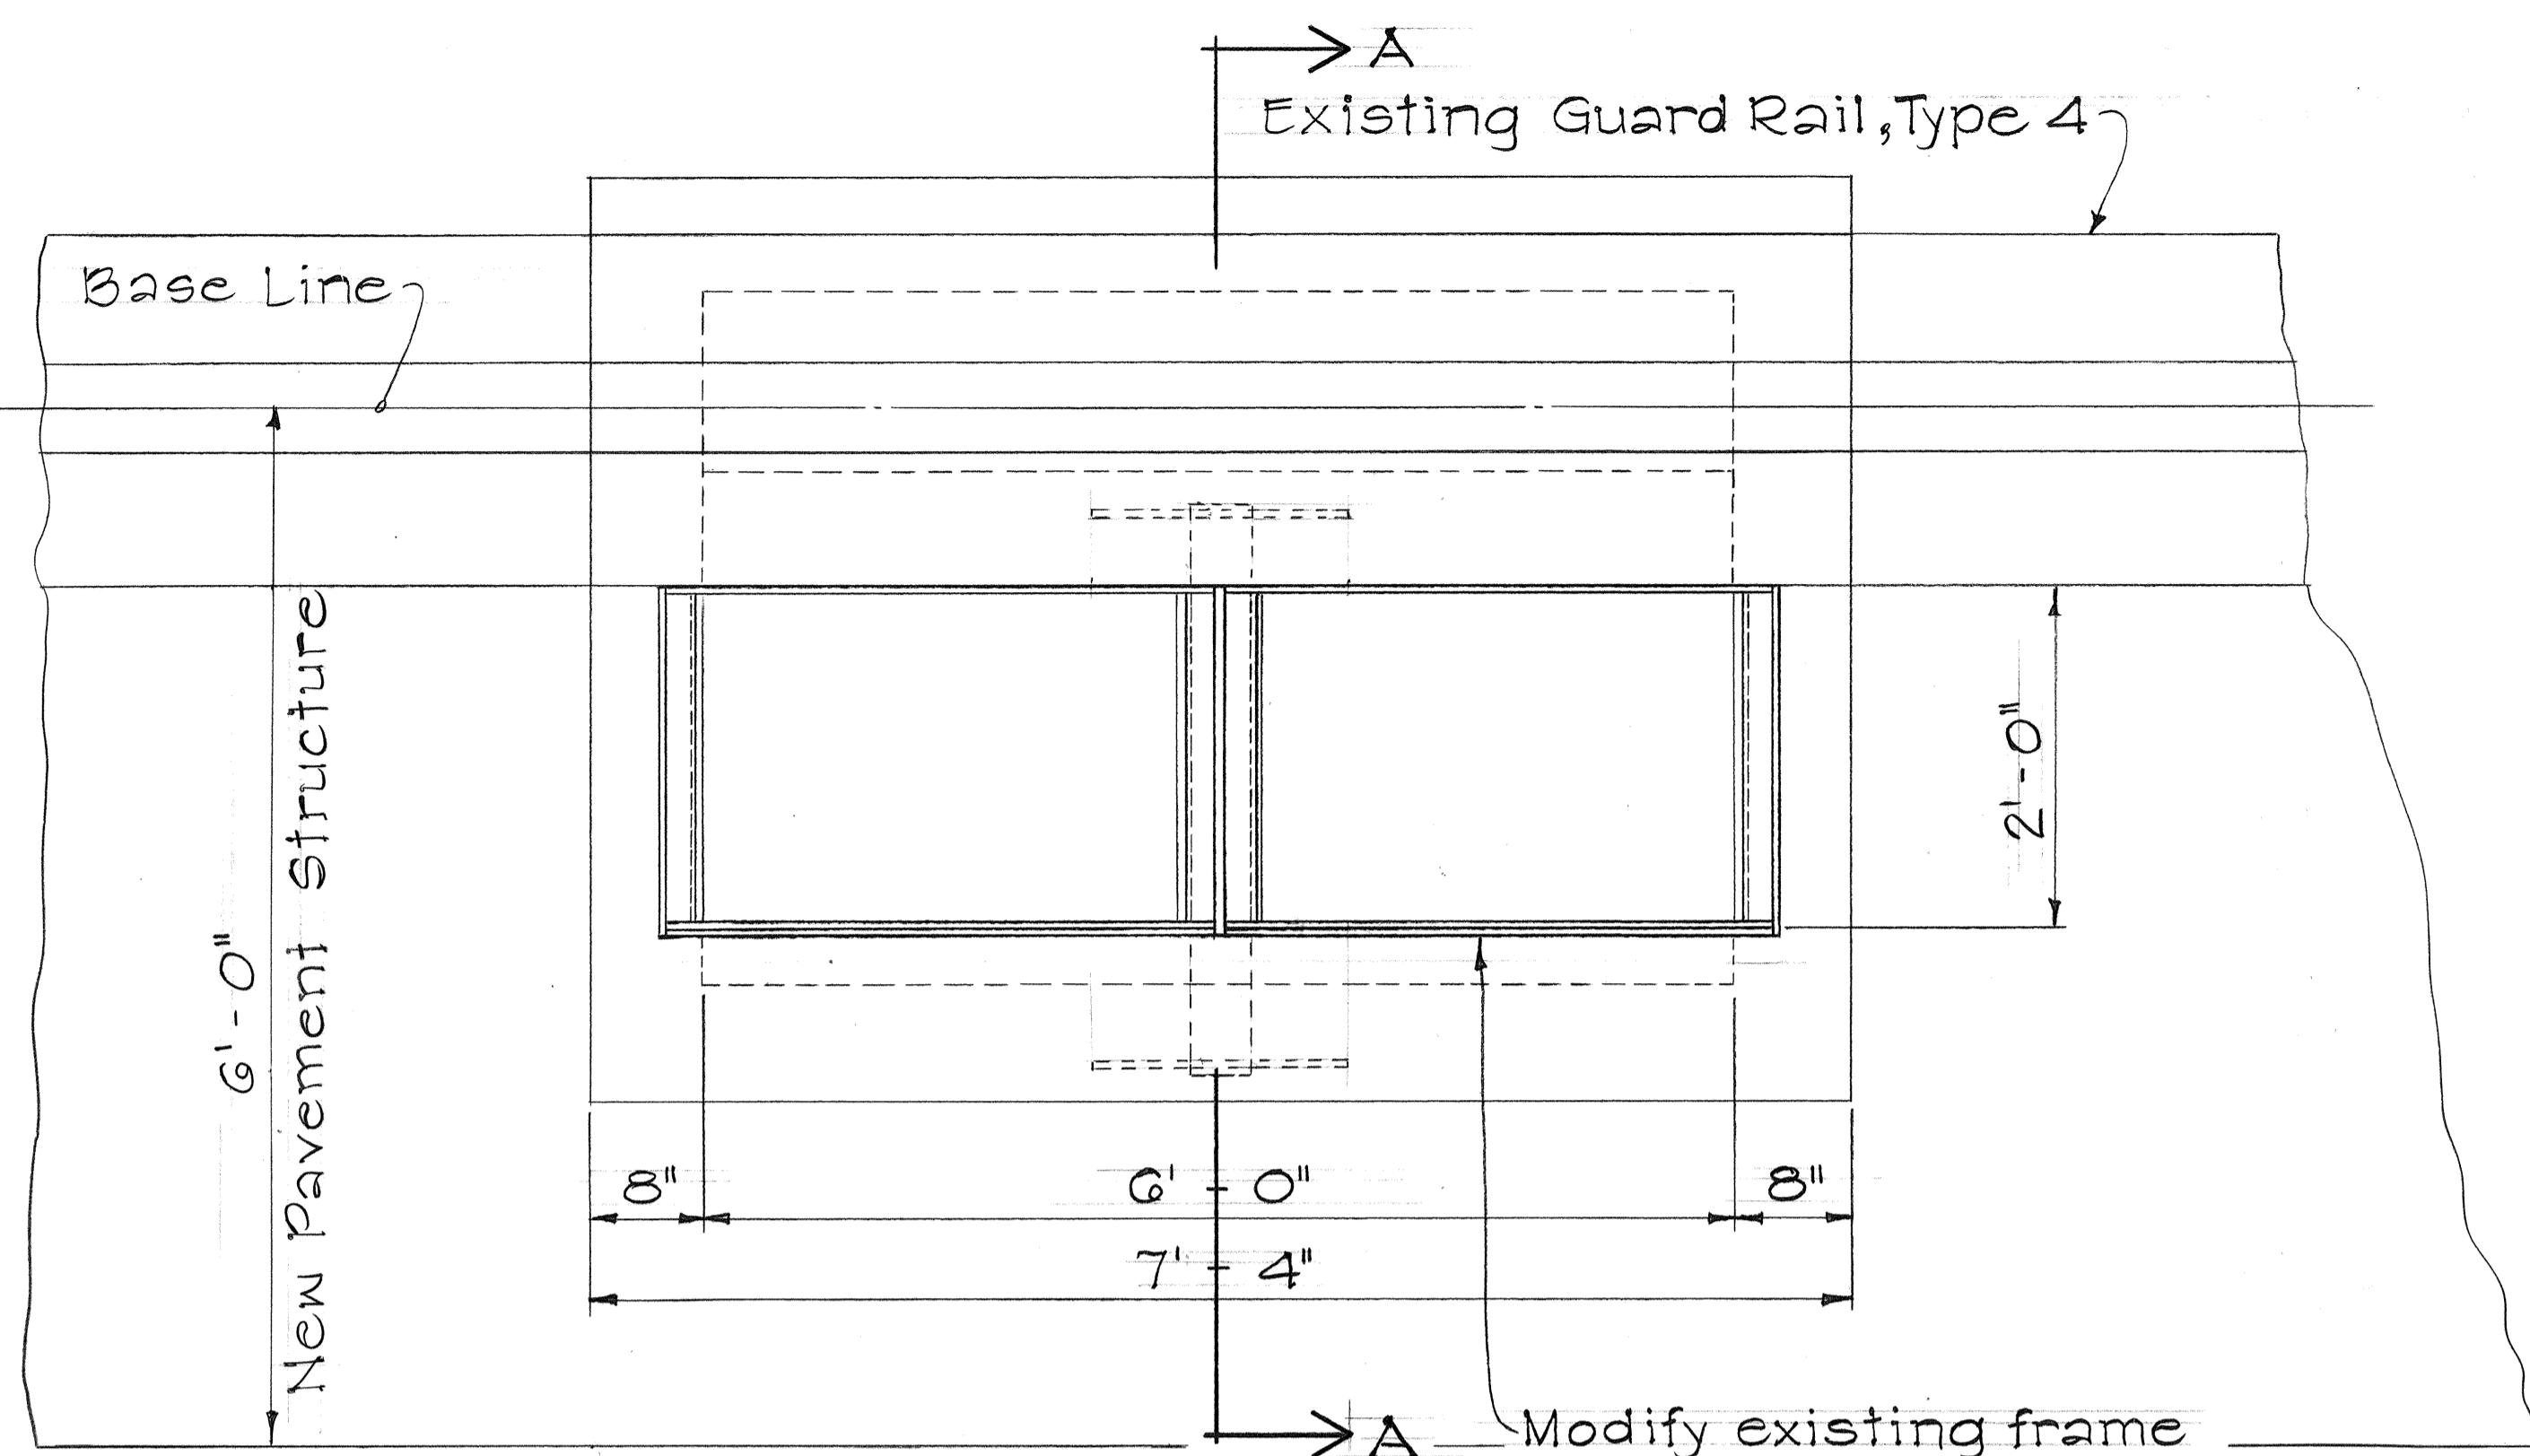


PLAN VIEW OF STEEL FRAME

Scale: 1" = 1'-0"


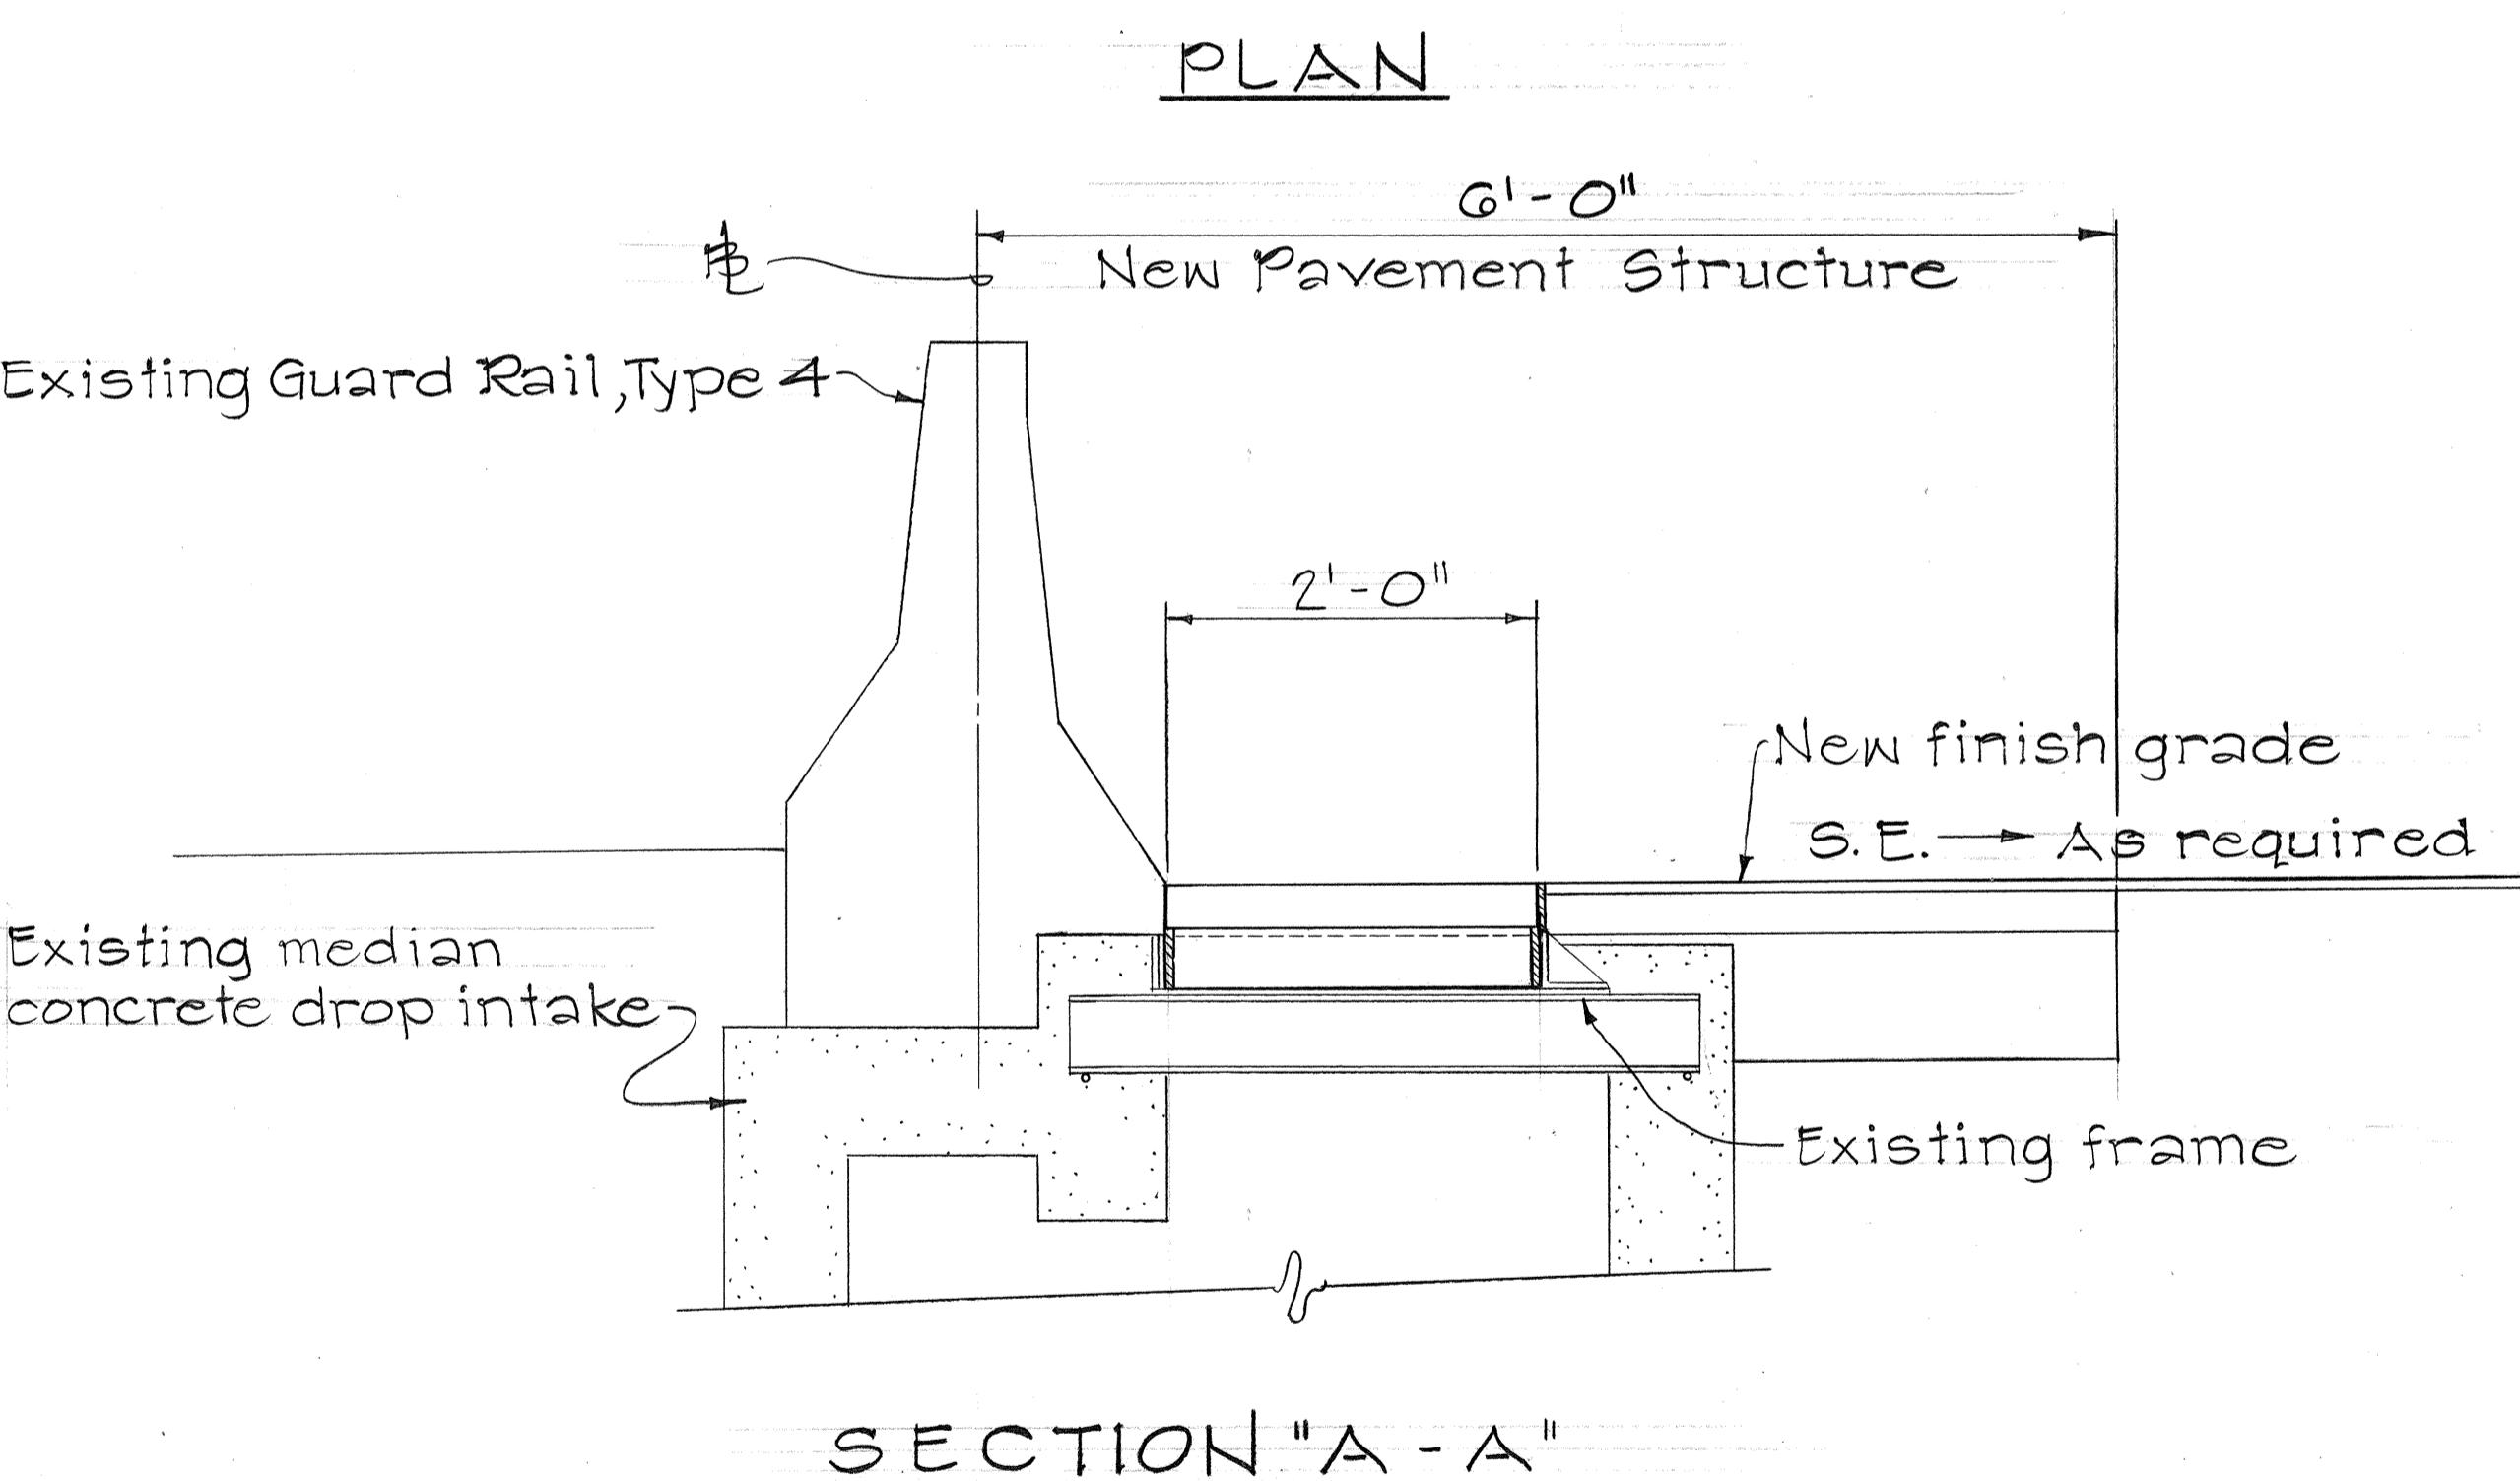


MEDIAN CONCRETE DROP INTAKE


Scale: 1" = 1'-0"

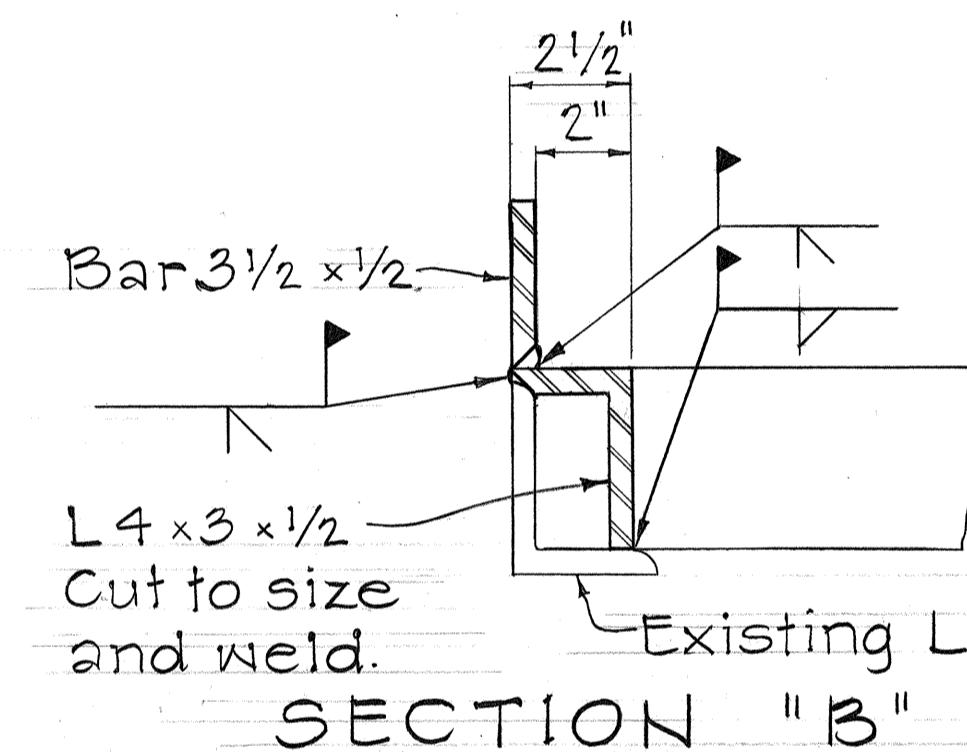

SECTION "B"

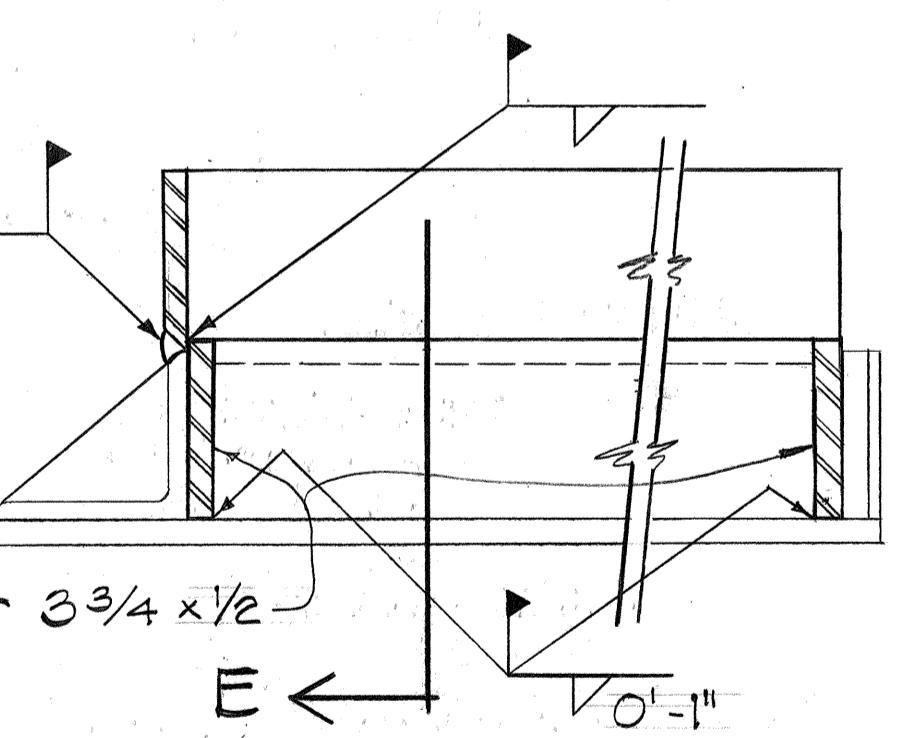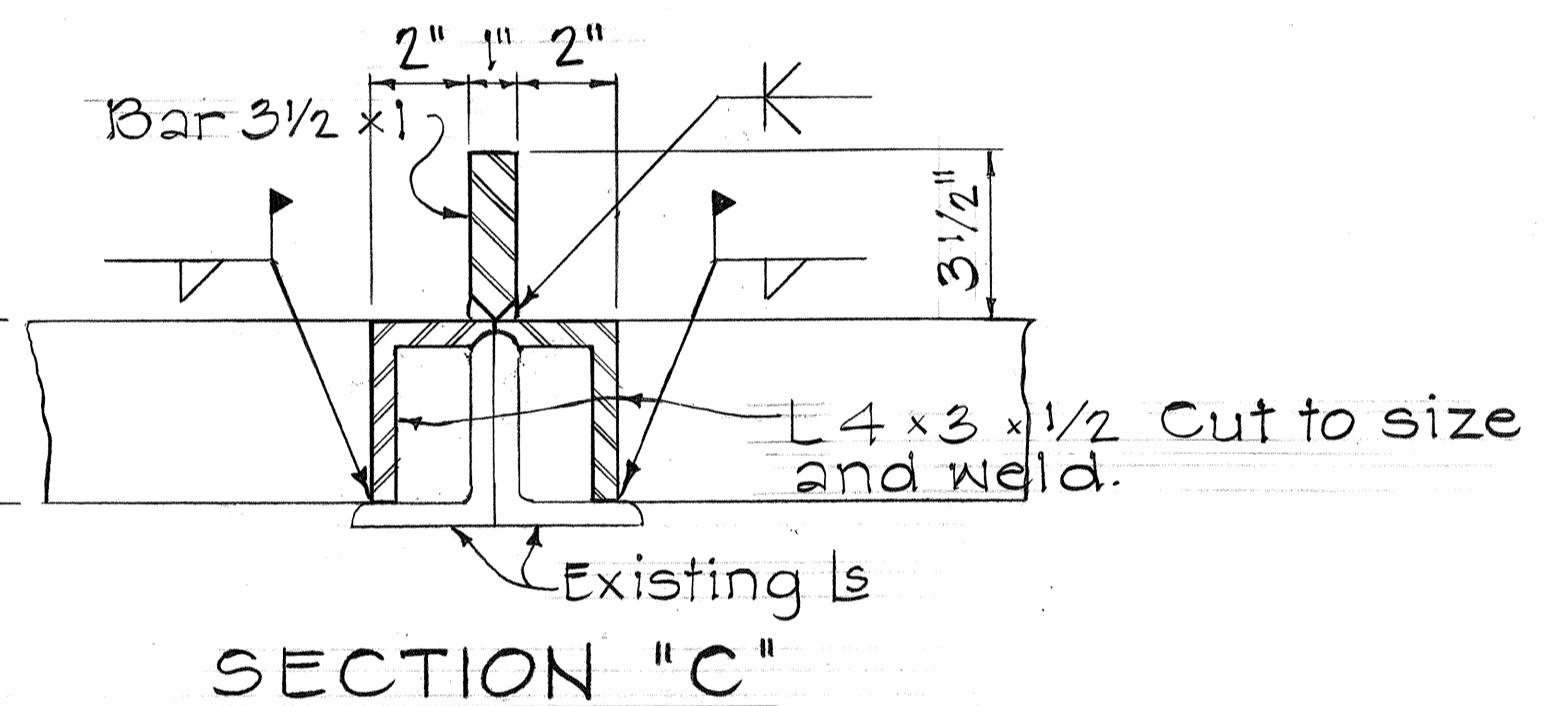

SECTION "D-D"

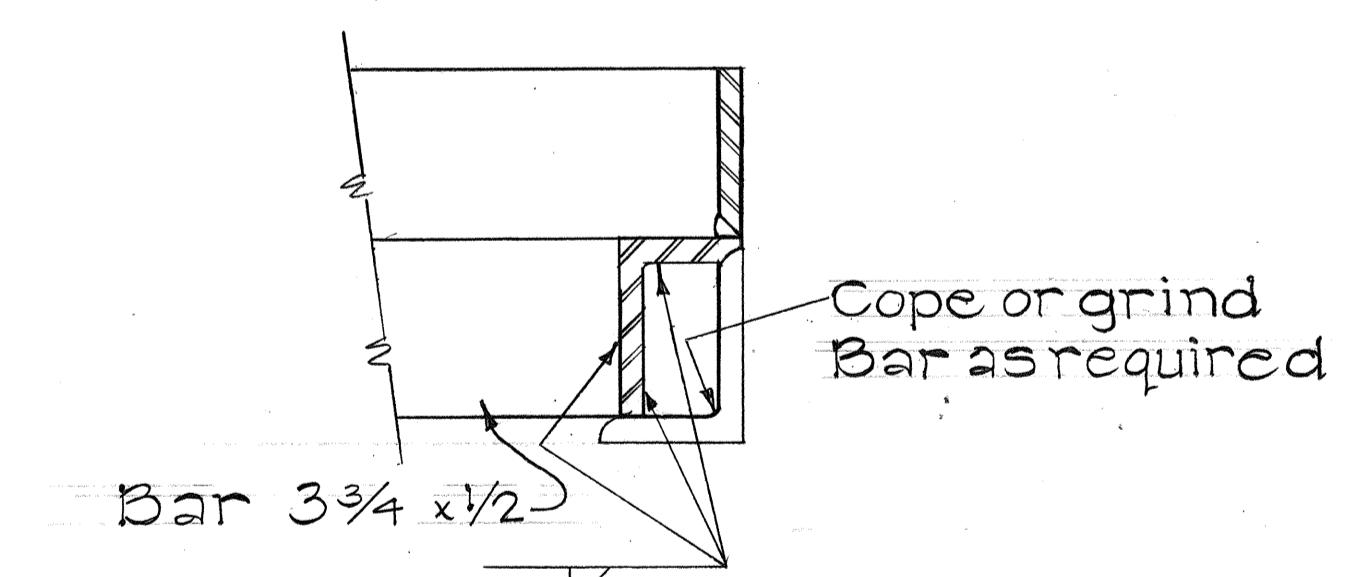

SECTION "E"

Note: All fillet welds, $5/16"$

TYPICAL DETAILS AT ALL JOINTS

Scale: 3" = 1'-0"

DETAILS TO ADJUST TYPE A-12 FRAMES AND GRATES


STATE OF HAWAII
DEPARTMENT OF TRANSPORTATION
HIGHWAYS DIVISION

DRAINAGE DETAILS

INTERSTATE H-I IMPROVEMENTS
MIDDLE STREET TO KALIHI INTERCHANGE
EASTBOUND LANES
F.A.I. PROJECT NO. I-HI-1(178)

SCALE: AS NOTED
SHEET NO. 28 OF 33 SHEETS


FED. ROAD DIST. NO.	STATE	FED. AID PROJ. NO.	FISCAL YEAR	SHEET NO.	TOTAL SHEETS
HAWAII	HAW.	I-HI-1(178)	1984	C.06051	165

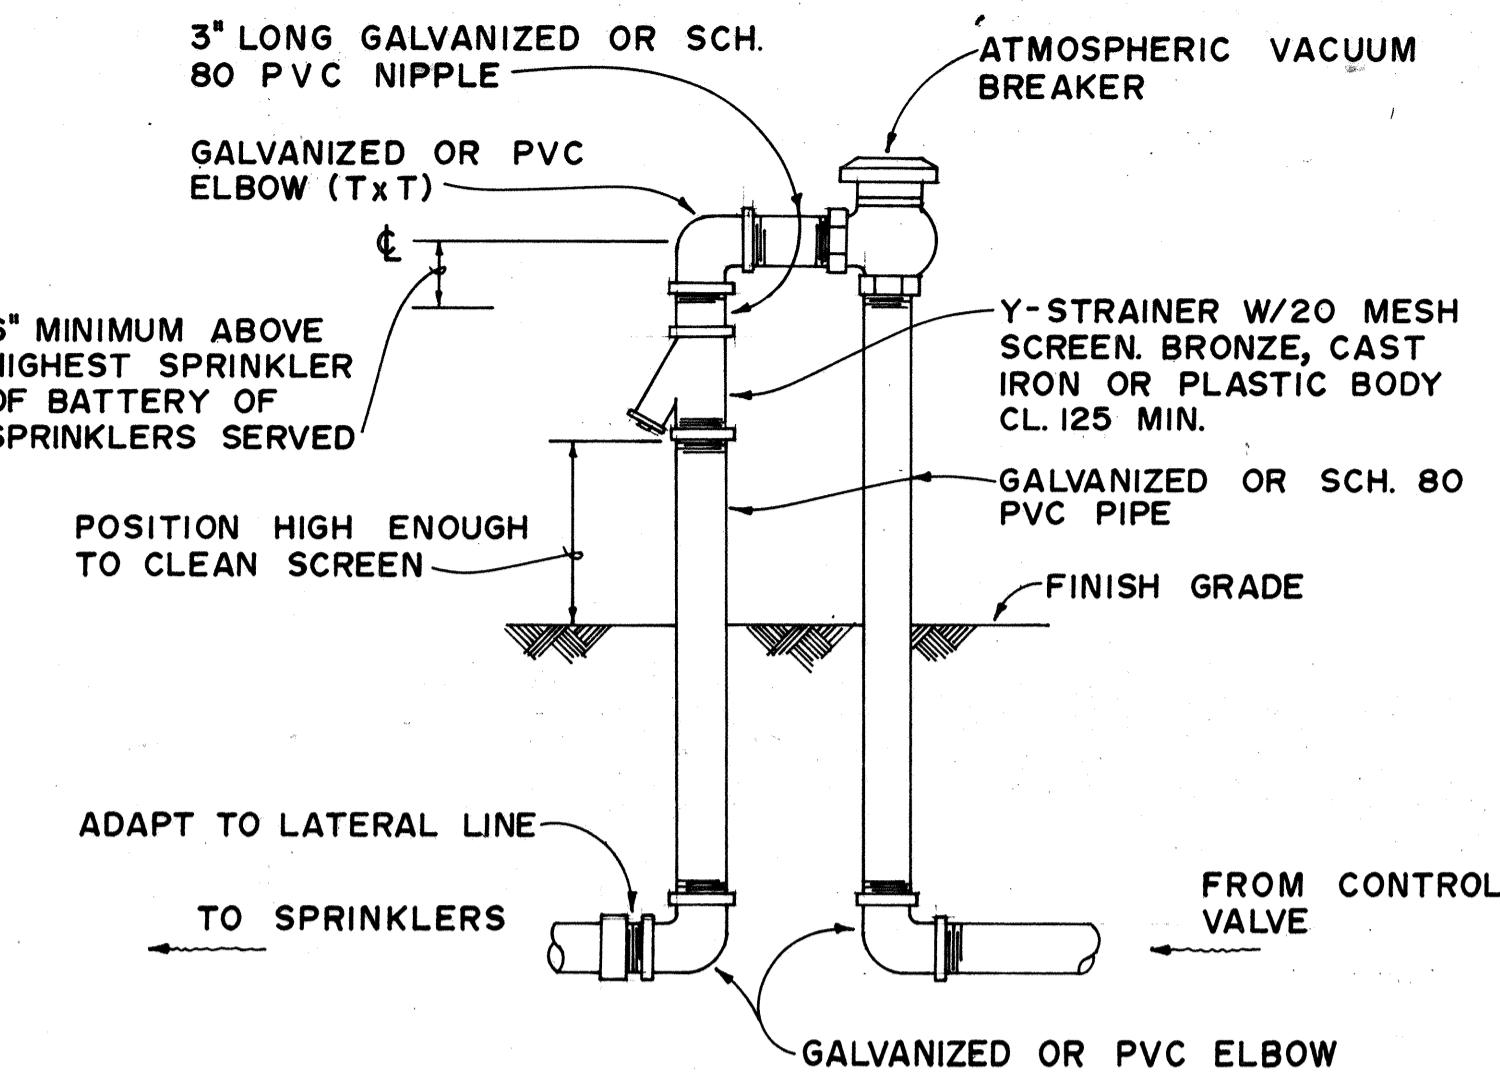

ATMOSPHERIC VACUUM BREAKER UNIT DETAIL


NOTES:

1. ATMOSPHERIC VACUUM BREAKER, Y-STRAINER AND PIPE ABOVE FINISH GRADE SHALL BE PRIME COATED AND PAINTED WITH TWO COATS OF DARK GREEN ENAMEL PAINT.
2. GALVANIZED PIPE BELOW FINISH GRADE SHALL BE PAINTED WITH TWO COATS OF ASPHALT PAINT.

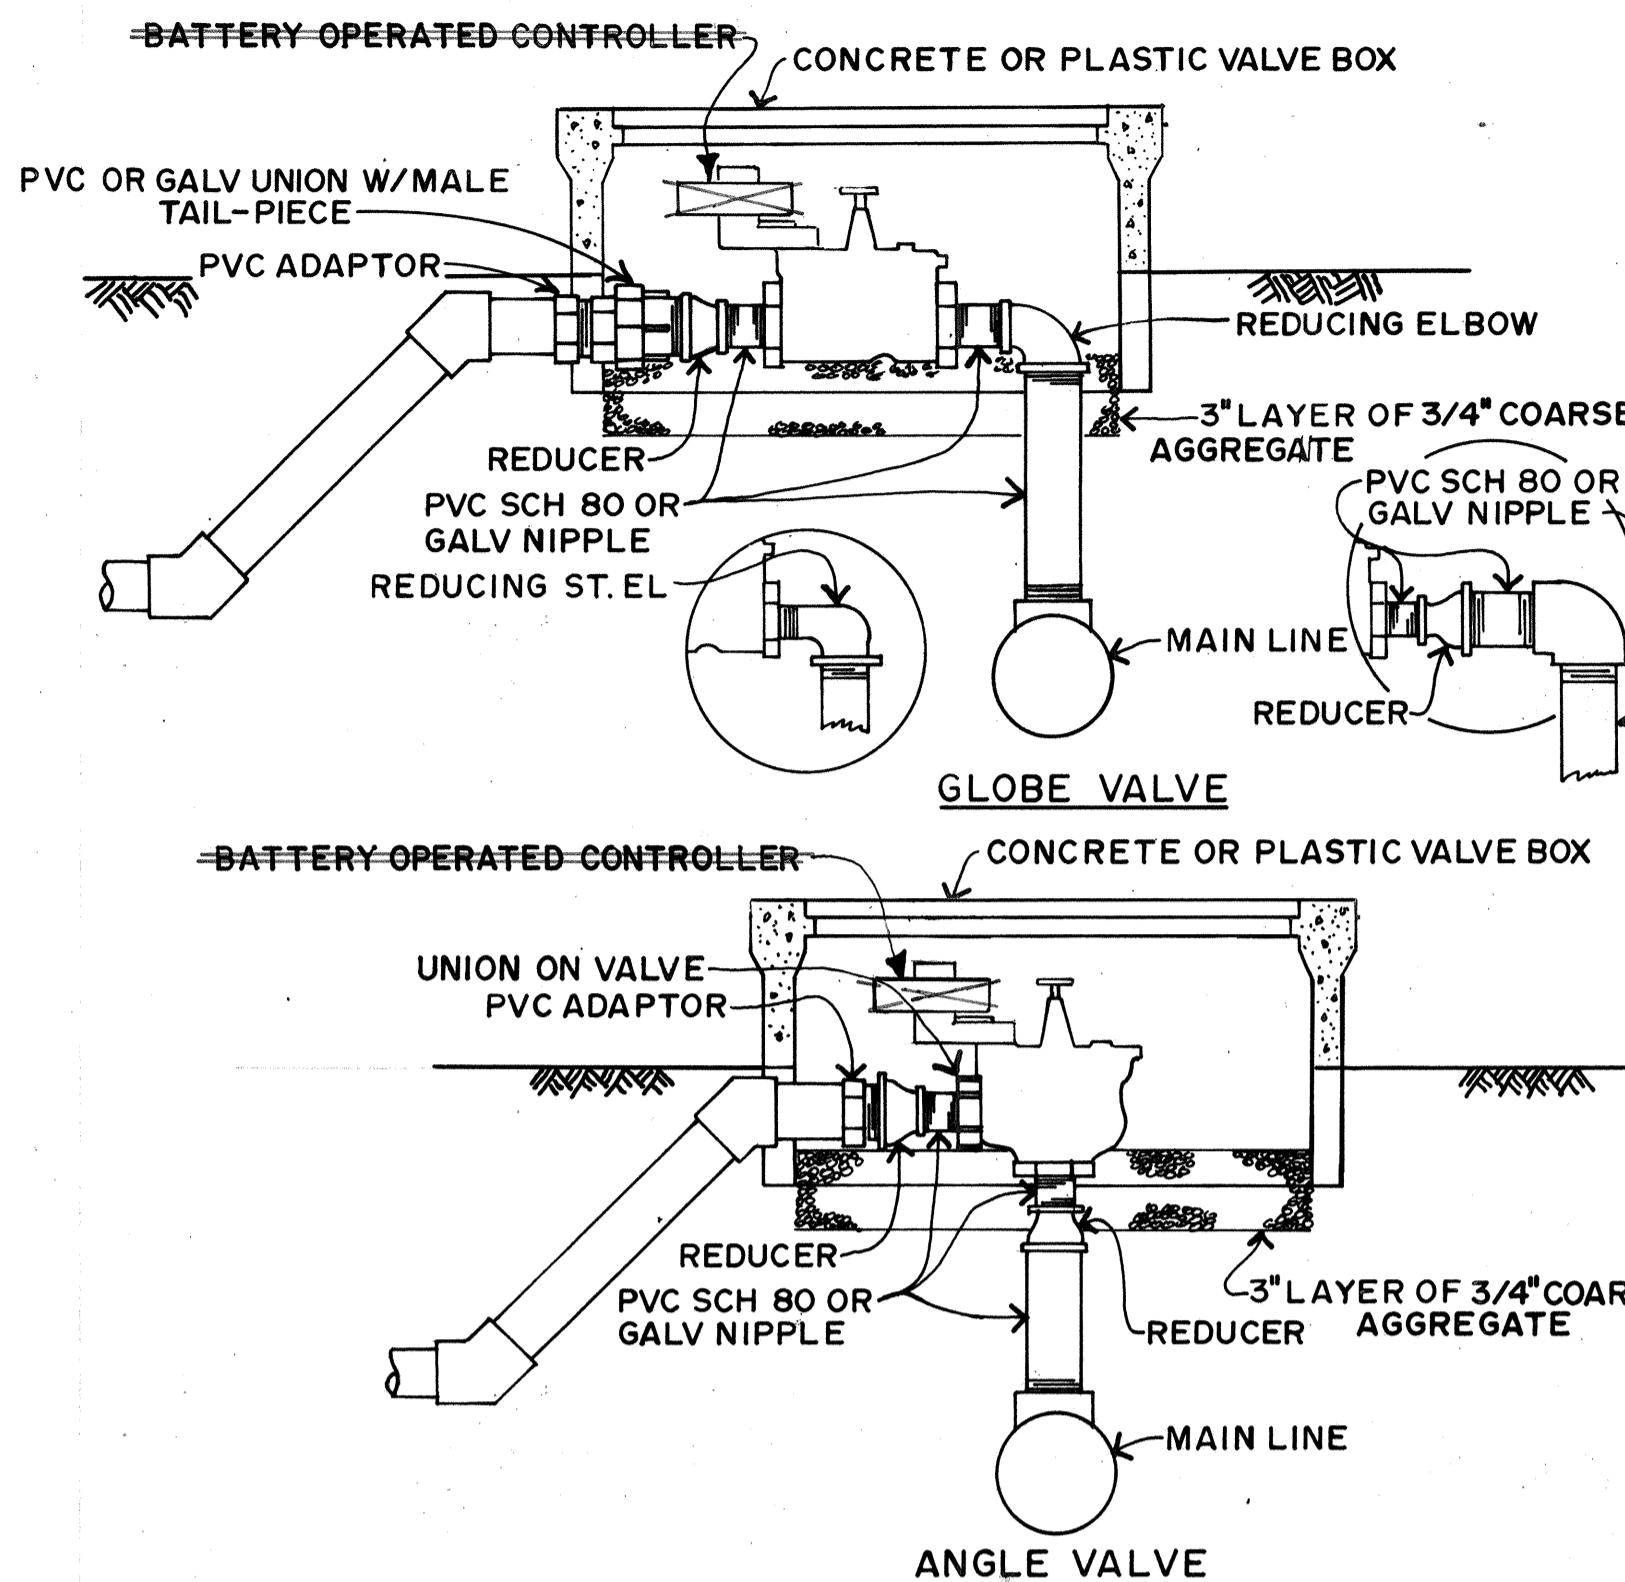


TYPICAL CONTROL VALVE DETAIL

NOTE: A 2" MINIMUM CLEARANCE SHALL BE REQUIRED ON ALL SIDES OF THE VALVE.

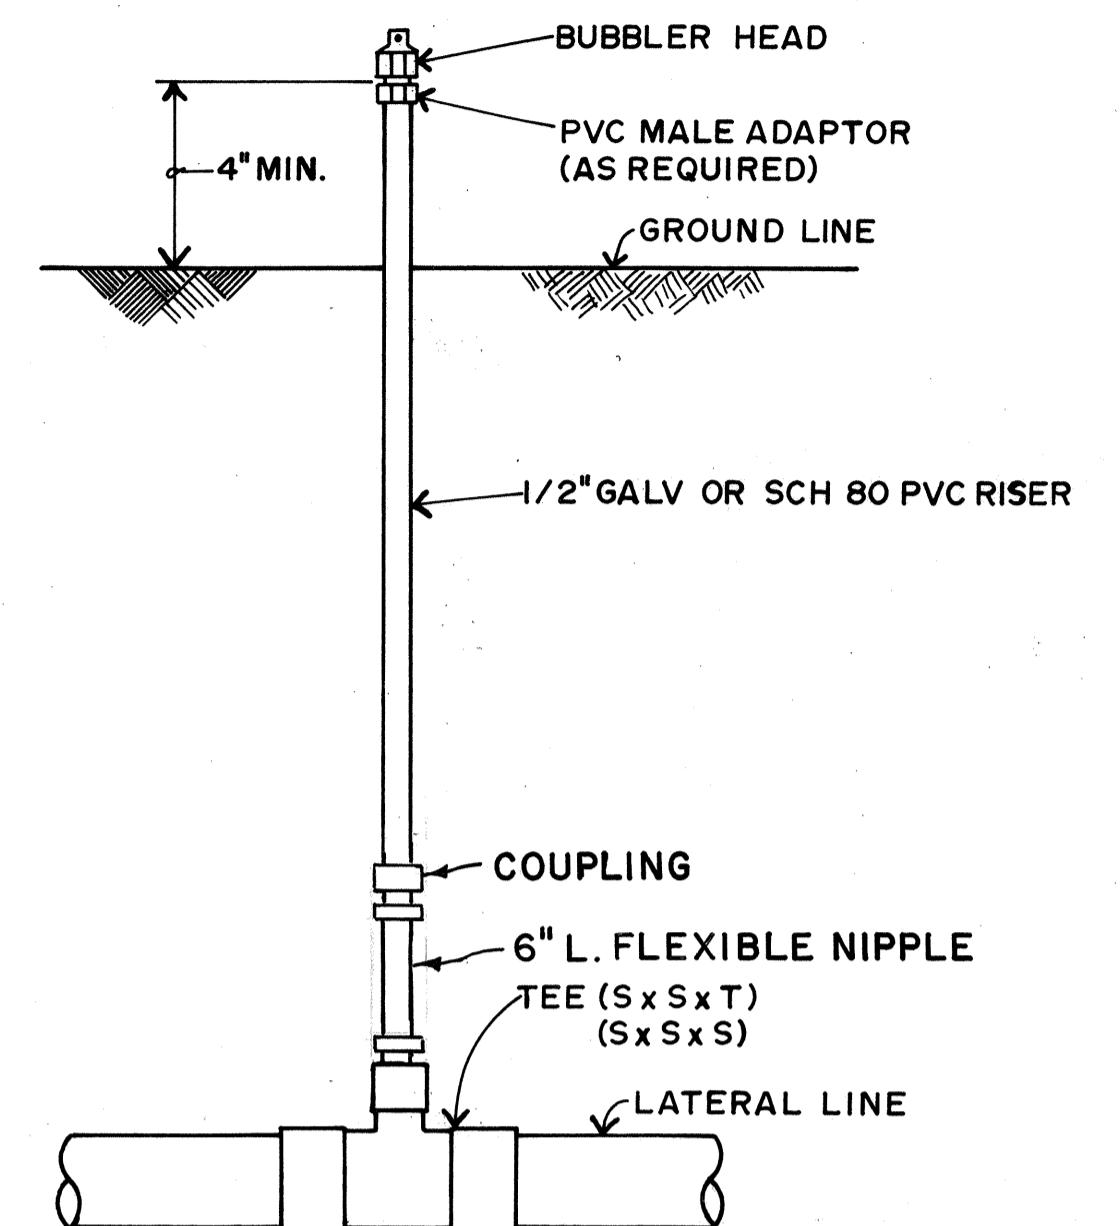


TYPICAL BUBBLER HEAD DETAIL

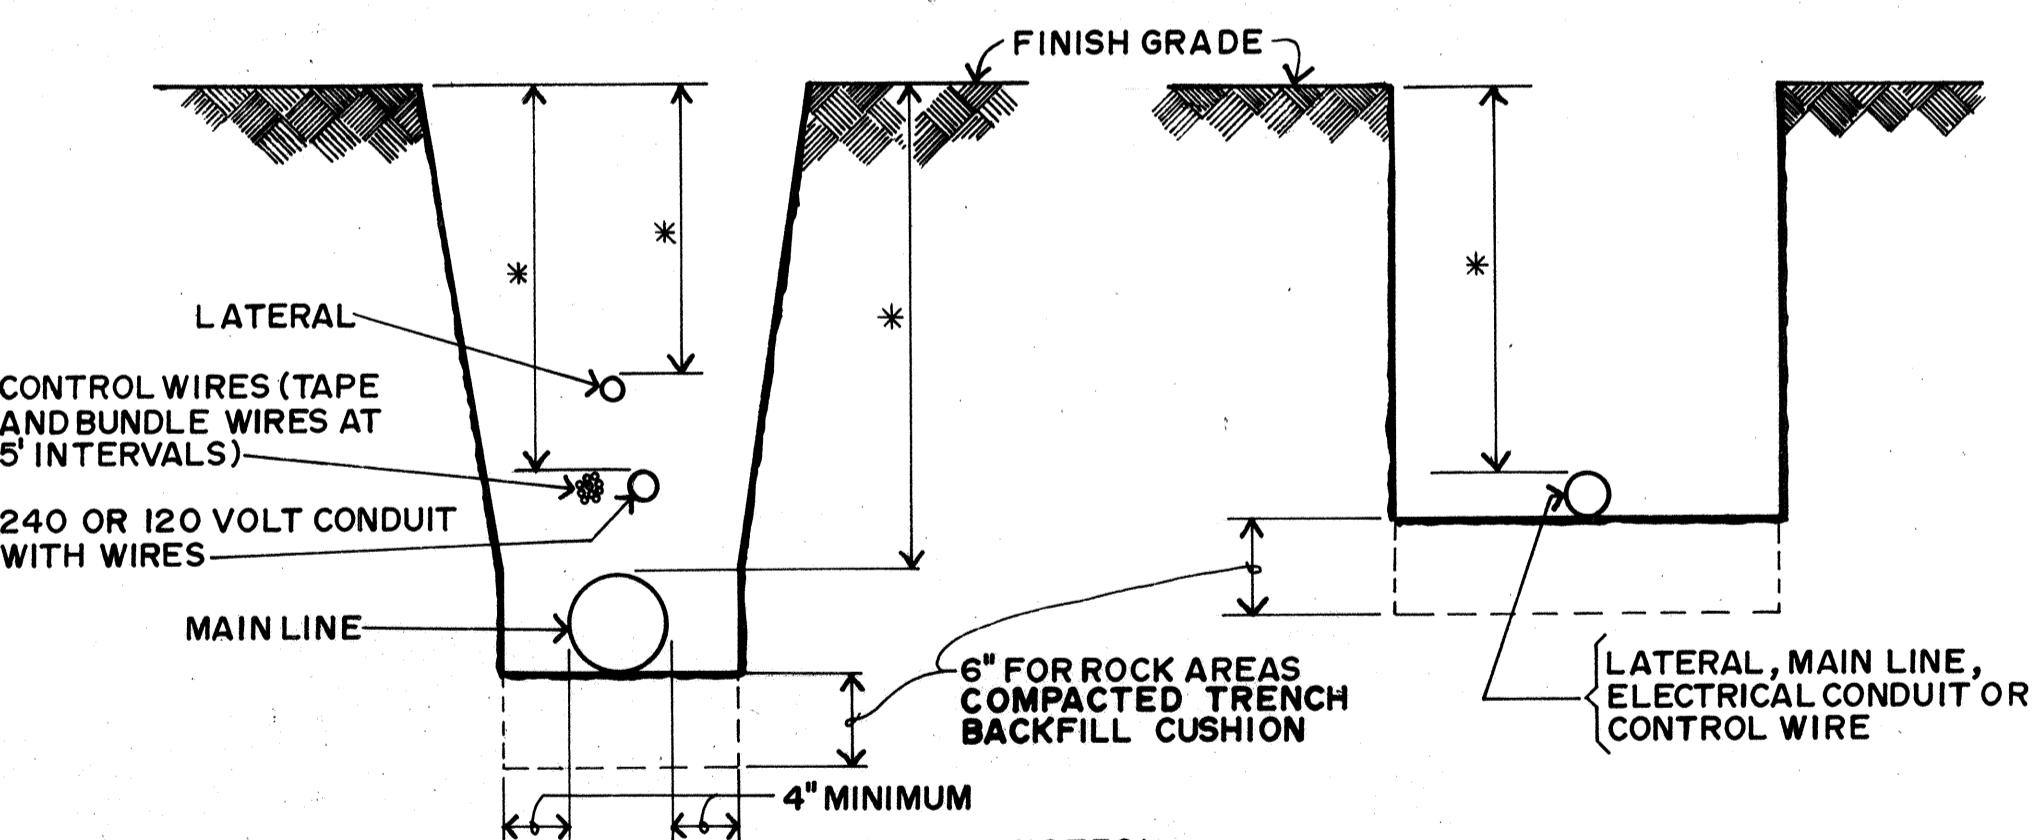

	MINIMUM COVER
SPRINKLER LATERALS	12"
SPRINKLER MAINS	
1/2" TO 2 1/2"	18"
3" OR 4"	24"
OVER 4"	30"
ELECTRICAL CONDUIT	24"
CONTROL WIRES	18"

TRENCH DETAIL

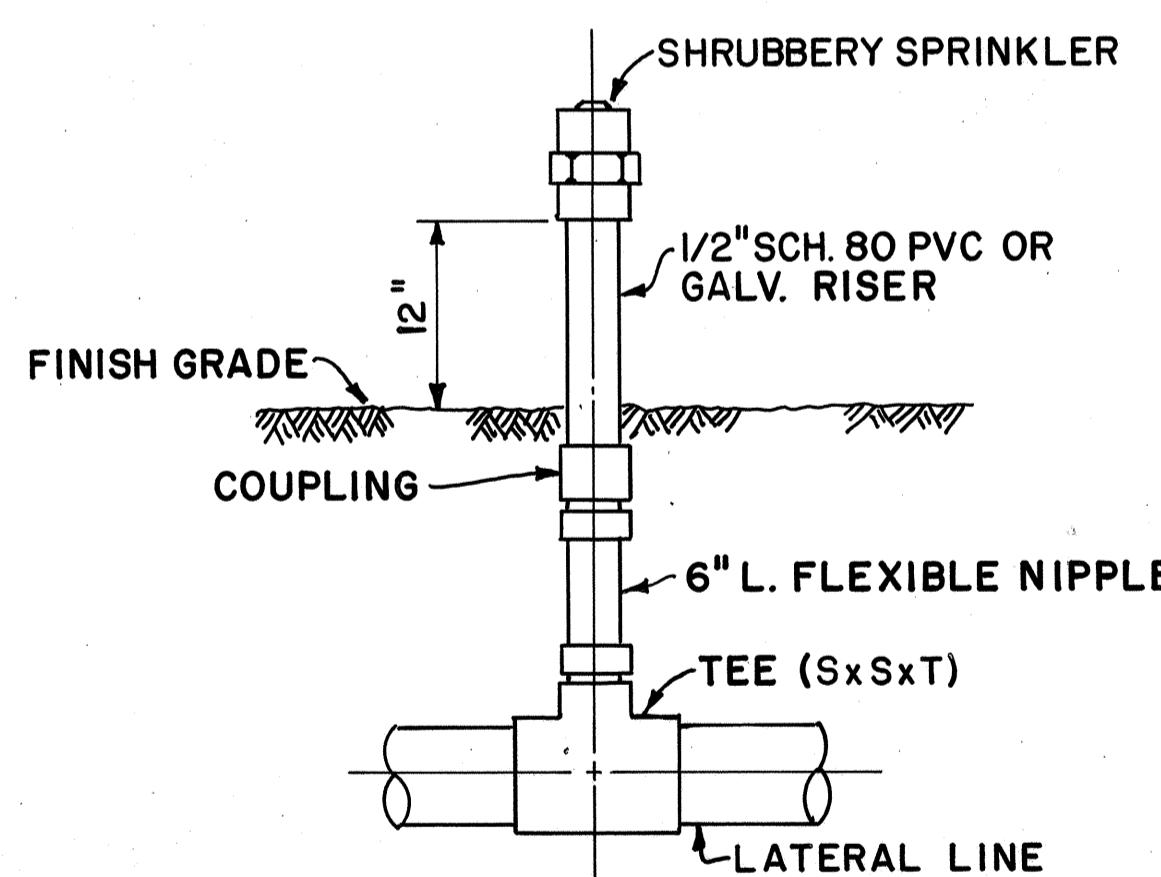

DETAIL OF SPRINKLER HEAD ON RISER

- NOTES:
1. PIPES UNDER ROADWAY SHALL HAVE MINIMUM COVER OF 24 INCHES AND SHALL NOT BE IN THE ROADWAY STRUCTURE.
 2. THERE SHALL BE A 3" MINIMUM CLEARANCE BETWEEN CONTROL WIRE BUNDLE, CONDUIT, MAIN AND LATERAL LINES.
 3. THE WIDTH OF THE TRENCH SHALL BE AS NARROW AS PRACTICAL TO FACILITATE INSTALLATION. APPROXIMATELY TWICE THE OUTSIDE DIAMETER OF THE PIPE WITH A MINIMUM OF 8".

11/14/83 Sheet added to Contract
Plans to show required
sprinkler details.


DATE	REVISION	SHEET NO. OF SHEETS
------	----------	---------------------

STATE OF HAWAII
DEPARTMENT OF TRANSPORTATION
HIGHWAYS DIVISION
SPRINKLER DETAILS
INTERSTATE H-I IMPROVEMENTS
MIDDLE STREET TO KALIHI INTERCHANGE
EASTBOUND LANES
F.A.I. PROJECT NO. I-HI-(178)
NOT TO SCALE

C.0.60 S-1


SURVEY PLOTTED BY _____
DRAWN BY _____
THREADED BY _____
DESIGNED BY _____
QUANTITY BY _____
CHECKED BY _____

ORIGINAL
PLAN
NOTE BOOK
No. _____

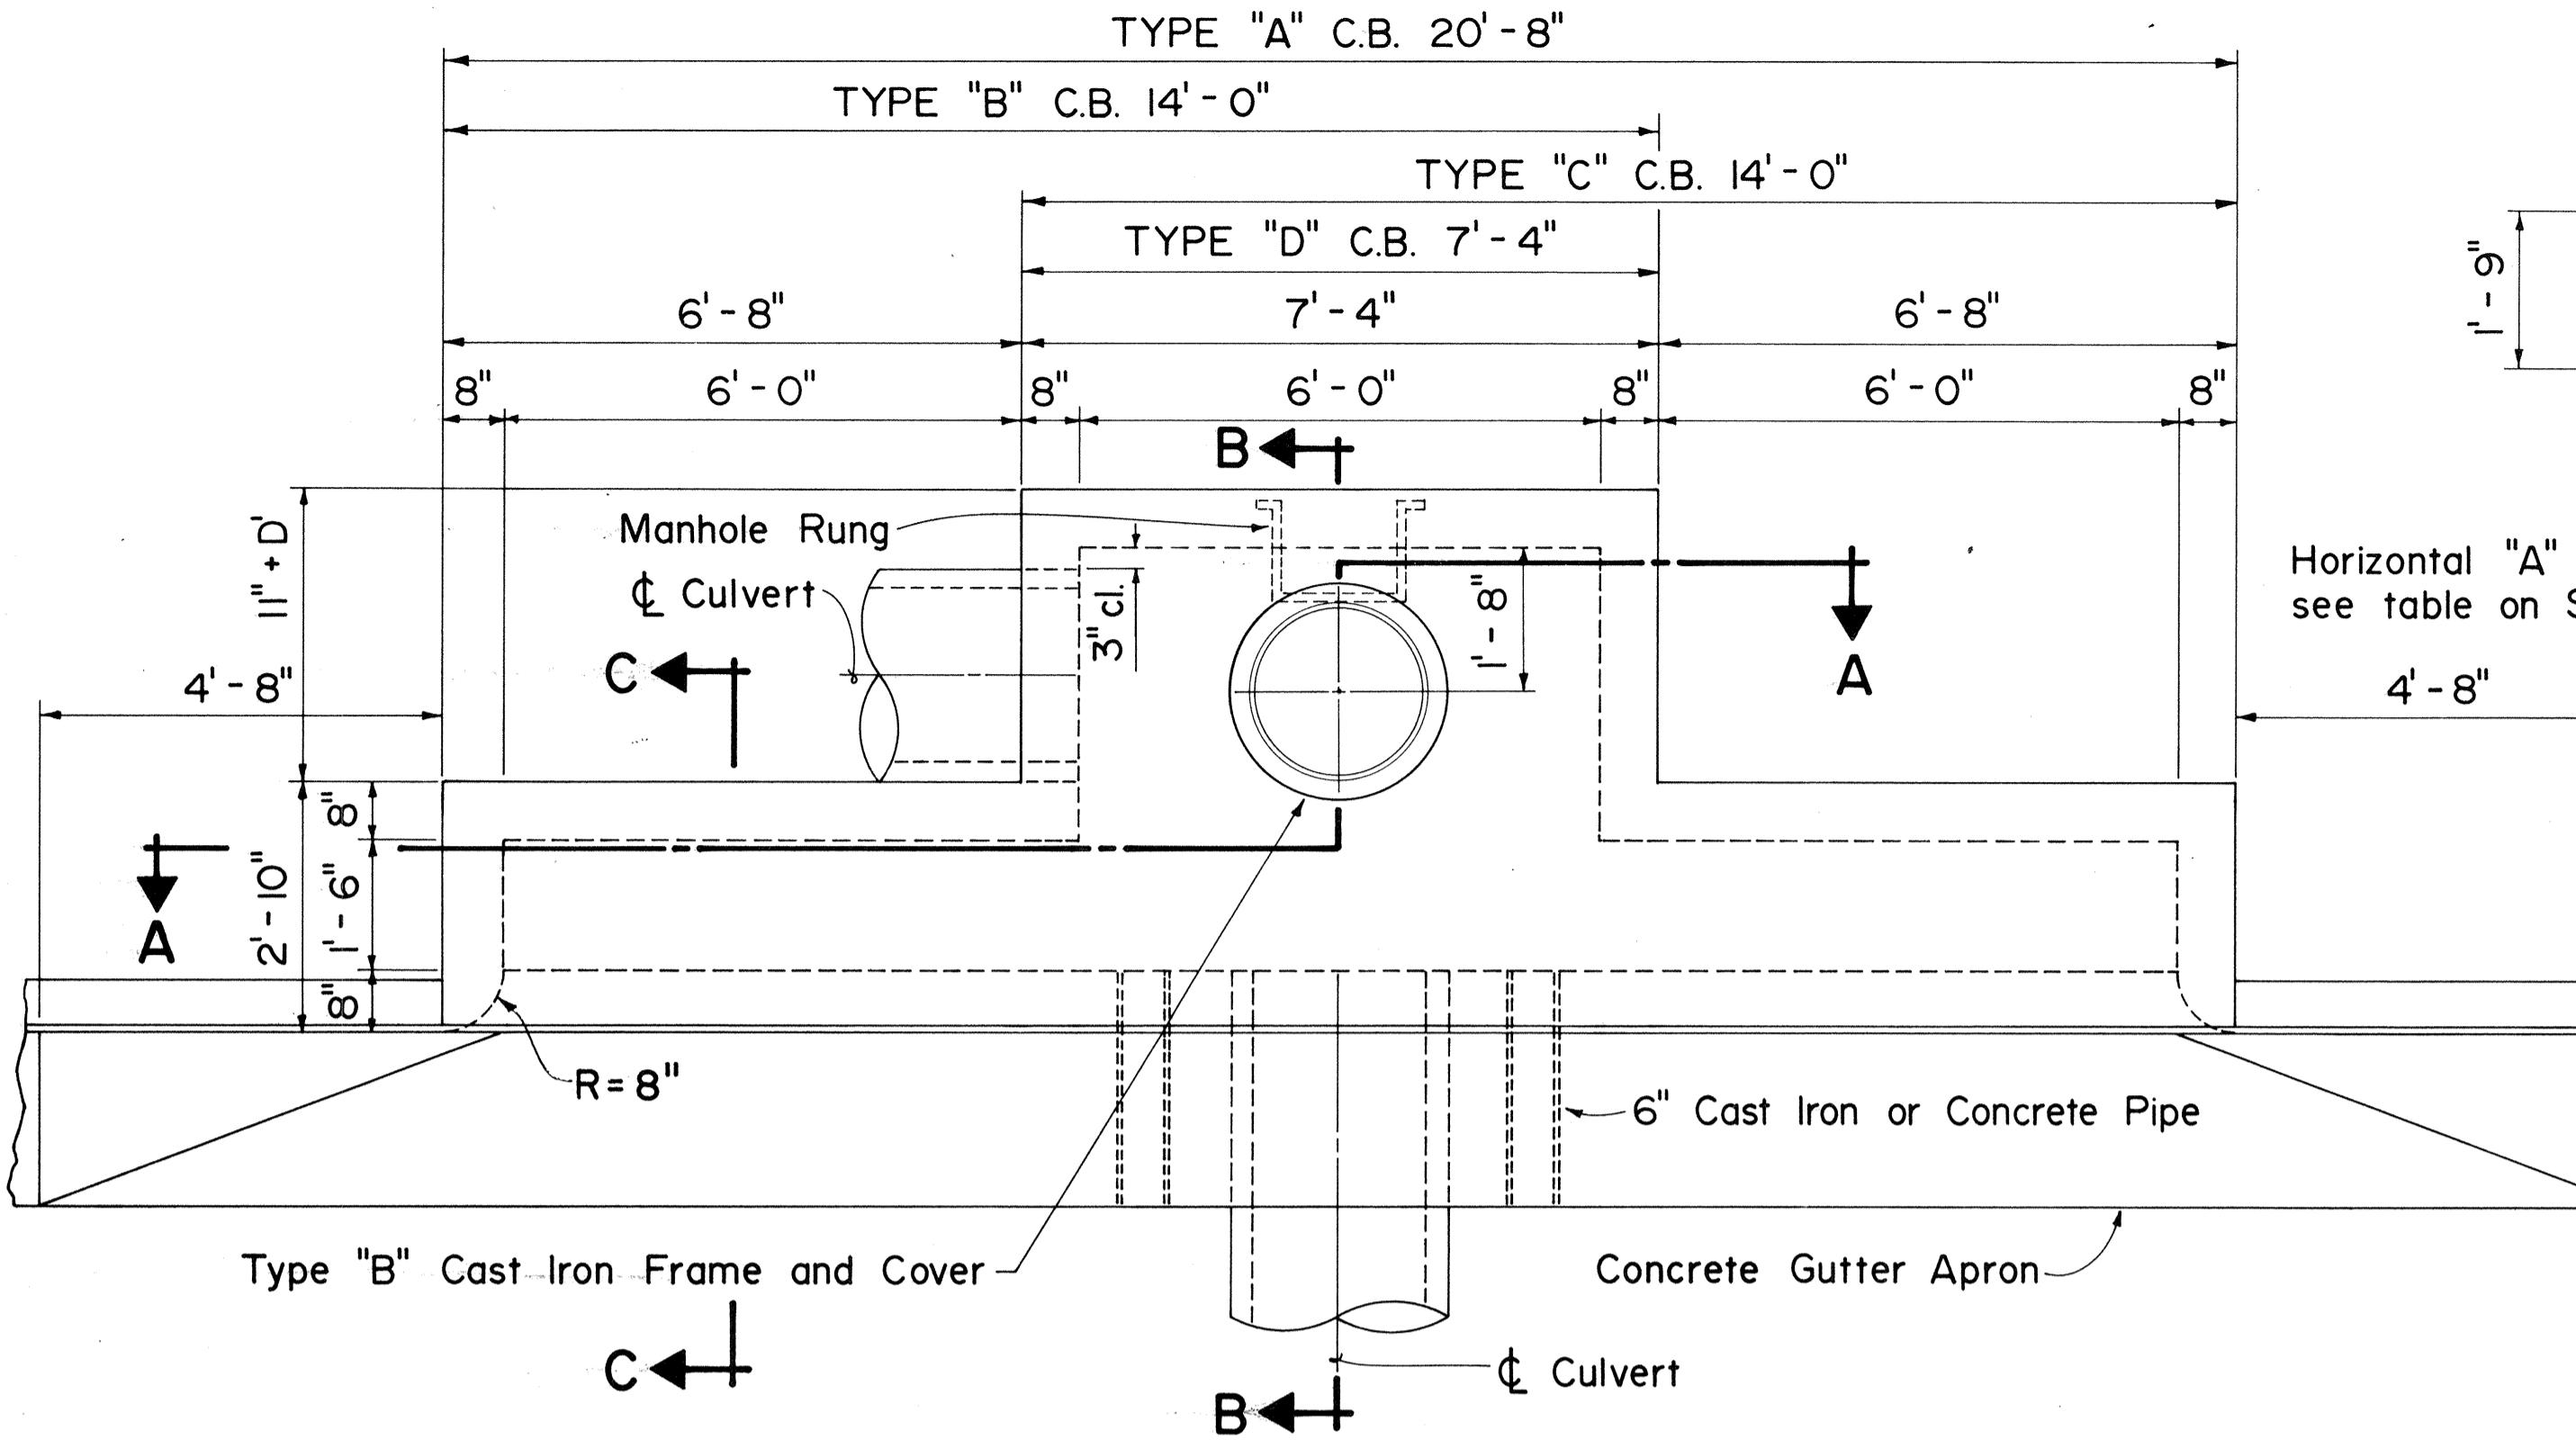


PLAN

Opening for Type "B" Cast Iron Frame and Cover. For added reinforcing around hole see Standard Details sheet DH 4

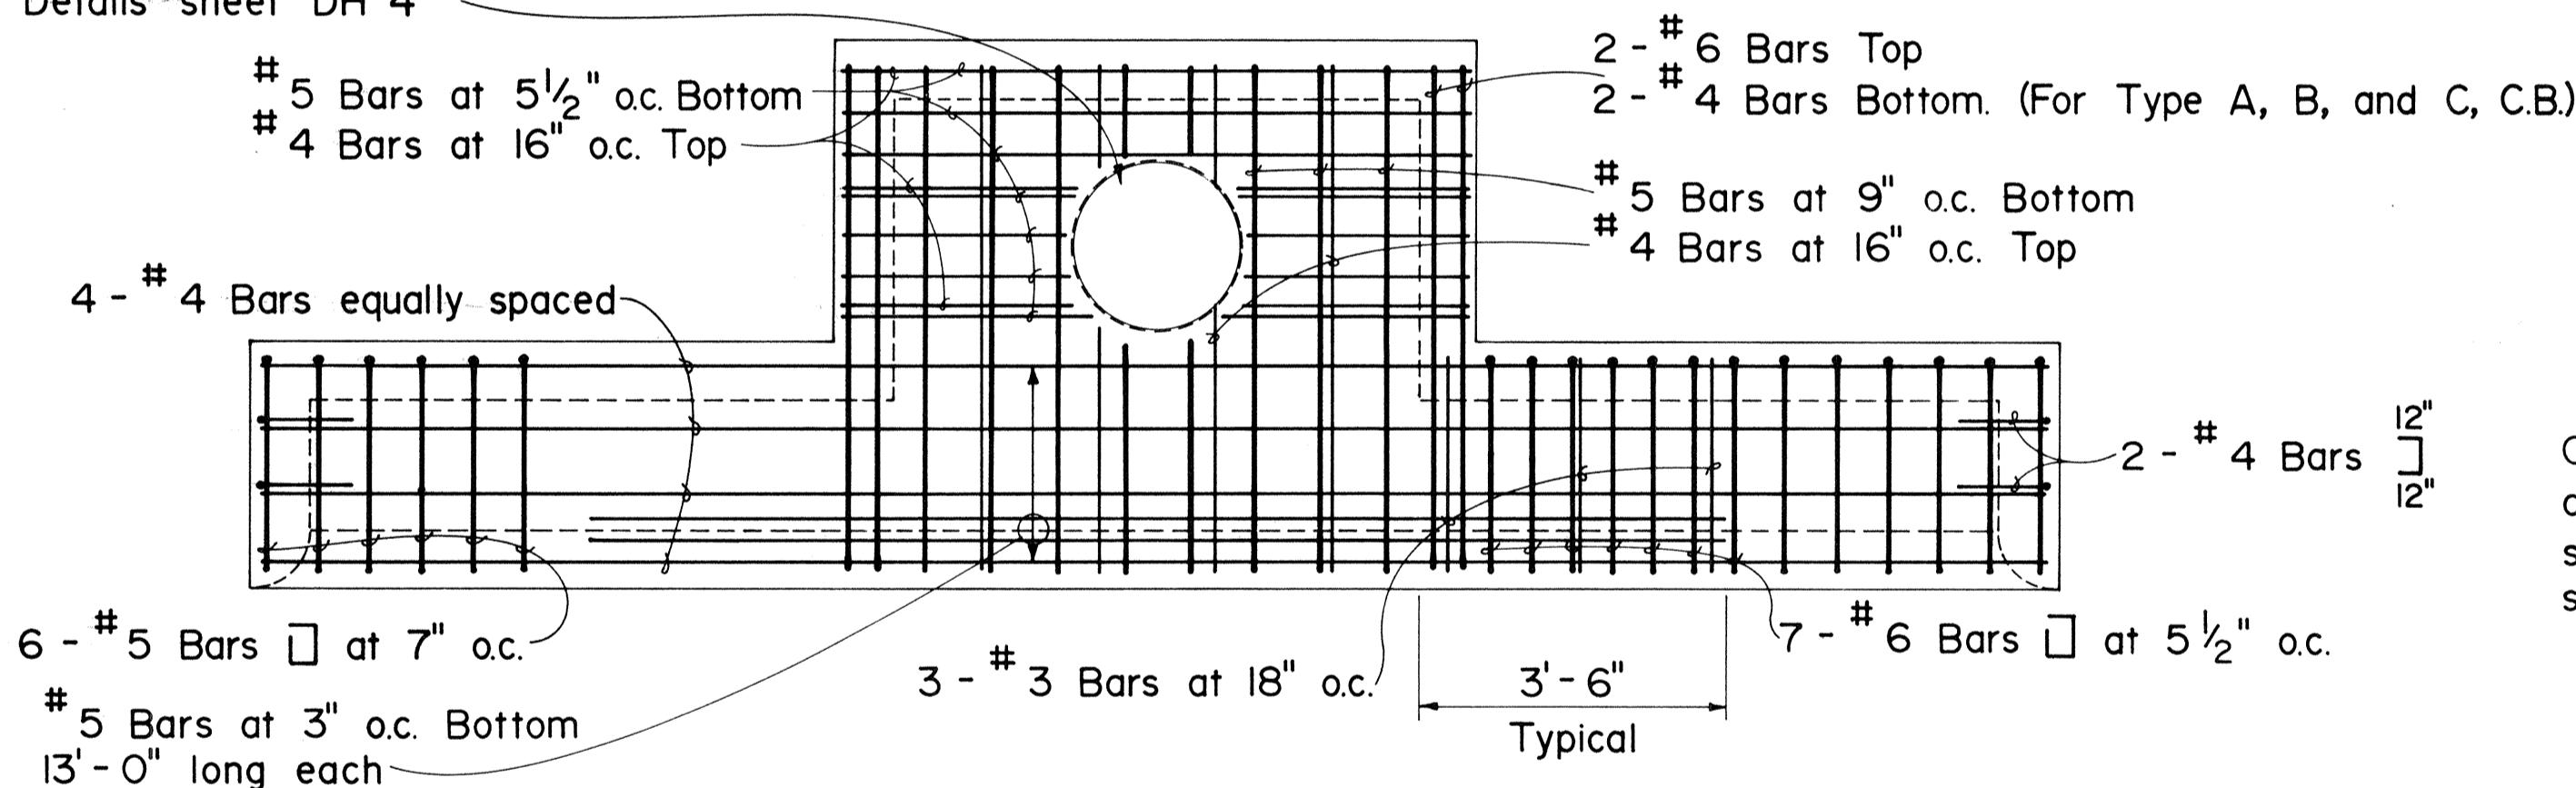


PLAN VIEW OF REINFORCING STEEL


TYPE "A", "B", "C" & "D" CATCH BASIN

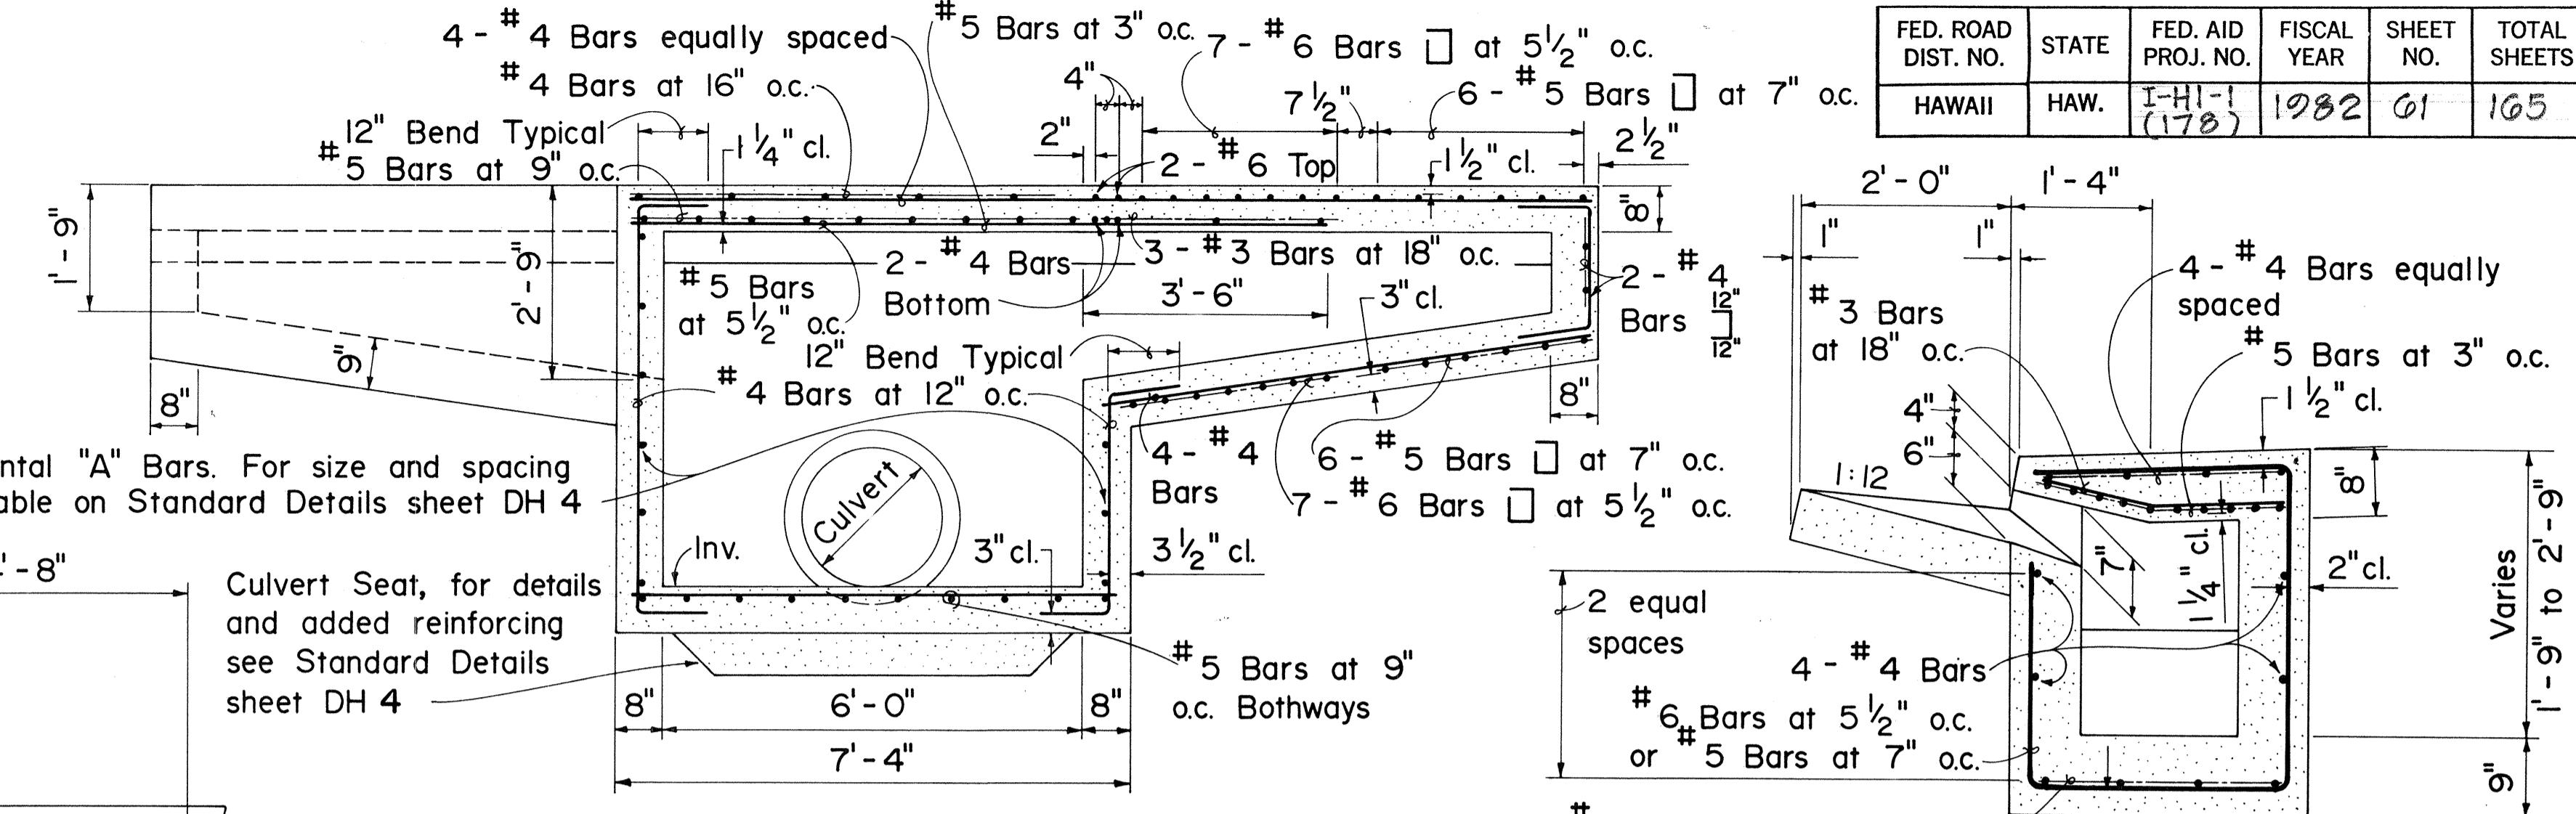


SECTION "A-A"

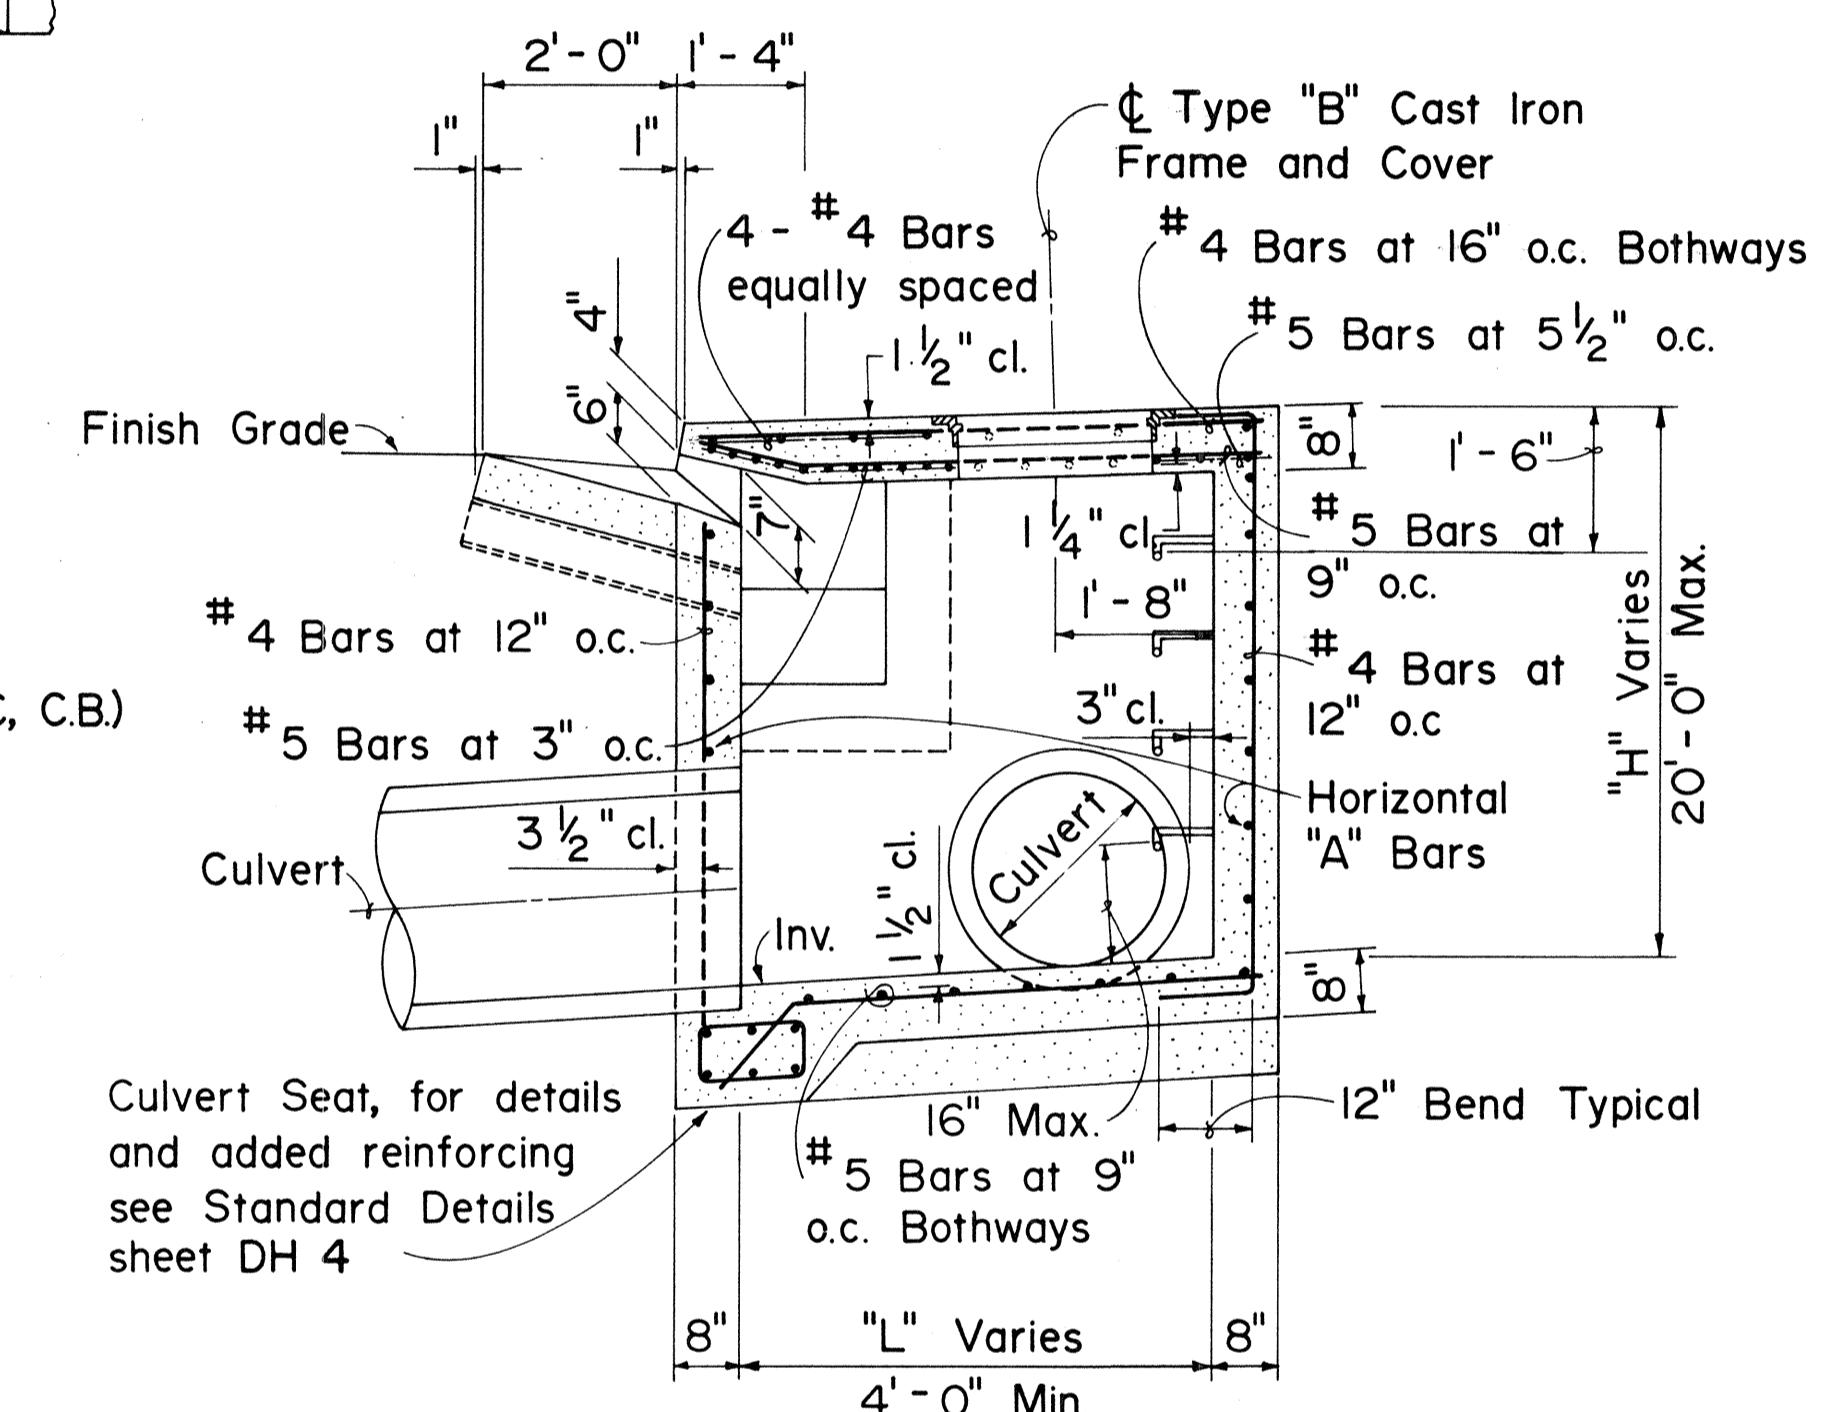

SECTION "B-B"

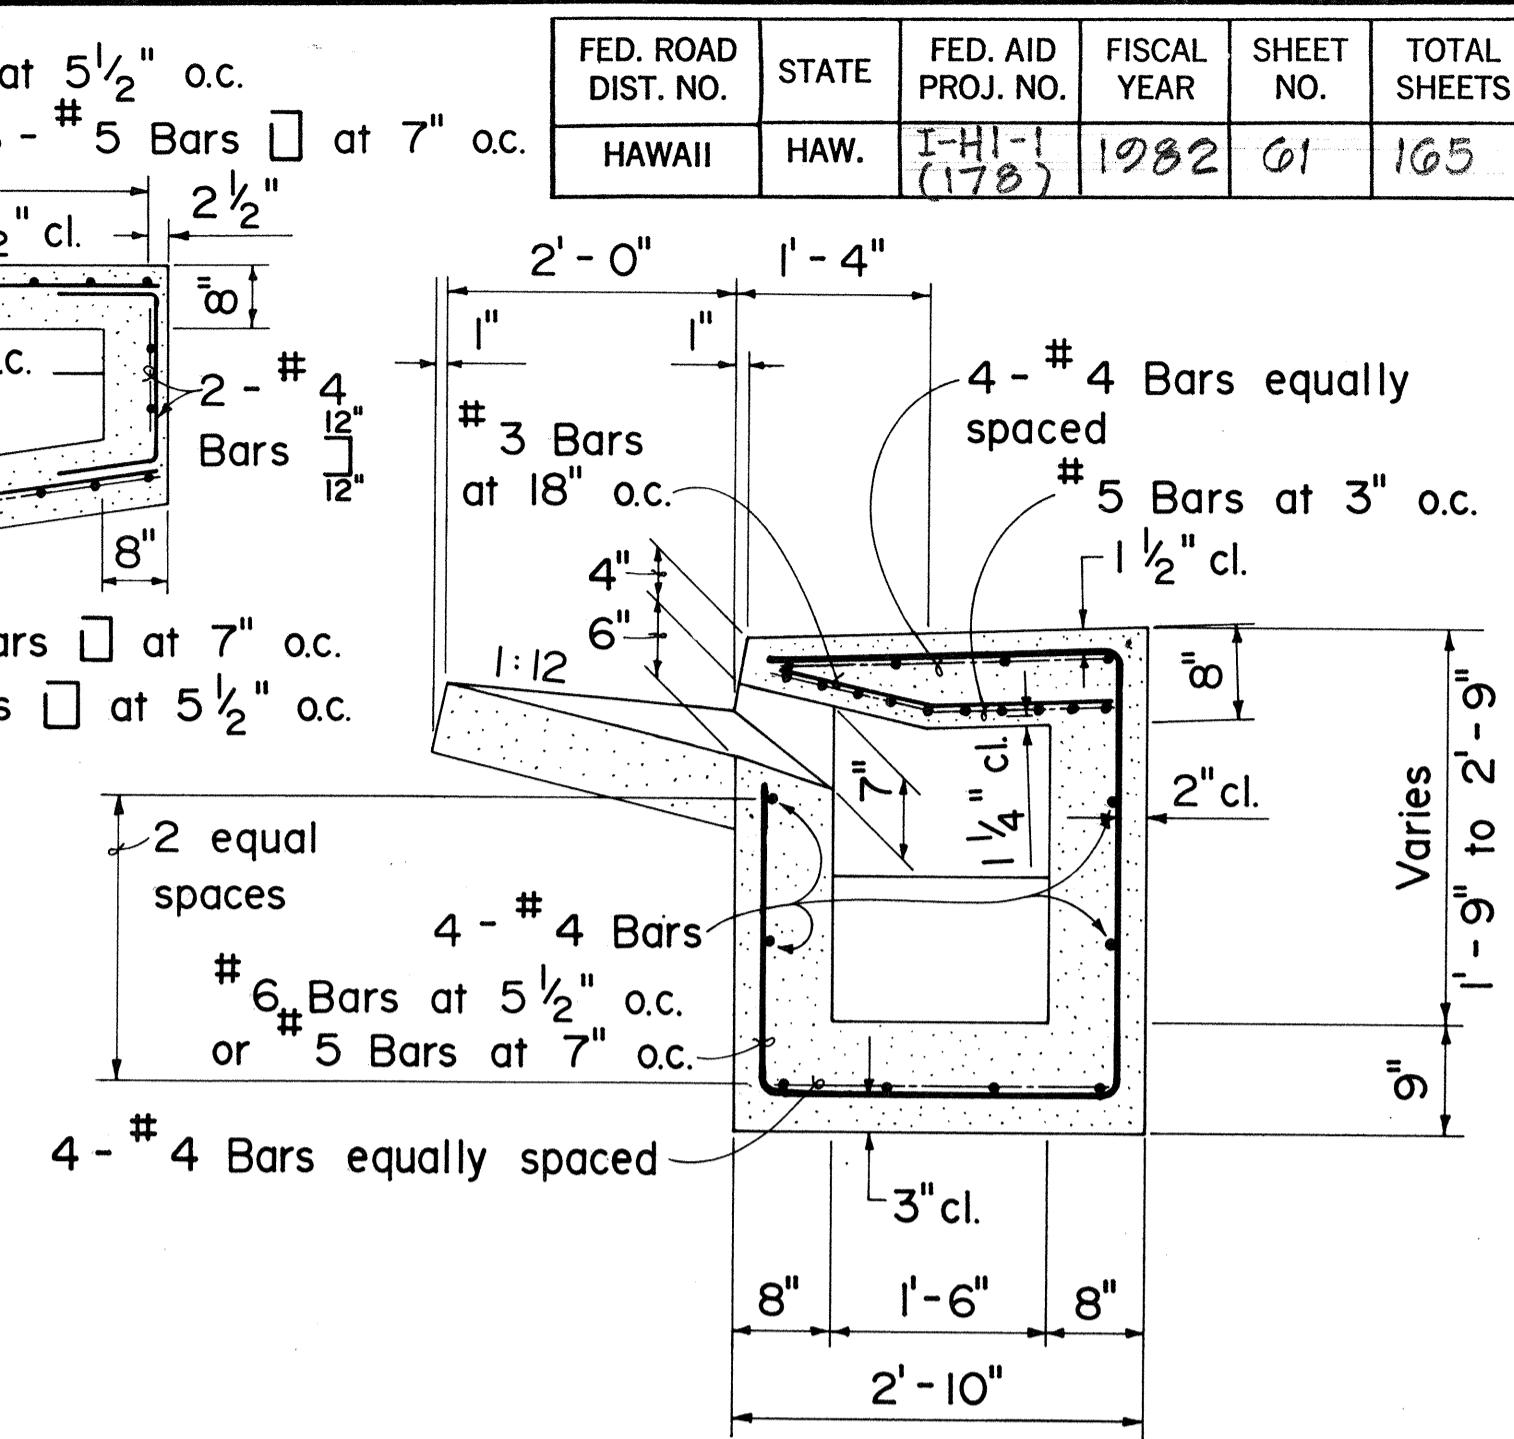

SECTION "C-C"
(2DG Curb and Gutter)

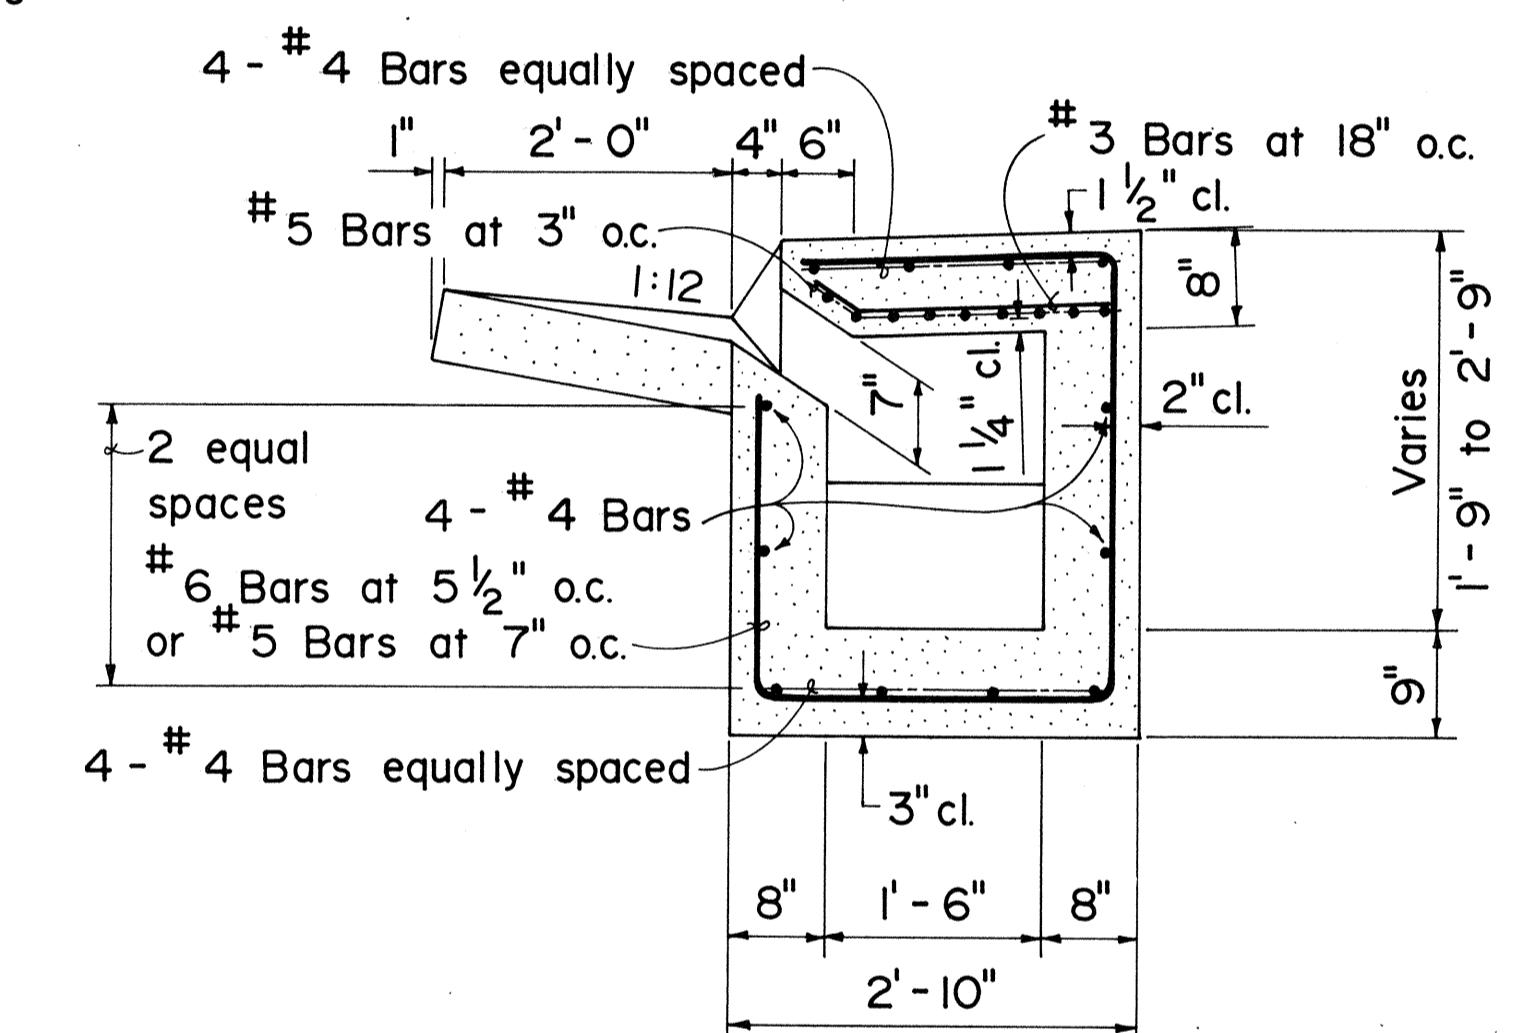

SECTION "C-C"
(2AG Curb and Gutter)

APPROVAL RECOMMENDED:
Edwin M. Lee
HYDRAULIC DESIGN ENGINEER

12/3/80
DATE

APPROVED:
Herb Zalech
ASSISTANT CHIEF, ENGINEERING

12/4/80
DATE

NO.	REVISION	APPROVED BY	DATE
I.	Supersedes Sht. DH I approved 12/17/69	H.L.	12/4/80






STATE OF HAWAII
DEPARTMENT OF TRANSPORTATION
HIGHWAYS DIVISION

STANDARD DETAILS TYPE A, B, C, & D CATCH BASIN

Not To Scale Date: Dec. 1980

SHEET NO. 29 OF 33 SHEETS DH 1

FED. ROAD DIST. NO.	STATE	FED. AID PROJ. NO.	FISCAL YEAR	SHEET NO.	TOTAL SHEETS
HAWAII	HAW.	I-HI-1 (170)	1982	62	165

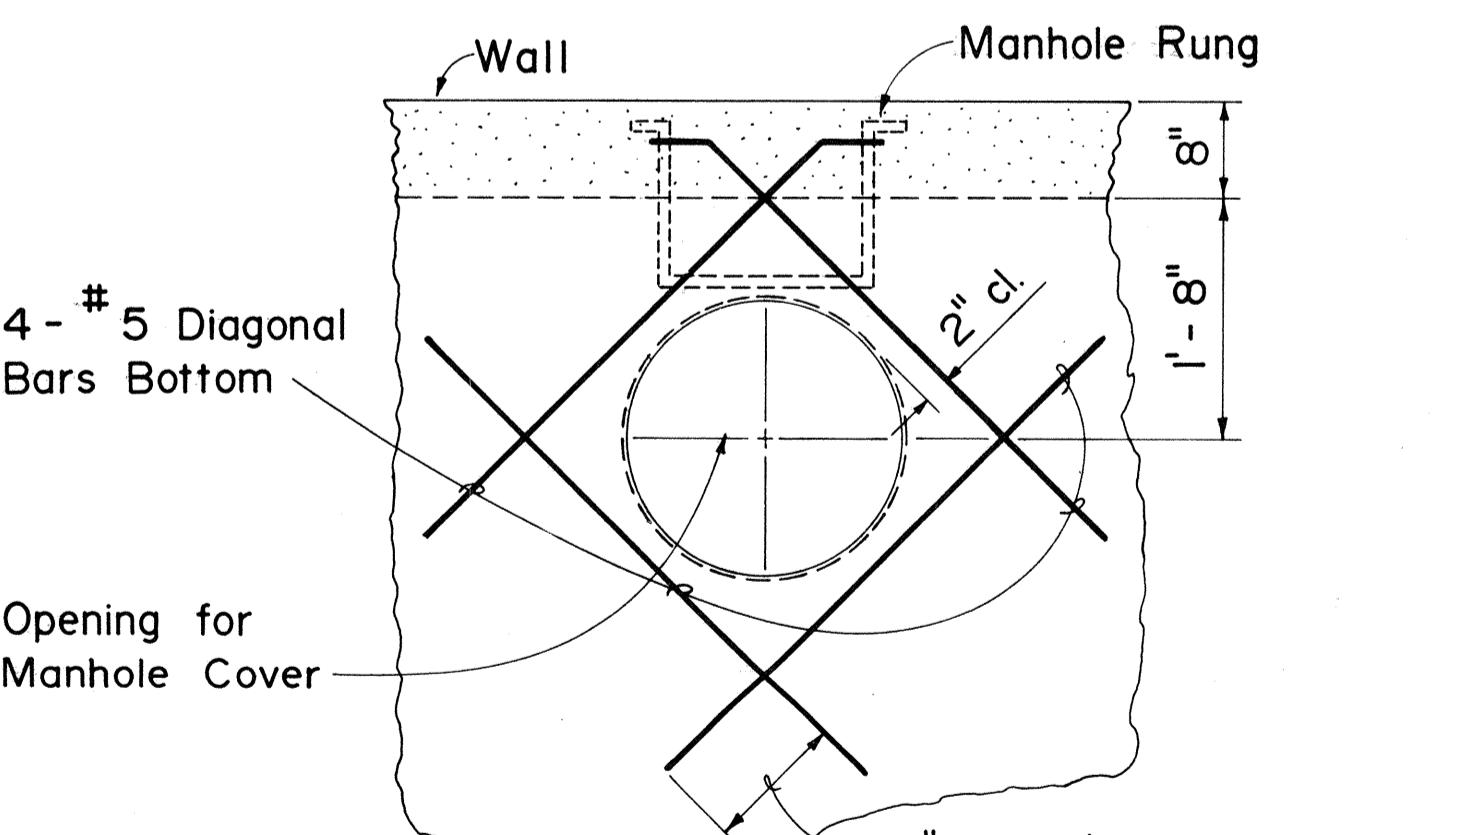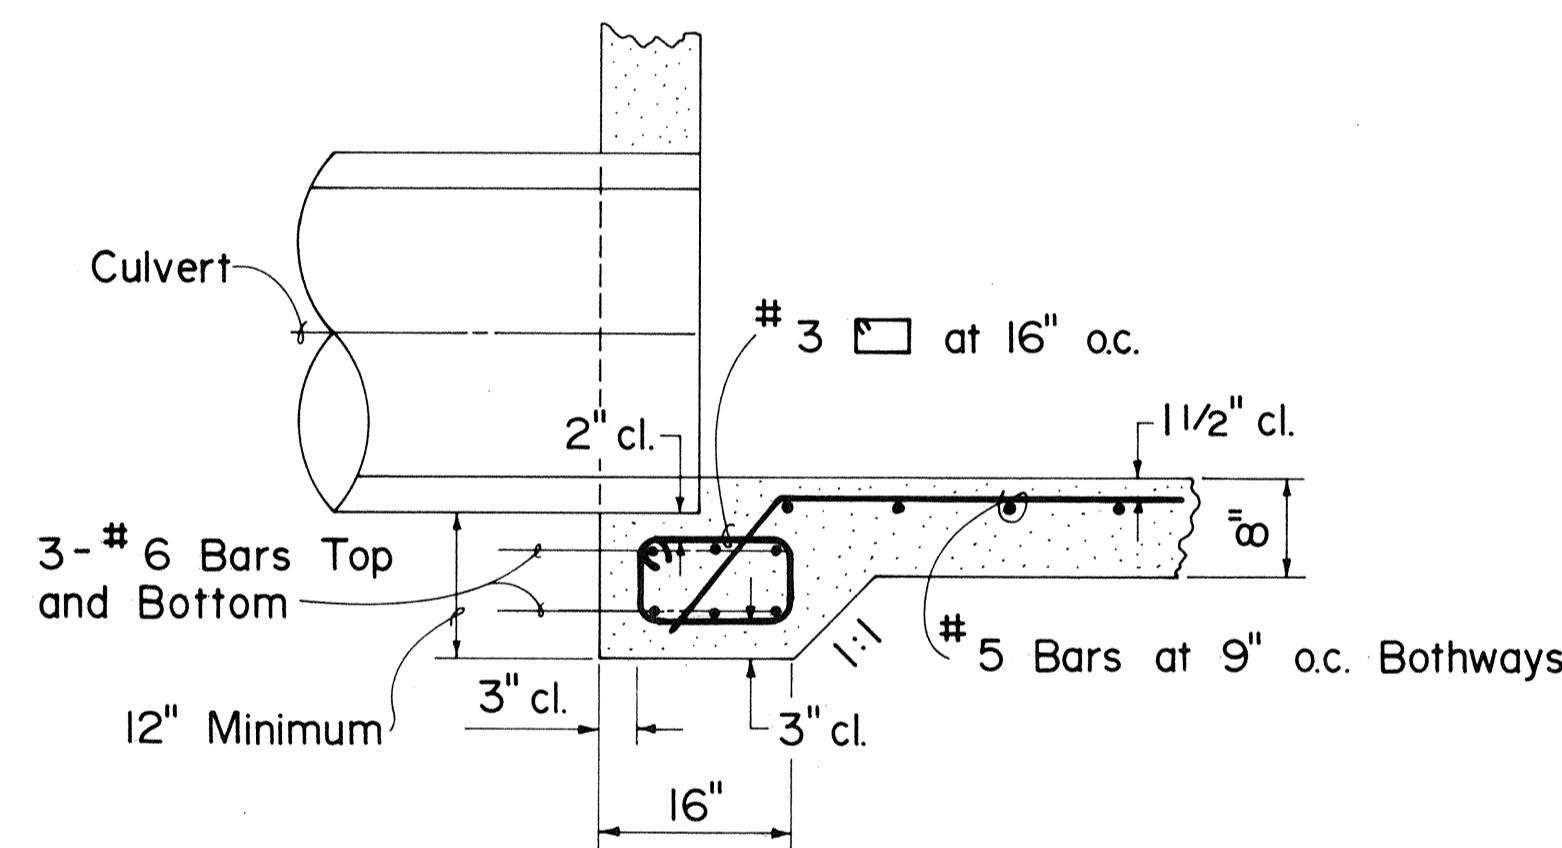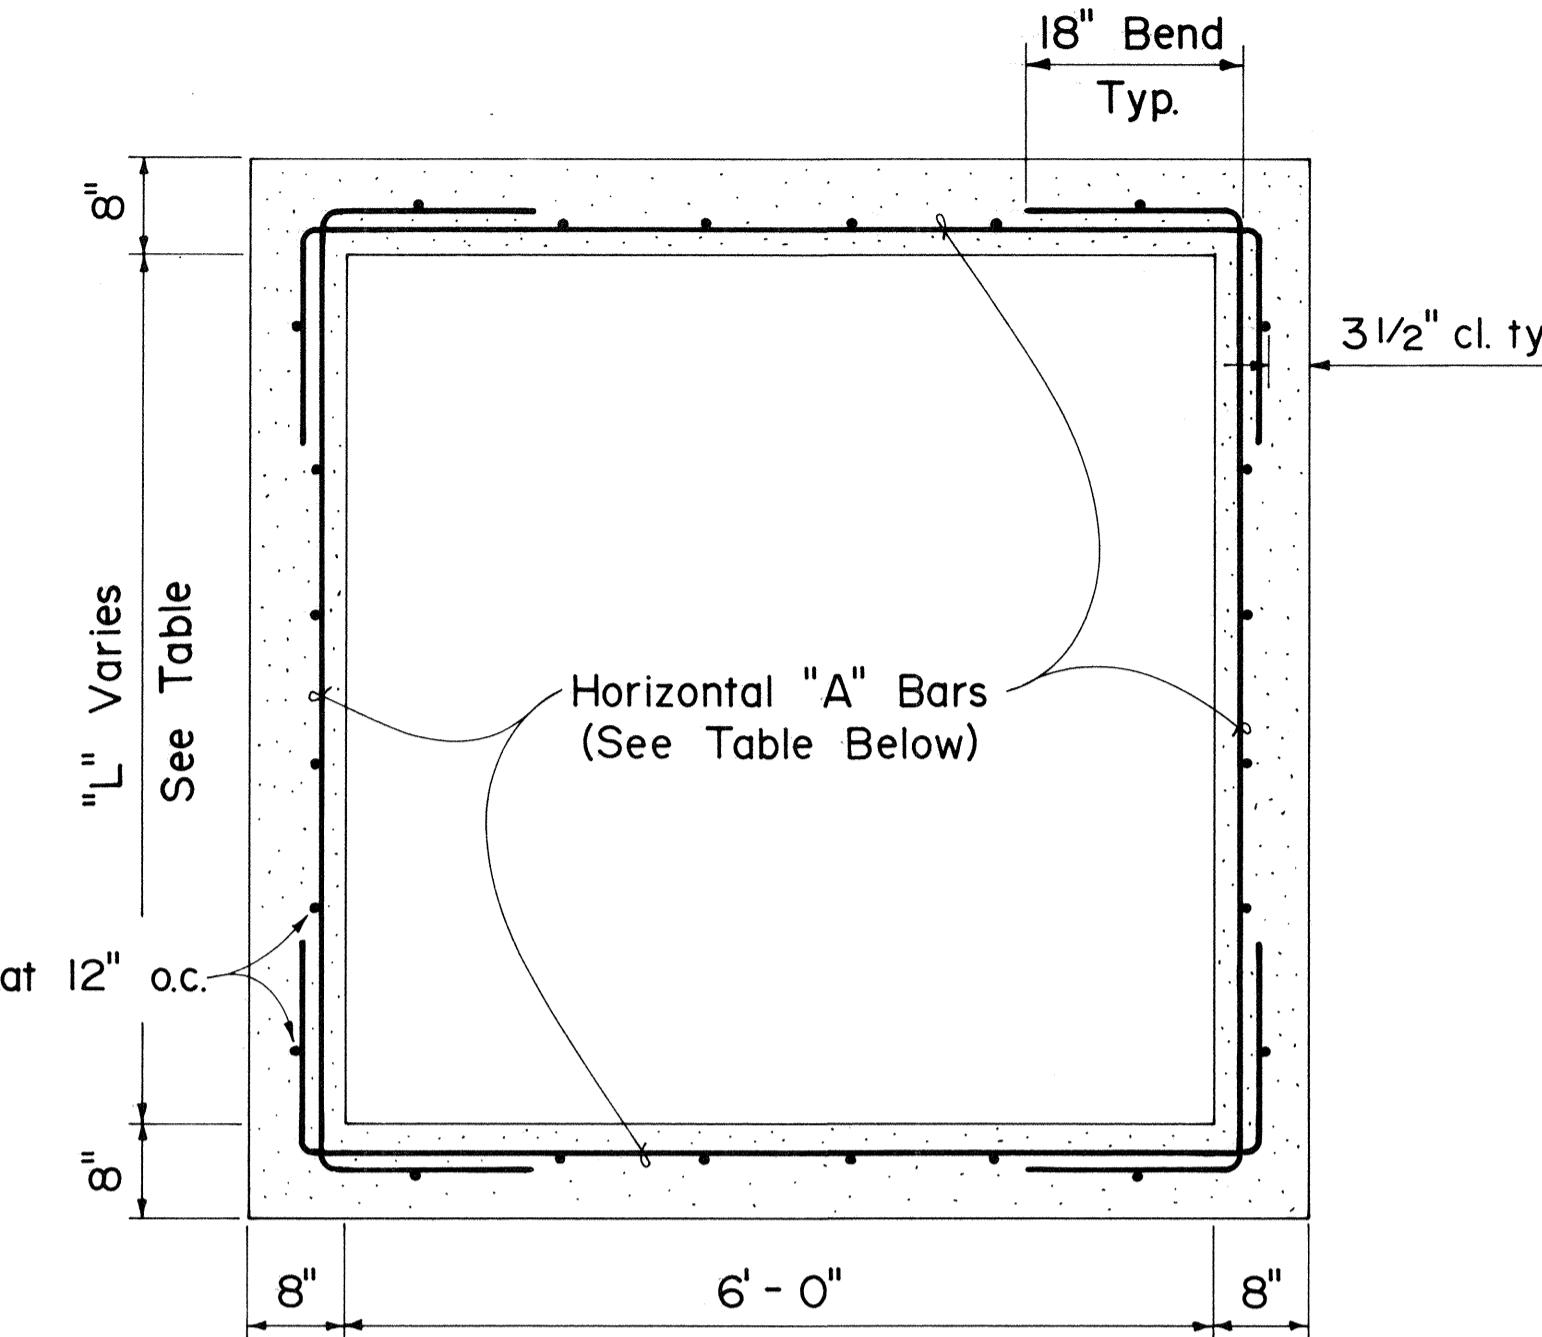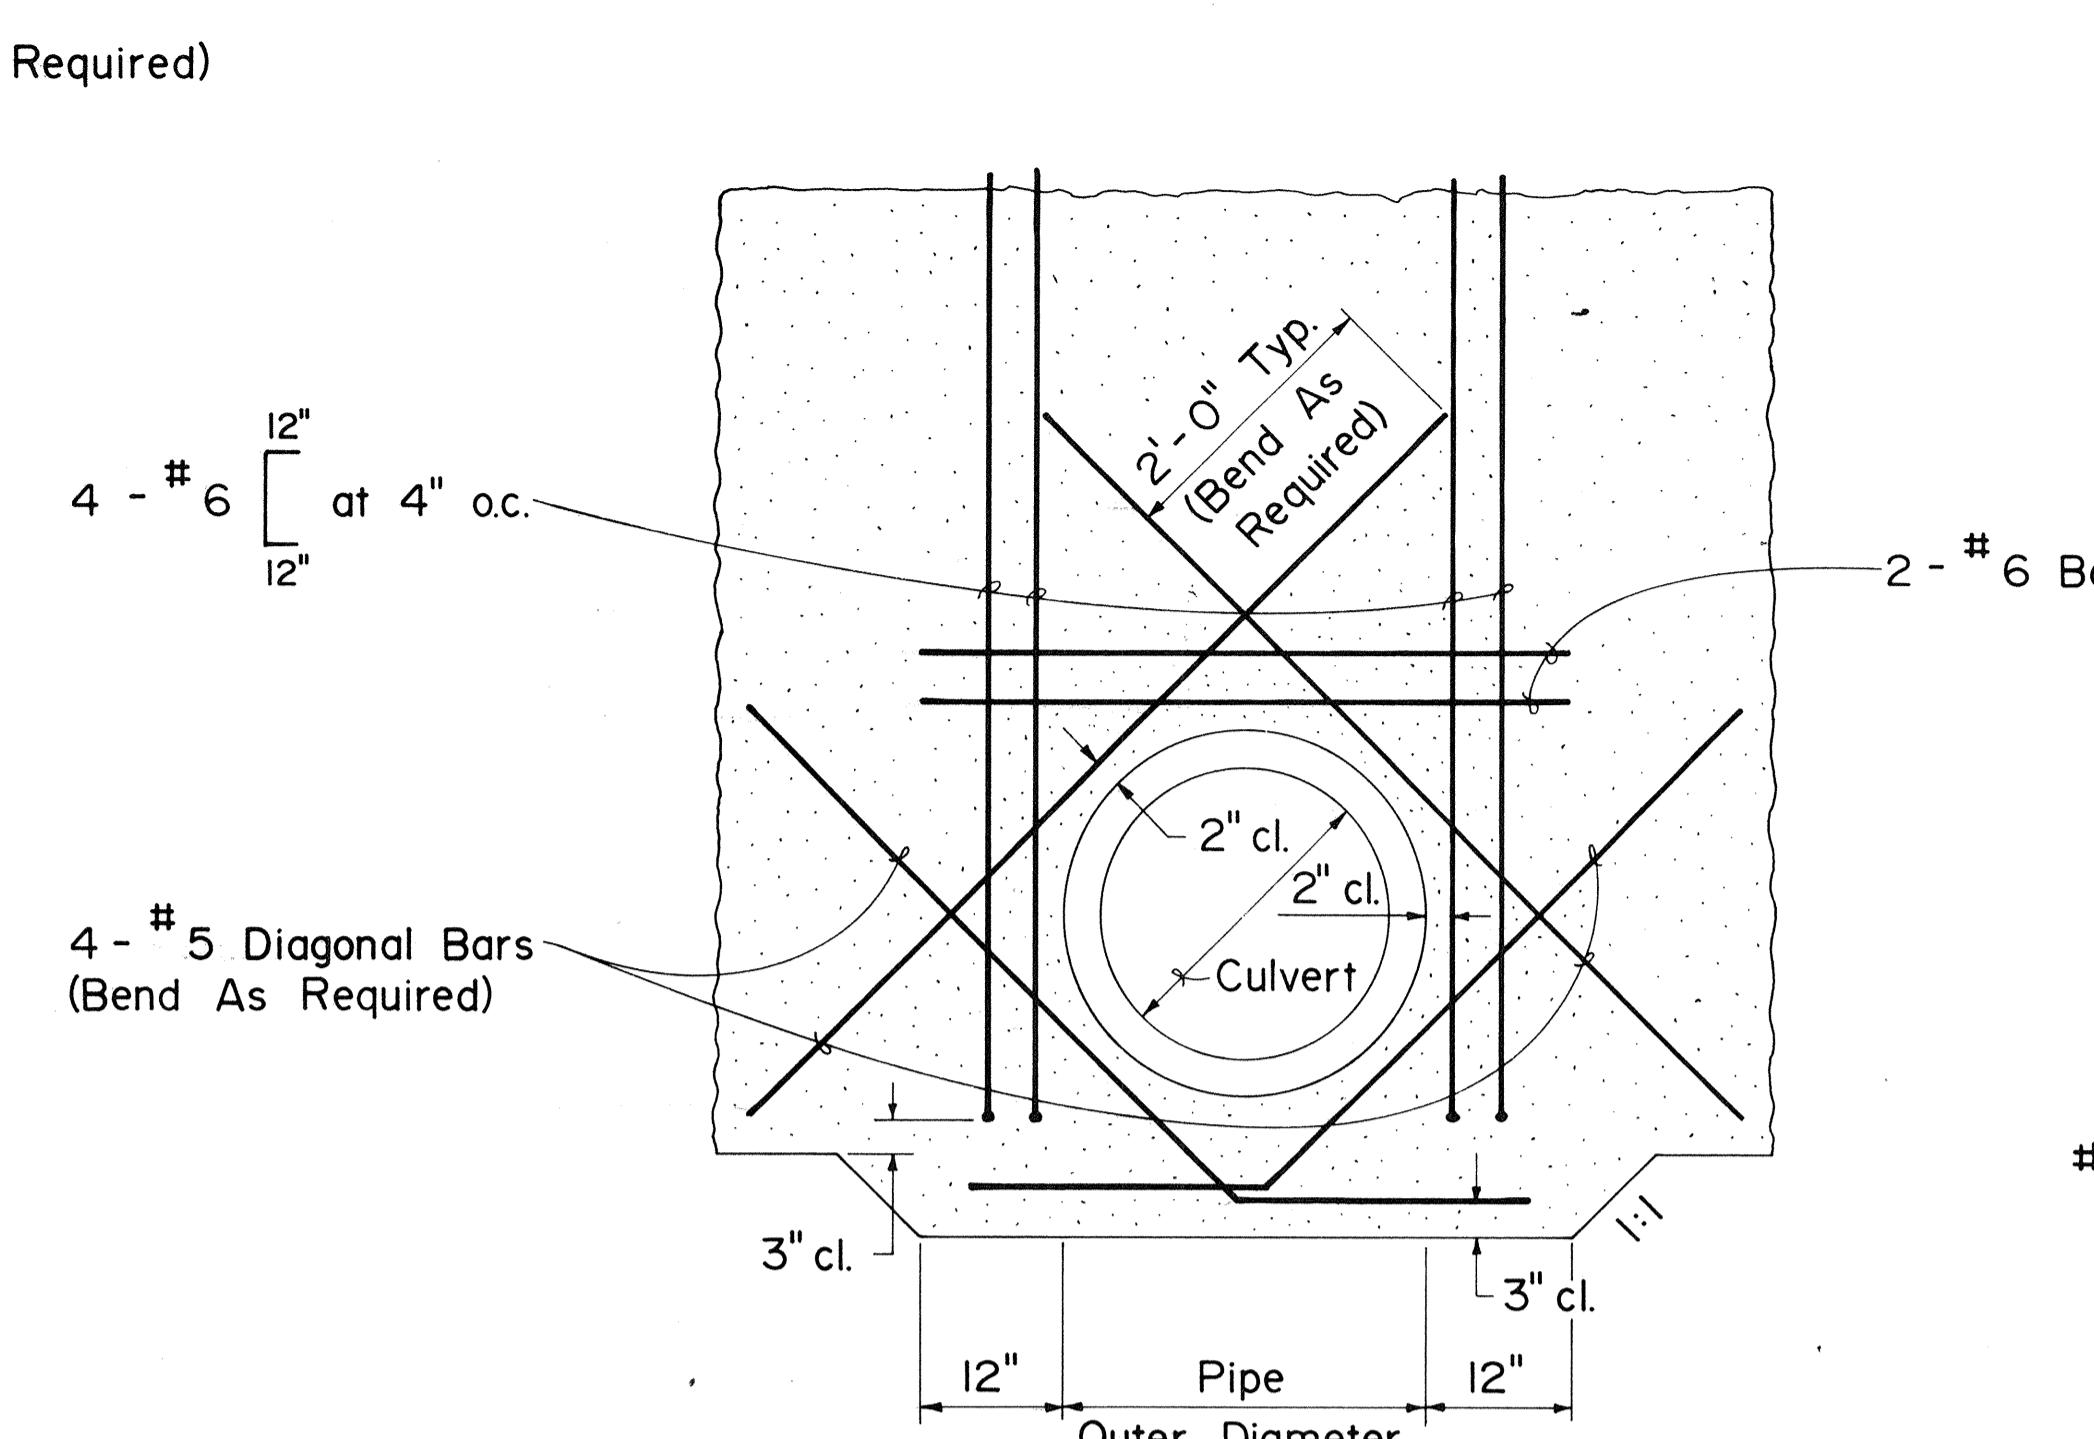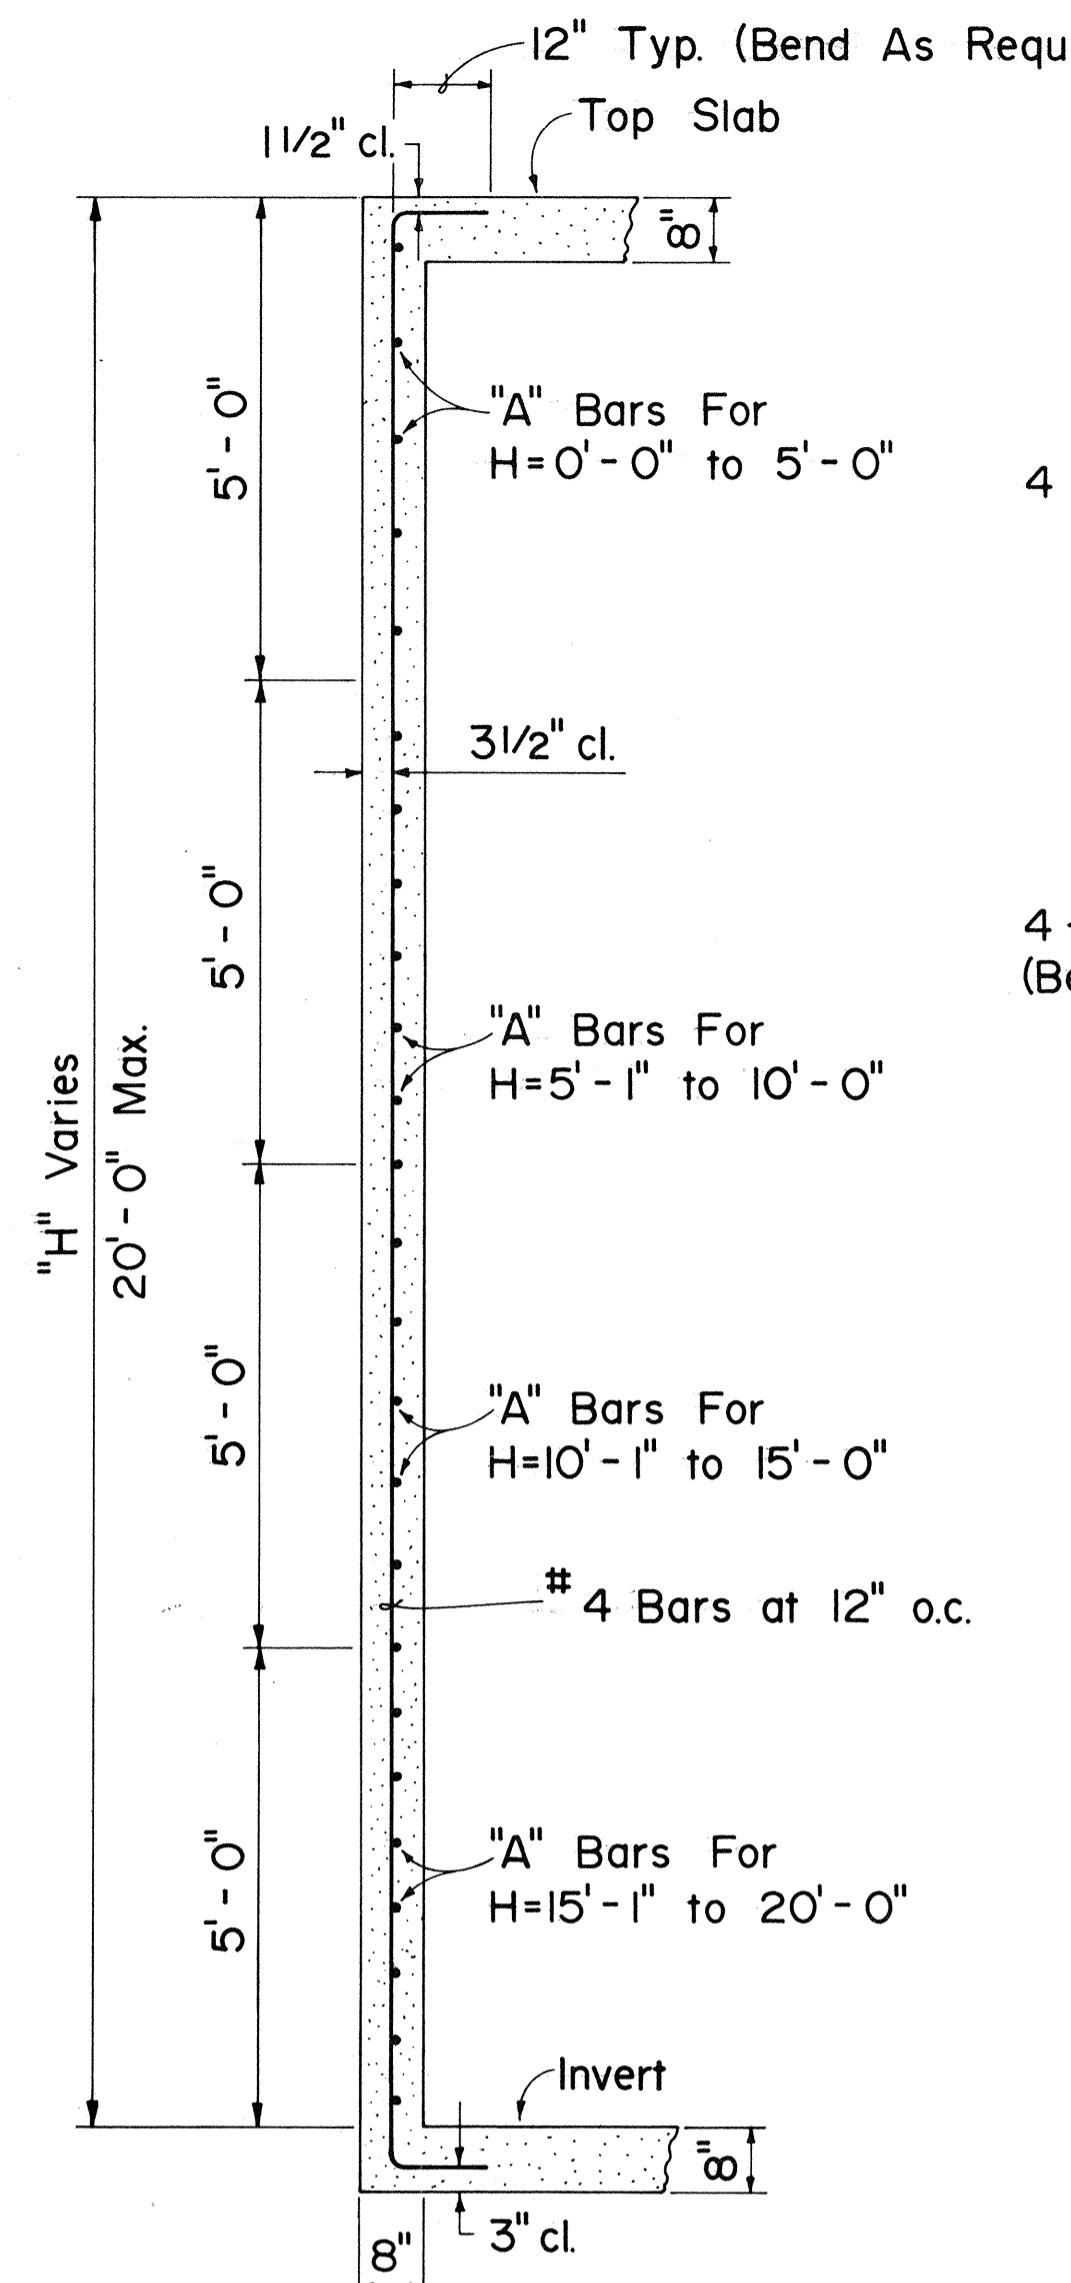

HORIZONTAL "A" BARS					
"H" MAX. (FT.)	"L" MAX. (FT.)				
	4'-0"	6'-0"	7'-4"	8'-4"	9'-4"
0'-0" to 5'-0"	# 4 at 12" o.c.	# 4 at 10" o.c.	# 5 at 10" o.c.	# 5 at 8" o.c.	# 5 at 7" o.c.
5'-1" to 10'-0"	# 4 at 9" o.c.	# 5 at 9" o.c.	# 5 at 6" o.c.	N.A.	N.A.
10'-1" to 15'-0"	# 5 at 10" o.c.	# 5 at 6" o.c.	N.A.	N.A.	N.A.
15'-1" to 20'-0"	# 5 at 8" o.c.	N.A.	N.A.	N.A.	N.A.


NO.	REVISION	APPROVED BY	DATE
I.	Replaces Sht. DH 4 approved 12-17-69	H.T.	12/4/80

APPROVAL RECOMMENDED:
John P. Lee
HYDRAULIC DESIGN ENGINEER
DATE


APPROVED:
Robert Takashii
ASSISTANT CHIEF, ENGINEERING
DATE

STATE OF HAWAII
DEPARTMENT OF TRANSPORTATION
HIGHWAYS DIVISION
STANDARD DETAILS
TYPICAL REINFORCING DETAILS
FOR CATCH BASINS
Not To Scale Date: Dec. 1980
SHEET No. 30 OF 33 SHEETS DH 4


FED. ROAD DIST. NO.	STATE	FED. AID PROJ. NO.	FISCAL YEAR	SHEET NO.	TOTAL SHEETS
HAWAII	HAW.	I-HI-1 (178)	1982	63	165

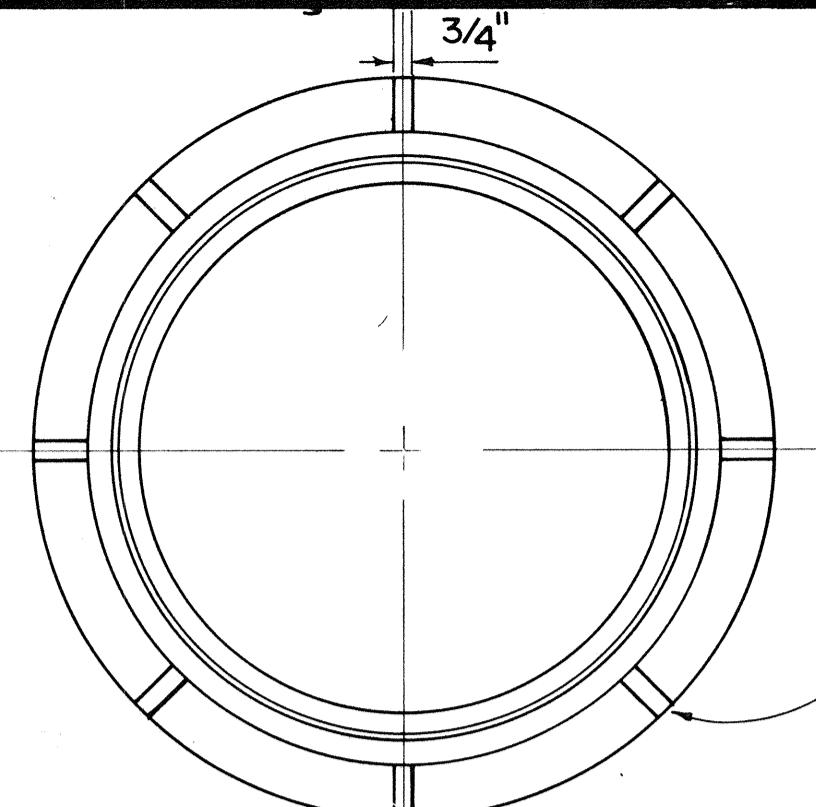


PLAN OF FRAME

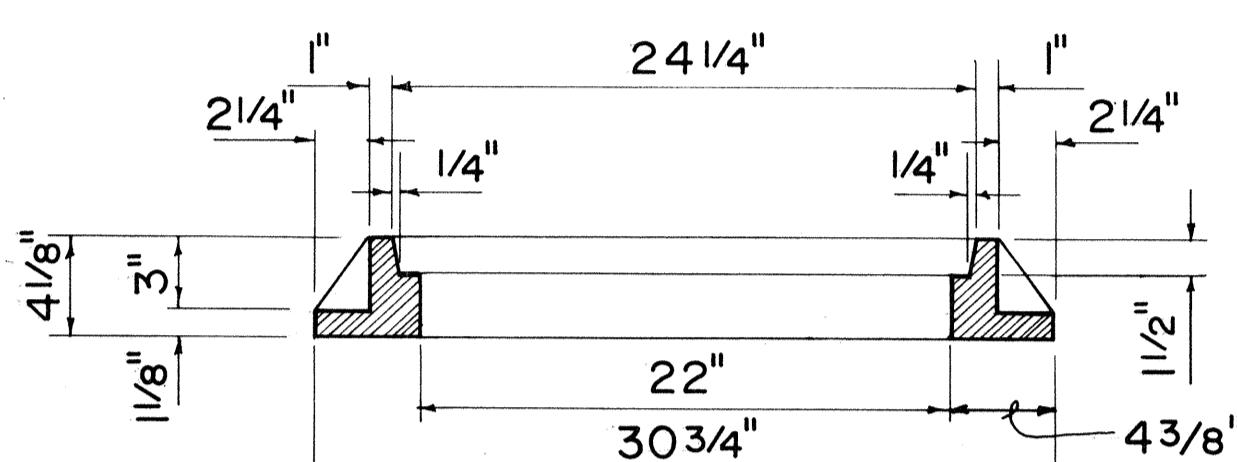


SECTION OF FRAME

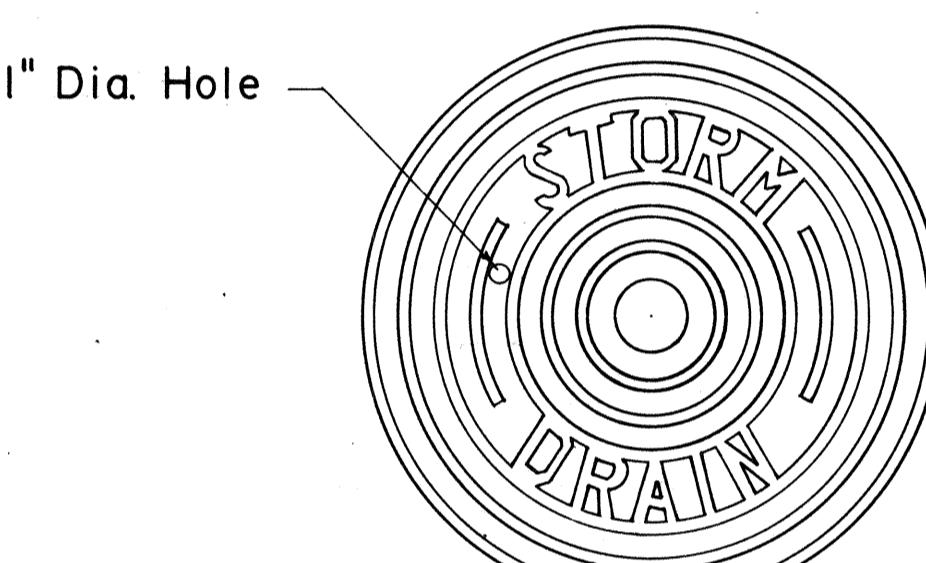

TOP VIEW OF COVER

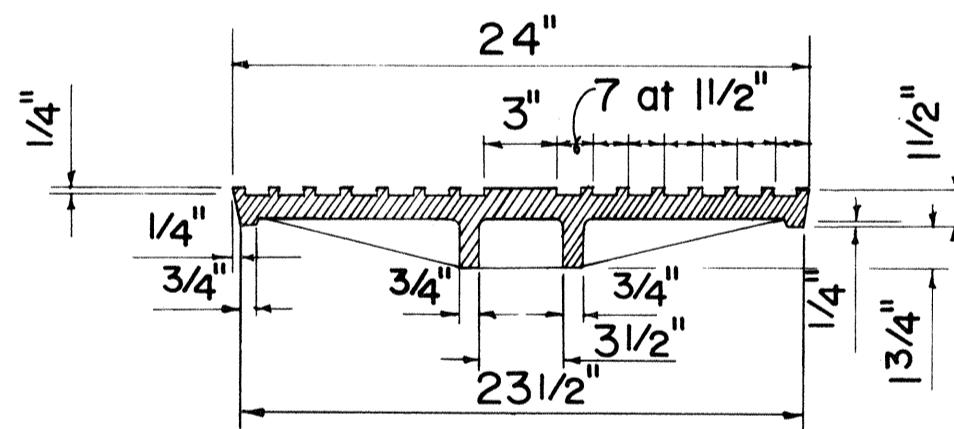


SECTION

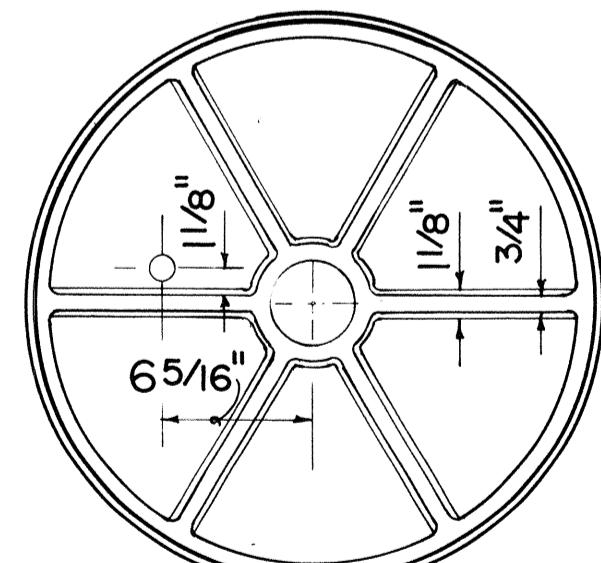


BOTTOM VIEW OF COVER


**TYPE "P" CAST IRON
FRAME AND COVER**

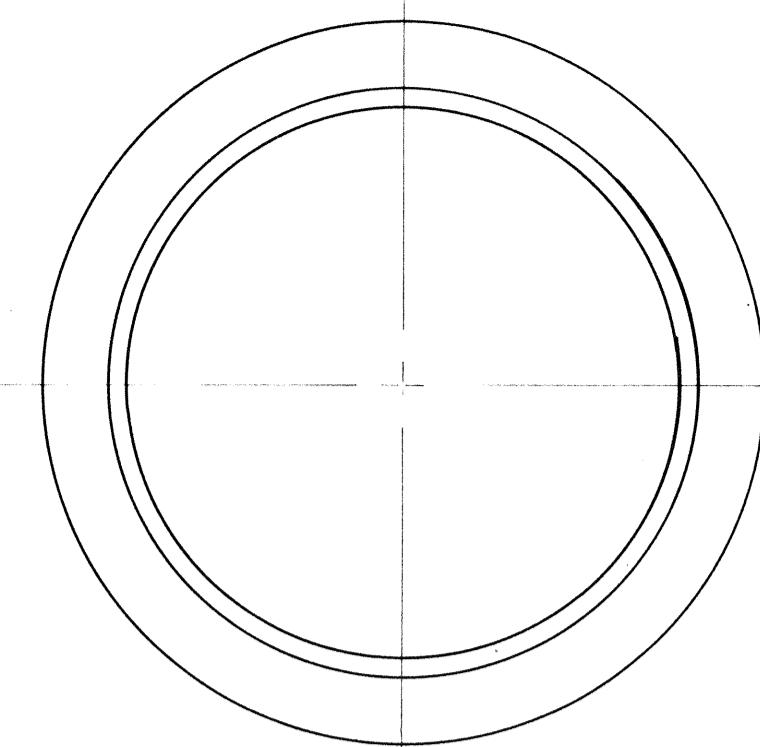


PLAN OF FRAME

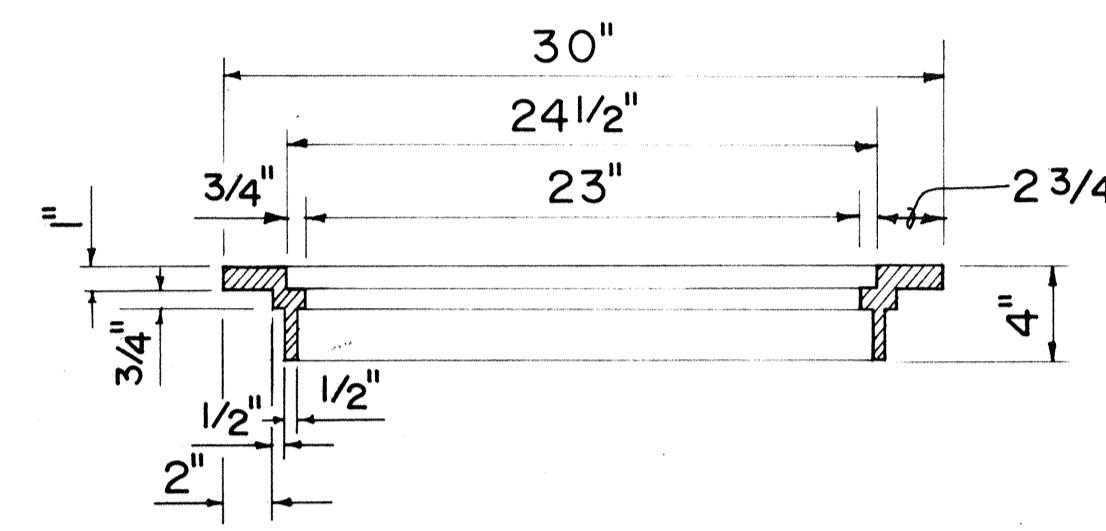


SECTION OF FRAME

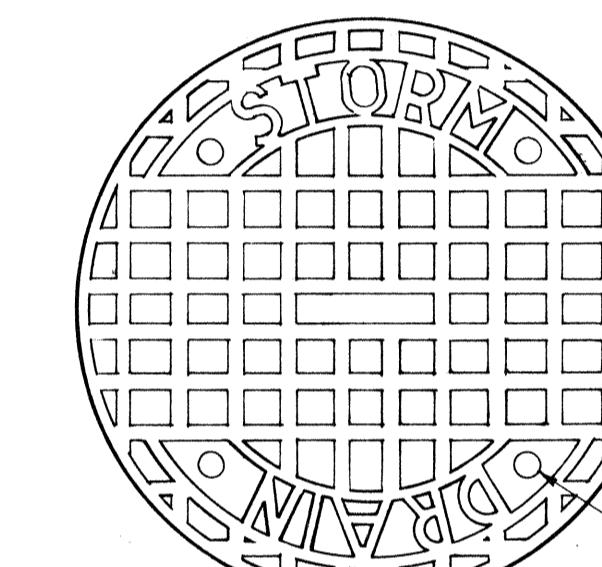

TOP VIEW OF COVER

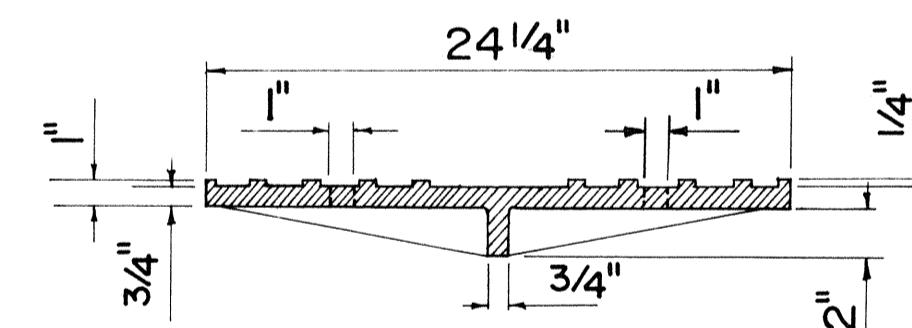


SECTION

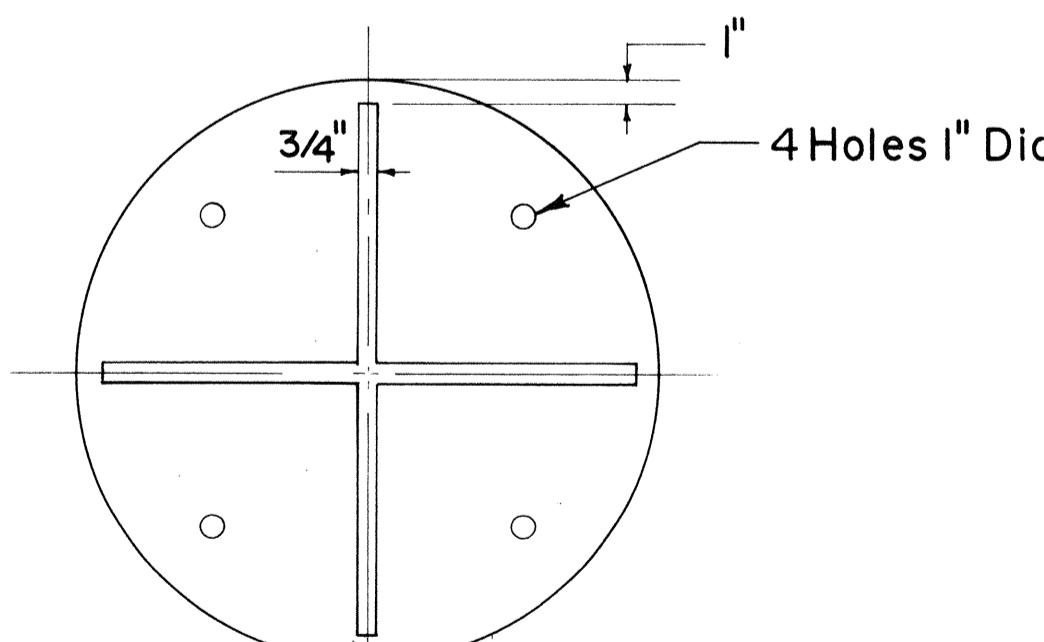


BOTTOM VIEW OF COVER


**TYPE "B" CAST IRON
FRAME AND COVER**

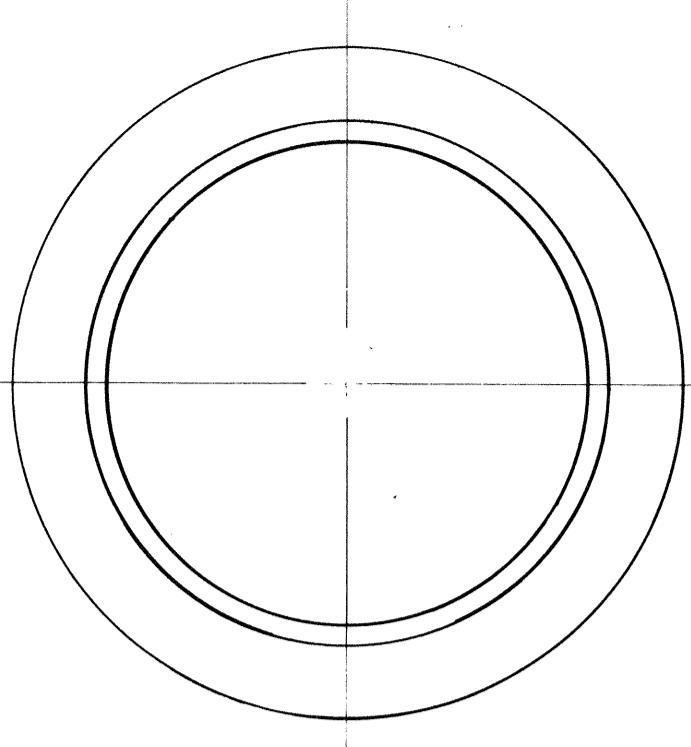


PLAN OF FRAME

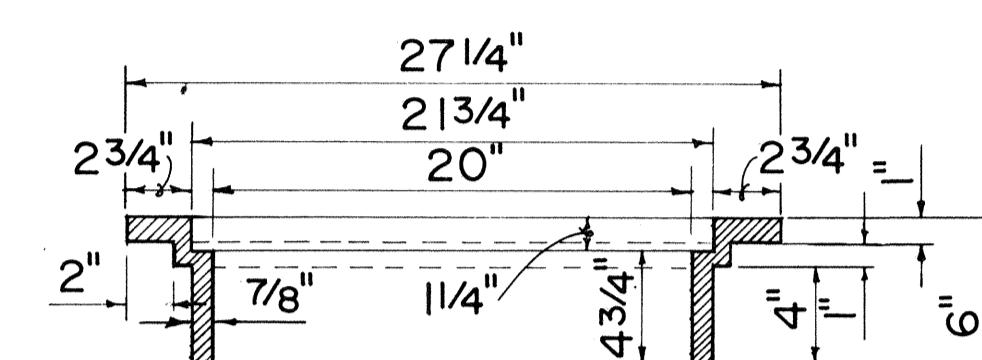


SECTION OF FRAME

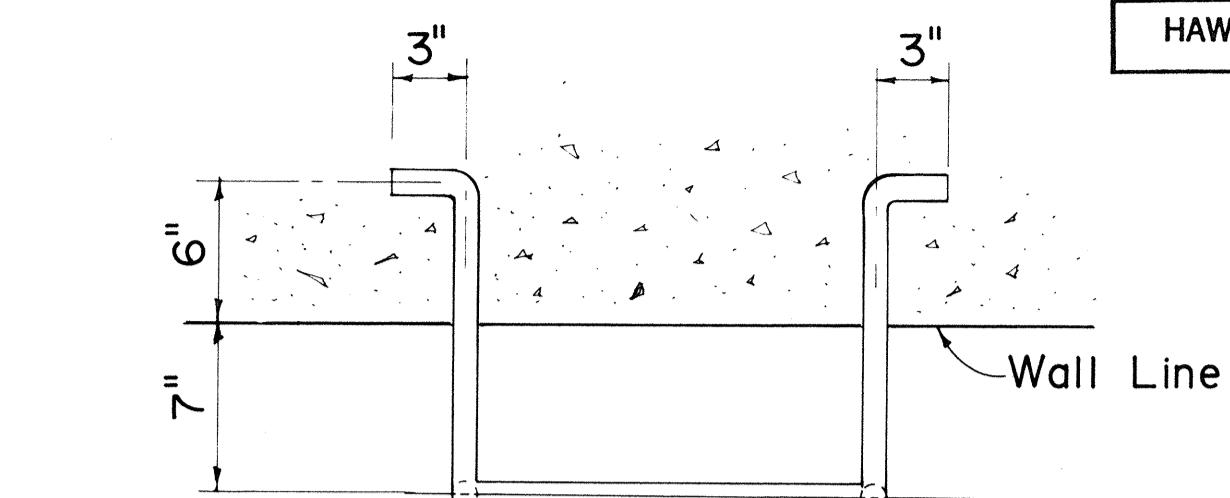


PLAN

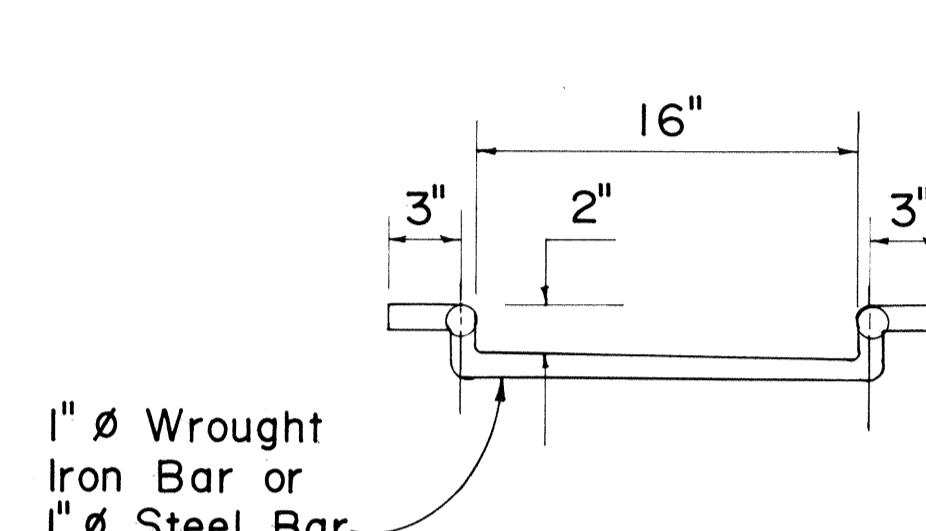


FRONT VIEW

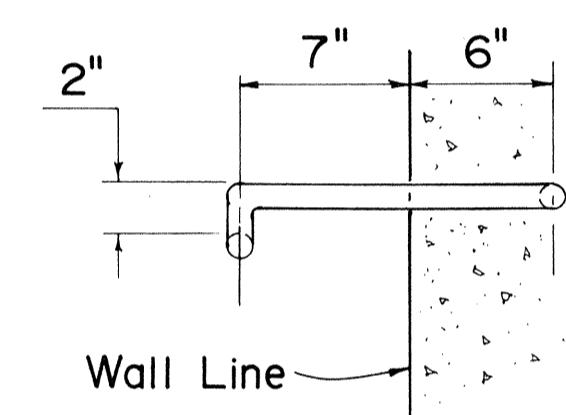

SIDE VIEW

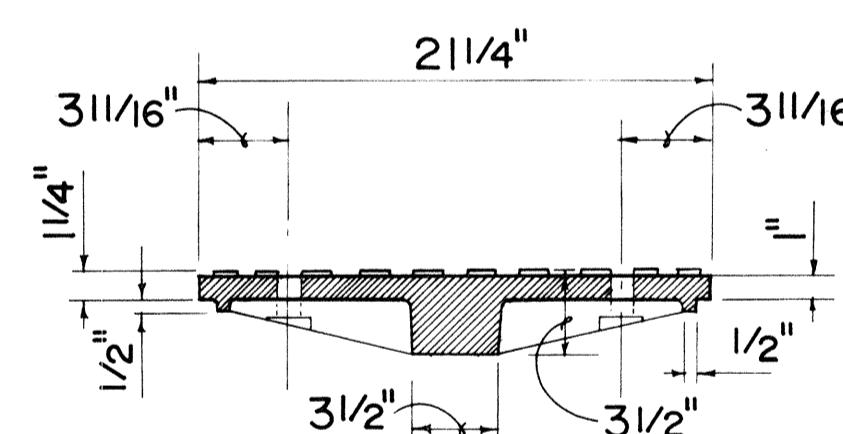

SECTION

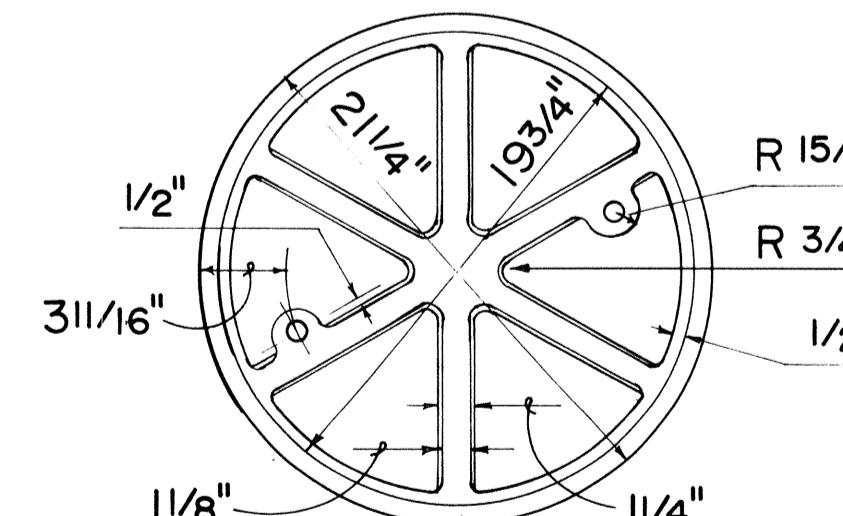

BOTTOM VIEW OF COVER

**TYPE "A" CAST IRON
FRAME AND COVER**

NO.	REVISION	APPROVED BY	DATE
I.	Supersedes Sht. DH 6 approved 12-17-69	H.P.	6/22/79

APPROVAL RECOMMENDED:

Oakano HYDRAULIC DESIGN ENGINEER 6-19-79 DATE

APPROVED:

Robert Takeishi ASSISTANT CHIEF, ENGINEERING 6-22-79 DATE

STATE OF HAWAII
DEPARTMENT OF TRANSPORTATION
HIGHWAYS DIVISION


STANDARD DETAILS

CATCH BASIN AND
MANHOLE CASTINGS


Not To Scale Date: Dec. 1977

SHEET NO. 31 OF 33 SHEETS DH 6


FED. ROAD DIST. NO.	STATE	FED. AID PROJ. NO.	FISCAL YEAR	SHEET NO.	TOTAL SHEETS
HAWAII	HAW.	I-HI-1 (178)	1982	64	105

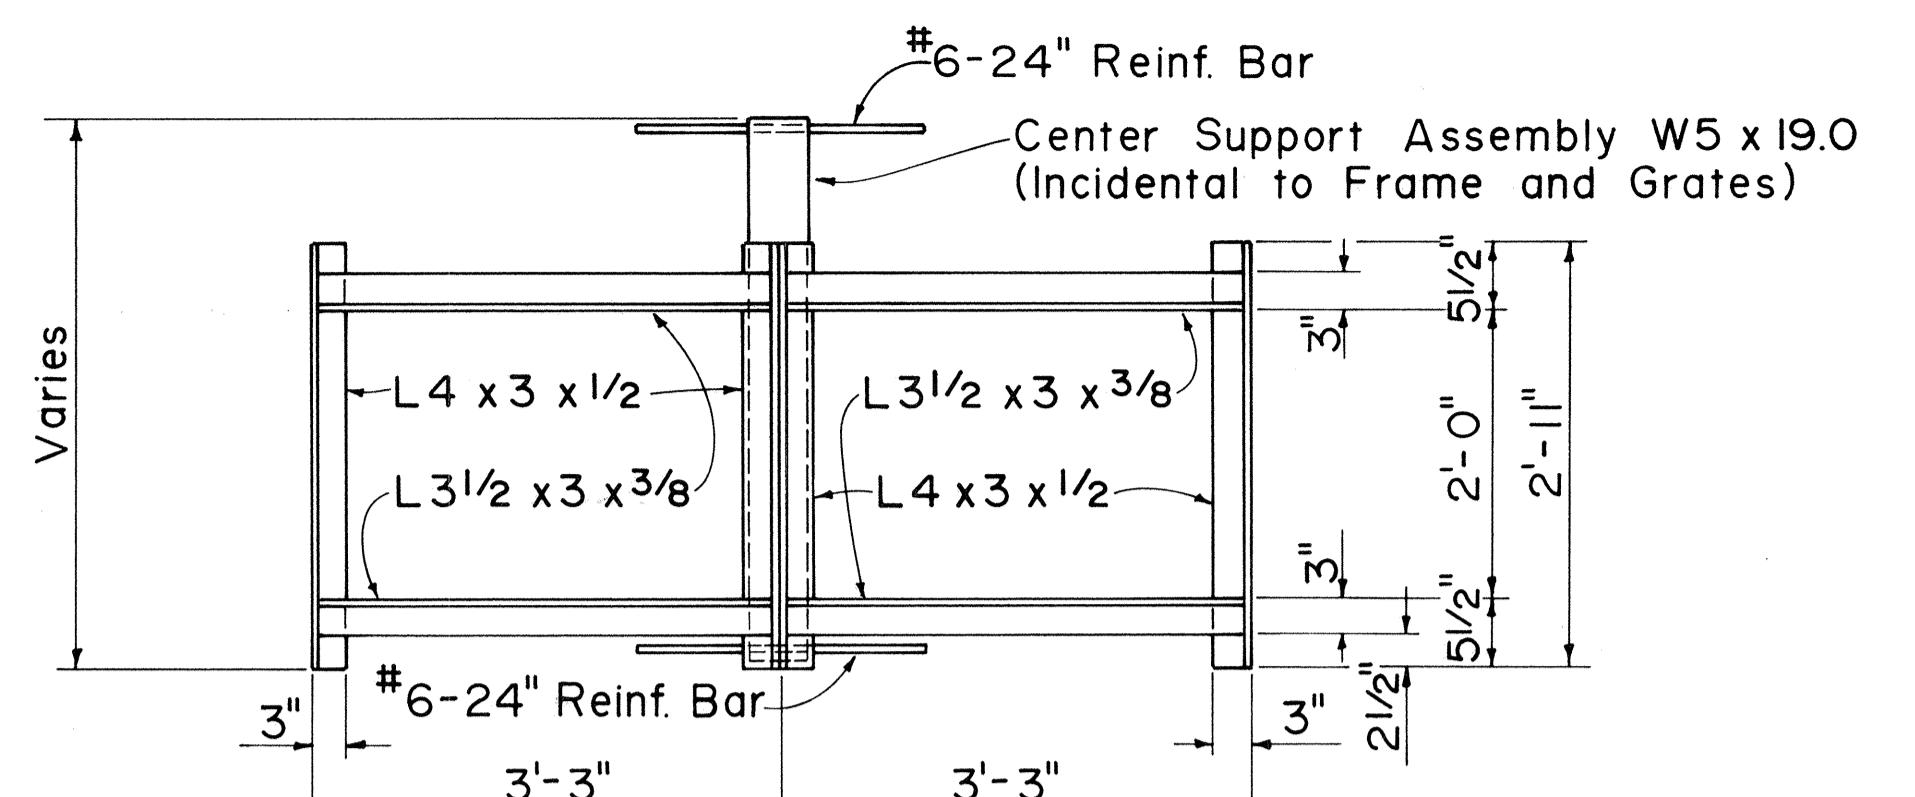


PLAN
(Two or More Grates)

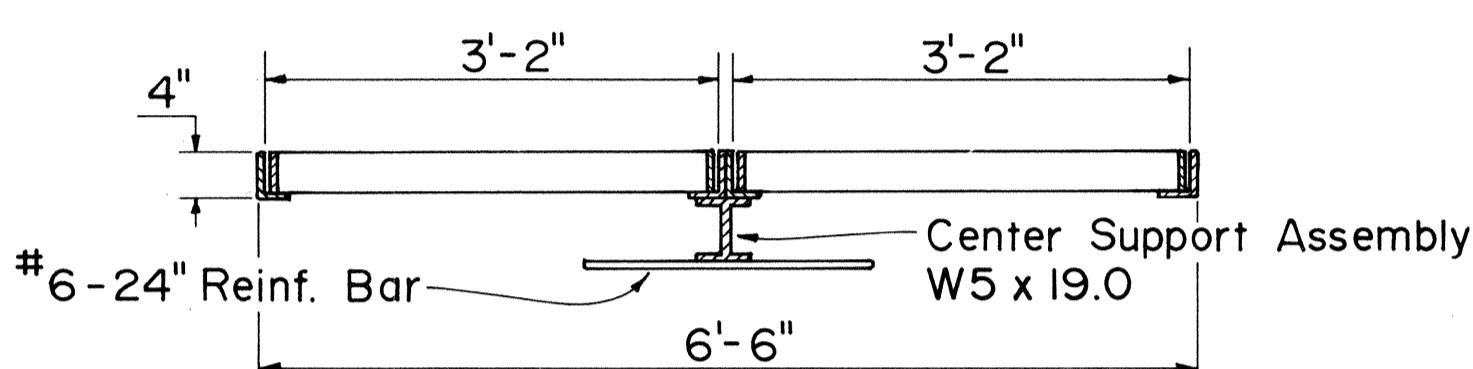

LONGITUDINAL SECTION
(Thru Frame & Grate)

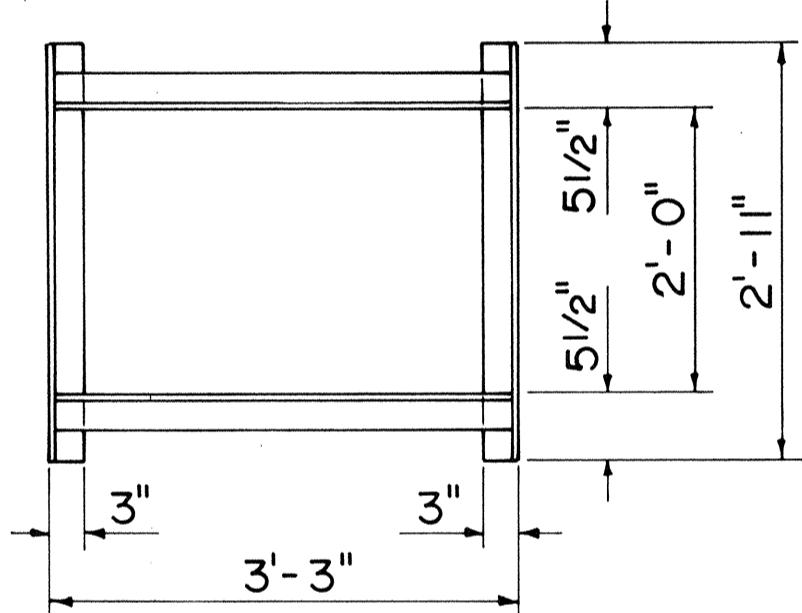


PLAN
(Single Grate)

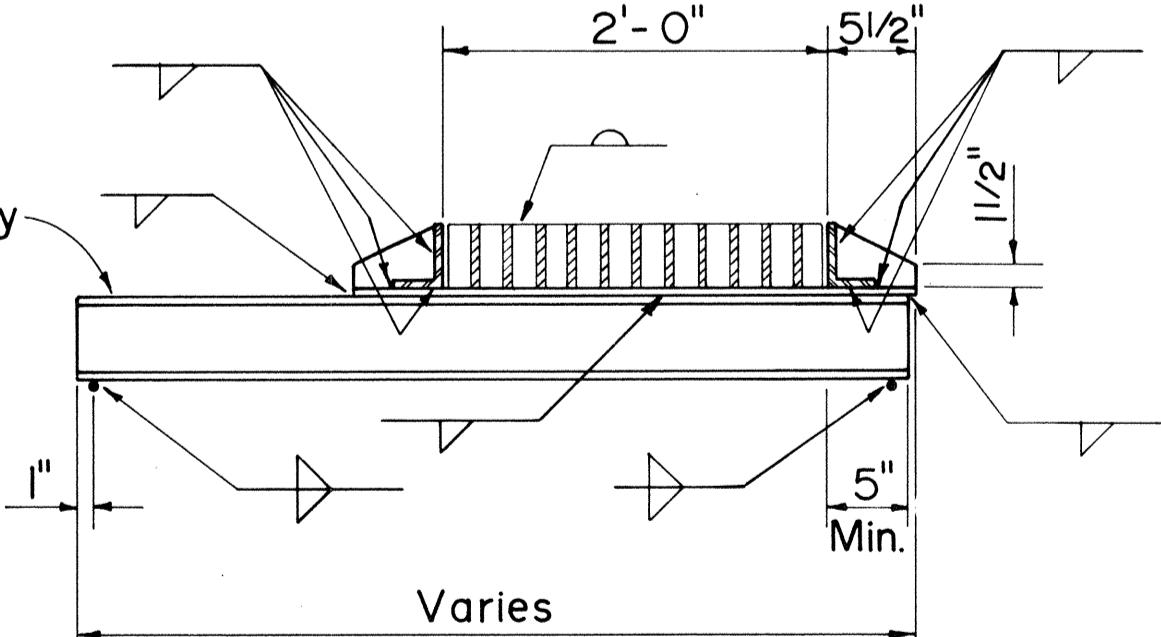


CROSS SECTION
(Thru Frame & Grate)

FRAME DETAILS

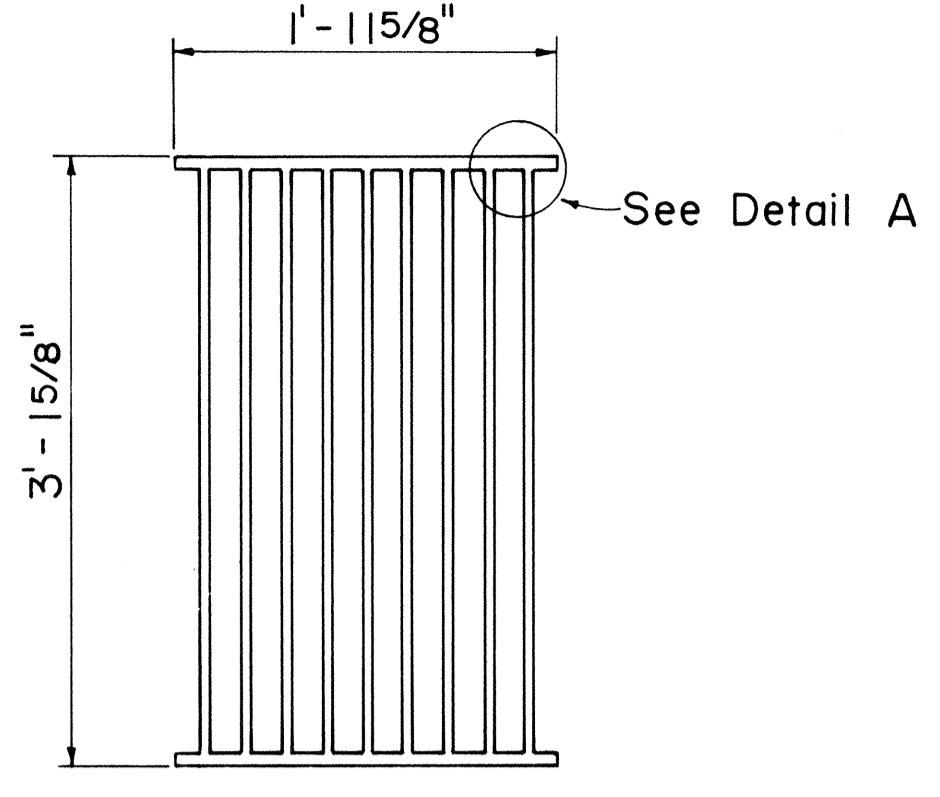


PLAN

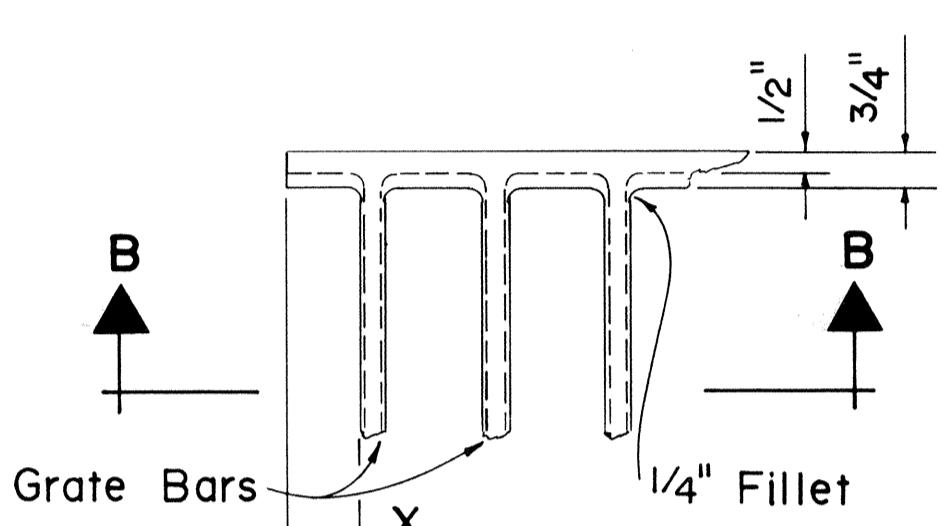


SECTION B-B


ALTERNATIVE CAST MALLEABLE IRON OR CAST STEEL GRATE

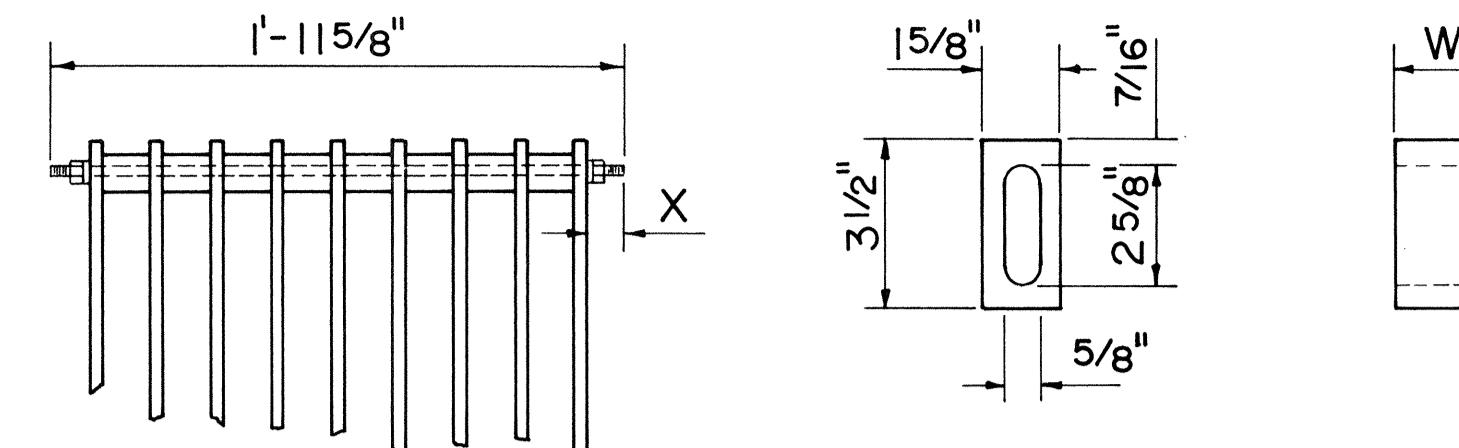


BOLTED END BLOCK

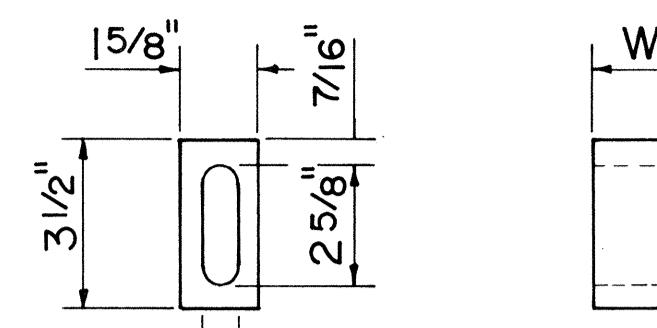

BAR SPACER

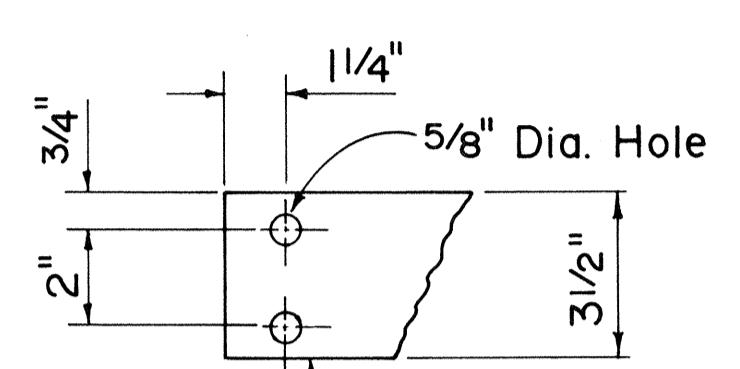


END OF BAR

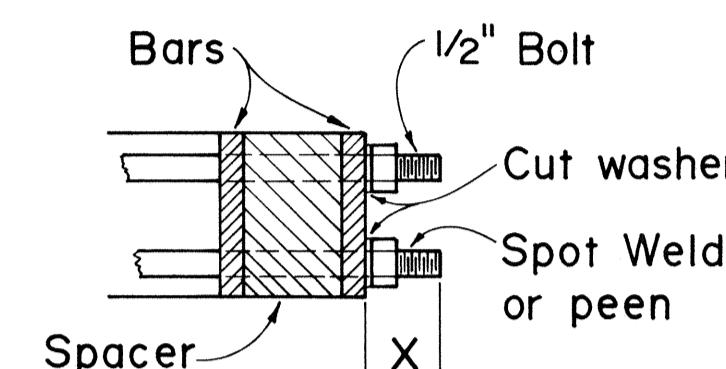


BOLTING DETAIL

ALTERNATIVE BOLTED GRATE

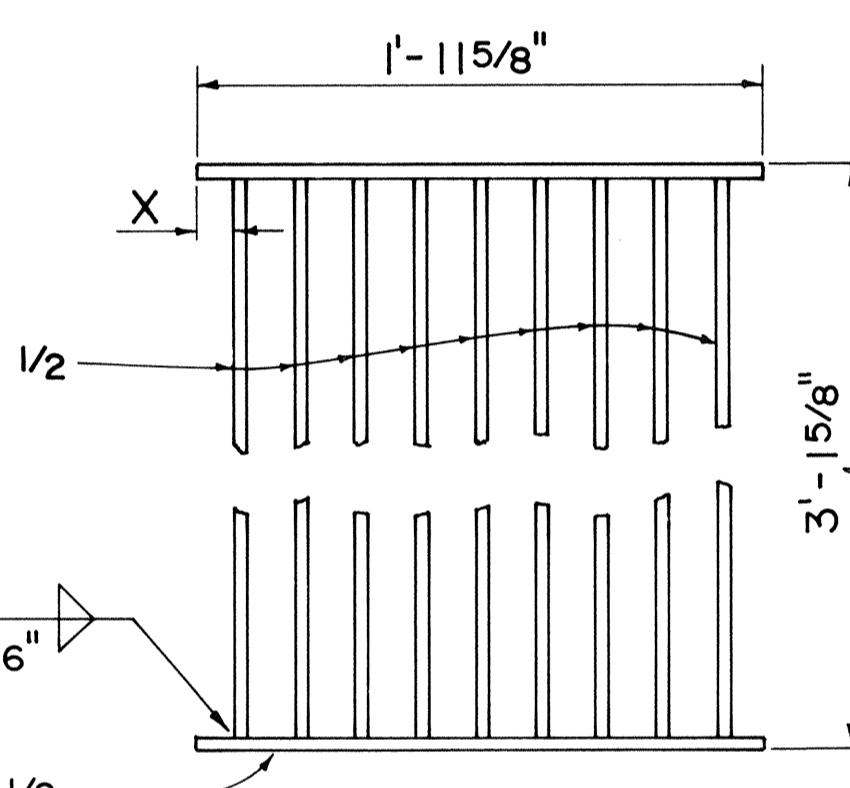

PLAN

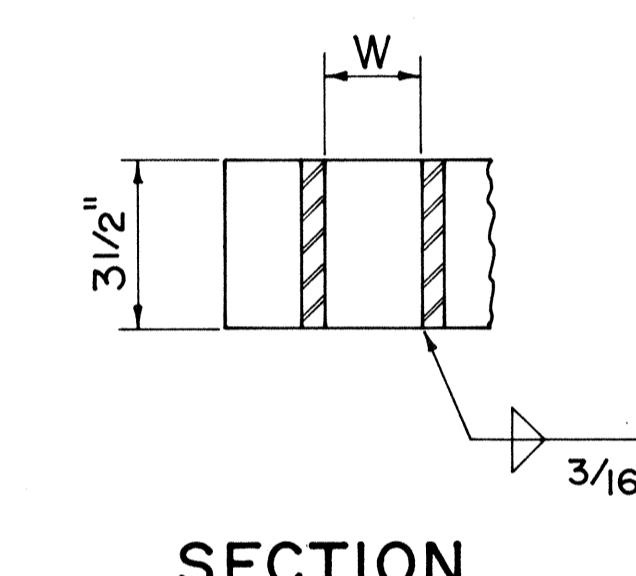

SECTION

ALTERNATIVE WELDED GRATE

GRATE BAR SPACING TABLE			
TYPE	NO. BARS	CLEAR BAR SPACING-W	X
A-9	9	2"	1 9/16"
A-12	12	1 3/8"	1 1/4"

NO.	REVISION	APPROVED BY	DATE
1.	Supersedes Sht. DH 7 approved 12-17-69	H.I.	6/22/79
2.	Revise standard nomenclature for rolled steel shapes.	H.I.	4/21/82

STATE OF HAWAII DEPARTMENT OF TRANSPORTATION HIGHWAYS DIVISION			
STANDARD DETAILS			
TYPE A-9 AND A-12 FRAMES AND GRATES			
Not To Scale Date: Dec. 1977			

SHEET NO. 32 OF 33 SHEETS DH 7

64

APPROVAL RECOMMENDED:
J. Takano
HYDRAULIC DESIGN ENGINEER
6-19-79
DATE

APPROVED:
Heribert Zalewski
ASSISTANT CHIEF, ENGINEERING
6-22-79
DATE

ORIGINAL	SURVEY PLOTTED BY
PLAN	DESIGN DRAWN BY
NOTE BOOK	TESTED BY
QUANTITIES BY	CHIEF IN CHARGE
NO. _____	CHECKED BY

