


TOTAL SHEETS FED. ROAD DIST. NO. FISCAL SHEET YEAR NO. STATE PROJ. NO. H1E-01-11M 2012 HAW.

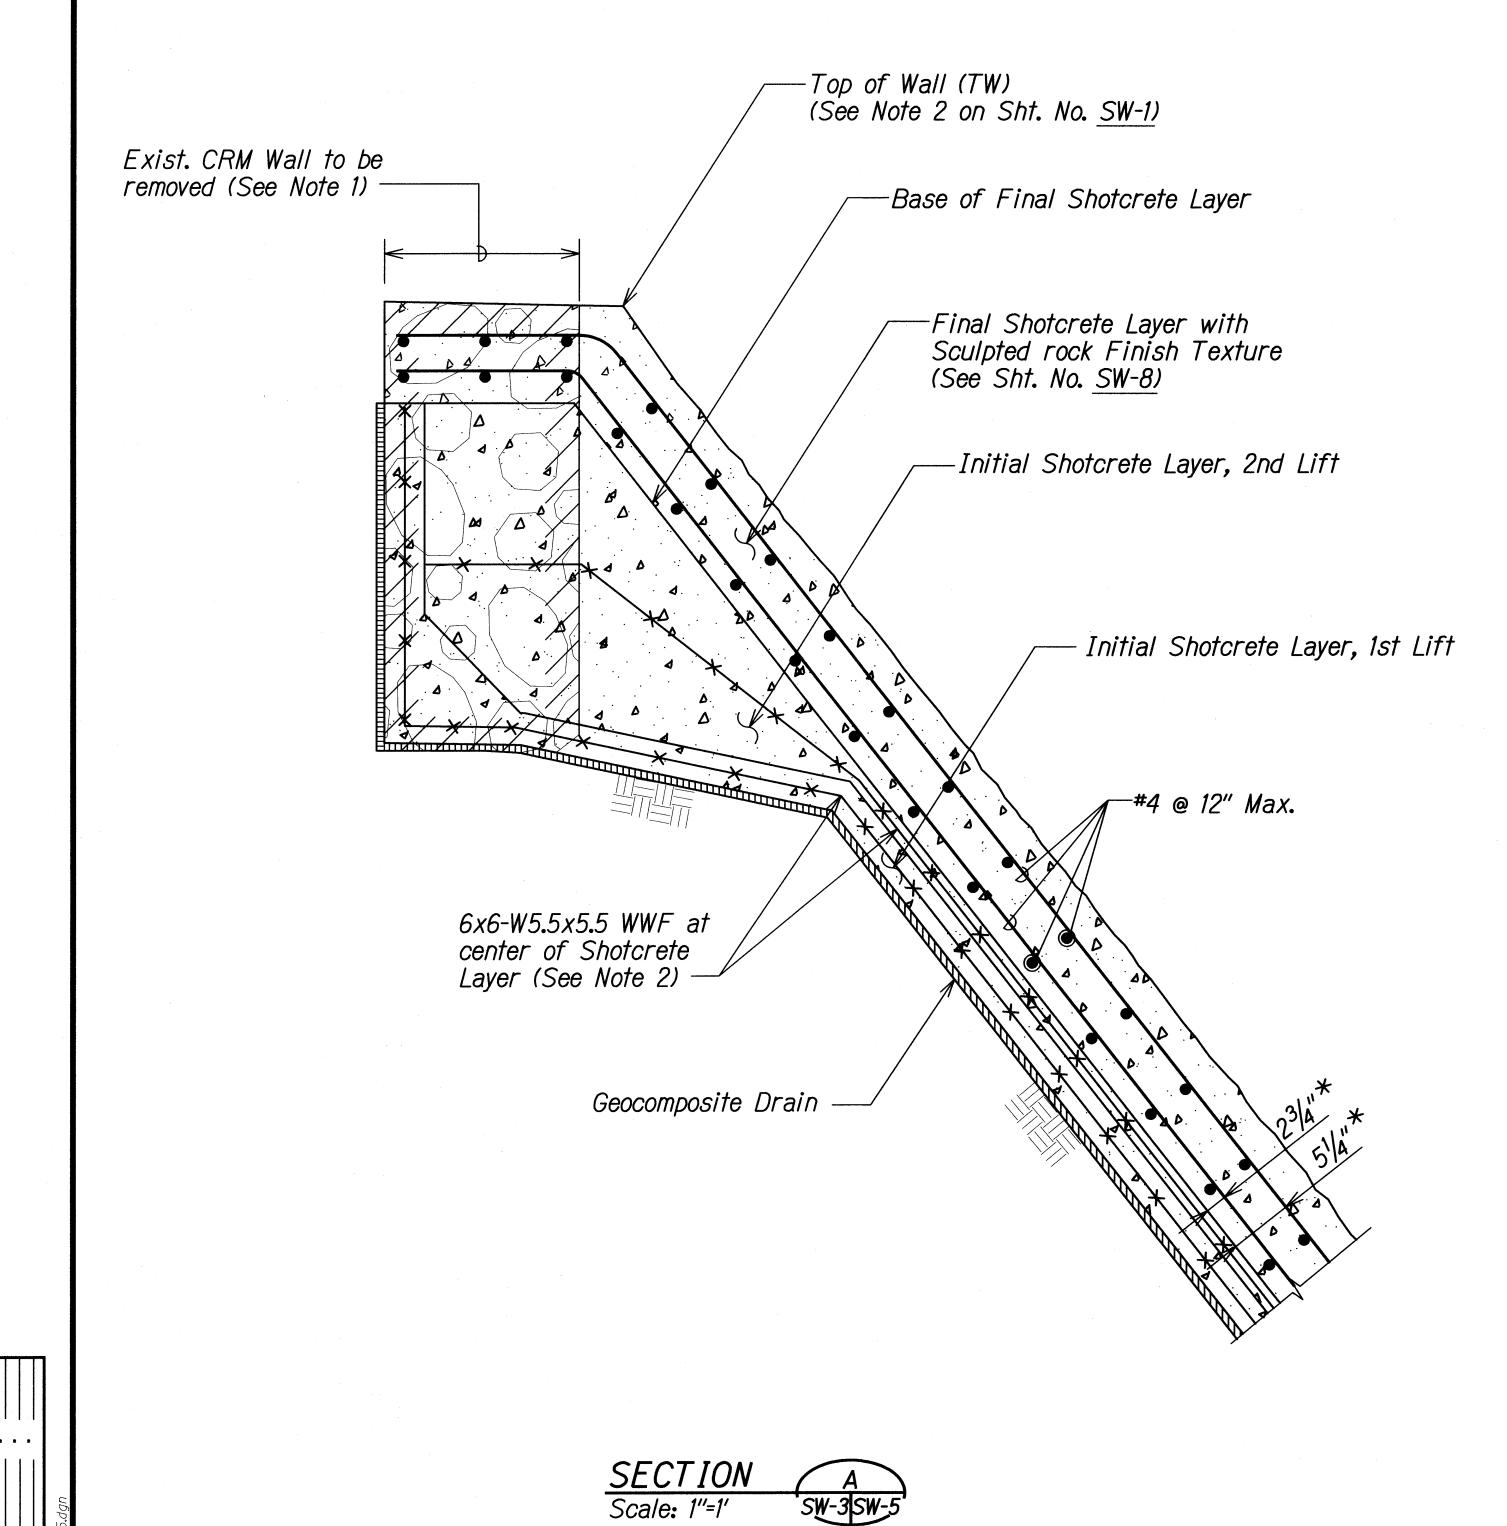


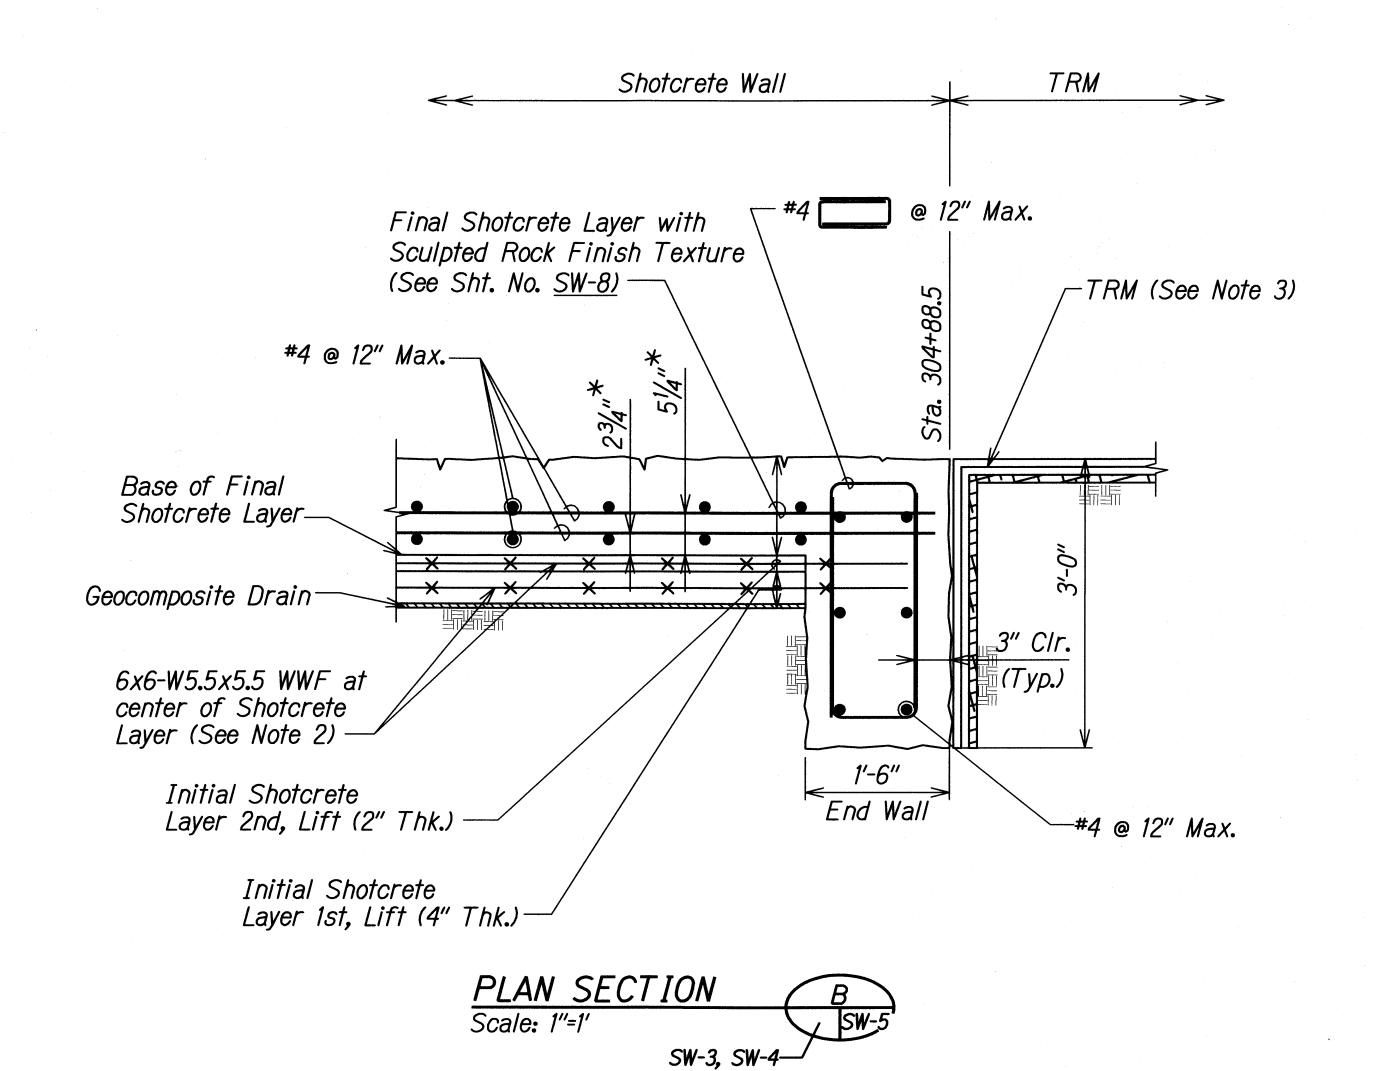

NOTES:

- 1. Contractor shall exercise care during removal of exist CRM Wall to protect existing building columns from damage.
- 2. For WWF Splicing Detail, See Sht. No. <u>SW-7</u>.
- 3. For Details of TRM installations shall be per manufacturer's recommendations.
- *4. Dimension shown is the distance from Base of Final Shotcrete to centerline of rebar.

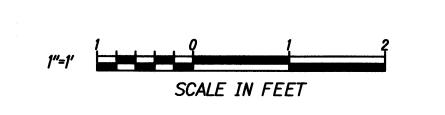

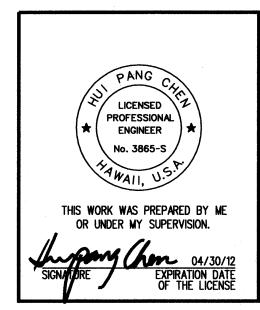


DEPARTMENT OF TRANSPORTATION HIGHWAYS DIVISION

SHOTCRETE WALL


<u>DETAILS</u> INTERSTATE ROUTE H-1
AIEA STREAM EROSION CONTROL

Project No. H1E-01-11M Date: September 2011 Scale: As Shown

SHEET No. SW-5 OF 8 SHEETS

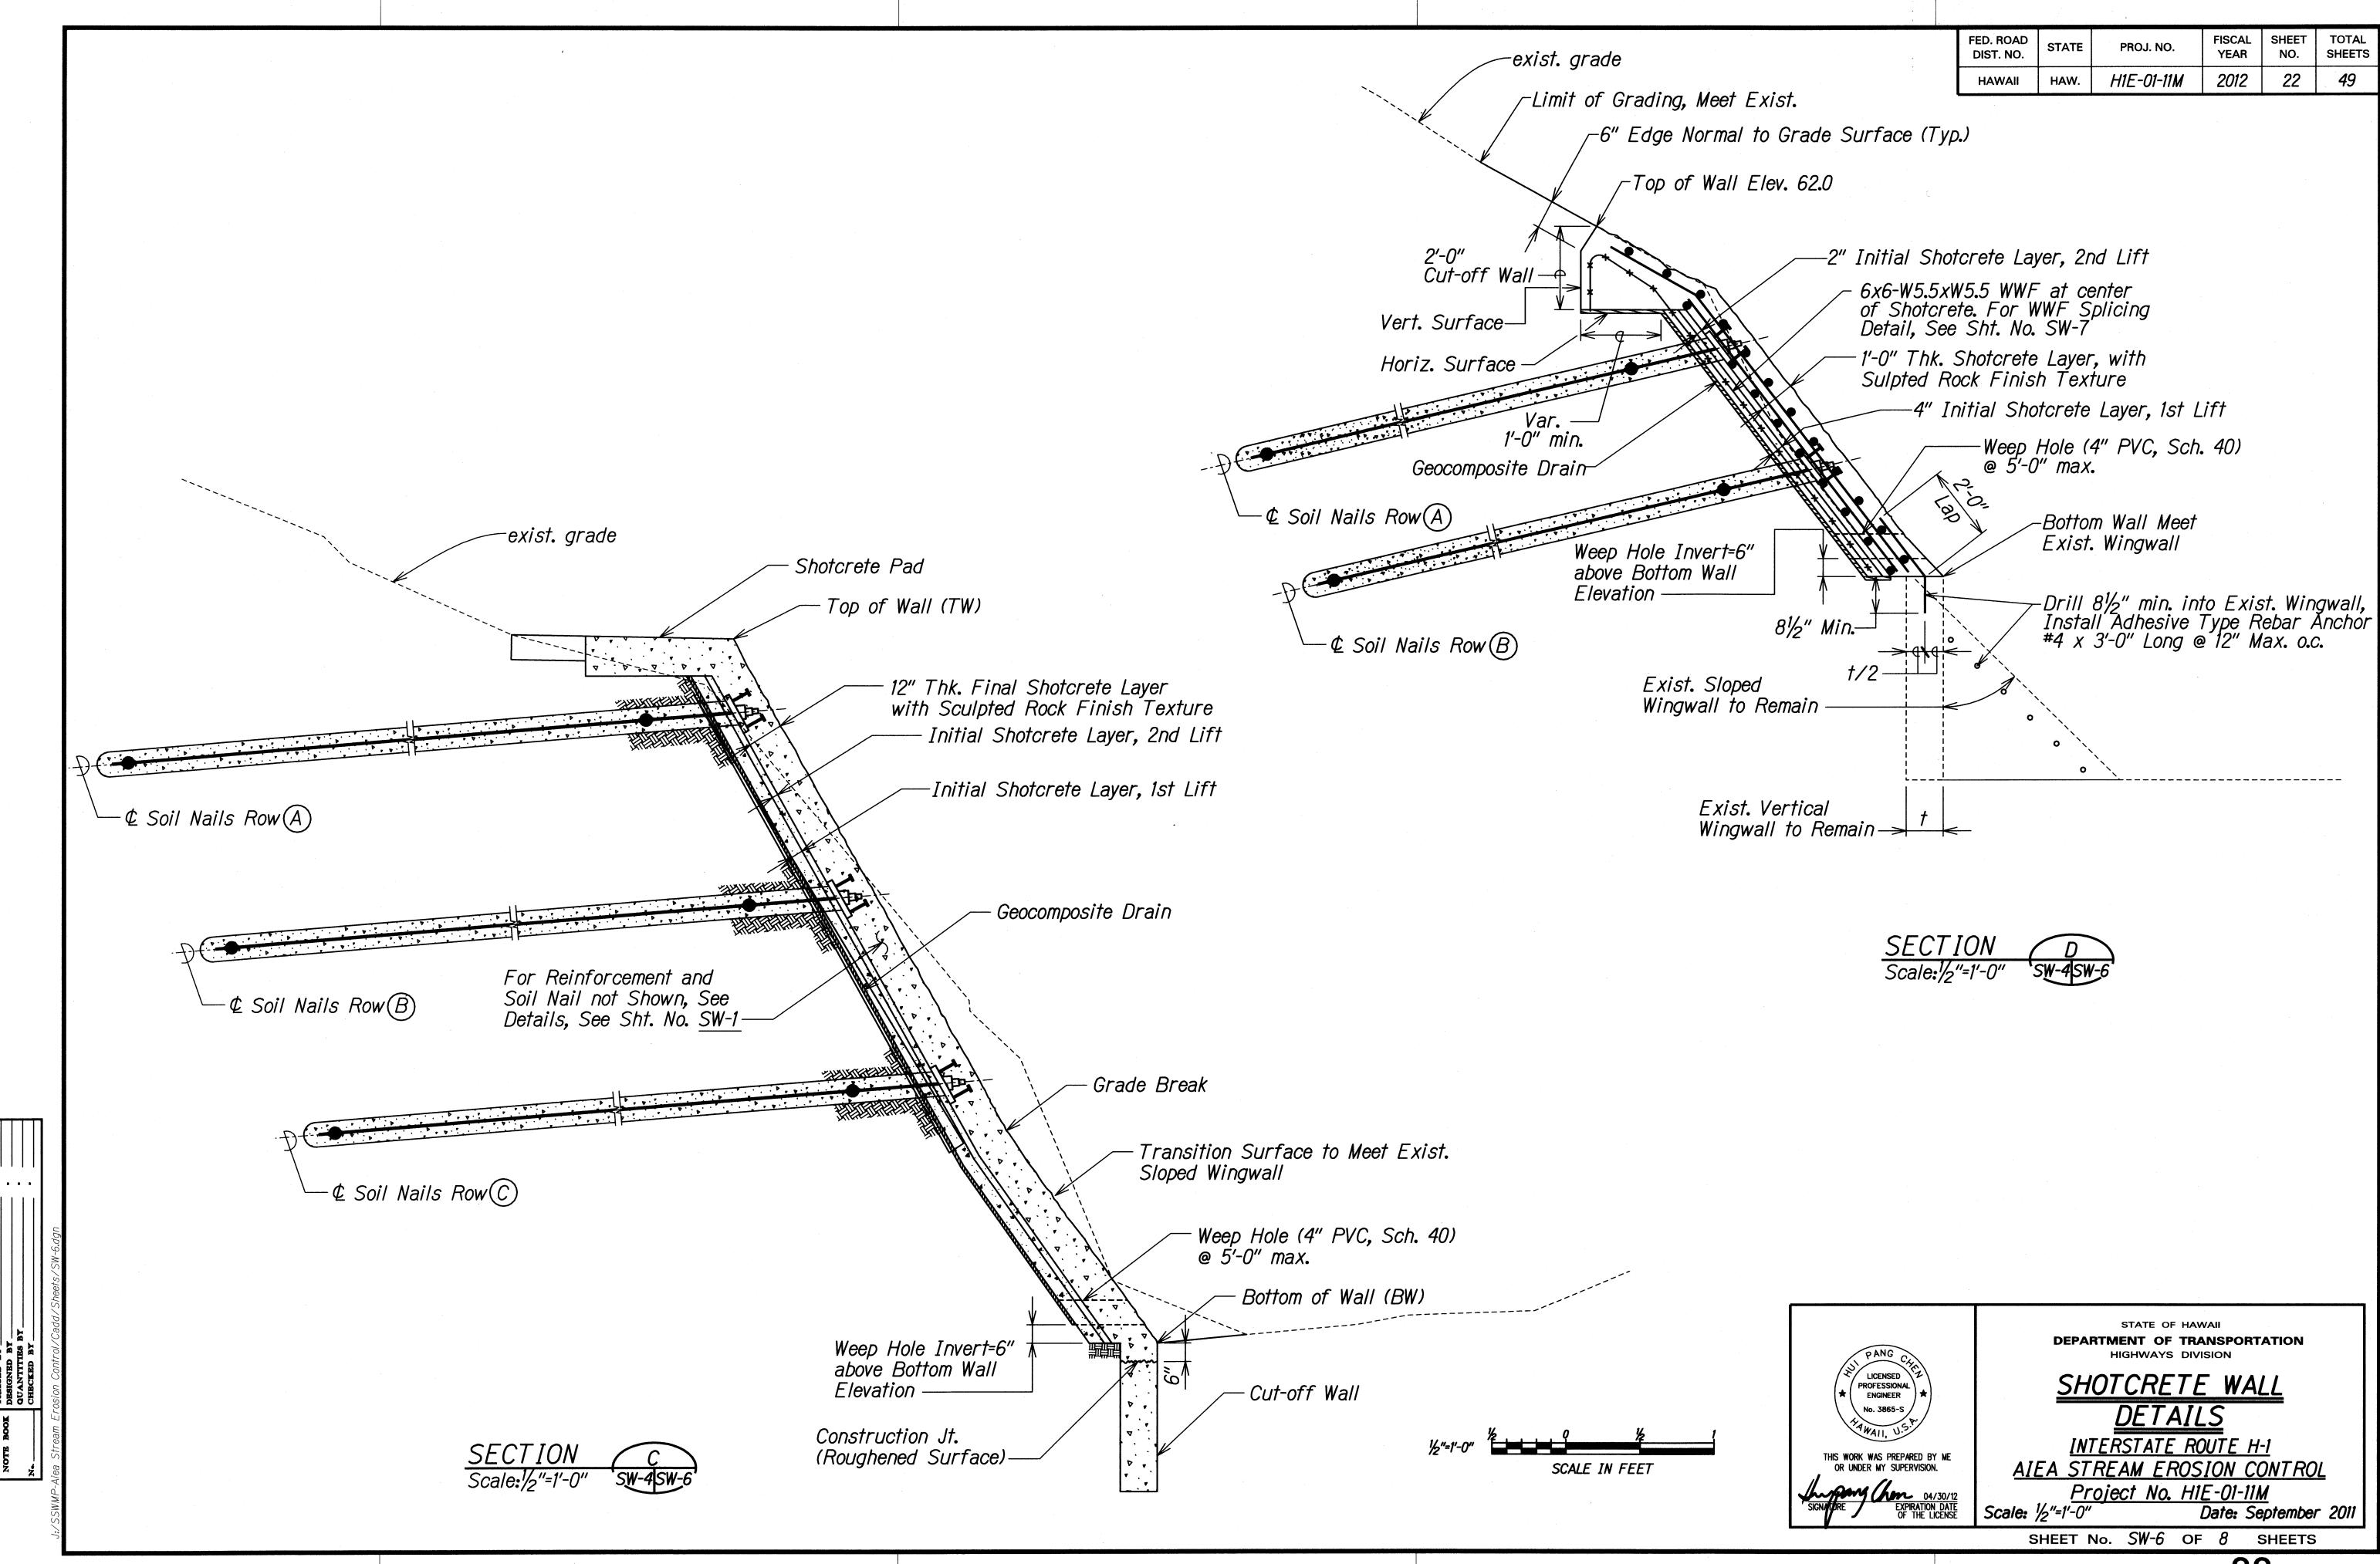


FISCAL SHEET YEAR NO. TOTAL FED. ROAD DIST. NO. PROJ. NO. SHEETS H1E-01-11M 2012 23 49

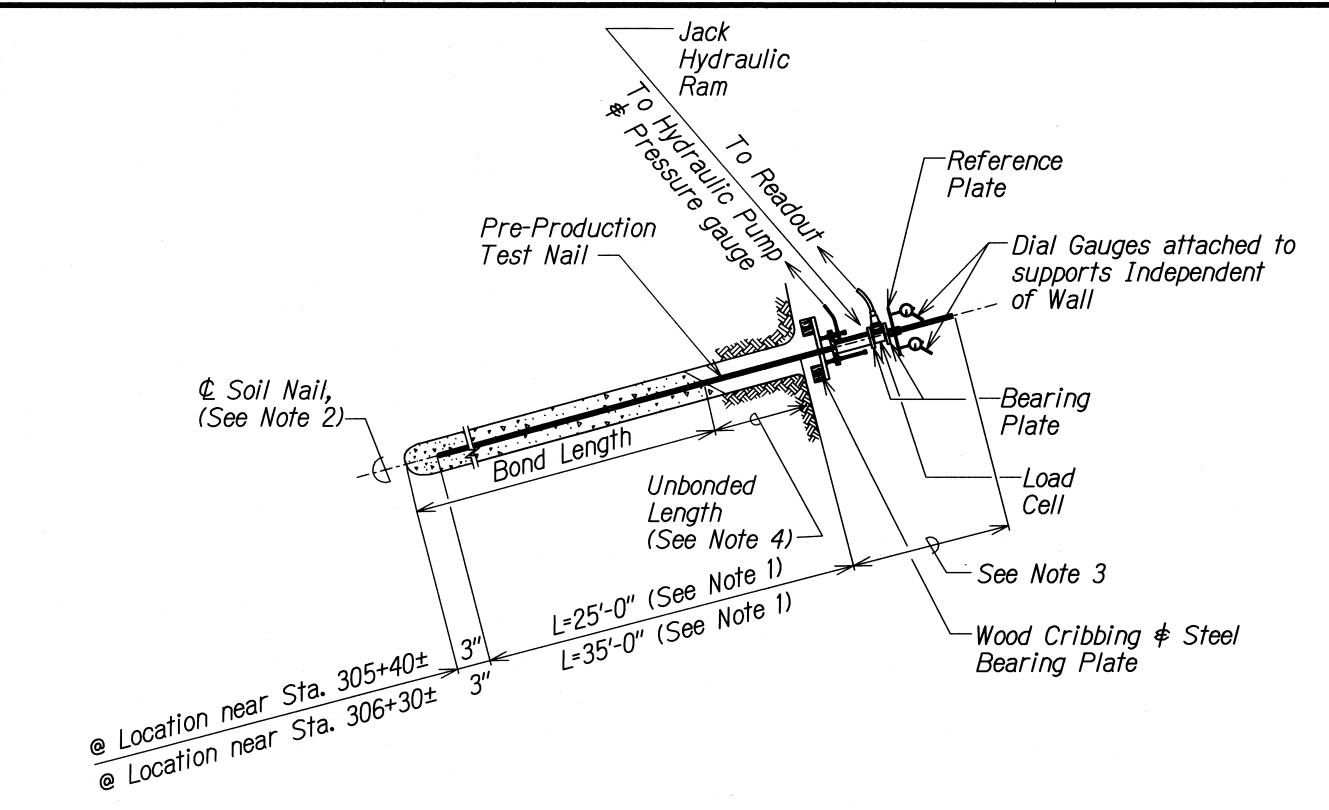

PRE-PRODUCTION LOAD TEST SOIL NAIL DETAIL Scale: NTS

LEGEND:


L = Soil Nail Bar Embedment Length

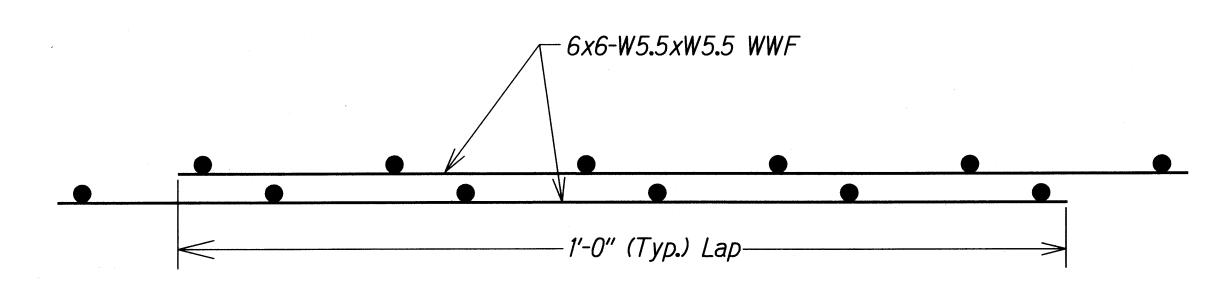


LAP SPLICE DETAIL

NOTES:

- 1. No separate measurement will be made for Pre-Production Load Test. Soil Nail shall be considered incidental Soil Nail Installations.
- 2. The Pre-Production Load Test Soil Nails shall be #14 threaded bar conforming to ASTM A 615 Grade 75. These soil nails shall contain centralizers.
- 3. After completion of Load Test, the Contractor may remove the protruding portion of the Pre-Production Load Test Soil Nail for Geocomposite Drain installations.
- 4. For the Verification and Proof Load Test Nails an Unbonded length of 3 feet shall be provided.

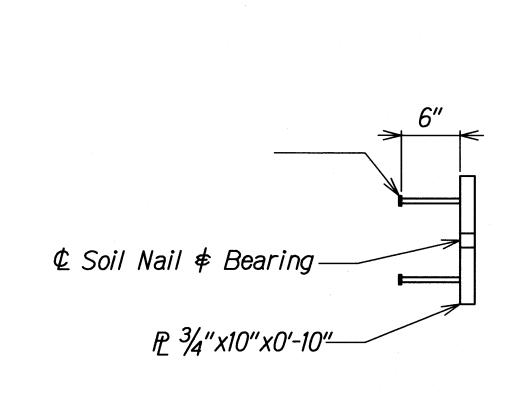

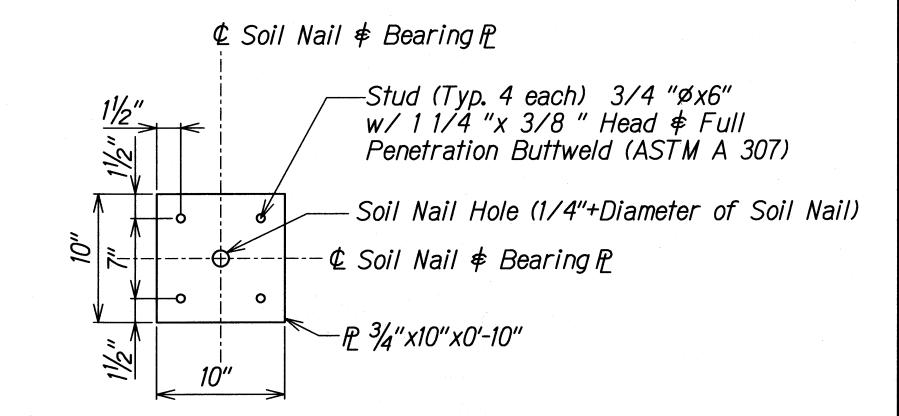


SECTION


PLAN

BEARING PLATE DETAIL

Scale: 1/2"=1'-0"

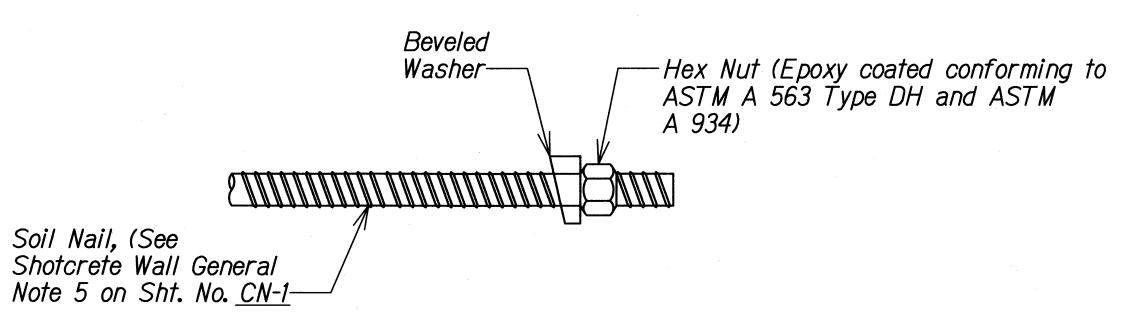

SOIL NAIL THREAD BAR Scale: NTS

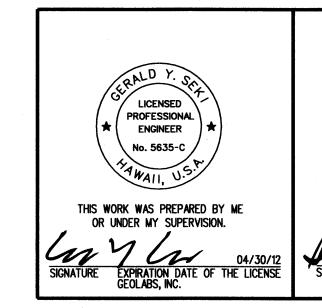

DEPARTMENT OF TRANSPORTATION LICENSED PROFESSIONAL ENGINEER

THIS WORK WAS PREPARED BY ME OR UNDER MY SUPERVISION.

SHOTCRETE WALL <u>DETAILS</u>

HIGHWAYS DIVISION

INTERSTATE ROUTE H-1 AIEA STREAM EROSION CONTROL Project No. HIE-01-11M Scale: As Noted Date: September 2011

SHEET No. SW-7 OF 8 SHEETS



SCALE IN FEET