


ATTACHMENT F
EROSION CONTROL PLAN

FED. ROAD DIST. NO.	STATE	PROJ. NO.	FISCAL YEAR	SHEET NO.	TOTAL SHEETS
HAWAII	HAW.	H1E-01-11MR	2013	41	49

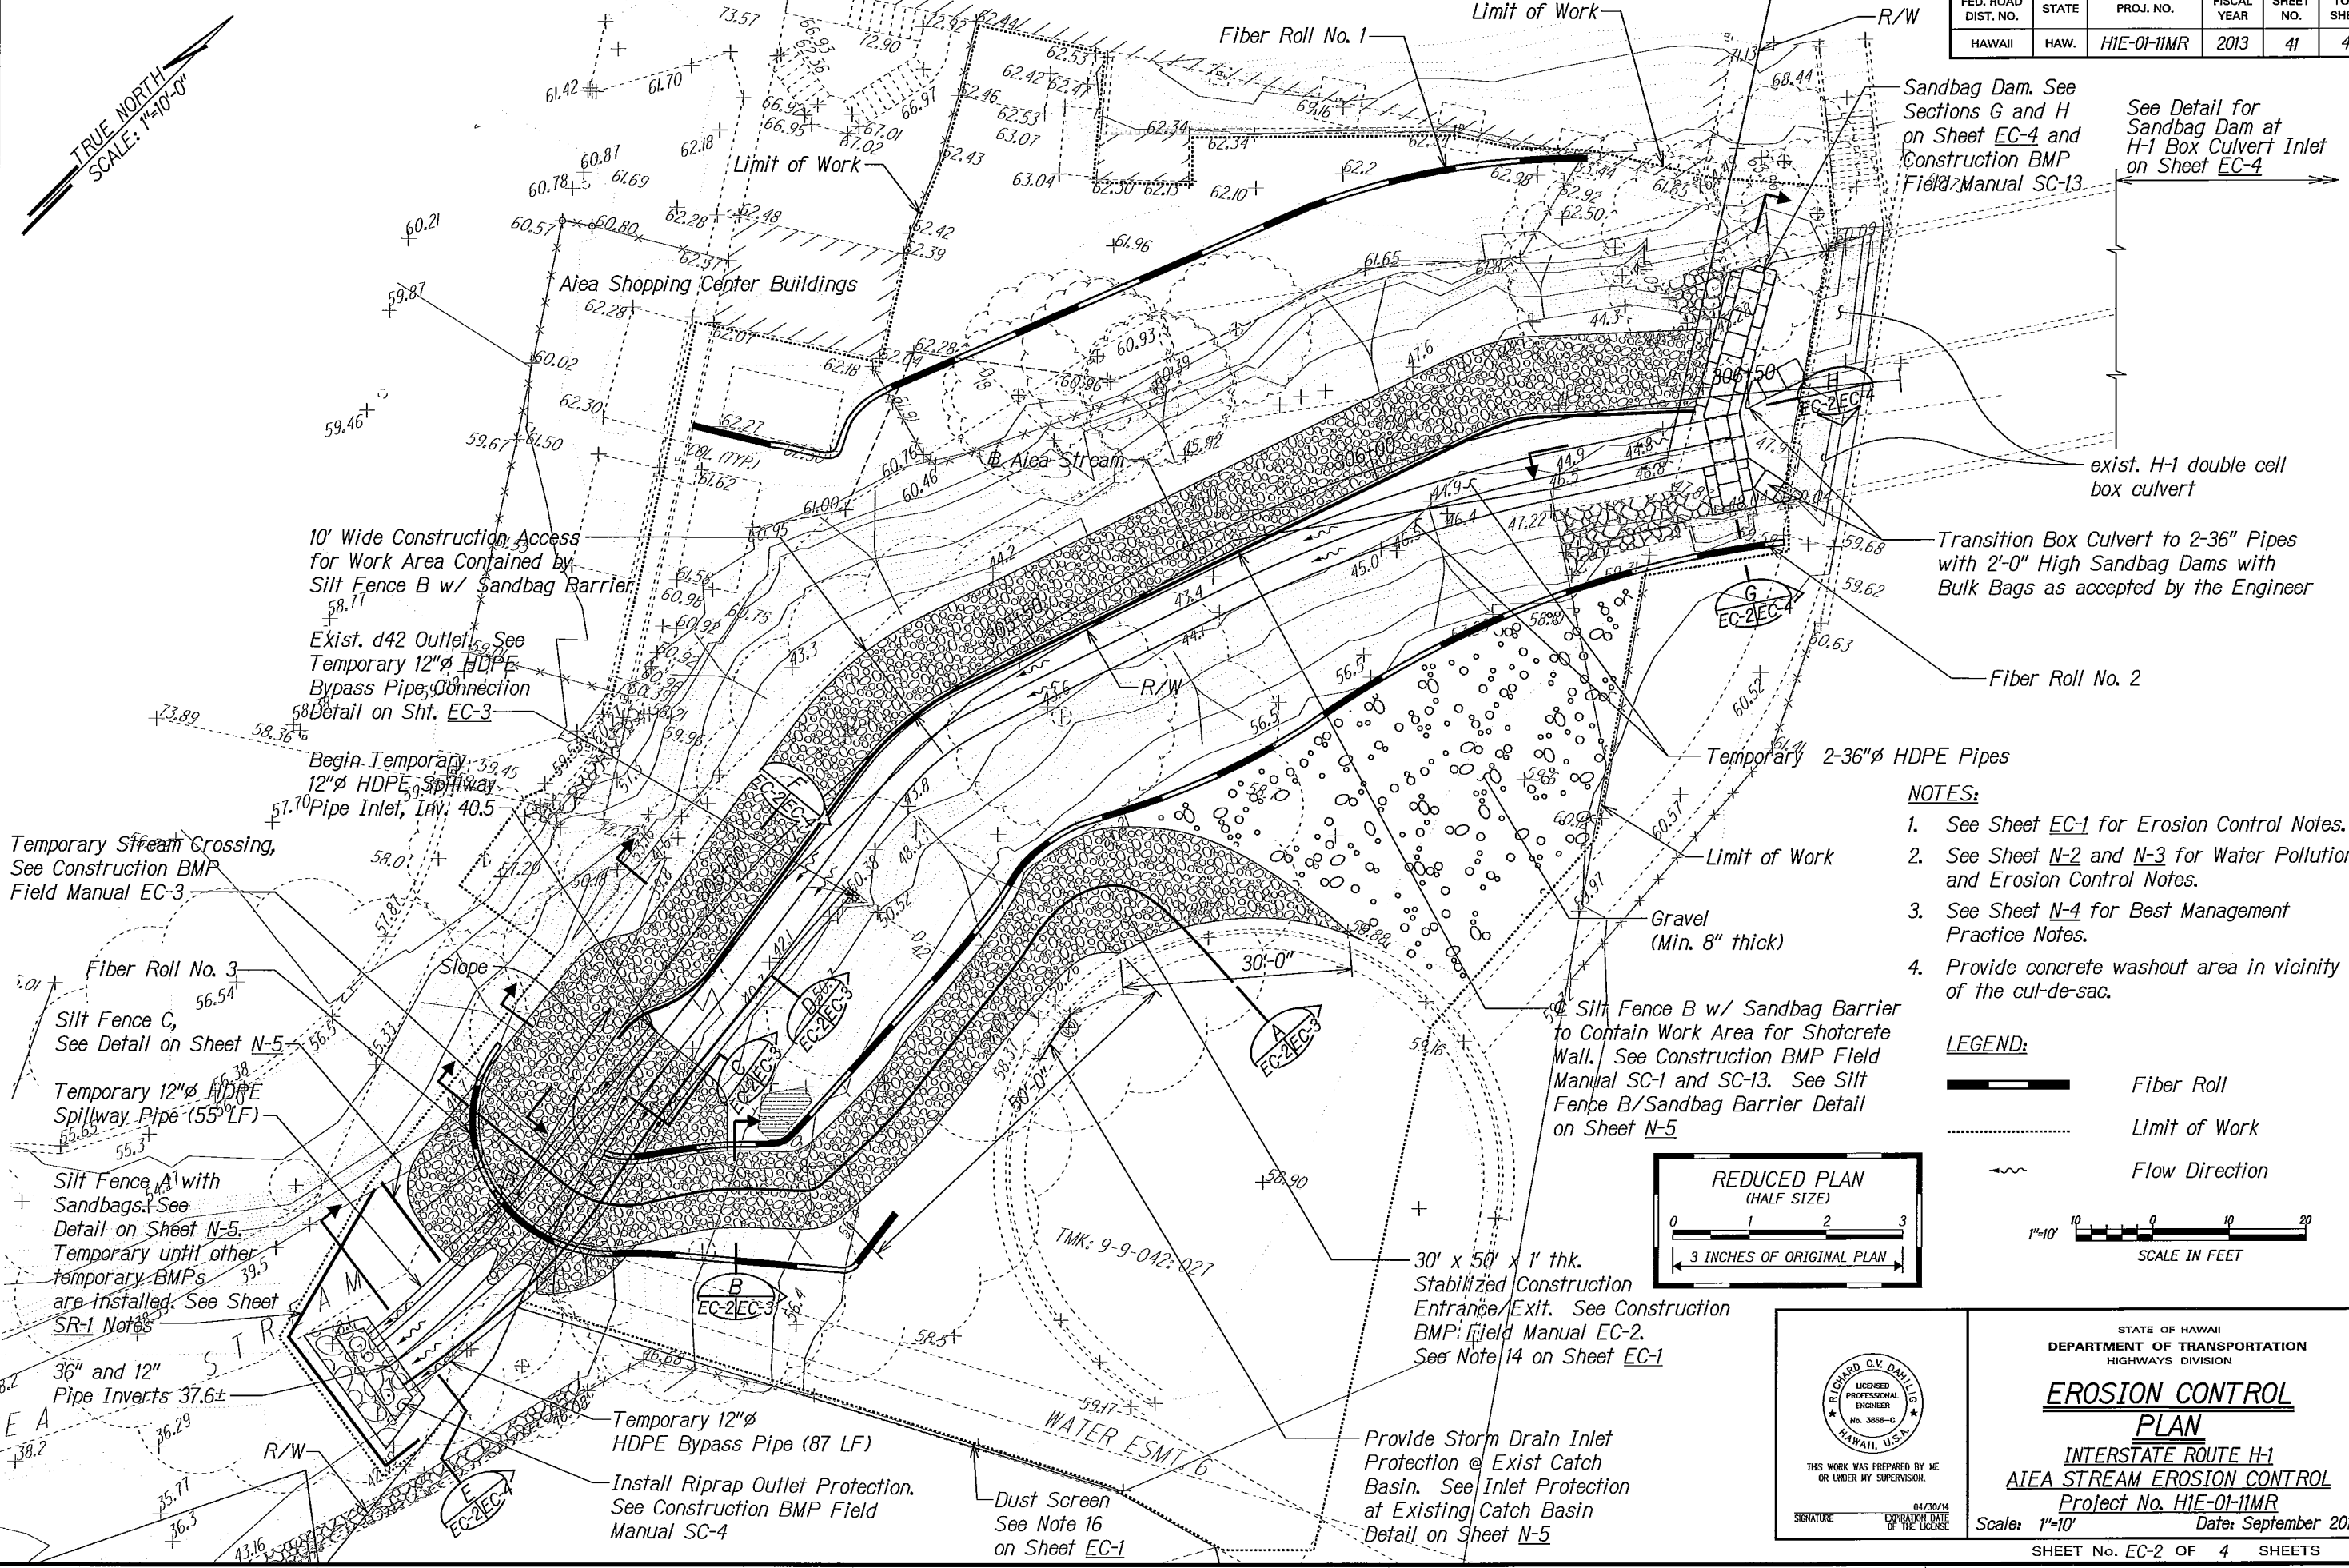

Sandbag Dam. See Sections G and H on Sheet EC-4 and Construction BMP Field Manual SC-13

See Detail for Sandbag Dam at H-1 Box Culvert Inlet on Sheet EC-4

Transition Box Culvert to 2-36" Pipes with 2'-0" High Sandbag Dams with Bulk Bags as accepted by the Engineer

- NOTES:**
1. See Sheet EC-1 for Erosion Control Notes.
 2. See Sheet N-2 and N-3 for Water Pollution and Erosion Control Notes.
 3. See Sheet N-4 for Best Management Practice Notes.
 4. Provide concrete washout area in vicinity of the cul-de-sac.

LEGEND:

- Fiber Roll
- Limit of Work
- Flow Direction

1"=10' SCALE IN FEET



THIS WORK WAS PREPARED BY ME OR UNDER MY SUPERVISION.

SIGNATURE: _____ DATE: 04/30/14 EXPIRATION DATE OF THE LICENSE: _____

STATE OF HAWAII
DEPARTMENT OF TRANSPORTATION
HIGHWAYS DIVISION

EROSION CONTROL PLAN

INTERSTATE ROUTE H-1
AIEA STREAM EROSION CONTROL

Project No. H1E-01-11MR

Scale: 1"=10' Date: September 2012

SHEET No. EC-2 OF 4 SHEETS

SURVEY PLOTTED BY	DATE
DRAWN BY	
DESIGNED BY	
NOTED BY	
CHECKED BY	

T:\SS\MP-Aiea Stream Erosion Control\Cadd\Sheets\EC-2.dgn