		LEGEND			ABBREVIATI	ONS	
SYMBOL	DESCRIPTION	SYMBOL	DESCRIPTION	ABBREV.	DESCRIPTION	ABBREV.	DESCRIPTION
	BUTTERFLY VALVE		FLOOR DRAIN	ABV	ABOVE	GPM	GALLONS PER MINUTE
\$	MOTORIZED BUTTERFLY VALVE		FLOOR SINK	ARCH BLDG	ARCHITECTURAL BUILDING	HB HP	HOSE BIBB HORSEPOWER
	CHECK VALVE		EQUILPMENT/MATERIAL TO BE REMOVED	ВТИН	BRITISH THERMAL UNITS PER HOUR	HZ IN.	HERTZ INCHES
	FLEXIBLE CONNECTION			CONN.	CONNECTION CONTINUATION	LBS	POUNDS
	STRAINER			СТ	COOLING TOWER	LRA LWT	LOCK ROTOR AMPS LEAVING WATER TEMPERATURE
	QUIPMENT INDICATOR QUIPMENT ABBREVIATION IARK NUMBER			CWP CW CWR CWS CFM DIAM DET	CONDENSER WATER PUMP COLD WATER CONDENSER WATER RETURN CONDENSER WATER SUPPLY CUBIC FEET PER MINUTE DIAMETER DETAIL	MECH MIN NO. NTS NPSH POC QTY	MECHANICAL MINIMUM NUMBER
Ø	DIAMETER, PHASE AT						NOT TO SCALE  NET POSITIVE SUCTION HEAD  POINT OF CONNECTION  QUANTITY
of the transfer of the transfe	WASTE PIPING			DN DWGS.	DOWN DRAWNGS	RLA RM	RATED LOAD AMPERES ROOM
555 4555 4555 4555 4455 4455 556- 4566 4550 4555 5555-	VENT PIPING			EAT EAT	EACH ENTERING AIR TEMPERATURE	RPM	REVOLUTIONS PER MINUTE
	UNION			EWT	ENTERING WATER TEMPERATURE	SHT TEMP	SHEET TEMPERATURE
томонический технородического на принаграфия по принаграфия принаграфия по принаг	COLD WATER PIPING			EXH EXIST	EXHAUST EXISTING	THK TYP	THICK TYPICAL
	PIPE UP			FD FLEX	FLOOR DRAIN FLEXIBLE	V	VOLTS
	PIPE DOWN			FIN FU	FINISH FIXTURE UNITS	WB W/ W	WET BULB WITH WASTE

FED. ROAD DIST. NO.	STATE	FED. AID PROJ. NO.	FISCAL YEAR	SHEET NO.	TOTAL SHEETS
HAWAII	HAW.	IM-H1-1(232)	2000	73	84

## <u>NOTES</u>

- 1. VERIFY ALL EXISTING CONDITIONS PRIOR TO COMMENCEMENT OF WORK.
- 2. COORDINATE WORK WITH ALL TRADES. VERIFY FIELD CONDITIONS AFFECTING OR AFFECTED BY THIS INSTALLATION. SHOULD CONFLICTS OCCUR, NOTIFY THE ENGINEER IMMEDIATELY.
- 3. ESTABLISH EXACT HEIGHT OF PIPE SUPPORT (DET. 1/M-4) BASED ON MEETING POINT OF CONNECTION (POC) TO EXISTING CONDENSER WATER PIPING. SLOPE NEW PIPING DOWN TOWARDS POC.
- 4. PROVIDE CONTINUOUS STEEL SUPPORT FOR NEW COOLING TOWERS TO REST UPON SUPPORTS PROVIDED BY THE GENERAL CONTRACTOR. IF REQUIRED, INCREASE HEIGHT OF STEEL SUPPORT TO MAINTAIN REQUIRED NPSH FOR EXISTING CONDENSER WATER PUMPS. (SECT B/M-4)
- 5. PRIOR TO COMMENCEMENT OF ANY WORK, TEST EXISTING CONTROLS TO INSURE THAT ALL EQUIPMENT ARE OPERATING PROPERLY; INTERFACE NEW CONTROLS WITH EXISTING.
- 6. PROVIDE TEMPORARY STRAINER UPSTEAM OF NEW CIRCUIT SETTERS. AFTER 24 HOUR OPERATION OF EACH CHILLER, REMOVE STRAINER.
- 7. PROVIDE FIVE (5) DAYS ADVANCE NOTICE TO THE BUILDING ENGINEER FOR ANY WORK REQUÍRING SHUTDOWN OF THE AIR CONDITIONING OR WATER SYSTEMS.

## **BOARD OF WATER SUPPLY NOTES**

1. NO CHANGE IN WATER CONSUMPTION. REPLACEMENT OF COOLING TOWERS AND HOSE BIBB IN KIND.

LICENSED PROFESSIONAL ENGINEER

STATE OF HAWAII
DEPARTMENT OF TRANSPORTATION
HIGHWAYS DIVISION


INTERSTATE ROUTE H-1
PUNAHOU ST. OFF-RAMP IMPROVEMENTS F.A.I. Proj. No. IM-H1-1(232)

THIS WORK WAS PREPARED BY ME OR UNDER MY SUPERVISION.

Date: 4/28/00

SHEET No. M-1 OF 5 SHEETS

		4- <u></u>				MARCH
FED. ROAD DIST. NO.	STATE	FED. AID PROJ. NO.	FISCAL YEAR	SHEET NO.	TOTAL SHEETS	
HAWAII	HAW.	IM-H1-1(232)	2000	74	84	

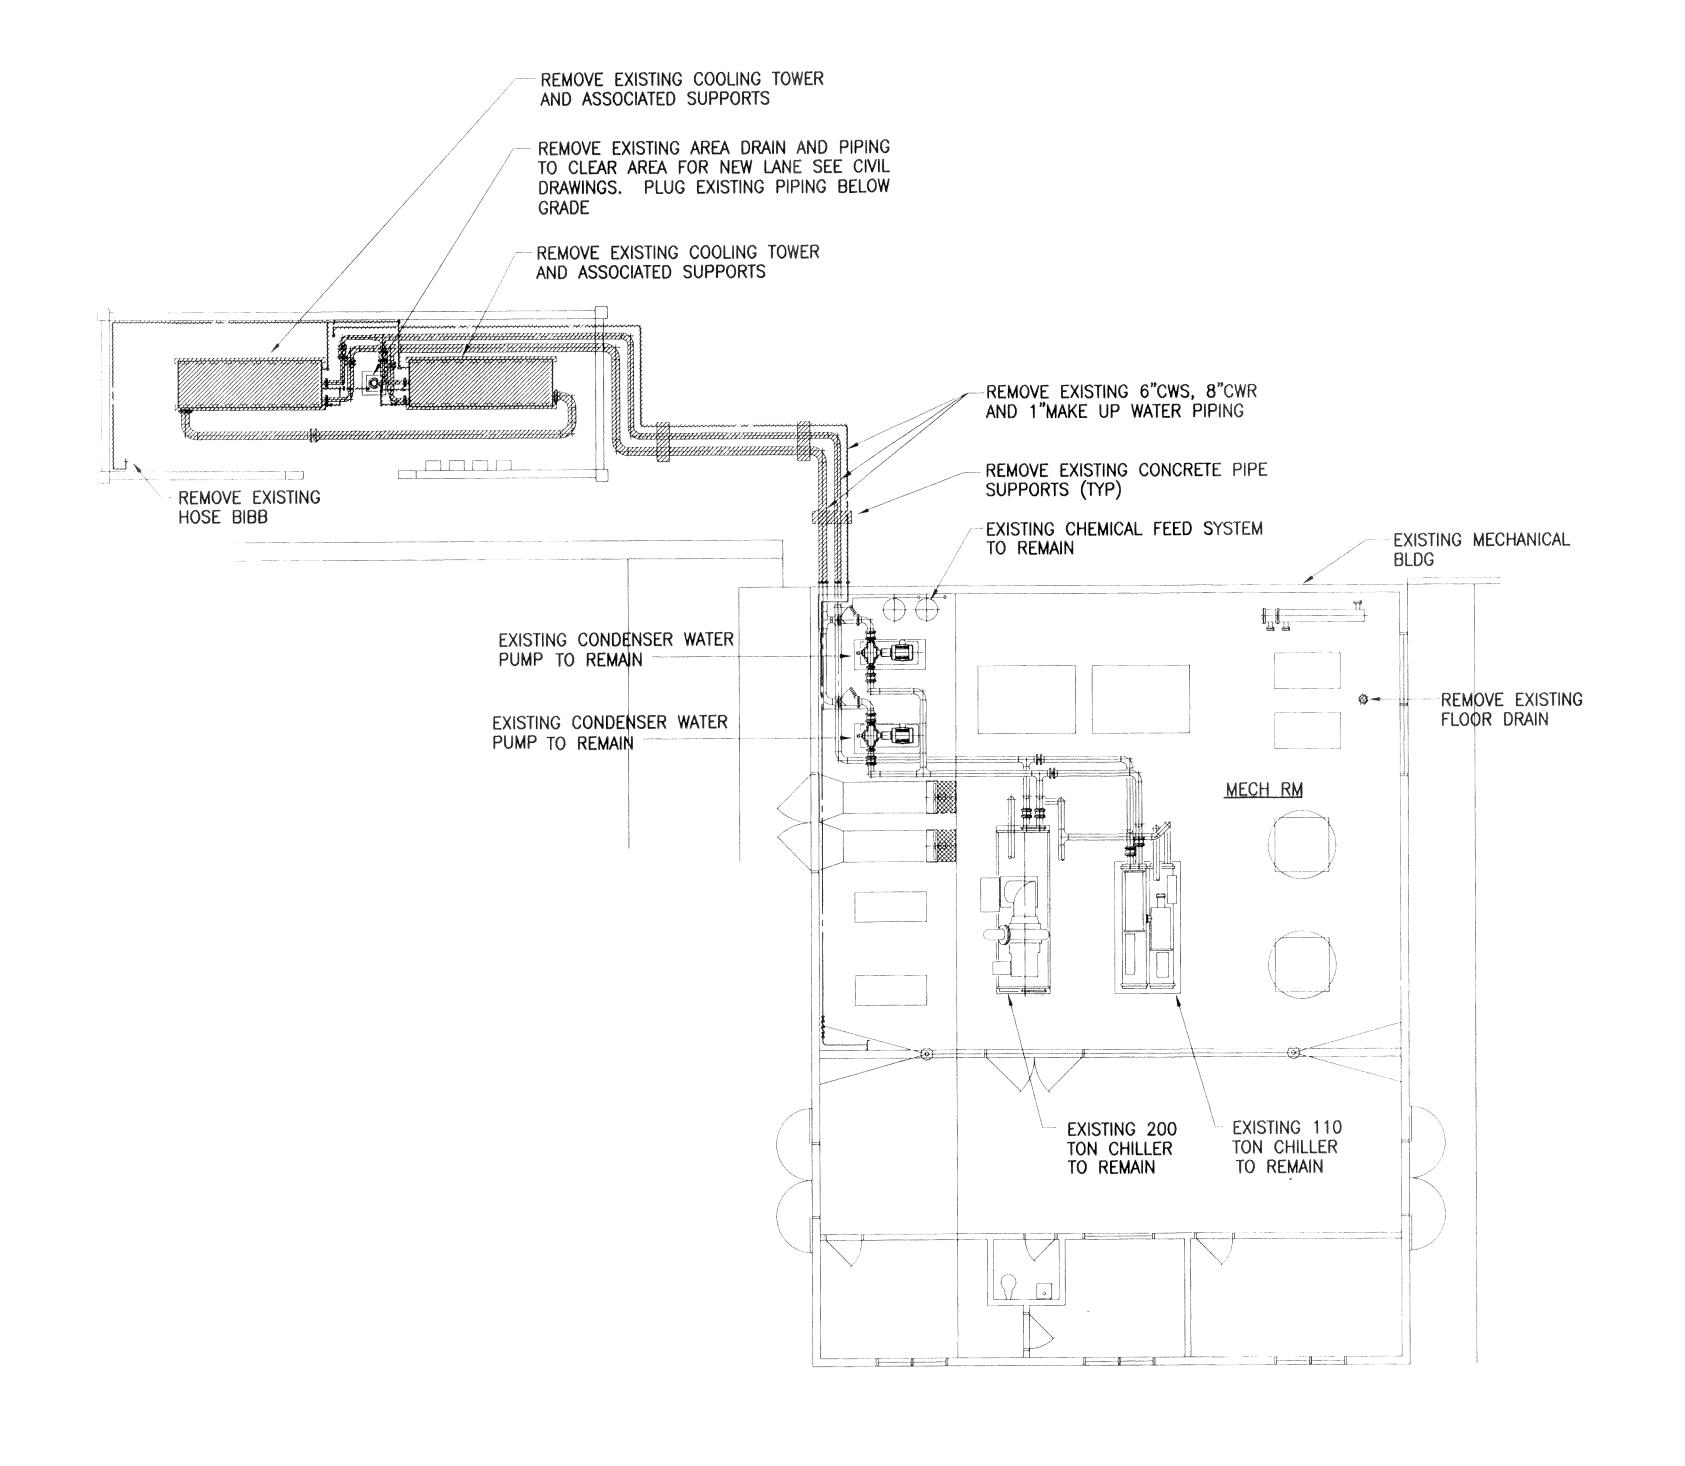

1 MECHANICAL DEMOLITION PLAN
SCALE: 1/8"=1'-0"





THIS WORK WAS PREPARED BY ME OR UNDER MY SUPERVISION.


STATE OF HAWAII
DEPARTMENT OF TRANSPORTATION
HIGHWAYS DIVISION


MECHANICAL DEMOLITION PLAN

<u>INTERSTATE ROUTE H-1</u> <u>PUNAHOU ST. OFF-RAMP IMPROVEMENTS</u> <u>F.A.I. Proj. No. IM-H1-1(232)</u>

DATE


Date: 4/28/00 SHEET No. M-2 OF 5 SHEETS

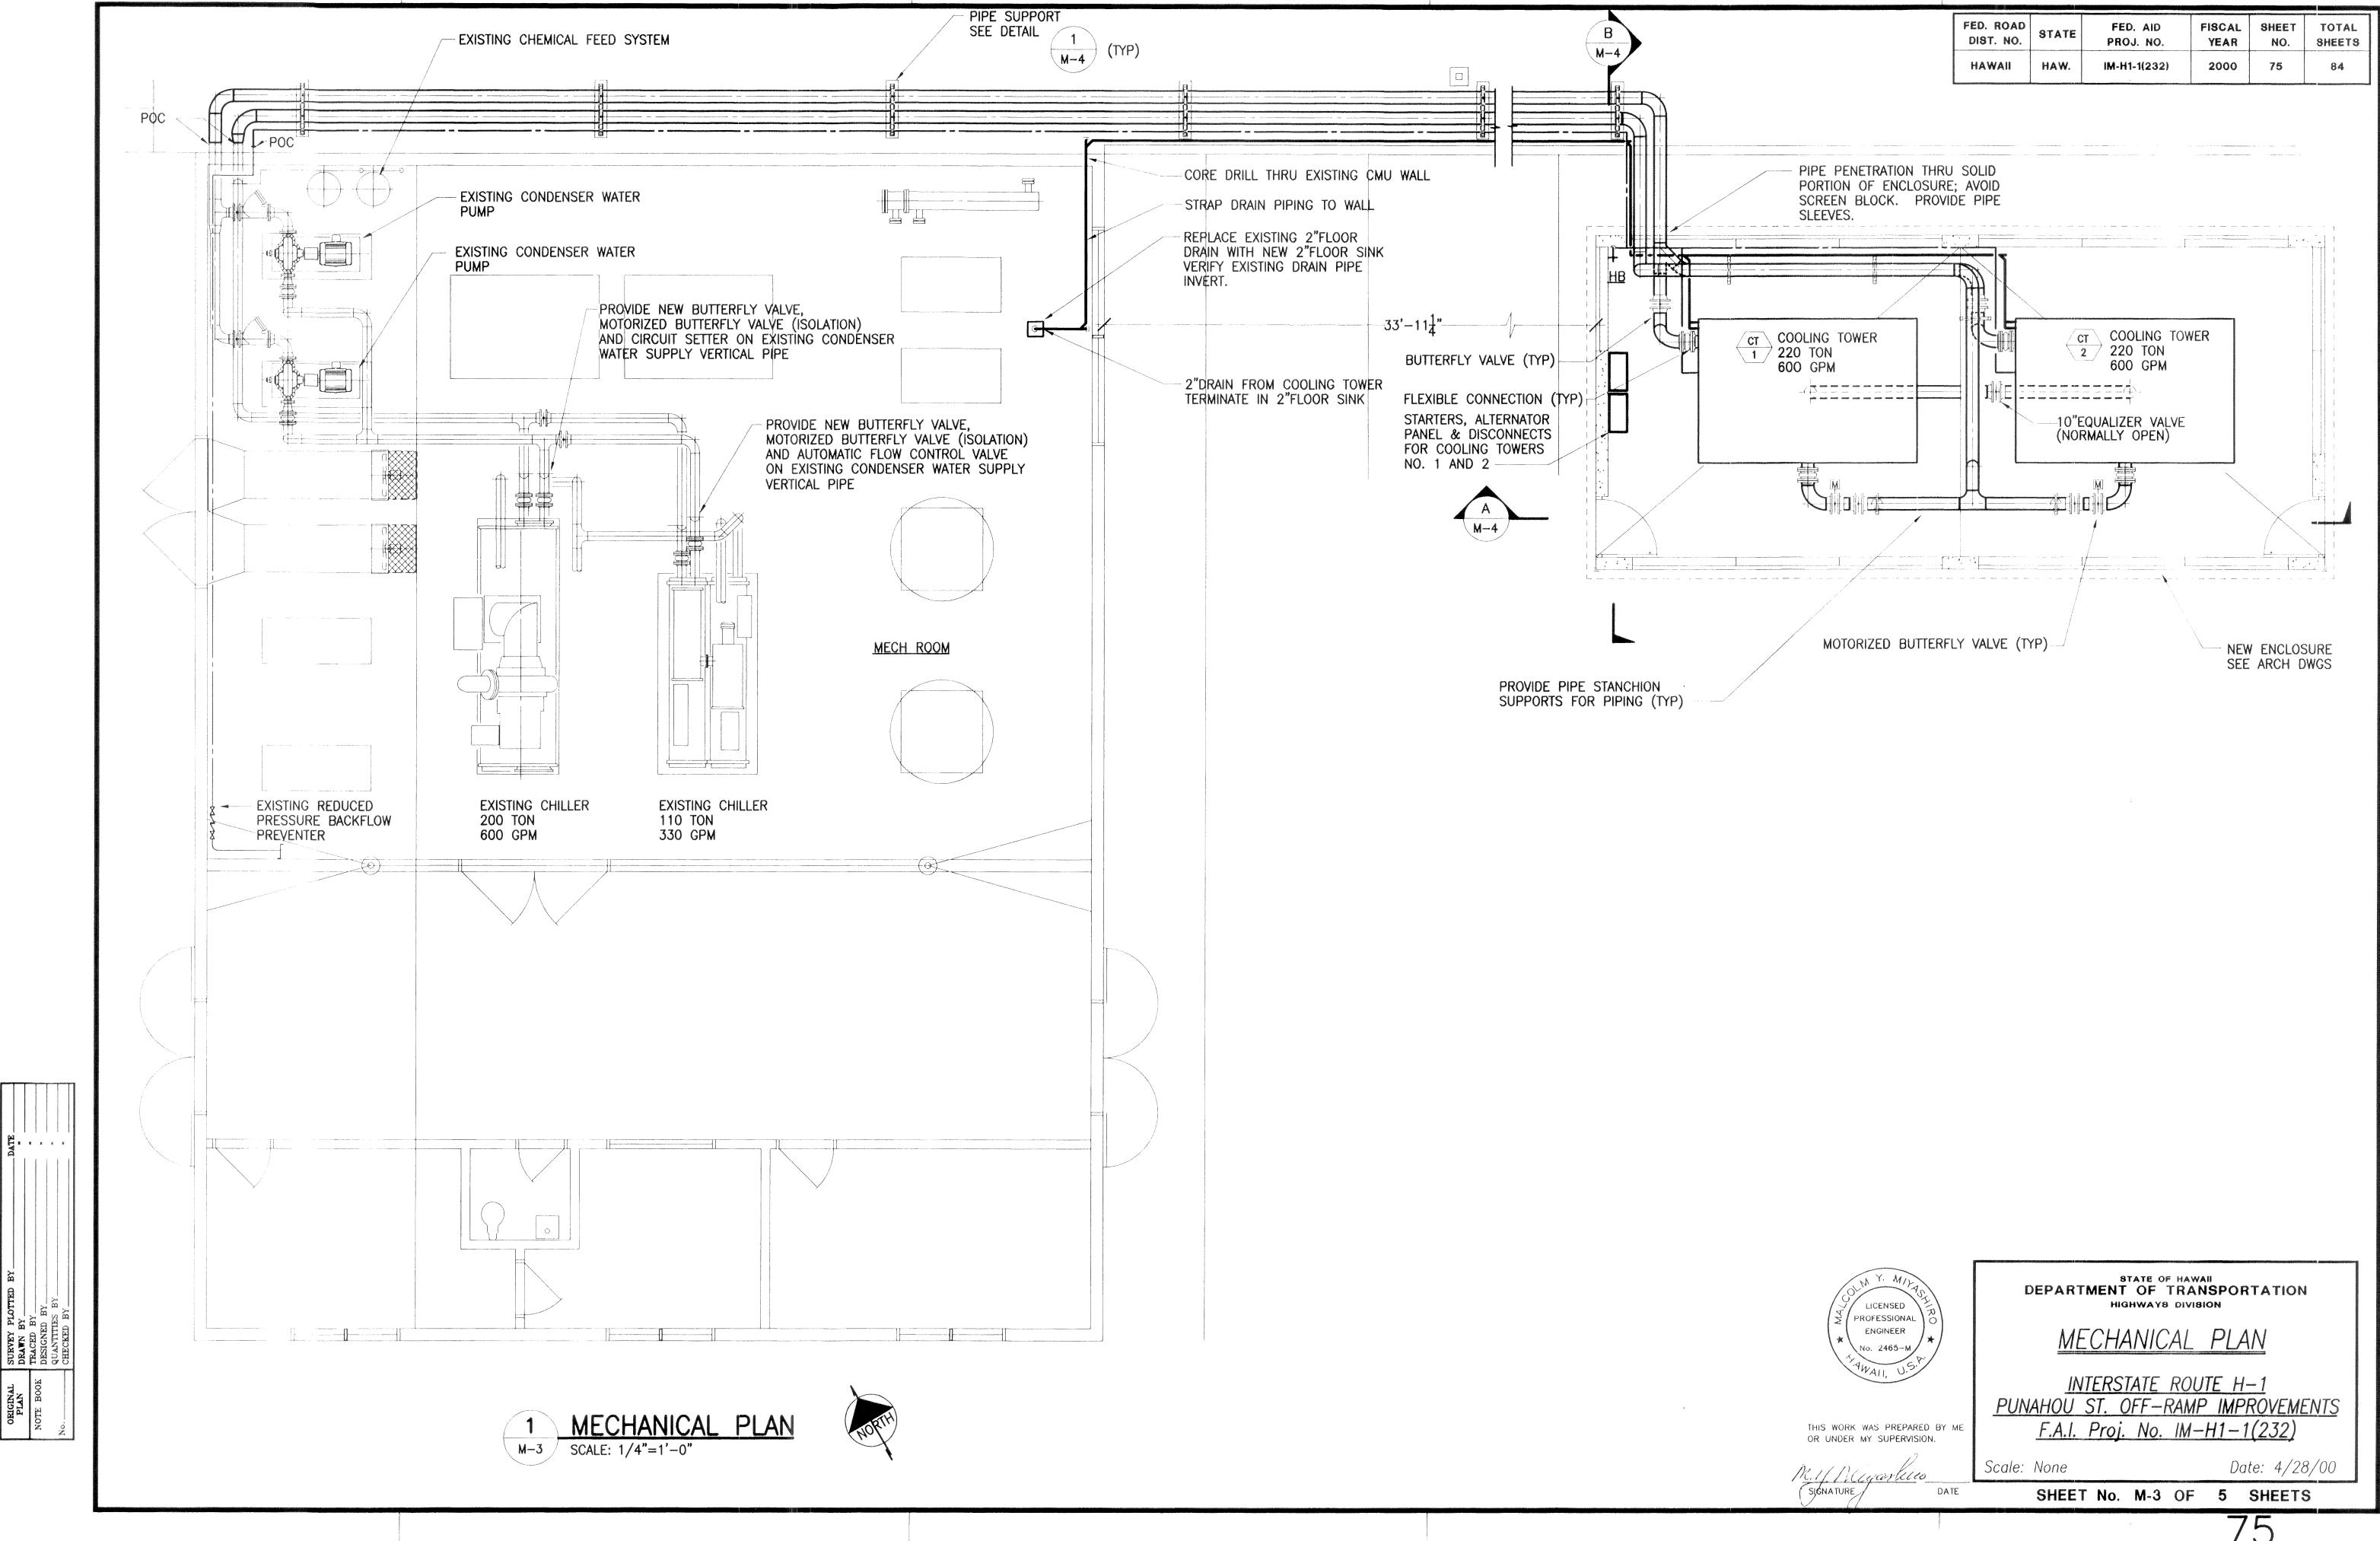

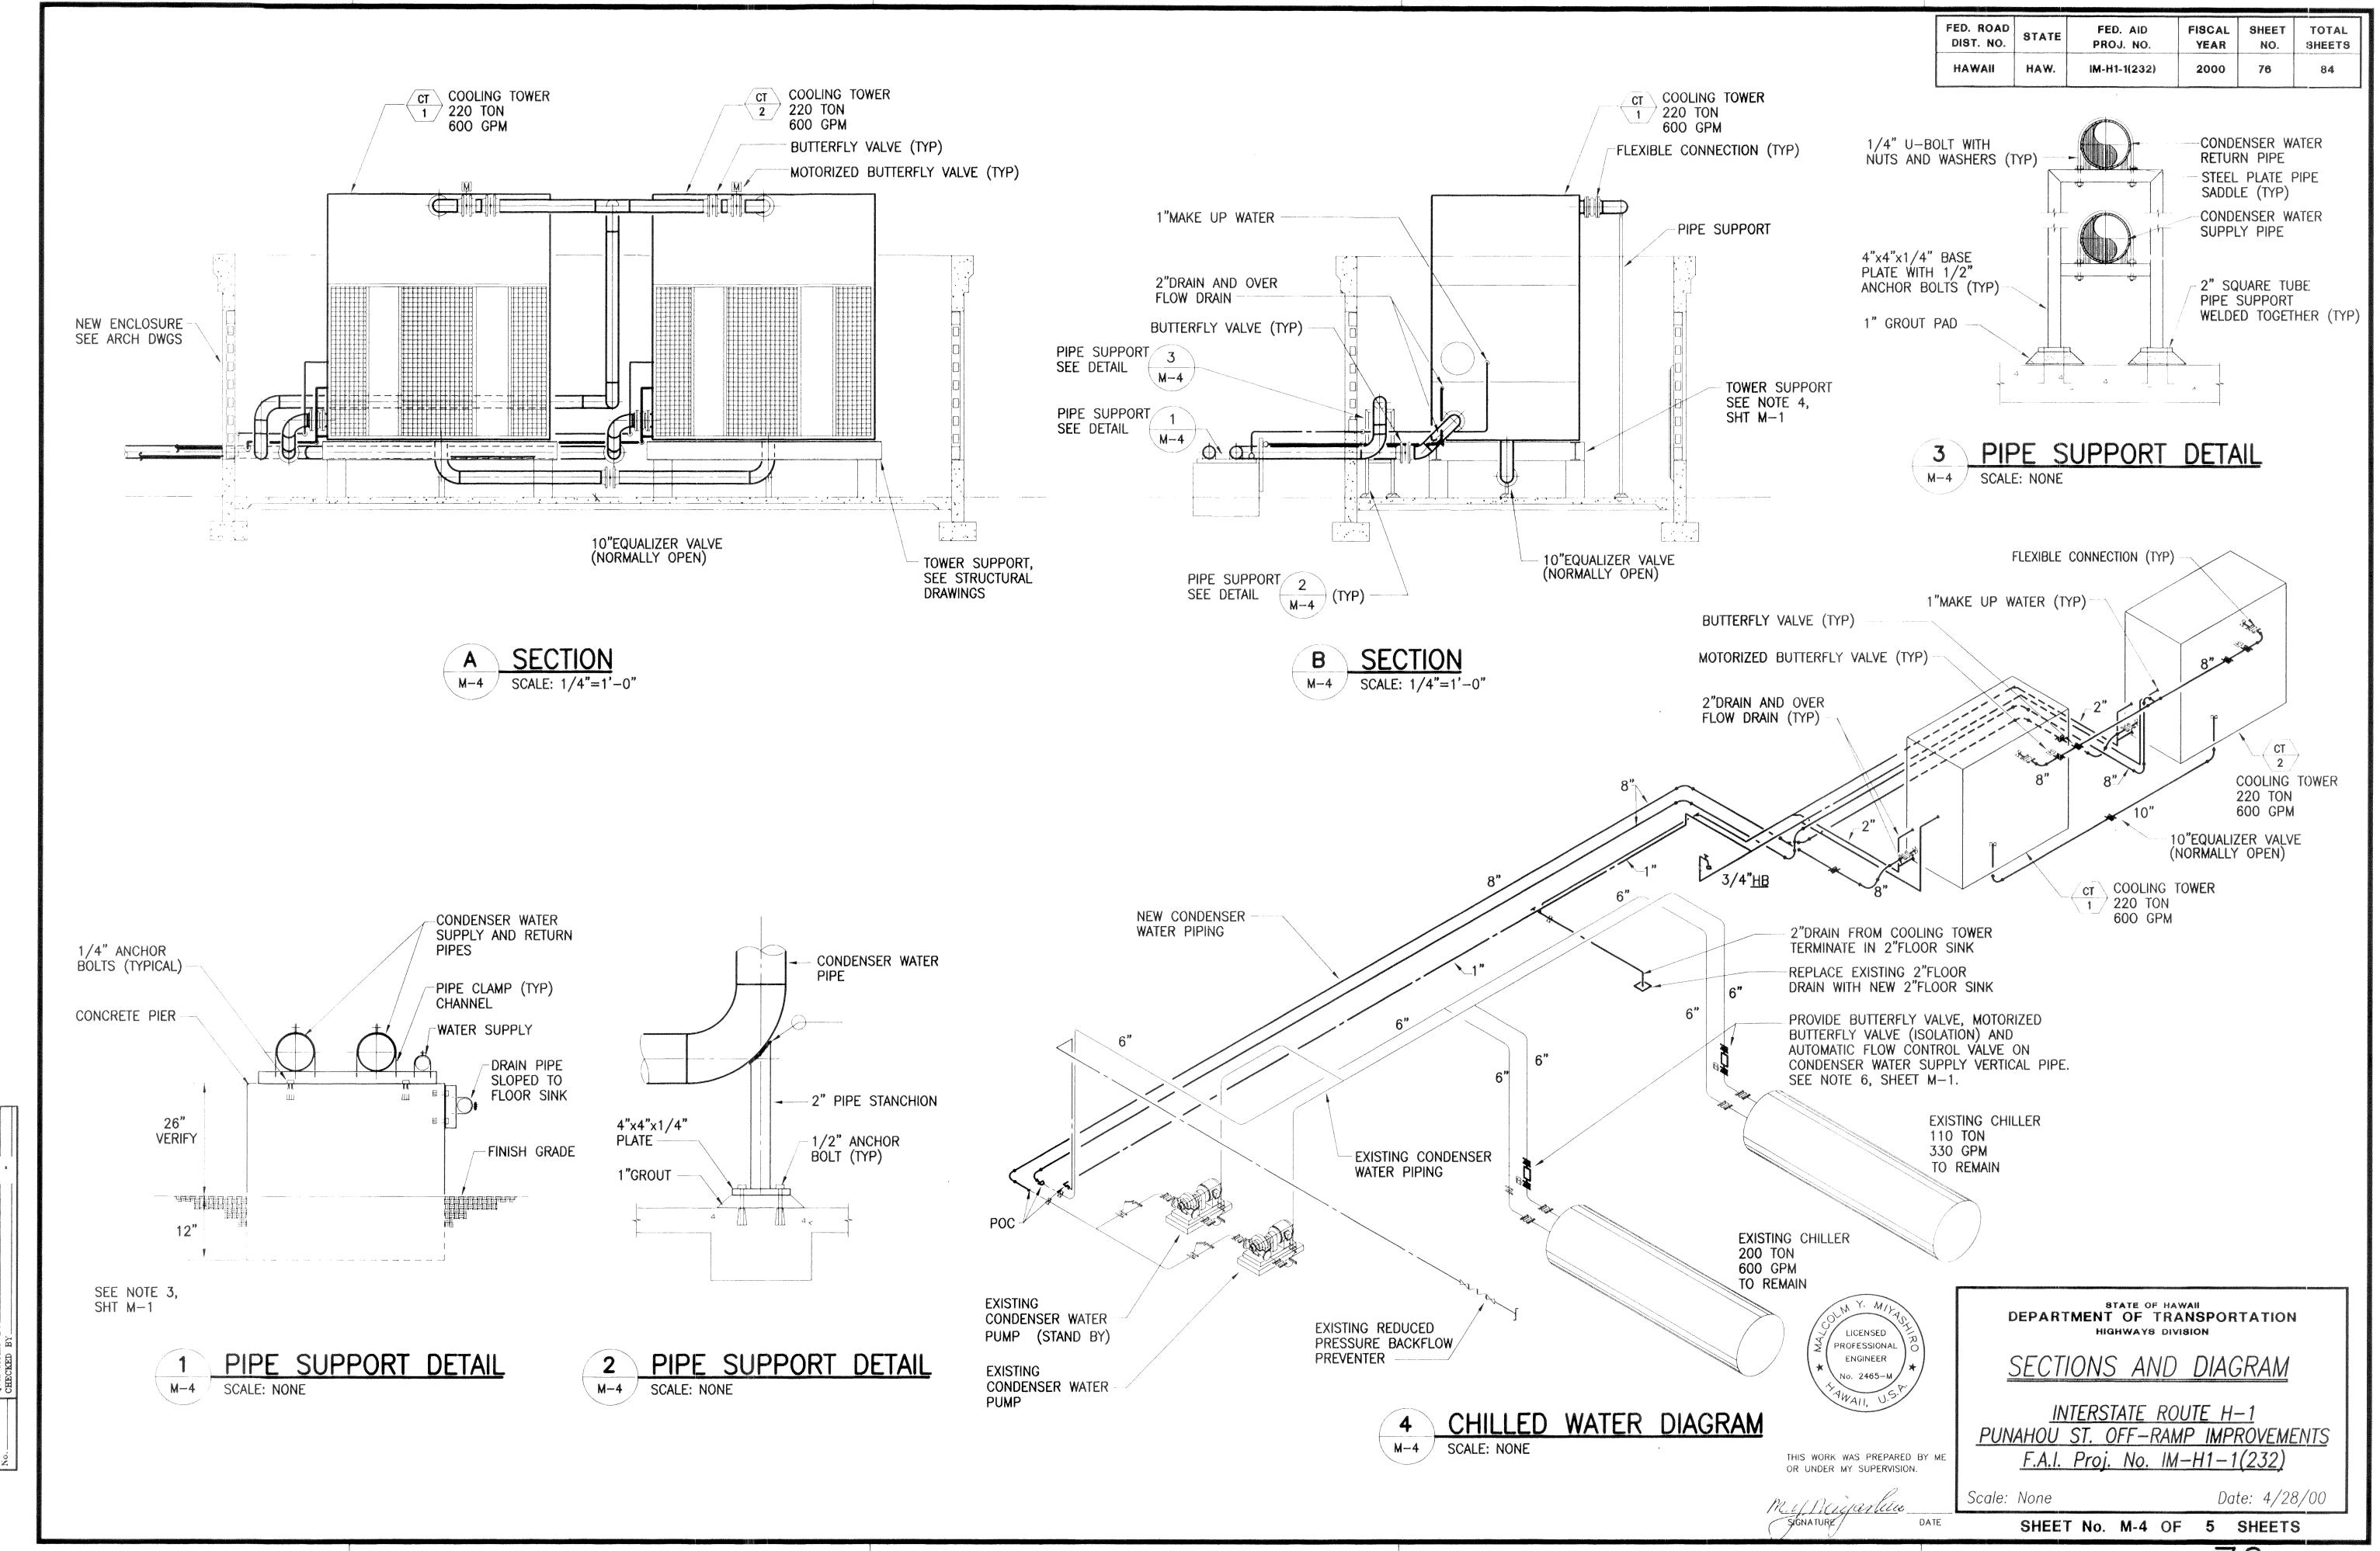

										EQ	<u>UIPMEN</u>	T SCH	EDULE
CO	OLING TO	OWER		<sup>11</sup> Маруаланды шамандын күрө төрөө	Provinces and the second s		And the second s			die Philippe - 1 - 1 - 1 - 1 - 1 - 1 - 1 - 1 - 1 -		anna ann an Aireann ann ann ann ann an Aireann ann	
MARK	MARK			EWT	LWT	FLOW RATE	FAN		N	MOTOR		UNIT	
NO.	LOCATION	SERVES	AIR TEMP. WB (F)	(۴)	(°F)		NO.	TYPE	AIR FLOW (CFM)	H.P.	V/ø/HZ	WEIGHT (LBS.)	REMARKS
$\left\langle \begin{array}{c} CT \\ 1 \end{array} \right\rangle$	OUTDOOR ENCLOSURE	EXISTING CHILLERS	78	95	85	600		CENTRIFUGAL	53100	25	480/3/60	9500	FLOW RATE BASED ON EXISTING CONDENSER WATER PUMPS PROVIDE 10 H.P. JOCKEY MOTOR
$\left\langle \frac{\text{CT}}{2} \right\rangle$	OUTDOOR ENCLOSURE	EXISTING CHILLERS	78	95	85	600	1	CENTRIFUGAL	53100	25	480/3/60	9500	FLOW RATE BASED ON EXISTING CONDENSER WATER PUMPS PROVIDE 10 H.P. JOCKEY MOTOR

DIST. NO.	PROJ. NO.	YEAR	NO.	TOTAL SHEETS
HAWAII HA	W. IM-H1-1(232)	2000	77	84

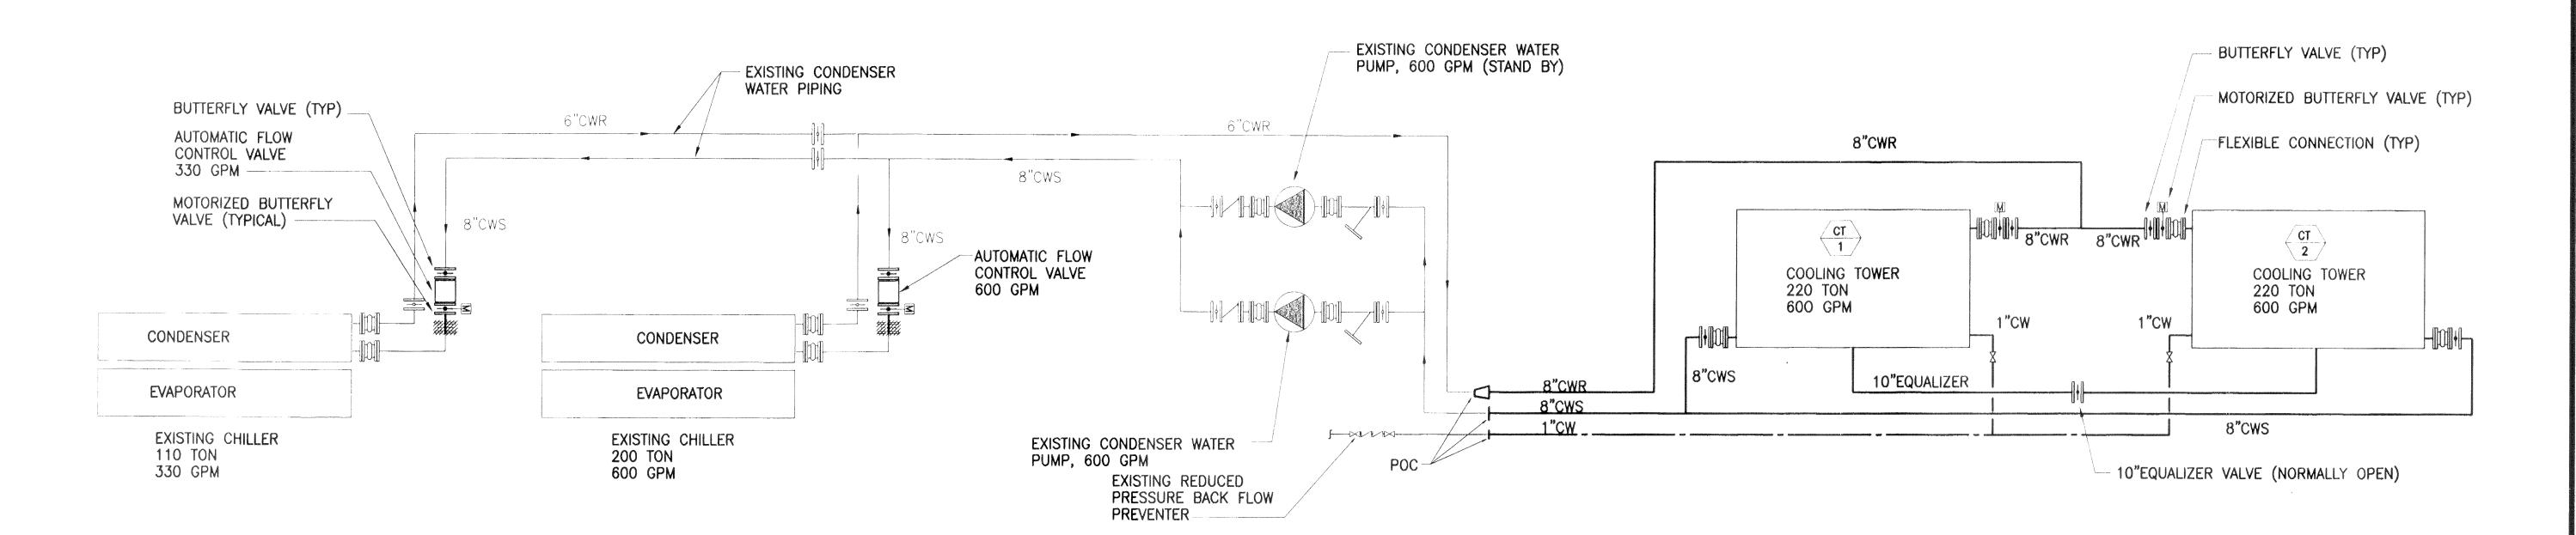

## CONDENSER WATER FLOW DIAGRAM M-5 SCALE: NONE

## SEQUENCE OF OPERATION

- 1. COOLING TOWERS SYSTEM DESIGN IS BASED ON NON-SIMULTANEOUS OPERATION OF THE TWO TOWERS.
- 2. ALL NEW CONTROLS SHALL BE COMPATIBLE WITH AND INTERCONNECTED TO EXISTING SYSTEM CONTROLS. EXISTING CONTROLS SHALL BE MAINTAINED EXCEPT AS MODIFIED UNDER THIS PROJECT.
- 3. OPERATION OF NEW MOTORIZED BUTTERFLY VALVE INSTALLED AT EACH EXISTING CHILLER SHALL BE INTERLOCKED WITH OPERATION OF EACH RESPECTIVE CHILLER. VALVE SHALL OPEN UPON START-UP OF CHILLER AND CLOSE UPON SHUTDOWN OF CHILLER.
- 4. OPERATION OF NEW COOLING TOWERS SHALL BE CONTROLLED IN THE SAME WAY AS EXISTING TOWERS EXCEPT THAT NEW TOWERS SHALL BE PROVIDED WITH ALTERNATOR PANEL TO AUTOMATICALLY SEQUENCE SINGULAR OPERATION OF TOWERS AND CORRESPONDING MOTORIZED BUTTERFLY VALVES. VALVE SHALL OPEN UPON START-UP OF TOWER AND CLOSE UPON SHUTDOWN OF TOWER.



STATE OF HAWAII
DEPARTMENT OF TRANSPORTATION HIGHWAYS DIVISION

CONDENSER WATER FLOW DIAGRAM

INTERSTATE ROUTE H-1 PUNAHOU ST. OFF-RAMP IMPROVEMENTS F.A.I. Proj. No. IM-H1-1(232)

THIS WORK WAS PREPARED BY ME OR UNDER MY SUPERVISION. M. 1/ Migos Mico

SHEET No. M-5 OF 5 SHEETS

Scale: None DATE

SURVEY PLOT
DRAWN BY
TRACED BY
DESIGNED BY
QUANTITIES B
CHECKED BY

Date: 4/28/00