

DRAINAGE SUMMARY

SAFETY IMPROVEMENTS,
 PROJ.: KALIHI STREET TO PALI HIGHWAY PROJ. NO.: I-HI-1(112):19

FED. ROAD DIST. NO.	STATE	FED. AID PROJ. NO.	FISCAL YEAR	SHEET NO.	TOTAL SHEETS
HAWAII	HAW.	I-HI-1(112):19	1973	51	176

STRUCTURES			ESTIMATED QUANTITIES													REMARKS														
NUMBER	TYPE	STATION	ITEM NO.	206. 01	206. 80	503. 001	602. 101	603. 1902	603. 2066	604. 201	604. 236	604. 237	604. 238	604. 305	605. 006	605. 012	605. 300													
			DETAIL SHEET	Structure Excavation other than at Bridges	Filter Material	Concrete other than in Bridges	Reinforcing Steel other than in Bridges	Remove, Clean and Relay Existing 24" Pipe	24-Inch Corrugated Metal Pipe, Sheet Thickness, 0.079 inch	Type "A" Cast Iron Frame and Cover	Type "S" Steel Frame and Grate	Type 6:1:20-1-4 Steel Frame and Grate	Modified Type "S" Steel Frame and Grates	Removing, Cleaning and Returning Type B Cast Iron Frame and Cover	6-Inch Perforated Underdrain Pipe	12-Inch Perforated Underdrain Pipe	Adjusting Underdrain Cleanout													
			UNIT USED	C.Y.	C.Y.	C.Y.	Lb.	L.F.	L.F.	Ea.	Ea.	Ea.	Ea.	Ea.	L.F.	L.F.	Ea.													
1	C.B. #63 Type D	@ Sta. 50 + 90 W.B.	GH	1.0		1.6	330				2			1				Install 2 Grates												
2	C.B. #68 Type C	@ Sta. 52 + 75 E.B.	4H, 5H	5.7		2.8	400				3							" 3 "												
3	C.B. #70 Type D	@ Sta. 54 + 75 E.B.	4H, 5H	5.7		2.8	400				3							" 3 "												
4	C.B. #72 Type C	Ramp "K-G" Sta. 9 + 50	GH			1.0	177				2			1				" 2 "												
5	C.B. Type D	@ Sta. 56 + 04 W.B.	7H			1.0	158			1				1				Adjust Catch Basin												
6	C.B. #74 Type C	Ramp "K-2" Sta. 15 + 95	8H	6.9		3.8	122		4			2		1				Construct new Drop Intake w/2 Grates - Demolish Catch Basin												
7	C.B. #2-F Type C	Ramp "K-2" Sta. 18 + 16	9H	8.4		4.3	122		4			2		1				Construct new D.I. w/2 Grates - Demolish C.B. - Existing sprinkler line												
8	C.B. #4-F Type C	@ Sta. 62 + 00 E.B.	10H	2.6		2.2	444					2		1				Install 2 Grates - Existing sprinkler line												
9	C.B. #6-F Type C	@ Sta. 63 + 75 E.B.	10H	1.1		1.7	396					2		1				" " " " " "												
10	C.B. #11-F Type C	@ Sta. 67 + 25 E.B.	9H	10.4		4.5	131		4			2		1				Construct new D.I. w/2 Grates - Demolish C.B. - Existing sprinkler line												
11	C.B. #15-F Type C	@ Sta. 70 + 75 E.B.	8H	8.8		3.7	122		4			2		1				" " " " " "												
12	C.B. #14-F Type B	@ Sta. 70 + 75 W.B.	11H	4.0		3.7	122					2		1				" " " " " "												
13	C.B. #17-F Type C	@ Sta. 73 + 25 E.B.	11H	9.4		3.8	122					2		1				" " " " " "												
14	C.B. #18-F Type B	Ramp "1" Sta. 2 + 10	12H	3.9		4.0	194					2		1				" " " " " "												
15	C.B. #20-F Type D	Ramp "1" Sta. 0 + 45	13H	4.9		4.2	439				2			1				Install 2 Grates - Existing sprinkler line												
16	C.B. #21-F Type D	@ Sta. 75 + 36 E.B.												1				Demolish C.B. and plug existing culvert - Existing sprinkler line												
17	C.B. #24-F Type D	@ Sta. 77 + 00 W.B.	13H	4.9		4.2	439				2			1				Install 2 Grates - Existing sprinkler line												
18	C.B. #28-F Type D	@ Sta. 78 + 80 W.B.	13H	4.9		4.2	439				2			1				" " " " " "												
19	C.B. #32-F Type A	@ Sta. 81 + 75 W.B.	14H	8.4		4.4	127		6		2	2		1				Construct new D.I. w/4 Grates - Demolish C.B. - Existing sprinkler line												
20	C.B. #30-F Type D	Ramp "4" Sta. 1 + 50	15H	1.8		1.8	366				2			1				Install 2 Grates - Existing sprinkler line												
21	C.B. #37-F Type C	@ Sta. 85 + 00 W.B.	16H	4.5		2.2	245				2							" " " " " - Reconstruct Conc. Curb & Gutter												
22	New SDMH Type A-1	@ Sta. 85 + 90.20 W.B.	17H, 40H	7.7		2.7	112			1								Construct new SDMH												
23	New Drop Intake	@ Sta. 86 + 15 W.B.	17H, 39H	12.0		4.0	122					2						New Drop Intake w/2 Grates												
24	C.B. #42-F Type C	@ Sta. 89 + 00 W.B.	12H	3.0		3.5	122		2		2			1				Construct new D.I. w/2 Grates - Demolish C.B. - Existing sprinkler line												
25	C.B. #50-F Type C	@ Sta. 101 + 00 E.B.	18H	8.2		3.7	122		6		2			1				" " " " " " " "												
26	C.B. #52-F Type C	@ Sta. 106 + 00 E.B.	19H	1.0		2.0	344				2			1				Install 2 Grates - Existing sprinkler line												
27	C.B. #55-F Type C	@ Sta. 108 + 25 E.B.	18H	2.6		1.5	296				2			1				" " " " " " "												
Sub-Total - This Sheet				131.8		79.3	6413		30	2	26	26		22																

SURVEY PLOTTED BY: _____
 DRAWN BY: _____
 DESIGNED BY: _____
 CHECKED BY: _____
 QUANTITIES BY: _____
 DATE: _____

DRAINAGE SUMMARY

SAFETY IMPROVEMENTS,
PROJ.: KALIHI STREET TO PALI HIGHWAY PROJ. NO.: I-HI-1(112):19

FED. ROAD DIST. NO.	STATE	FED. AID PROJ. NO.	FISCAL YEAR	SHEET NO.	TOTAL SHEETS
HAWAII	HAW.	I-HI-1(112):19	1973	52	176

STRUCTURES			ESTIMATED QUANTITIES														REMARKS																						
NUMBER	TYPE	STATION	ITEM NO.	DETAIL SHEET	UNIT USED	206.	206.	503.	602.	603.	603.	604.	604.	604.	604.	604.	605.	605.																					
						01	80	001	101	1902	206b	201	236	237	238	305	000	012	300																				
						C.Y.	C.Y.	C.Y.	Lb.	L.F.	L.F.	Ea.	Ea.	Ea.	Ea.	Ea.	Ea.	Ea.	Ea.	L.F.	L.F.	Ea.																	
28	C.B.#56-F Type B	Sta. 110+00 W.B.	20H, 30H			32		33	35		4																										Construct new D.I. w/2 Grates - Demolish C.B. - Existing sprinkler line		
29	C.B.#57-F Type D	Sta. 110+05 E.B.	21H					1.6	440																											Install 2 Grates - Existing sprinkler line			
30	C.B.#61-F Type A	Sta. 111+70 E.B.	24H			1.0		2.0	497																											" " " w/throat opening - Existing sprinkler line			
31	C.B.#60-F Type A	Sta. 111+70 W.B.	25H			4.7		2.5	279	6																										" " " " " " " " " " "			
32	C.B.#63-F Type B	Sta. 114+50 E.B.	26H			1.0		1.5	259				2																							" " " - Existing sprinkler line			
33	C.B.#62-F Type C	Sta. 9+20 Ramp "7"	27H					1.0	207																											" " " " " " " " " "			
34	C.B.#64-F Type C	Sta. 7+50 Ramp "7"	27H					1.0	216																											" " " " " " " " " "			
35	C.B.#66-F Type C	Sta. 5+00 Ramp "6"	4H, 5H			5.7		2.8	400																											" 3 " " " " " "			
36	C.B.#67-F Type A	Sta. 7+25 Ramp "6"	4H, 5H			7.3		3.4	500																											" 4 " " " " " "			
37	C.B.#69-F Type B	Sta. 121+00 W.B.	19H					2.0	251																											" 2 " " " " " "			
38	C.B.#70-F Type C	Sta. 9+25 Ramp "6"	28H					1.6	408																											" " " " " " " " " "			
39	C.B.#72-F Type C	Sta. 11+50 Ramp "6"	22H					1.6	473																											" " " " " " " " " "			
40	C.B.#71-F Type B	Sta. 123+75 W.B.	20H			1.0		1.1	256																											" " " " " " " " " "			
41	C.B.#75-F Type C	Sta. 13+50 Ramp "6"	23H					1.6	453																											" " " " " " " " " "			
42	C.B.#74-F Type B	Sta. 125+75 W.B.	29H			1.0		1.9	354																											" " " w/throat opening - Existing sprinkler line			
43	C.B.#1-F(T) Type B	Sta. 128+25 W.B.	30H			0.5		2.0	297																											" " " - Existing sprinkler line			
44	C.B.#2-F(T) Type D	Sta. 128+25 E.B.	31H			2.6		2.2	45	10																										Construct new D.I. w/ grates & throat opening - Demolish C.B. - Existing sprinkler line			
45	C.B.#4-F(T) Type D	Sta. 129+75 W.B.	32H			1.0		2.0	320																											Install 2 Grates - Existing sprinkler line			
46	C.B.#5-F(T) Type D	Sta. 130+25 E.B.	31H			6.0		2.5	49	16																										Construct new D.I. w/ grates & throat opening - Demolish C.B. - Existing sprinkler line			
47	C.B.#6-F(T) Type A	Sta. 132+75 W.B.	33H			0.5		2.3	122																											Install 4 Grates - Existing sprinkler line			
48	C.B.#7-F(T) Type A	Sta. 132+75 E.B.	31H			6.0		2.5	49	16																										Construct new D.I. w/ grates & throat opening - Demolish C.B. - Existing sprinkler line			
49	C.B.#9-F(T) Type D	Sta. 134+40 E.B.	31H			4.9		2.3	48	16																											" " " " " " " " " "		
50	C.B.#8-L(T) Type A	Sta. 136+73 W.B.	34H			7.8		4.7	503																											Install 2 Grates - Existing sprinkler line			
51	C.B.#4-L(T) Type D	Sta. 137+42 E.B.	35H			4.9		4.8	197																											Construct new D.I. w/3 Grates			
52	C.B.#9-L(T) Type C	Sta. 140+28 W.B.	36H			8.1		3.5	429																											Install 2 Grates - Existing sprinkler line			
53	C.B.#6-L(T) Type D	Sta. 140+50 E.B.	37H			2.0		2.6	295																											" " " " " " " " " "			
54	C.B.#10-L(T) Type C	Sta. 141+26 W.B.	36H			7.6		5.5	463																											" " " " " " " " " "			
Sub - Total - This Sheet						76.8		65.8	7845	6	62		56	2	3	25																							

SURVEY PLANNED BY: _____ DATE: _____
 DRAWN BY: _____
 DESIGNED BY: _____
 CHECKED BY: _____
 ORIGINAL PLAN NO. _____
 NOTE BOOK NO. _____

DRAINAGE SUMMARY

SAFETY IMPROVEMENTS,
 PROJ.: KALIHI STREET TO PALI HIGHWAY PROJ. NO.: I-HI-1(112):19

FED. ROAD DIST. NO.	STATE	FED. AID PROJ. NO.	FISCAL YEAR	SHEET NO.	TOTAL SHEETS
HAWAII	HAW.	I-HI-1(112):19	1973	53	176


STRUCTURES			ESTIMATED QUANTITIES													REMARKS													
NUMBER	TYPE	STATION	ITEM NO.	DETAIL SHEET	206. 206. 503. 602. 603. 603. 604. 604. 604. 604. 604. 604. 605. 605.																								
					01	80	001	101	1902	2066	201	236	237	238	305	006	012	300											
					Structure Excavation other than at Bridges	Filter Material	Concrete other than in Bridges	Reinforcing Steel other than in Bridges	Remove Clean and Reuse Existing 24" Pipe	24-inch Corrugated Metal Pipe, Sheet Thickness 0.079 inch	Type A Cast Iron Frame and Cover	Type S Steel Frame and Grate	Type 20-1/4 Steel Frame and Grate	Modified Type S Steel Frame and Grates	Removing, Cleaning and Returning Type Blast Iron Frame and Cover	6-Inch Perforated Underdrain Pipe	12-Inch Perforated Underdrain Pipe	Adjusting Underdrain Cleanout											
					C.Y.	C.Y.	C.Y.	Lb.	L.F.	L.F.	Ea.	Ea.	Ea.	Ea.	Ea.	L.F.	L.F.	Ea.											
55	C.B.#11-L(7) Type D	Ramp "B" Sta. 3+51	37H		2.2		4.5	202				2			1					Construct new D.I. w/2 Grates - Demolish C.B. - Existing sprinkler line									
56	C.B.#13-L(7) Type D	@ Sta. 145+78 W.B.	26H				1.6	320				2			1					Install 2 Grates - Existing sprinkler line									
57	C.B.#16-L(7) Type D	@ Sta. 148+00 W.B.	4H, 5H		4.2		2.2	300				2								Install 2 Grates - Reconstruct existing conc. curb and gutter									
	24" Culvert	@ Sta. 85+03 W.B. to @ Sta. 85+86.37± W.B.	17H		42.0						86																		
	24" Culvert	@ Sta. 85+02.03 W.B. to @ Sta. 86+12± W.B.	17H		11.0					22																			
	6" Underdrain	@ Sta. 134+40± to @ Sta. 134+59±	30H		2.1	2.0									22														
	Existing Cleanout	@ Sta. 106+00± to @ Sta. 114+37±	20H															8											
Sub ~ Total ~ This Sheet					655	2.0	8.3	831		108		6			2	22			8										
Total ~ Sheet Nos. 1H, 2H & 3H					274.1	2.0	153.4	15,089	6	200	2	88	28	3	40	22			8										
Rounded Total					280	3	160	15,100	6	200	2	88	28	3	40	22			8										

SURVEY PLOTTED BY _____ DATE _____
 DRAWN BY _____
 DESIGNED BY _____
 CHECKED BY _____
 ORIGINAL PLAN NOTE BOOK No. _____


FED. ROAD DIST. NO.	STATE	FED. AID PROJ. NO.	FISCAL YEAR	SHEET NO.	TOTAL SHEETS
HAWAII	HAW.	I-H-1(112)13	1973	54	176

GENERAL NOTES

- Demolishing and removing a portion or the entire existing structure shall not be paid for separately, but shall be considered incidental to structural concrete.
- Unnecessary culvert lengths within the catch basins or storm drain manholes shall be neatly cut flush with the face of the wall.
- Contractor shall reuse salvaged manhole rungs and also provide new manhole rungs whenever necessary. Manhole Rungs (16" o.c) are required when "H" is greater than 4 feet 6 inches. Only one rung (12 inches from the bottom) is required if "H" is 4 feet 6 inches or less. Manhole Rungs may be placed at any location as ordered by the Engineer. (For detail of Manhole Rung see sheet no. 41H) Manhole Rungs shall be considered incidental to structural concrete.
- Salvaged C.I. Frame and Covers shall be cleaned and returned to 727 Kakoi Street, Honolulu, Hawaii 96819.
- Exposed portion of C.I. frame shall be cleaned before pouring concrete for top slab.
- Contractor shall verify the locations of all culverts and sprinkler lines in the field. Any culvert or sprinkler line damaged during construction shall be repaired or replaced by the Contractor at his expense. (See Sprinkler Plans for approximate location of existing sprinkler lines at Catch Basins.)
- Reconstruction of existing Concrete Curb and Gutter shall be considered incidental to Structural Concrete.
- If necessary all adjustments to the existing subdrain pipes and cleanouts shall be made by the Contractor, and the work mentioned shall not be paid for separately but shall be considered incidental to the various contract items. The work mentioned above does not apply to subdrain work as indicated in these plans.
- Location of C.I. Frame & Cover for S.D.M.H. or Catch Basin shall be determined by the Engineer in the field.
- For typical pavement structure, see typical roadway section.
- Only non-pneumatic type of drill as approved by the Engineer will be permitted for drilling holes in concrete.
- For location of swale see roadway plans.
- Contractor shall use Structural Concrete for all modified or new Drop Intakes.

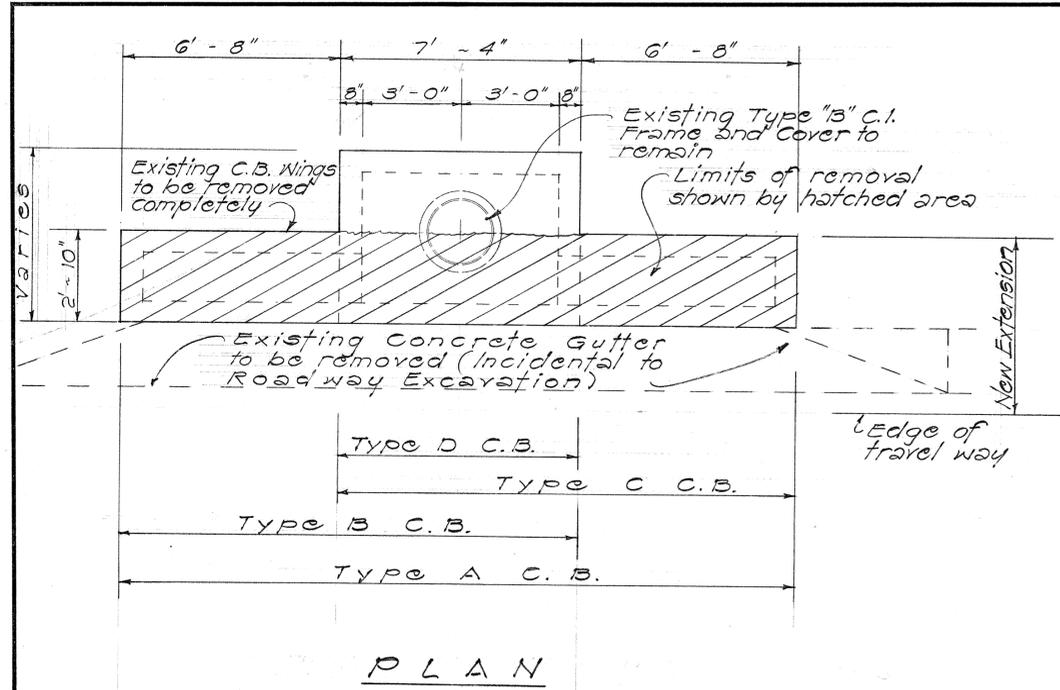


PLAN

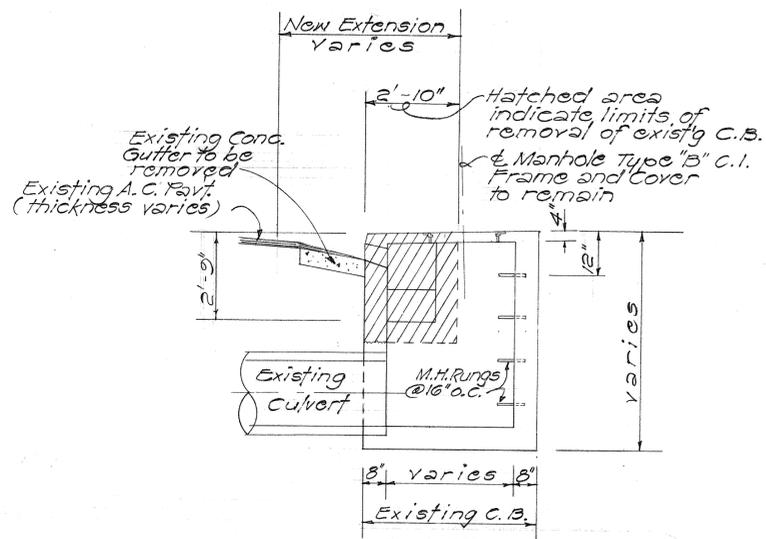


SECTION


DETAILS - REMOVAL OF EXISTING CATCH BASINS

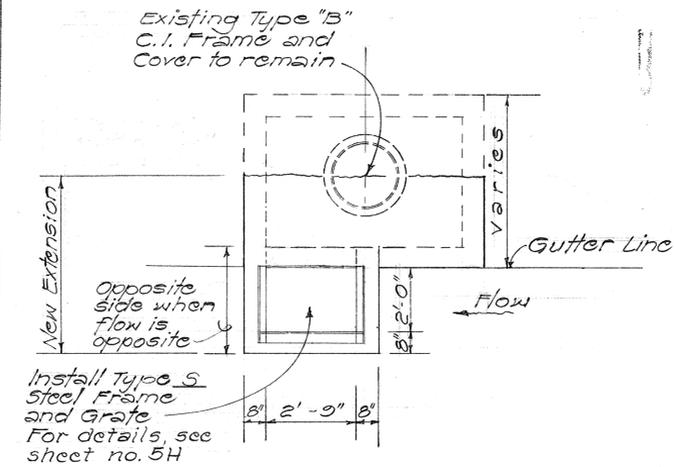

PLAN MODIFICATION FOR 1 GRATE

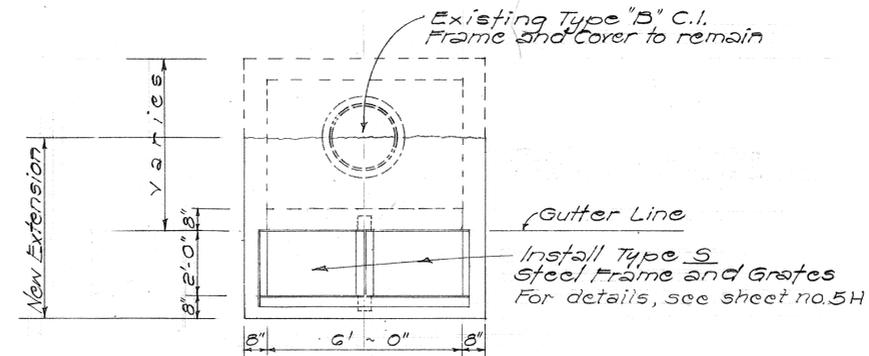

PLAN MODIFICATION FOR 2 GRATES

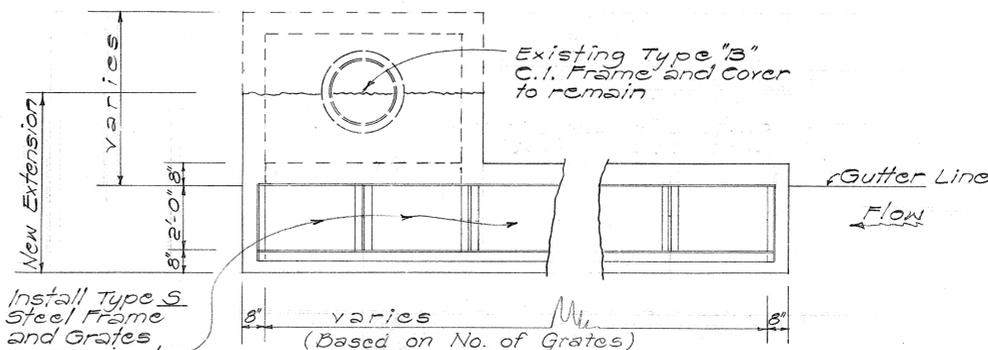

Install Type S Steel Frame and Grates as required for details see sht. no. 5H

PLAN MODIFICATION FOR 3 OR MORE GRATES

PLAN VIEW OF MODIFICATIONS TO CONVERT EXISTING CATCH BASINS TO USE ONE OR MULTIPLE GRATES

DATE	REVISION

DESIGNED BY	
CHECKED BY	
DATE	


STATE OF HAWAII
DEPARTMENT OF TRANSPORTATION
HIGHWAYS DIVISION

DRAINAGE DETAILS
Modification of Catch Basins with Grated Inlet within an Existing Gutter


Safety Improvements from Kalihi Street to Pali Highway
Fed. Aid Interstate Proj. No. I-H-1(112)13
Scale: 3/8" = 1'-0" Date: April, 1973

SHEET No. 4H OF 41 HSHEETS


FED. ROAD DIST. NO.	STATE	FED. AID PROJ. NO.	FISCAL YEAR	SHEET NO.	TOTAL SHEETS
HAWAII	HAW.	I-H-1(112)-19	1973	55	176

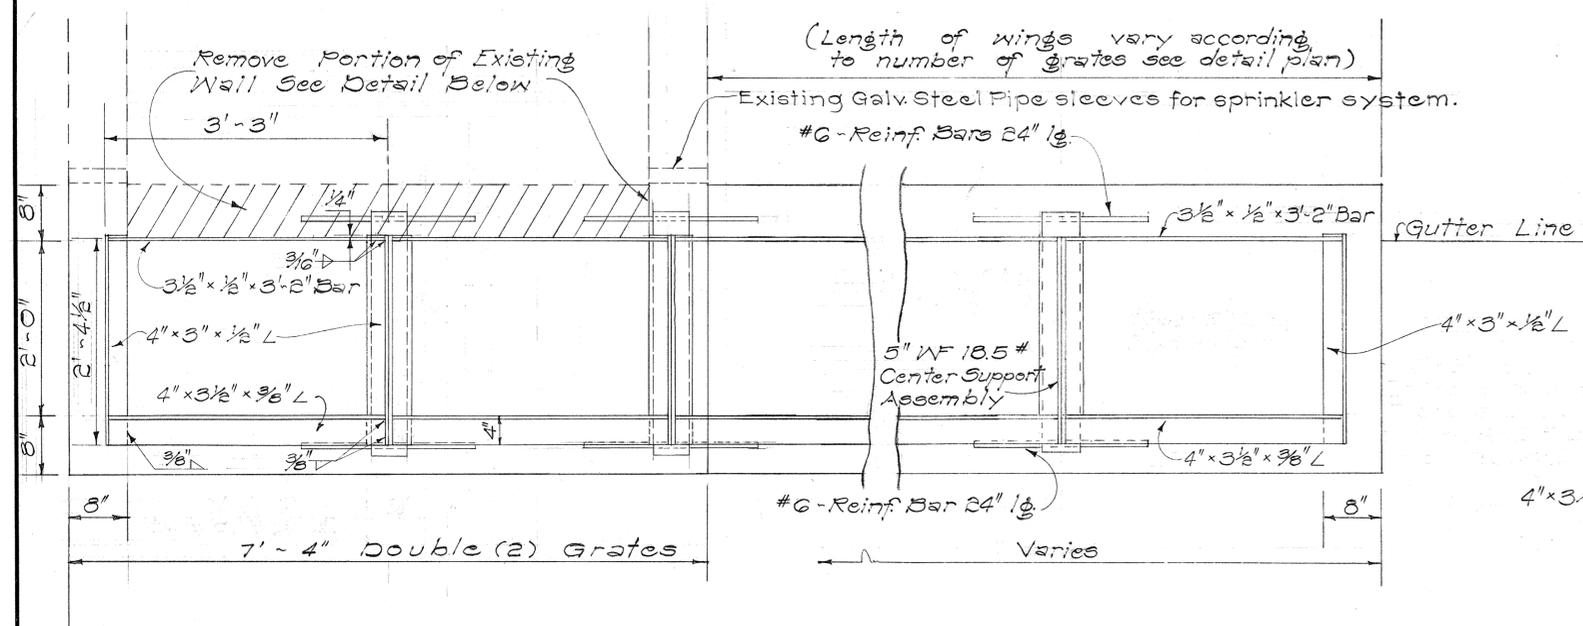


P L A N
 Scale: 1" = 1'-0"

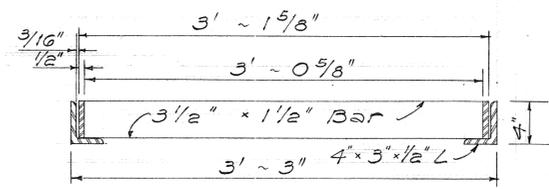



LONGITUDINAL SECTION
 (Thru Frame and Grate)
 Scale: 1 1/2" = 1'-0"

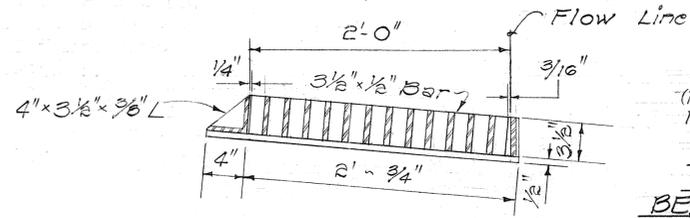


CROSS SECTION
 (Thru Frame and Grate)
 Scale: 1 1/2" = 1'-0"

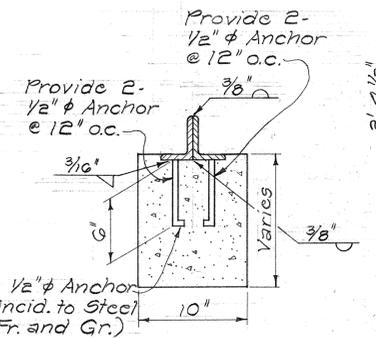


DETAIL OF REINFORCED CONCRETE BEAM CENTER SUPPORT
 Scale: 1 1/2" = 1'-0"

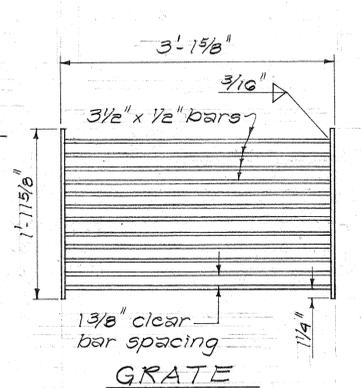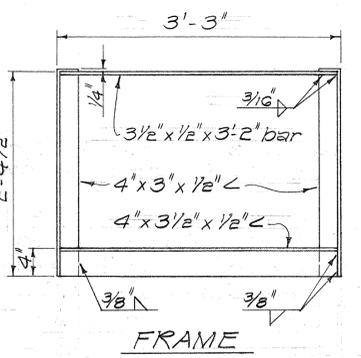


DETAIL OF TYPE "S" STEEL FRAME & GRATE
 Scale: 1" = 1'-0"

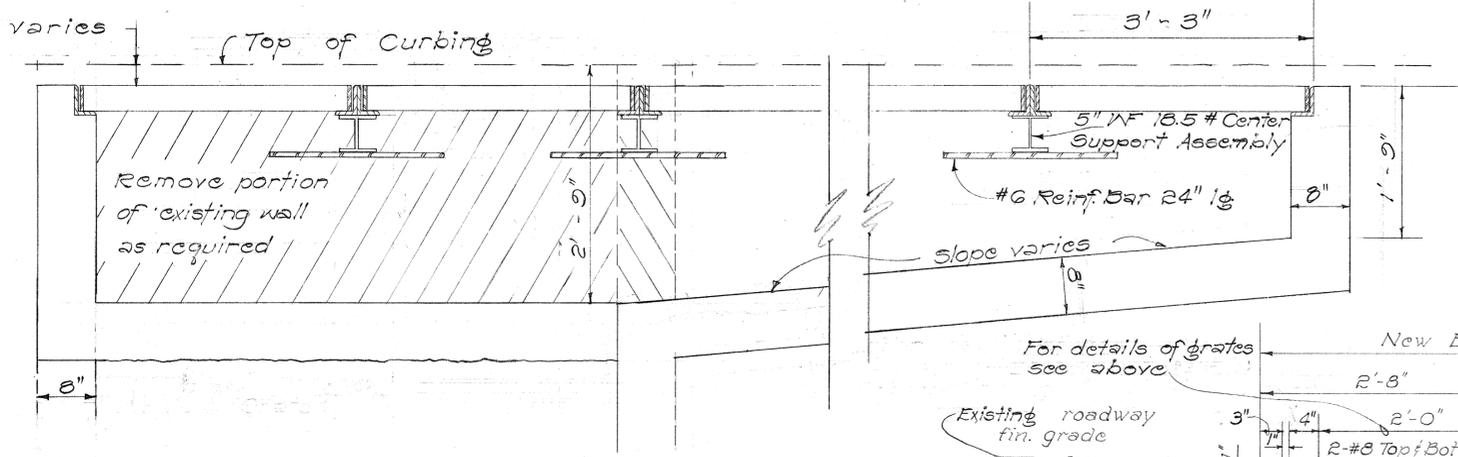


SECTION
 Scale: 1" = 1'-0"

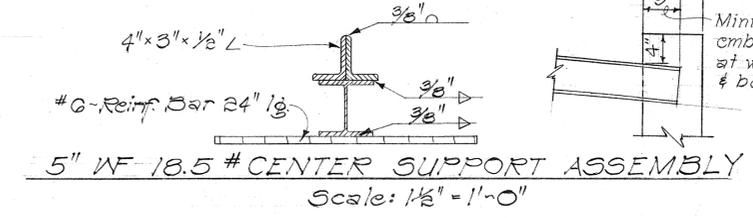

5" WF-18.5 # CENTER SUPPORT ASSEMBLY
 Scale: 1 1/2" = 1'-0"

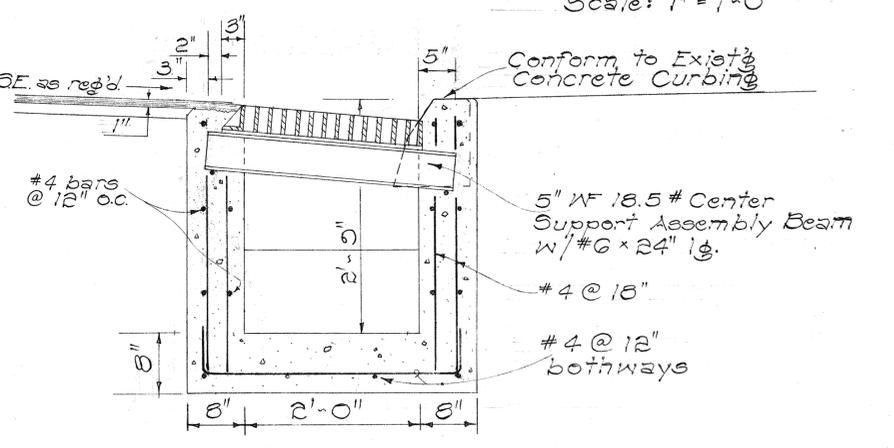

TYPICAL SECTION OF NEW C.B. WING
 Scale: 1" = 1'-0"

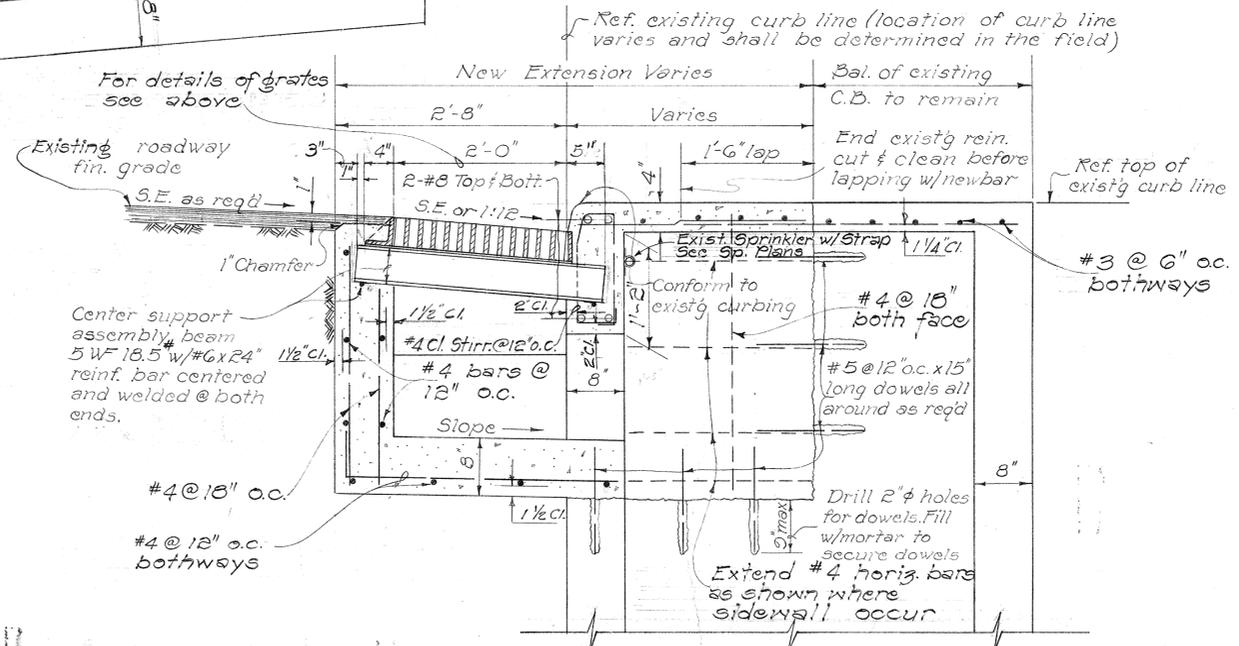

TYPICAL SECTION THRU MODIFIED C.B.
 Scale: 1" = 1'-0"


- NOTES:**
- Center Support Assembly shall be used when two or more Gratings are specified.
 - Center Support Assembly shall not be paid for separately but shall be considered as incidental to Type "S" Steel Frame and Grate.
 - All welds 3/8" unless noted otherwise.
 - Grate and Frame shall be hot dip galvanized after fabrication, see specifications.
 - The various materials shall conform to the specifications of ASTM as listed in the following tabulation and the Std. Specifications.

Material	ASTM Designation
Structural Steel	A283, Grade D
Cast Steel	A27, Grade G5-35
Malleable Iron Casting	A47, Grade No. 35018
 - Contractor has the option of using cast malleable iron, cast steel, welded, bolted, cast malleable iron and block or cast steel and block grate.
 - Frames & Grates shall have edges ground smooth.


STATE OF HAWAII
 DEPARTMENT OF TRANSPORTATION
 HIGHWAYS DIVISION
DRAINAGE DETAILS
 MODIFICATIONS OF C.B. WITH GRATED INLET WITHIN EXISTING GUTTER AND DETAILS OF TYPE "S" STEEL FRAME AND GRATES
 Safety Improvement
 Middle St. to Pali Hwy.
 F.A.I. Proj. No. I-H-1(112)-19
 Scale: As Noted Date: April, 1973
SHEET No. 54 OF 41 SHEETS

DATE
 SURVEY PLOTTED BY
 DRAWN BY
 DESIGNED BY
 CHECKED BY
 ORIGINAL PLAN
 NOTE BOOK
 No.


FED. ROAD DIST. NO.	STATE	FED. AID PROJ. NO.	FISCAL YEAR	SHEET NO.	TOTAL SHEETS
HAWAII	HAW.	I-HI-1(112):10	1973	56	176

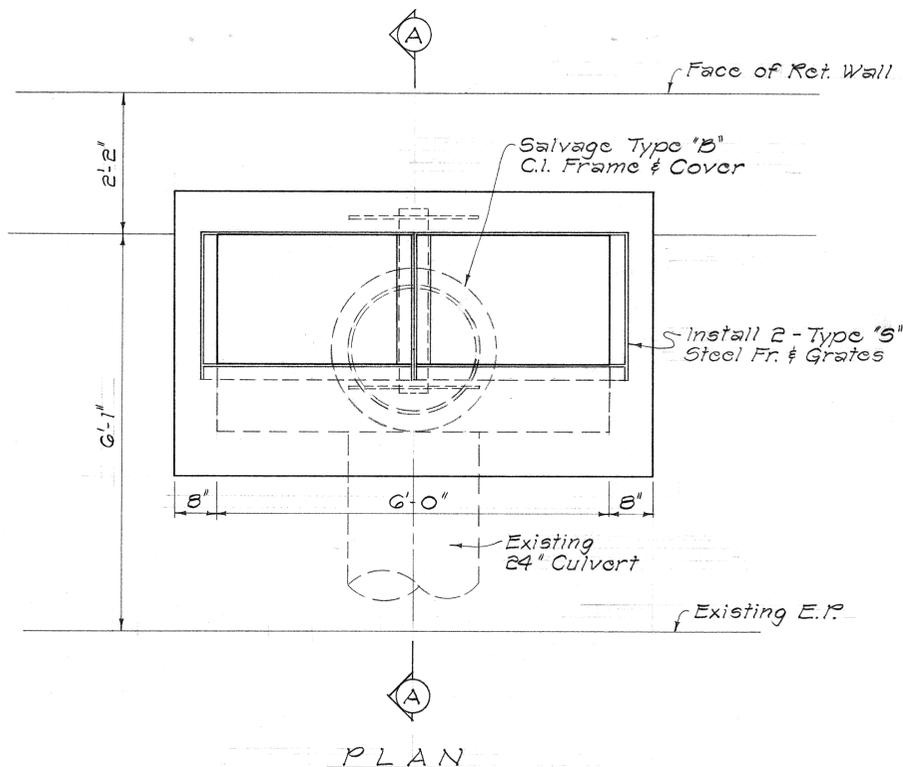

PLAN

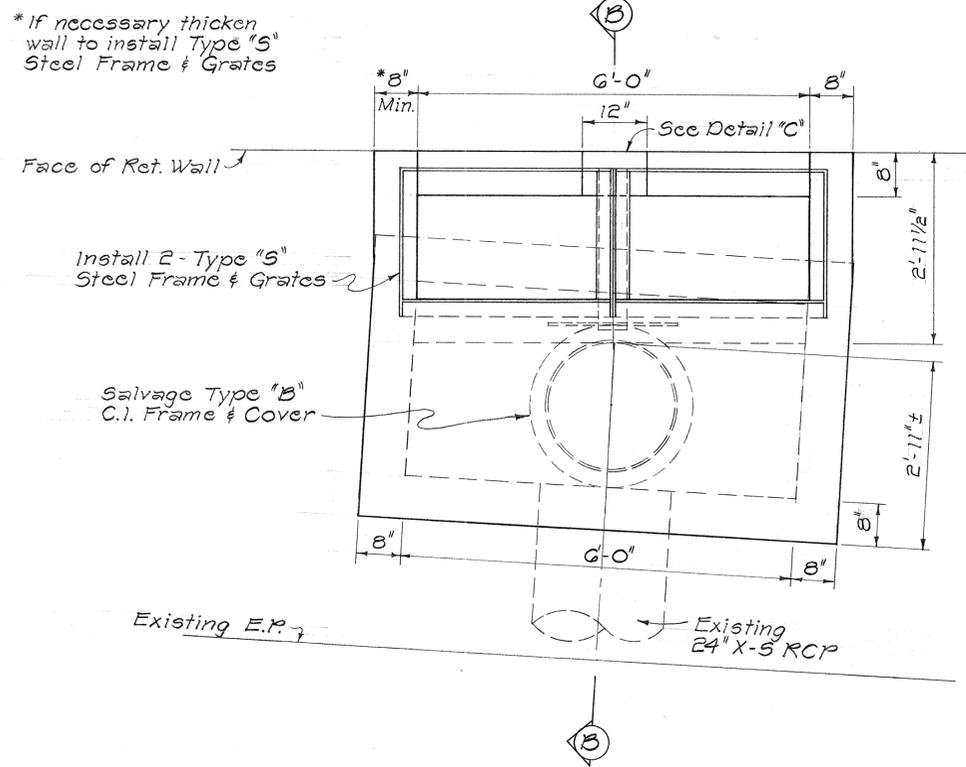


PLAN

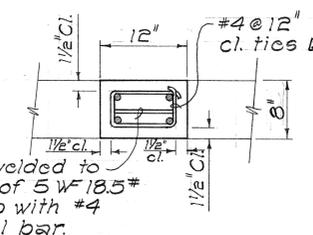


#6 welded to bottom of 5 W 18.5* and lap with #4 vertical bar.

DETAIL "C"
Scale: 1" = 1'-0"

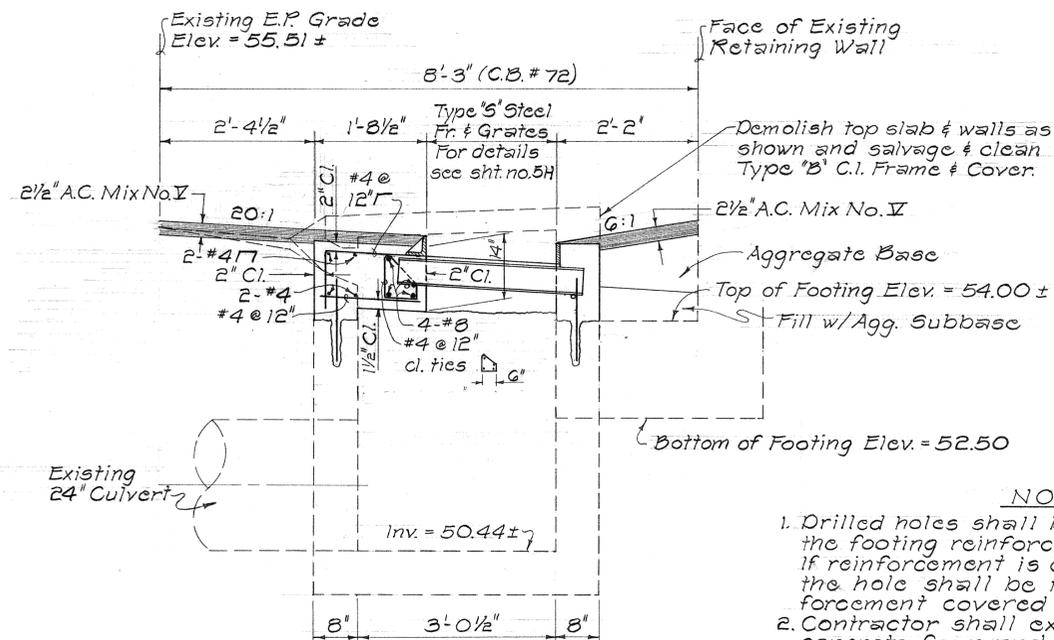

SECTION "A-A"

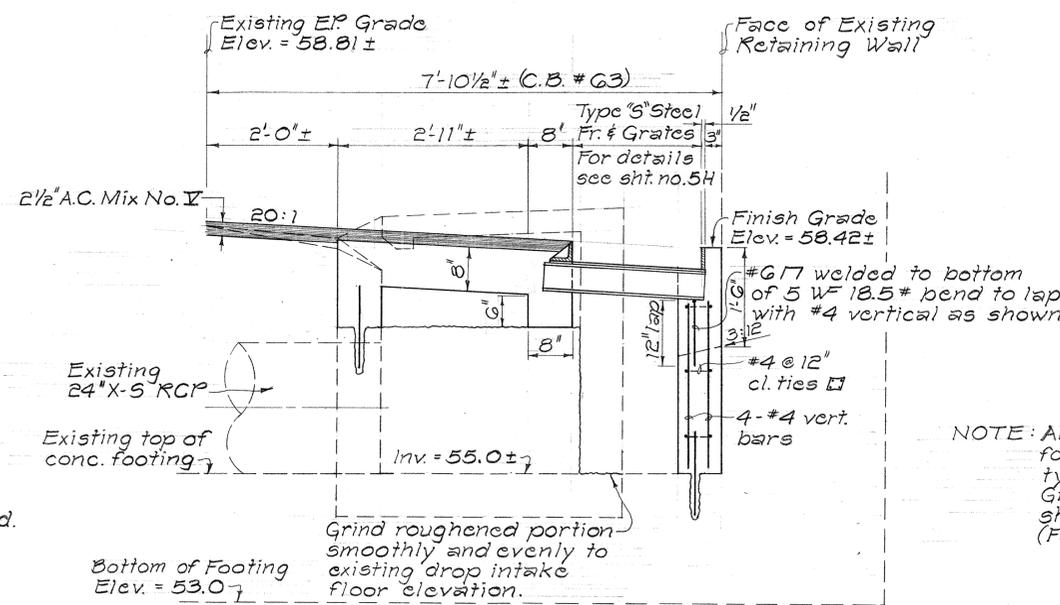

SECTION "B-B"

- NOTES**
1. Drilled holes shall be located such that the footing reinforcement will not be exposed. If reinforcement is encountered in drilling, the hole shall be relocated and the reinforcement covered with epoxy mortar.
 2. Contractor shall exercise care in removing concrete from and in the proximity of existing structures. Any damage to existing structures shall be repaired as directed by the Engineer and at the Contractor's expenses.
 3. Epoxy mortar shall be approved by the Engineer.

NOTE: All notes, dimensions and reinforcing layouts are similar to typical section for Type "S" Grated Drop Intake except as shown or noted on this sheet. (For details, see sht. no. 39H)




**DETAILS OF CATCH BASINS @
RAMP "K-G" STA. 9+50 (C.B. #72)
@ STA. 50+90 ± W.B. (C.B. #63)**

Scale: 3/4" = 1'-0"


DATE	APPROVED BY
DESIGNED BY	CHECKED BY
NO. OF SHEETS	

STATE OF HAWAII
DEPARTMENT OF TRANSPORTATION
HIGHWAYS DIVISION
DRAINAGE DETAILS
MODIFICATION OF CATCH BASIN
WITH TYPE "S" GRATED INLET
Safety Improvements
Kalini Street to Pali Highway
F.A.I. Proj. No. I-HI-1(112):10
Scale As Noted Date: Apr, 1973
SHEET No. GH OF 41 SHEETS

FED. ROAD DIST. NO.	STATE	FED. AID PROJ. NO.	FISCAL YEAR	SHEET NO.	TOTAL SHEETS
HAWAII	HAW.	I-HI-1(112)9	1973	57	176

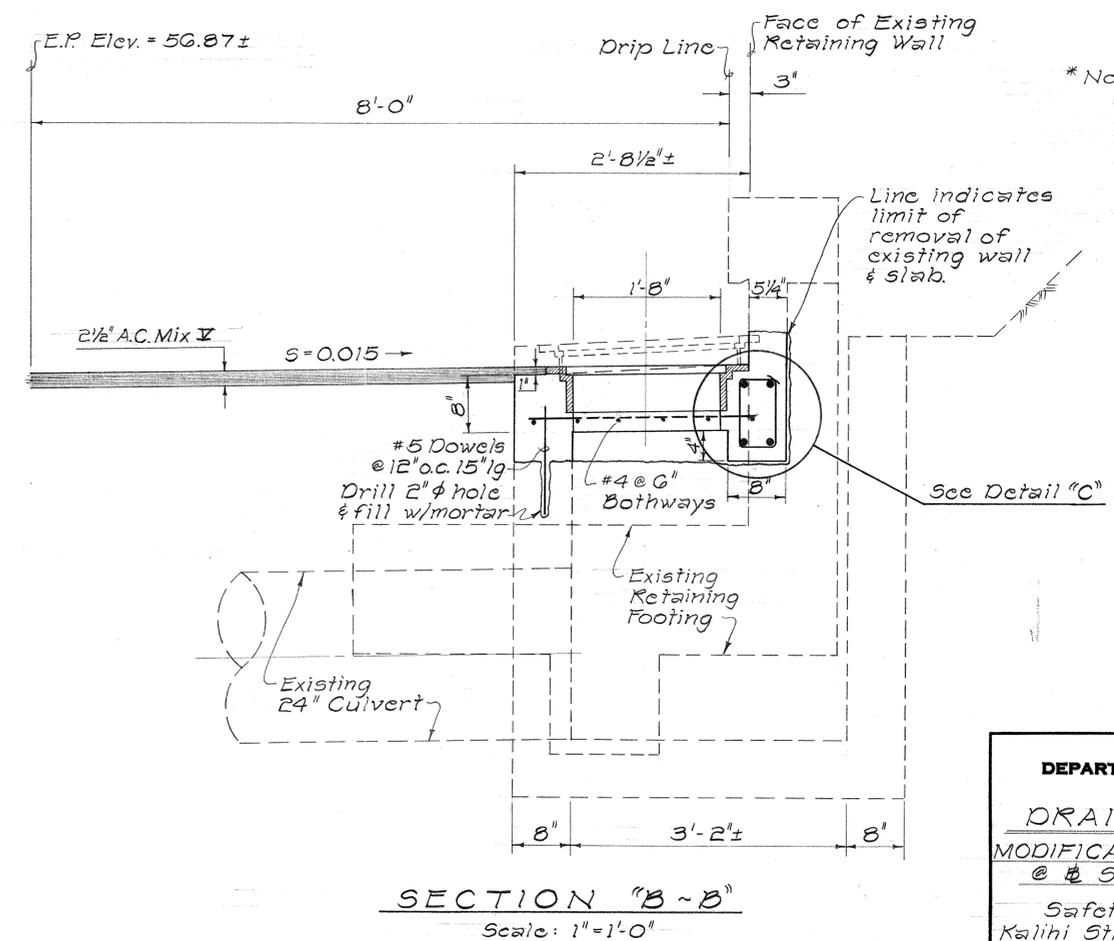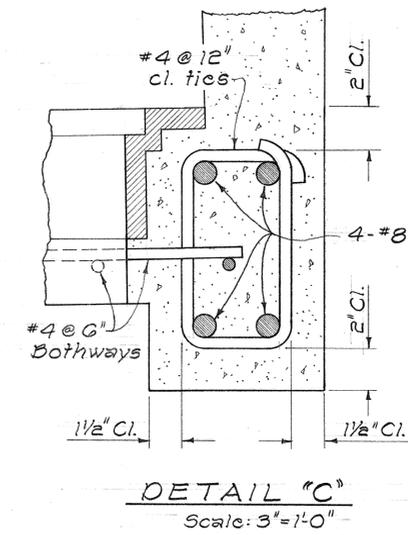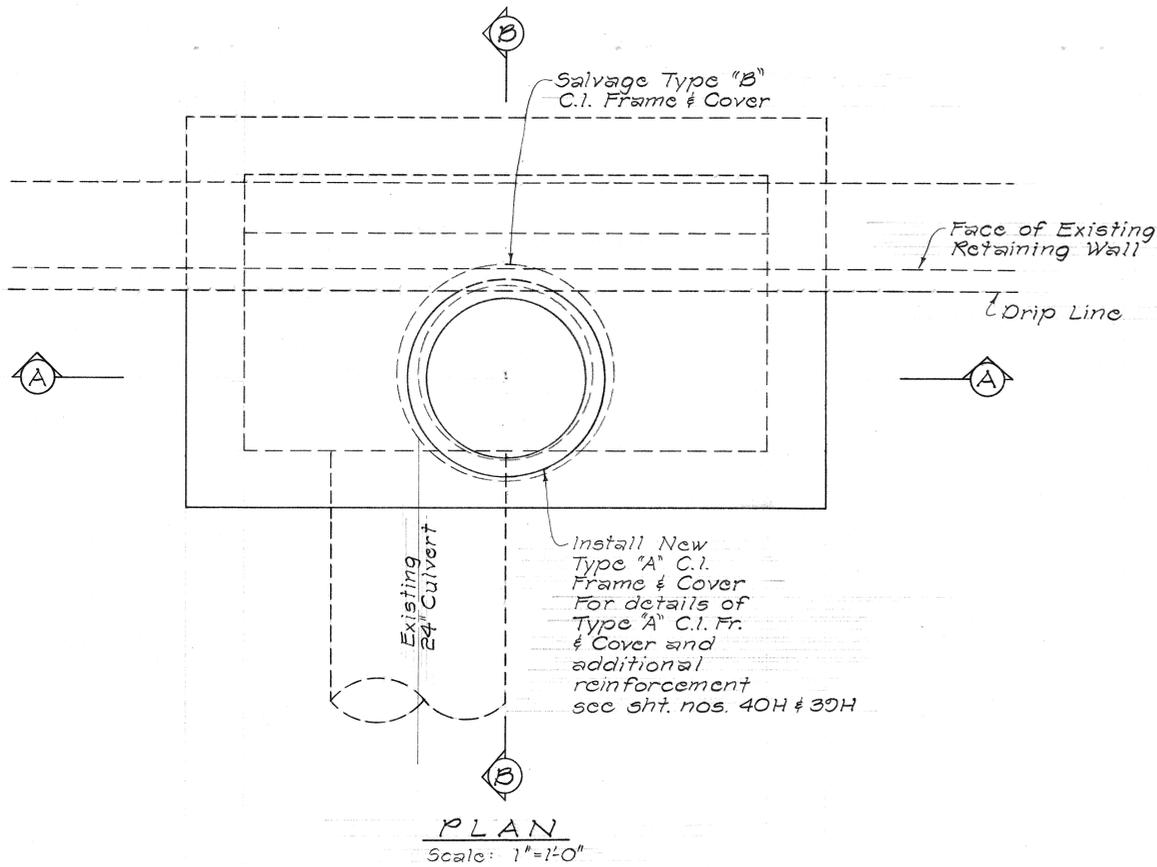

* Note:
At retaining wall section, all existing exposed reinforcing is to remain and be cleaned.

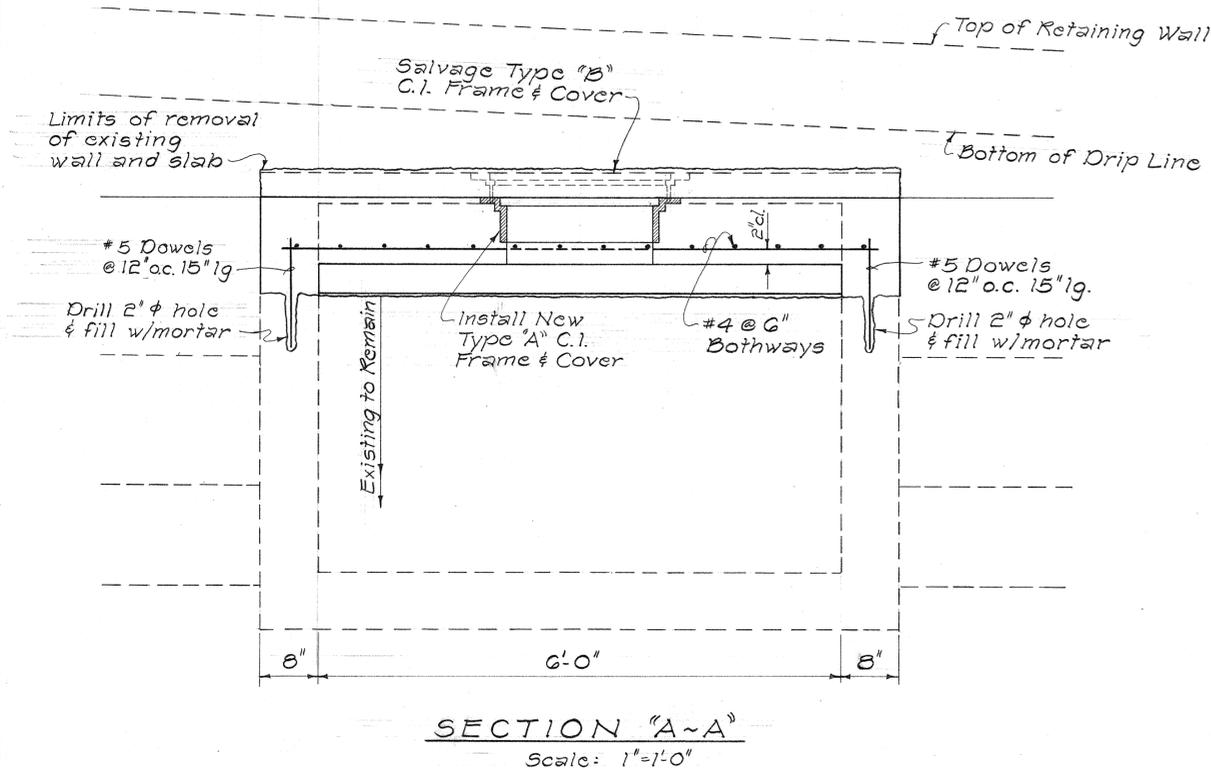

DETAILS OF C.B. @ STA. 56 + 04 W.B.

STATE OF HAWAII
DEPARTMENT OF TRANSPORTATION
HIGHWAYS DIVISION


DRAINAGE DETAILS
MODIFICATION OF CATCH BASIN
@ STA. 56 + 04 W.B.

Safety Improvements
Kalili Street to Fali Highway
F.A.I. Proj. No. I-HI-1(112): 19
Scale As Noted Date: April, 1973

SHEET No. 7H OF 41 HSHEETS


DESIGNED BY	DATE
DRAWN BY	
CHECKED BY	
IN CHARGE	
NO. 1	
NO. 2	
NO. 3	
NO. 4	
NO. 5	
NO. 6	
NO. 7	
NO. 8	
NO. 9	
NO. 10	
NO. 11	
NO. 12	
NO. 13	
NO. 14	
NO. 15	
NO. 16	
NO. 17	
NO. 18	
NO. 19	
NO. 20	

FED. ROAD DIST. NO.	STATE	FED. AID PROJ. NO.	FISCAL YEAR	SHEET NO.	TOTAL SHEETS
HAWAII	HAW.	I-HI-1(112):10	1973	50	170

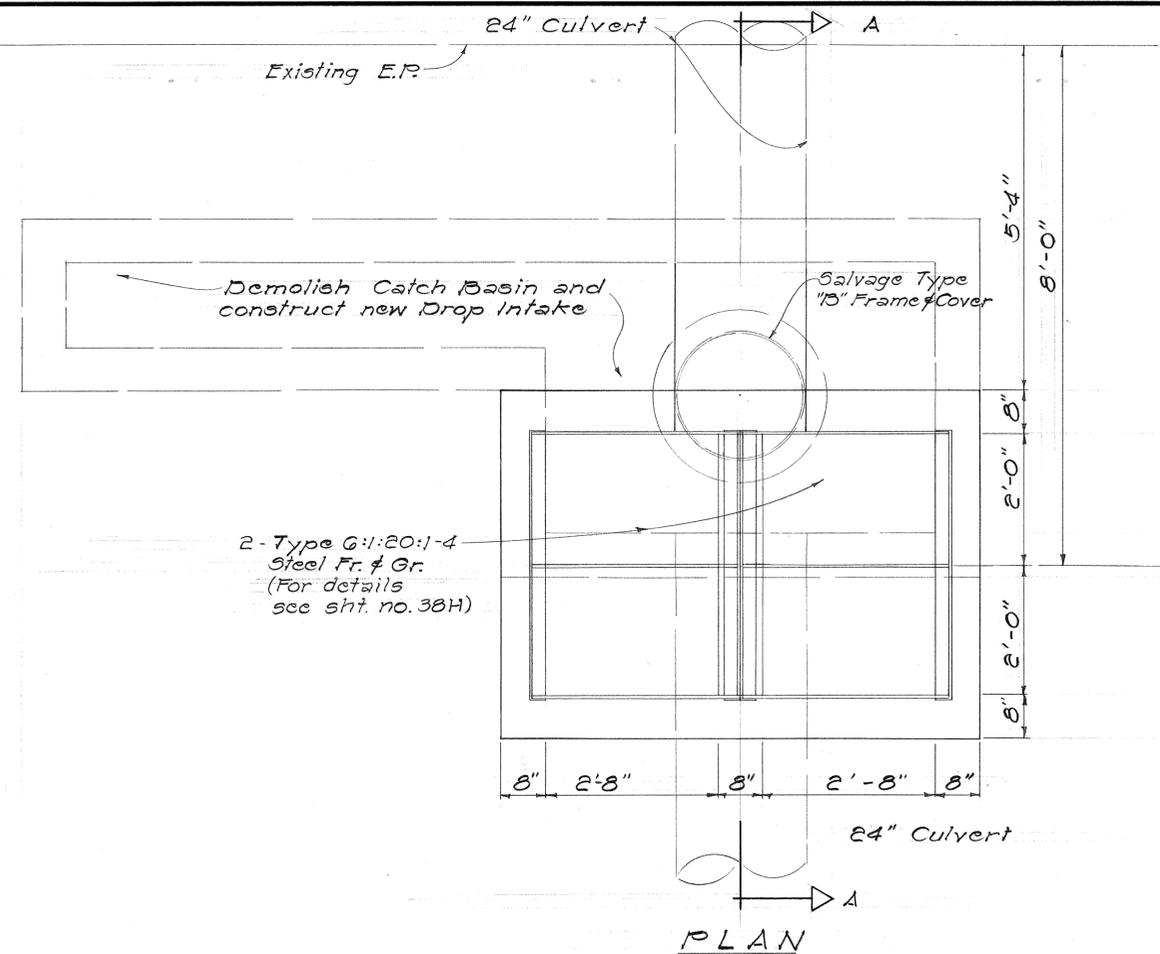


2 - Type G:1:20:1-4 Steel Fr. & Gr. (For details see sht. no. 38H)

PLAN

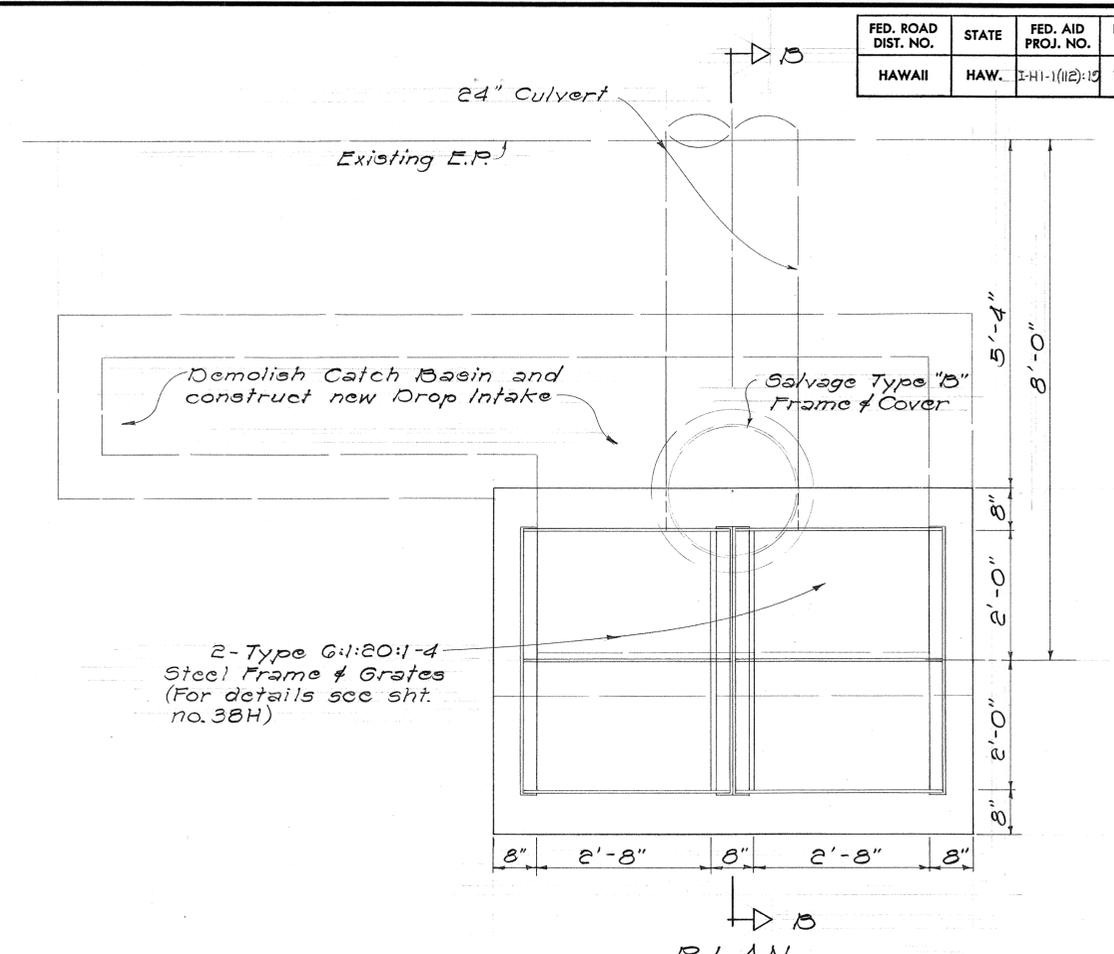


2 - Type G:1:20:1-4 Steel Frame & Grates (For details see sht. no. 38H)

PLAN

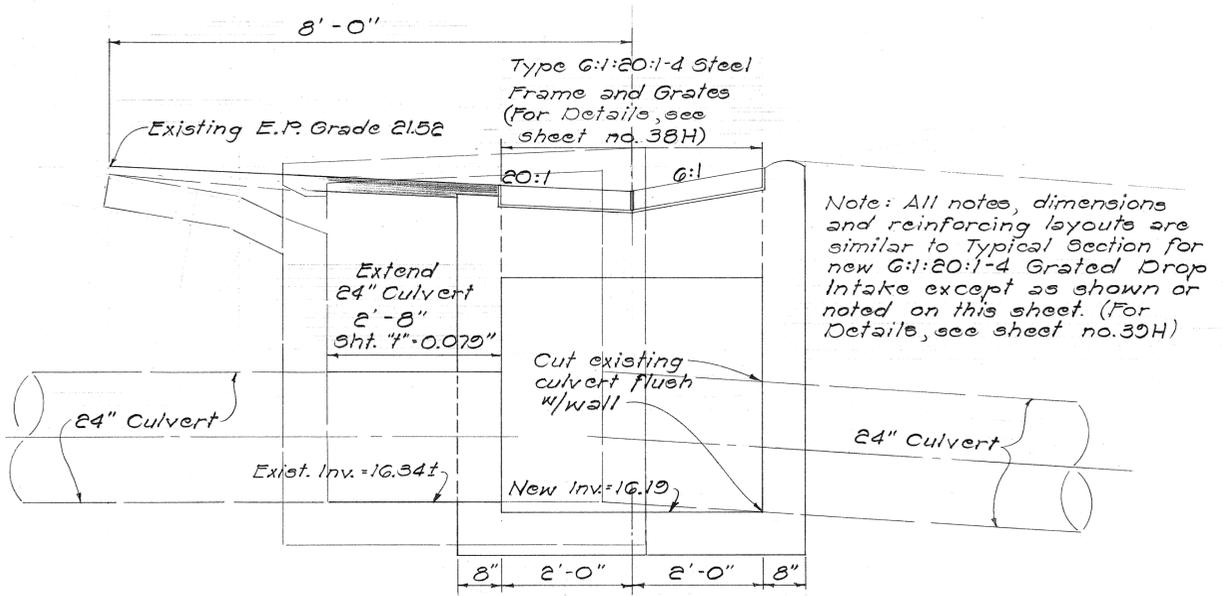

SECTION "A-A"

NEW G:1:20:1-4 GRATED DROP INTAKE AT STA. 70 + 75 E.B.

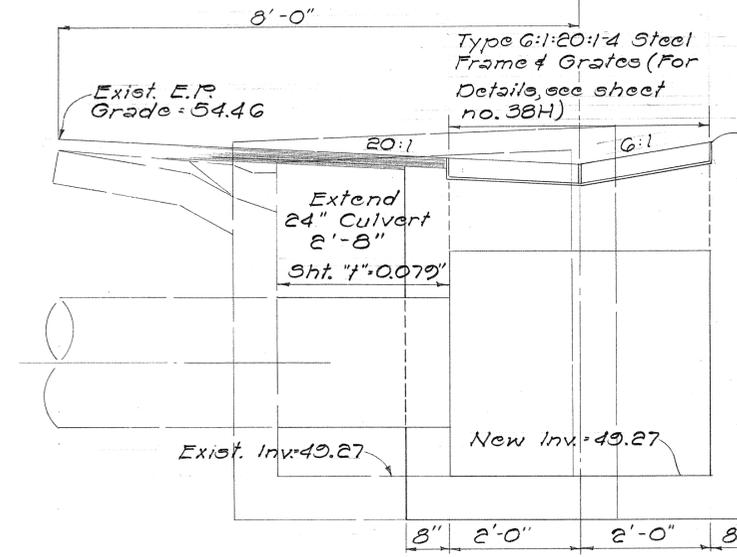

SECTION "B-B"

NEW G:1:20:1-4 GRATED DROP INTAKE @ RAMP "K-2" STA. 15 + 95

STATE OF HAWAII
DEPARTMENT OF TRANSPORTATION
HIGHWAYS DIVISION





DRAINAGE DETAILS
NEW G:1:20:1-4
GRATED DROP INTAKE

Safety Improvements
Kalihi Street to Pali Highway
F.A.I. Proj. No. I-HI-1(112):10
Scale: 3/4" = 1'-0" Date: Apr, 1973

SHEET No. 50 OF 41 SHEETS

DATE	BY
DESIGNED BY	BY
CHECKED BY	BY
QUANTITIES BY	BY
NOTE BOOK	BY
ORIGINAL PLAN	BY
SURVEY PLOTTED BY	BY

FED. ROAD DIST. NO.	STATE	FED. AID PROJ. NO.	FISCAL YEAR	SHEET NO.	TOTAL SHEETS
HAWAII	HAW.	I-HI-1(112)-10	1973	59	176

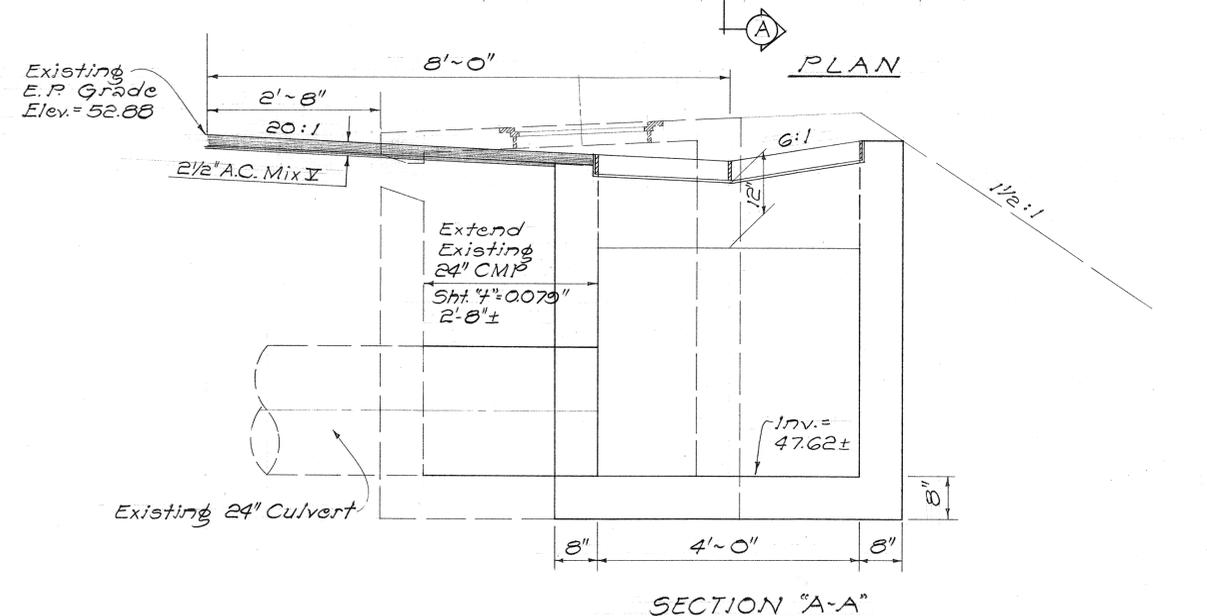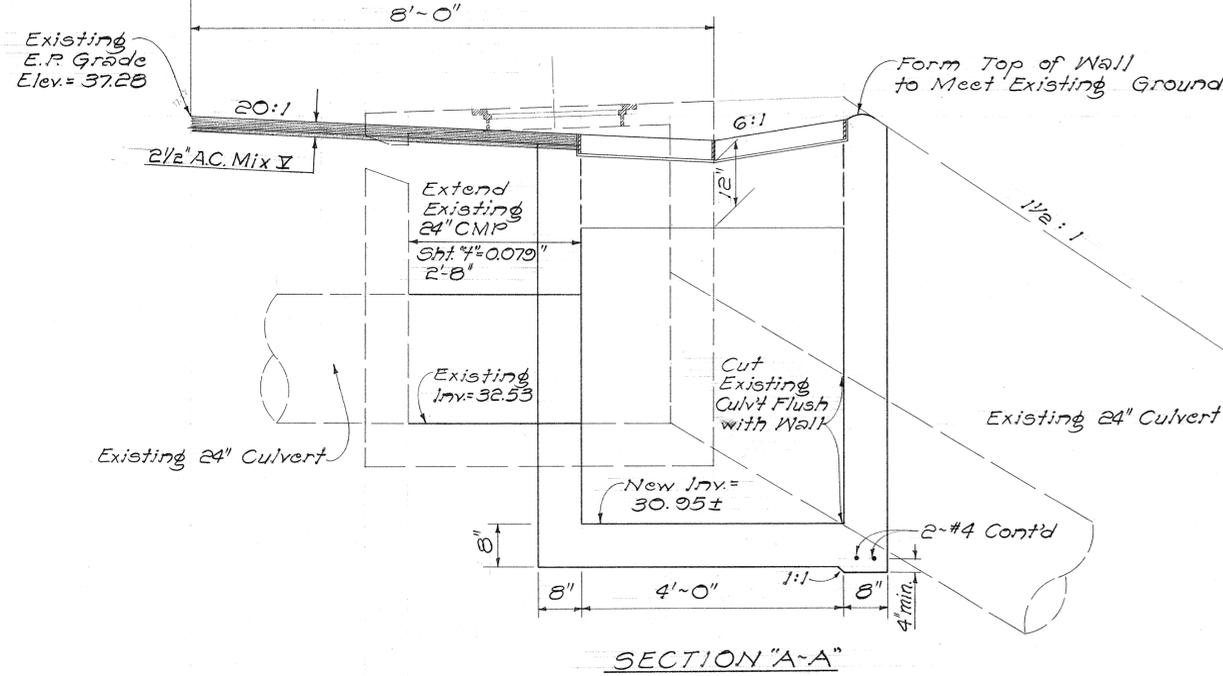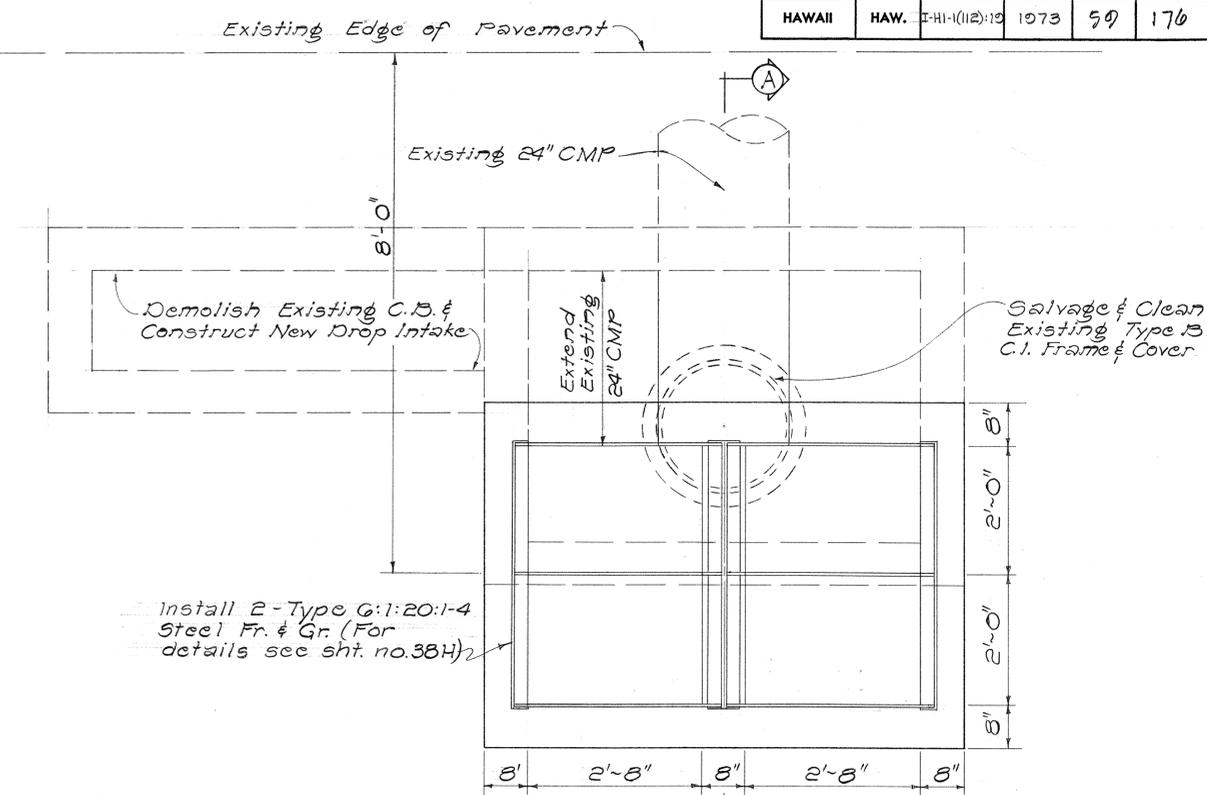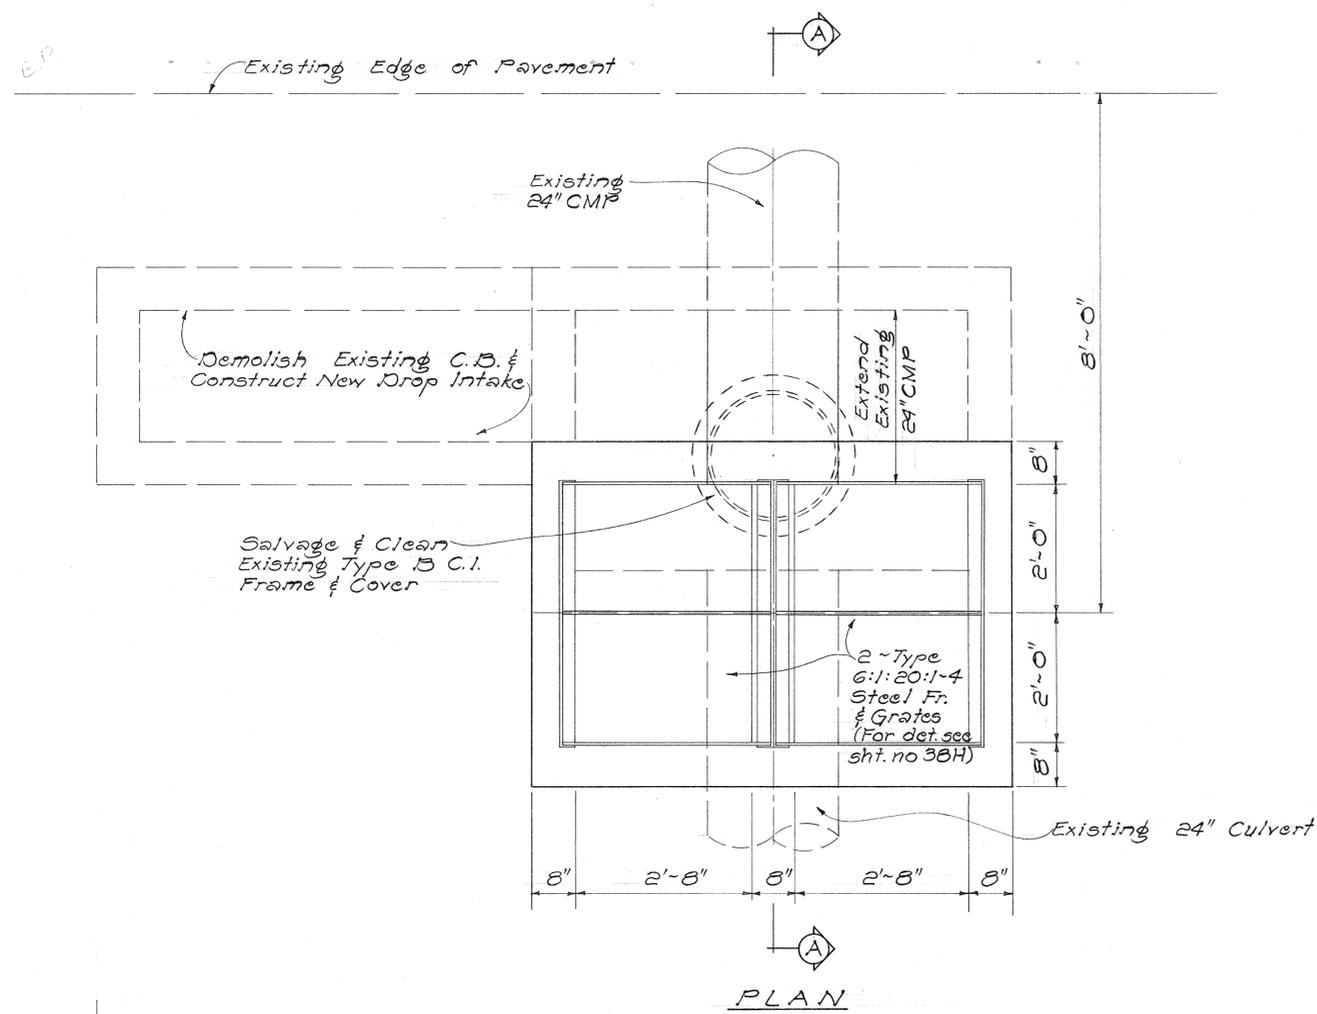

NOTE:
 Except as noted on this sheet, see typical section for notes, dimensions and reinforcing steel details for Type G:1:20:1-4 Grated Drop Intake on sht. no. 39H


STATE OF HAWAII
 DEPARTMENT OF TRANSPORTATION
 HIGHWAYS DIVISION
DRAINAGE DETAILS
NEW TYPE G:1:20:1-4
GRATED INLETS
 Safety Improvements
 Kalihi Street to Pali Highway
 F.A.I. Proj. No. I-HI-1(112)-10
 Scale: 3/4"=1'-0" Date: Apr, 1973
SHEET No. 59 OF 41 SHEETS

C.B. #11-F Sta. 67+25 E.B.


C.B. #2-F Ramp K-2 Sta. 18+16±

DATE	
SURVEY PLOTTED BY	
DESIGNED BY	
QUANTITIES BY	
CHECKED BY	
ORIGINAL PLAN	
NOTE BOOK	
No.	

FED. ROAD DIST. NO.	STATE	FED. AID PROJ. NO.	FISCAL YEAR	SHEET NO.	TOTAL SHEETS
HAWAII	HAW.	I-H-1(112)19	1973	60	176

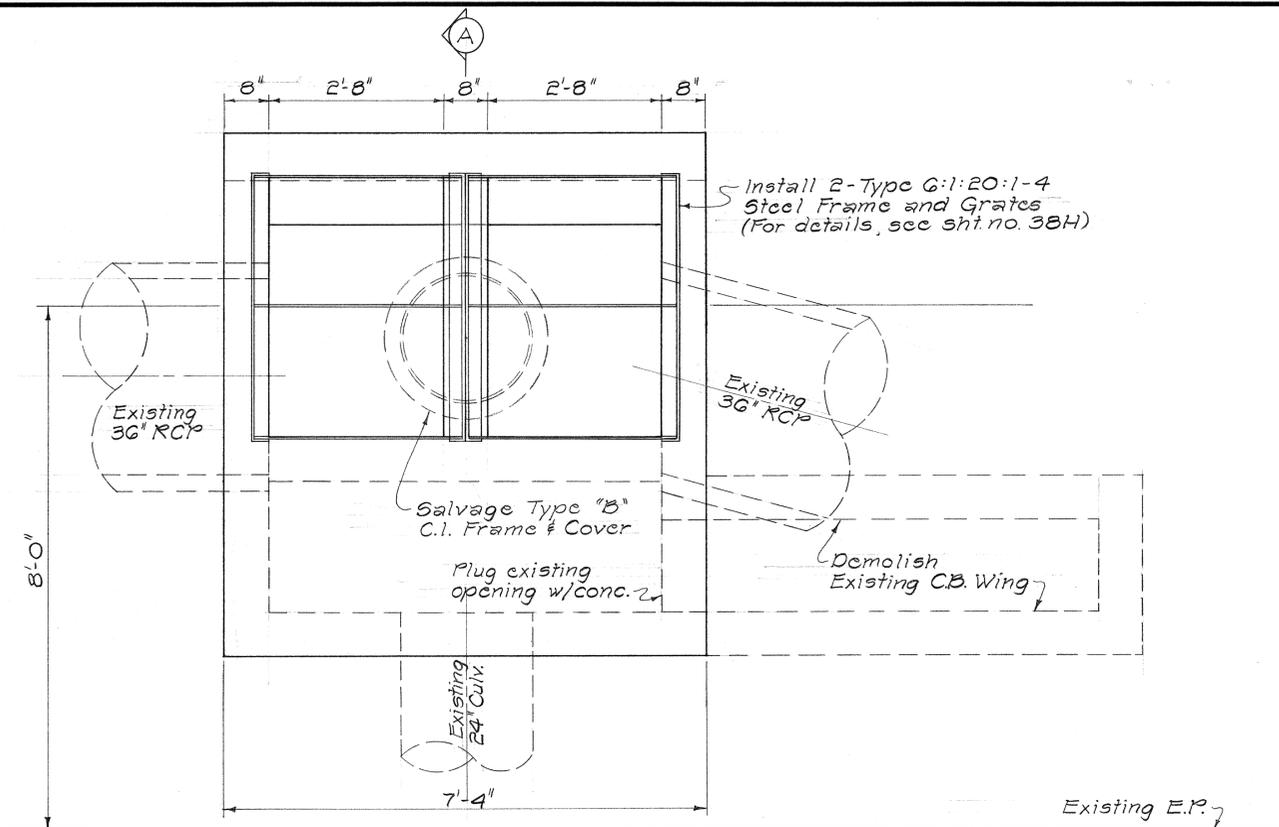


PLAN

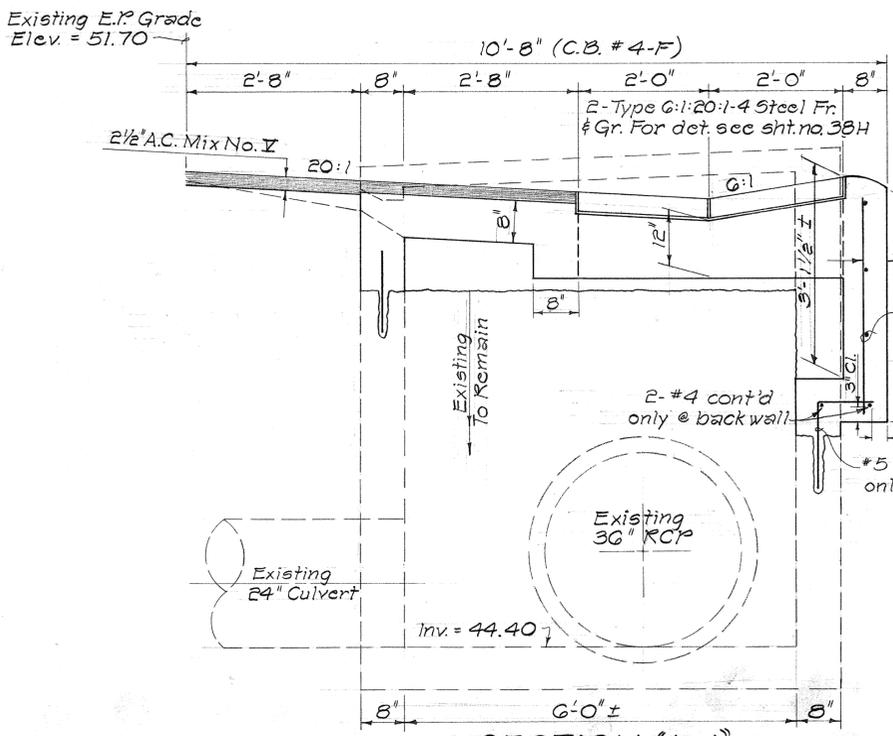


SECTION "A-A"

NOTE:
All notes, dimensions and reinforcing layouts are similar to typical section for G:1:20:1-4 Grated Drop Intake except as shown or noted on this sheet (For details, see sht. no. 38H)

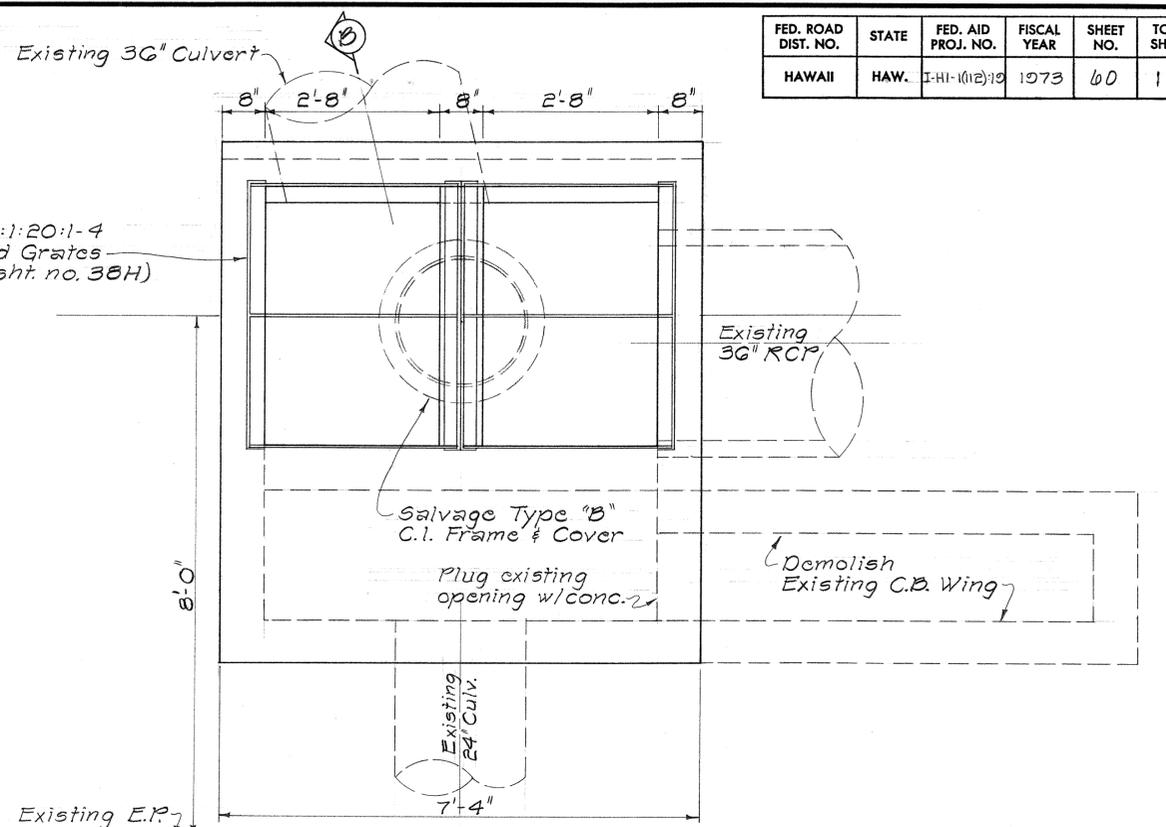

PLAN

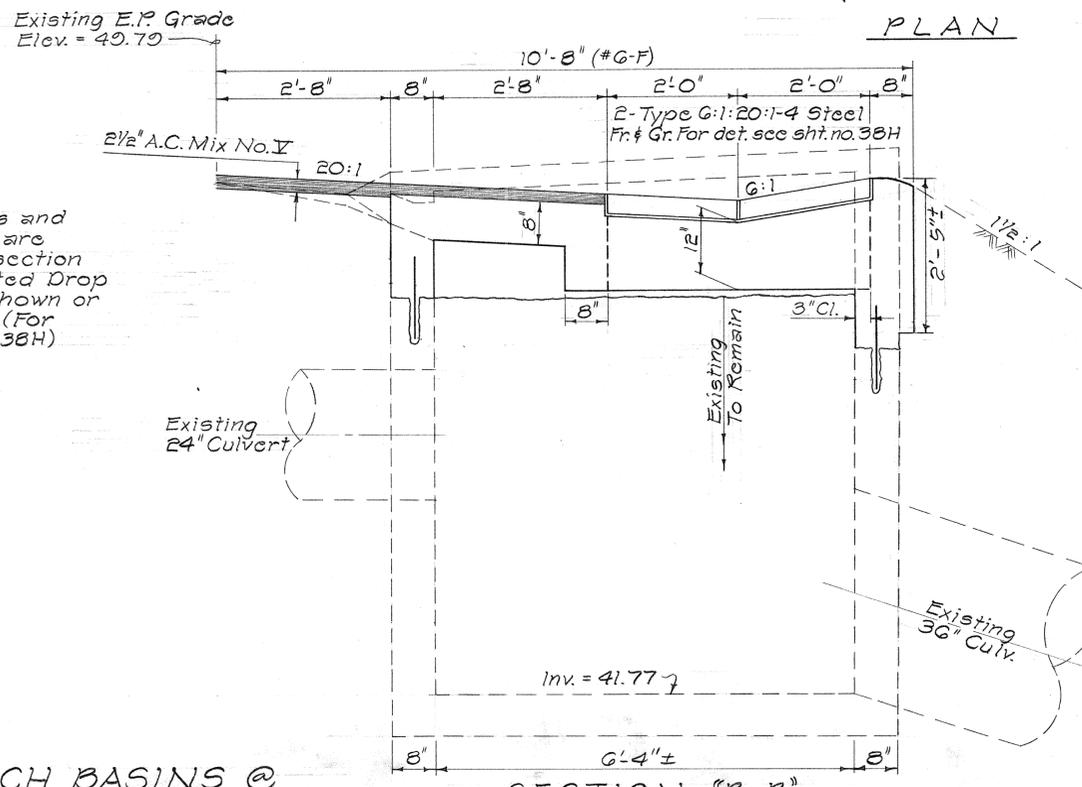

SECTION "B-B"



DETAILS OF CATCH BASINS @
 @ STA. 62 + 00 E.B. (C.B. #4-F)
 @ STA. 63 + 75 E.B. (C.B. #6-F)

Scale: 3/4" = 1'-0"

STATE OF HAWAII
DEPARTMENT OF TRANSPORTATION
HIGHWAYS DIVISION
DRAINAGE DETAILS
MODIFICATION OF CATCH BASINS
WITH TYPE G:1:20:1-4
GRATED INLET
 Safety Improvements
 Kalihi Street to Pali Highway
 F.A.I. Proj. No. I-H-1(112):19
 Scale: 3/4"=1'-0" Date: Apr., 1973
SHEET No. 10H OF 41H SHEETS


DATE	BY
DESIGNED BY	
DRAWN BY	
CHECKED BY	
NOTED BY	
ORIGINAL PLAN	
NO. BOOK	
NO.	

FED. ROAD DIST. NO.	STATE	FED. AID PROJ. NO.	FISCAL YEAR	SHEET NO.	TOTAL SHEETS
HAWAII	HAW.	I-HI-1(112)-10	1973	61	176

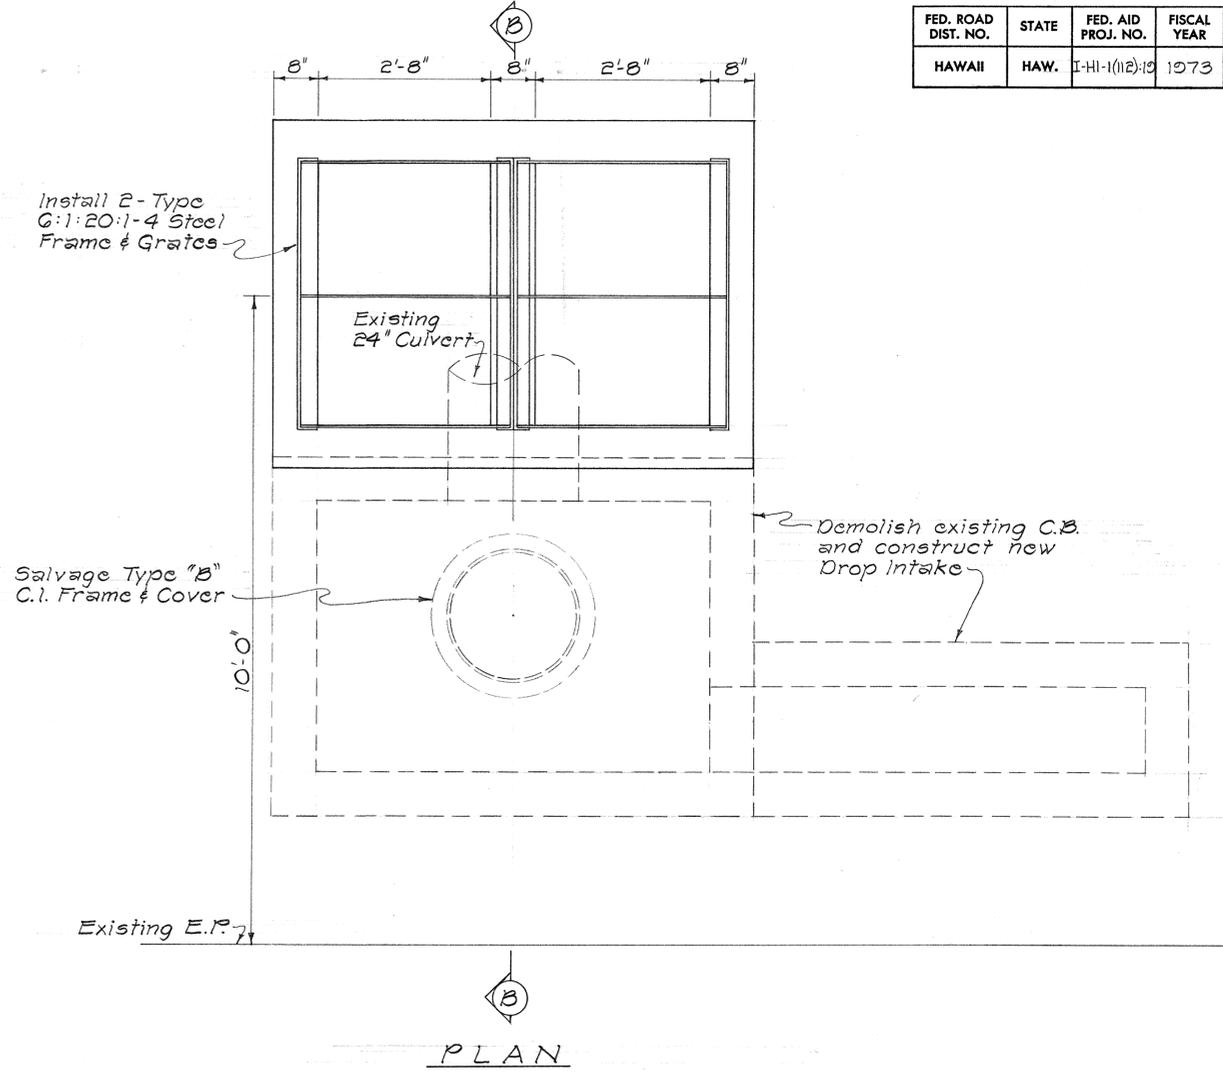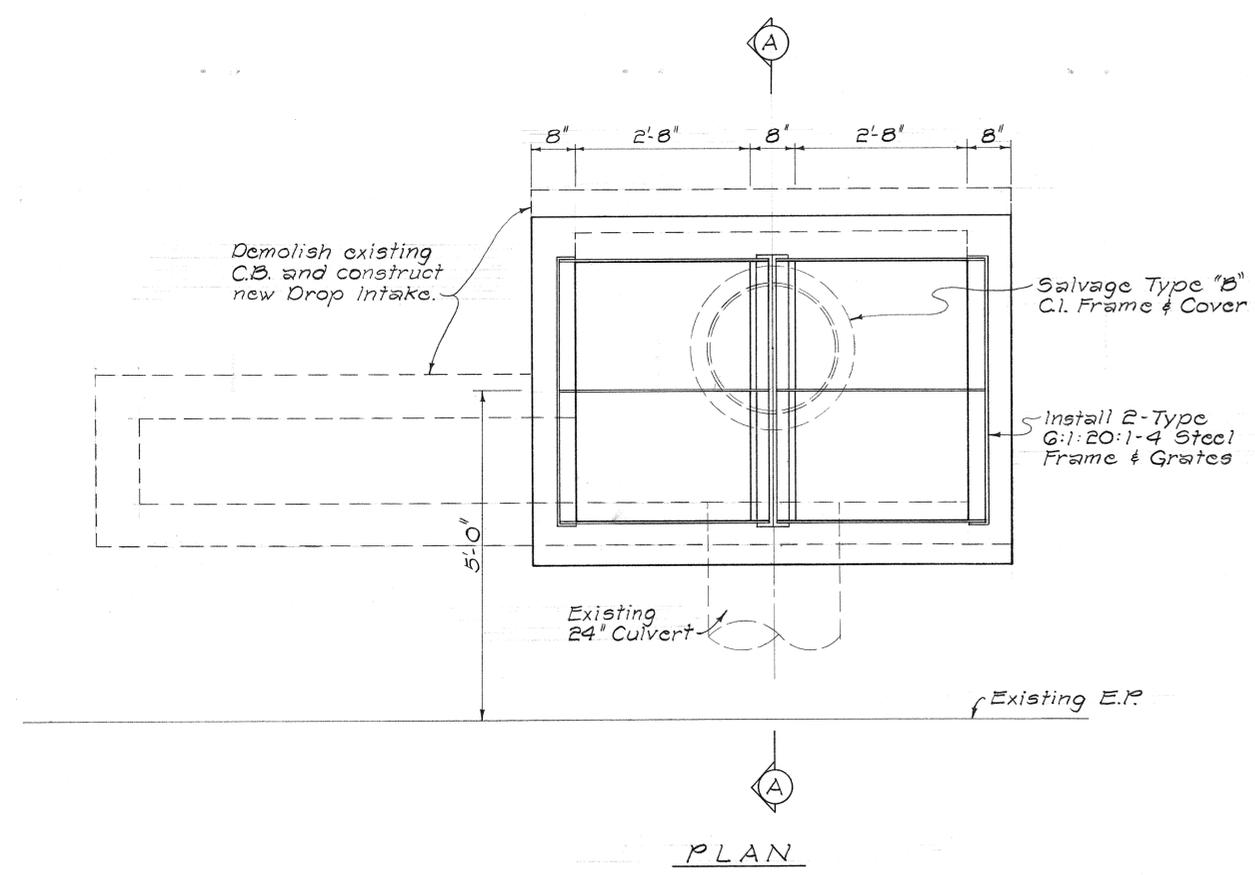


PLAN

PLAN

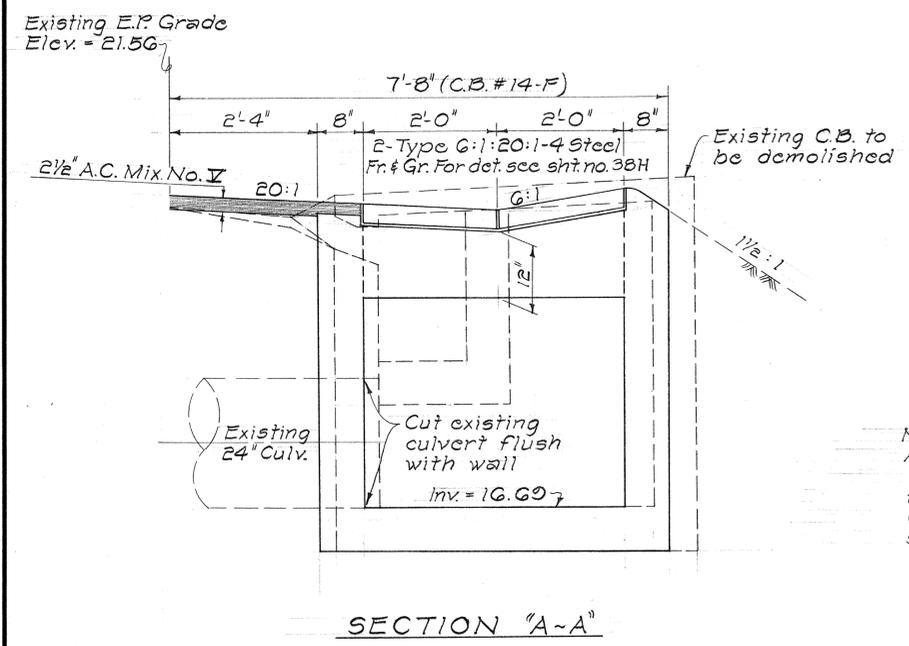

SECTION "A-A"

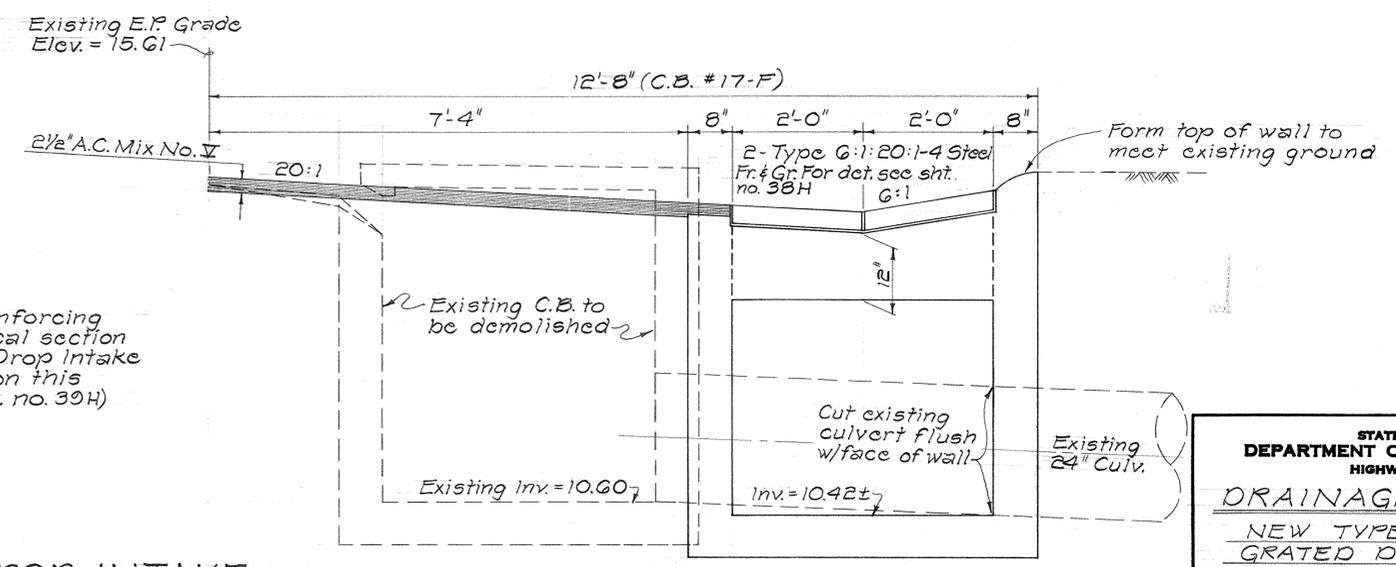

SECTION "B-B"


NOTE:
All notes, dimensions and reinforcing layouts are similar to typical section for new G:1:20:1-4 Grated Drop Intake except as shown or noted on this sheet. (For details, see sht. no. 39H)

NEW G:1:20:1-4 GRATED DROP INTAKE
 @ STA. 70 + 75 W.B. (C.B. #14-F)
 @ STA. 73 + 25 E.B. (C.B. #17-F)
 Scale: 3/4" = 1'-0"


STATE OF HAWAII
 DEPARTMENT OF TRANSPORTATION
 HIGHWAYS DIVISION
DRAINAGE DETAILS
 NEW TYPE G:1:20:1-4
 GRATED DROP INTAKE
 Safety Improvements
 Kalihi Street to Pali Highway
 F.A.I. Proj. No. I-HI-1(112)-10
 Scale: 3/4" = 1'-0" Date: Apr, 1973
SHEET No. 114 OF 41 SHEETS

DATE	
SURVEY PLOTTED BY	
DRAWN BY	
DESIGNED BY	
CHECKED BY	
ORIGINAL PLAN	
NOTE BOOK	
No.	


FED. ROAD DIST. NO.	STATE	FED. AID PROJ. NO.	FISCAL YEAR	SHEET NO.	TOTAL SHEETS
HAWAII	HAW.	I-HI-1(112):10	1973	62	176

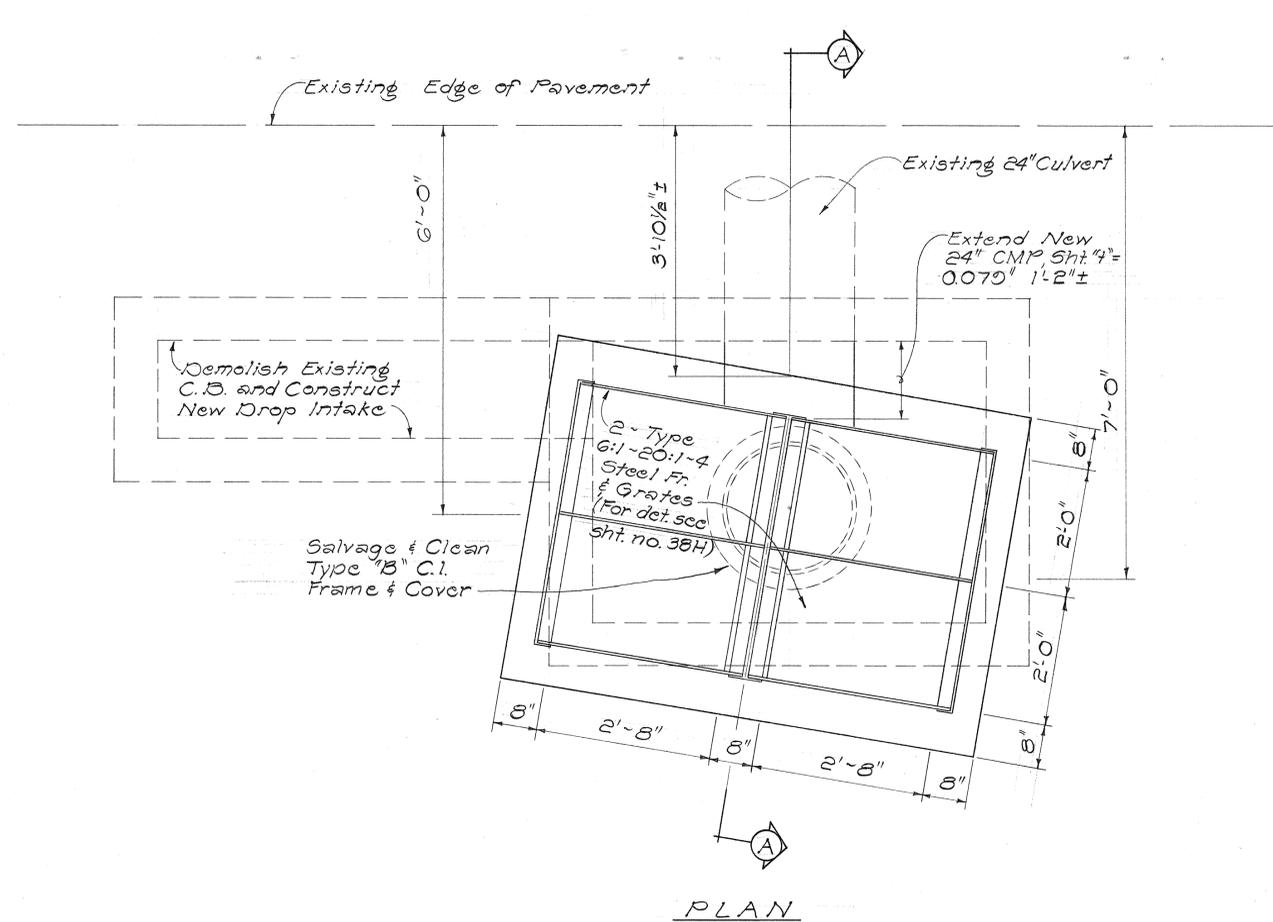

PLAN

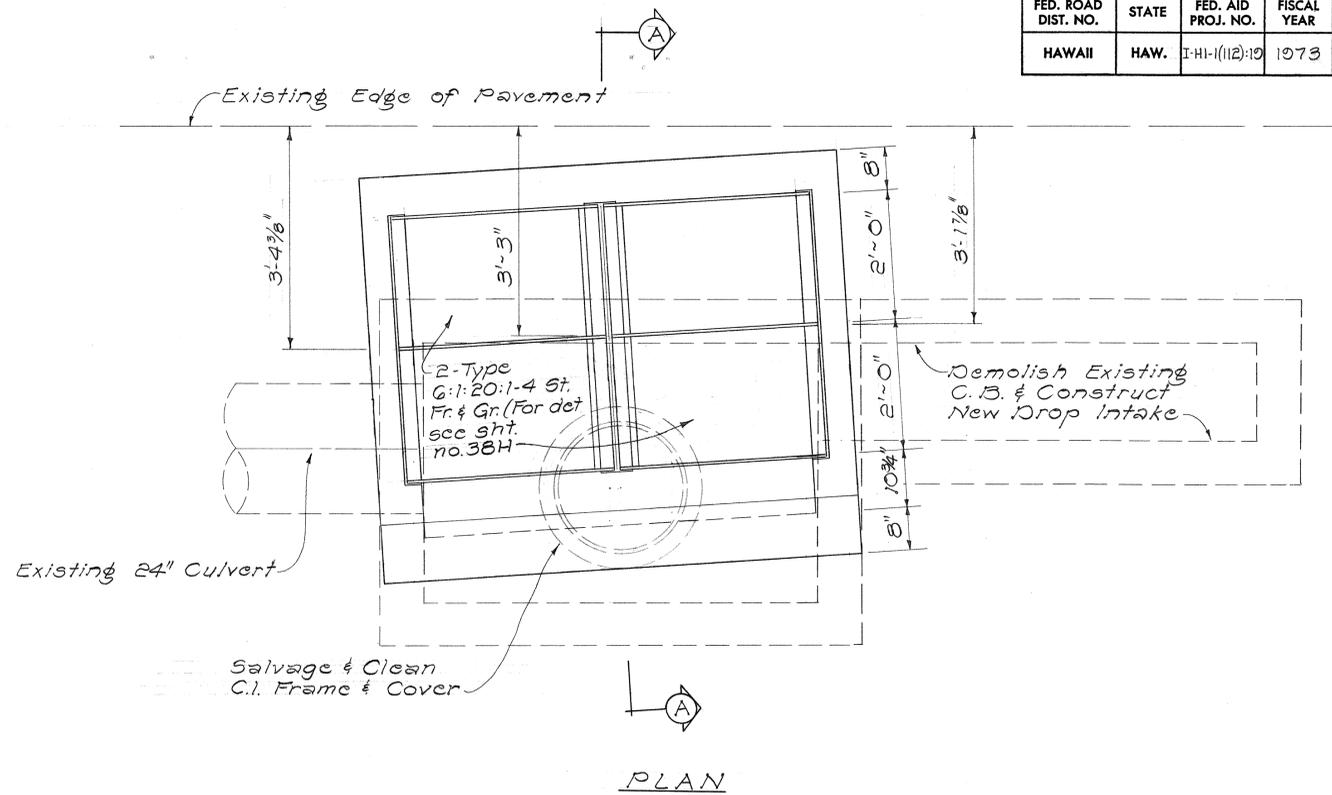


PLAN

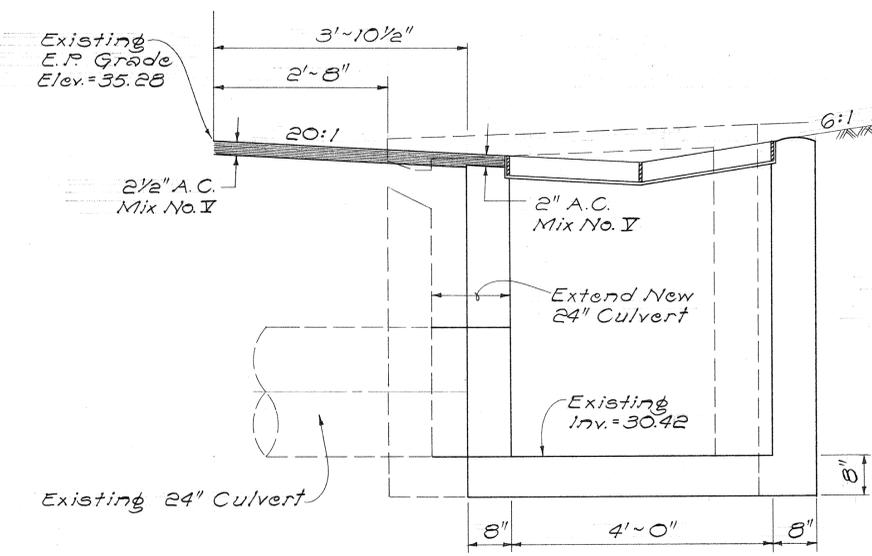

SECTION "A-A"

C.B. #42-F STA. 89+00 W.B.

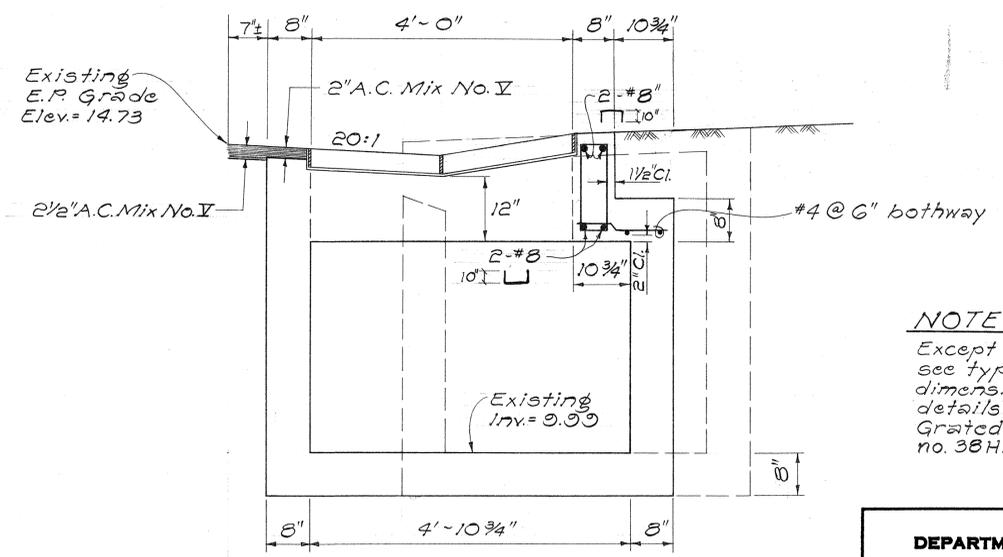

SECTION "A-A"

C.B. #18-F 'R-1' STA. 2+10

DATE	_____
DESIGNED BY	_____
CHECKED BY	_____
NO. _____	_____



STATE OF HAWAII
DEPARTMENT OF TRANSPORTATION
HIGHWAYS DIVISION

DRAINAGE DETAILS
NEW G:1-20:1-4
GRADED DROP INTAKE



Safety Improvements
Kalihii Street to Pali Highway
F.A.I. Proj. No. I-HI-1(112):10
Scale: 3/4" = 1'-0" Date: April, 1973

SHEET No. 124 OF 414 SHEETS

FED. ROAD DIST. NO.	STATE	FED. AID PROJ. NO.	FISCAL YEAR	SHEET NO.	TOTAL SHEETS
HAWAII	HAW.	I-HI-1(112):10	1973	63	176

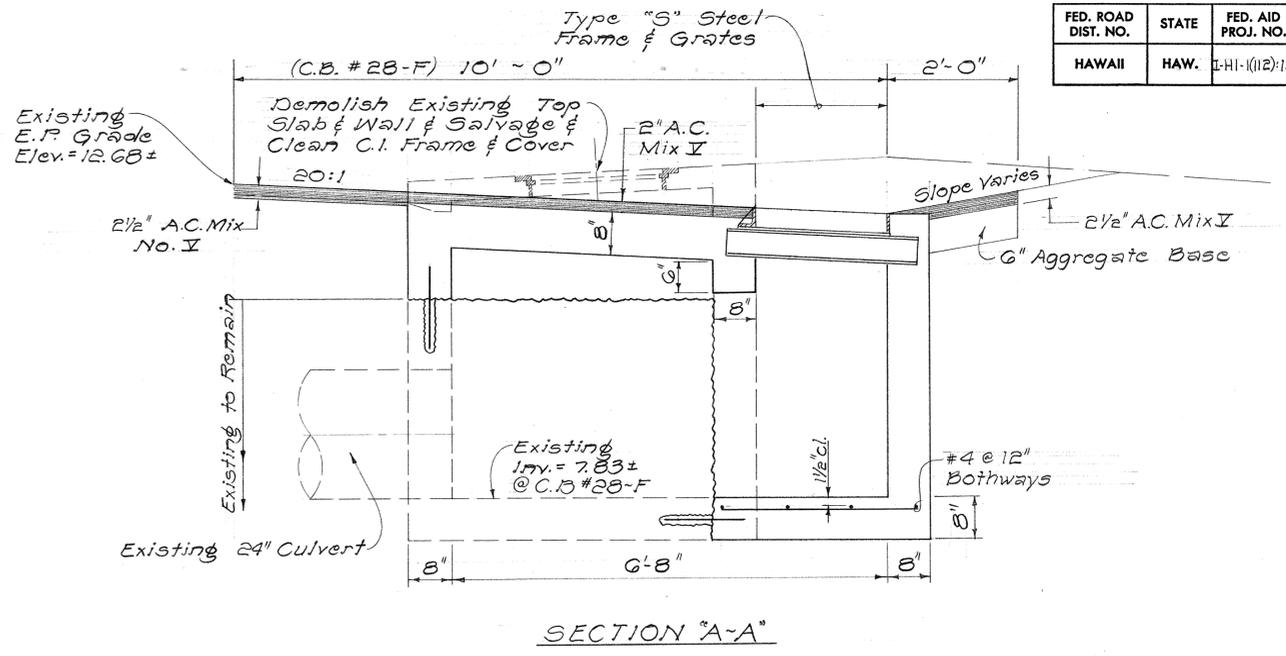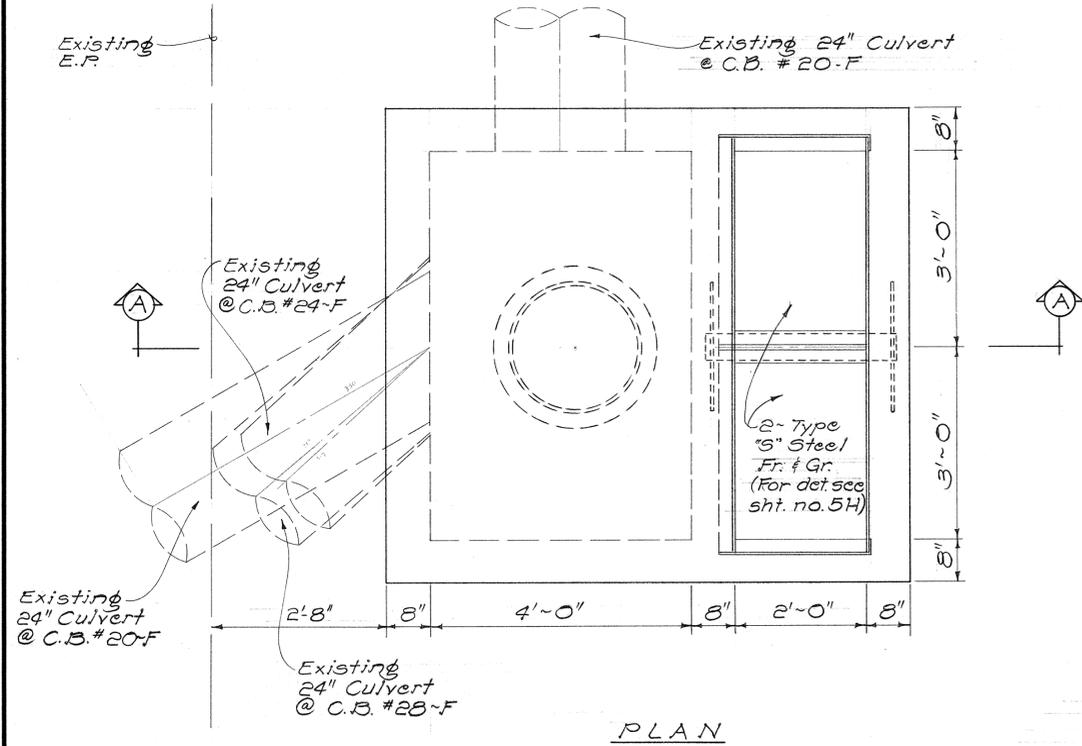

NOTE:
 All notes, dimensions and reinforcing layouts are similar to typical section for Type "S" Grated Drop Intake except as shown or noted on this sheet (For details, see sht. no. 39H)




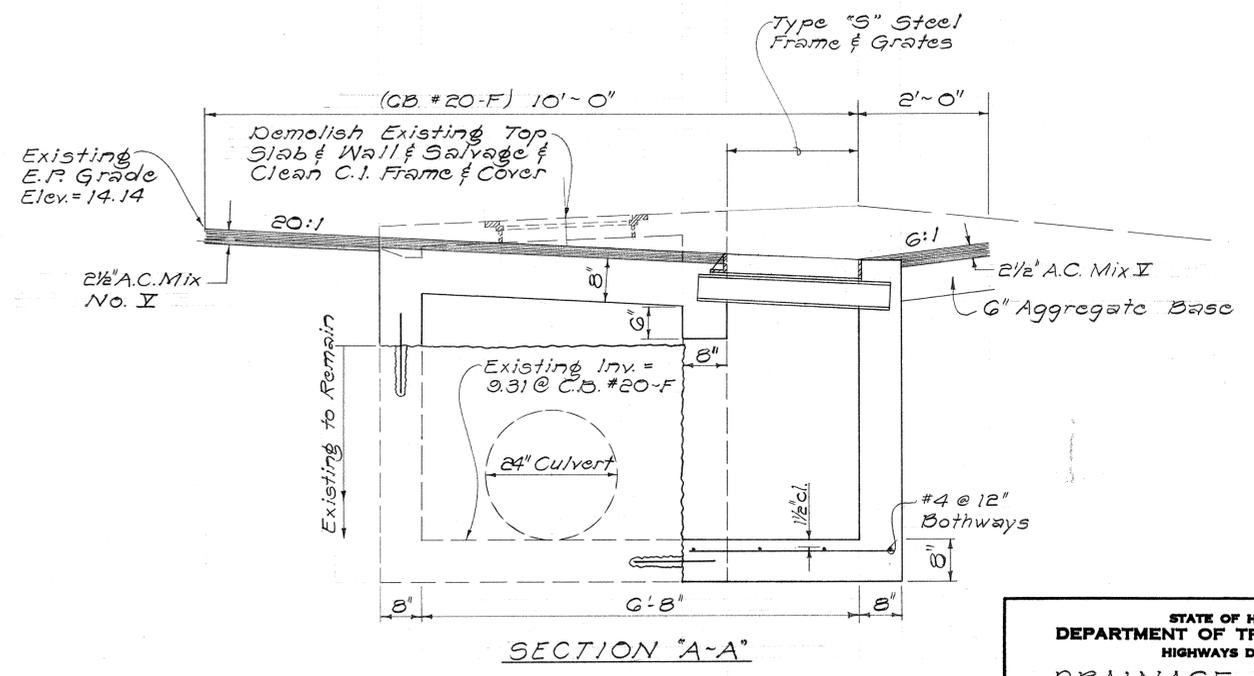
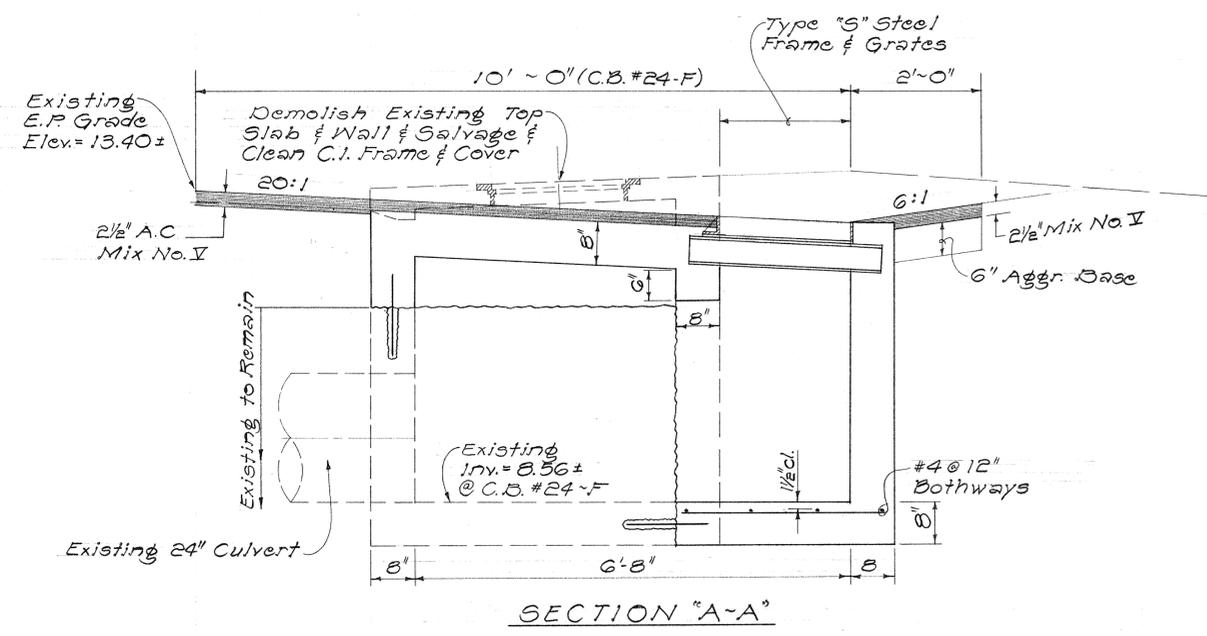


DETAILS OF CATCH BASINS AT
 STA. 77+00 W.B. (C.B. #24-F)
 STA. 78+80 (C.B. #28-F)
 STA. 0+45 R-1 (C.B. #20-F)

STATE OF HAWAII
 DEPARTMENT OF TRANSPORTATION
 HIGHWAYS DIVISION
DRAINAGE DETAILS
 MODIFICATIONS OF CATCH BASINS WITH TYPE "S" GRATED INLET
 Safety Improvements
 Kalihi Street to Pali Highway
 F.A.I. Proj. No. I-HI-1(112):10
 Scale: 3/4" = 1'-0" Date: Apr. 1973
SHEET No. 13H OF 41 H SHEETS

DATE	
DESIGNED BY	
CHECKED BY	
NO. 1	

FED. ROAD DIST. NO.	STATE	FED. AID PROJ. NO.	FISCAL YEAR	SHEET NO.	TOTAL SHEETS
HAWAII	HAW.	I-HI-1(112)12	1973	64	176

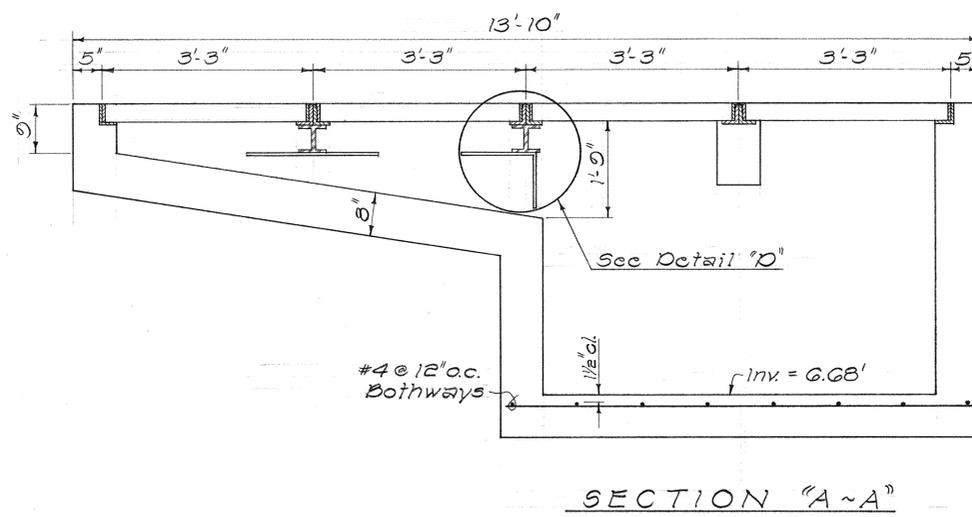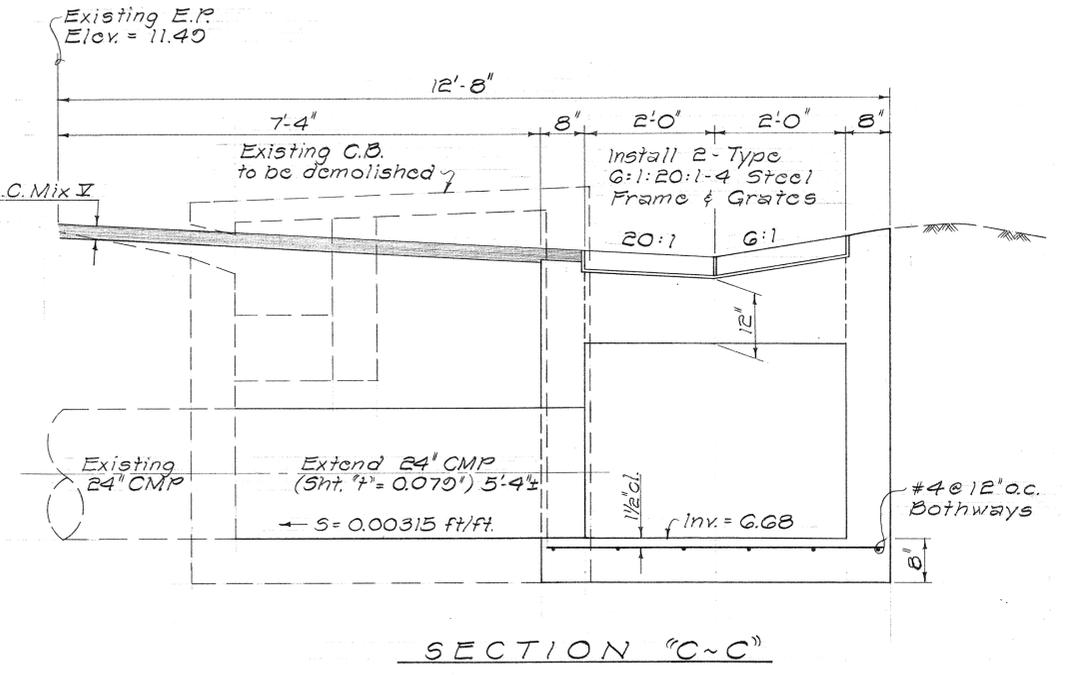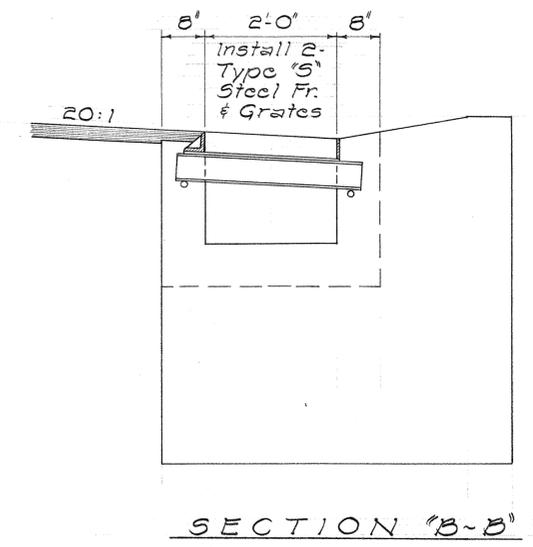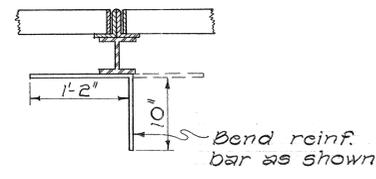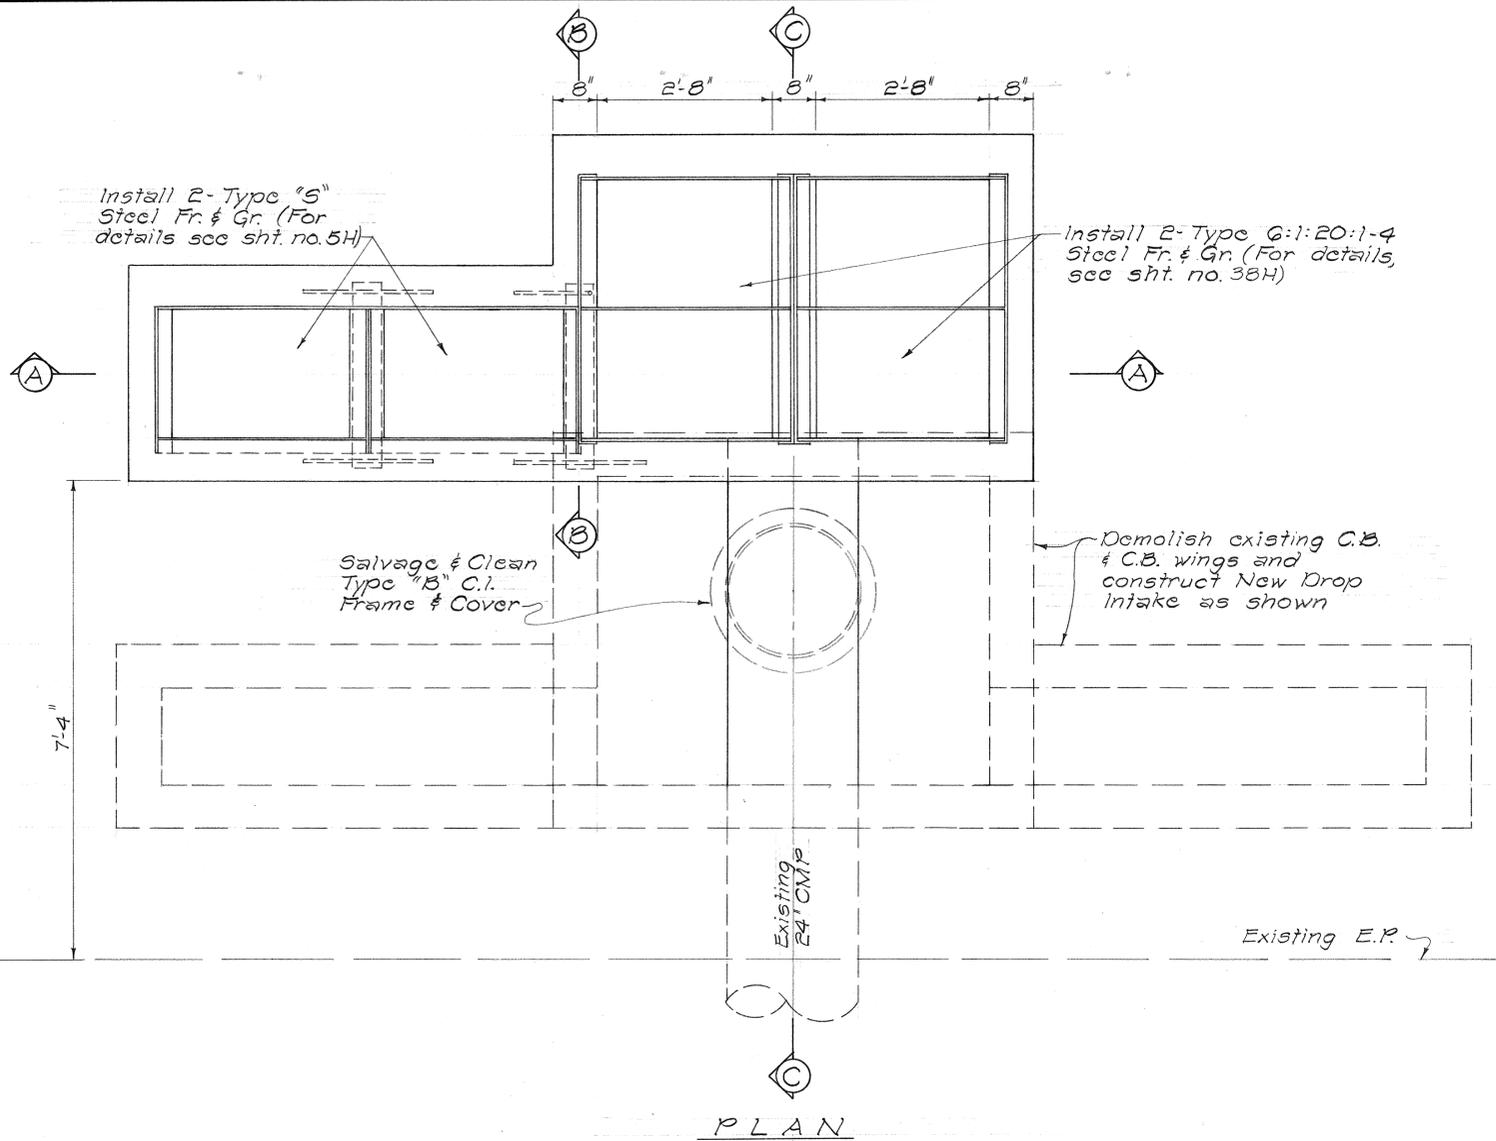

NOTE:






All notes, dimensions and reinforcing layouts are similar to typical section for Type G:1:20:1-4 Grated Drop Intake except as shown or noted on this sheet. (For details, see sht. no. 38H)

NEW G:1:20:1-4 GRATED DROP INTAKE
 @ STA. 81 + 75 W.B. (C.B. #32-F)
 Scale: 3/4" = 1'-0"

STATE OF HAWAII
 DEPARTMENT OF TRANSPORTATION
 HIGHWAYS DIVISION
DRAINAGE DETAILS
 NEW TYPE G:1:20:1-4
 GRATED DROP INTAKE
 Safety Improvements
 Kalihi Street to Pali Highway
 F.A.I. Proj. No. I-HI-1(112)12
 Scale As Shown Date: Apr. 1973
SHEET No. 14H OF 41H SHEETS

DATE	_____
DESIGNED BY	_____
CHECKED BY	_____
NO. _____	

FED. ROAD DIST. NO.	STATE	FED. AID PROJ. NO.	FISCAL YEAR	SHEET NO.	TOTAL SHEETS
HAWAII	HAW.	I-HI-1(112):19	1973	65	176

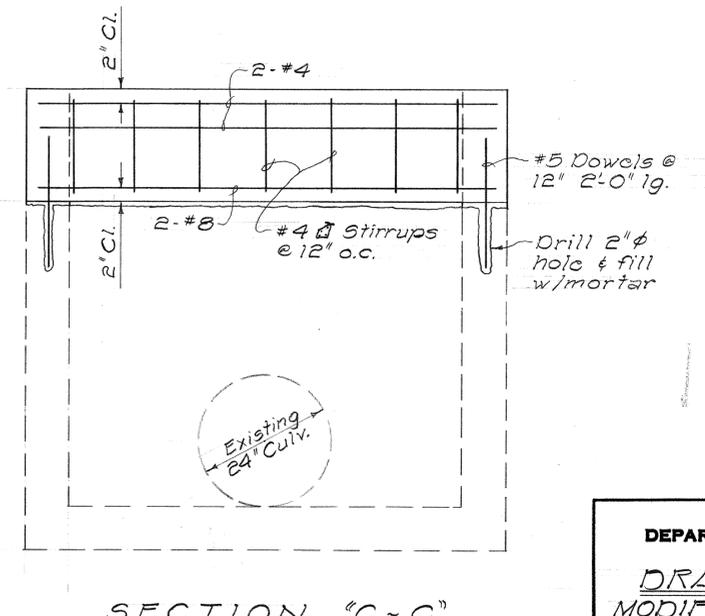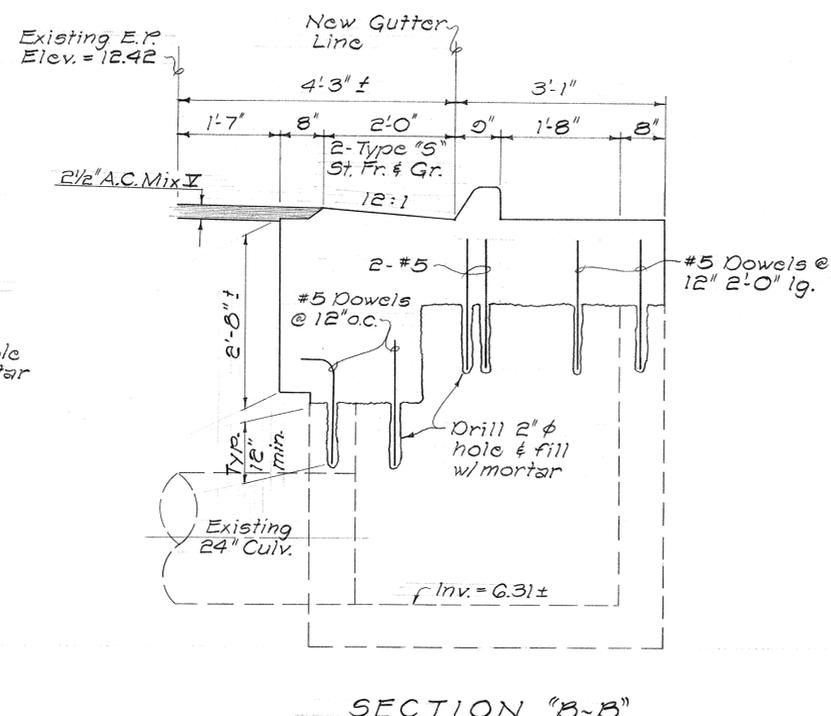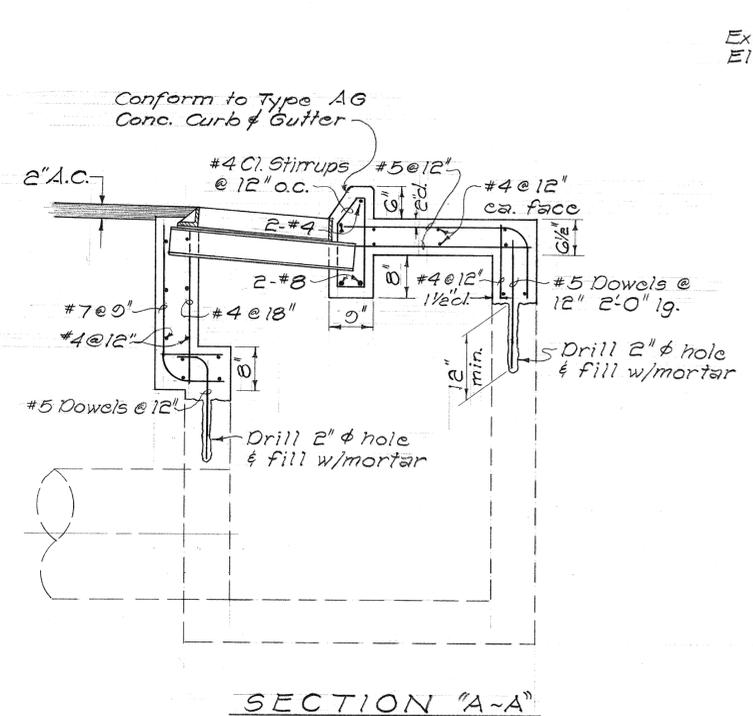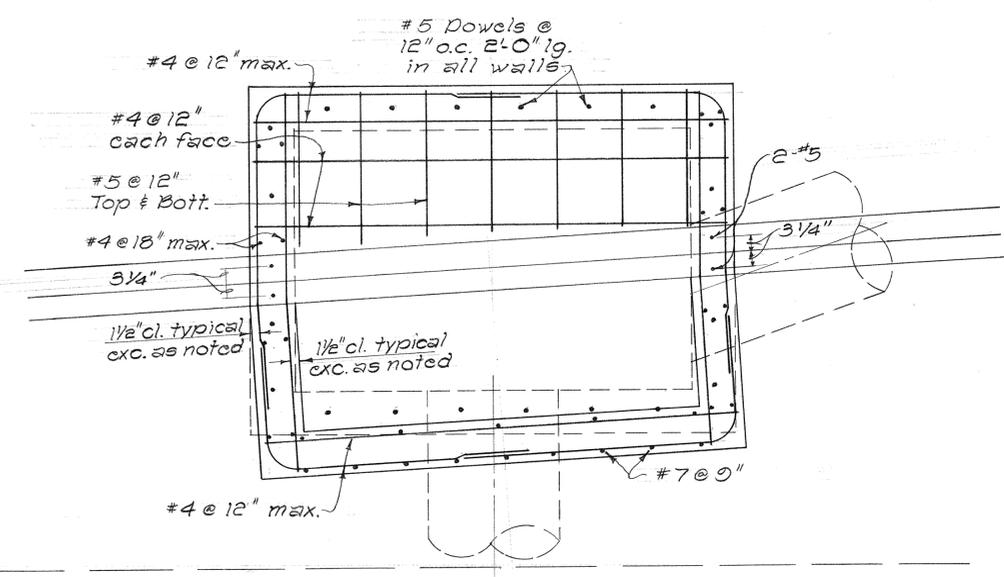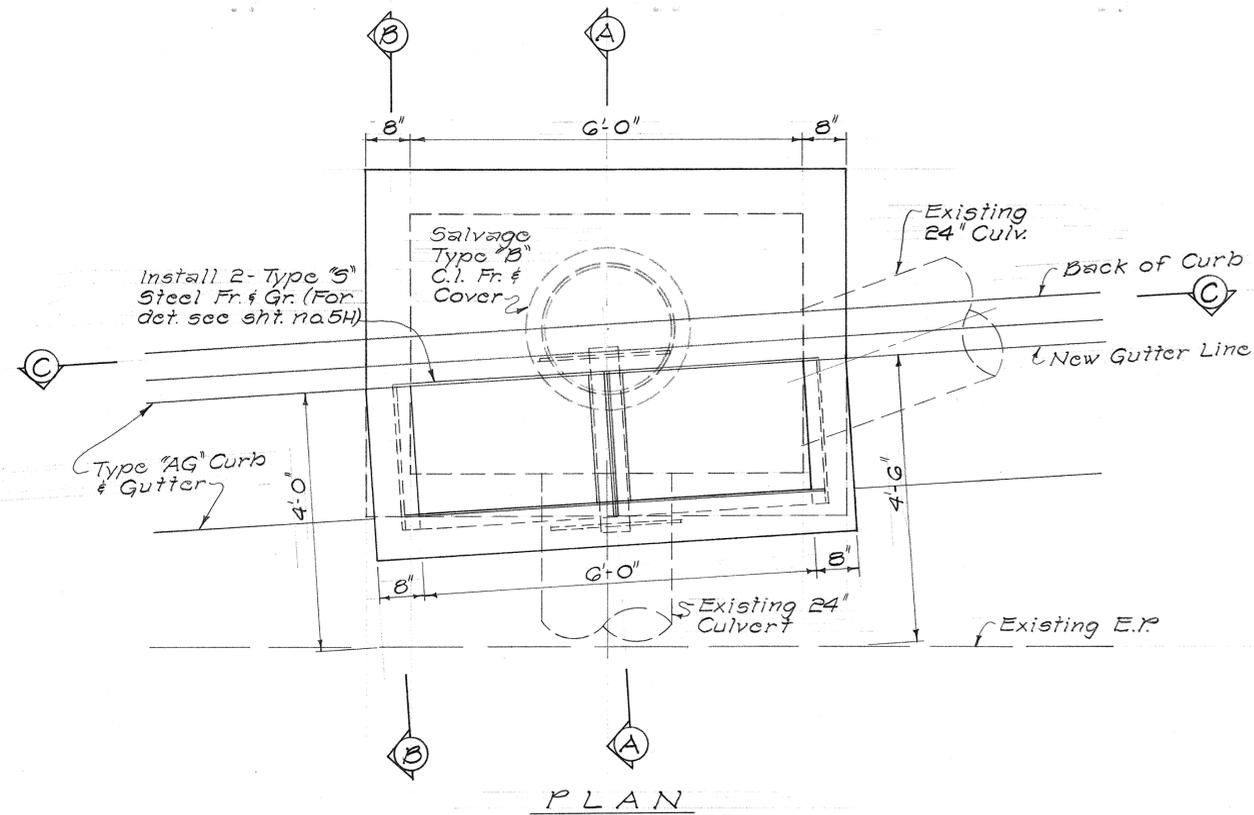

DETAIL OF CATCH BASIN @
RAMP "4" STA. 1 + 50 (C.B. # 30-F)


Scale: 3/4" = 1'-0"

STATE OF HAWAII
DEPARTMENT OF TRANSPORTATION
HIGHWAYS DIVISION


DRAINAGE DETAILS
MODIFICATION OF CATCH BASIN
WITH TYPE "G" GRATED INTAKE
SAFETY IMPROVEMENTS
KALIHI STREET TO PALI HIGHWAY
F.A.I. PROJ. No. I-HI-1(112):19
Scale: As Noted Date: April, 1973
SHEET No. 15H OF 4TH SHEETS

DATE	
SURVEY PLATTED BY	
DRAWN BY	
CHECKED BY	
REVISIONS BY	
NO. BOOK	
NO.	


FED. ROAD DIST. NO.	STATE	FED. AID PROJ. NO.	FISCAL YEAR	SHEET NO.	TOTAL SHEETS
HAWAII	HAW.	I-HI-1(12):10	1973	66	176

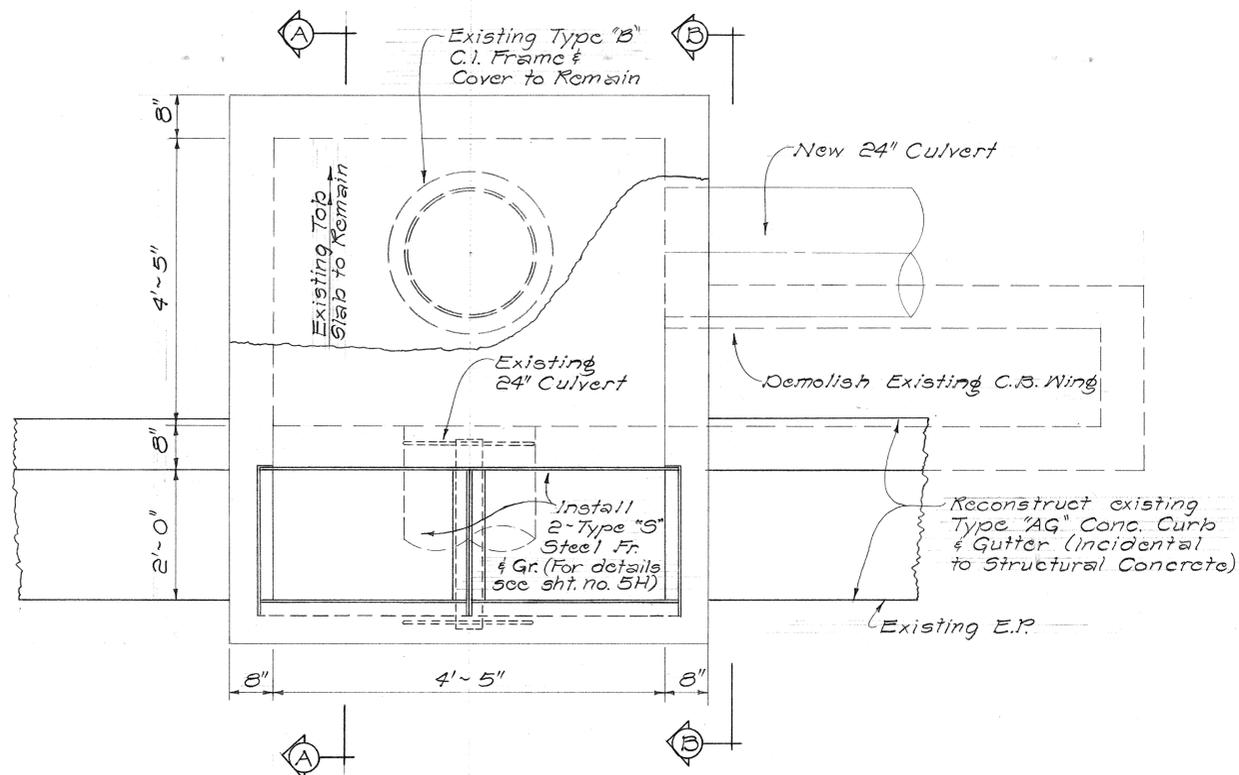

PLAN

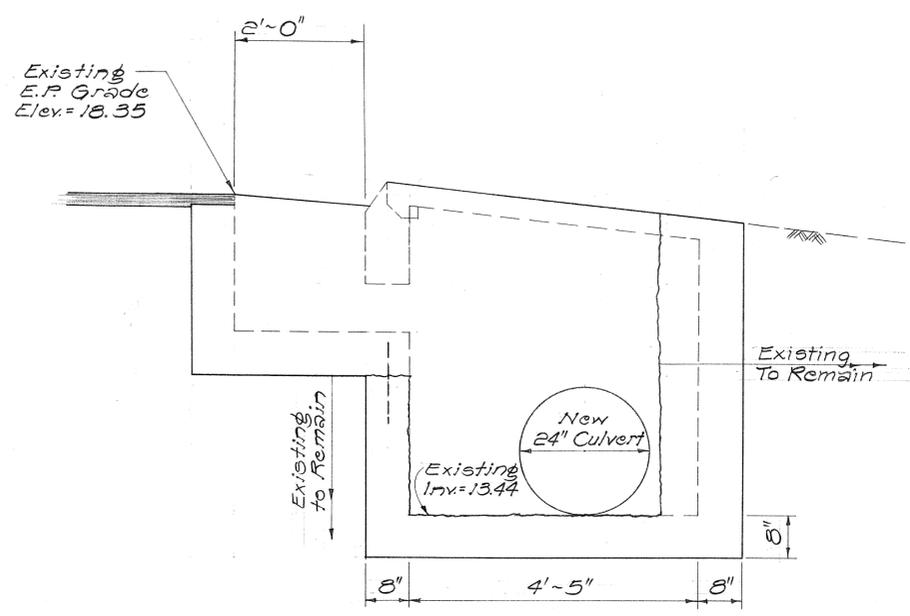

SECTION "B-B"

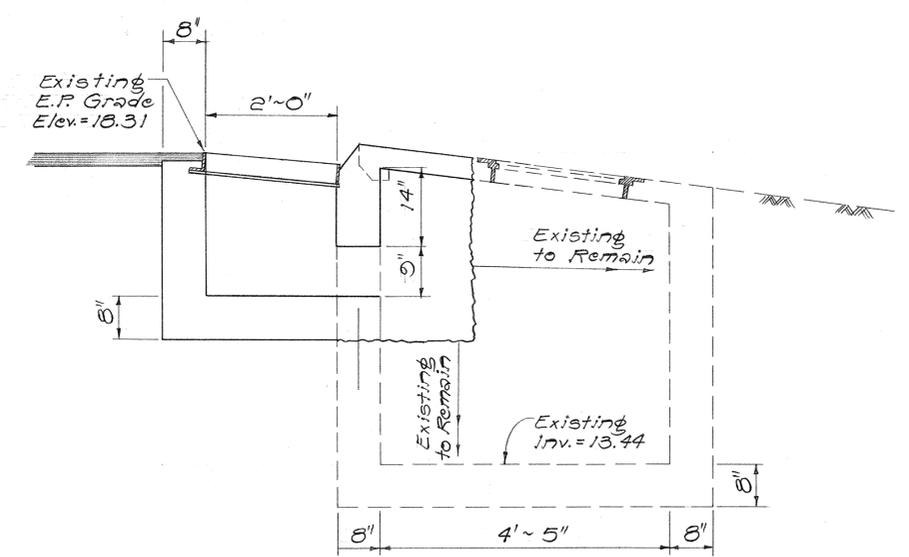

SECTION "A-A"

NOTE:
 Except as noted on this sheet see typical section for notes, dimension and reinforcing steel details for Type "5" Grated Drop Intake on sht. no. 4H & 5H

DETAILS OF C.B. #37-F @ STA. 85+00 W.B.

DATE	_____
DESIGNED BY	_____
CHECKED BY	_____
NO.	_____




STATE OF HAWAII
 DEPARTMENT OF TRANSPORTATION
 HIGHWAYS DIVISION

DRAINAGE DETAILS
 MODIFICATION OF CATCH BASIN
 WITH TYPE "5" GRATED INLET

Safety Improvements
 Kalihi Street to Pali Highway
 F.A.I. Proj. No. I-HI-1(12):10
 Scale: 3/4" = 1'-0" Date: April, 1973

SHEET No. 16H OF 41 HSHEETS


FED. ROAD DIST. NO.	STATE	FED. AID PROJ. NO.	FISCAL YEAR	SHEET NO.	TOTAL SHEETS
HAWAII	HAW.	I-HI-1(112):10	1973	67	176

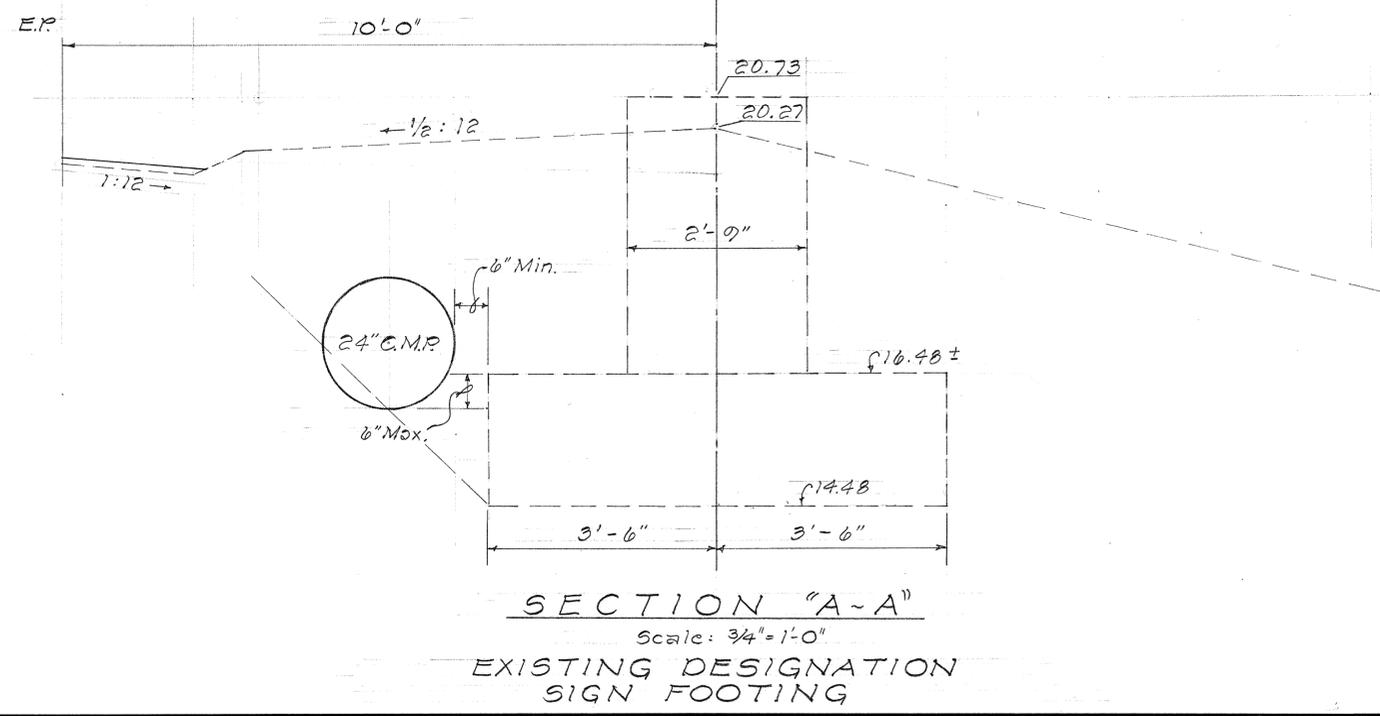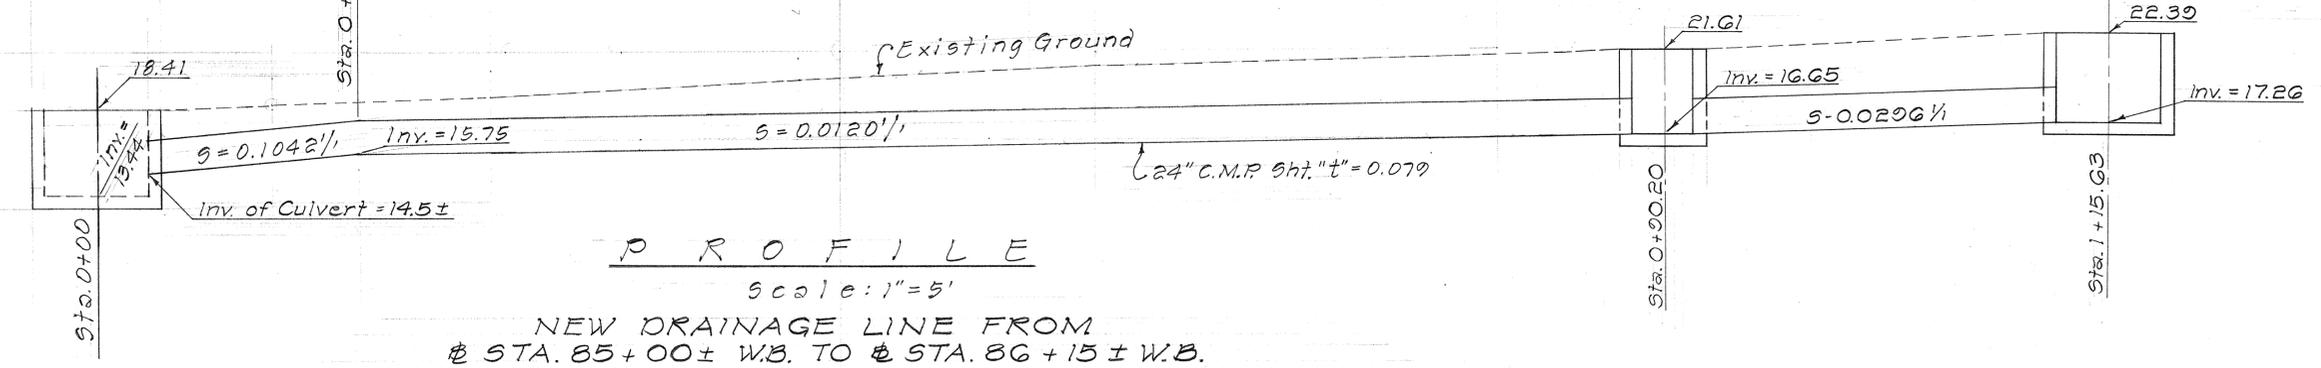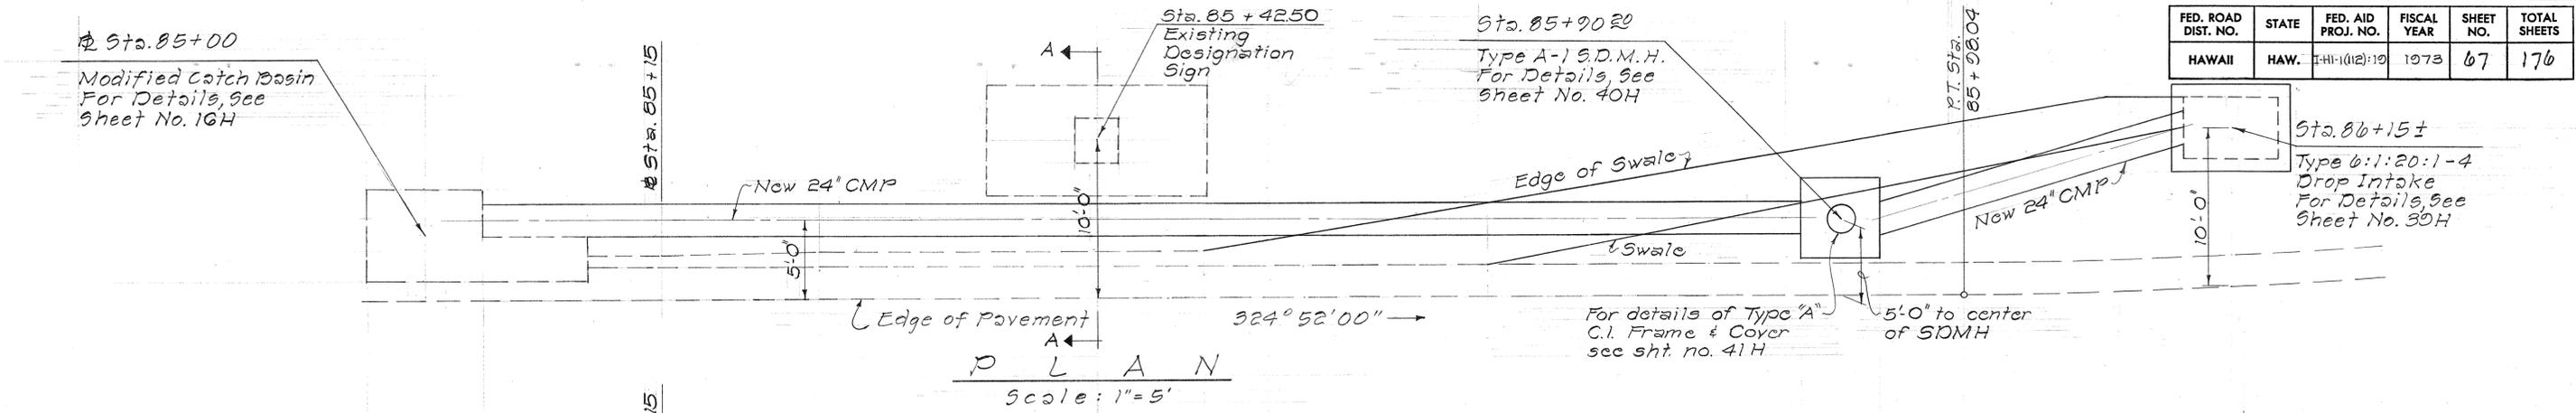


DATE	
DESIGNED BY	
CHECKED BY	
NO. 1	

STATE OF HAWAII
DEPARTMENT OF TRANSPORTATION
HIGHWAYS DIVISION
DRAINAGE DETAILS
PLAN & PROFILE FOR NEW
DRAINAGE LINE FROM # STA.
85+00 ± W.B. TO # STA. 86+15 ± W.B.
Safety Improvements
Kalihi Street to Pali Highway
F.A.I. Proj. No. I-HI-1(112):10
Scale As Noted Date: April, 1973
SHEET No. 17H OF 41 HSHEETS

FED. ROAD DIST. NO.	STATE	FED. AID PROJ. NO.	FISCAL YEAR	SHEET NO.	TOTAL SHEETS
HAWAII	HAW.	I-HI-1(112):10	1973	68	176

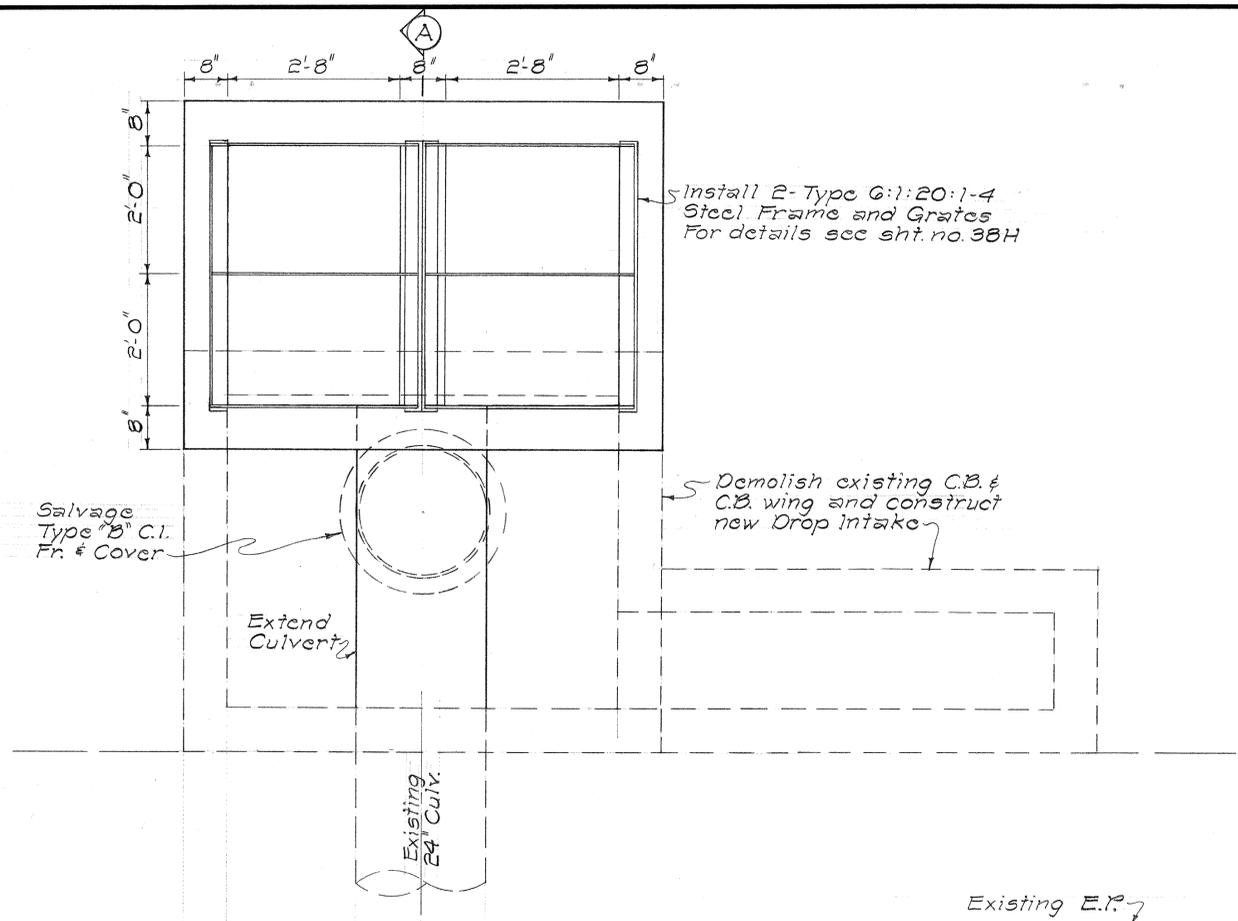


PLAN

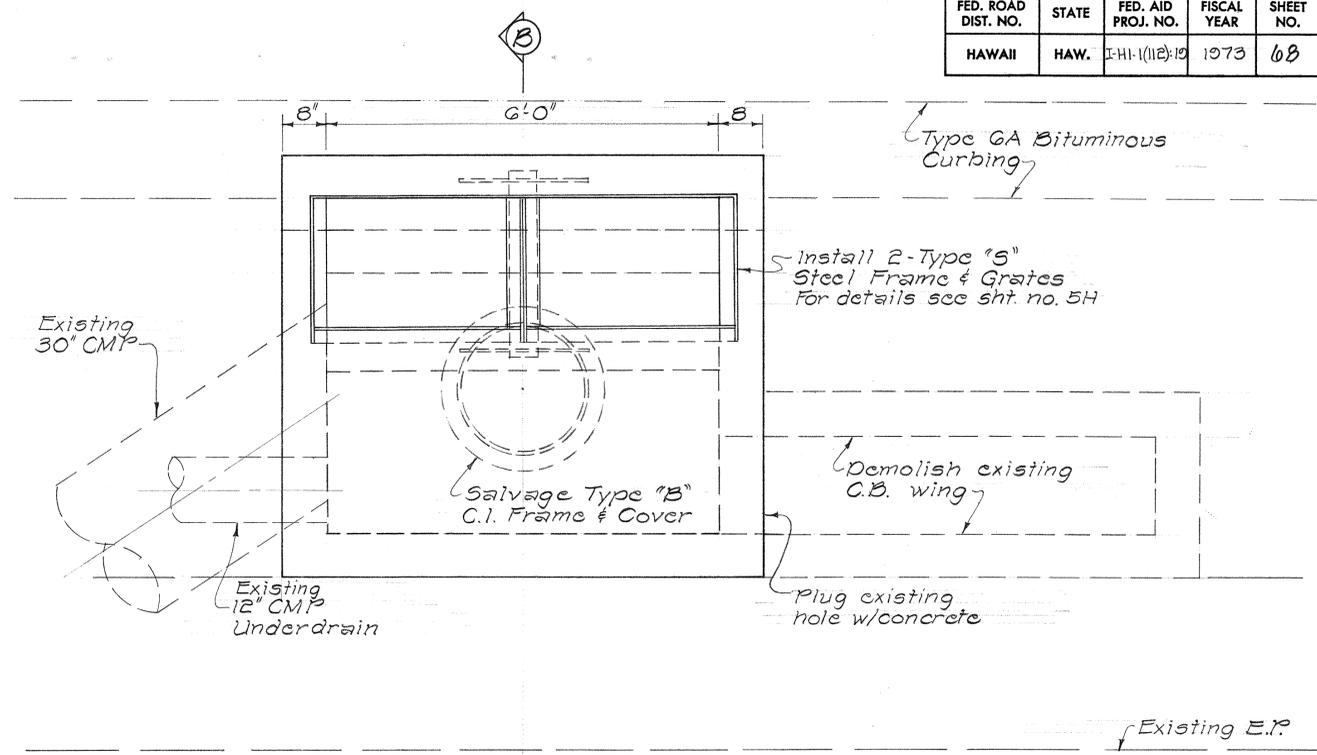


PLAN

NOTE:
All notes, dimensions and reinforcing layouts are similar to typical section for new G:1:20:1-4 Grated Drop Intake except as shown or noted on this sheet (For det. see sht. no. 39H)

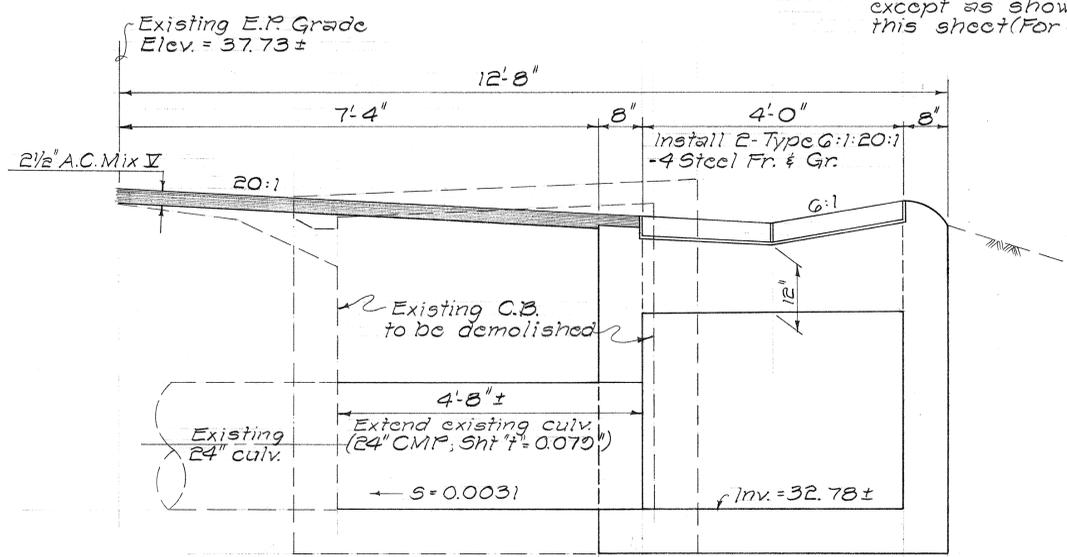

SECTION "A-A"

NEW G:1:20:1-4 GRATED DROP INTAKE @ STA. 101 + 00 E.B. (C.B. # 50-F)
Scale: 3/4" = 1'-0"

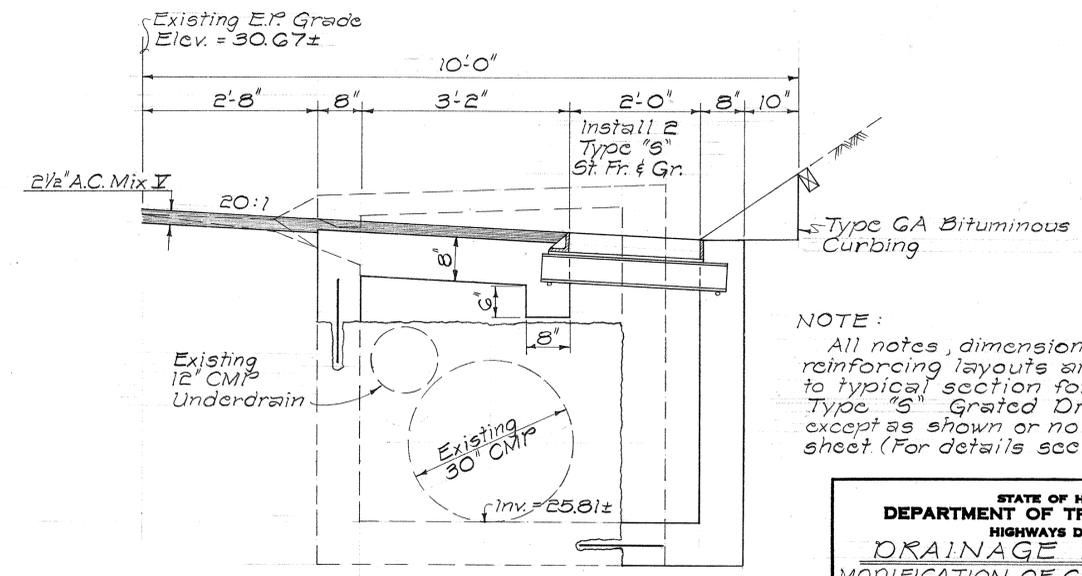

SECTION "B-B"


DETAILS OF CATCH BASIN @ STA. 108 + 25 E.B. (C.B. # 55-F)
Scale: 3/4" = 1'-0"

NOTE:
All notes, dimensions and reinforcing layouts are similar to typical section for Type "S" Grated Drop Intake except as shown or noted on this sheet. (For details see sht. no. 39H)


STATE OF HAWAII
DEPARTMENT OF TRANSPORTATION
HIGHWAYS DIVISION
DRAINAGE DETAILS
MODIFICATION OF CATCH BASINS
WITH TYPE "S" GRATED INLET
AND NEW TYPE G:1:20:1-4
GRATED DROP INTAKE
Safety Improvements
Kalihii Street to Pali Highway
F.A.I. Proj. No. I-HI-1(112):10
Scale: 3/4" = 1'-0" Date: April, 1973
SHEET No. 16H OF 41H SHEETS

DATE	
DESIGNED BY	
CHECKED BY	
NO.	


FED. ROAD DIST. NO.	STATE	FED. AID PROJ. NO.	FISCAL YEAR	SHEET NO.	TOTAL SHEETS
HAWAII	HAW.	I-HI-1(112):19	1973	69	176

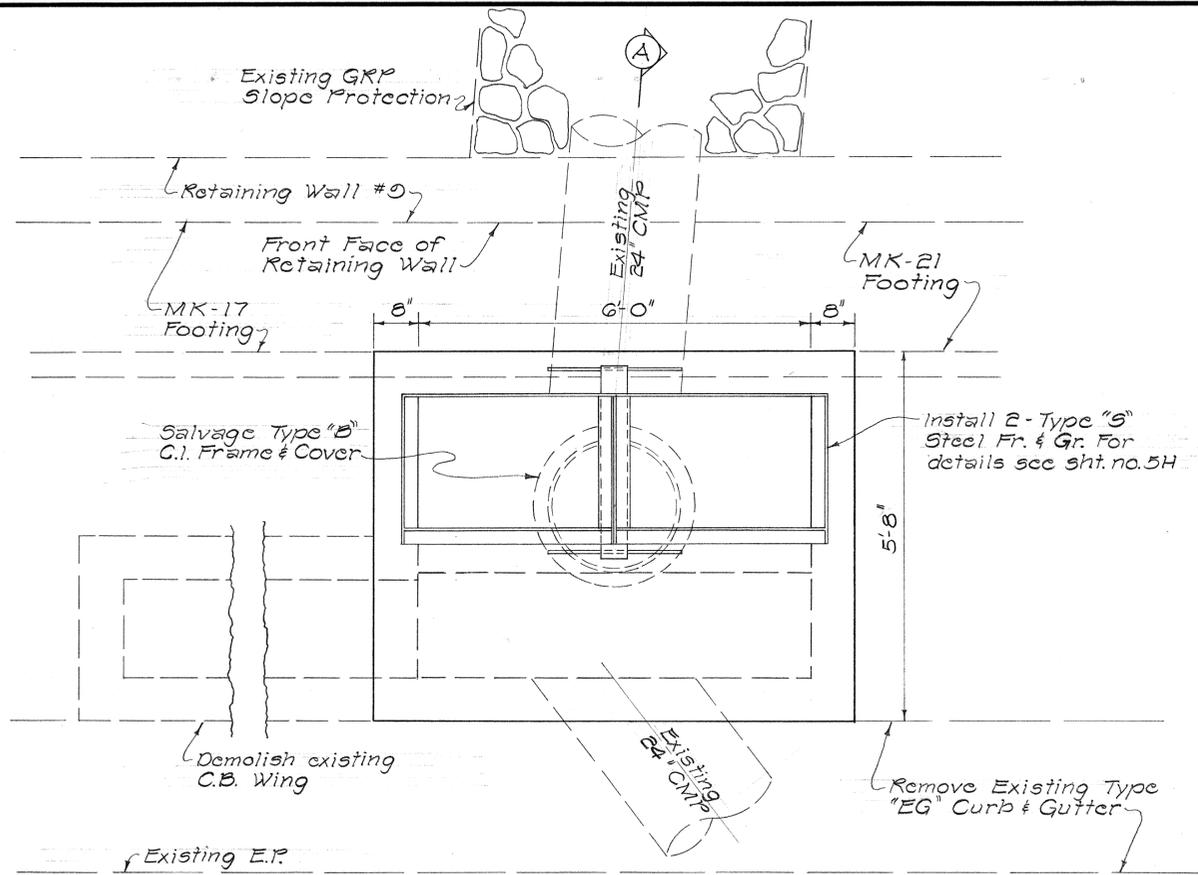


PLAN

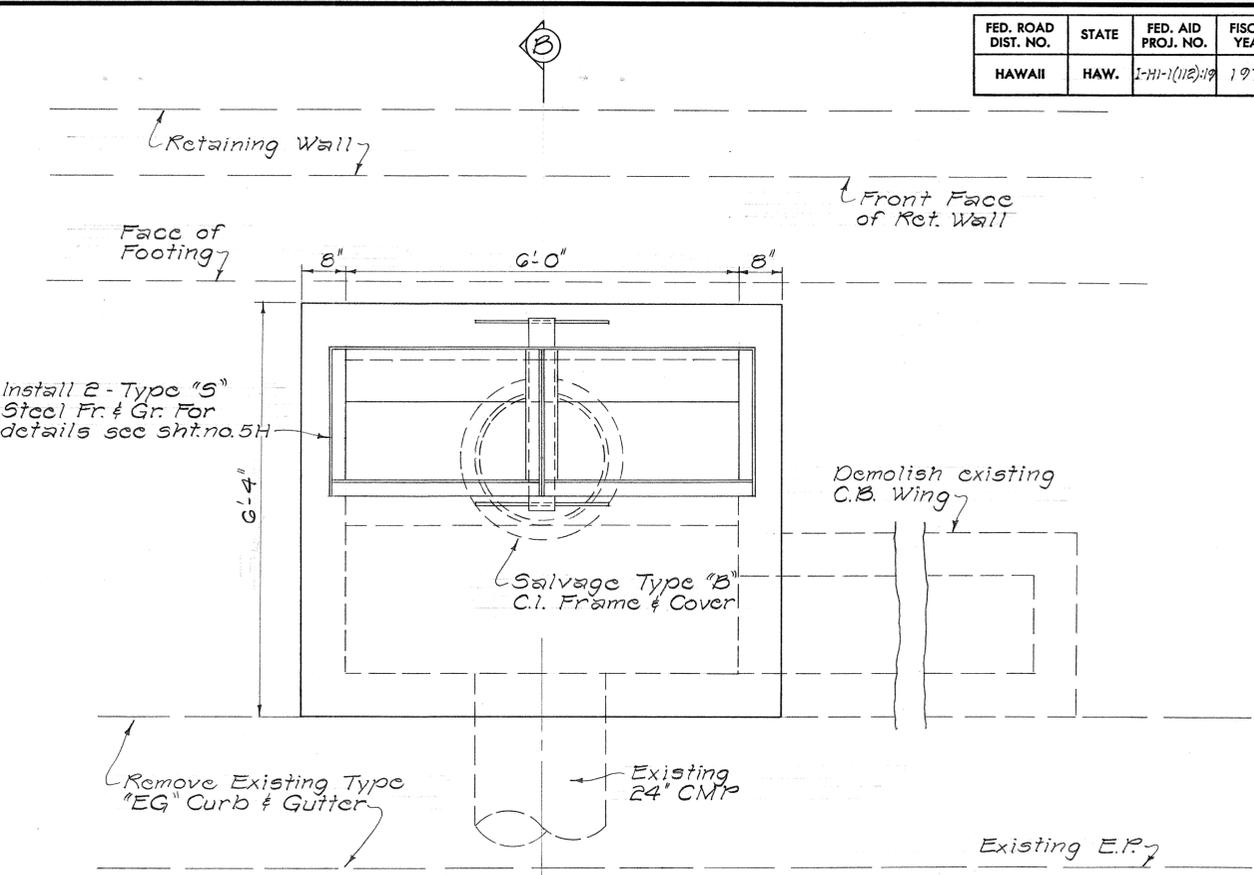

PLAN

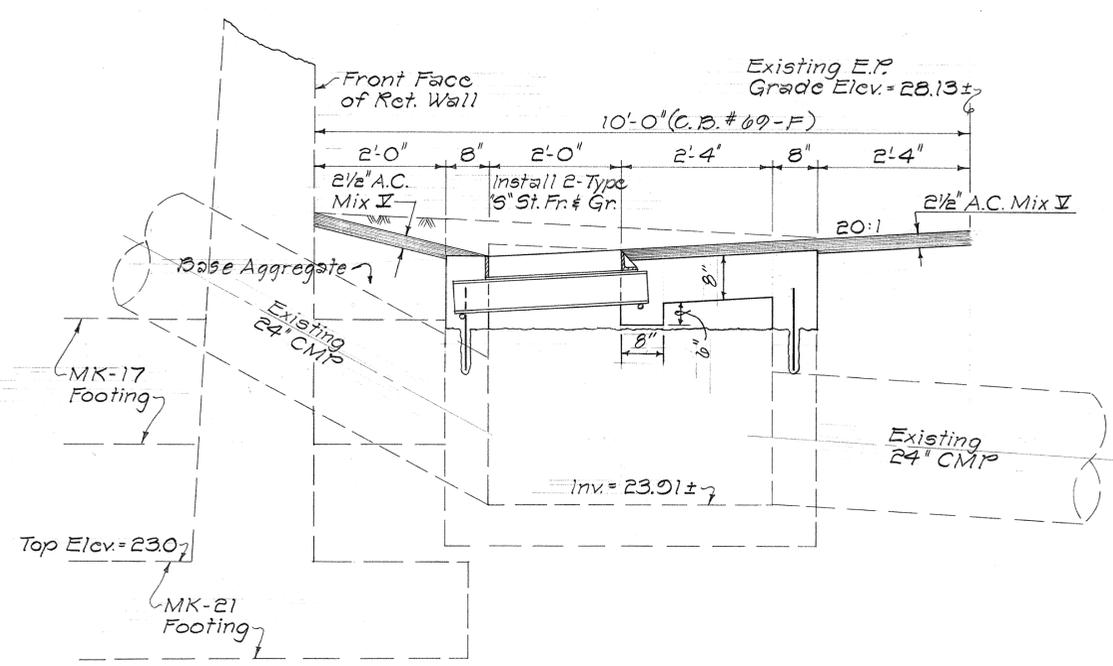

SECTION "A-A"

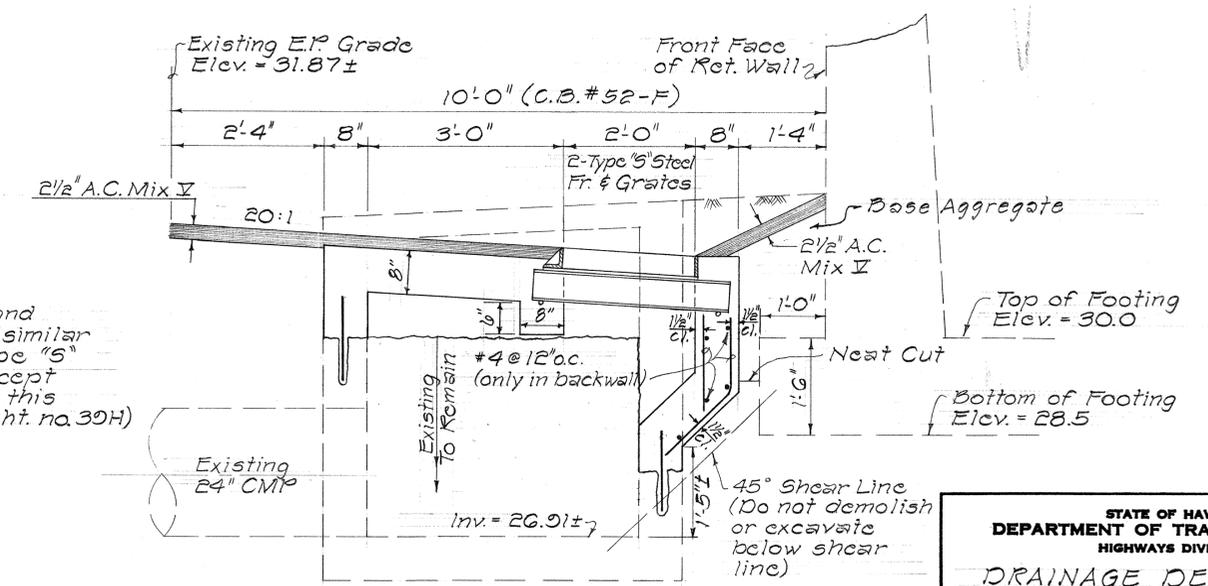

SECTION "B-B"





NOTES:
 All notes, dimensions and reinforcing layouts are similar to typical section for Type "5" Grated Drop Intake except as shown or noted on this sheet. (For details, see sht. no. 39H)

DETAILS OF CATCH BASINS @
 @ STA. 106 + 00 E.B. (C.B. #52-F)
 @ STA. 121 + 00 W.B. (C.B. #69-F)
 Scale: 3/4" = 1'-0"

STATE OF HAWAII
 DEPARTMENT OF TRANSPORTATION
 HIGHWAYS DIVISION
DRAINAGE DETAILS
 MODIFICATION OF CATCH BASINS
 WITH TYPE "5" GRATED INLET
 Safety Improvements
 Kalihī Street to Pali Highway
 F.A.I. Proj. No. I-HI-1(112):19
 Scale: 3/4" = 1'-0" Date: April, 1973
 SHEET No. 10H OF 41 H SHEETS

DATE: _____
 SURVEY PLOTTED BY: _____
 DRAWN BY: _____
 CHECKED BY: _____
 ORIGINAL PLAN: _____
 NOTE BOOK: _____
 No. _____

FED. ROAD DIST. NO.	STATE	FED. AID PROJ. NO.	FISCAL YEAR	SHEET NO.	TOTAL SHEETS
HAWAII	HAW.	I-H-1(112)19	1973	70	176

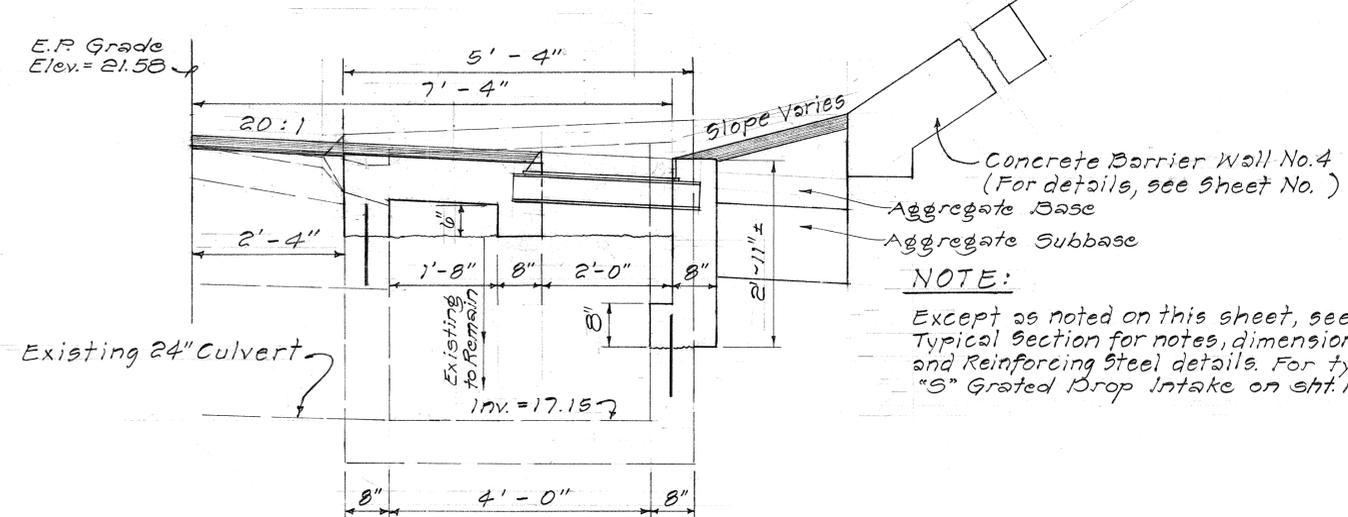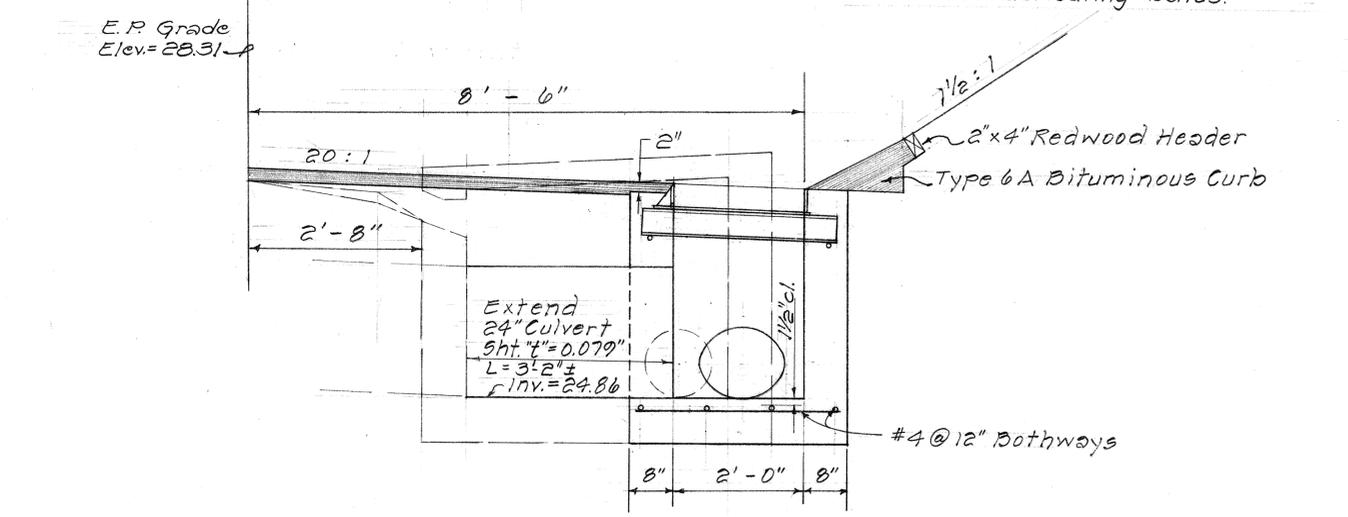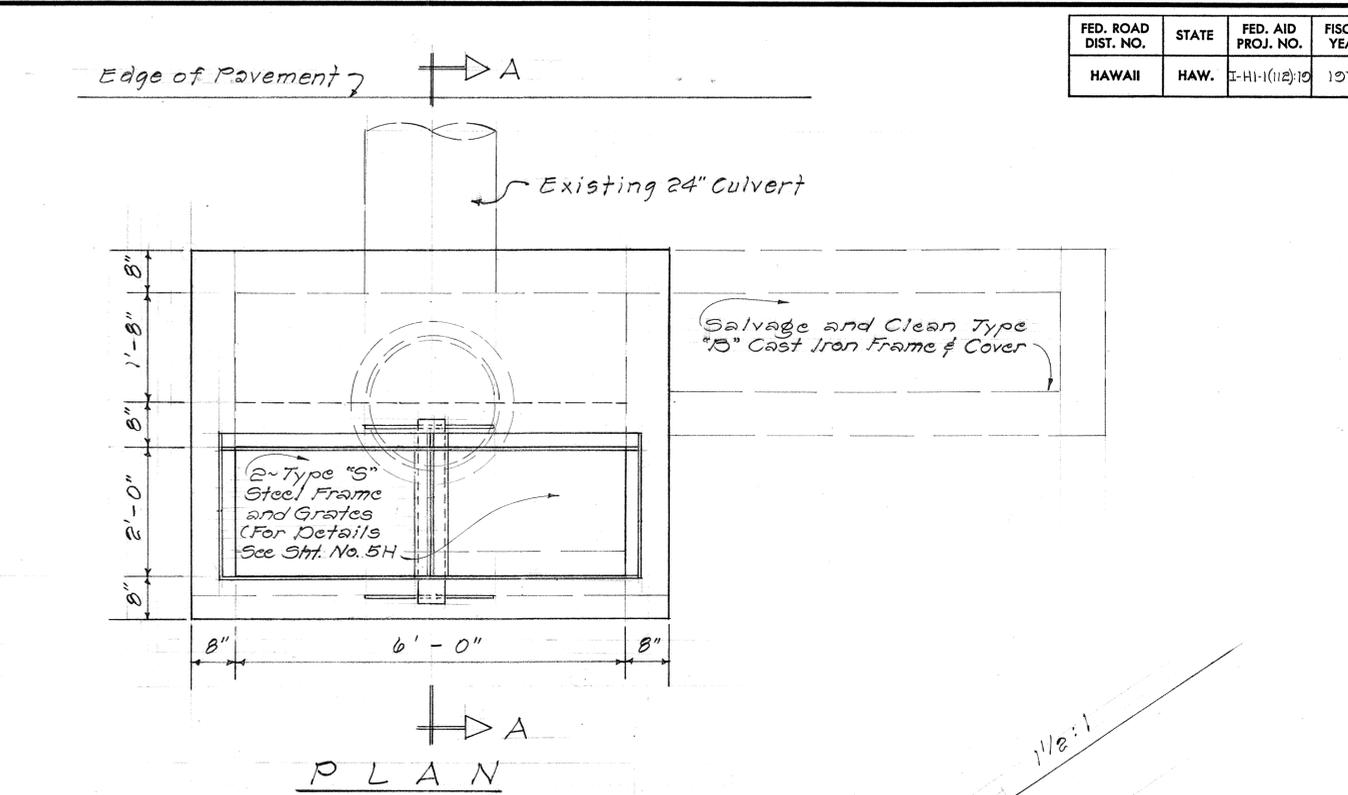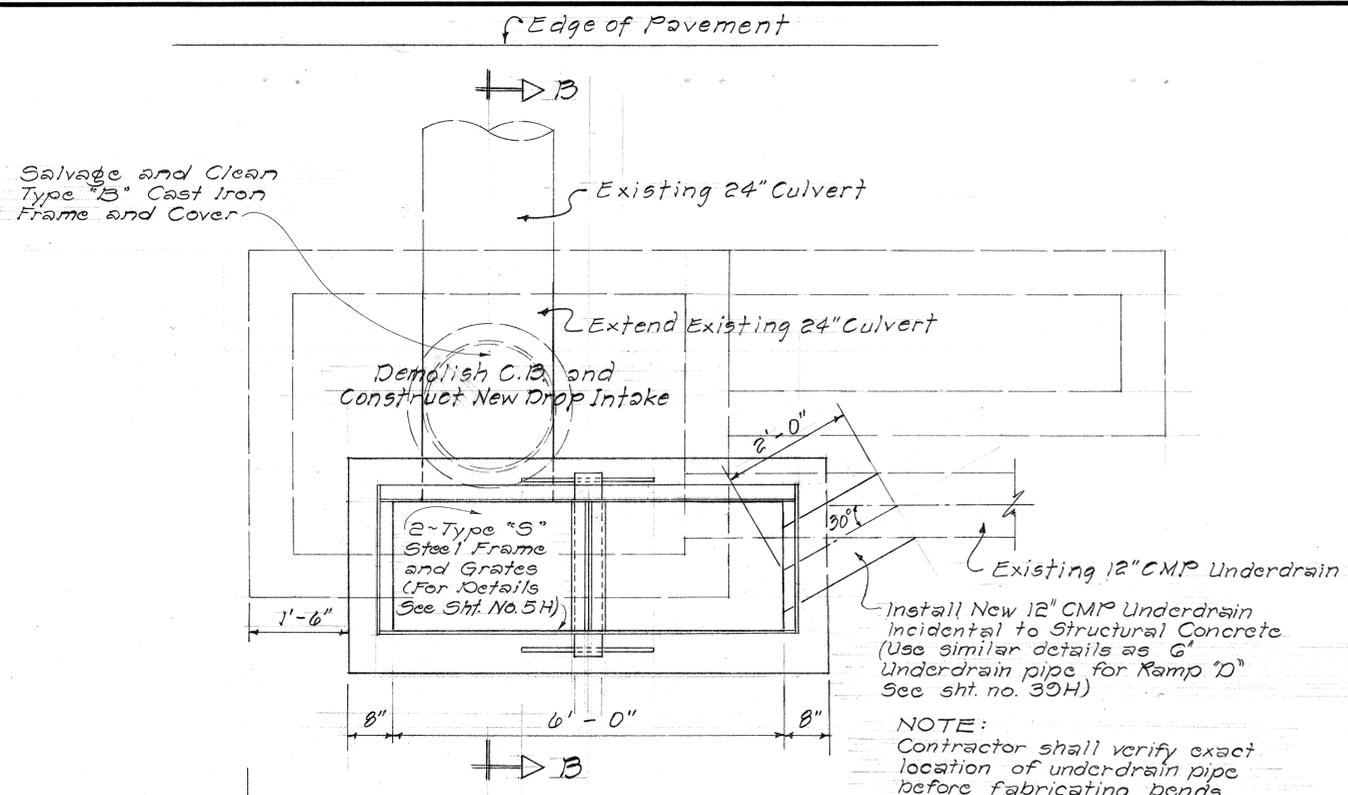

NEW TYPE "S" DROP INTAKE AT
 @ STA. 110+00 W.B.

DETAILS OF C.B. # 71-F
 AT @ STA. 123+75 W.B.

STATE OF HAWAII
 DEPARTMENT OF TRANSPORTATION
 HIGHWAYS DIVISION


DRAINAGE DETAILS
 MODIFICATIONS OF CATCH BASINS
 WITH TYPE "S" GRATED INLETS

Safety Improvements
 Kalihi St. to Pali Hwy.
 F.A.I. Proj. No. I-H-1(112):19
 Scale: 3/4" = 1'-0" Date: April, 1973


SHEET No. 20H OF 41 H SHEETS

DATE	_____
DESIGNED BY	_____
CHECKED BY	_____
NO. _____	_____


FED. ROAD DIST. NO.	STATE	FED. AID PROJ. NO.	FISCAL YEAR	SHEET NO.	TOTAL SHEETS
HAWAII	HAW.	I-H-1(112):19	1973	71	176

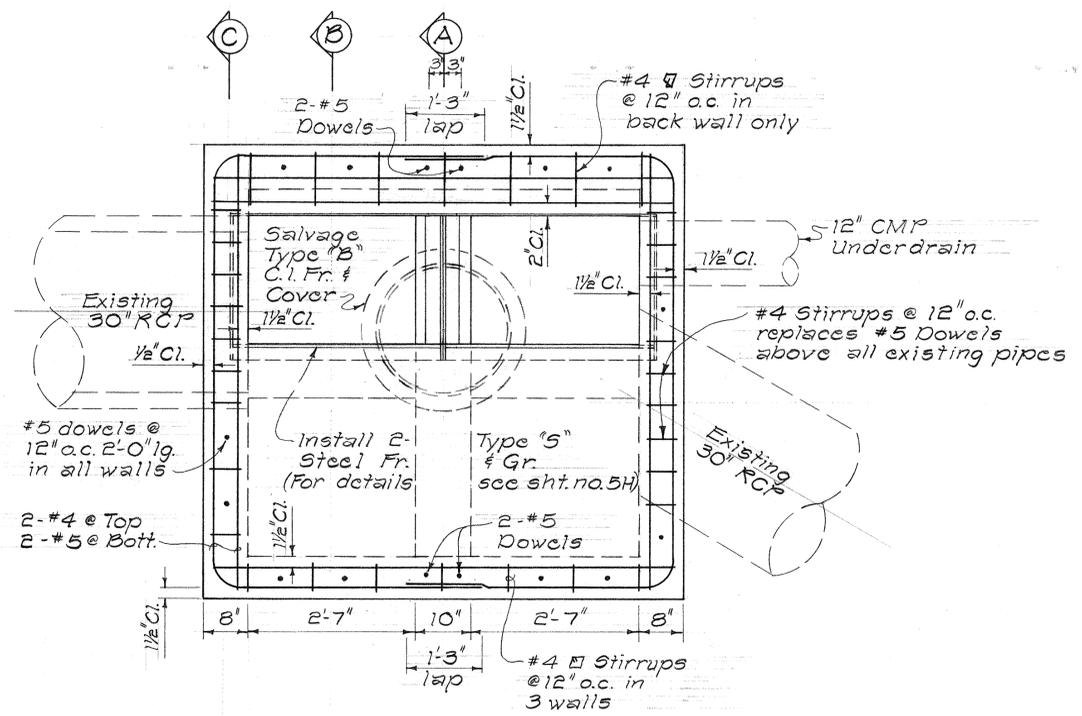


PLAN

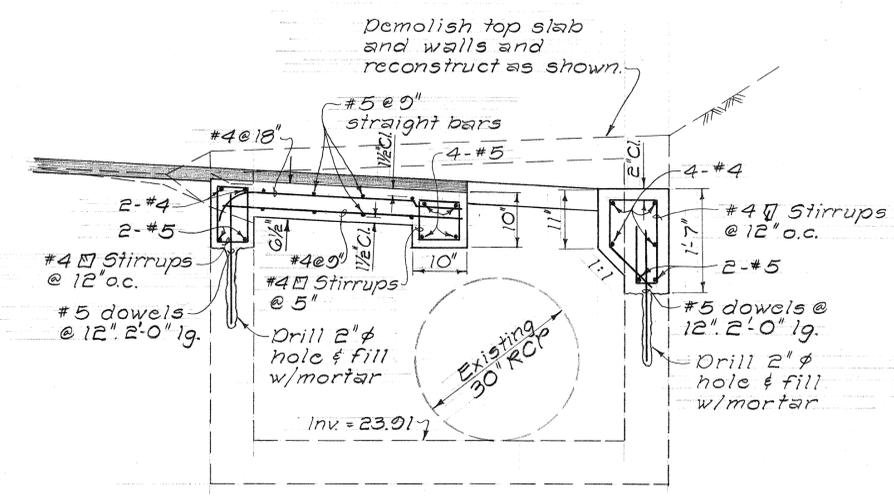

SECTION "B-B"
(DETAILS OF LONGITUDINAL BEAM & SLAB)

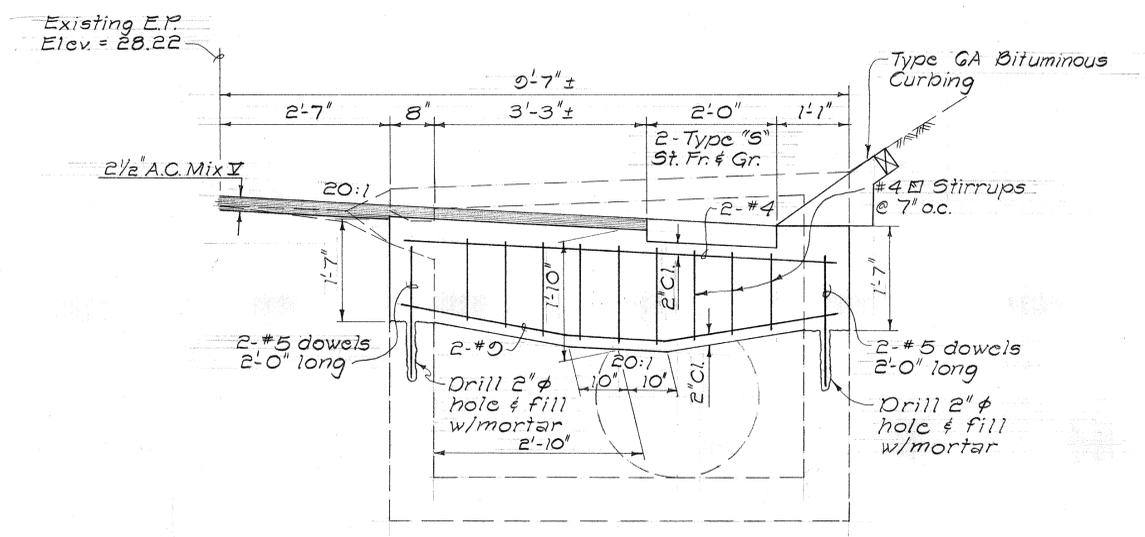

SECTION "A-A"
(DETAILS OF TRANSVERSE BEAM)

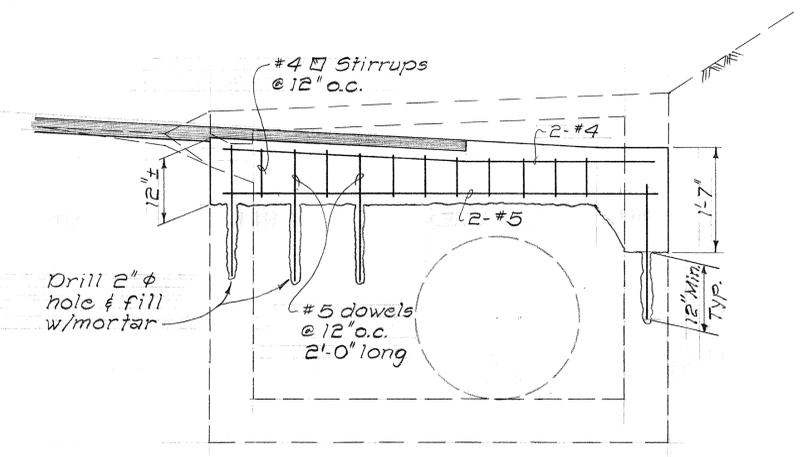





SECTION "C-C"
(DETAILS OF SIDE WALL)

DETAILS OF CATCH BASIN @
± STA. 110 + 05 ± E.B. (C.B. #57-F)
 Scale: 3/4" = 1'-0"

STATE OF HAWAII
 DEPARTMENT OF TRANSPORTATION
 HIGHWAYS DIVISION
DRAINAGE DETAILS
 MODIFICATION OF CATCH BASINS
 WITH TYPE "S" GRATED INLET
 Safety Improvements
 Kalihi Street to Pali Highway
 F.A.I. Proj. No. I-H-1(112):19
 Scale: 3/4" = 1'-0" Date: Apr, 1973
SHEET No. 21H OF 41H SHEETS

DATE	
REVISION	
DESIGNED BY	
CHECKED BY	
NO. 1	

FED. ROAD DIST. NO.	STATE	FED. AID PROJ. NO.	FISCAL YEAR	SHEET NO.	TOTAL SHEETS
HAWAII	HAW.	I-HI-1(112)-10	1973	72	176

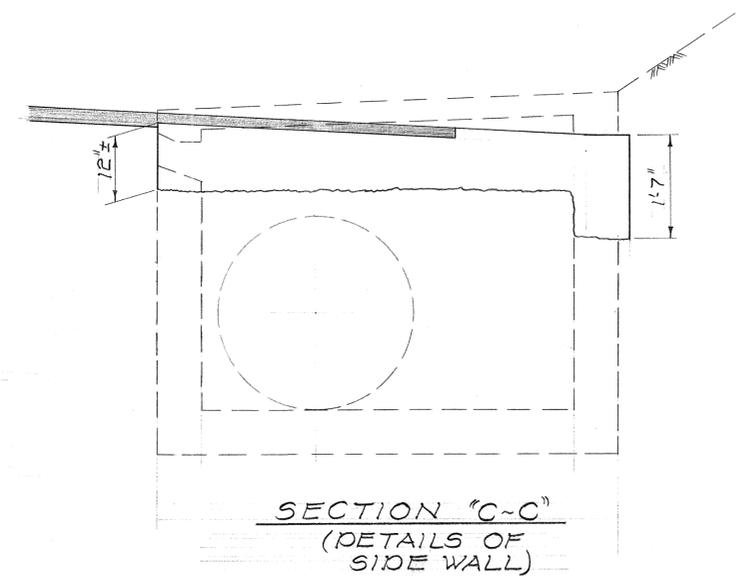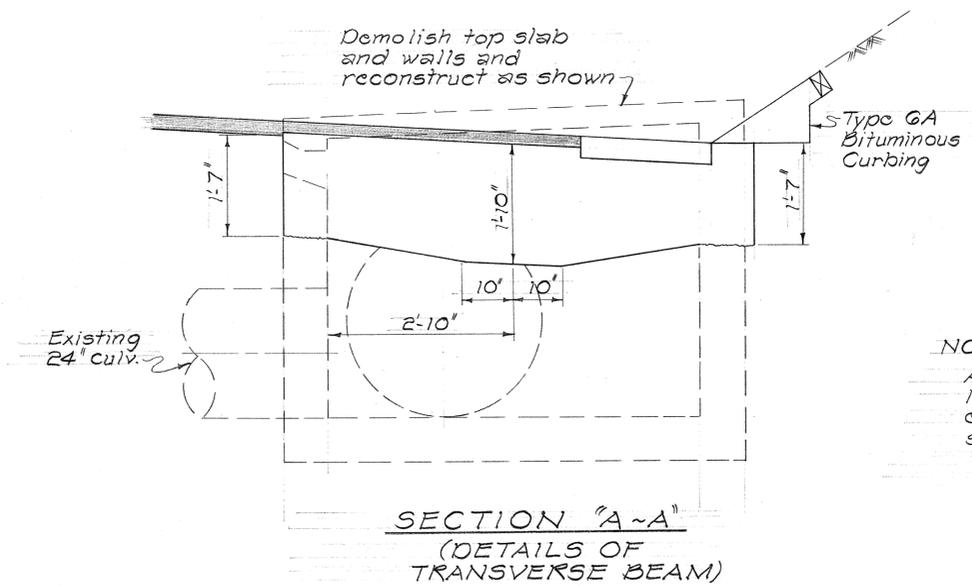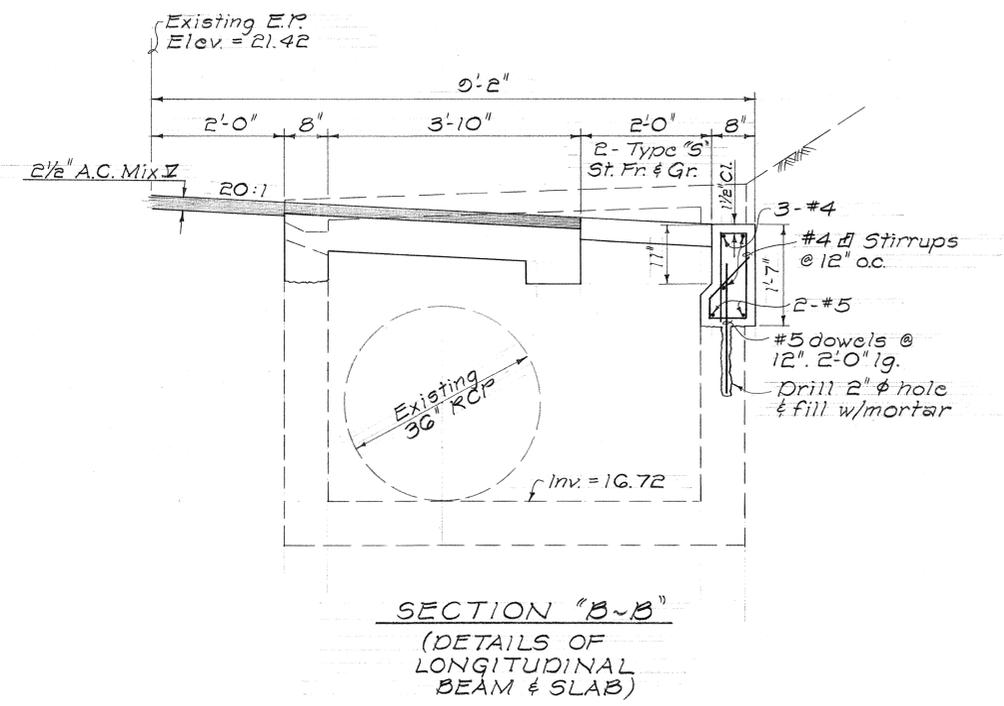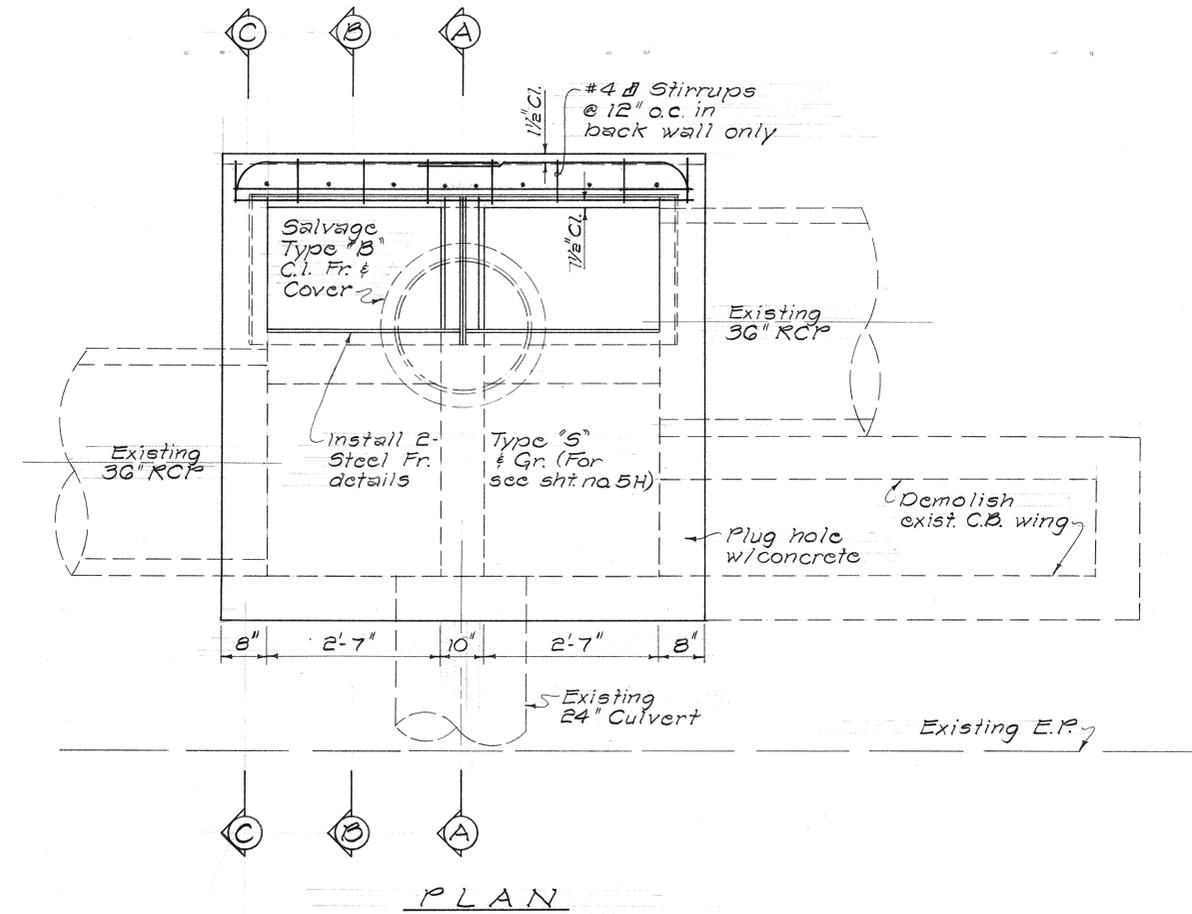

NOTE:
 All notes, dimensions and reinforcing layouts are similar to C.B. #57-F except as shown or noted on this sheet (For details, see sht. no. 21H)

**DETAILS OF CATCH BASIN @
 RAMP "G" STA. 11 + 50 (C.B. #72-F)**
 Scale: 3/4" = 1'-0"

DATE	_____
DESIGNED BY	_____
CHECKED BY	_____
NO. _____	_____





STATE OF HAWAII
 DEPARTMENT OF TRANSPORTATION
 HIGHWAYS DIVISION

DRAINAGE DETAILS
 MODIFICATION OF CATCH BASIN
 WITH TYPE "S" GRATED INLET

Safety Improvements
 Kalihi Street to Pali Highway
 F.A.I. Proj. No. I-HI-1(112)-10
 Scale: 3/4" = 1'-0" Date: Apr, 1973

SHEET No. 22H OF 41 HSHEETS

FED. ROAD DIST. NO.	STATE	FED. AID PROJ. NO.	FISCAL YEAR	SHEET NO.	TOTAL SHEETS
HAWAII	HAW.	I-H-1-1(12):10	1973	73	176

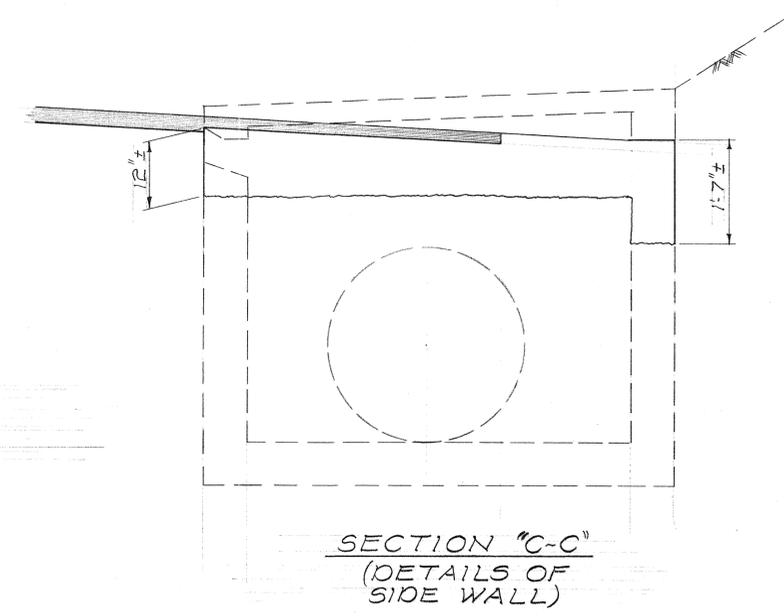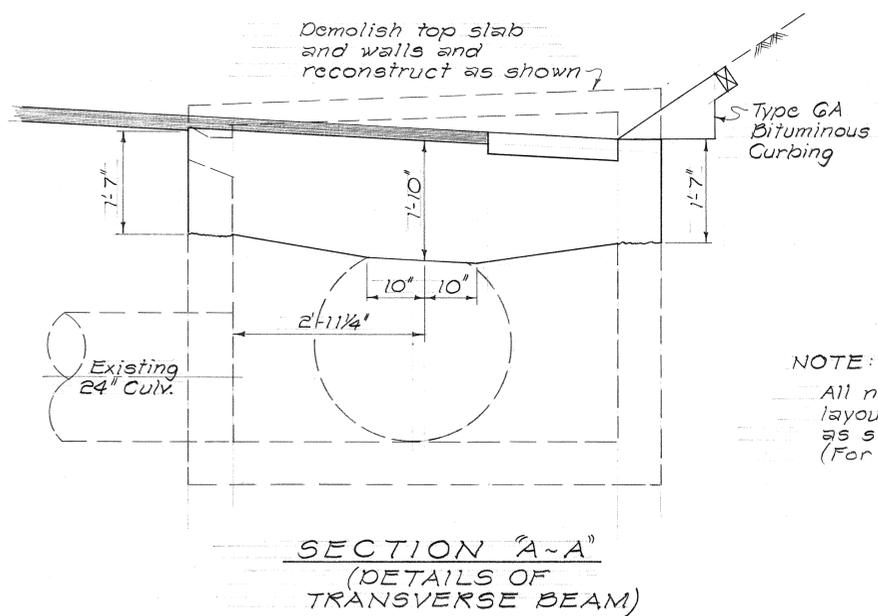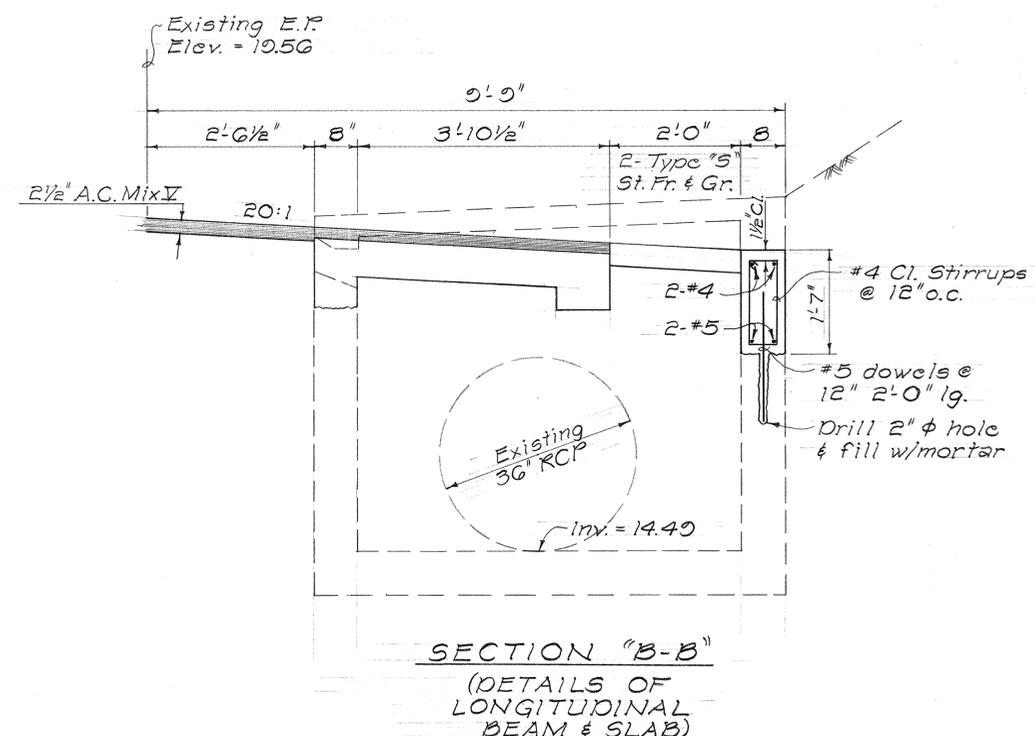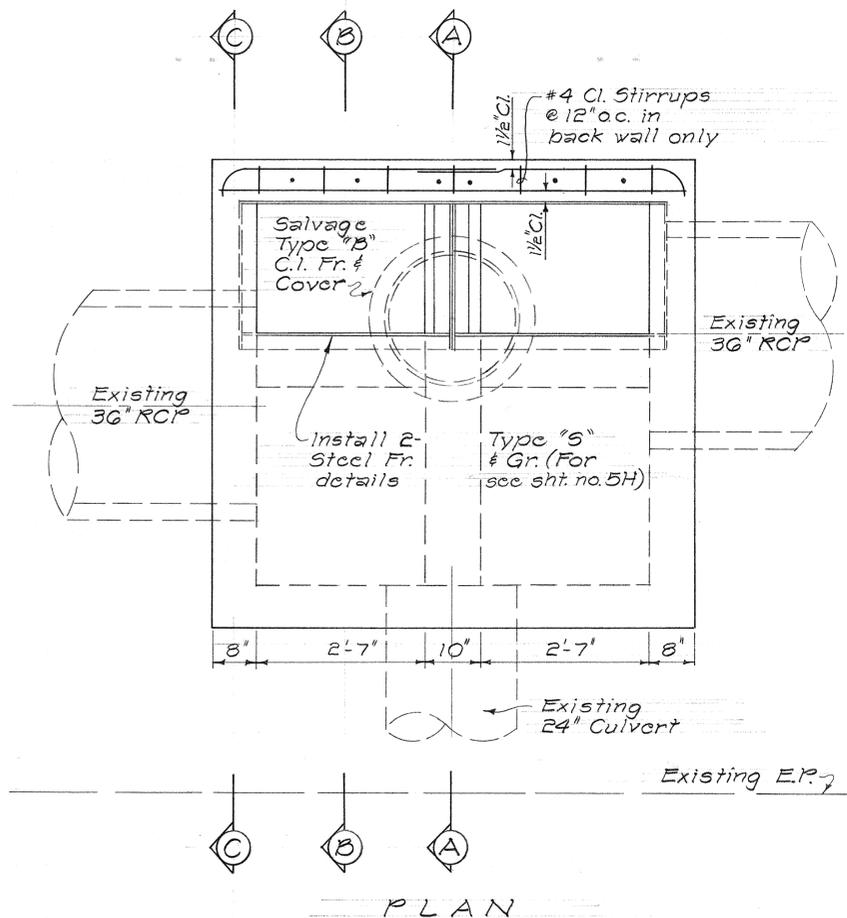

NOTE:
All notes, dimensions and reinforcing layouts are similar to C.B. #57-F except as shown or noted on this sheet. (For details, see sht. no. 21H)

DETAILS OF CATCH BASIN @
RAMP "G" STA. 13 + 50 (C.B. #75-F)
Scale: 3/4" = 1'-0"

STATE OF HAWAII
DEPARTMENT OF TRANSPORTATION
HIGHWAYS DIVISION


DRAINAGE DETAILS
MODIFICATION OF CATCH BASIN
WITH TYPE "5" GRATED INLET

Safety Improvements
Kalihi Street to Pali Highway
F.A.I. Proj. No. I-H-1-1(12):10
Scale: 3/4" = 1'-0" Date: Apr. 1973

SHEET No. 23 OF 41 SHEETS

DATE	
DESIGNED BY	
DRAWN BY	
CHECKED BY	
APPROVED BY	
ORIGINAL PLAN	
NOTE BOOK	
No.	

FED. ROAD DIST. NO.	STATE	FED. AID PROJ. NO.	FISCAL YEAR	SHEET NO.	TOTAL SHEETS
HAWAII	HAW.	I-HI-1(12):19	1973	74	176

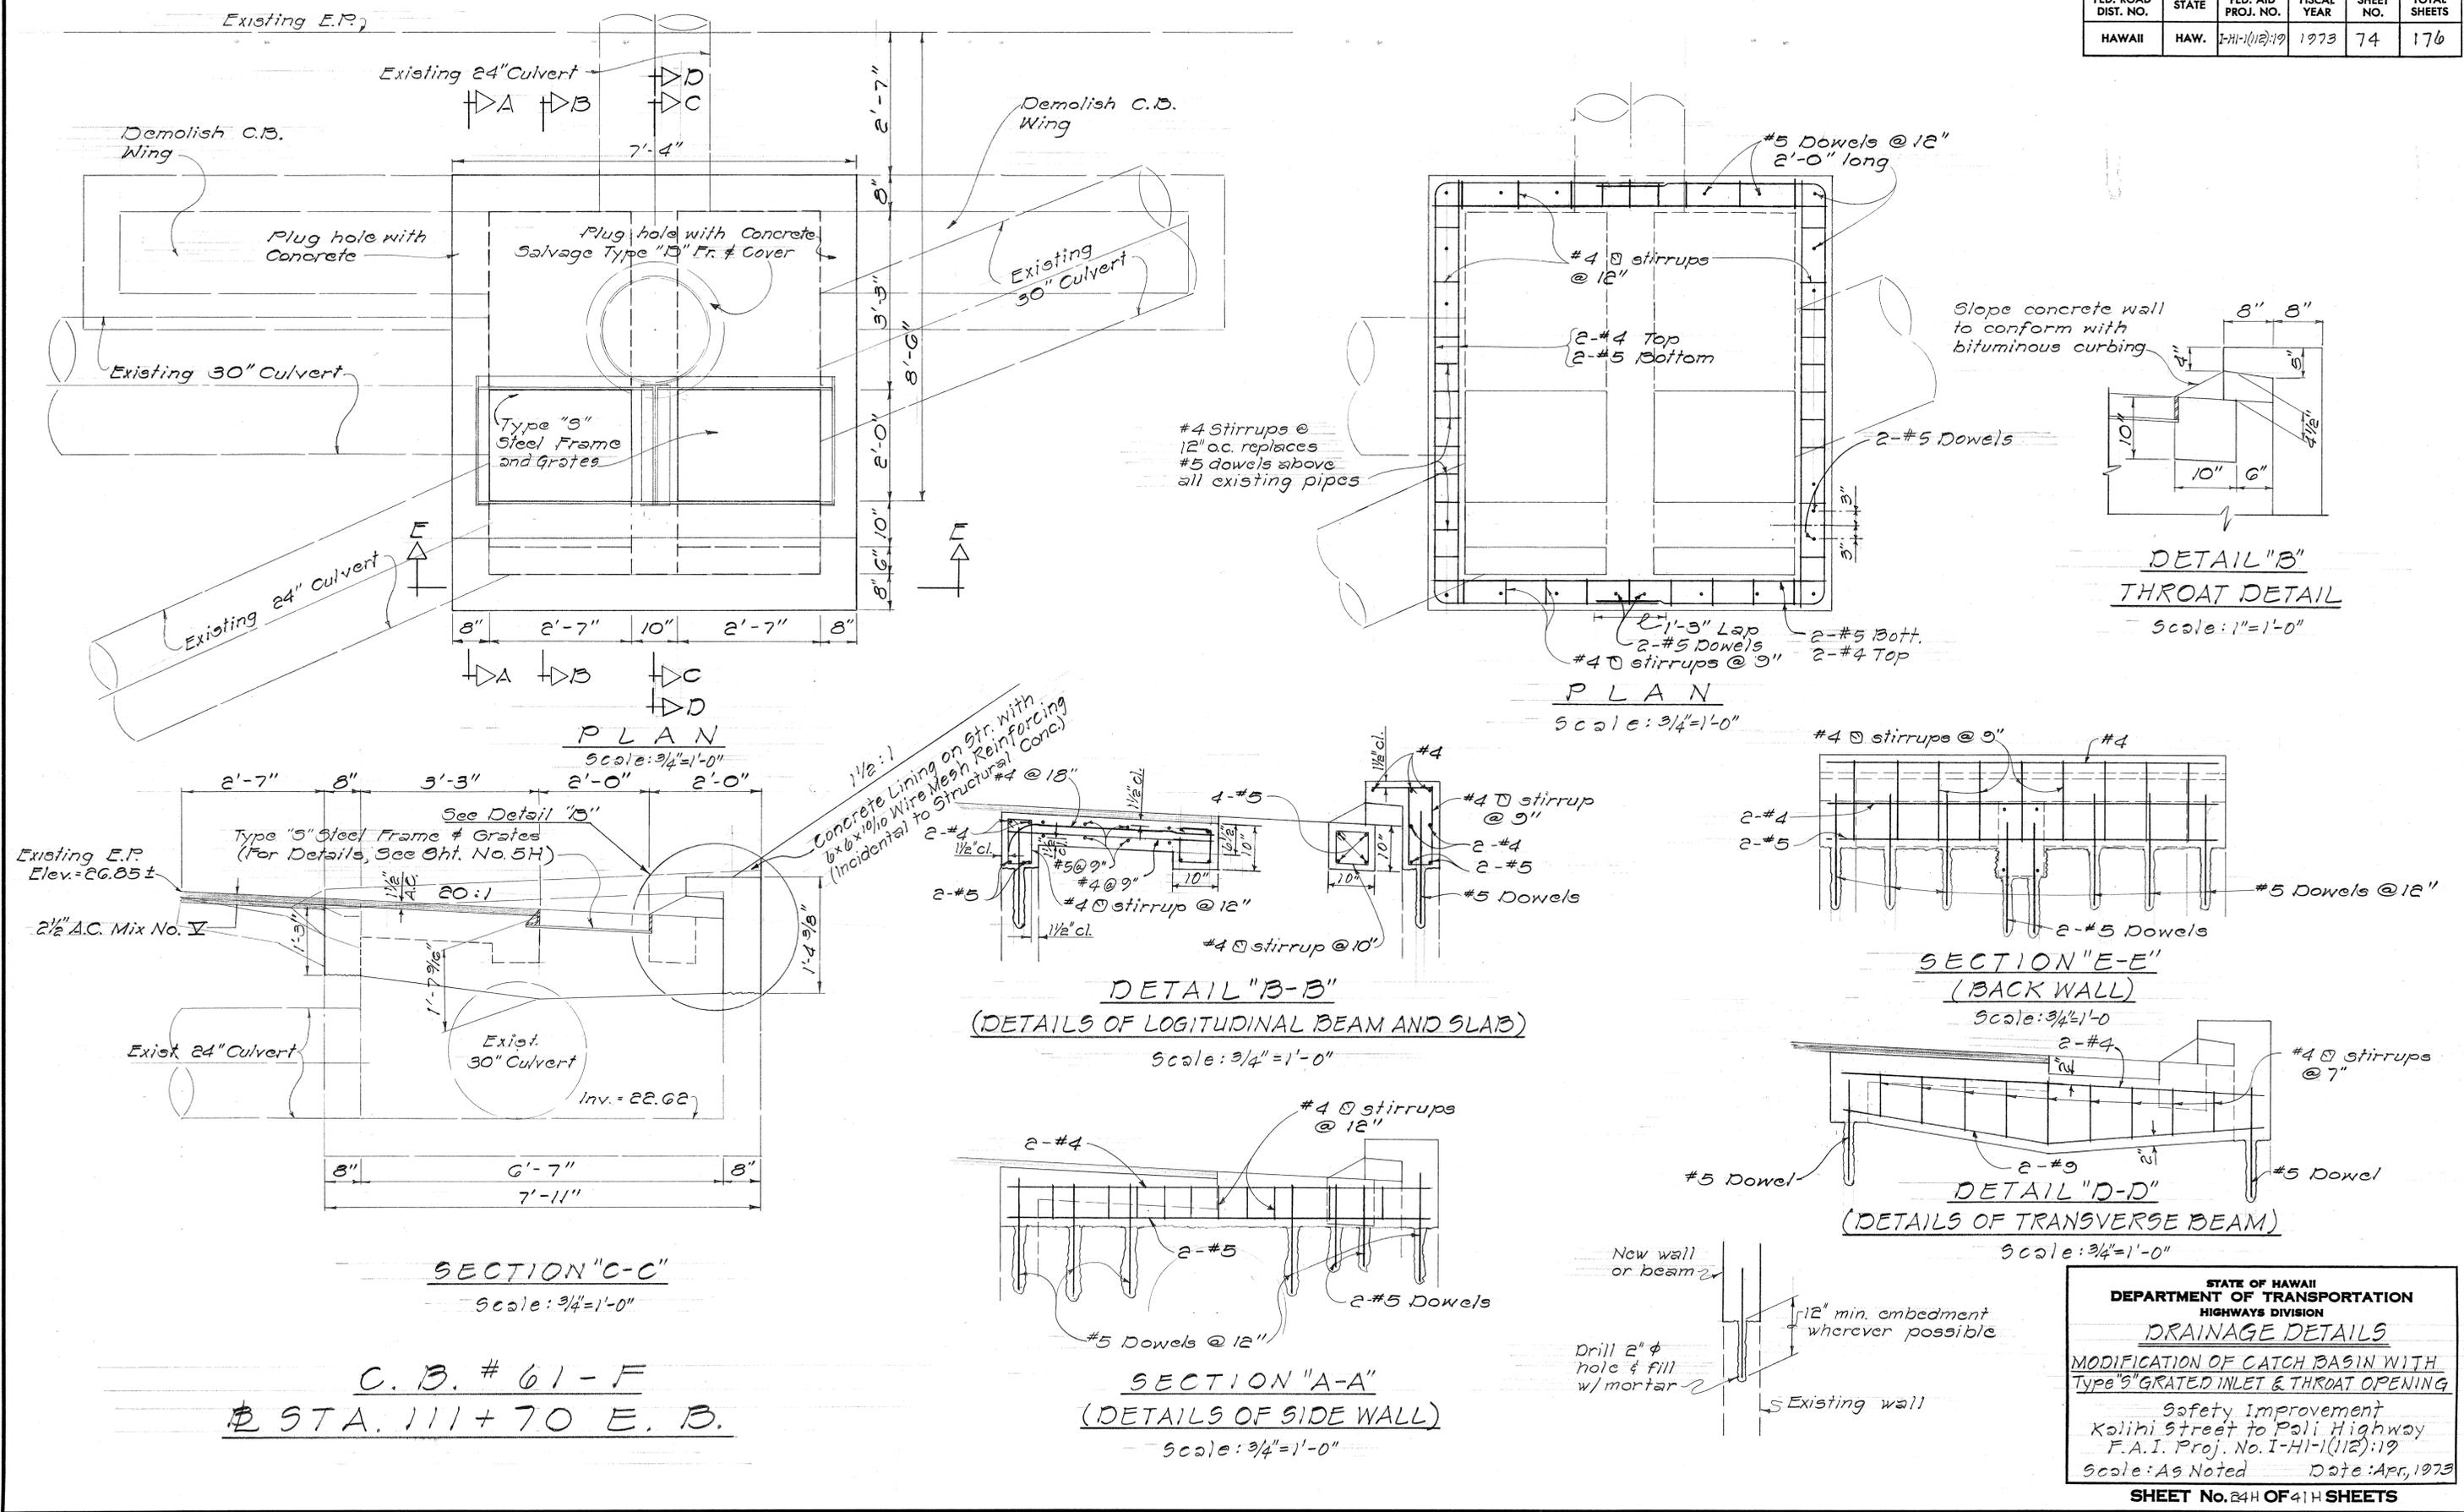

DATE	REVISION

DESIGNED BY	CHECKED BY
DRAWN BY	
NO. 1	

STATE OF HAWAII
DEPARTMENT OF TRANSPORTATION
HIGHWAYS DIVISION

DRAINAGE DETAILS

MODIFICATION OF CATCH BASIN WITH
Type "S" GRATED INLET & THROAT OPENING

Safety Improvement
Kalihi Street to Pali Highway
F.A.I. Proj. No. I-HI-1(12):19
Scale: As Noted Date: Apr. 1973

SHEET No. 24H OF 41H SHEETS

C.B. # 61-F
STA. 111+70 E.B.



SECTION "A-A"
(DETAILS OF SIDE WALL)
Scale: 3/4" = 1'-0"

DETAIL "B-B"
(DETAILS OF LOGITUDINAL BEAM AND SLAB)
Scale: 3/4" = 1'-0"

SECTION "E-E"
(BACK WALL)
Scale: 3/4" = 1'-0"

DETAIL "D-D"
(DETAILS OF TRANSVERSE BEAM)
Scale: 3/4" = 1'-0"



SECTION "C-C"
Scale: 3/4" = 1'-0"

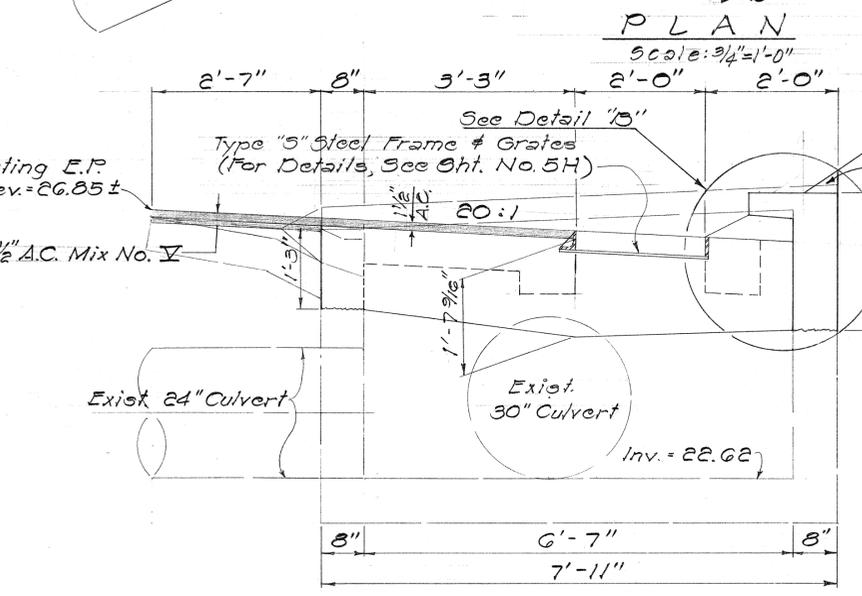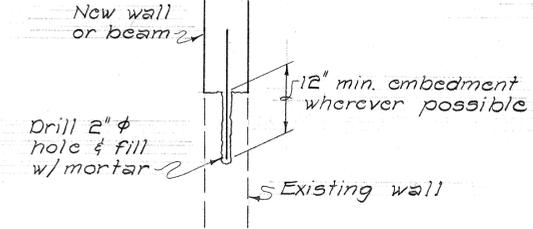



PLAN
Scale: 3/4" = 1'-0"

PLAN
Scale: 3/4" = 1'-0"


DETAIL "B"
THROAT DETAIL
Scale: 1" = 1'-0"

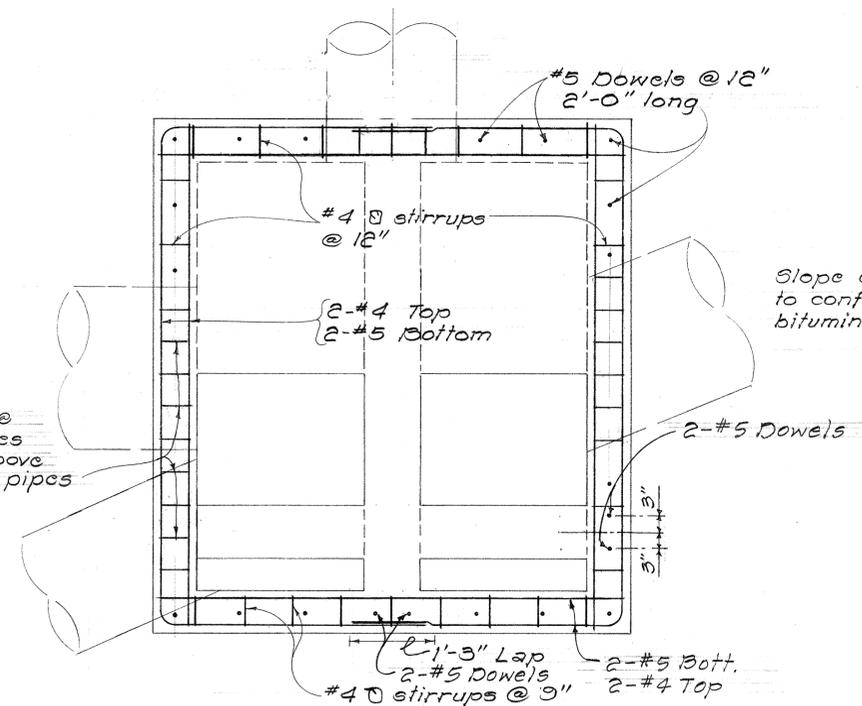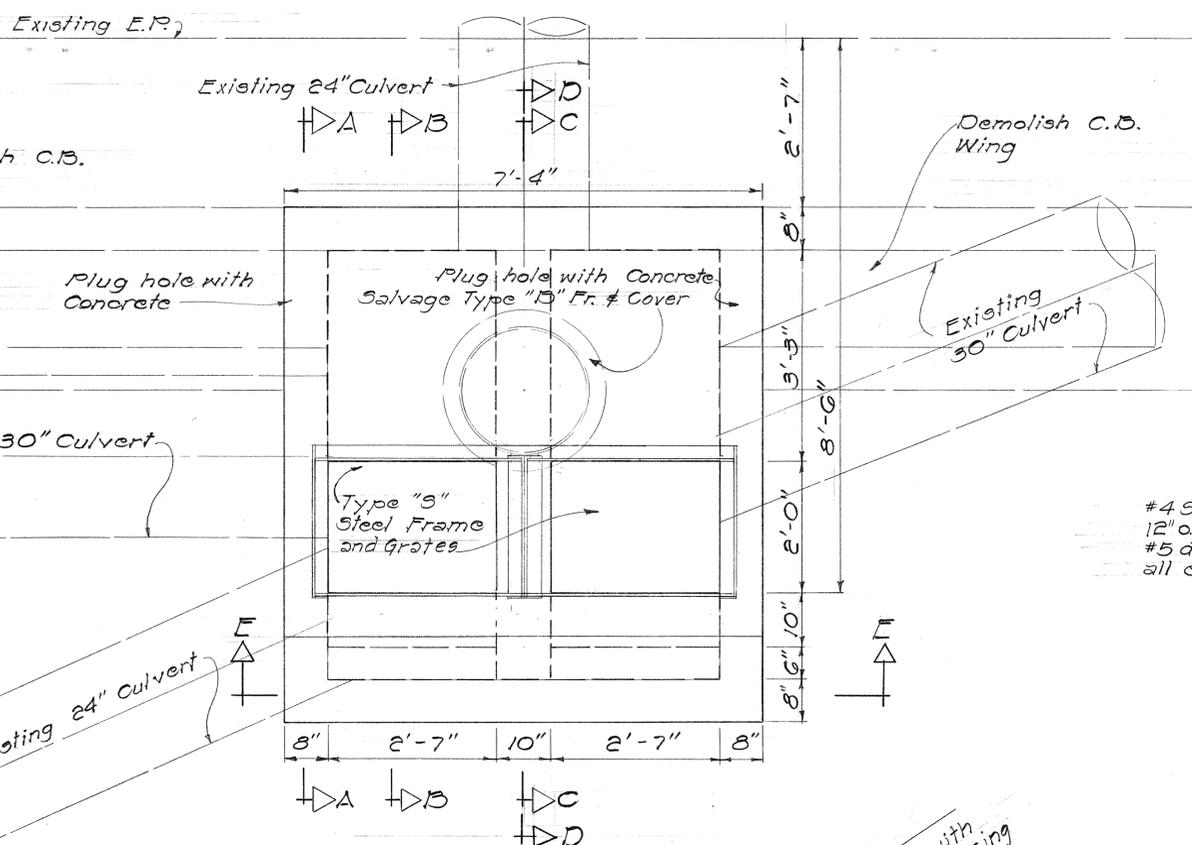

FED. ROAD DIST. NO.	STATE	FED. AID PROJ. NO.	FISCAL YEAR	SHEET NO.	TOTAL SHEETS
HAWAII	HAW.	I-HI-1(112)10	1973	75	176

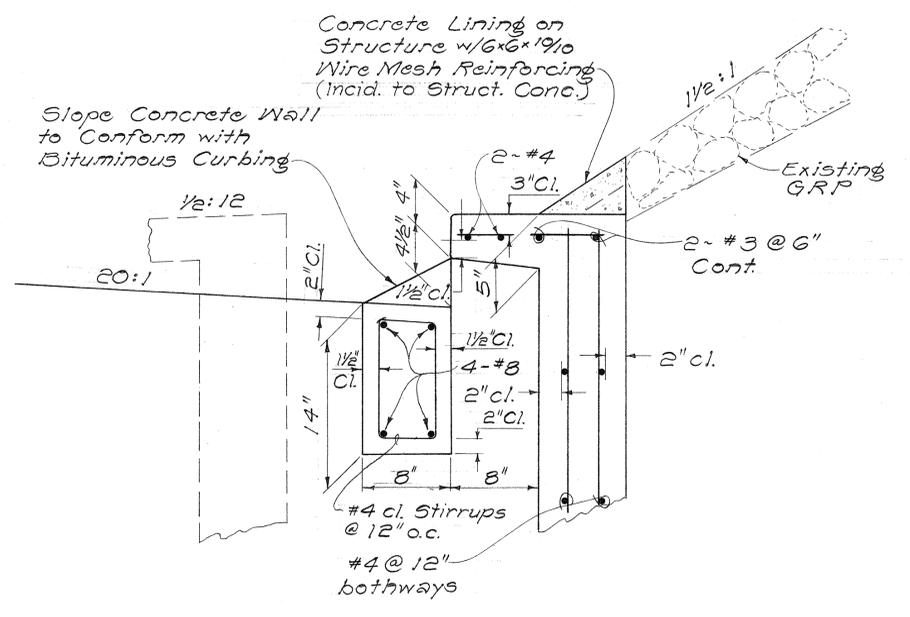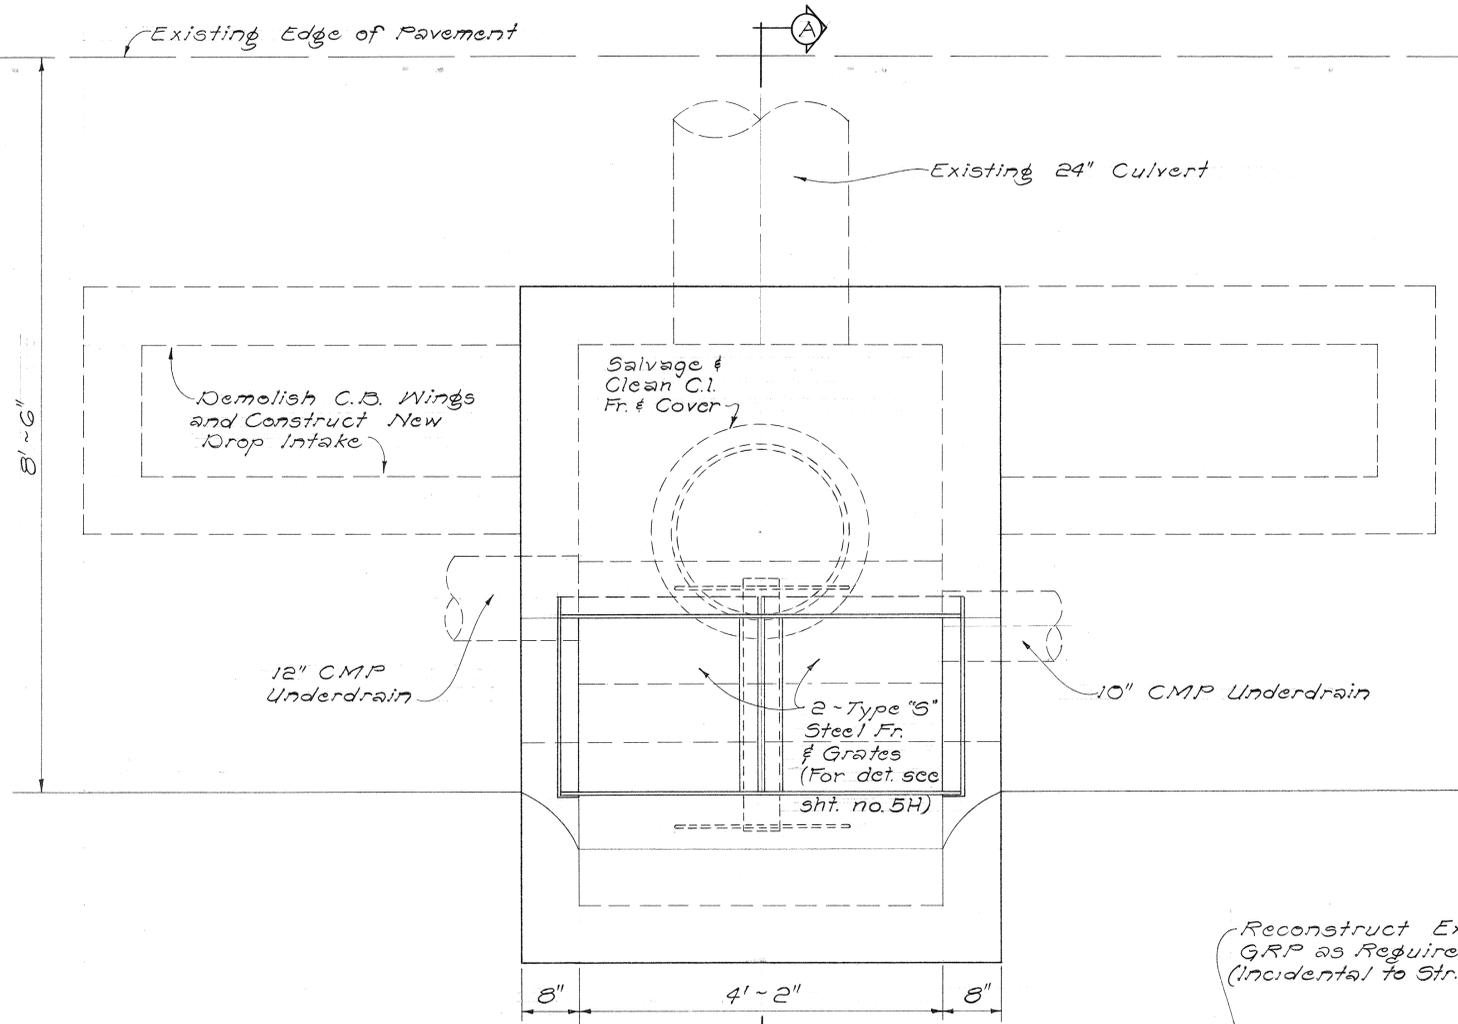

DETAIL "A"
Scale: 1/2" = 1'-0"

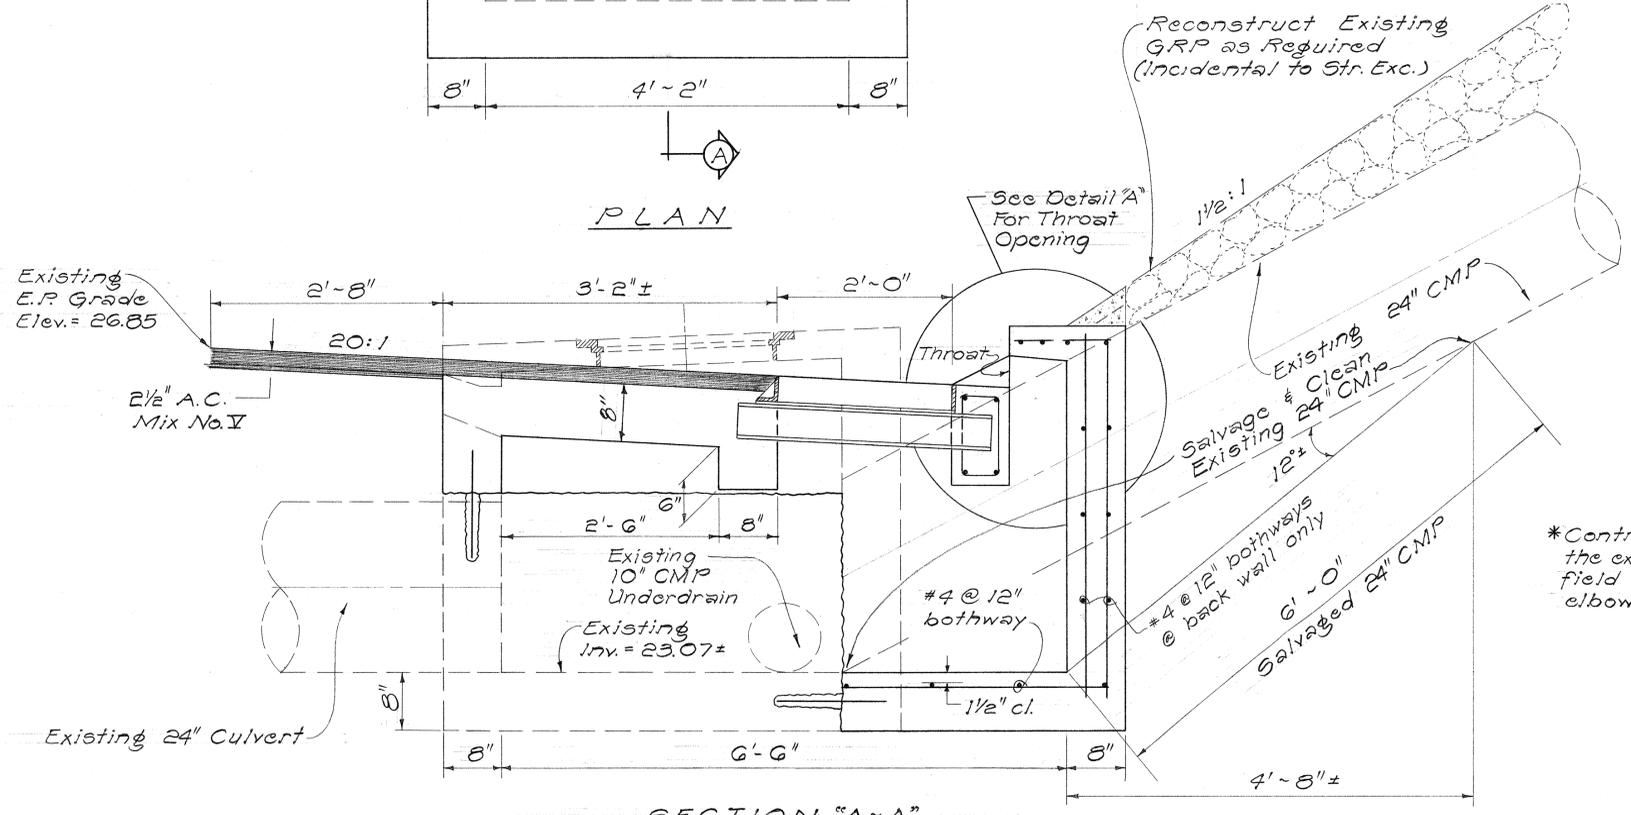

SECTION "A-A"
C.B. #60-F STA. 111+70 W.B.
Scale: 1" = 1'-0"





NOTE:
Except as noted on this sheet, see typical section for notes, dimension, and reinforcing steel details for Type "S" Grated Drop Intake on sht. no. 39H

*Contractor shall verify the exact angle in the field before fabricating elbow.

STATE OF HAWAII
DEPARTMENT OF TRANSPORTATION
HIGHWAYS DIVISION
DRAINAGE DETAILS
MODIFICATION OF CATCH BASIN
WITH TYPE "S" GRATED
AND THROAT INLET
Safety Improvements
Kalihi Street To Pali Highway
F.A.I. Proj. No. I-HI-1(112)10
Scale As Noted Date: Apr. 1973
SHEET No. 25H OF 41H SHEETS

DATE	_____
REVIEW PLOTTED BY	_____
DRAWN BY	_____
DESIGNED BY	_____
CHECKED BY	_____
NO. _____	

FED. ROAD DIST. NO.	STATE	FED. AID PROJ. NO.	FISCAL YEAR	SHEET NO.	TOTAL SHEETS
HAWAII	HAW.	I-11-(112):19	1973	76	176

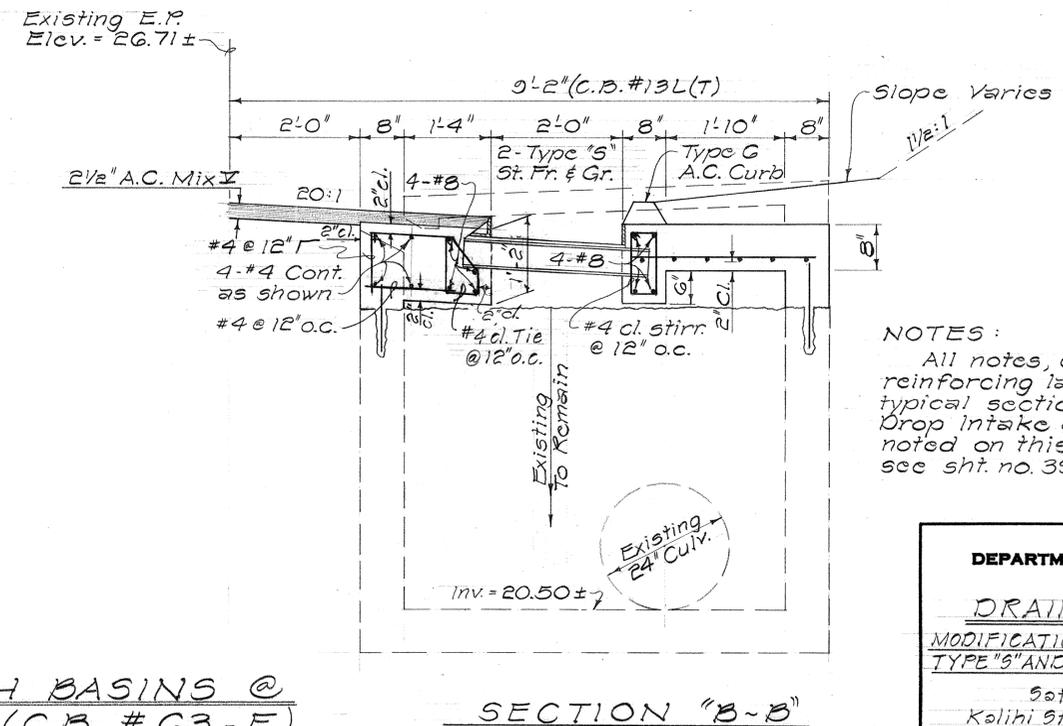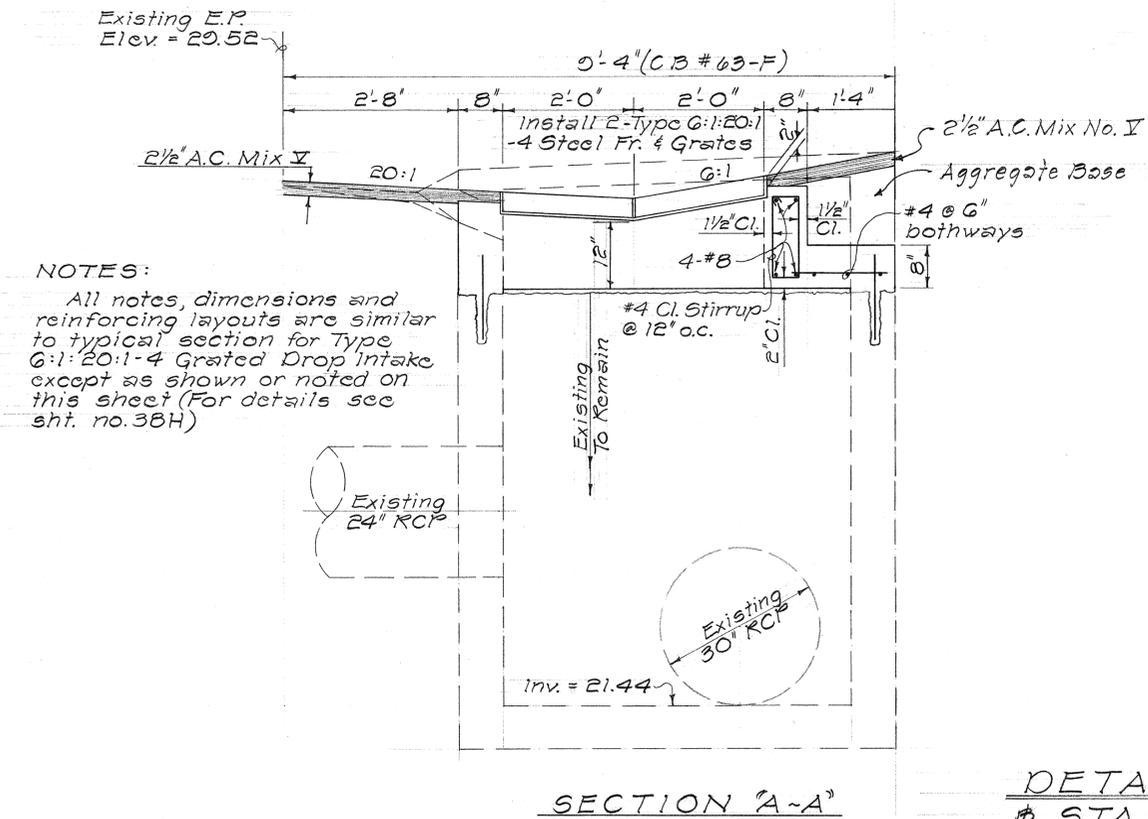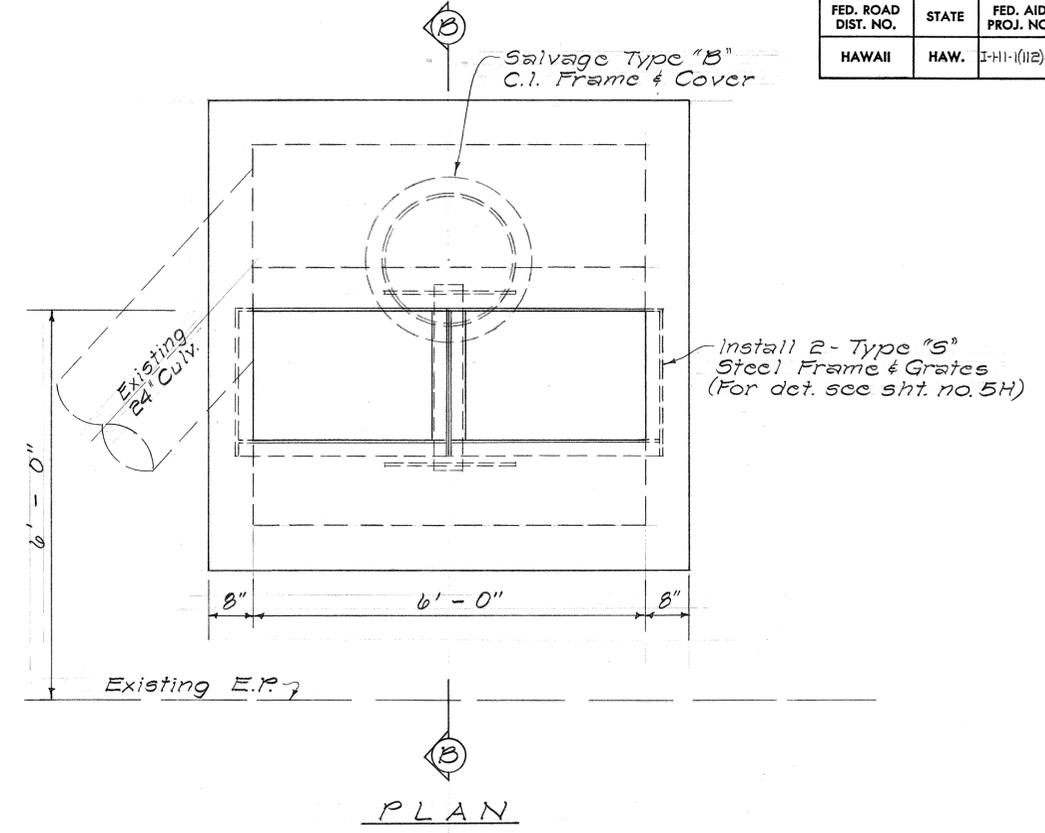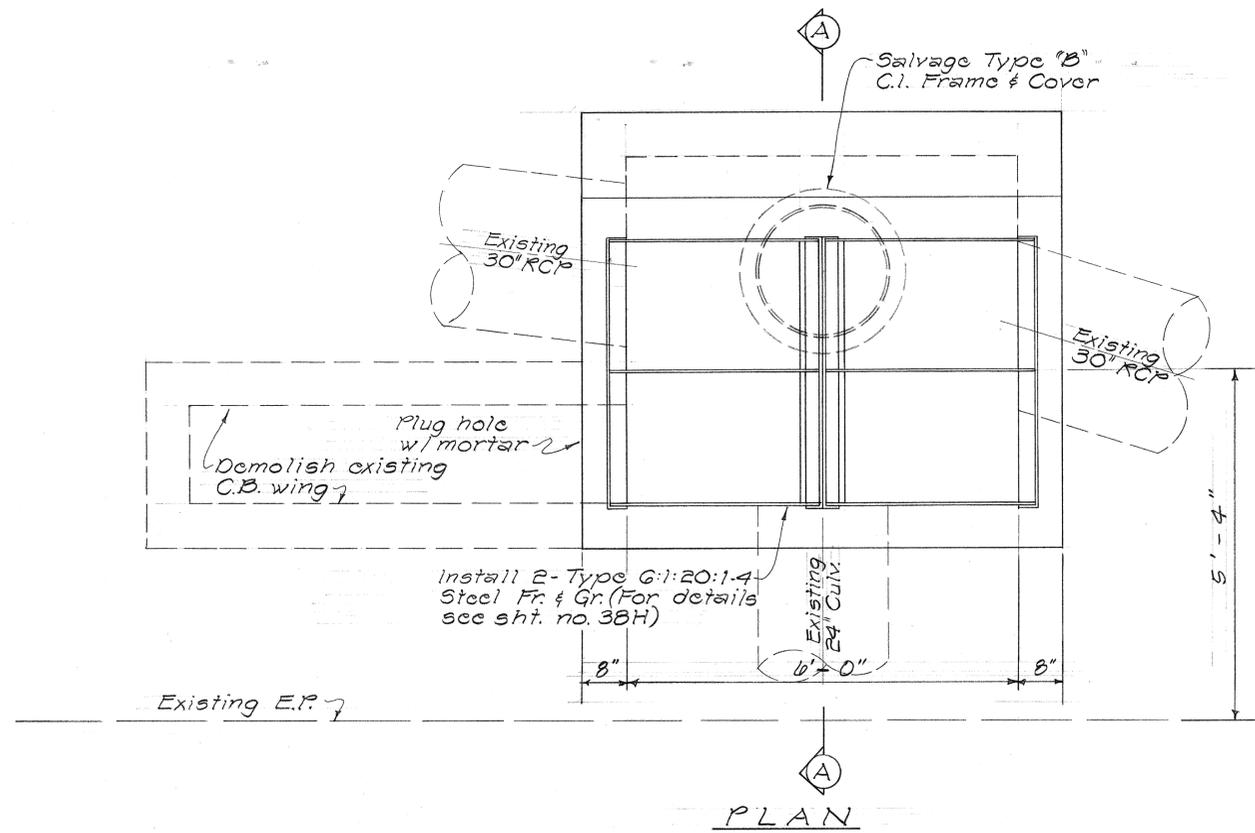

NOTES:

All notes, dimensions and reinforcing layouts are similar to typical section for Type G:1:20:1-4 Grated Drop Intake except as shown or noted on this sheet (For details see sht. no. 38H)

NOTES:

All notes, dimensions and reinforcing layouts are similar to typical section for Type "S" Grated Drop Intake except as shown or noted on this sheet. (For details see sht. no. 39H)

DETAILS OF CATCH BASINS @
 @ STA. 114 + 50 E.B. (C.B. #63-F)
 @ STA. 145 + 78 W.B. (C.B. #13-L(T))

Scale: 3/4" = 1'-0"

STATE OF HAWAII
 DEPARTMENT OF TRANSPORTATION
 HIGHWAYS DIVISION


DRAINAGE DETAILS
 MODIFICATION OF CATCH BASIN WITH TYPE "S" AND G:1:20:1-4 GRATED INLETS

Safety Improvements
 Kalihī Street to Pali Highway
 F.A.I. Proj. No. I-HI-1(12):19
 Scale: 3/4" = 1'-0" Date: April, 1973


SHEET No. 26H OF 41 HSHEETS

DATE	
REVISION	
DESIGNED BY	
CHECKED BY	
NO.	

FED. ROAD DIST. NO.	STATE	FED. AID PROJ. NO.	FISCAL YEAR	SHEET NO.	TOTAL SHEETS
HAWAII	HAW.	I-HI-1(112):10	1973	77	176

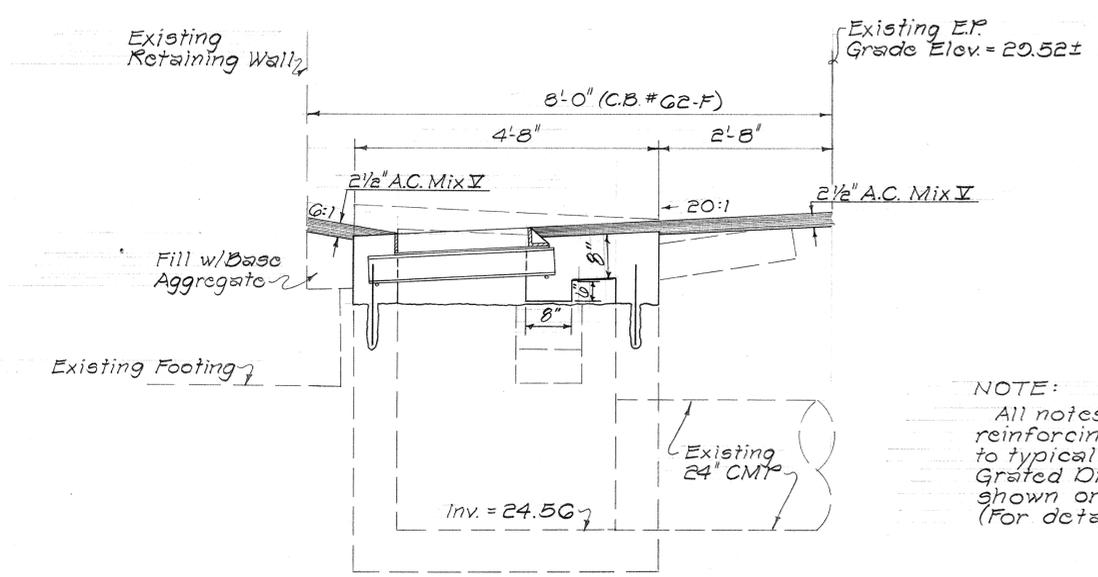


SECTION "A-A"

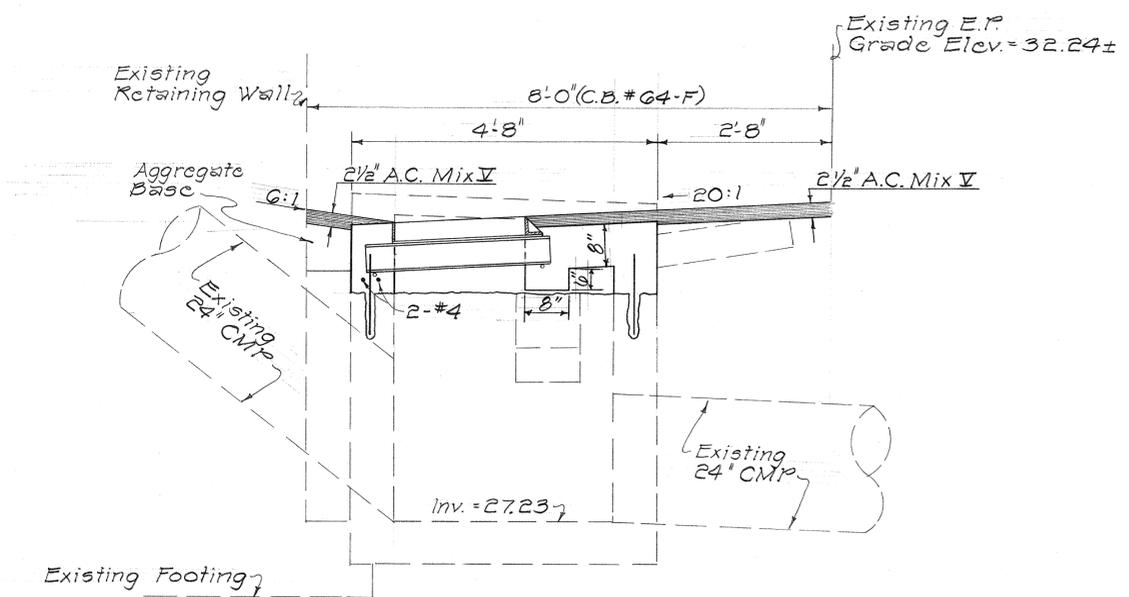

SECTION "B-B"

NOTE:
All notes, dimensions and reinforcing layouts are similar to typical section for Type "S" Grated Drop Intake except as shown or noted on this sheet. (For details see sht. no. 39H)

Install 2-Type "S" Steel Frame and Grates. For details see sht. no. 5H

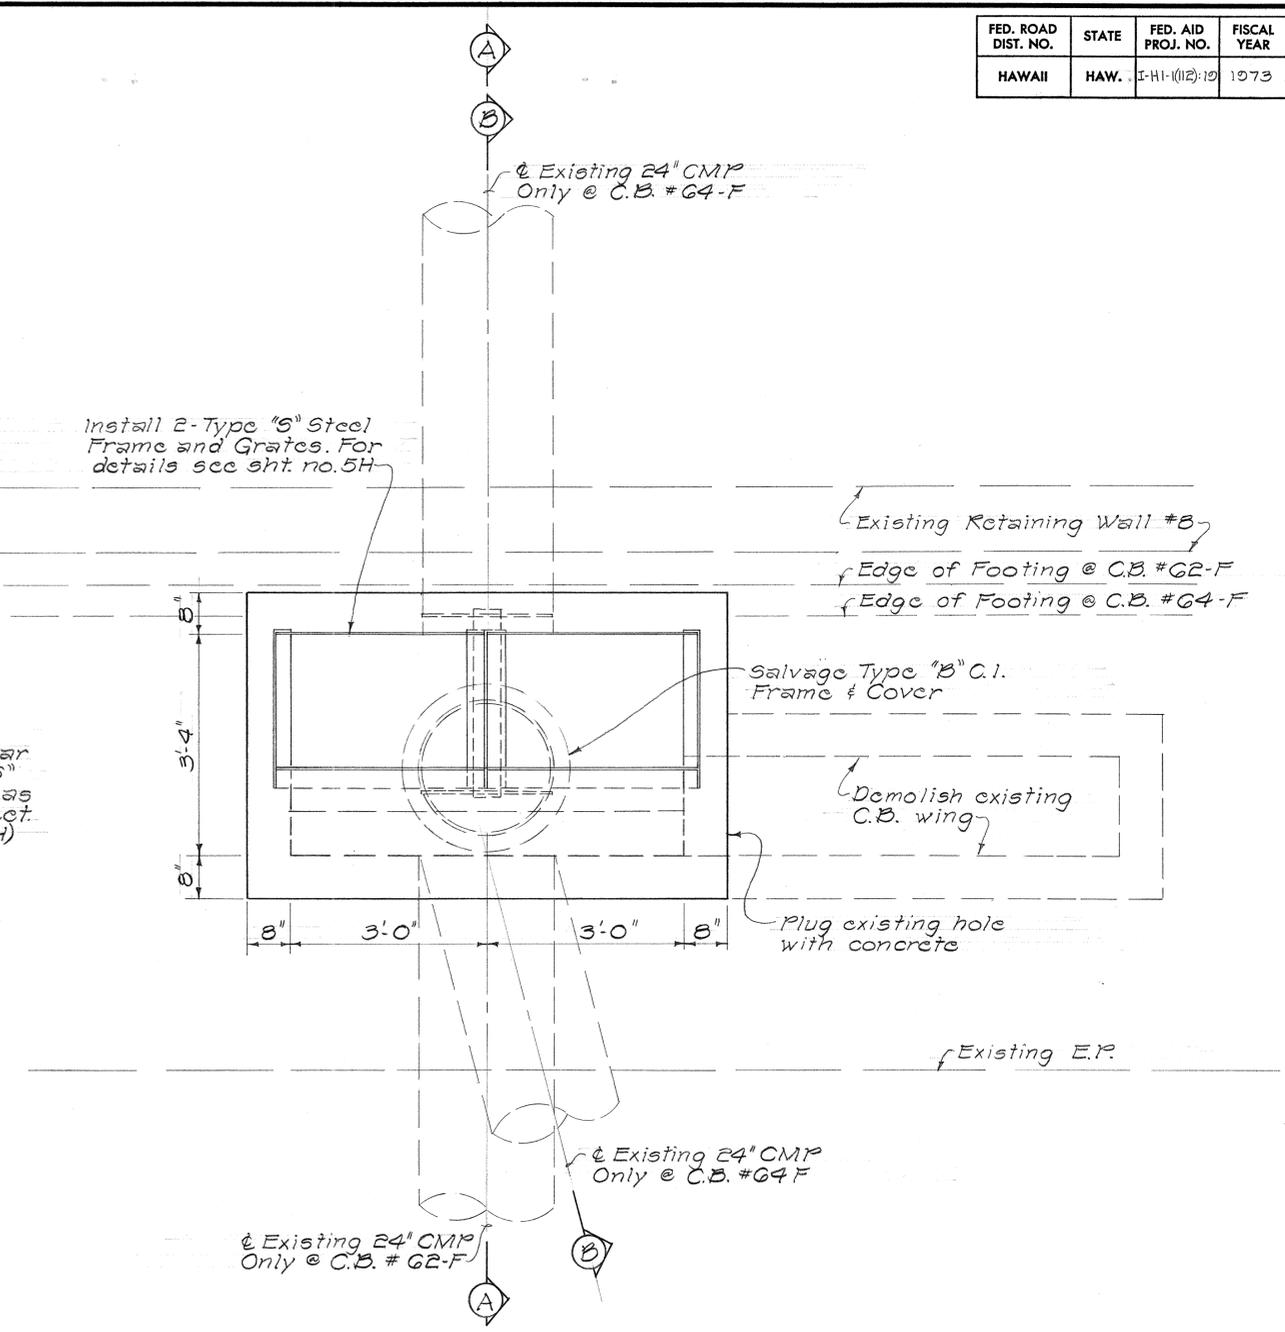

PLAN


DETAILS OF CATCH BASINS @
RAMP "7" STA. 7+50 (C.B. #64-F)
RAMP "7" STA. 9+90 (C.B. #62-F)

Scale: 3/4" = 1'-0"


DATE	
DESIGNED BY	
CHECKED BY	
NO. _____	

STATE OF HAWAII
DEPARTMENT OF TRANSPORTATION
HIGHWAYS DIVISION
DRAINAGE DETAILS
MODIFICATION OF CATCH BASINS
W/TYPE "S" GRATED INLET
Safety Improvements
Kalih Street to Pali Highway
F.A.I. Proj. No. I-HI-1(112):10
Scale: 3/4" = 1'-0" Date: Apr, 1973
SHEET No. 27H OF 41 HSHEETS

FED. ROAD DIST. NO.	STATE	FED. AID PROJ. NO.	FISCAL YEAR	SHEET NO.	TOTAL SHEETS
HAWAII	HAW.	I-HI-1(112)-10	1973	78	176

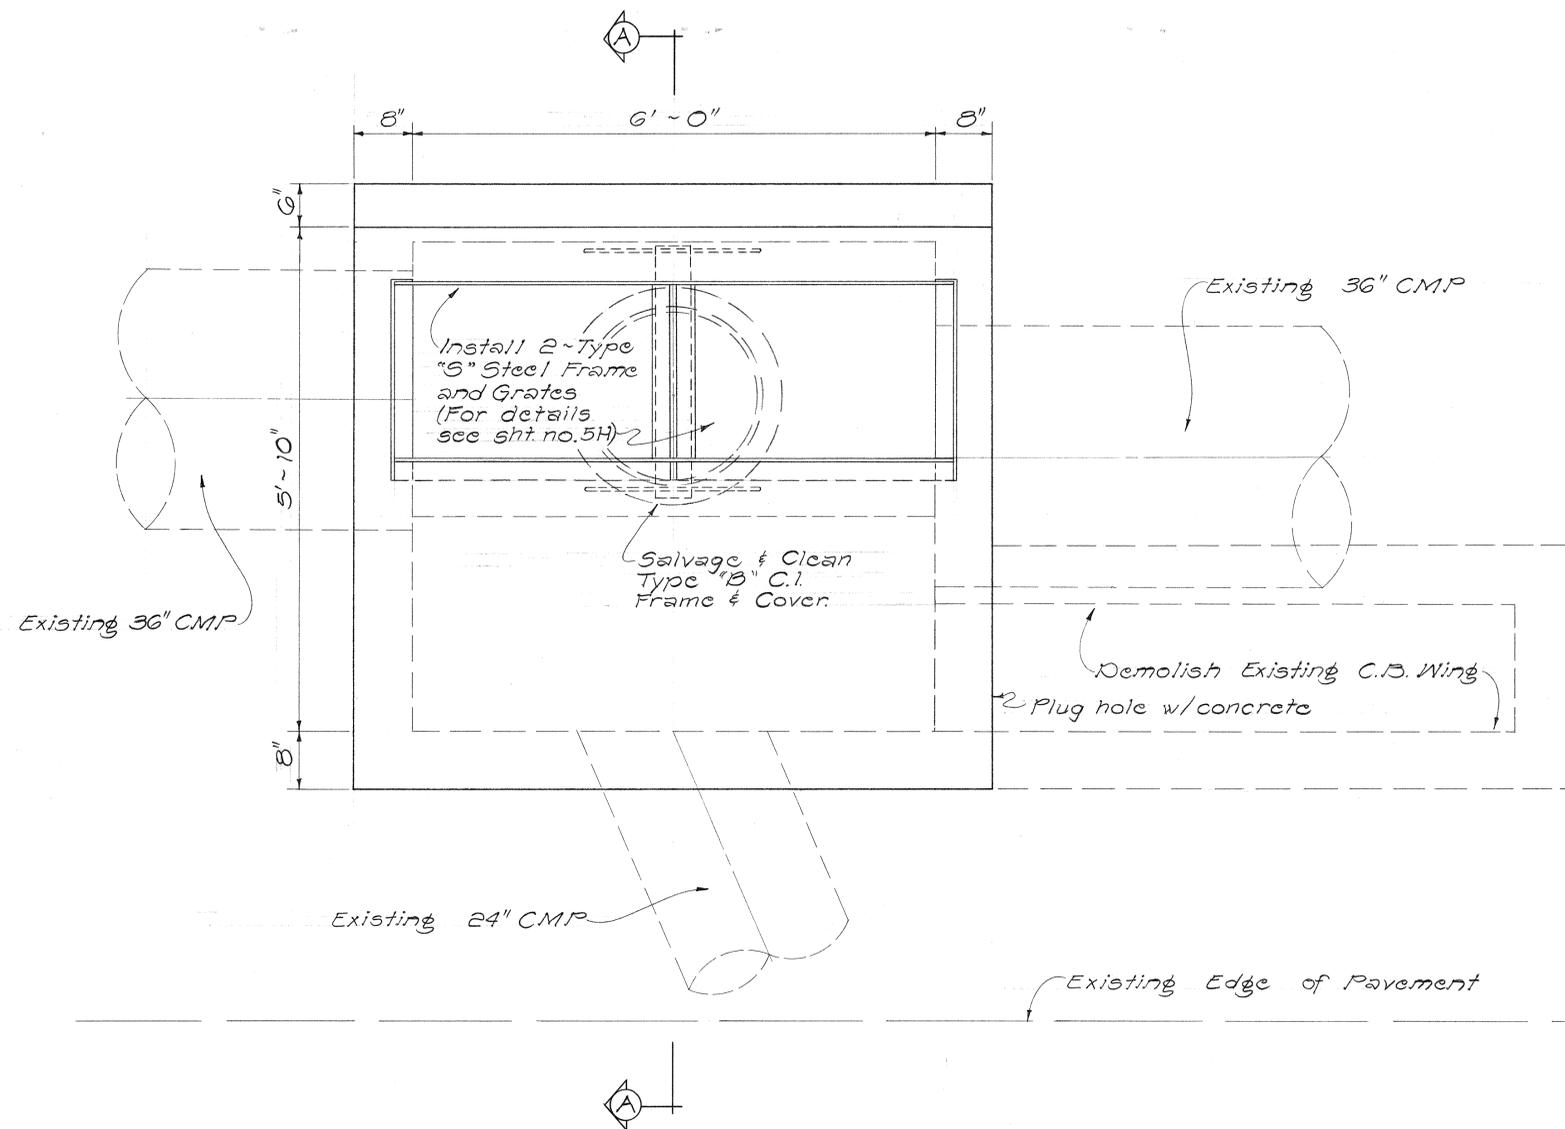

PLAN

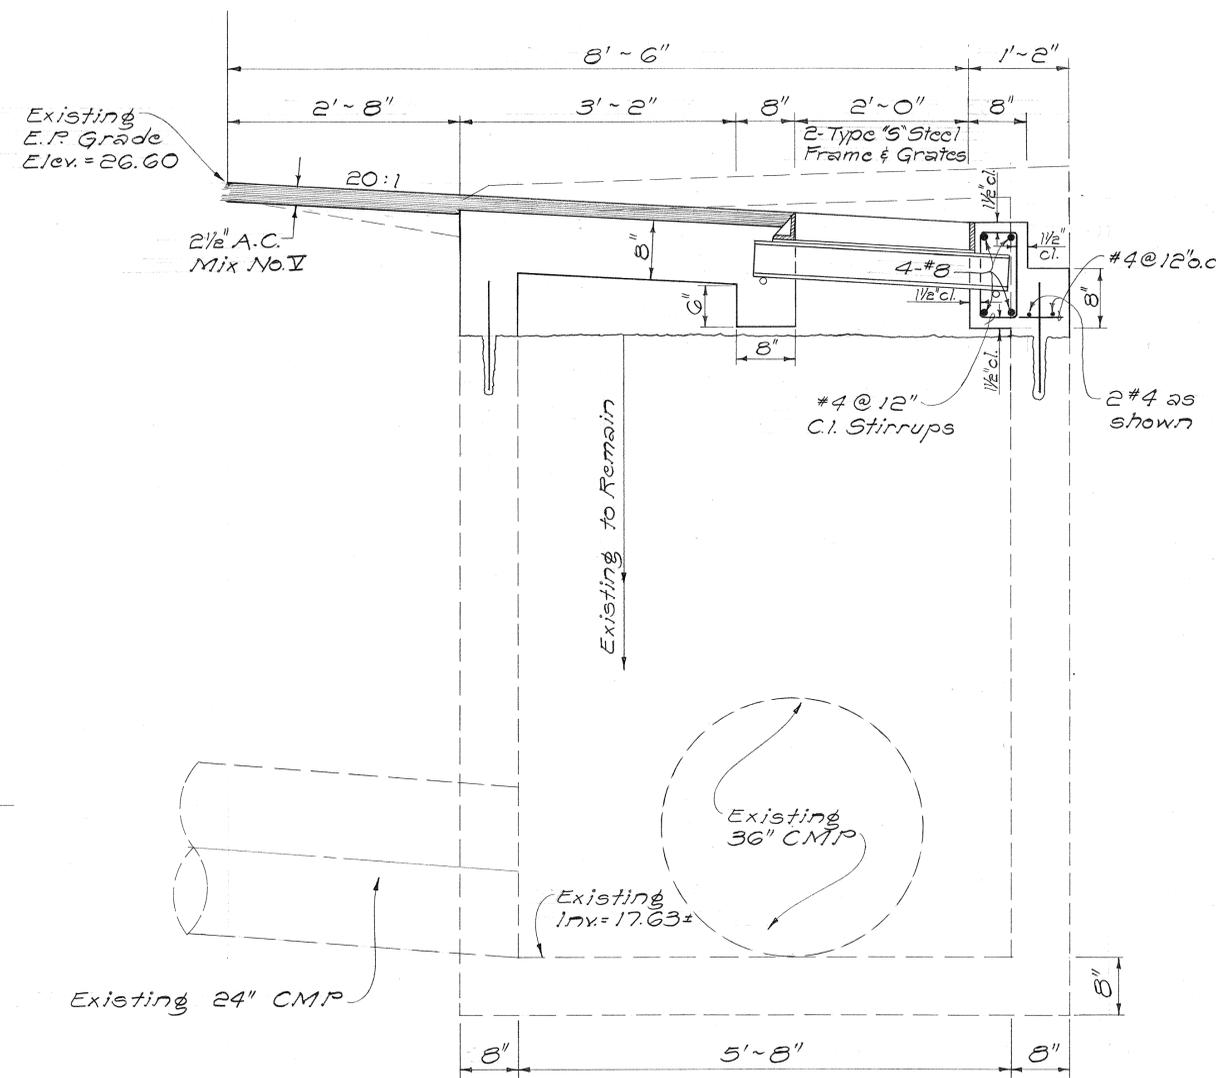

SECTION "A-A"

NOTE:

Except as noted on this sheet see typical section for notes dimension and reinforcing steel details for Type "S" Grated Drop Intake on sh. no. 39H

DETAIL OF C.B. #70-F @ RAMP 6 STA. 9+25

DATE	_____
DESIGNED BY	_____
CHECKED BY	_____
DRAWN BY	_____
REVISIONS	_____
NO.	_____

STATE OF HAWAII
DEPARTMENT OF TRANSPORTATION
HIGHWAYS DIVISION


DRAINAGE DETAILS

MODIFICATIONS OF CATCH BASIN WITH TYPE "S" GRATED INLET

Safety Improvements
Kalini Street to Pali Highway
F.A.I. Proj. No. I-HI-1(112)-10
Scale: 1"=1'-0" Date: Apr, 1973

SHEET No. 28H OF 41 HSHEETS

FED. ROAD DIST. NO.	STATE	FED. AID PROJ. NO.	FISCAL YEAR	SHEET NO.	TOTAL SHEETS
HAWAII	HAW.	1H1-1(12)-10	1973	79	176

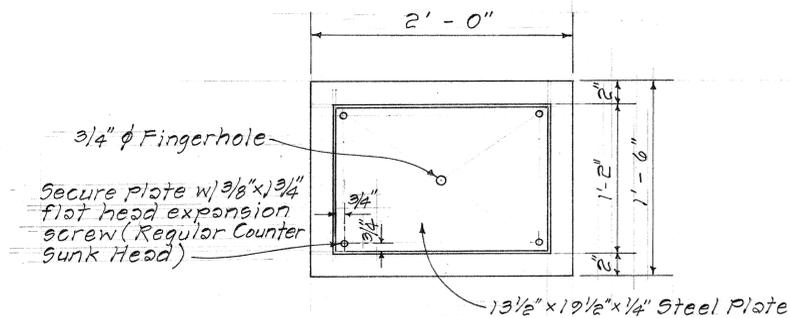


PLAN

Scale: 1 1/2" = 1'-0"


NOTE:

Demolishing existing concrete block, salvaging steel plate and cutting existing non-perforated pipe shall be considered incidental to Pay Item "Adjusting Underdrain Cleanouts"

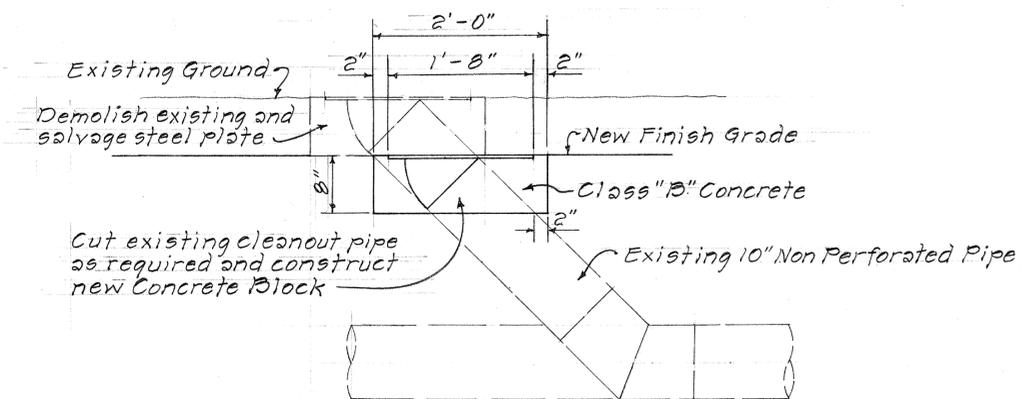


DETAILS FOR ADJUSTMENTS TO THE EXISTING UNDERDRAIN CLEANOUTS

Scale: 1" = 1'-0"

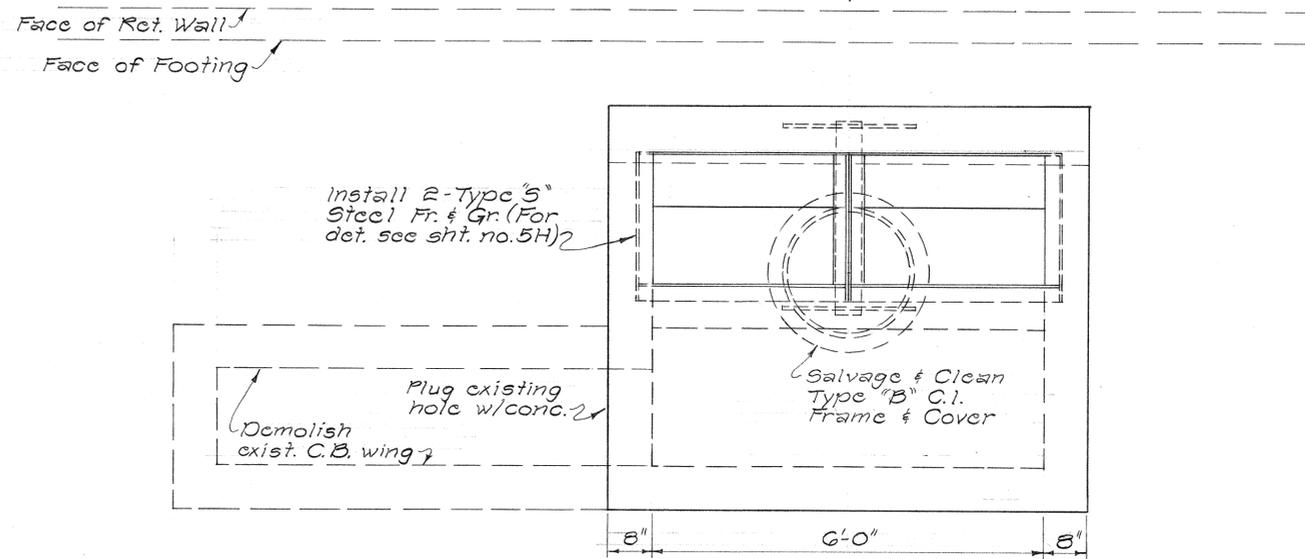

PLAN

Existing E.P.

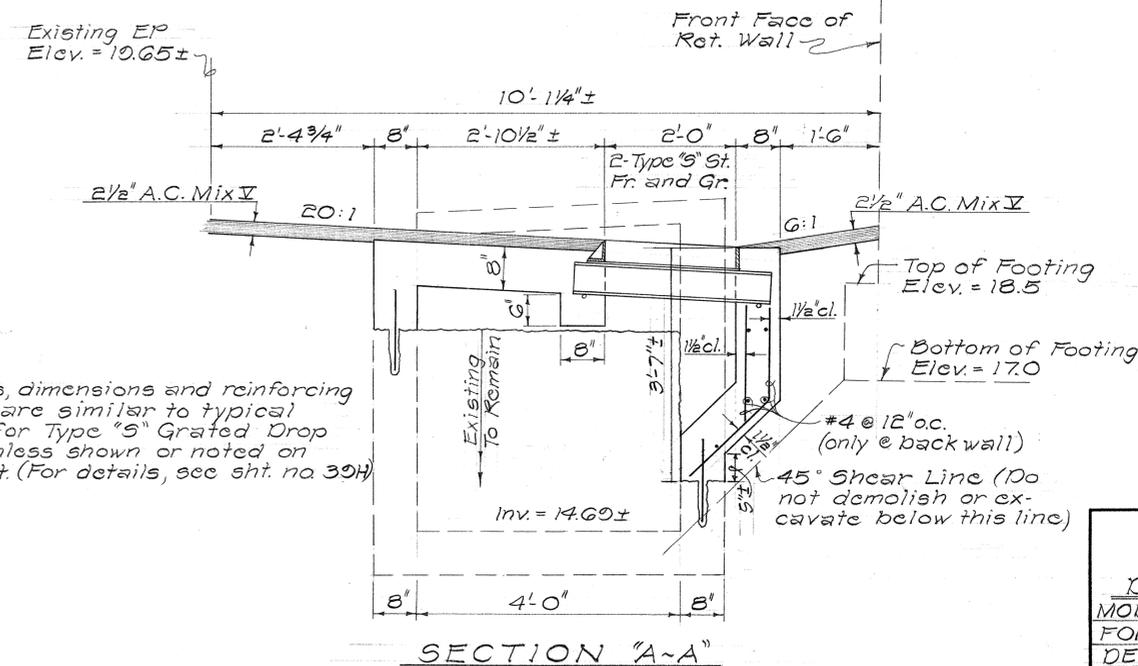

NOTE:

All notes, dimensions and reinforcing layouts are similar to typical section for Type "S" Grated Drop Intake unless shown or noted on this sheet. (For details, see sht. no. 39H)

DETAILS OF CATCH BASIN @

± STA. 125 + 75 W.B. (C.B. #74-F)

Scale: 3/4" = 1'-0"

STATE OF HAWAII
DEPARTMENT OF TRANSPORTATION
HIGHWAYS DIVISION


DRAINAGE DETAILS
MODIFICATIONS TO CATCH BASIN FOR TYPE "S" GRATED INLET & DETAILS FOR ADJUSTMENTS TO THE UNDERDRAIN CLEANOUTS

Safety Improvements
Kalini Street to Pali Highway
F.A.I. Proj. No. I-H1-1(172)-10
Scale As Noted Date: Apr. 1973


SHEET No. 20H OF 41H SHEETS

DATE
DESIGNED BY
CHECKED BY
NO.

FED. ROAD DIST. NO.	STATE	FED. AID PROJ. NO.	FISCAL YEAR	SHEET NO.	TOTAL SHEETS
HAWAII	HAW.	I-HI-1(112):10	1973	80	176

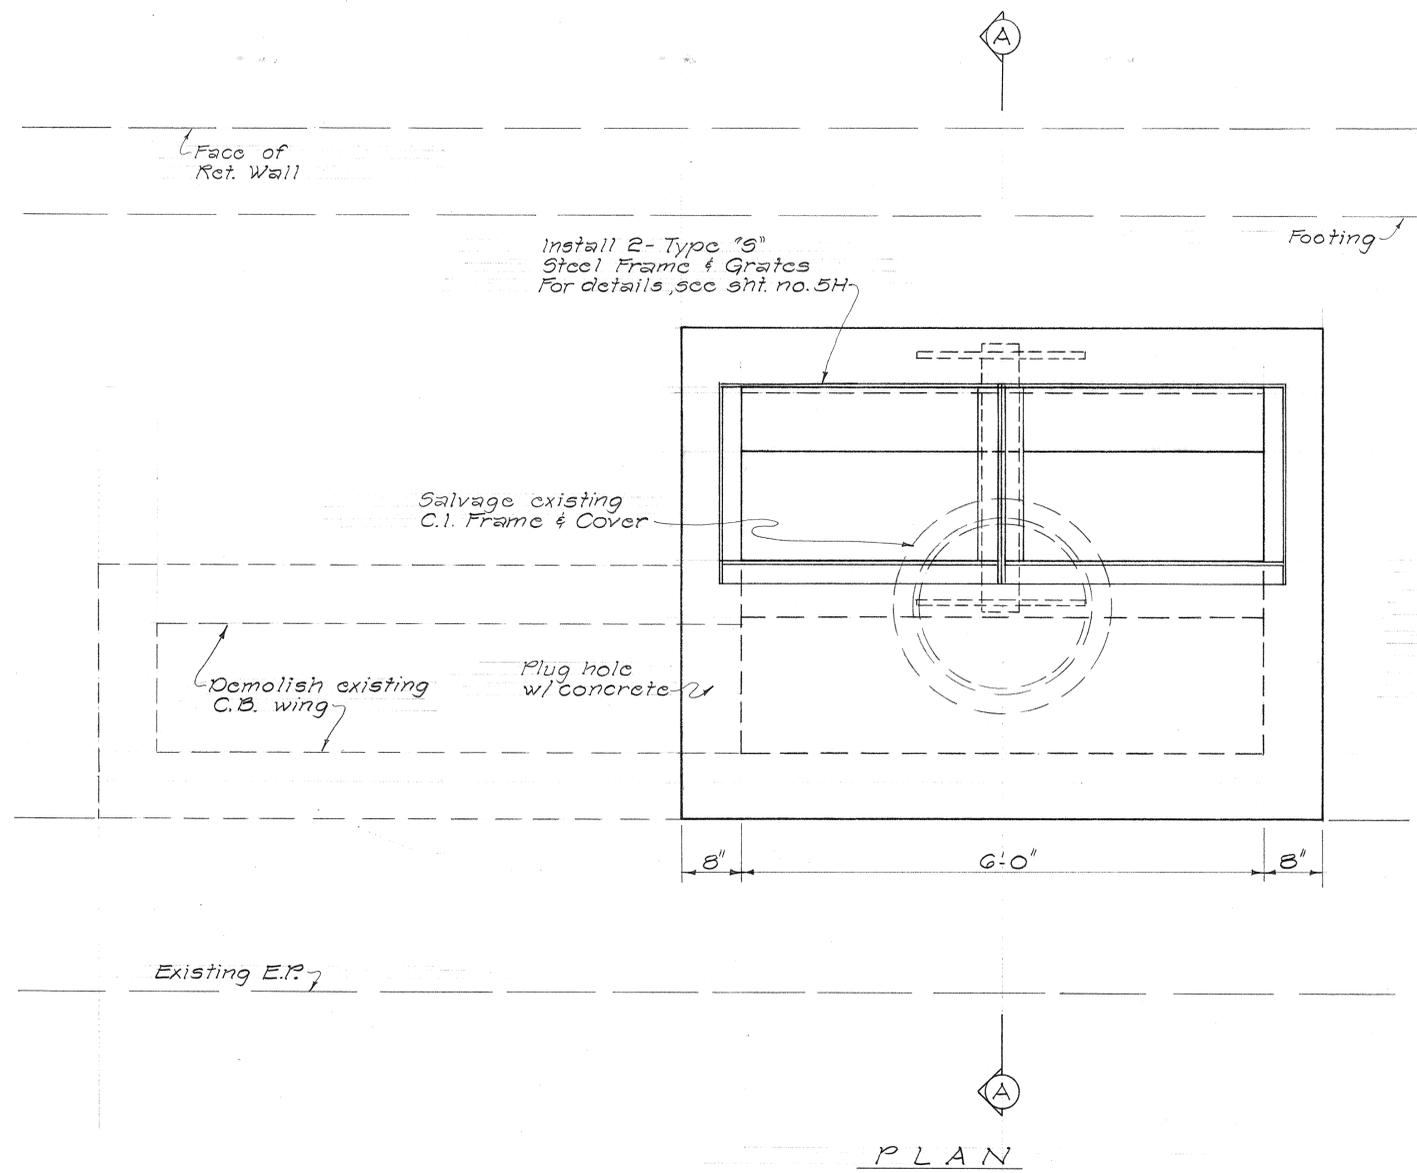

NOTES:
All notes, dimensions and reinforcing layouts are similar to typical section for Type "S" Grated Drop Intake except as shown or noted on this sheet. (For details see sht. no. 30H)

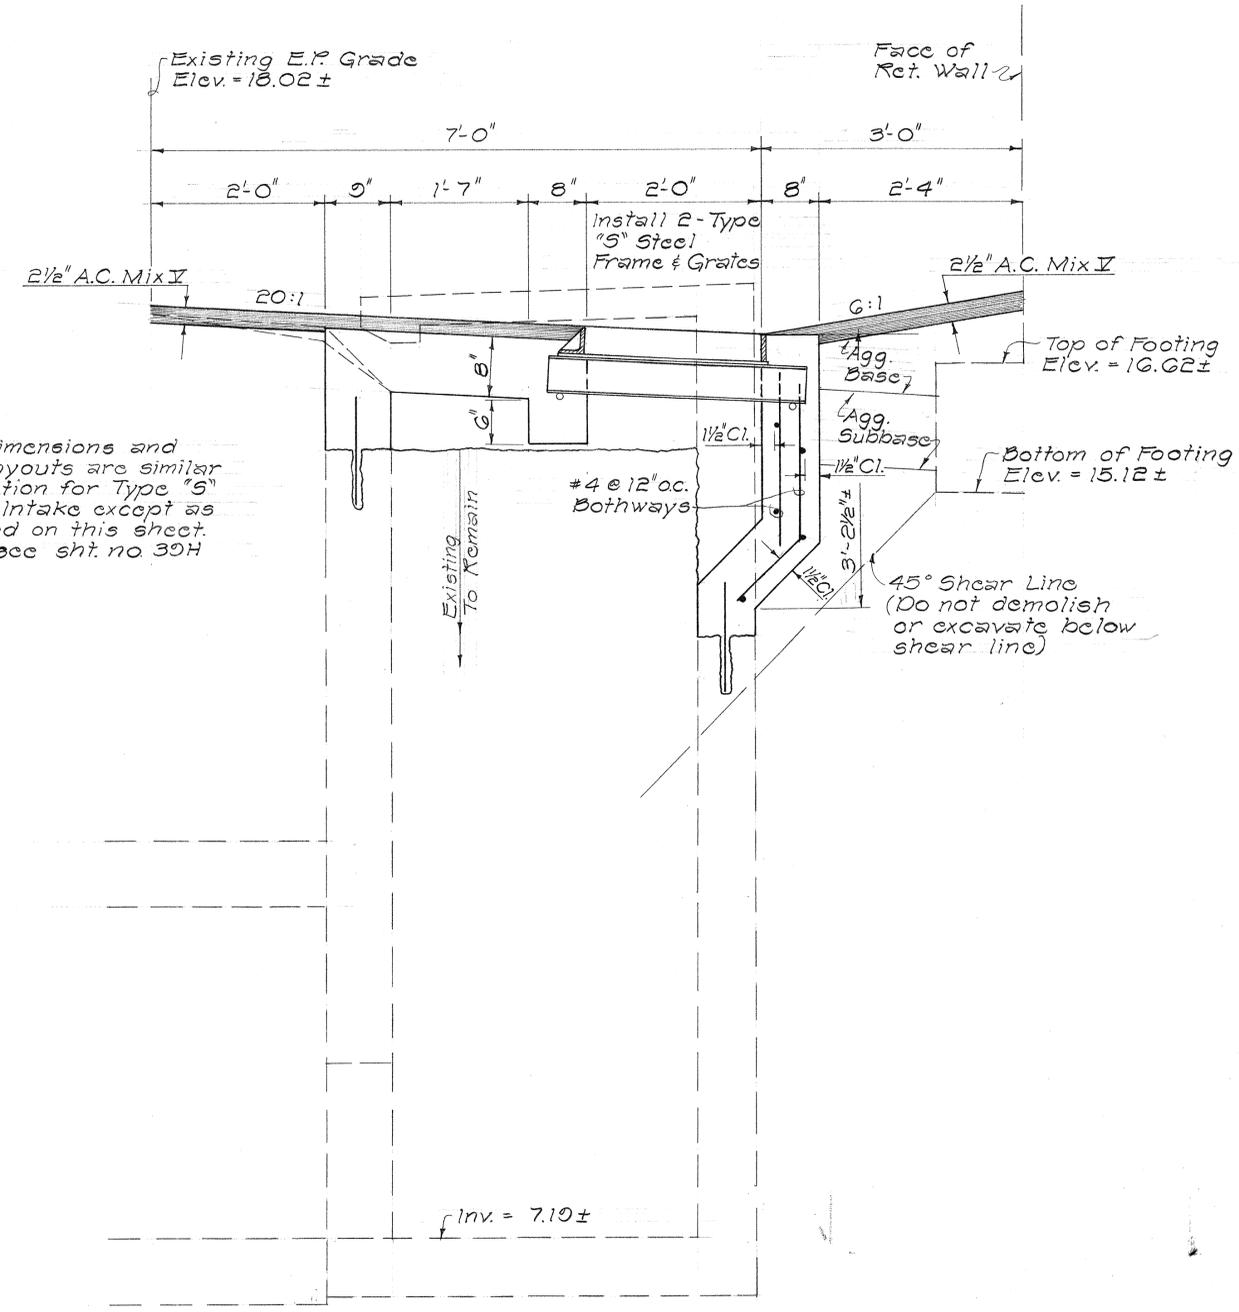

DETAILS OF CATCH BASIN @
ST. 128 + 25 W.B. (C.B. #1-F(T))
Scale: 1" = 1'-0"

STATE OF HAWAII
DEPARTMENT OF TRANSPORTATION
HIGHWAYS DIVISION

DRAINAGE DETAILS






MODIFICATION OF CATCH BASIN
WITH TYPE "S" GRATED INLET

Safety Improvements
Kalihi Street to Pali Highway
F.A.I. Proj. No. I-HI-1(112):10
Scale: 1" = 1'-0" Date: Apr. 1973

SHEET No. 30H OF 41 HSHEETS

DESIGNED BY	DATE
DRAWN BY	
CHECKED BY	
NO. OF SHEETS	
TOTAL SHEETS	

FED. ROAD DIST. NO.	STATE	FED. AID PROJ. NO.	FISCAL YEAR	SHEET NO.	TOTAL SHEETS
HAWAII	HAW.	I-H-1(112)-10	1973	81	176

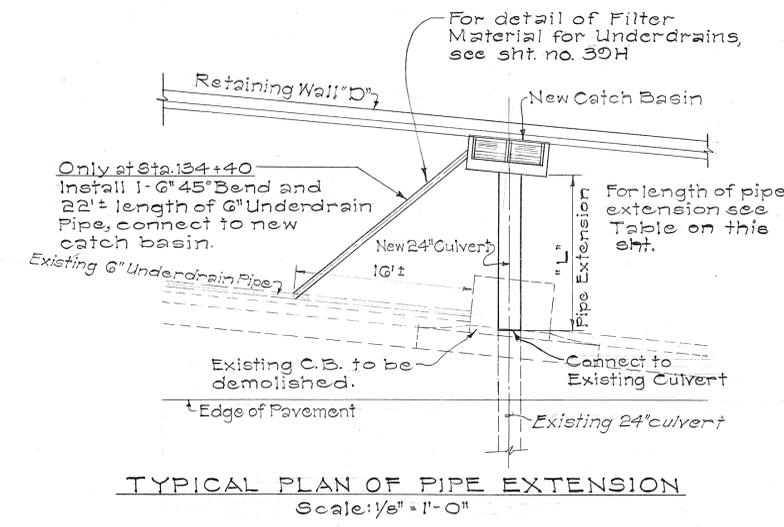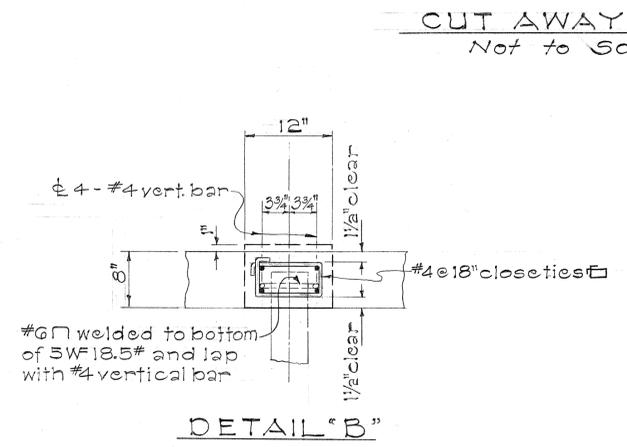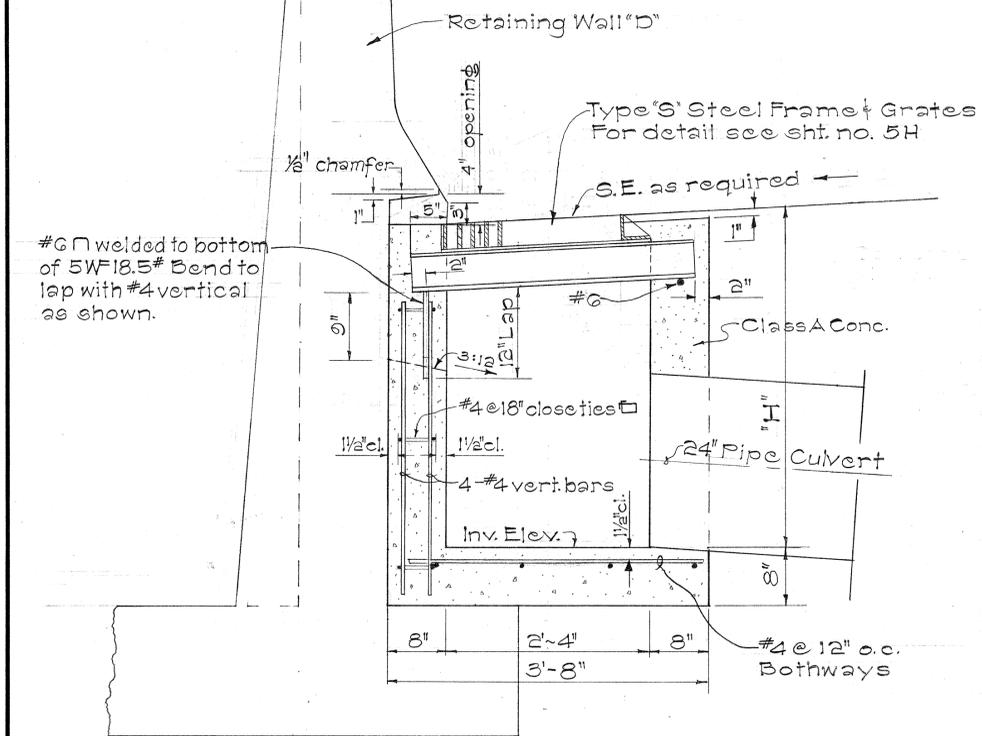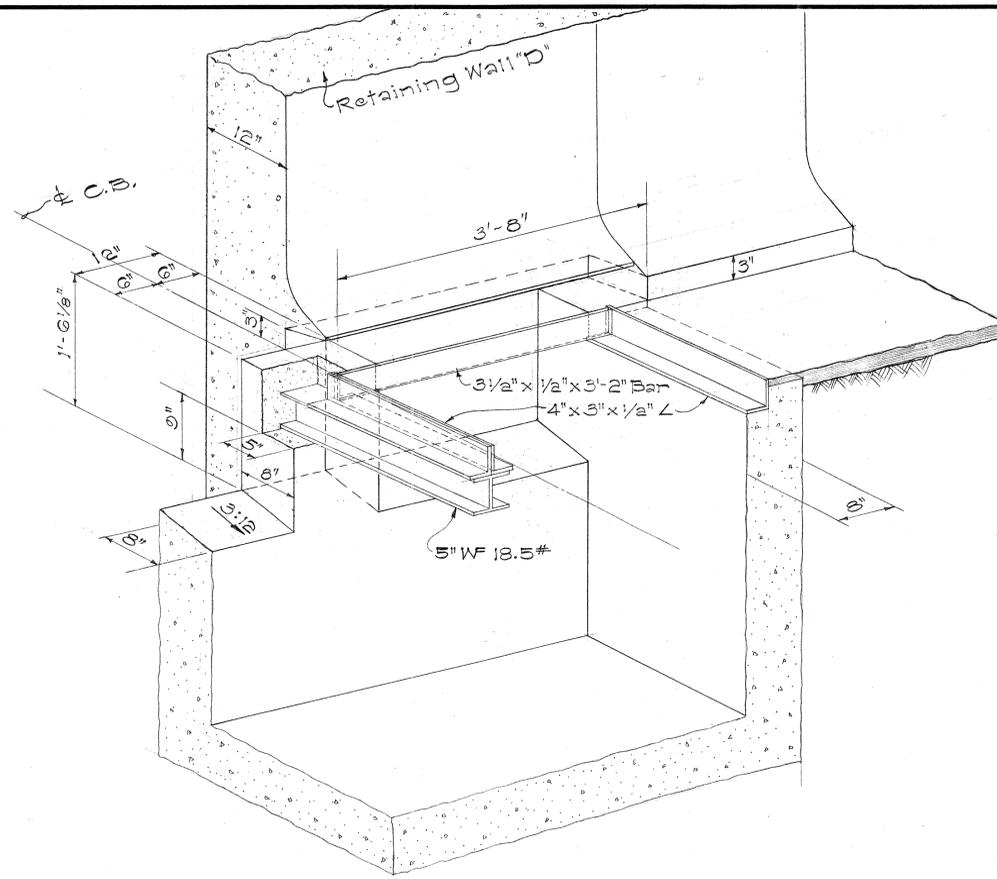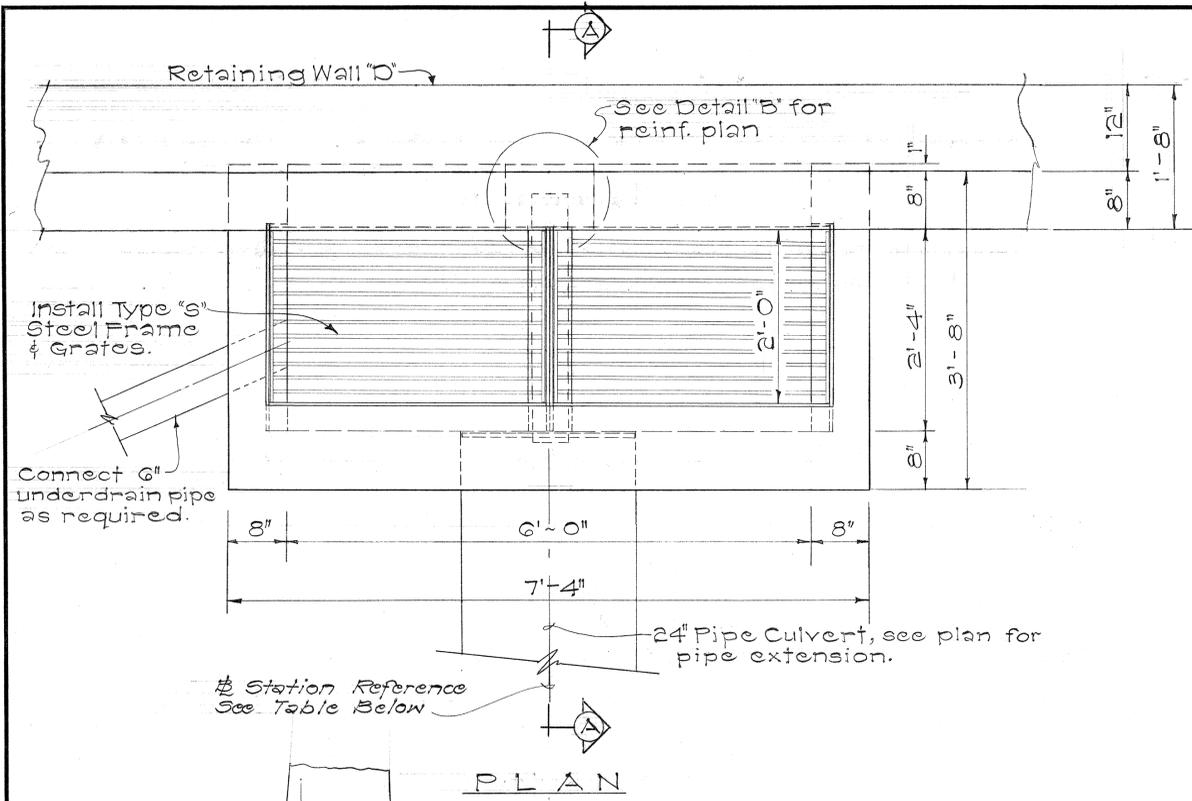

STATION	INVE. ELEV.	"H"	"L"
134 + 40 E.B.	11.63	4.12	14.26
132 + 75 E.B.	10.84	4.32	15.22
130 + 25 E.B.	12.68	3.76	15.0
128 + 25 E.B.	13.94	3.79	8.66

DETAILS FOR NEW CATCH BASINS FROM STATION 128 + 25 E.B. TO 134 + 40 E.B.
Scale: 1" = 1'-0"

STATE OF HAWAII
DEPARTMENT OF TRANSPORTATION
HIGHWAYS DIVISION


DRAINAGE DETAILS
New Catch Basins with Grated Inlet along Retaining Wall "D"

Safety Improvements from Kalih'i St. to Pali Highway
Fed. Aid Inter. Proj. No. I-H-1(112)-10
Scale As Shown Date: April, 1973


SHEET No. 31H. OF 41 HSHEETS

DATE
DESIGNED BY
CHECKED BY
NOTED BY
ORIGINAL PLAN

FED. ROAD DIST. NO.	STATE	FED. AID PROJ. NO.	FISCAL YEAR	SHEET NO.	TOTAL SHEETS
HAWAII	HAW.	I-HI-1(112)10	1973	82	176

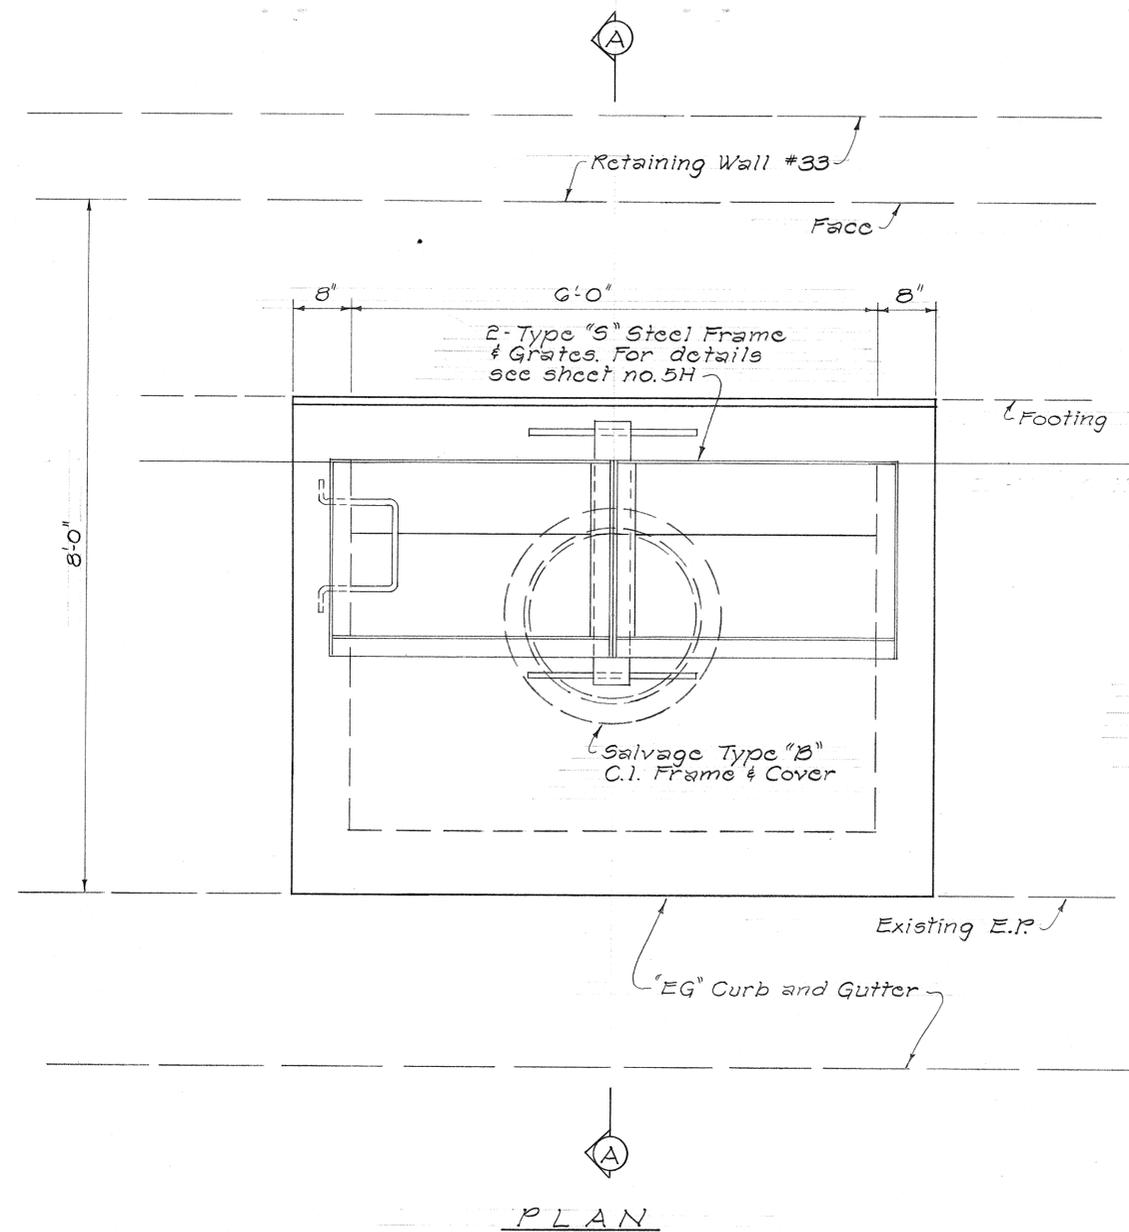

NOTE:
All notes, dimensions and reinforcing layouts are similar to typical section for Type "S" Grated Drop intake except as shown or noted on this sheet. (For details, see sht. no. 30H)





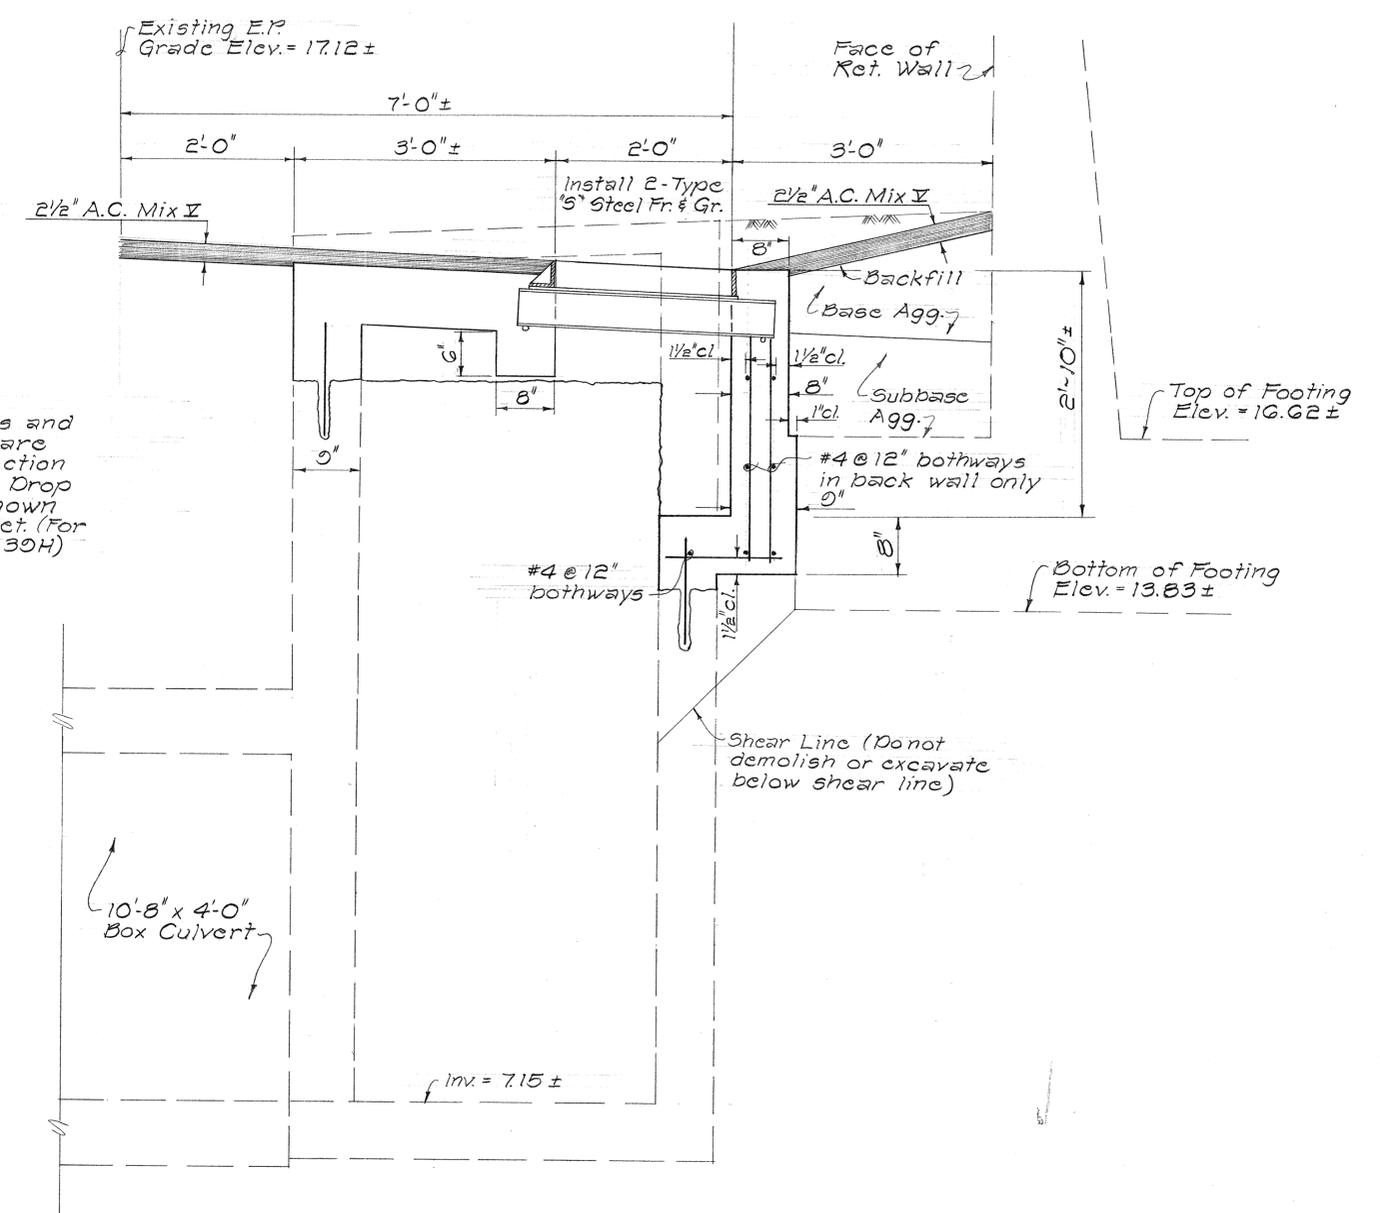


DETAILS OF CATCH BASIN @
STA. 129 + 75 W.B. (C.B. #4-F(T))
Scale: 1" = 1'-0"

STATE OF HAWAII
DEPARTMENT OF TRANSPORTATION
HIGHWAYS DIVISION
DRAINAGE DETAILS
MODIFICATION OF CATCH BASIN
WITH TYPE "S" GRATED INLET
Safety Improvements
Kalihi Street to Pali Highway
F.A.I. Proj. No. I-HI-1(112)-10
Scale: 1" = 1'-0" Date: Apr, 1973
SHEET No. 32 OF 41 SHEETS

DATE	_____
DESIGNED BY	_____
CHECKED BY	_____
NO. _____	_____

FED. ROAD DIST. NO.	STATE	FED. AID PROJ. NO.	FISCAL YEAR	SHEET NO.	TOTAL SHEETS
HAWAII	HAW.	I-HI-1(112):10	1973	83	176

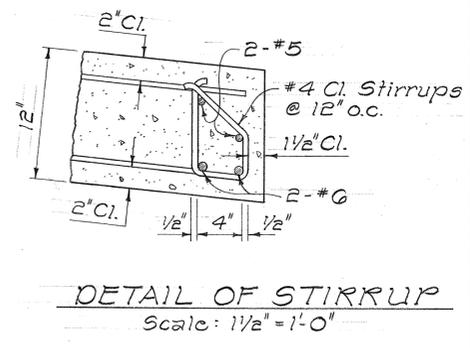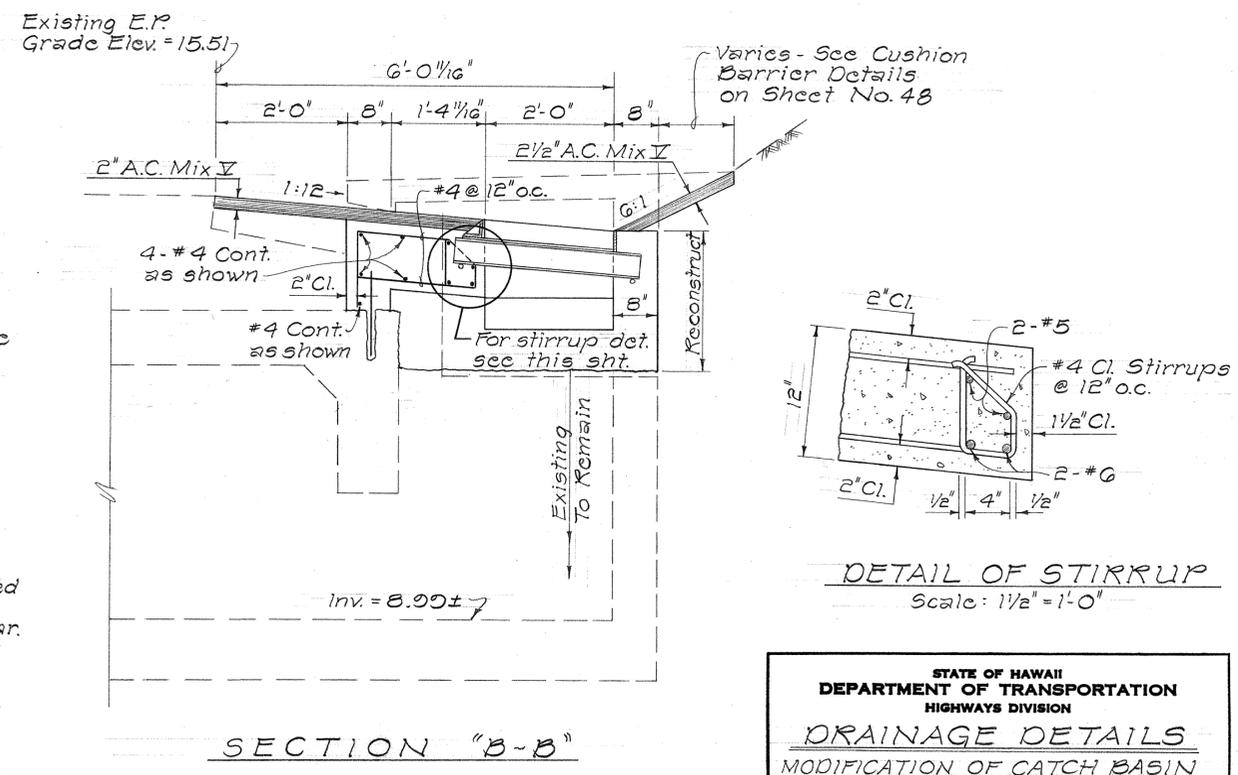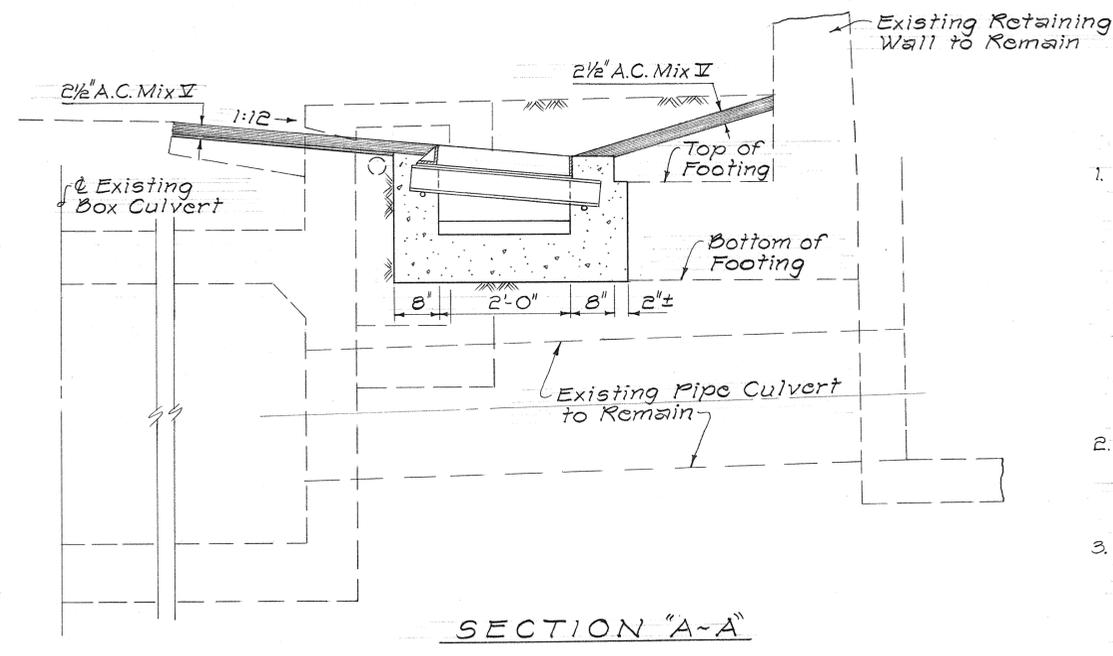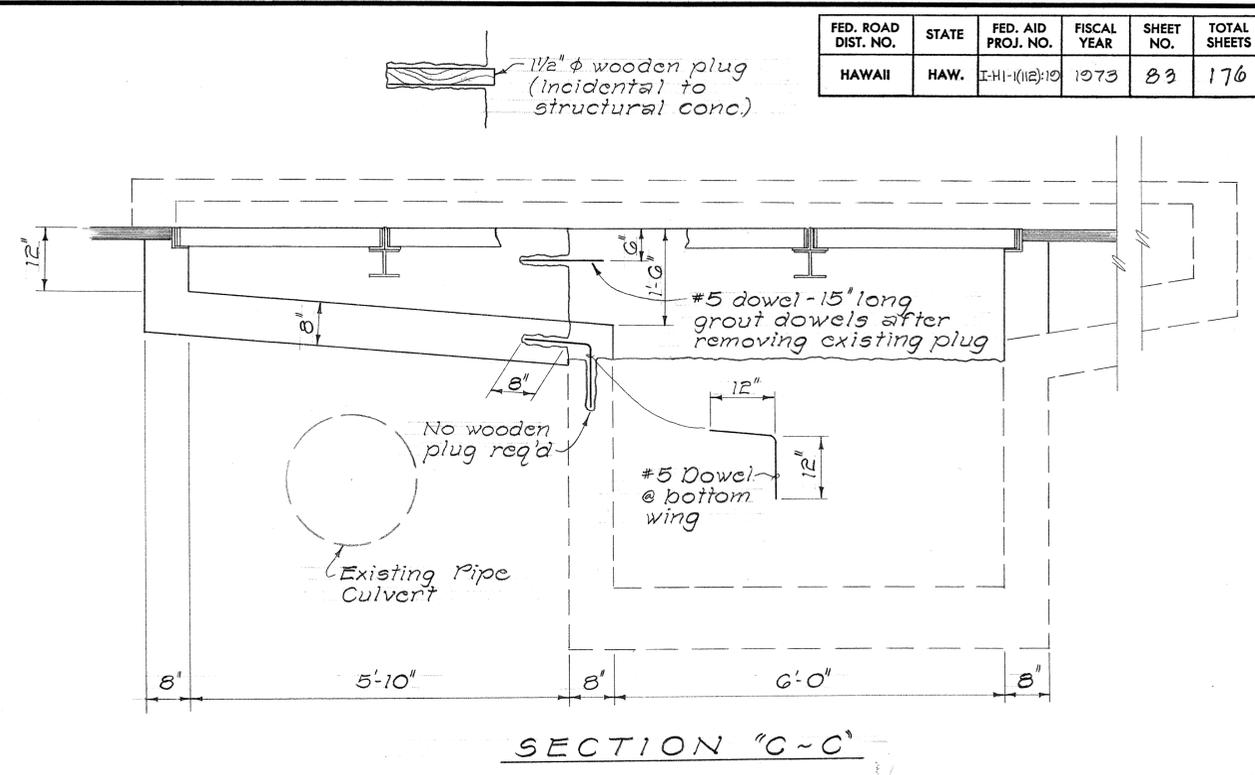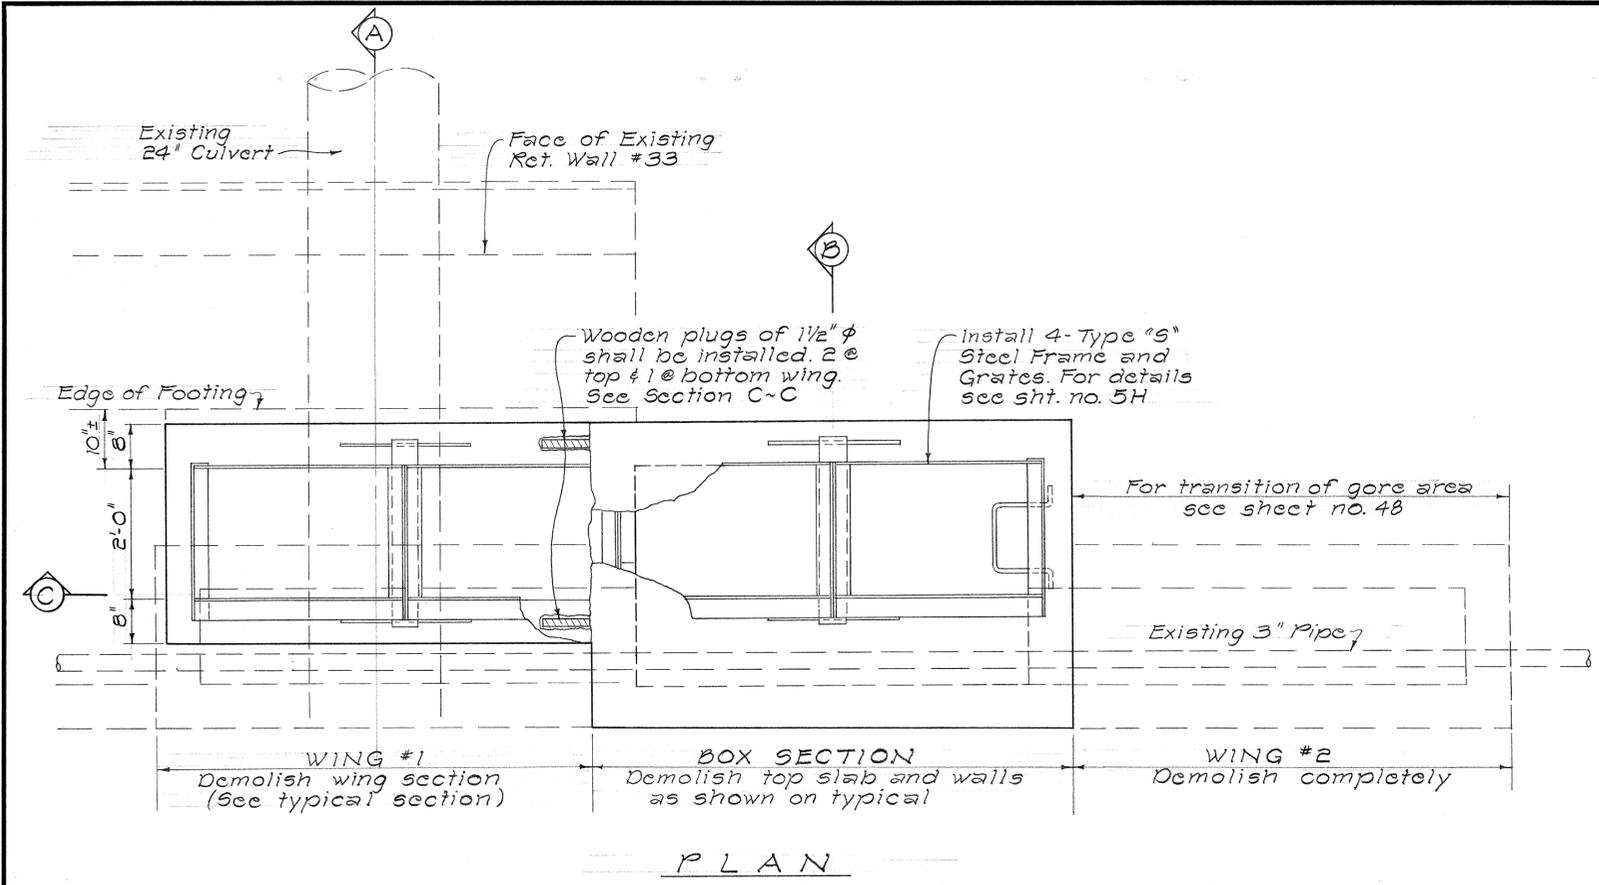


- NOTES:**
- Contractor shall work in increments in modifying C.B. Contractor shall demolish wing section #1 first and shall form and pour concrete as shown in typical before commencing work for box and wing section #2. At connection of wing #1 and box, wooden plugs of 1 1/2" diameter shall be installed at all locations for #5 reinforcing bar dowels and #6 reinforcing bar for WF Anchor. For details of dowels see this sheet. For detail of #6 reinforcing bar for WF Anchor see sht. no. 5H
 - Drilled holes shall be located such that the Reinforced Concrete Box reinforcement will not be exposed. If reinforcement is encountered in drilling, the hole shall be relocated and the reinforcement covered with epoxy mortar.
 - Contractor shall exercise care in removing concrete from and in the proximity of existing structures. Any damage to existing structures shall be repaired as directed by the Engineer and at the expenses of the Contractor.
 - Epoxy mortar shall be approved by the Engineer.

**DETAILS OF CATCH BASIN @
STA. 132 + 75 W.B. (C.B. #G-F(T))**
Scale: 3/4" = 1'-0"


STATE OF HAWAII
DEPARTMENT OF TRANSPORTATION
HIGHWAYS DIVISION
DRAINAGE DETAILS
MODIFICATION OF CATCH BASIN
WITH TYPE "S" GRATED INLET
Safety Improvements
Kalihi Street to Pali Highway
F.A.I. Proj. No. I-HI-1(112):10
Scale As Noted Date: Apr., 1973
SHEET No. 83 OF 41 SHEETS

DATE: _____
DRAWN BY: _____
DESIGNED BY: _____
CHECKED BY: _____
ORIGINAL PLAN NO. _____


FED. ROAD DIST. NO.	STATE	FED. AID PROJ. NO.	FISCAL YEAR	SHEET NO.	TOTAL SHEETS
HAWAII	HAW.	I-HI-1(112):19	1973	84	176

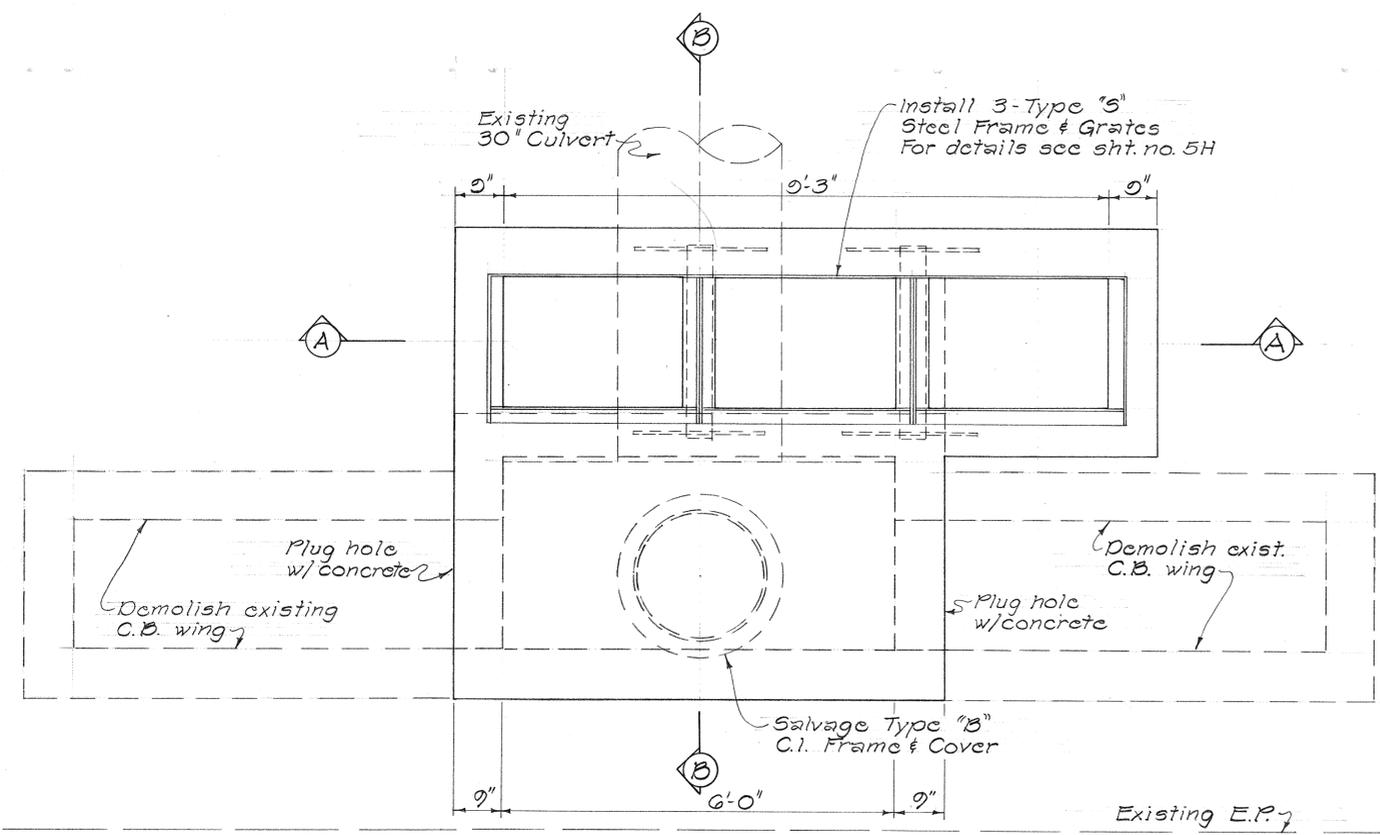

PLAN

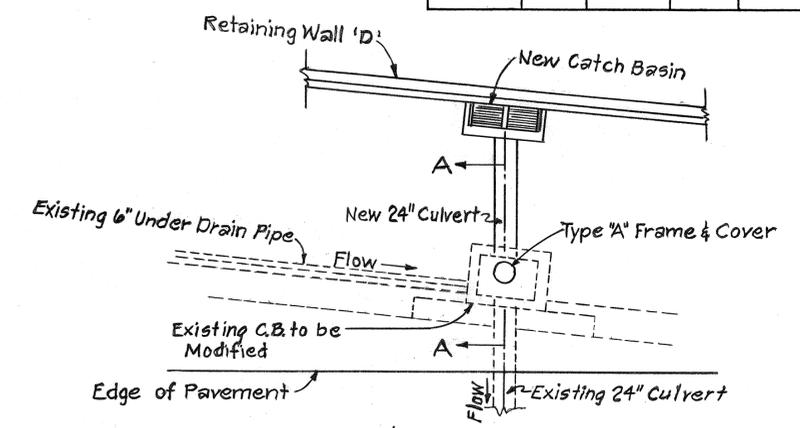


PLAN OF C.B. #9-F(T) AT 134+40 E.B.

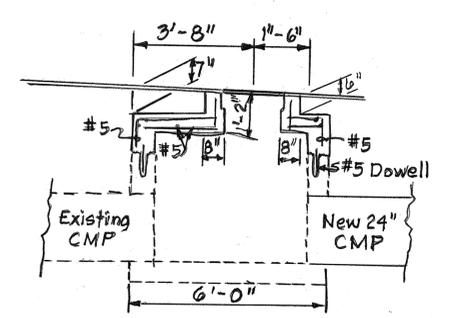

SECTION "A-A"


C.C.O. #5

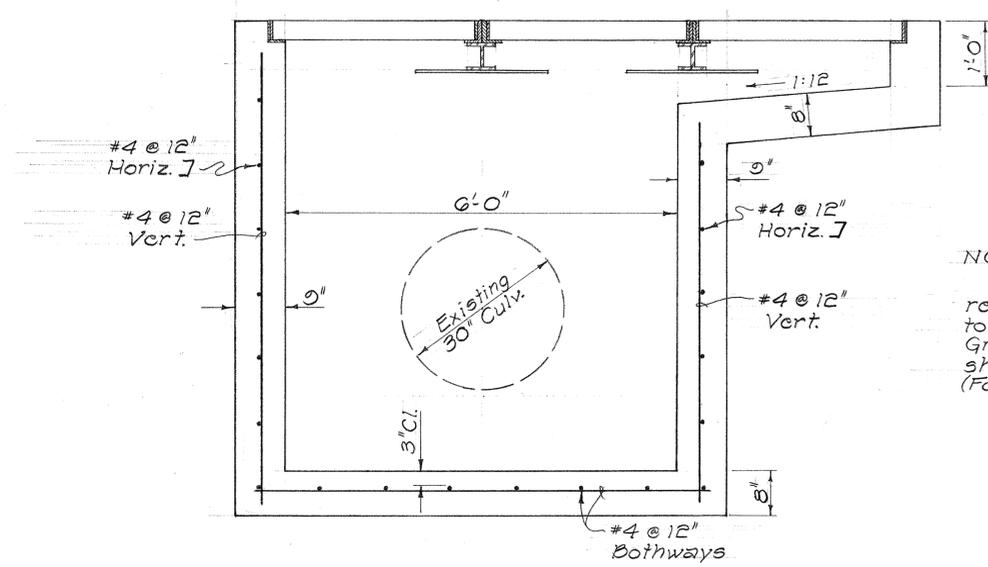

SECTION "A-A"

NOTE:
All notes, dimensions and reinforcing layouts are similar to typical section for Type "S" Grated Drop Intake except as shown or noted on this sheet. (For details, see sht. no. 30H)

DETAILS OF CATCH BASIN @ STA. 136 + 73 W.B. (C.B. #2L(T))
Scale: 3/4" = 1'-0"




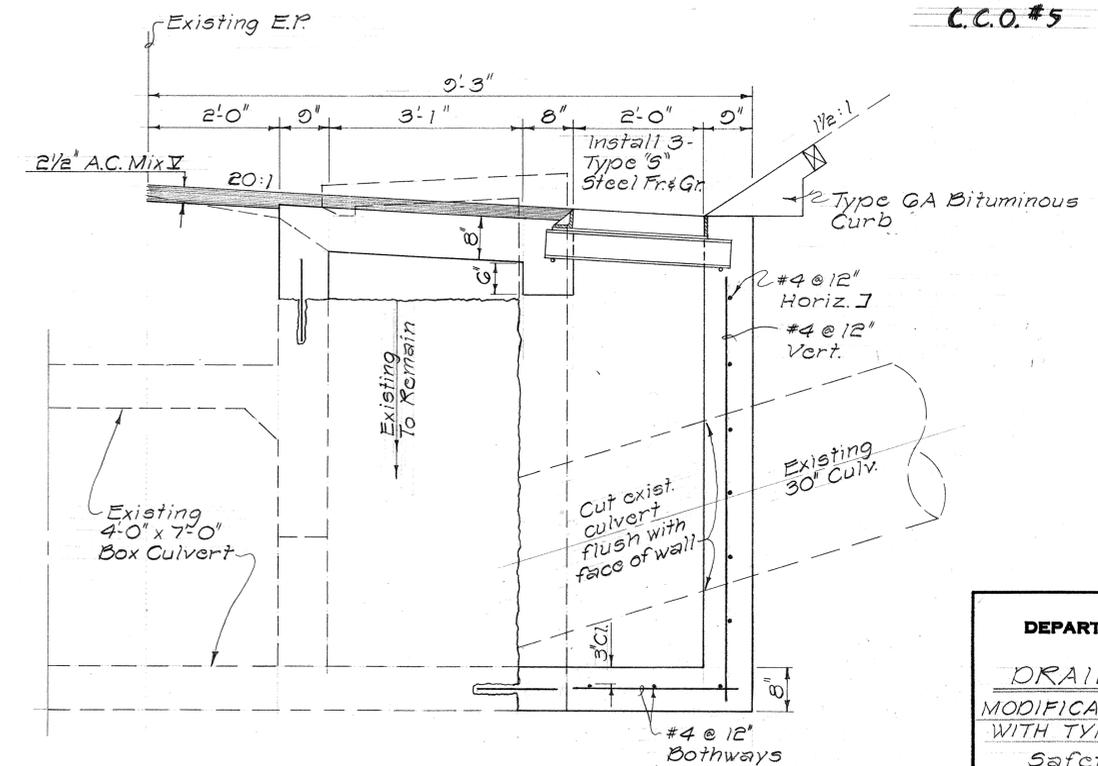


SECTION "B-B"


STATE OF HAWAII
DEPARTMENT OF TRANSPORTATION
HIGHWAYS DIVISION
DRAINAGE DETAILS
MODIFICATION OF CATCH BASINS WITH TYPE "S" GRATED INLET
Safety Improvements
Kalih Street to Pali Highway
F.A.I. Proj. No. I-HI-1(112):19
Scale: 3/4" = 1'-0" Date: Apr, 1973
SHEET No. 34H OF 41H SHEETS

DATE	
DESIGNED BY	
CHECKED BY	
DRAWN BY	
TRACED BY	
ORIGINAL PLAN	
NOTE BOOK	
No.	

FED. ROAD DIST. NO.	STATE	FED. AID PROJ. NO.	FISCAL YEAR	SHEET NO.	TOTAL SHEETS
HAWAII	HAW.	I-HI-1(112)10	1973	85	176

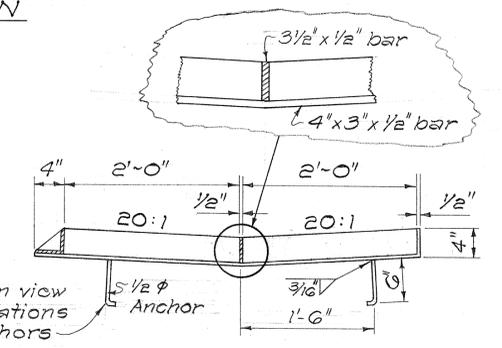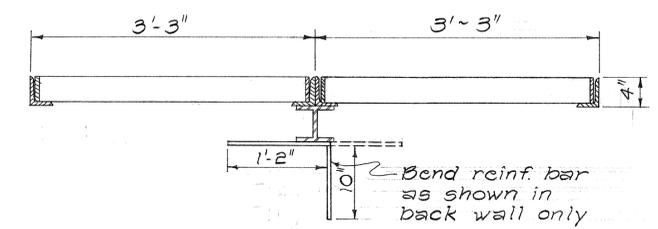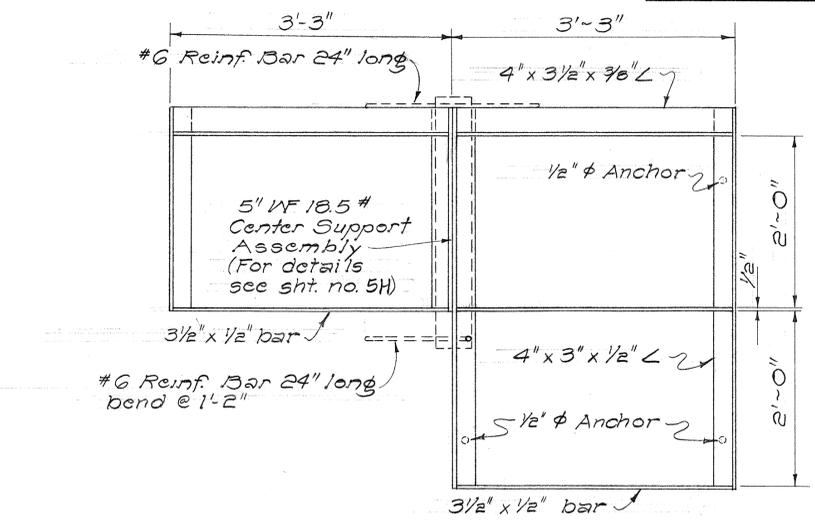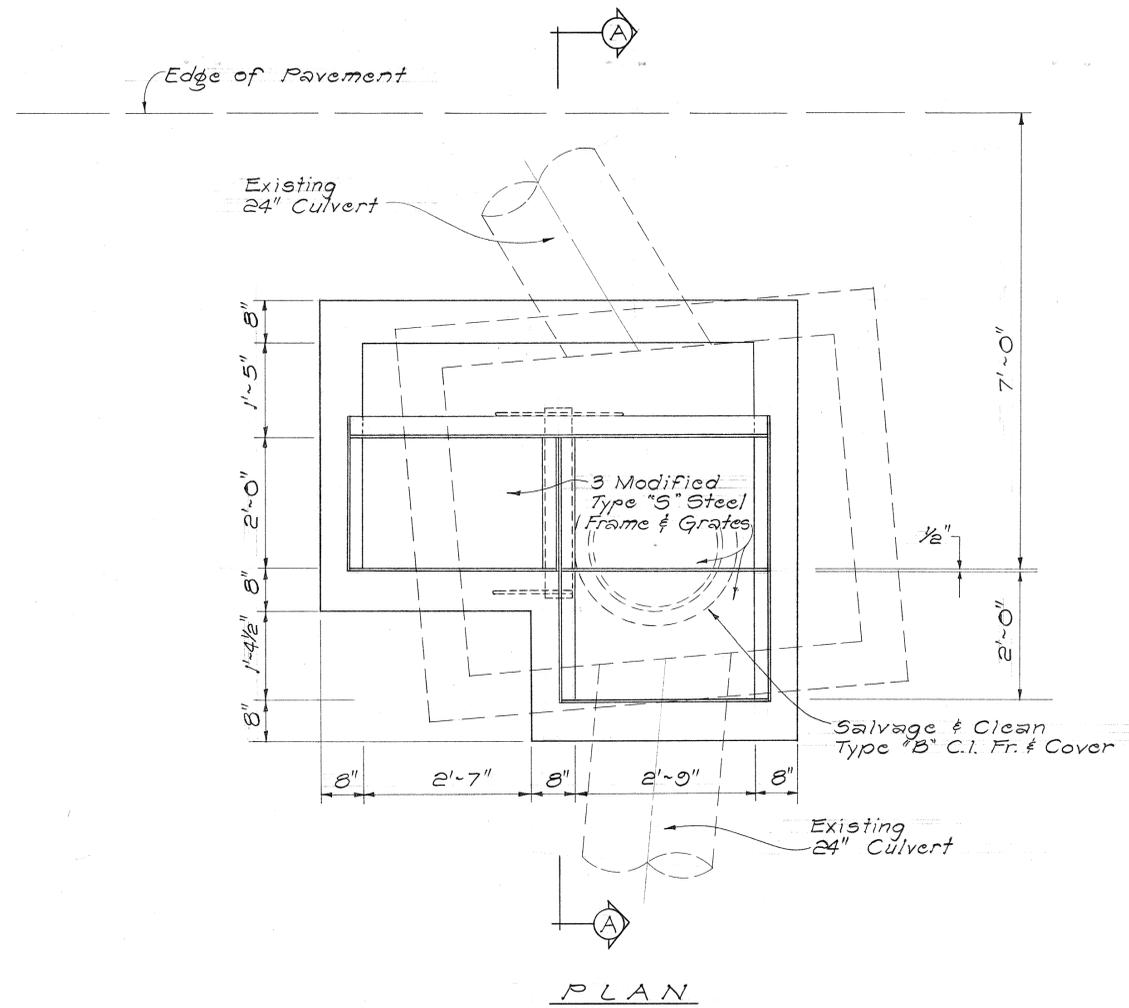

MODIFIED TYPE "S" STEEL FRAME AND GRATES
Scale: 1" = 1'-0"

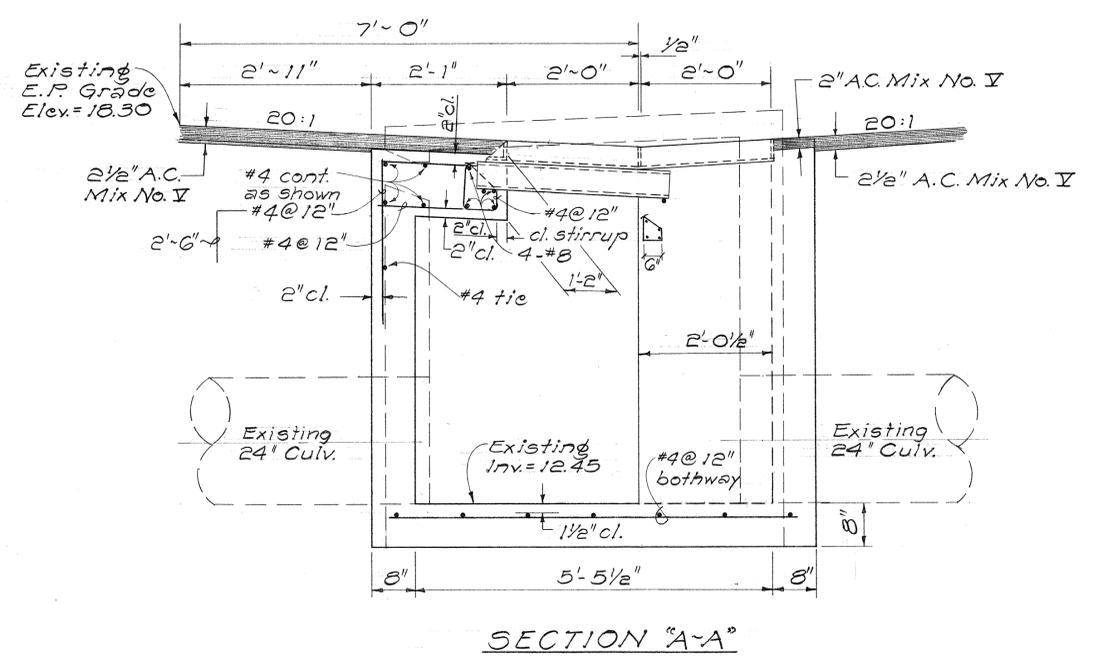

C.D. #4-L(T) STA. 137+42 ± E.B.
Scale: 3/4" = 1'-0"

NOTES:

1. Except as shown on this sheet all details for Modified Type "S" Steel Frame and Grates are similar to Type "S" Steel Frame & Grates (For details see sht. no. 5H)
2. All notes as shown for Type "S" Steel Frame and Grates on sht. no. 5H are applicable to Modified Type "S" Steel Frame and Grates.
3. Cut existing culverts flush with the inner face of wall.

DATE	
REVISION	
DESIGNED BY	
CHECKED BY	
NO.	


STATE OF HAWAII
DEPARTMENT OF TRANSPORTATION
HIGHWAYS DIVISION

DRAINAGE DETAILS
NEW MODIFIED TYPE "S"
GRATED DROP INTAKE AND
DETAILS OF MODIFIED TYPE "S"
STEEL FRAME AND GRATES



Safety Improvements
Kalihī Street to Pali Highway
F.A.I. Proj. No. I-HI-1(112)10
Scale As Noted Date: April, 1973

SHEET No. 35 OF 41 SHEETS


FED. ROAD DIST. NO.	STATE	FED. AID PROJ. NO.	FISCAL YEAR	SHEET NO.	TOTAL SHEETS
HAWAII	HAW.	I-HI-1(112)-10	1973	86	176

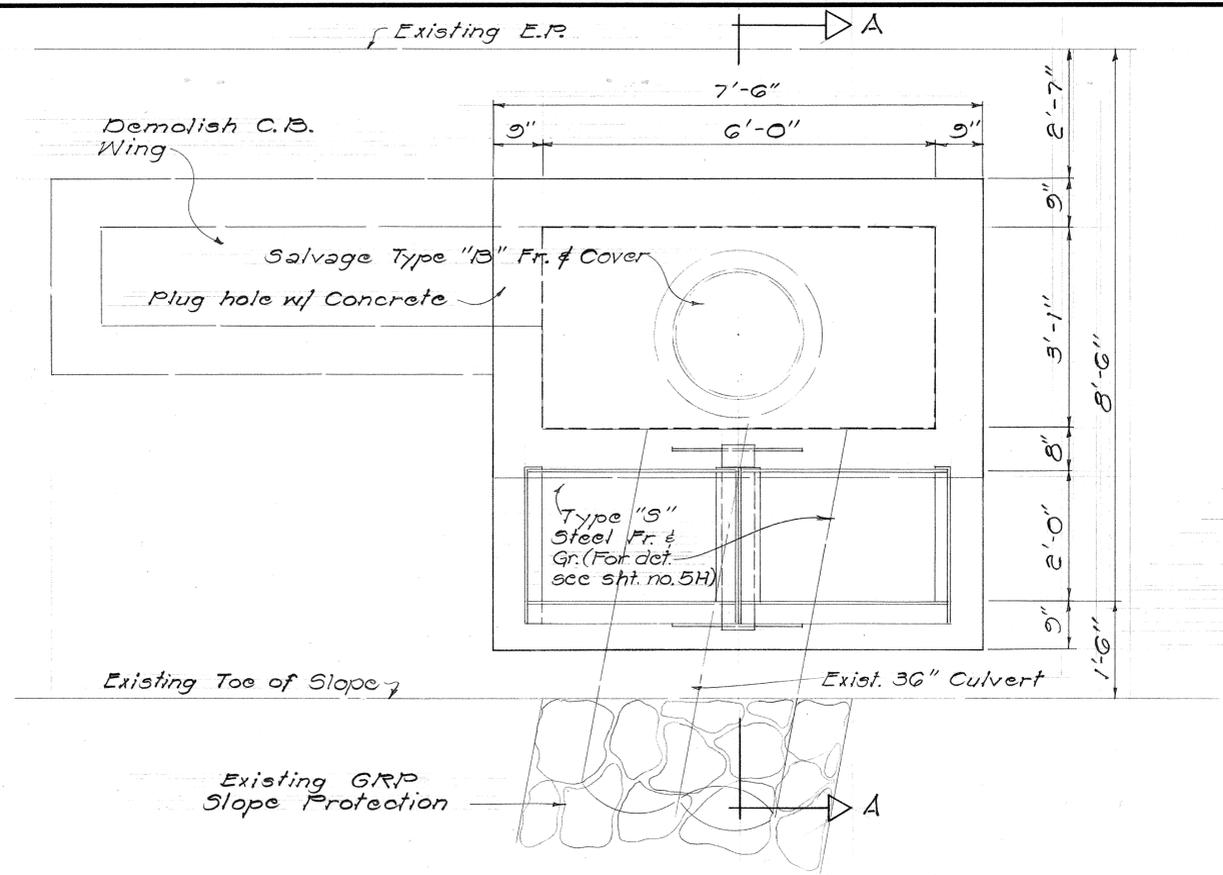

NOTE:
Except as noted on this sheet, see Typical Section for notes, dimensions and reinforcing steel details for Type "S" Grated Drop Intake on sht. no. 39H

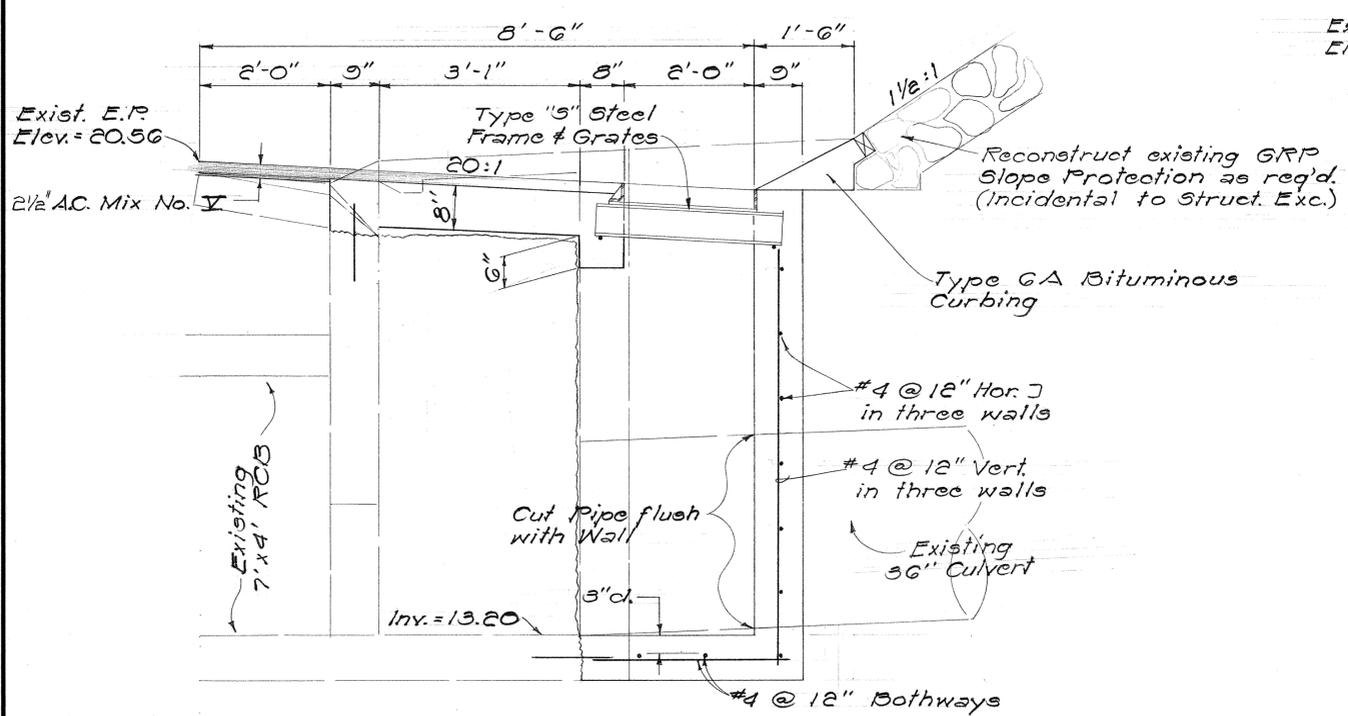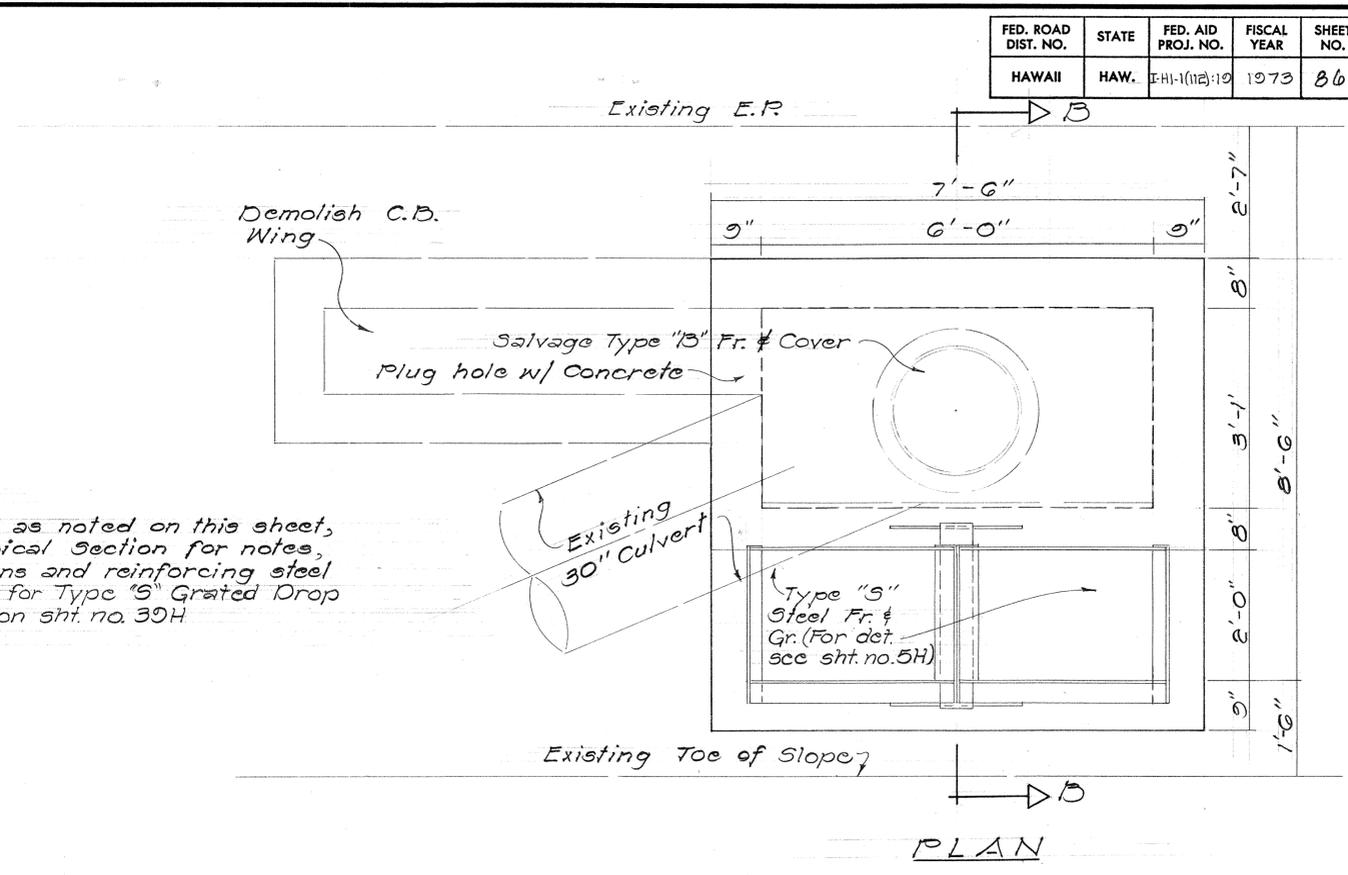

SECTION A-A
DETAILS FOR C.B. #9L(T)
AT STA. 140+28 W.B.

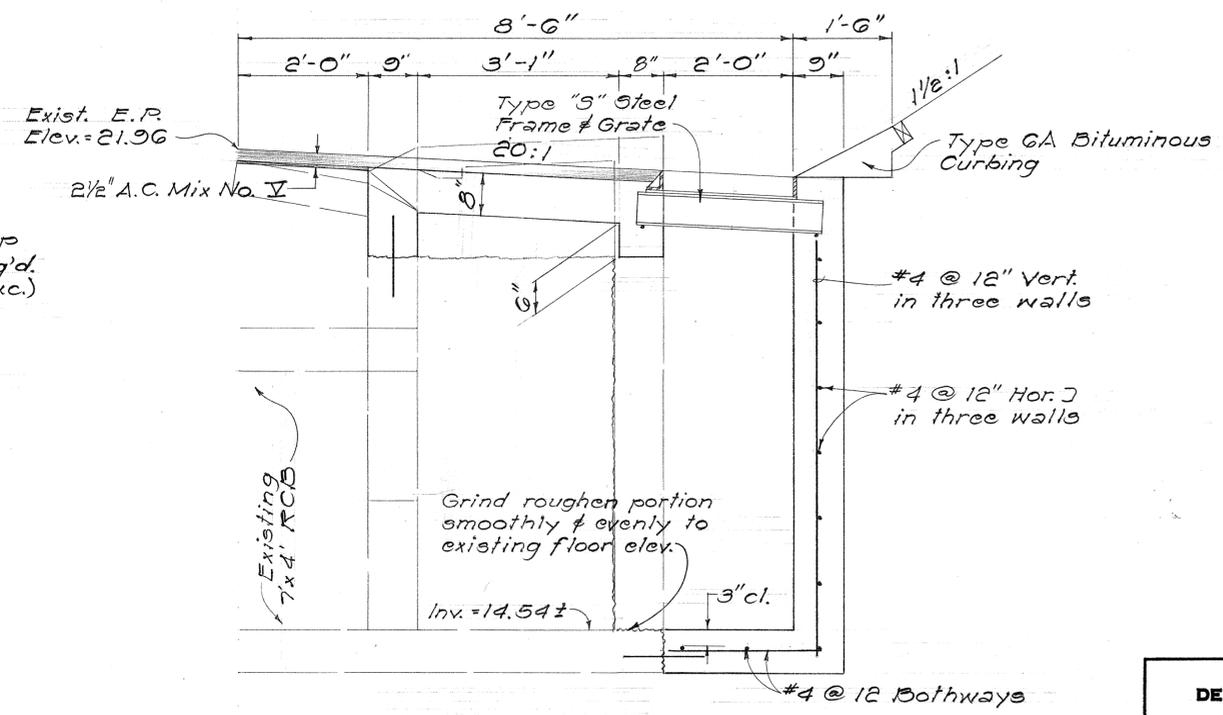

SECTION B-B
DETAILS FOR C.B. #10L(T)
AT STA. 141+96 W.B.

STATE OF HAWAII
DEPARTMENT OF TRANSPORTATION
HIGHWAYS DIVISION





DRAINAGE DETAILS
MODIFICATIONS OF CATCH BASINS WITH TYPE "S" GRATED INLET

Safety Improvements
Kalihi Street to Pali Highway
F.A.I. Proj. No. I-HI-1(112)-10
Scale: 3/4" = 1'-0" Date: April, 1973

SHEET No. 36HOF41 H SHEETS

DATE	_____
DESIGNED BY	_____
CHECKED BY	_____
NO.	_____

FED. ROAD DIST. NO.	STATE	FED. AID PROJ. NO.	FISCAL YEAR	SHEET NO.	TOTAL SHEETS
HAWAII	HAW.	I-HI-1(112):10	1973	87	176

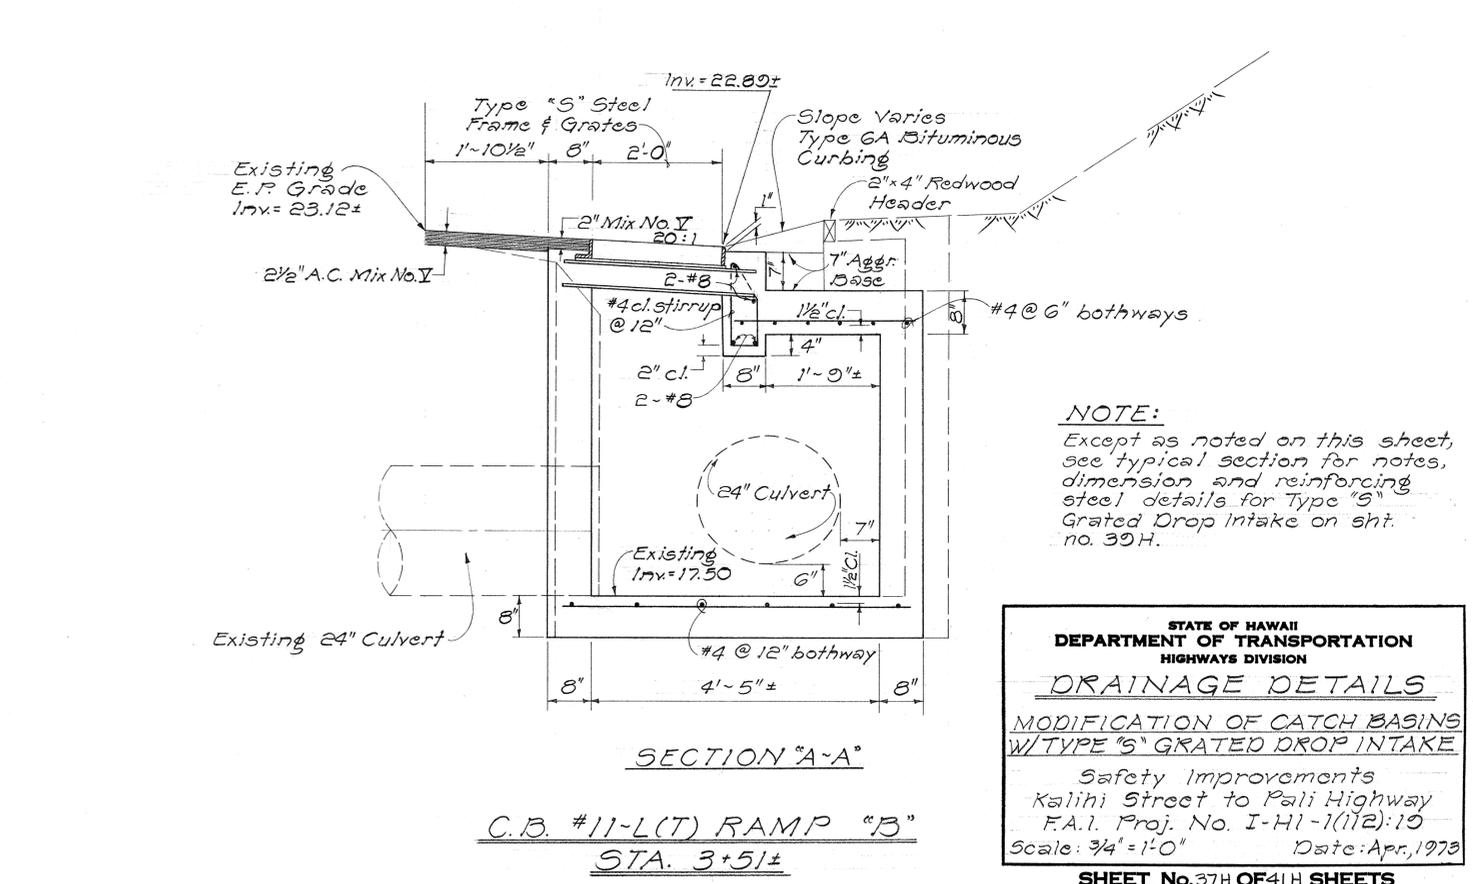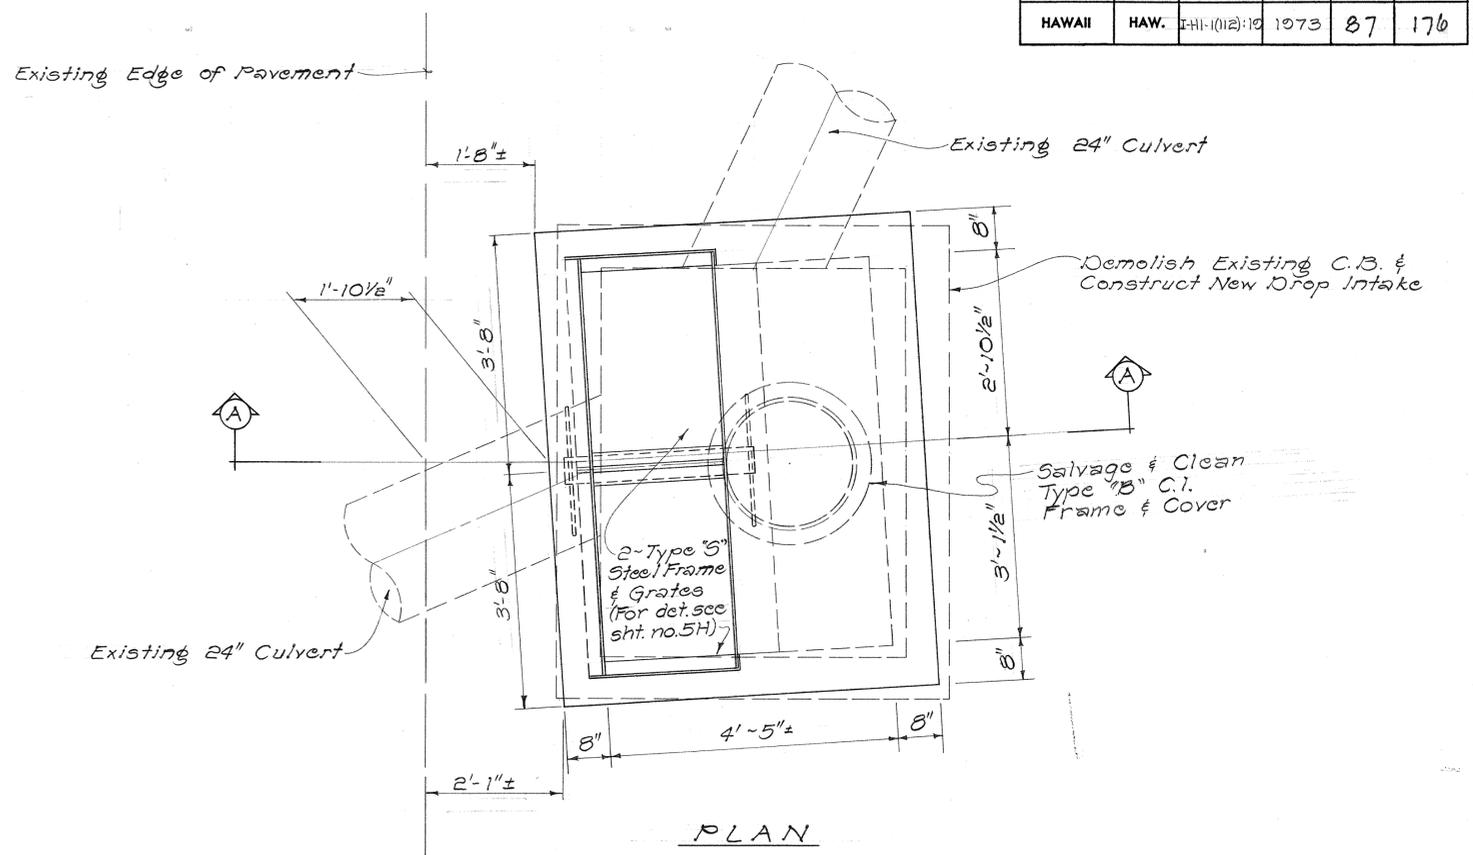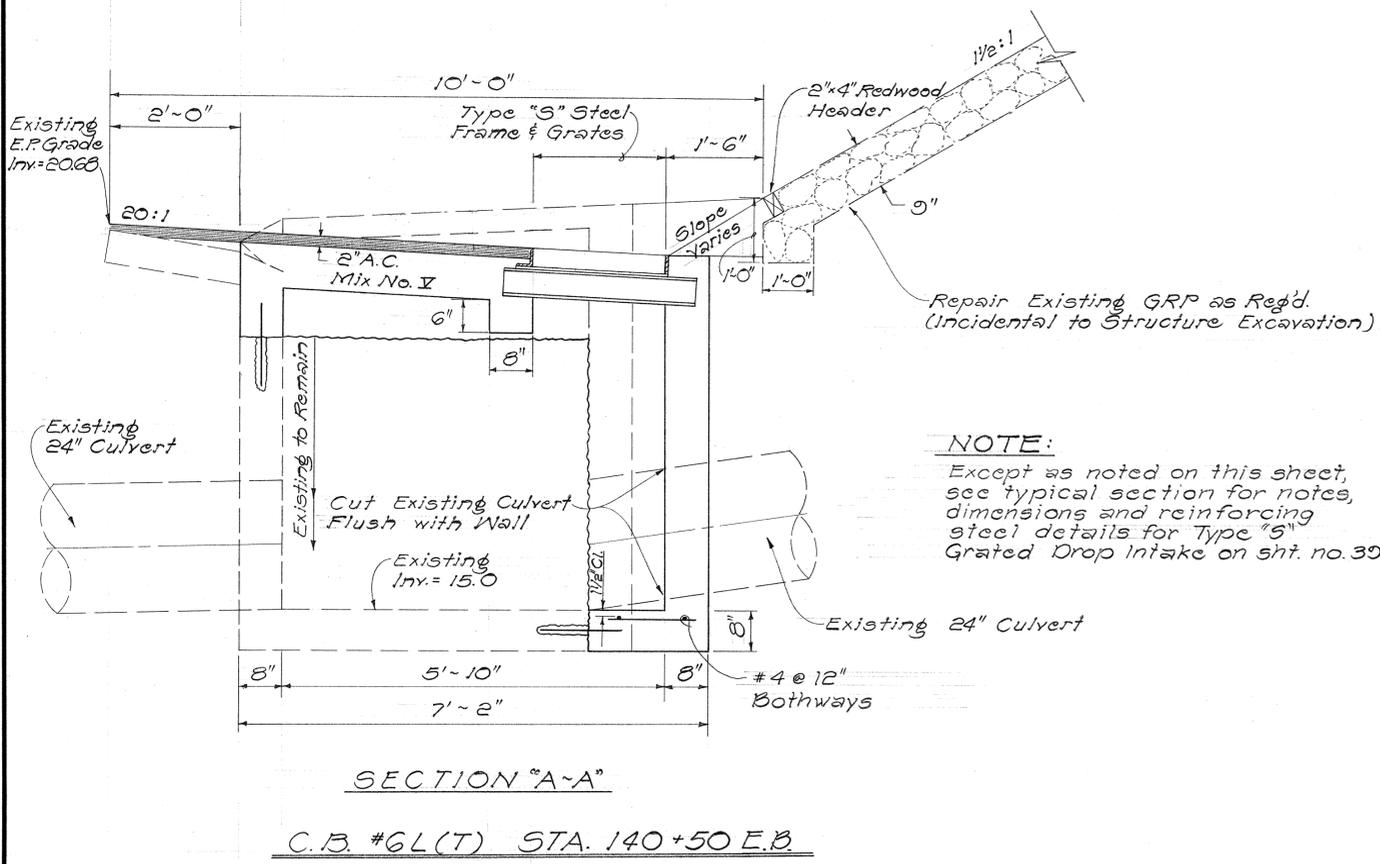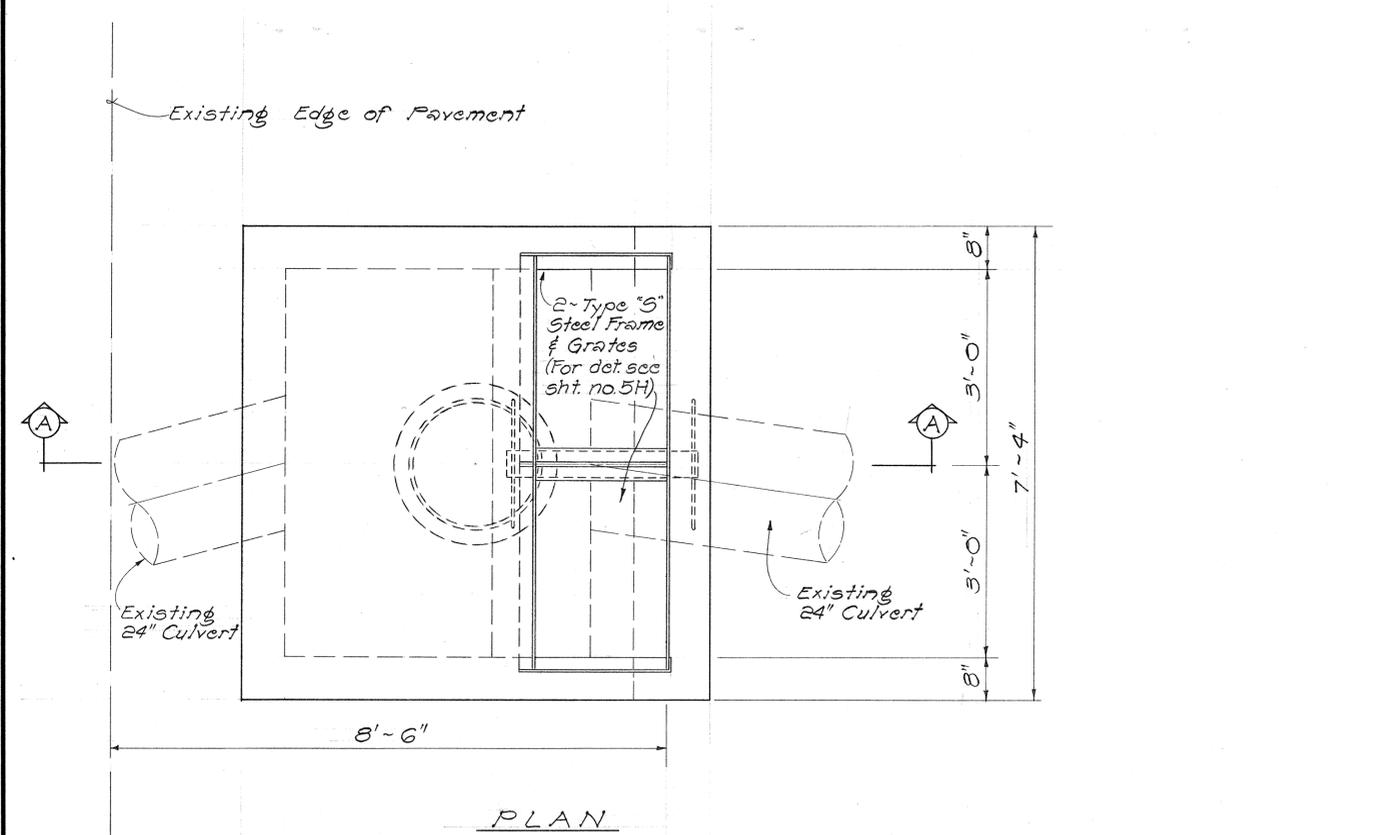

STATE OF HAWAII
DEPARTMENT OF TRANSPORTATION
HIGHWAYS DIVISION

DRAINAGE DETAILS


MODIFICATION OF CATCH BASINS
W/TYPE "5" GRATED DROP INTAKE

Safety Improvements
Kalih Street to Pali Highway
F.A.I. Proj. No. I-HI-1(112):10
Scale: 3/4" = 1'-0" Date: Apr. 1973


SHEET No. 37H OF 41H SHEETS

DATE
DESIGNED BY
CHECKED BY
NO. 1
NO. 2
NO. 3
NO. 4
NO. 5
NO. 6
NO. 7
NO. 8
NO. 9
NO. 10


FED. ROAD DIST. NO.	STATE	FED. AID PROJ. NO.	FISCAL YEAR	SHEET NO.	TOTAL SHEETS
HAWAII	HAW.	I-41-1(112)-10	1973	88	170

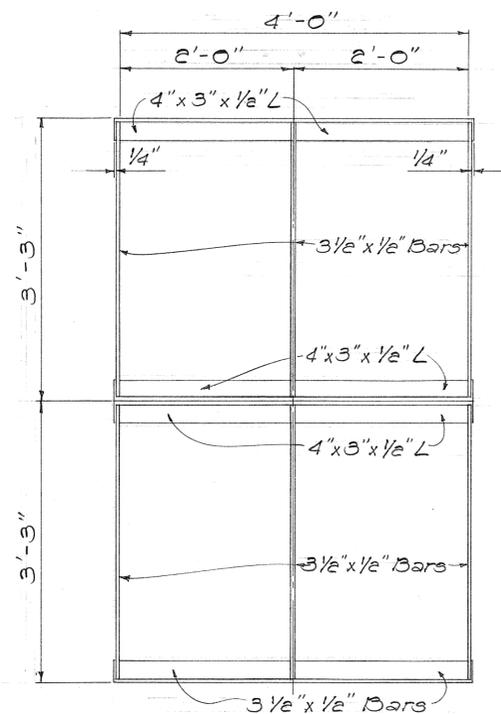


PLAN
Scale: 1"=1'-0"

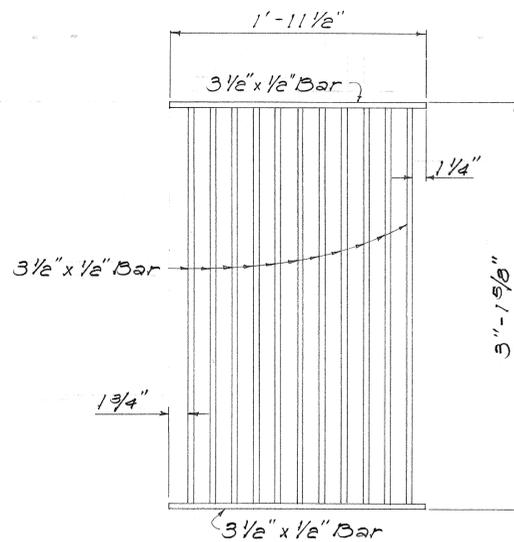


PLAN
Scale: 1 1/2"=1'-0"

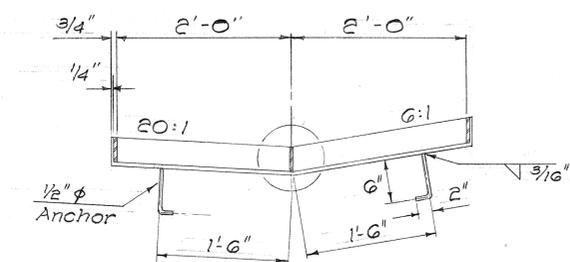

SECTION
Scale: 1"=1'-0"

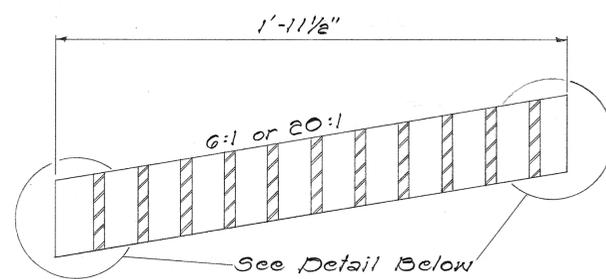


SECTION
Scale: 3"=1'-0"

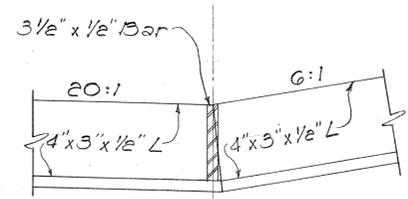


DETAIL
FRAME

Scale: 3"=1'-0"

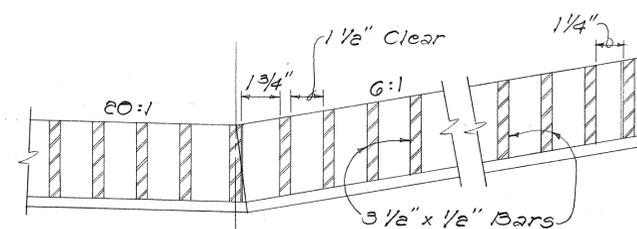


DETAIL
GRATE


Scale: 3"=1'-0"

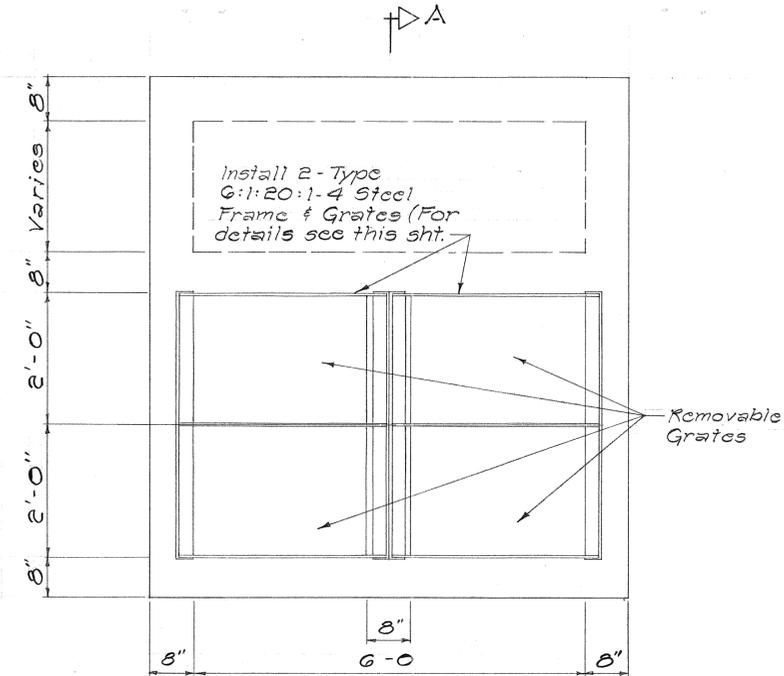

PLAN
Scale: 1"=1'-0"

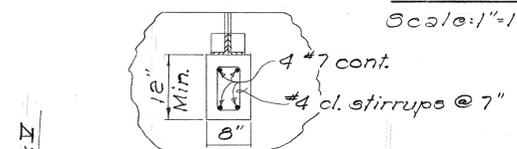

SECTION "B-B"
Scale: 3/4"=1'-0"

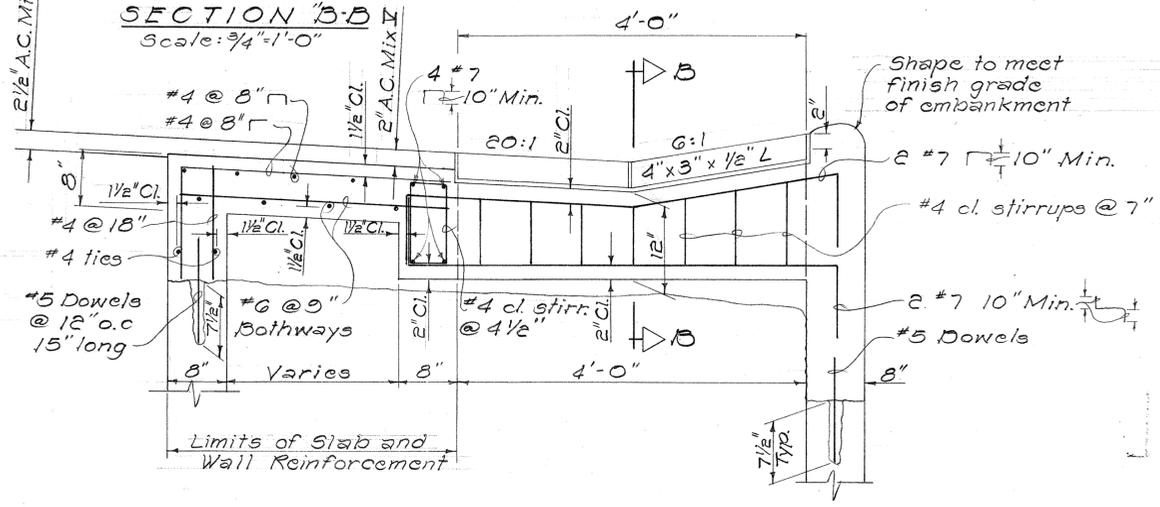

SECTION "A-A"
Scale: 1"=1'-0"


DETAILS ~ MODIFIED G:1:20:1-4
GRADED DROP INTAKE

- GENERAL NOTES**
- Grates and Frames shall be hot dip galvanized after fabrication, see specifications.
 - All welds 3/8" unless otherwise noted.
 - The Frame & Grate materials shall conform to the specifications of ASTM Designation Structural Steel A283, Grade D and the Standard Specifications.
 - Manhole Rungs (16" o.c.) are required when "H" is greater than 4 feet 6 inches. Only one rung (12 inches from the bottom) is required if "H" is 4 feet 6 inches or less. Manhole Rungs may be placed at any location as ordered by the Engineer.


DATE	
DESIGNED BY	
CHECKED BY	
NO.	

STATE OF HAWAII
DEPARTMENT OF TRANSPORTATION
HIGHWAYS DIVISION
DRAINAGE DETAILS
TYPICAL DETAILS FOR G:1:20:1-4
STEEL FRAME & GRATES & MODI-
FIED G:1:20:1-4 GRADED DROP INTAKE
Safety Improvements
Kalih Street to Pali Highway
F.A.I. Proj. No. I-41-1(112): 70
Scale as Noted Date: Apr. 1973
SHEET No. 88 OF 41H SHEETS


FED. ROAD DIST. NO.	STATE	FED. AID PROJ. NO.	FISCAL YEAR	SHEET NO.	TOTAL SHEETS
HAWAII	HAW.	I-HI-1(112):10	1973	89	176

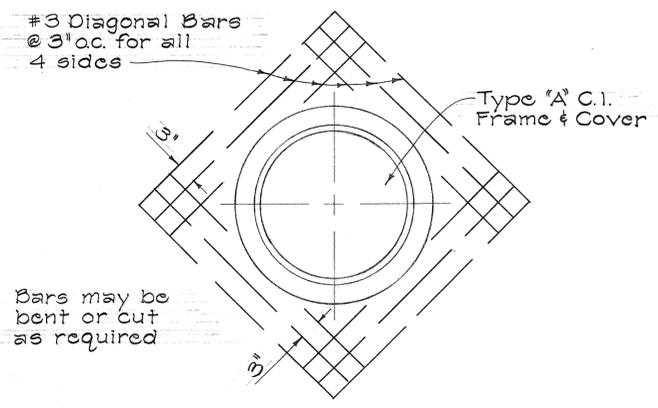

TYPICAL REINFORCEMENT FOR TYPE "A" C.I. FRAME & COVER
Scale: 1"=1'-0"

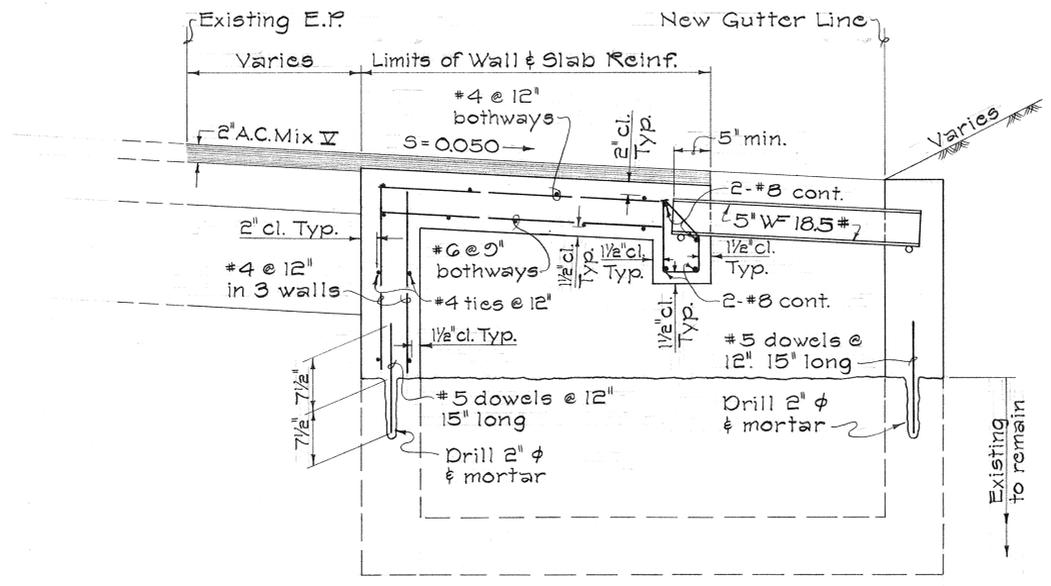


NOTE:
Use Typical as shown above except when specified in other parts of the plan.

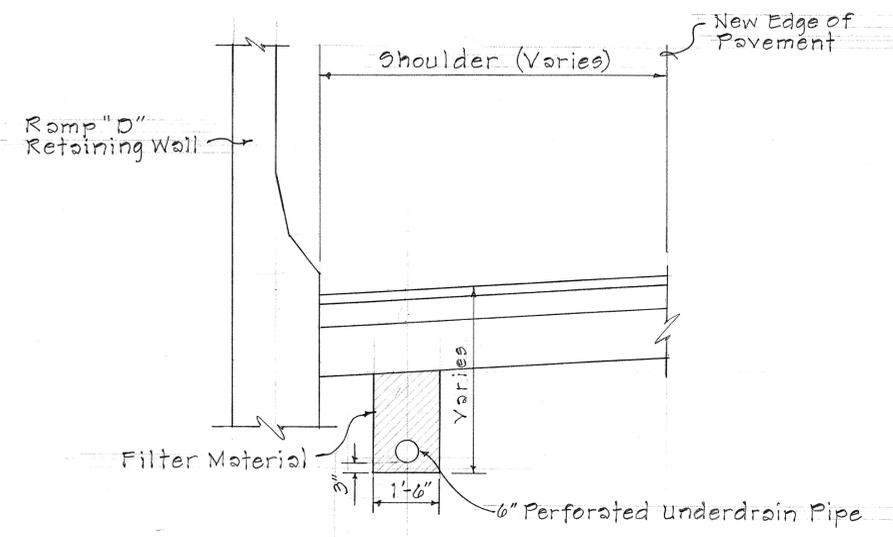


TYPICAL SECTION AT RAMP "D"
Scale: 1/2"=1'-0"

TYPICAL DETAILS ~ MODIFIED TYPE "S" STEEL FRAME & GRATES DROP INTAKE
Scale: 1"=1'-0"

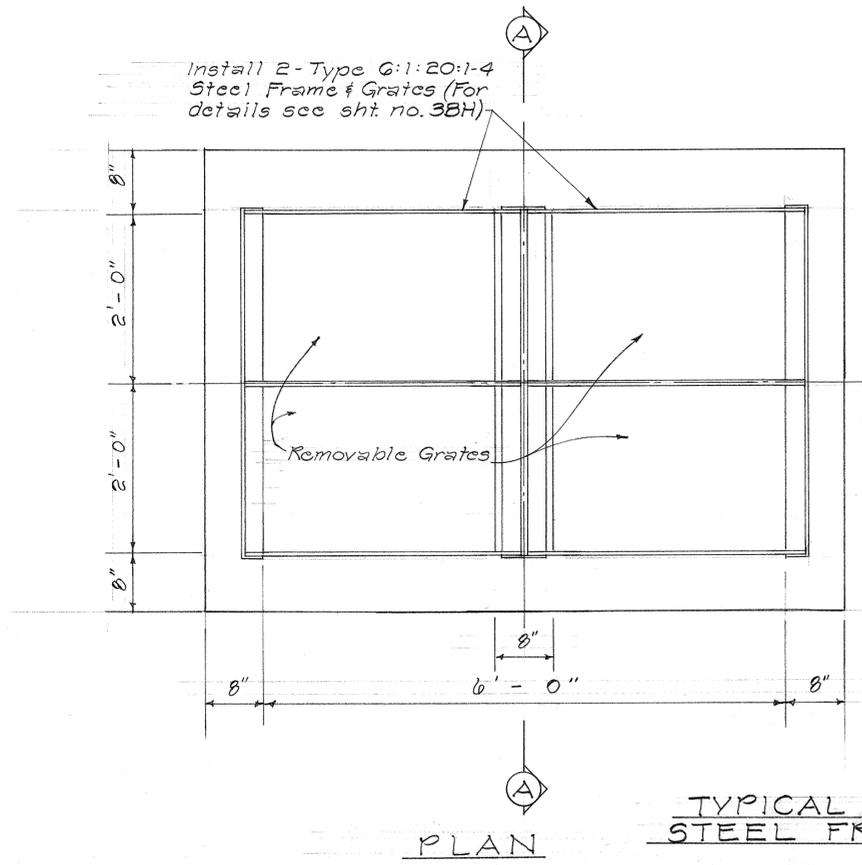

PLAN

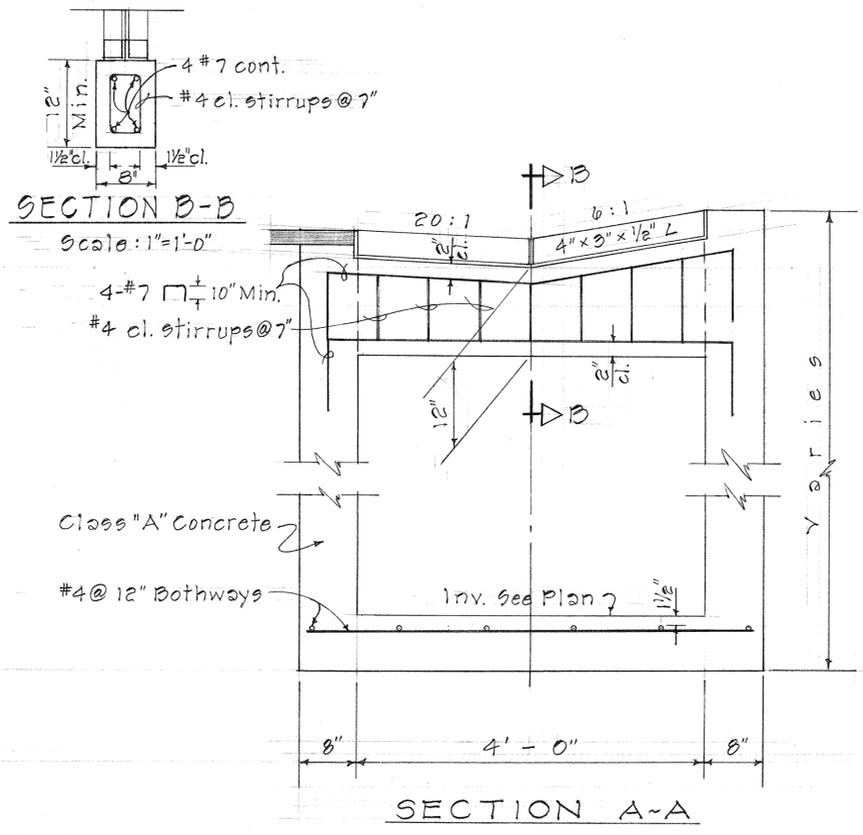

SECTION A-A

TYPICAL DETAILS ~ NEW TYPE G:1:20:1-4 STEEL FRAME & GRATES DROP INTAKE
Scale: 1"=1'-0"

DESIGNED BY	DATE
DRAWN BY	
CHECKED BY	
NO.	

STATE OF HAWAII
DEPARTMENT OF TRANSPORTATION
HIGHWAYS DIVISION


DRAINAGE DETAILS

TYPICAL DETAILS


Safety Improvements
Kalihi Street to Pali Highway
F.A.I. Proj. No. I-HI-1(112):10
Scale As Noted Date: Apr, 1973

SHEET No. 39 OF 41 SHEETS

FED. ROAD DIST. NO.	STATE	FED. AID PROJECT	FISCAL YEAR	SHEET NO.	TOTAL SHEETS
HAWAII	HAWAII	FHI-1(112)19	1973	070	176

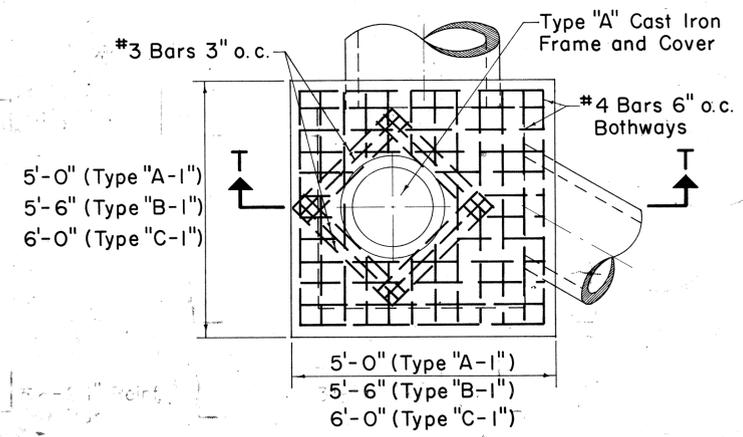


PLAN

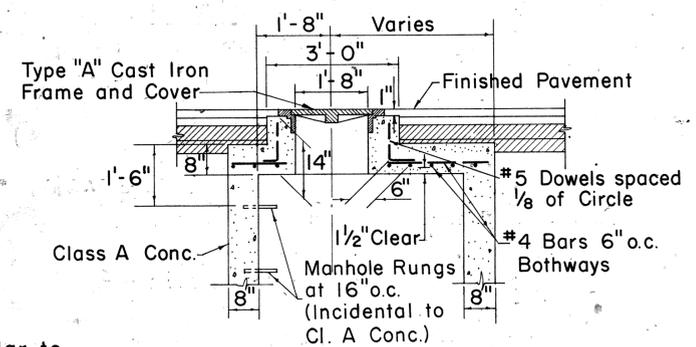


SECTION T-T

**TYPE "A-1", "B-1", & "C-1"
STORM DRAIN MANHOLE
TOP DETAIL UNDER PAVEMENT**

Scale: 1/2" = 1'-0"

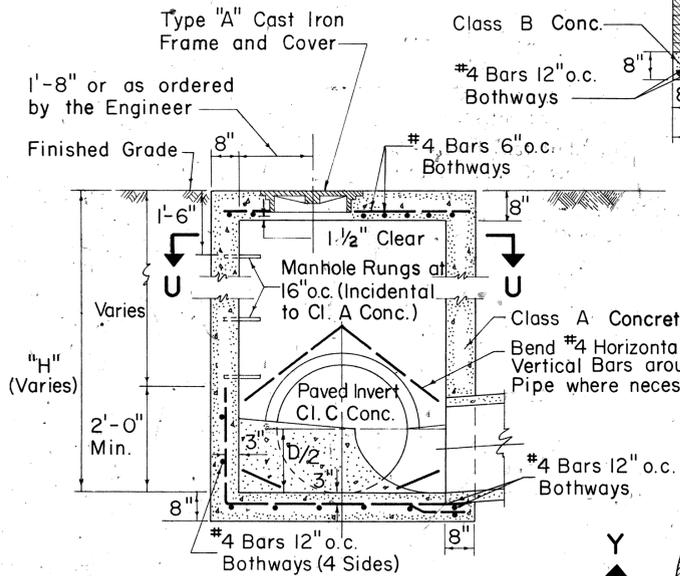


SECTION V-V

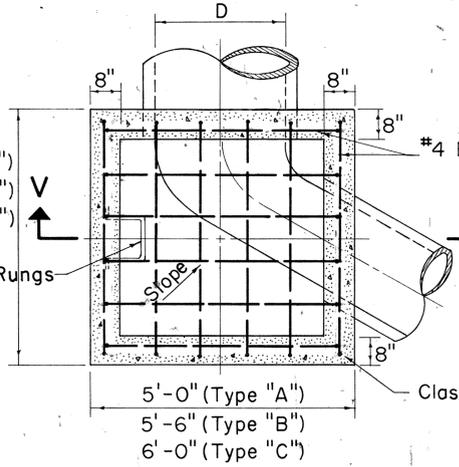


SECTION U-U

**TYPE "A", "B", & "C"
S.D.M.H.**

Scale: 1/2" = 1'-0"

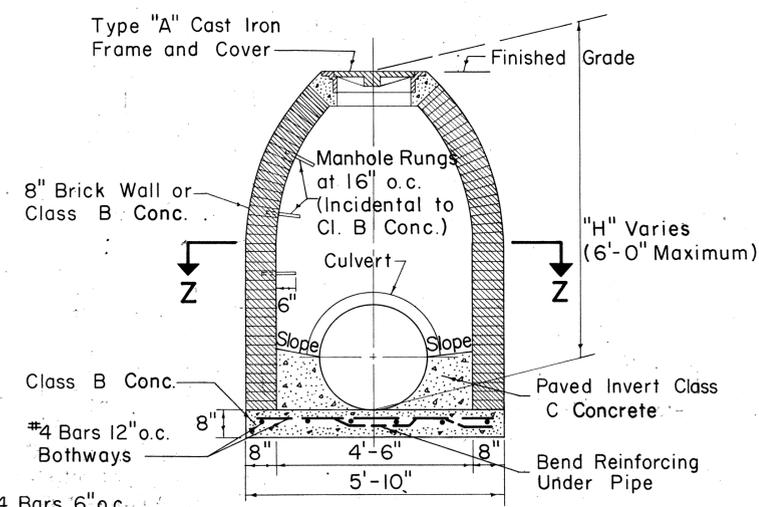


SECTION Y-Y

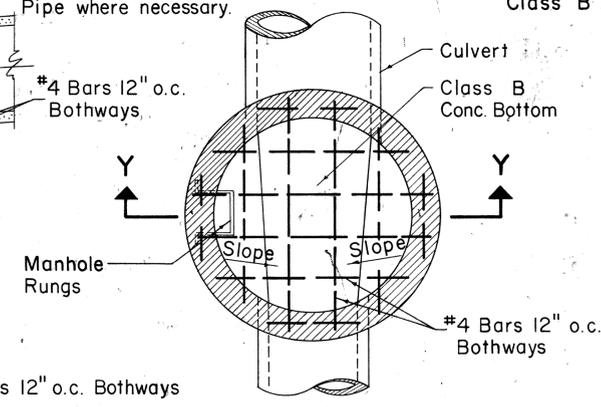


SECTION Z-Z

TYPE "D" STORM DRAIN MANHOLE

Scale: 1/2" = 1'-0"

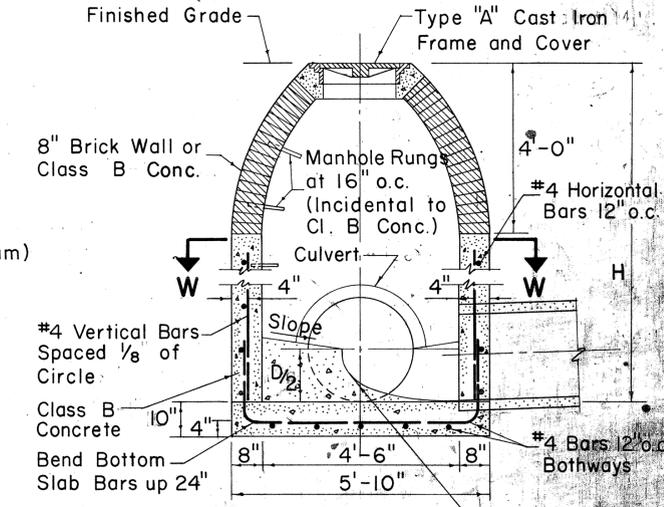

SECTION X-X

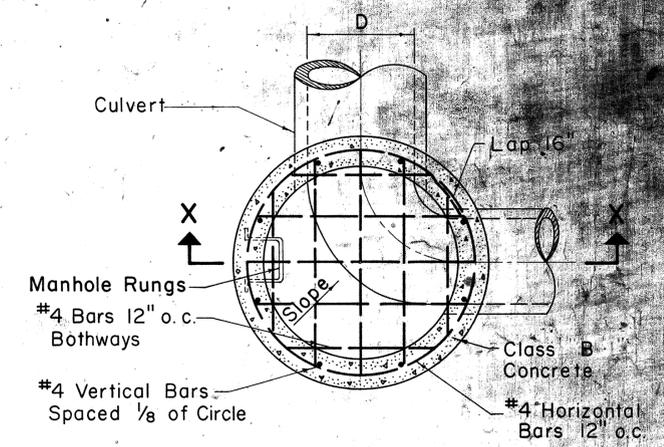

SECTION W-W

TYPE "E" STORM DRAIN MANHOLE

Scale: 1/2" = 1'-0"

NOTE:

- Exterior surface of brick wall shall be plastered with 1" thickness of 1:2 Cement Mortar.
- Number, size and direction of culvert at manhole to be as shown on plans.
- Paved invert not required at drop manholes.
- All Class C Concrete to be incidental to Class B Concrete.

Note:

Bottom detail similar to Type "A", "B", & "C".

GENERAL NOTES

- Culvert shall enter and leave S.D.M.H. from any position and in the direction indicated by the plans or ordered by the Engineer.
- Manhole Rungs (16" o.c.) are required when "H" is greater than 4'-6". Only one rung (12" from the bottom) is required if "H" is 4'-6" or less. Type "A" C.I. Frame and Cover and Manhole Rungs may be placed at any location as ordered by the Engineer.

APPROVAL RECOMMENDED:
[Signature] 12-17-69
 HYDRAULIC DESIGN ENGINEER DATE

APPROVED:
[Signature] 12-17-69
 ASS'T. CHIEF, ENGINEERING DATE


NO.	REVISION	APPROVED BY	DATE

STATE OF HAWAII
 DEPARTMENT OF TRANSPORTATION
 HIGHWAYS DIVISION


STANDARD DETAILS
STORM DRAIN MANHOLES

Scales: As Noted Date: July, 1969


FED. ROAD DIST. NO.	STATE	FED. AID PROJ. NO.	FISCAL YEAR	SHEET NO.	TOTAL SHEETS
HAWAII	HAW.	H-1-1(1)(2)-10	1973	91	176

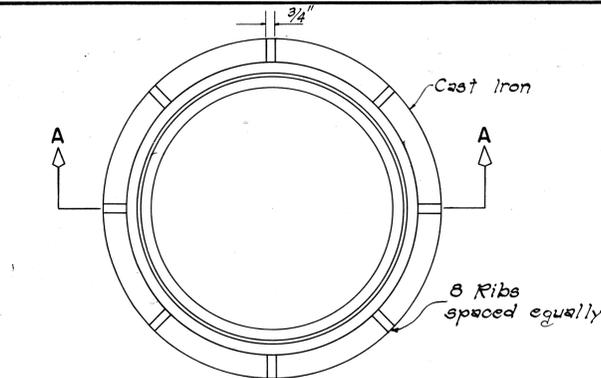


PLAN

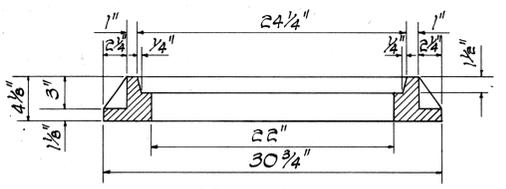


SECTION A-A

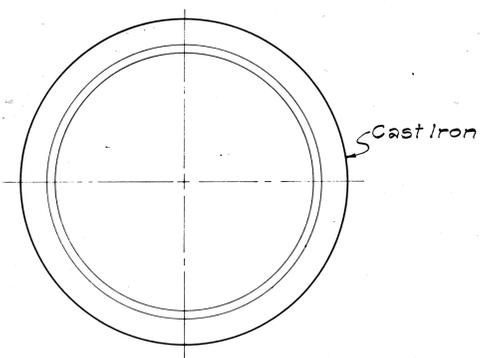


PLAN OF RIM

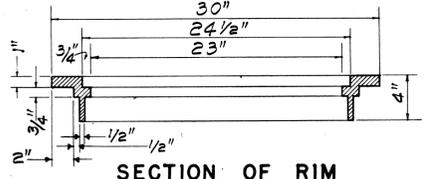


SECTION OF RIM

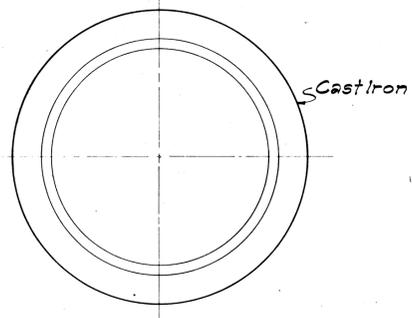


PLAN OF RIM

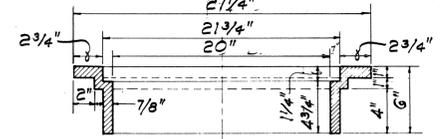


SECTION OF RIM

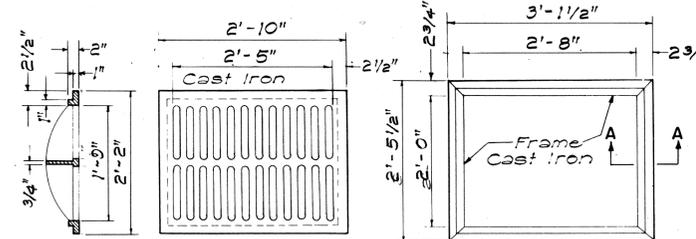


SECTION TOP VIEW TOP VIEW
TYPE C C.I. FRAME AND GRATE
SCALE: 3/4" = 1'-0"

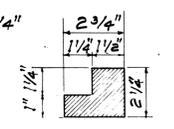


SECTION "A-A"
SCALE 3" = 1'-0"

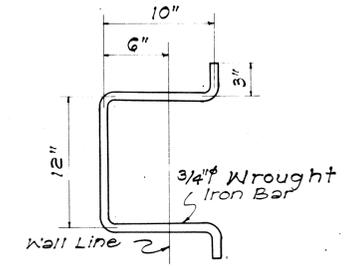


MANHOLE RUNG
SCALE: 1-1/2" = 1'-0"

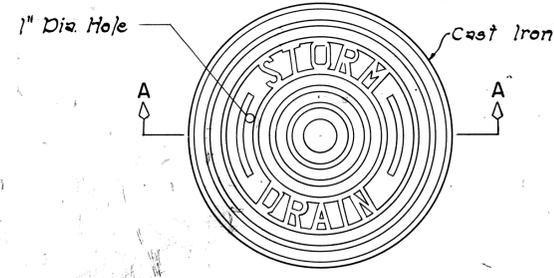


PLAN

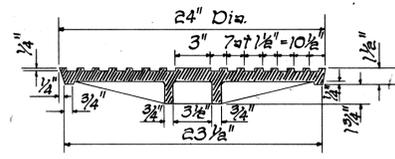


SECTION A-A

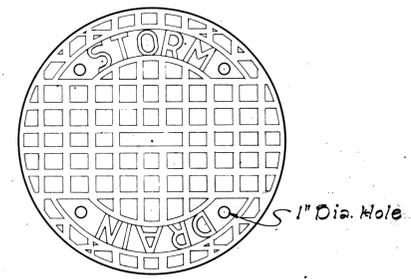


TOP VIEW OF COVER

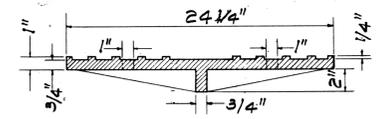


SECTION

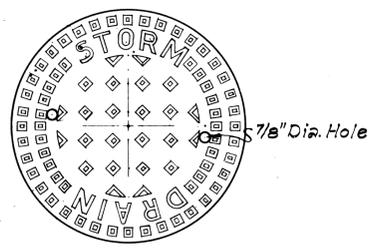

TOP VIEW OF COVER

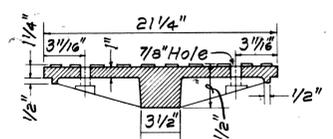


SECTION

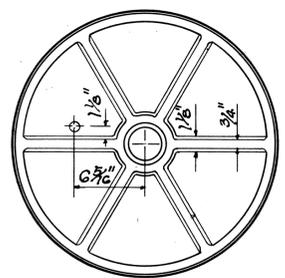


BOTTOM VIEW OF COVER

DETAILS OF TYPE "P"
CAST IRON FRAME AND COVER
SCALE: 1-1/2" = 1'-0"

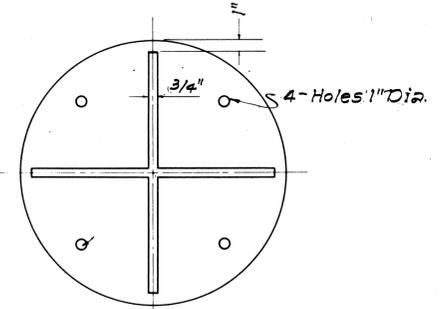

BOTTOM VIEW OF COVER

DETAILS OF TYPE "B"
CAST IRON FRAME AND COVER
SCALE: 1-1/2" = 1'-0"

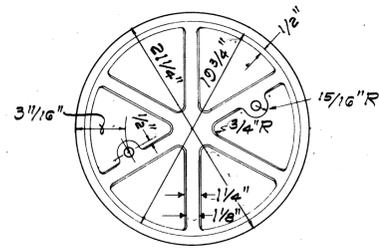

BOTTOM VIEW OF COVER

DETAILS OF TYPE "A"
CAST IRON FRAME AND COVER
SCALE: 1-1/2" = 1'-0"

ORIGINAL PLAN	DATE
SURVEY PLOTTED BY	
DRAWN BY	
TRACED BY	
QUANTITIES BY	
CHECKED BY	

NO.	REVISION	APPROVED BY	DATE
1.	Detail of Type "P" Cast Iron Frame and Cover	H.T.	1-6-71

APPROVAL RECOMMENDED:
R. Pakans 12-17-69
HYDRAULIC DESIGN ENGINEER DATE

APPROVED:
John S. S. S. 12-17-69
ASSISTANT CHIEF, ENGINEERING DATE

STATE OF HAWAII
DEPARTMENT OF TRANSPORTATION
HIGHWAYS DIVISION

STANDARD DETAILS
CATCH BASIN AND
MANHOLE CASTINGS

Scale: As Noted Date: July, 1969
SHEET No. 41H OF 41H SHEETS DH 6