



<u>Notes:</u>

- 1. Use 3-ply laminated flexible plastic, black-white-black thickness: black cap sheet-0.010", white base sheet-0.052", black base sheet-0.010".
- 2. Attach to meter socket using Scotch 3M brand Very High Bond(VHB) double coated acrylic foam tape or equivalent.
- 3. Letters/numbers shall be 1/16" stroke, (white in color).
- 4. Letters/numbers area inscribed by cutting through "black cap sheet" to expose white letters/numbers.



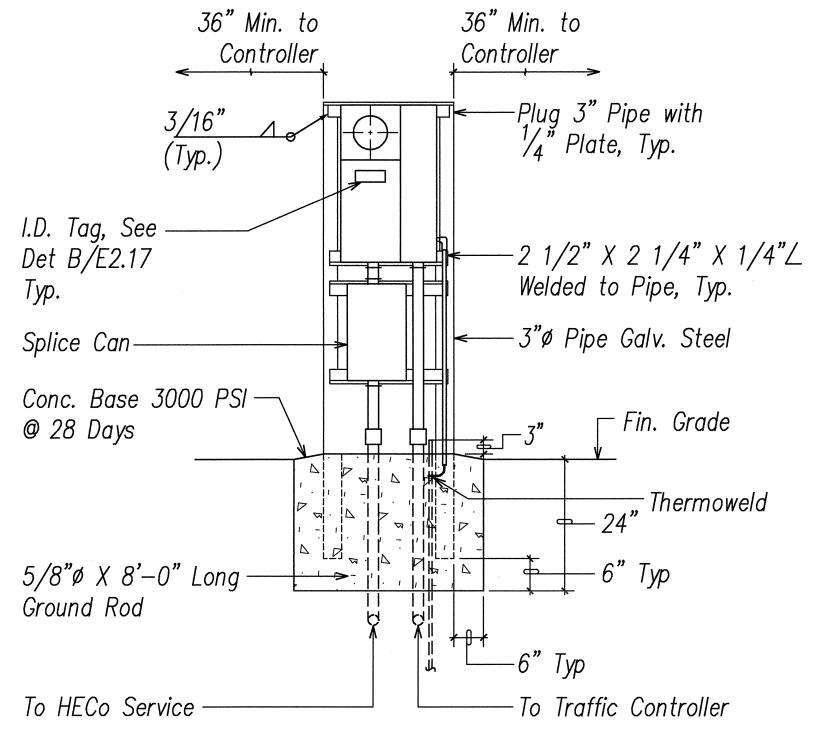


FRONT ELEVATION

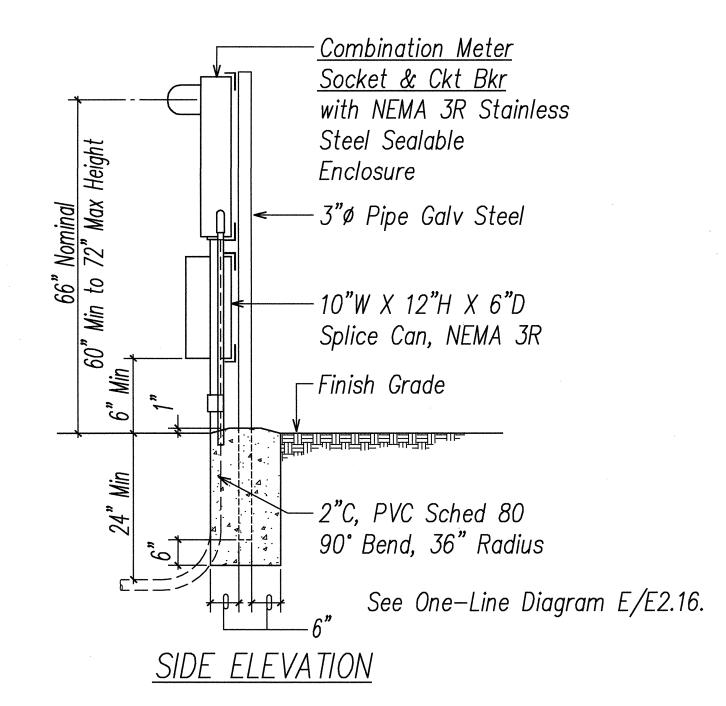



- 1. Contractor shall make all electrical connection to controller, provide 2-1P50A breakers, ground and 2" conduit.
- 2. All conduits to contain a polyolefin pull line. (Jet Line Cat. #232 or Equiv)
- 3. Pedestal shall be hot-dipped galvanized after fabrication.
- 4. All fastening bolts, nuts & washers shall be stainless steel. Provide one coat shop primer & two coats of acrylic enamel finish, color to match controller cabinet.
- 5. Provide 48" clearance in front of meter.
- 6. See Pipe Guard Detail F/E2.19.

Notes:




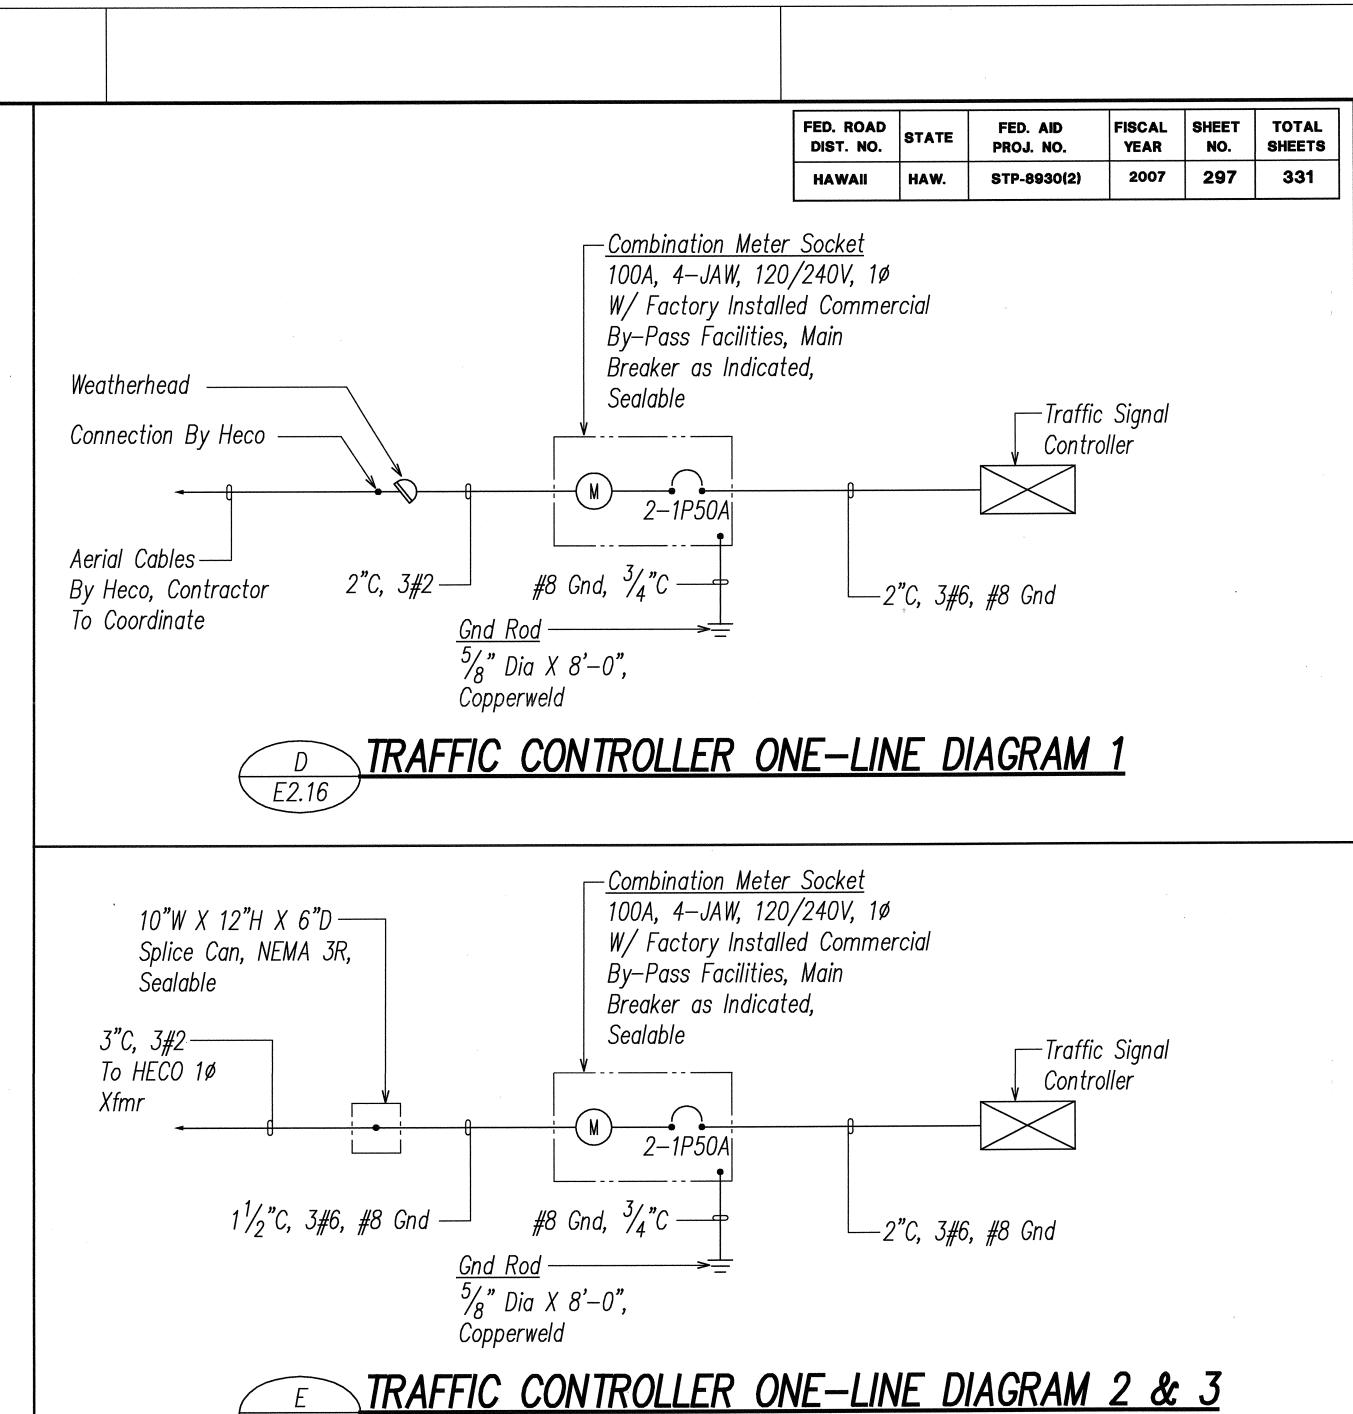


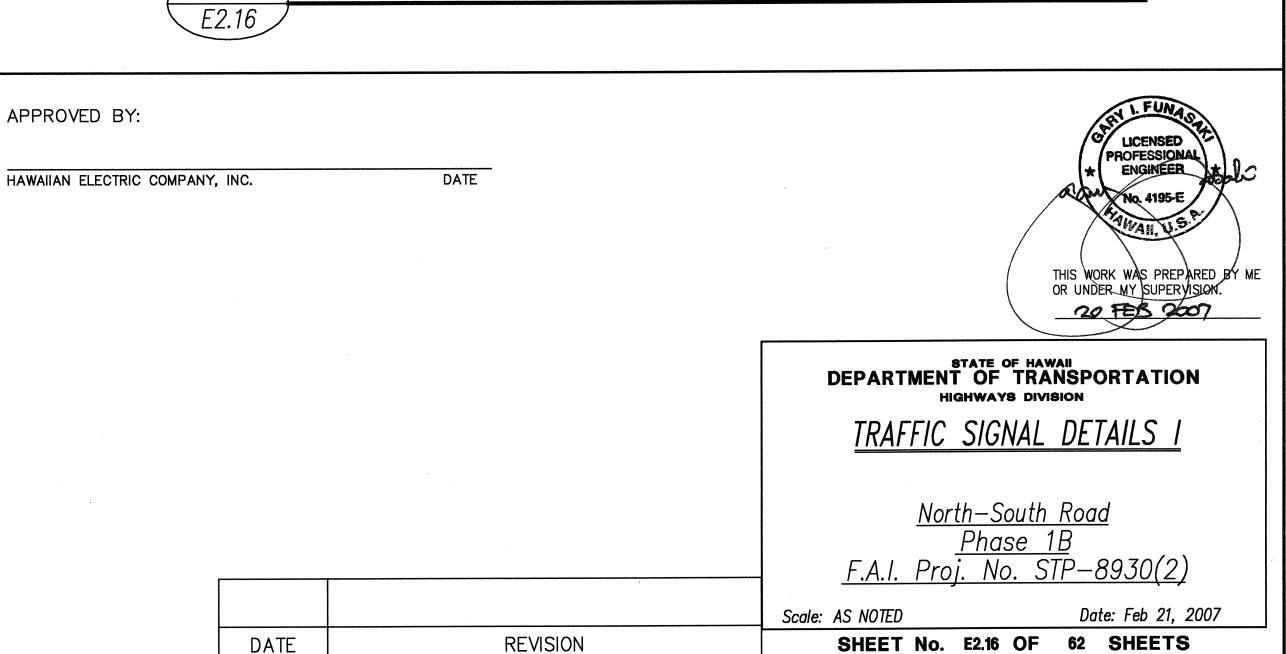


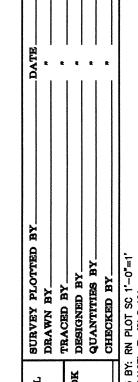


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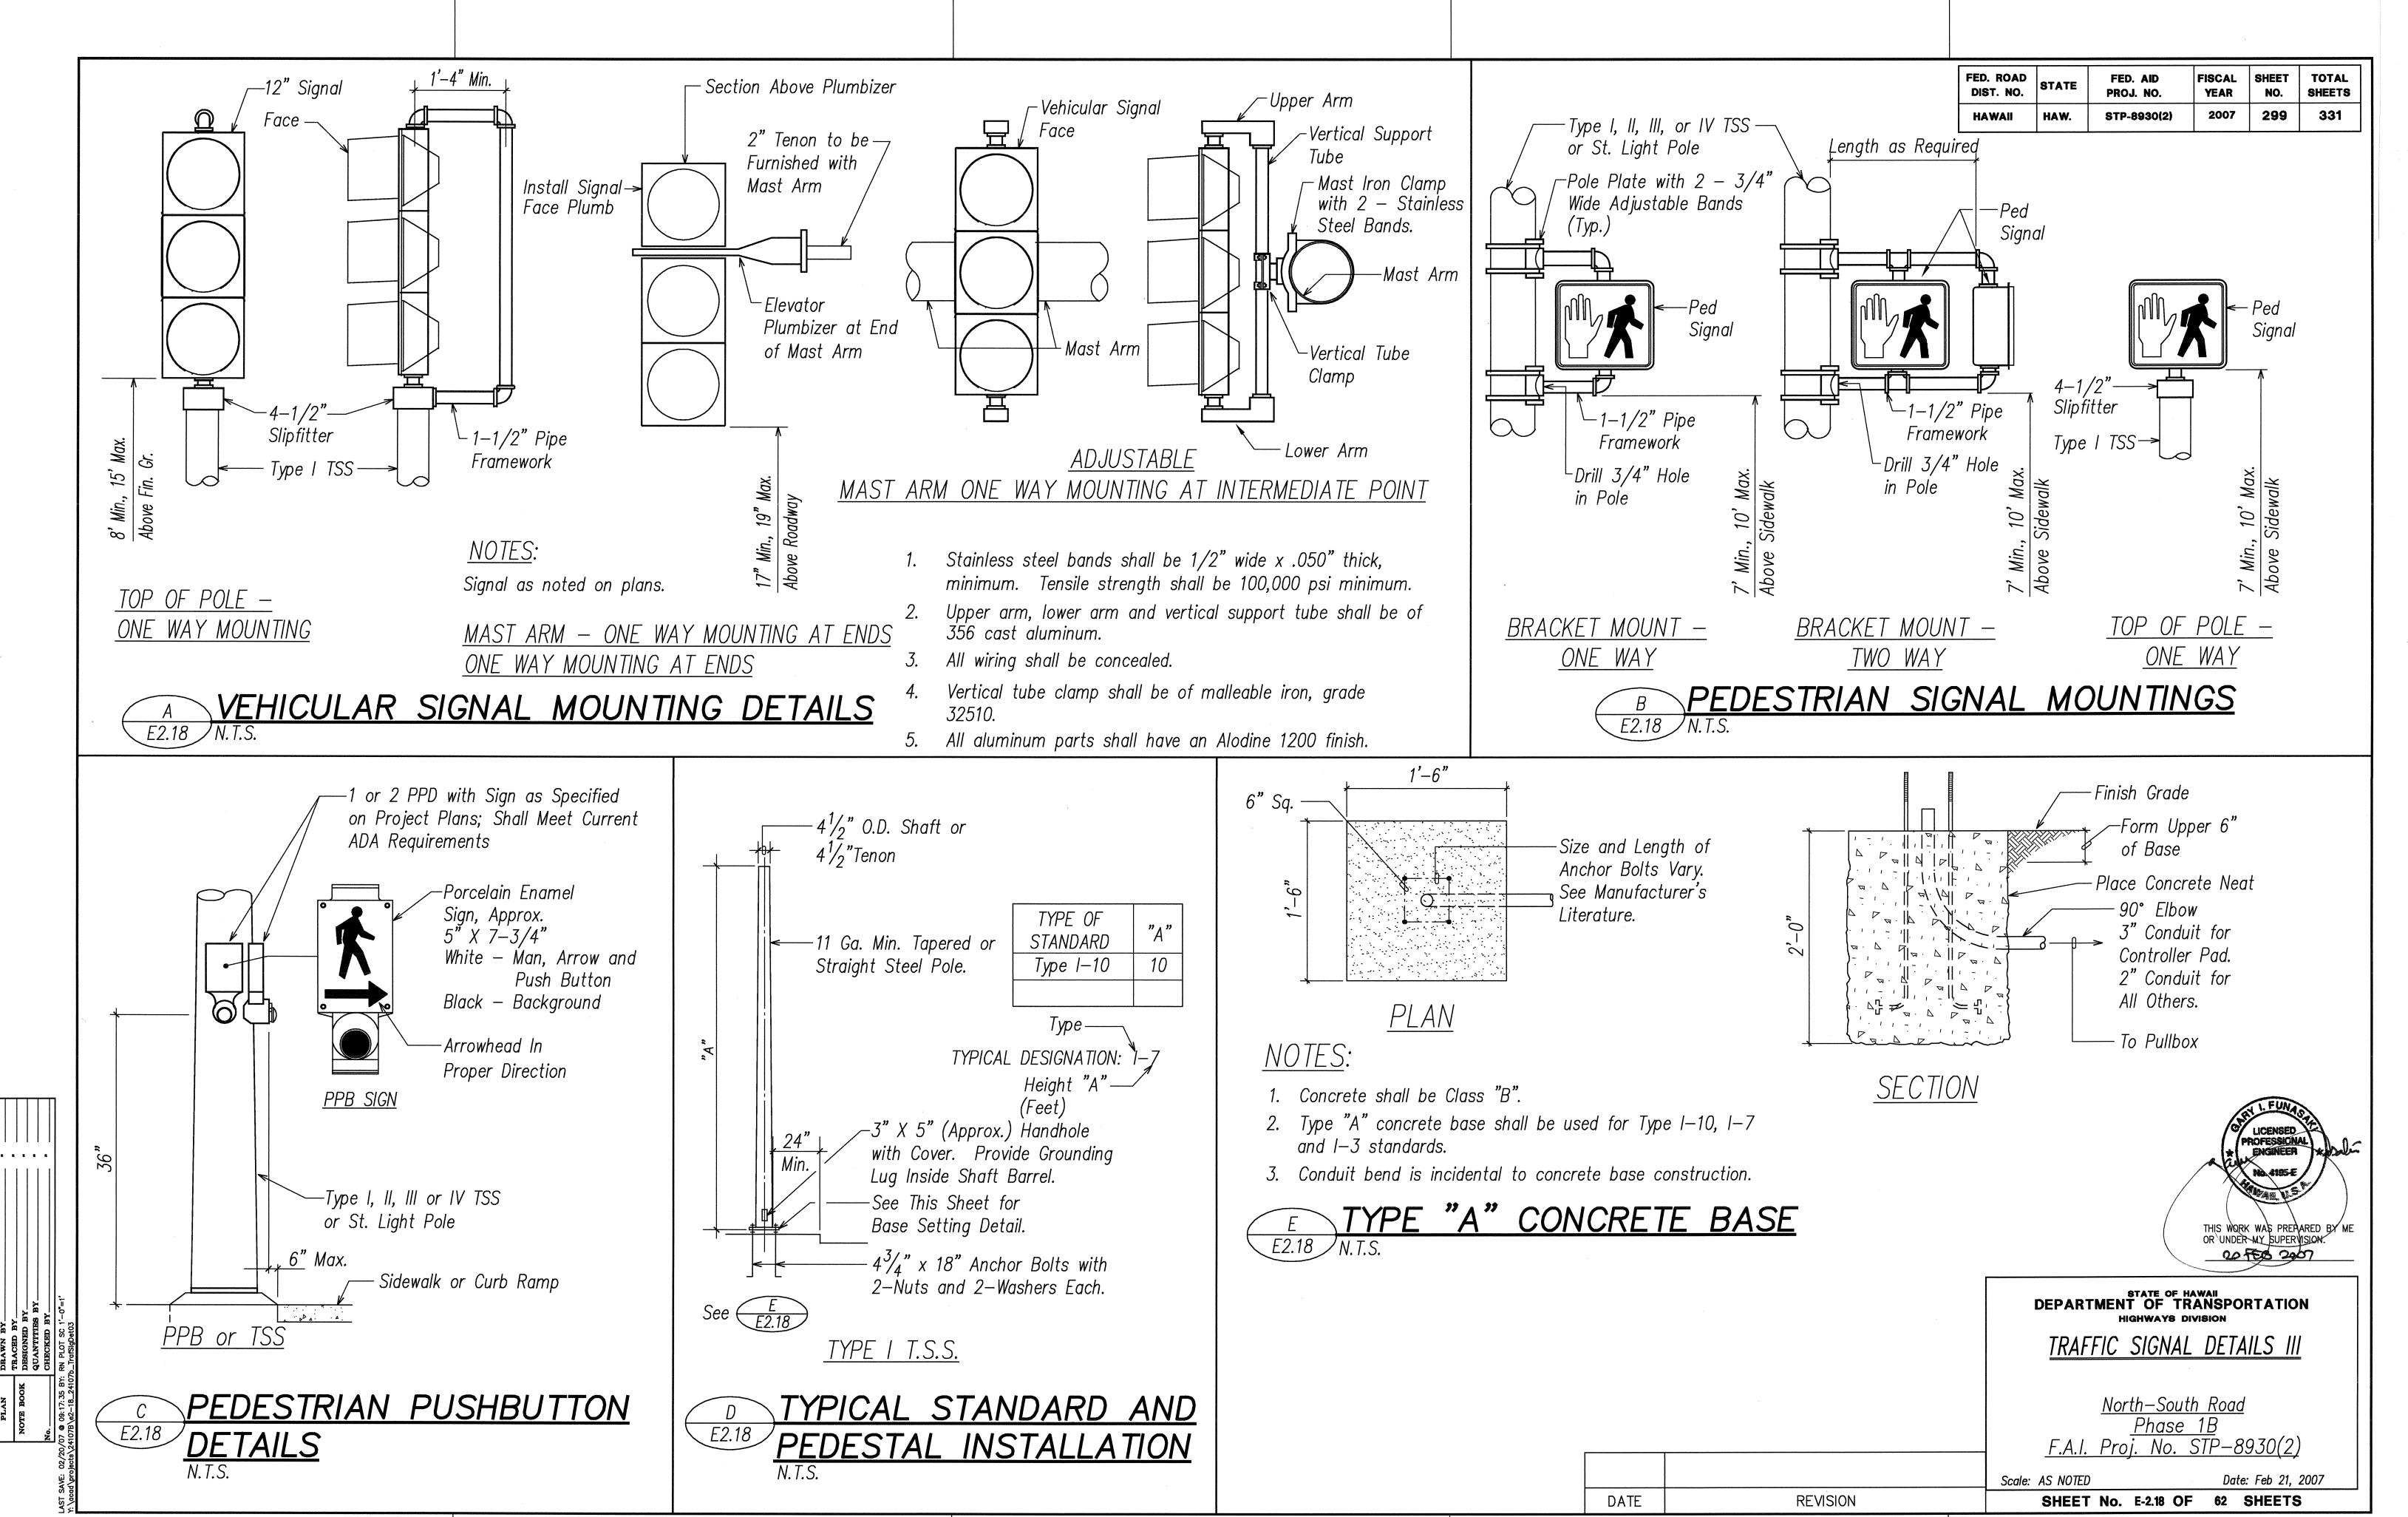
DEPARTMENT OF TRANSPORTATION TRAFFIC SIGNAL DETAILS II

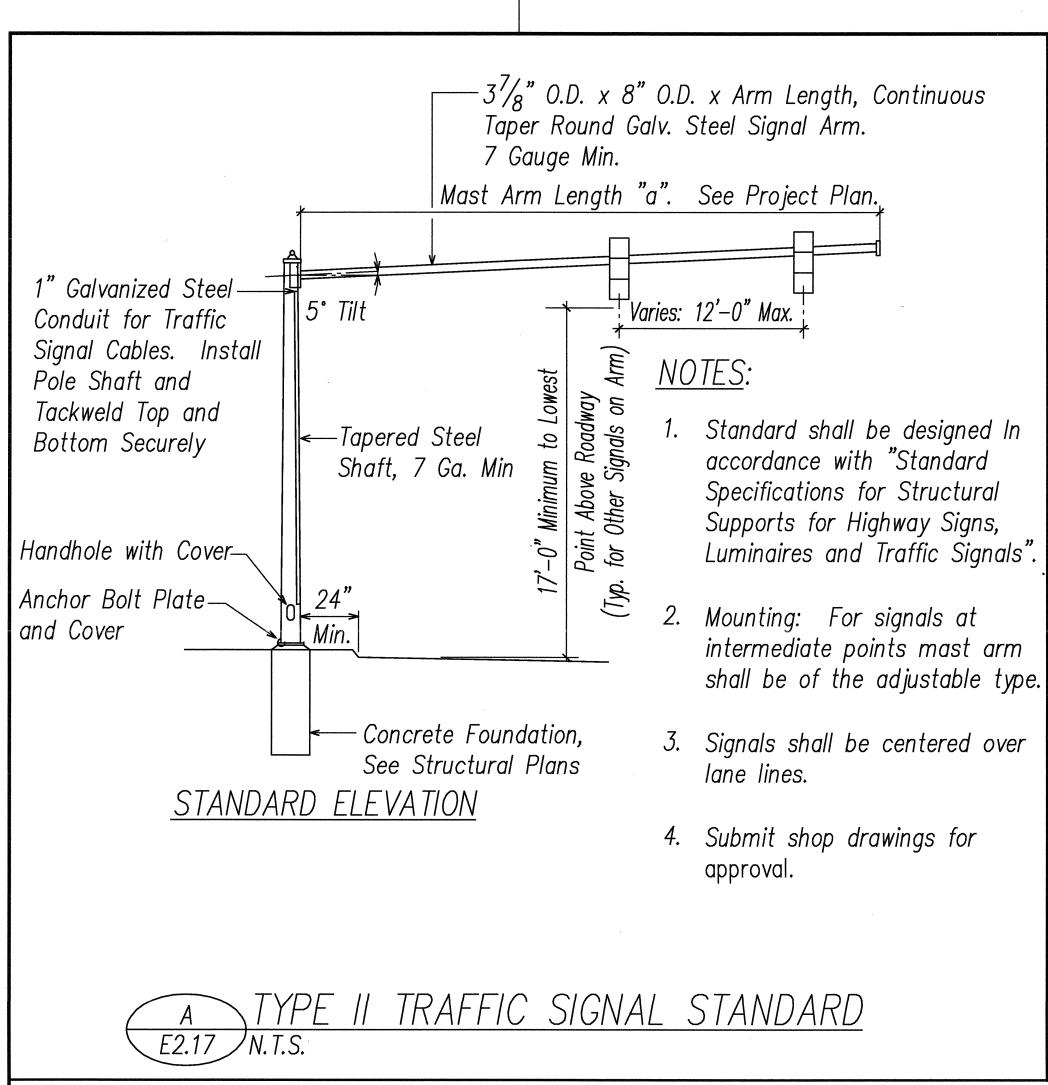North-South Road <u>Phase 1B</u> F.A.I. Proj. No. STP-8930(2)

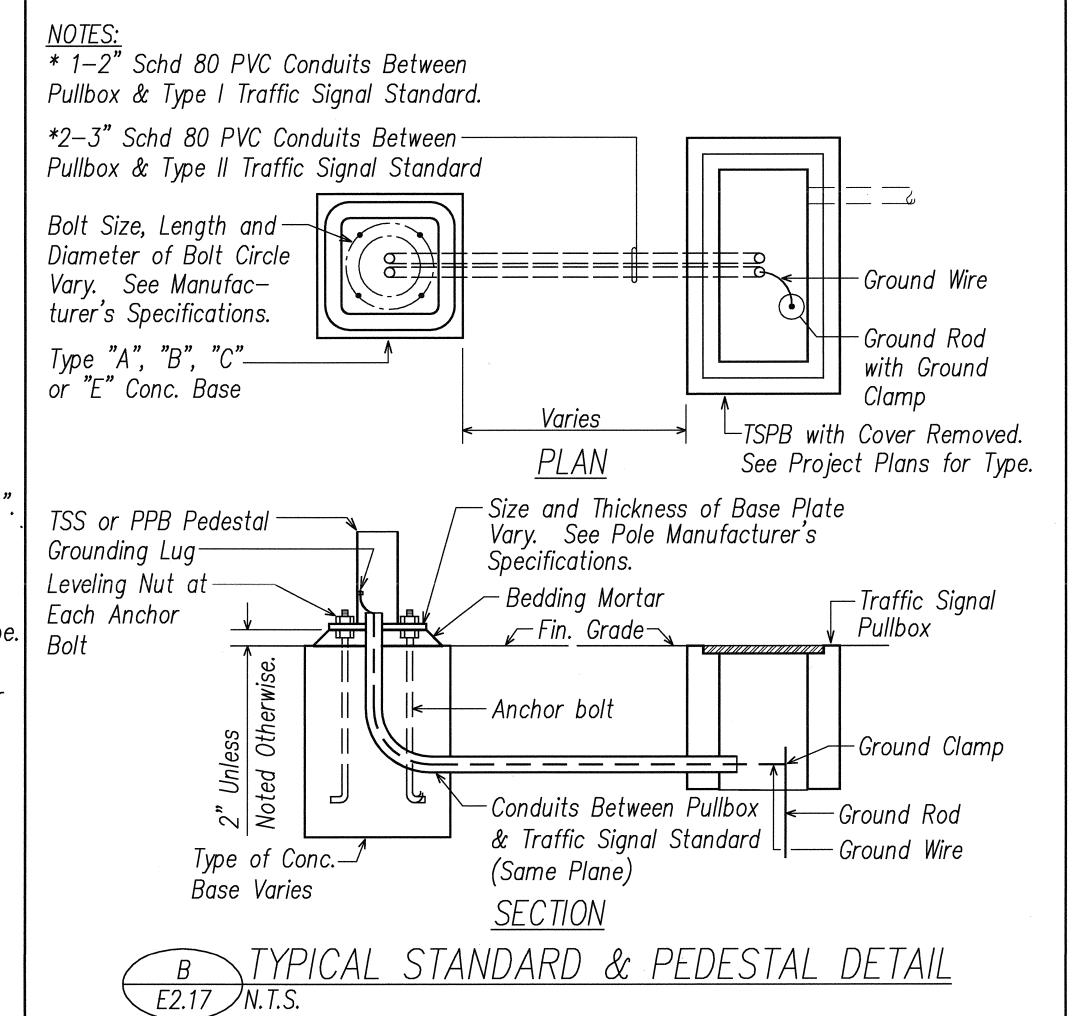
Date: Feb 21, 2007

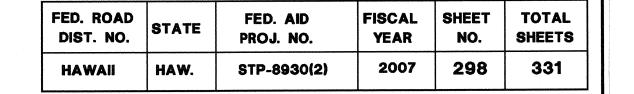
Scale: AS NOTED SHEET No. E2.17 OF 62 SHEETS DATE REVISION
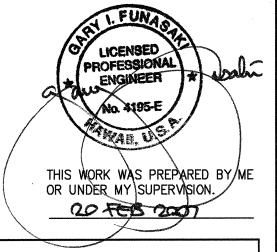
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FED. ROAD	STATE	FED. AID	FISCAL	SHEET	TOTAL
DIST. NO.		PROJ. NO.	YEAR	NO.	SHEETS
HAWAII	HAW.	STP-8930(2)	2007	300	331



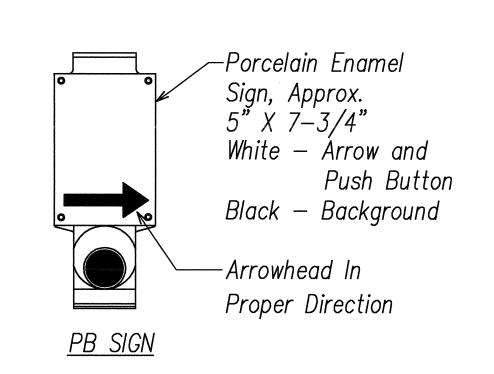


POST AND FOOTING DETAIL

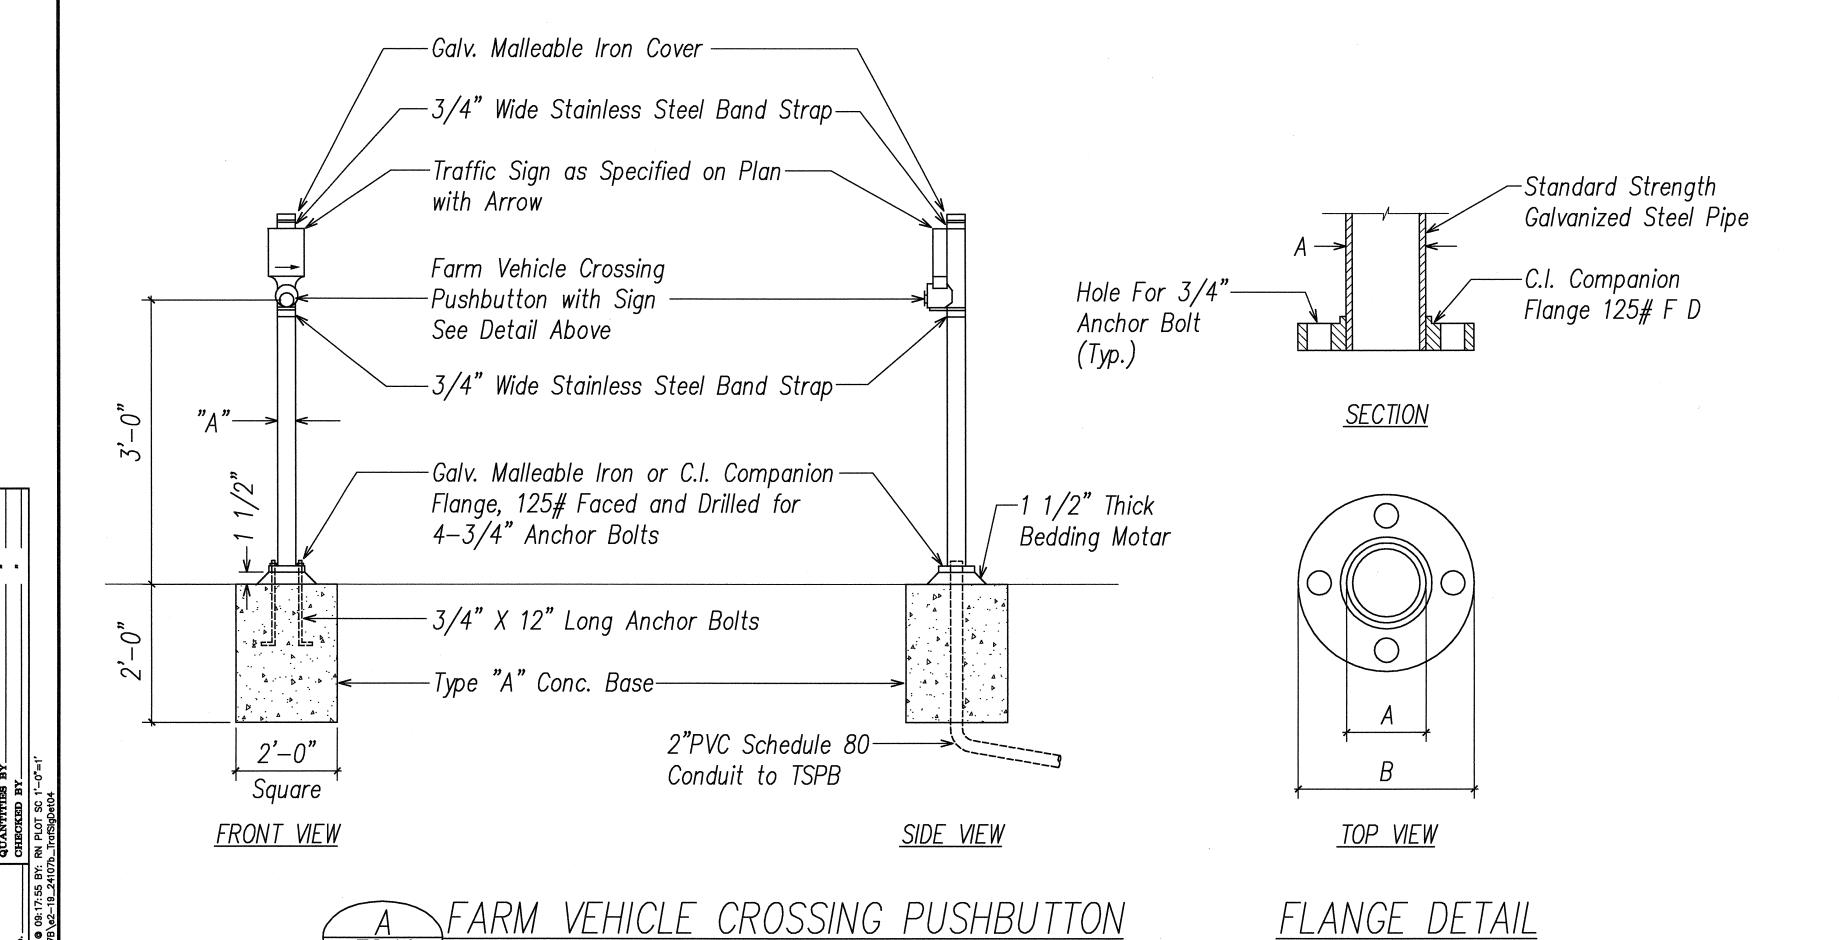NOT TO SCALE

<u>NOTE</u>:

- 1. Conduits shall Protrude 2" Max above Finished Surface of Foundation.
- 2. Conduits Shall slope away from Post Foundation.

DATA TABLE FOR PB POST					
AMOUNT	DIMENSIONS				
OF PB	Α	В			
1	3 1/2"	8"			
2–3	4 1/2"	9"			

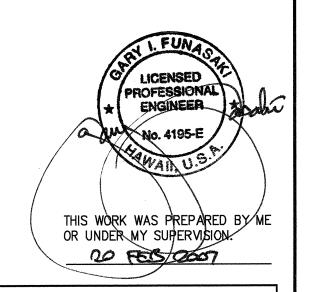

DEPARTMENT OF TRANSPORTATION HIGHWAYS DIVISION TRAFFIC SIGNAL DETAILS IV

<u>North-South Road</u> <u>Phase 1B</u> F.A.I. Proj. No. STP-8930(2)

 Scale: AS NOTED
 Date: Feb 21, 2007

 DATE
 REVISION

300