GENERAL NOTES:

1. All Work Shall be Constructed in Accordance With the Following Construction Standards and specifications:

Construction Standards of Department of Transportation, State of Hawaii, 2005.

Current Standards Specifications for Road and Bridge Construction, State of Hawaii.

- 2. It is Not the Intent of These Plans and Specifications to Indicate That All Existing Utilities are Shown on the Plans. The Information on the Existing Utilities are Based on Available Plans. The Locations are Approximate only and the Contractor Shall Verify the Location and Depth of the Facilities and Exercise Proper Care in Excavating in This Area. All Existing Utilities Whether or Not Shown on the Plans Shall be Protected at All Times by the Contractor. The Contractor shall be Responsible for Any Damages to the Facilities Whether Shown or Not Shown on Plans. Any Repair Work Shall be Provided at No Additional Cost to This Project.
- 3. Exercise Proper Care When Excavating in Areas With Existing Underground Facilities. Damages to the Existing Facilities Shall be Immediately Reported to the Respective Utility Companies, City or State Agency. The Repair Work Shall be Provided at no Additional Cost to the Project.
- 4. All Saw Cutting Work Shall be Considered Incidental to the Various Contract Items.
- 5. Notify and Coordinate Work With Construction and Maintenance Services, Department of Transportation, State of Hawaii 72 Hours in Advance of Commencing Installation of Highway Light System. (Ph. No. 831-6712)
- 6. For Typical Construction Details Not Shown on Plans, Refer to Applicable Standard Details of Construction and Maintenance Services, Department of Transportation, State of Hawaii.
- 7. The Highway Lighting System Shall Remain Operational During All Night Hours. The Contractor Shall be Responsible for Construction Phasing and/or Providing Temporary Lighting as Required to Maintain Operation of the Highway Lighting System.
- 8. Furnish Install a Minimum Two Each Keyed Tamper-proof Screws per Pullbox Cover Section Per State DOT Highways Standard. State DOT Highways Approved Screw Manufacturer is Bryce Fastener, Part #3GSRB12300 or Pre-approved Equal, Obtain Standard DOT Key Code from State DOT Highways Project Manager.

PULLBOX SCHEDULE

(100)	State Highways Electric Pullbox Type A, See State DOT Standard Plan TE-37A, See
	State DOT Standard Plan TE-37A, See
	General Note 8.

(101A) State Highways Street Light Pullbox Type B, See State DOT Standard Plan TE-37C, See General Note 8.

DUCT DESIGNATION

2	S	4 (A)	
			Duct Section "A" See Duct Section Details Conduit Size System: "S" Secondary Electric (Normal) "L" Lighting, Street, Area or Sign "SP" Spare "SS" Scale Signal
			Number of Ducts

FED. ROAD DIST. NO. STATE FEDERAL AID PROJ. NO. FISCAL YEAR NO. SHEETS

HAWAII HAW. STP-7415(001) 2014 157 173

SITE ELECTRICAL SYMBOLS

Single Bracket Arm Highway Light Standard
With Breakaway Transformer Base
Foundation, 113W LED

O-O Double Bracket Arm Highway Light Standard
With Breakaway Transformer Base
Foundation, 113W LED

Single Bracket Arm Highway Light Standard With Breakaway Transformer Base Foundation, 130W LED

Junction Box, Wall Mounted, Size as Indicated on the Drawings

□ Pullbox

 \varnothing

Transformer and Concrete Pad

BC Bare Copper

GRS Galvanized Rigid Steel

LED Light Emitting Diode

NWIM Nanotechnology Based Smart Concrete

Weigh-In-Motion Scale System

UON Unless Otherwise Noted

WIM Weigh-In-Motion Scale System

WP Weatherproof

1 >--> Key Note Indicator

----- Underground Ductline

Conduit \$ Wiring Concealed Within Concrete


Surface


----- Conduit \& Wiring Exposed

— eOH — Existing Overhead Utility Lines

1 D4 III L140 480V

Indicates Light Pole Identification Tag, See Detail

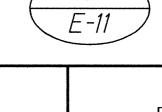

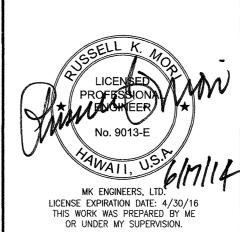

DEPARTMENT OF TRANSPORTATION
HIGHWAYS DIVISION

ELECTRICAL SYMBOLS


AND NOTES


MIDDLE STREET PAVENENT RECONSTRUCTION
North King Street to Kamehameha Highway


FAP NO. STP-7415(001)


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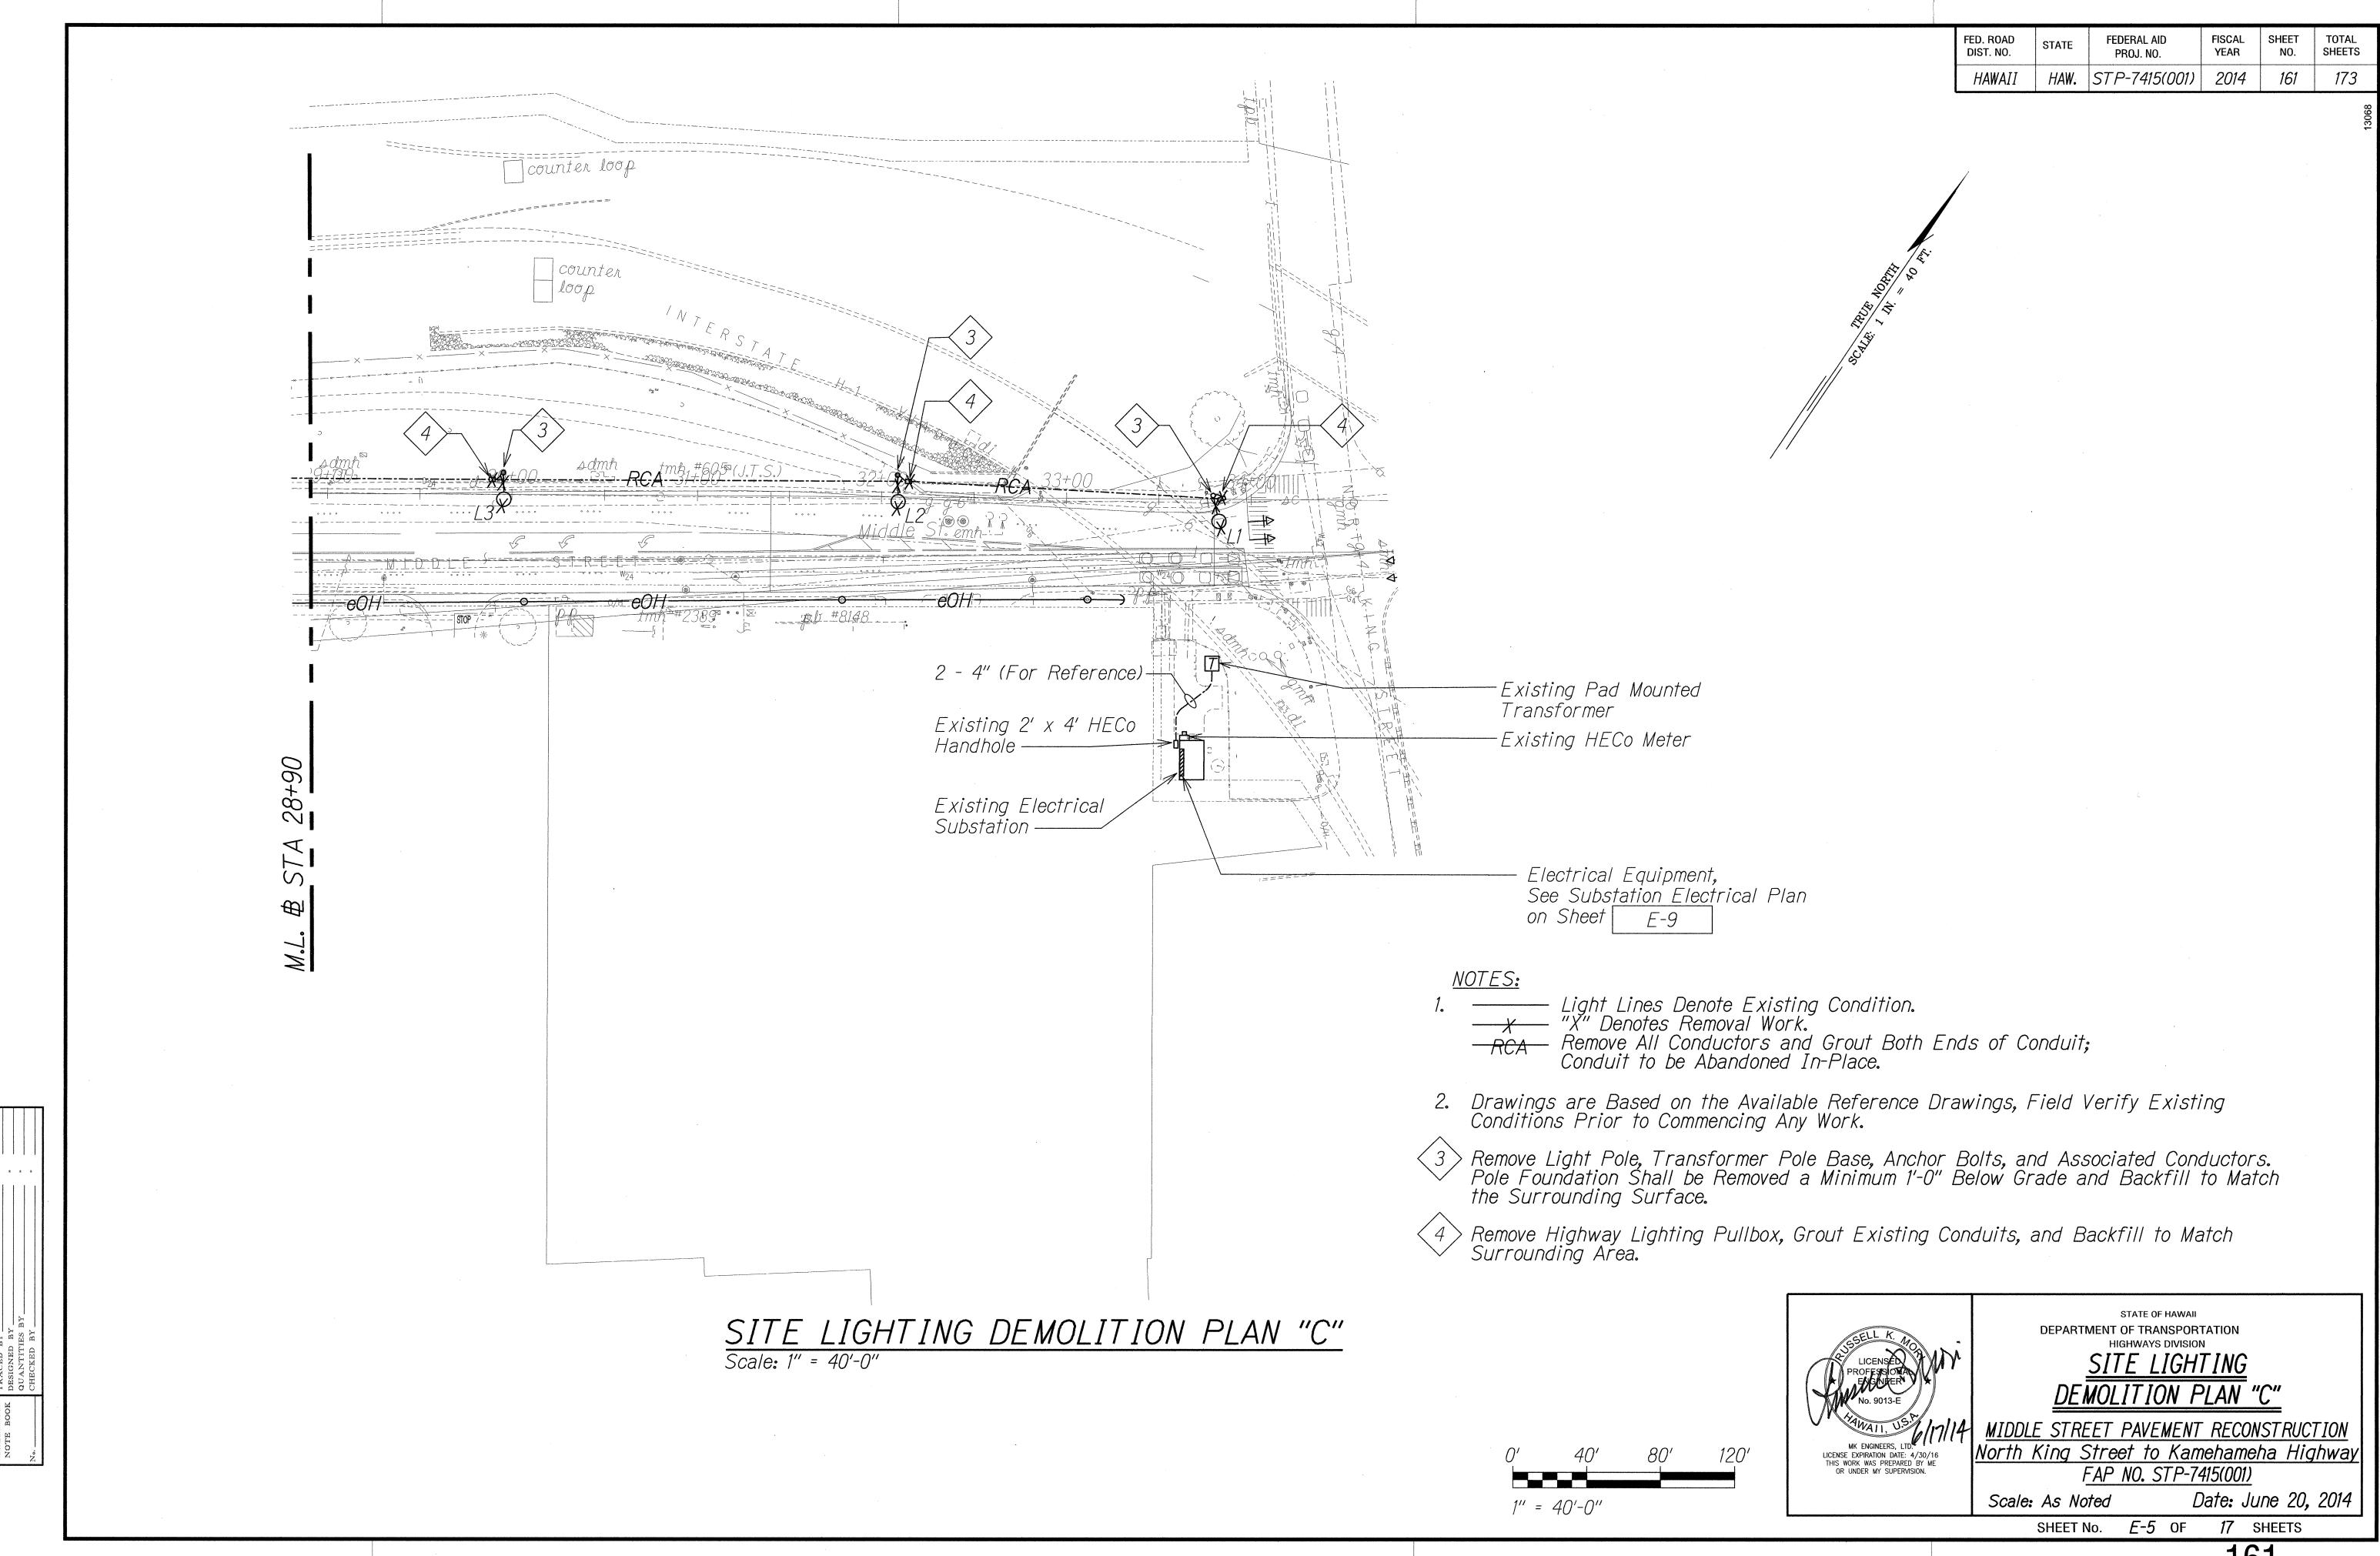
SHEET No. E-1 OF 17 SHEETS




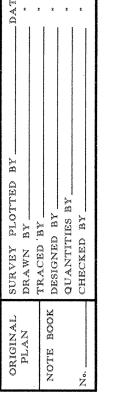


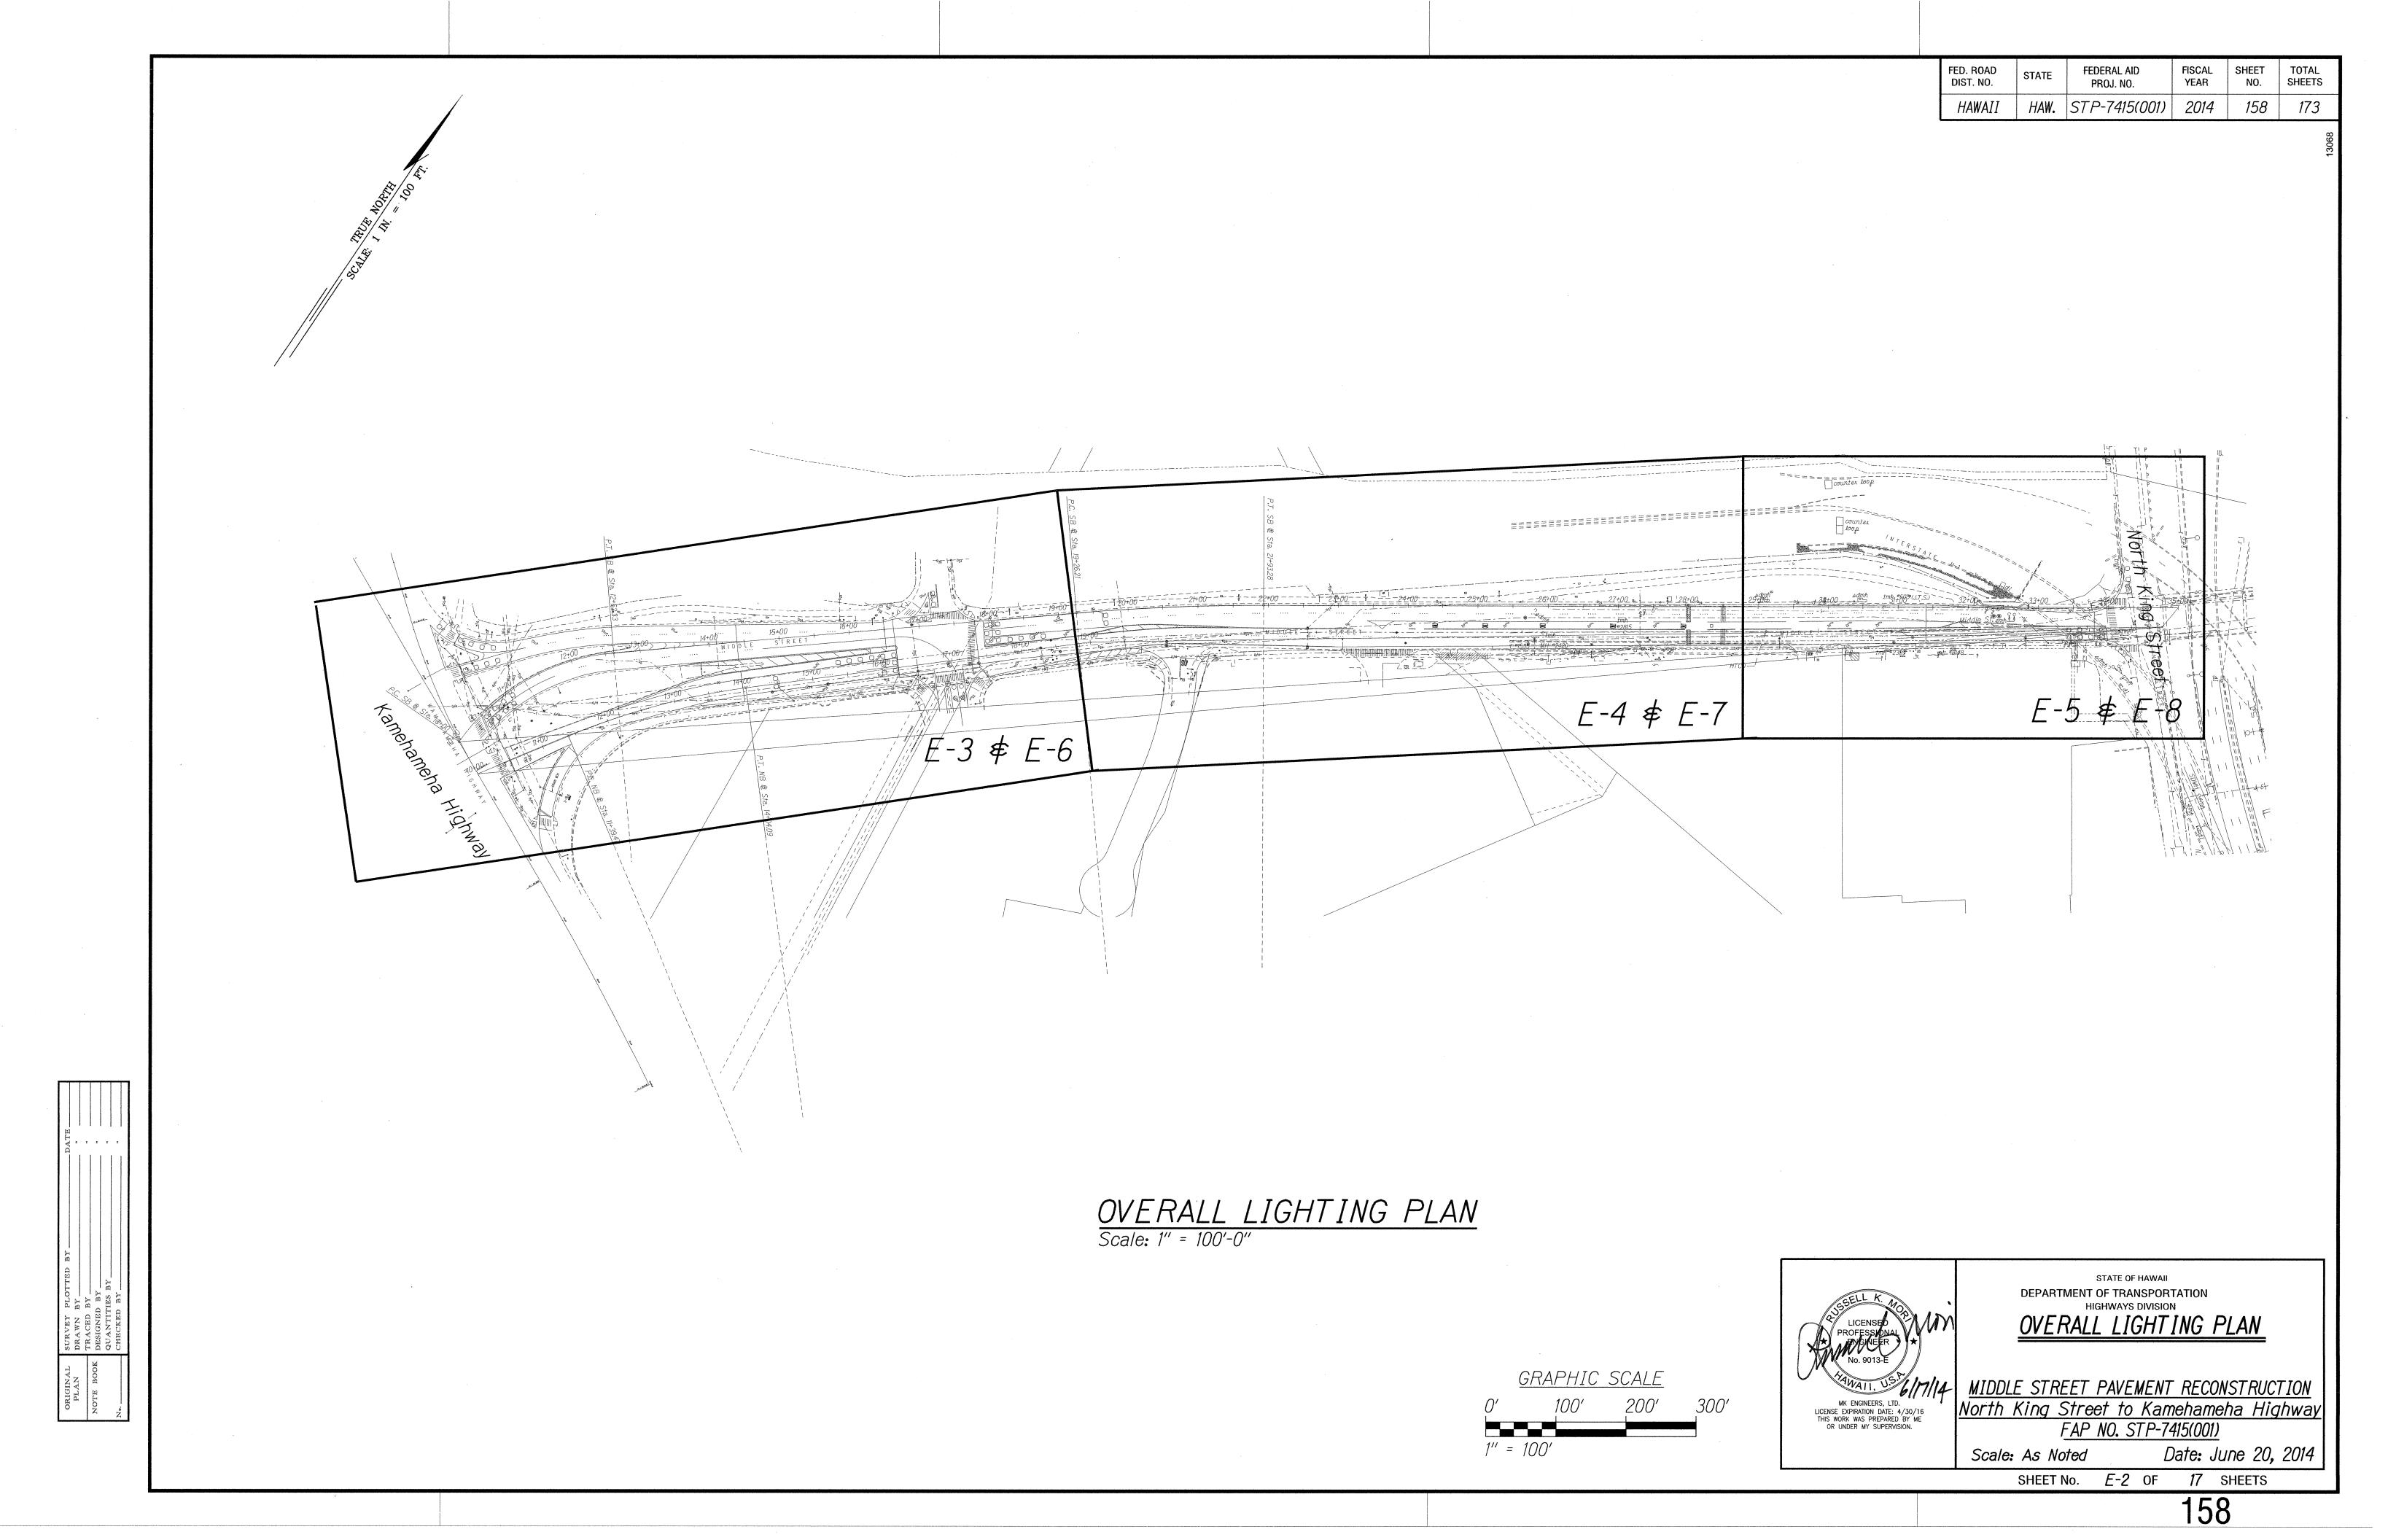

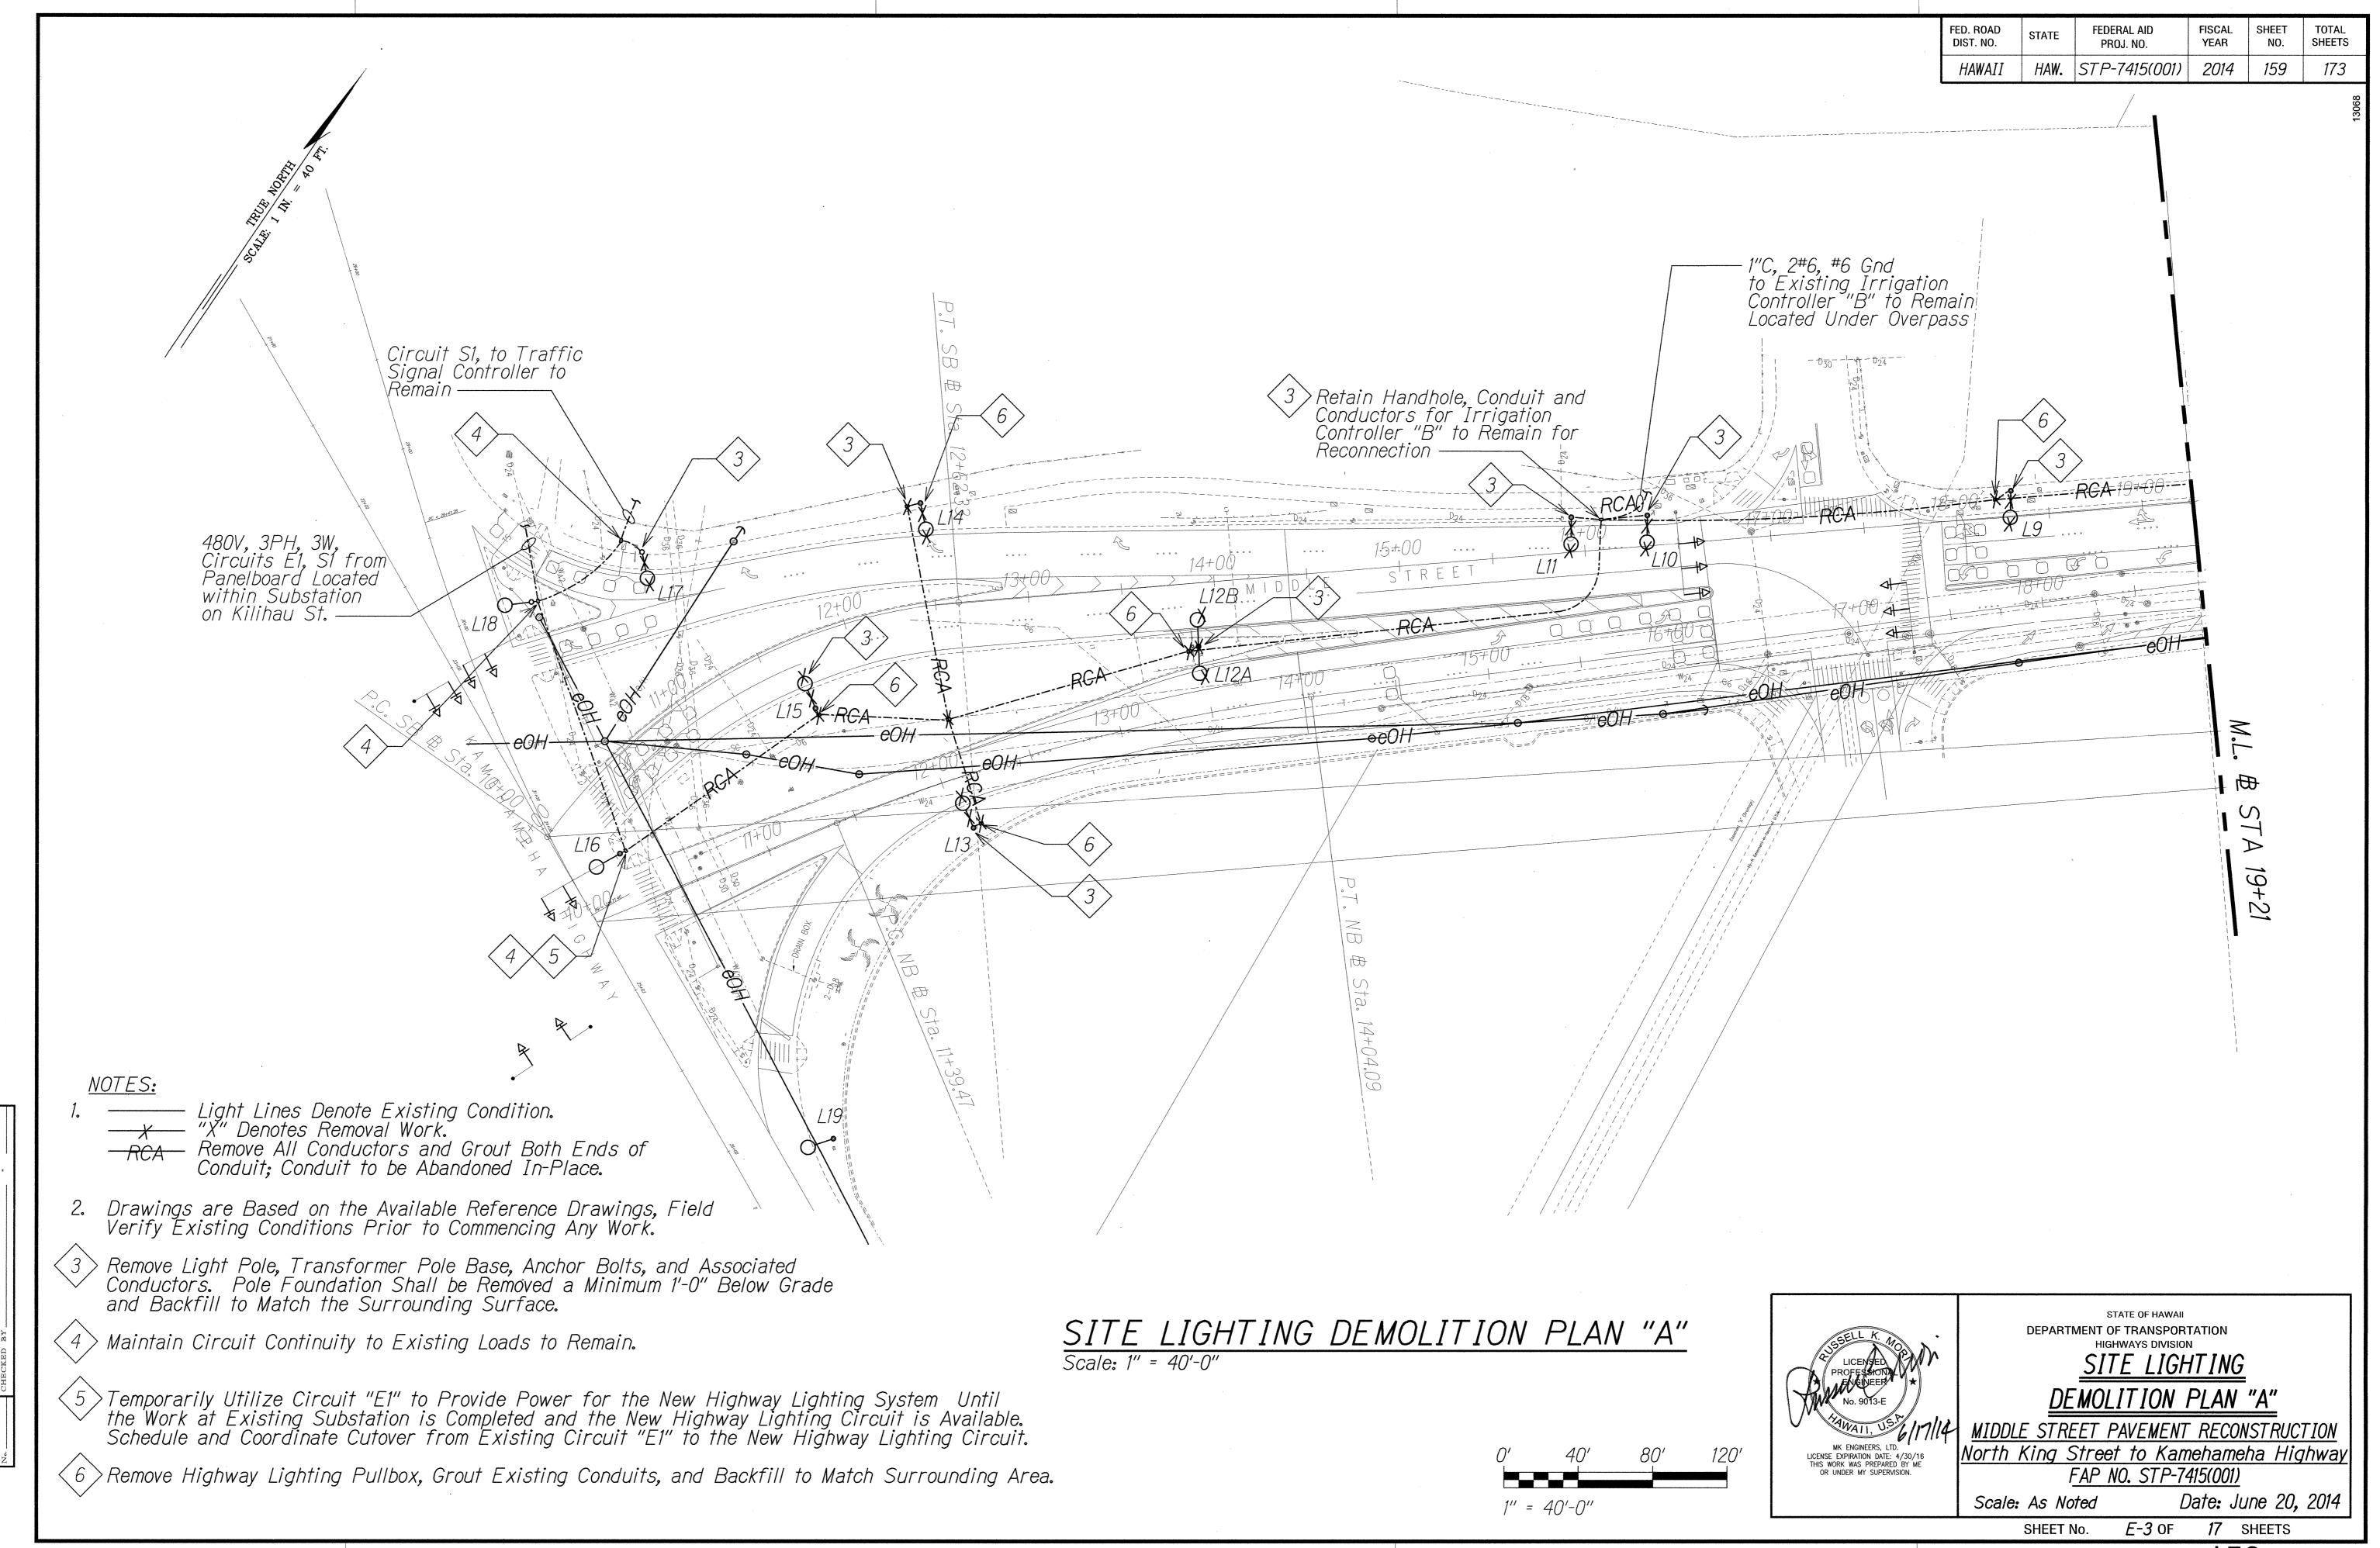

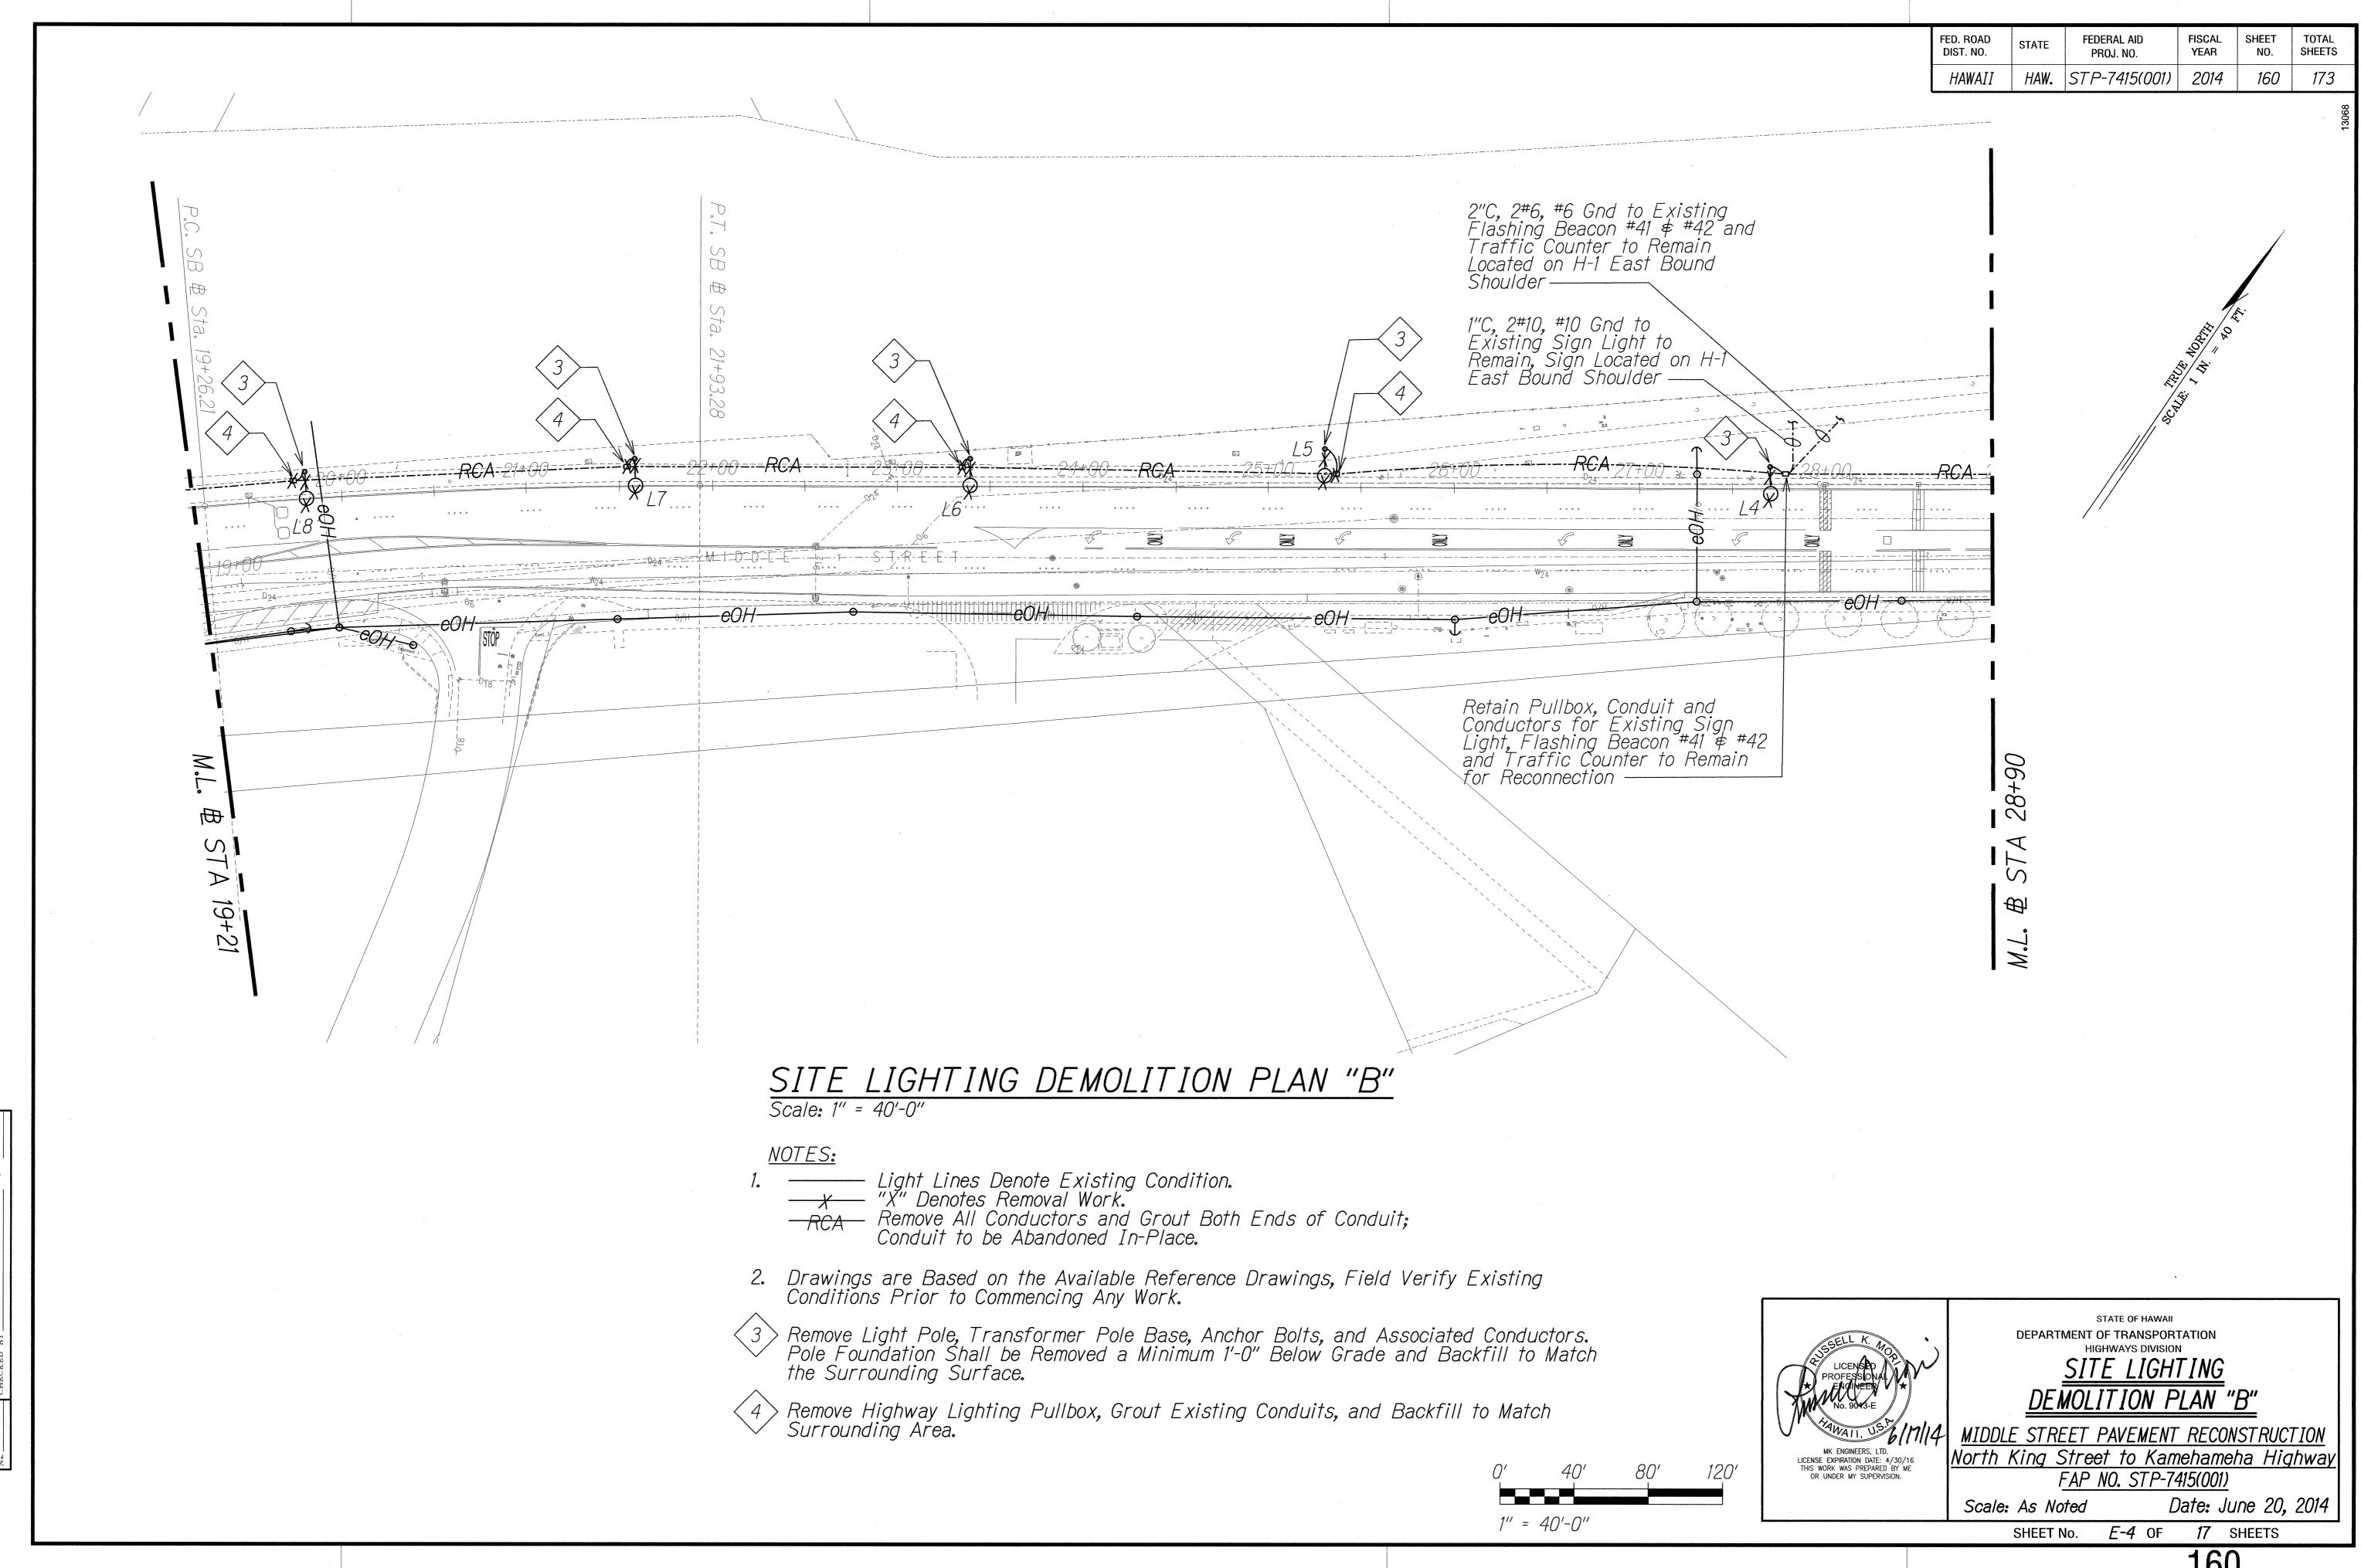


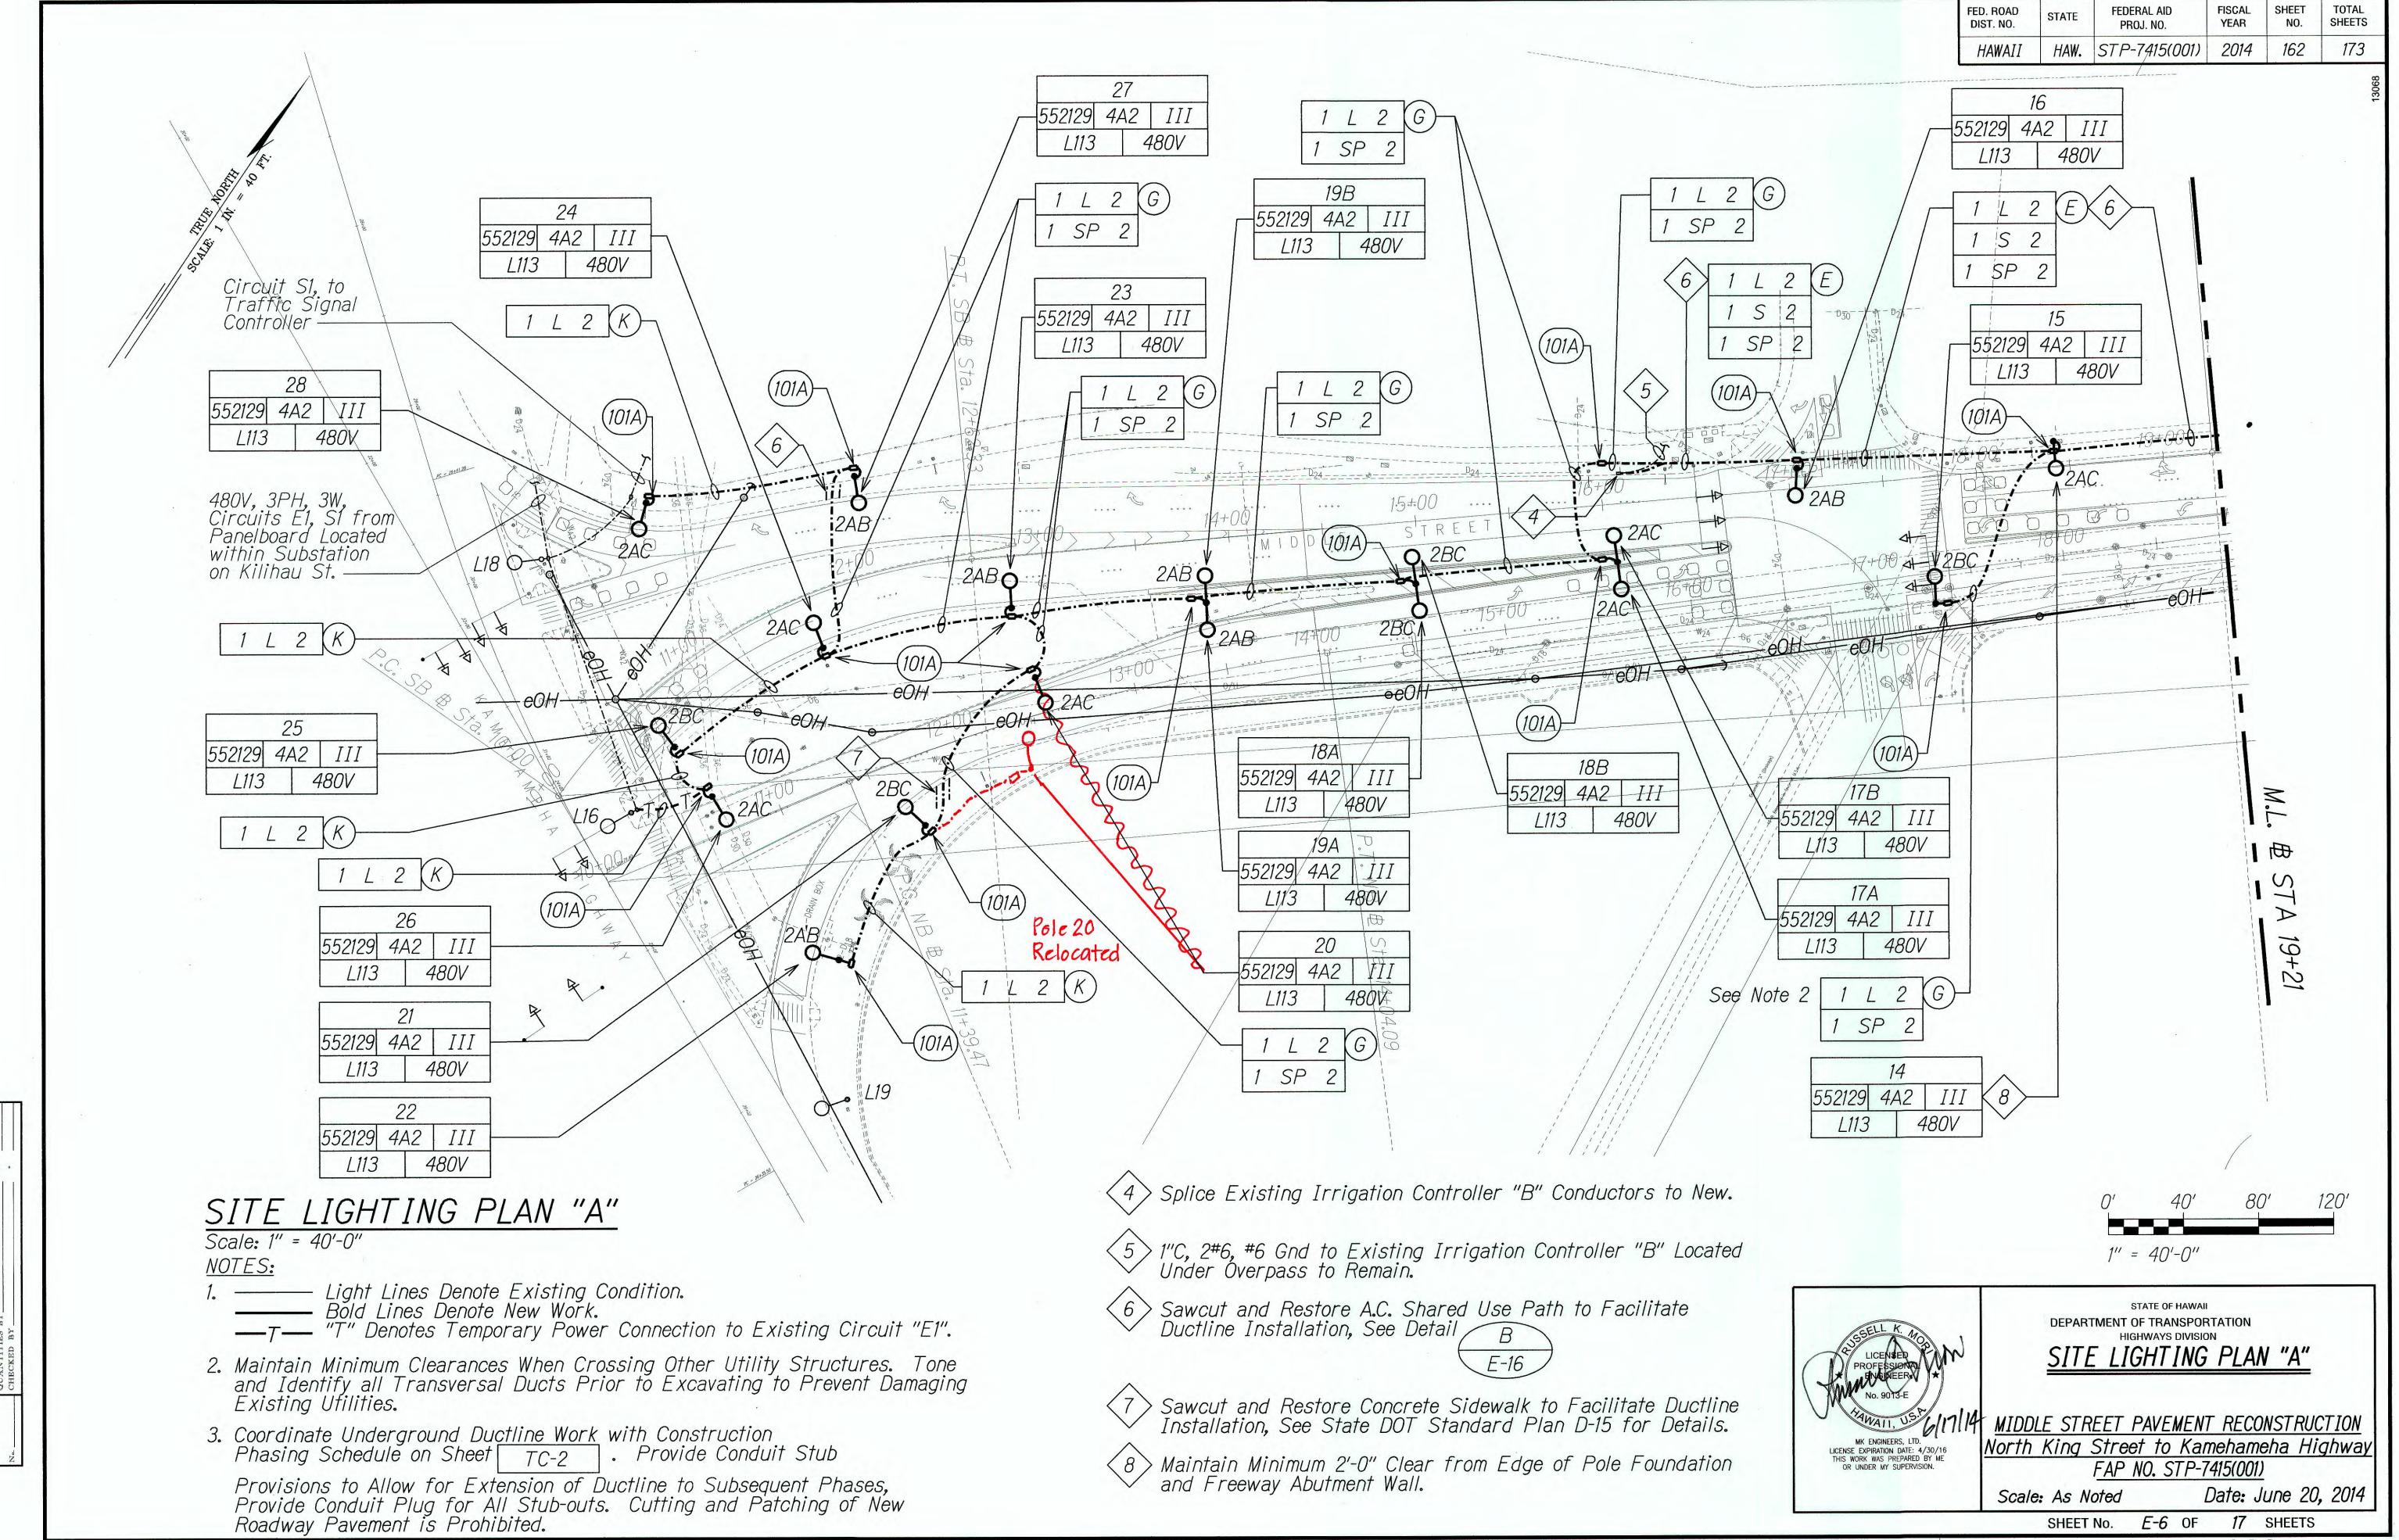

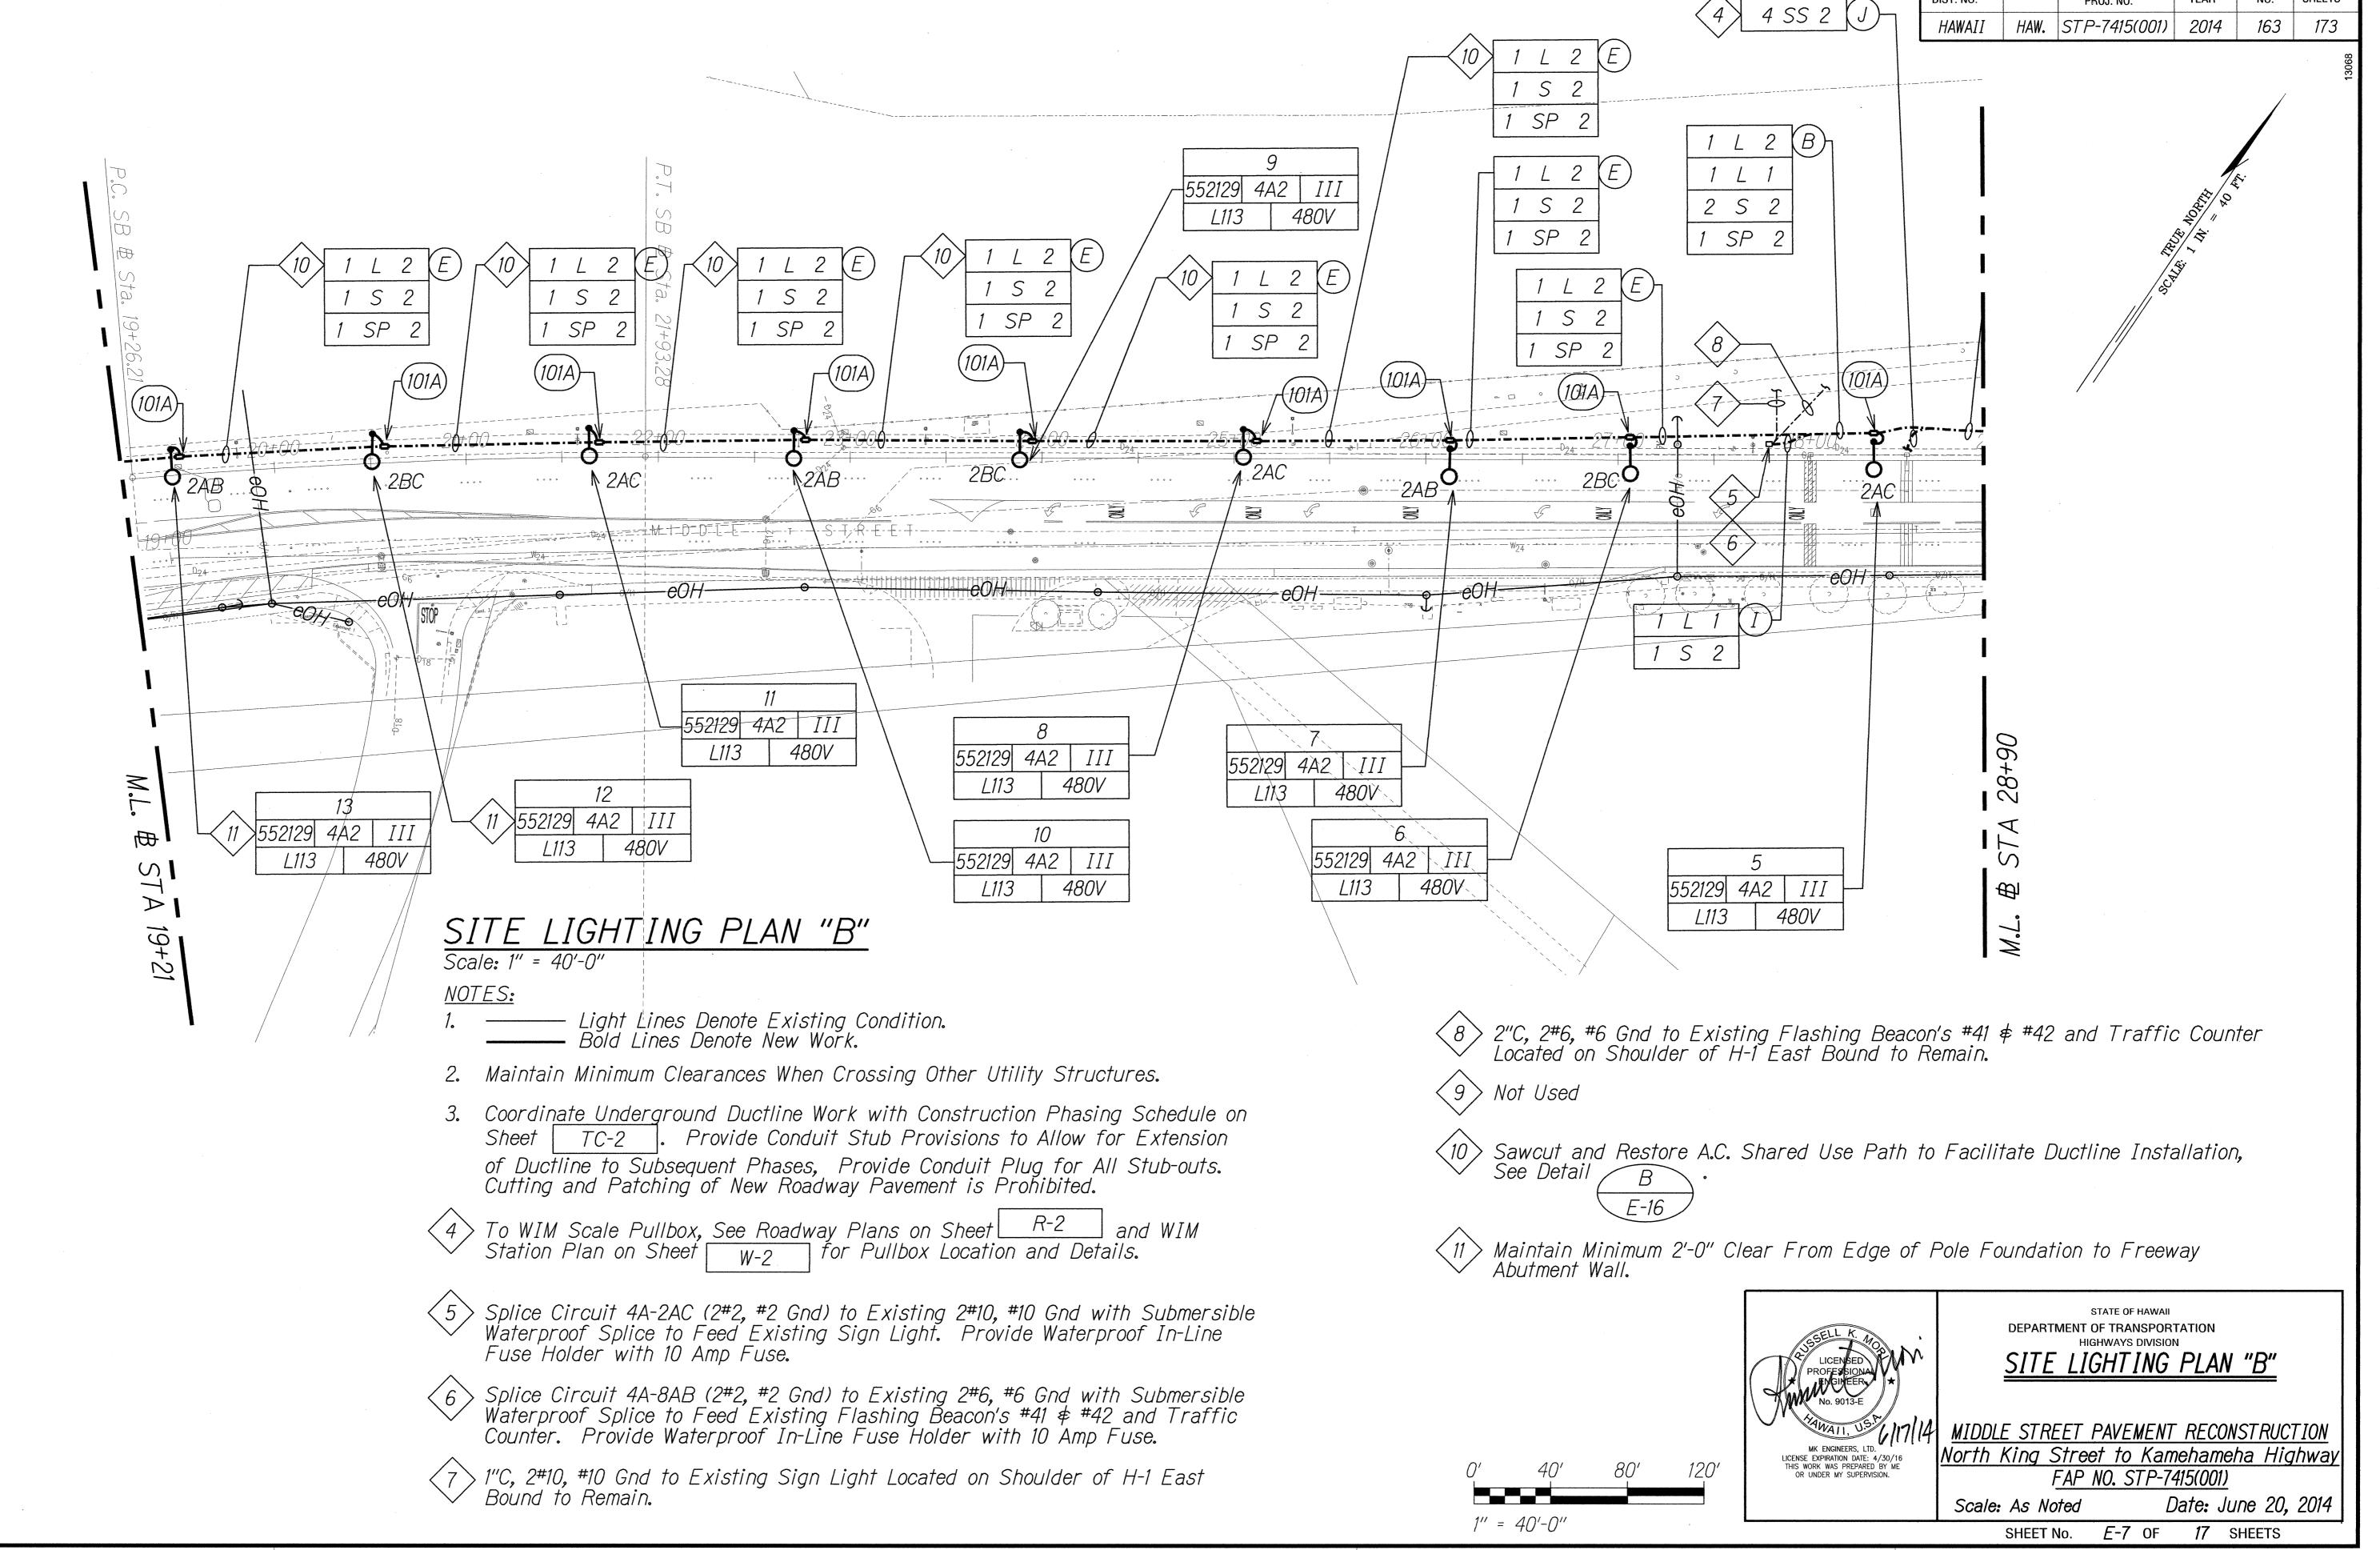


163

DIST. NO.

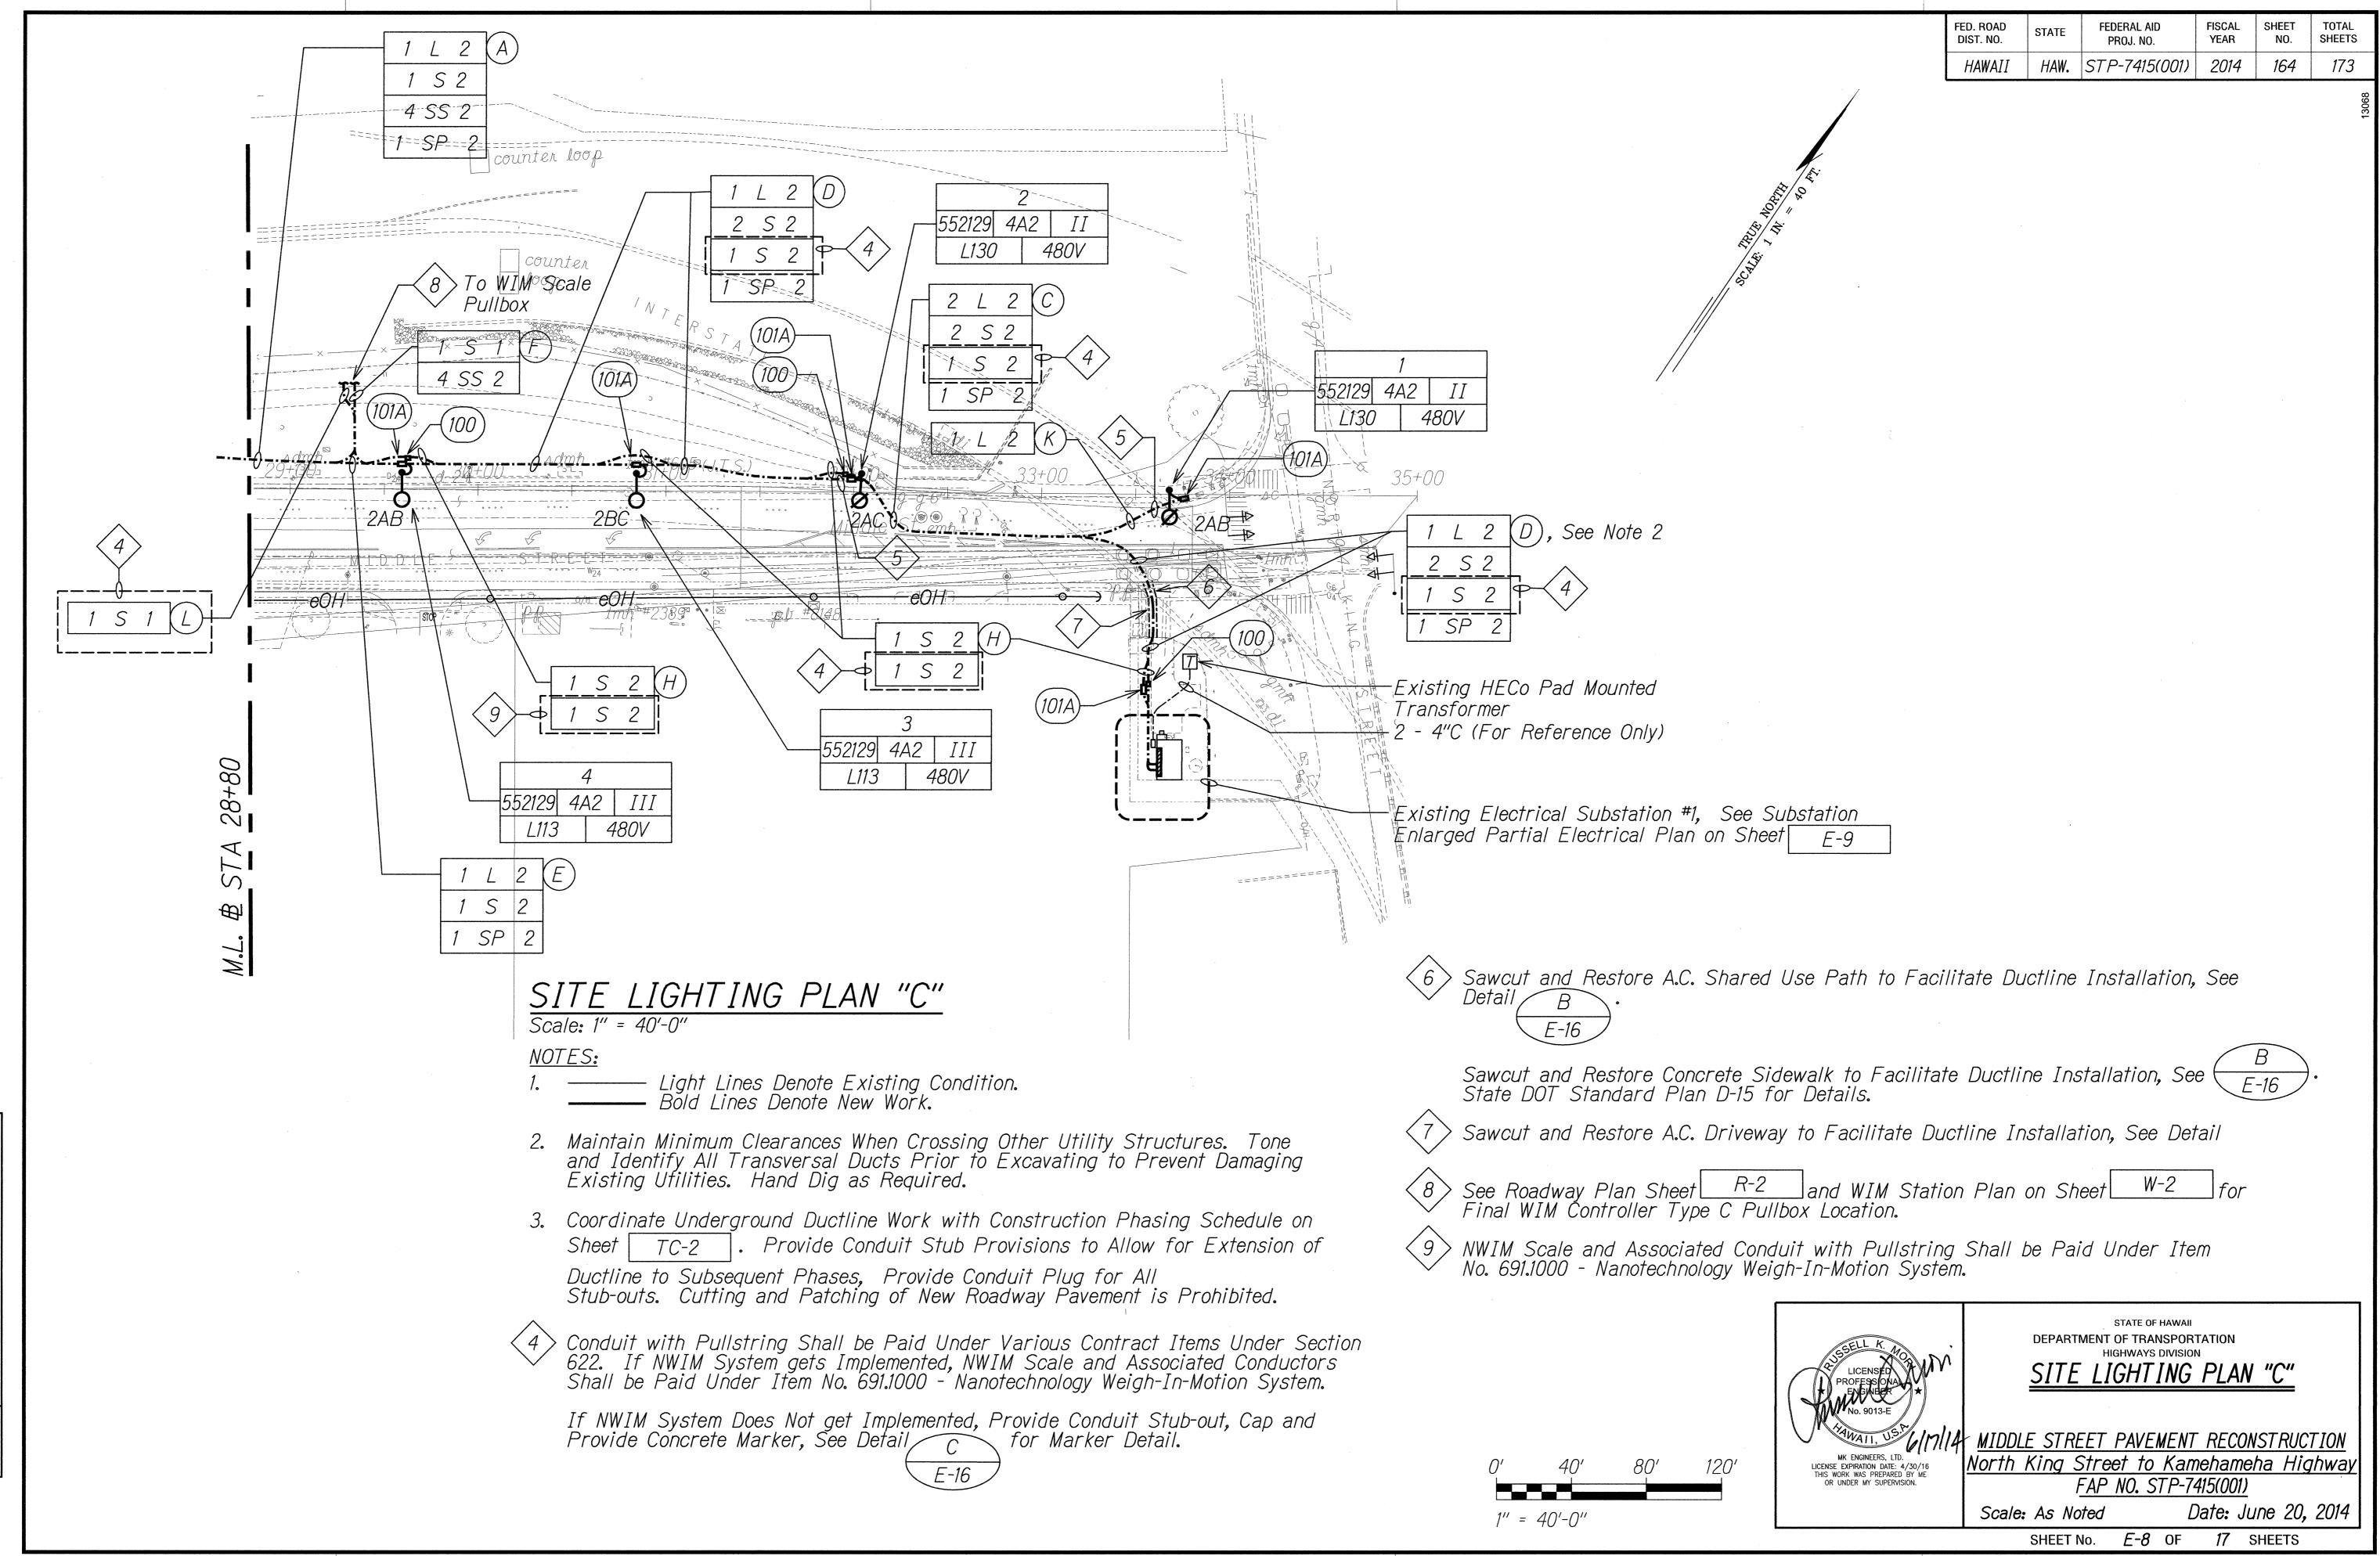

SURV DRAV TRAC DESIC

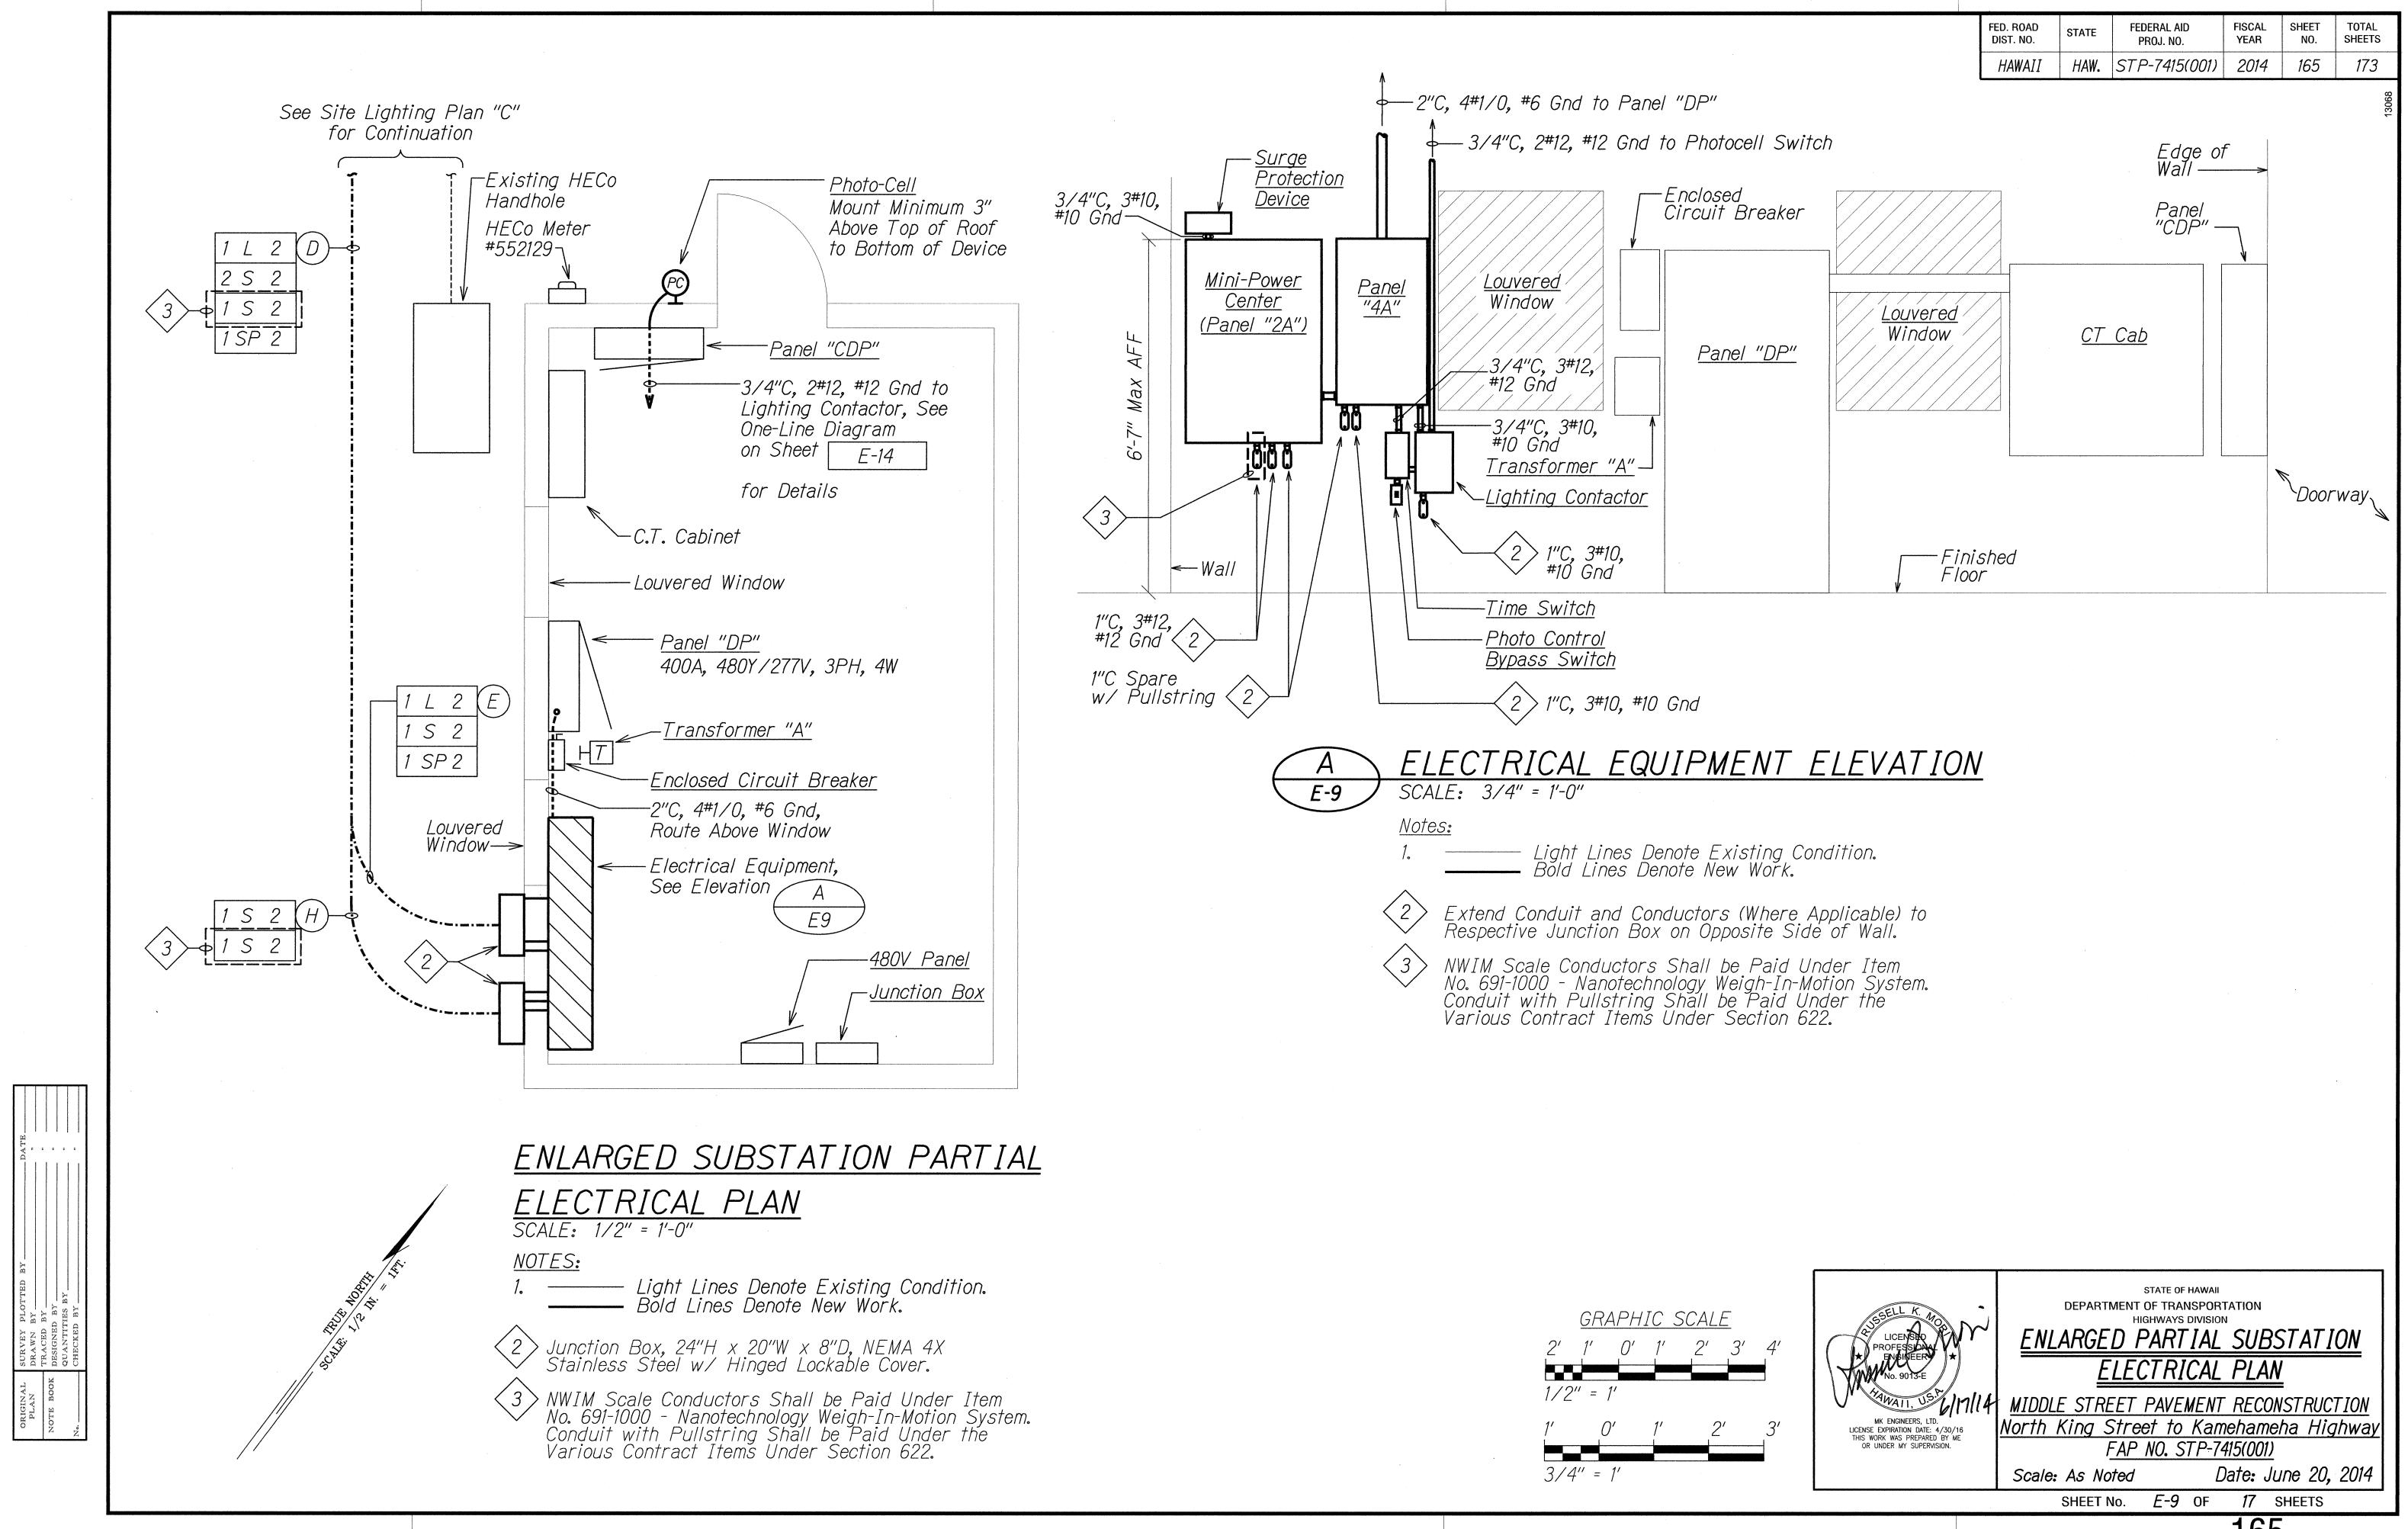

FED. ROAD	STATE	FEDERAL AID	FISCAL	SHEET	TOTAL
DIST. NO.		PROJ. NO.	YEAR	NO.	SHEETS
HAWAII	HAW.	STP-7415(001)	2014	166	173

TATE	FEDERAL AID PROJ. NO.	FISCAL YEAR	SHEET NO.	SHEETS		
HAW.	STP-7415(001)	2014	166	173		

VOLTAGE: 480Y/277V, 3 PH, 4V		77V, 3 PH, 4W	MAIN BKR:	LUG ONLY	′			EQUIPMENT GROUND BUS:	YES			
BUS: COPPER		R	TYPE:	BOLT-ON				ISOLATED GROUND BUS:	NO			
IS RA	TING:	225A		MOUNT:	SURFACE				FEED THRU LUGS:	NO		
D :		14,000		ENCLOSURE:	NEMA 1				U.L. LISTED AS SERVICE			
		de de la como de la compania de la c			an i Nilan de registrati i di Sinado de adeste de Antonio de Antonio de Side de de adeste de grande de Antonio		~		ENTRANCE EQUIPMENT:	NO		
			DESCRIPTION: L						DESCRIPTION: L-LIGHTS			
	KVA	···	R-RECEPTACLE, S-SPARE		CKT	CKT	CKT	CKT	R-RECEPTACLE, S-SPARE	KVA		
Α	B	C	PFB-PROV FOR	FUTURE CB	BKR	NO	NO	BKR	PFB-PROV FOR FUTURE CB	A	В	<u>C</u>
5.1			MINI-POWER CEI	NTER (PNL 2A)	3P40A	1	2	3P30A	STREET LIGHT PWR (MIDDLE ST.)	3.8		
	5.1		PART OF 1		-	3 ·	4	_	PART OF 2		3.8	
		5.1	PART OF 1		-	5	6	_	PART OF 2			3.
).6			LIGHTING CONTA	ACTOR COIL	1P20A	7	8	3P30A	EQUIPMENT PWR (MIDDLE ST.)	3.8		
	0.7		S-SPARE		1P20A	9	10	-	PART OF 8		3.8	
		0.7	S-SPARE		1P20A	11	12	-	PART OF 8			3.
-			PFB-PROV FOR I	FUTURE CB	1P	13	14	1P	PFB-PROV FOR FUTURE CB	-		
Territoria.	-		PFB-PROV FOR I	FUTURE CB	1P	15	16	1P	PFB-PROV FOR FUTURE CB		_	
		-	PFB-PROV FOR I	FUTURE CB	1P	17	18	1P	PFB-PROV FOR FUTURE CB			_
.7	5.8 5.8 SUBTOTALS							7.7	7.6	7.6		
						NOTE						

480 volts

	_											
			20V, 3 PH, 4W MAIN BKR: 3P50						EQUIPMENT GROUND BUS: YES			
BUS: COPPER		₹	TYPE:	BOLT-ON				ISOLATED GROUND BUS:	NO			
US RAT	ING:	100A		MOUNT:	SURFACE				FEED THRU LUGS:	NO		
IC:		10,000	10,000 ENCLOSURE:			NEMA 1			U.L. LISTED AS SERVICE	N.O.		
			DESCRIPTION. I	LICUTO			T	· 	ENTRANCE EQUIPMENT:	NO		
	KVA		DESCRIPTION: L		CVT	CKT	CVT	CKT	DESCRIPTION: L-LIGHTS		12378	
Α	B	С	R-RECEPTACLE PFB-PROV FOR	CKT BKR	CKT NO	CKT NO	CKT BKR	R-RECEPTACLE, S-SPARE PFB-PROV FOR FUTURE CB	A B C			
	U		:1								<u> </u>	
0.1			WIM CABINET P	VR	2P20A	1	2	3P20A	SURGE PROTECTOR	0.1		
	0.4		PART OF 1		-	3	4	-	PART OF 2		0.1	
		0.8	S-SPARE		1P20A	5	6	-	PART OF 2			0.1
0.1			NWIM CABINET I	PWR	2P20A	-7	8	1P20A	S-SPARE	0.6		
	0.4		PART OF 7		-	9	10	1P20A	S-SPARE		_	
		-	S-SPARE		1P20A	11	12	1P20A	S-SPARE			-
-			PFB-PROV FOR	FUTURE CB	1P	13	14	1P	PFB-PROV FOR FUTURE CB	-		
	-		PFB-PROV FOR	FUTURE CB	1P	15	16	1P	PFB-PROV FOR FUTURE CB		-	
		-	PFB-PROV FOR	FUTURE CB	1P	17	18	1P	PFB-PROV FOR FUTURE CB			-
0.2	0.8	0.8	SUBTOTALS					0.7	0.1	0.1		

0.86 DEMAND FACTOR

2.3 DEMAND KVA

6 DEMAND AMPS

208 volts

MK ENGINEERS, LTD.

LICENSE EXPIRATION DATE: 4/30/16
THIS WORK WAS PREPARED BY ME
OR UNDER MY SUPERVISION.

STATE OF HAWAII DEPARTMENT OF TRANSPORTATION
HIGHWAYS DIVISION

PANEL SCHEDULES

MIDDLE STREET PAVEMENT RECONSTRUCTION
North King Street to Kamehameha Highway
FAP NO. STP-7415(001)

Scale: As Noted


Date: June 20, 2014


SHEET No. E-10 OF 17 SHEETS


166

38.6 DEMAND KVA


46 DEMAND AMPS

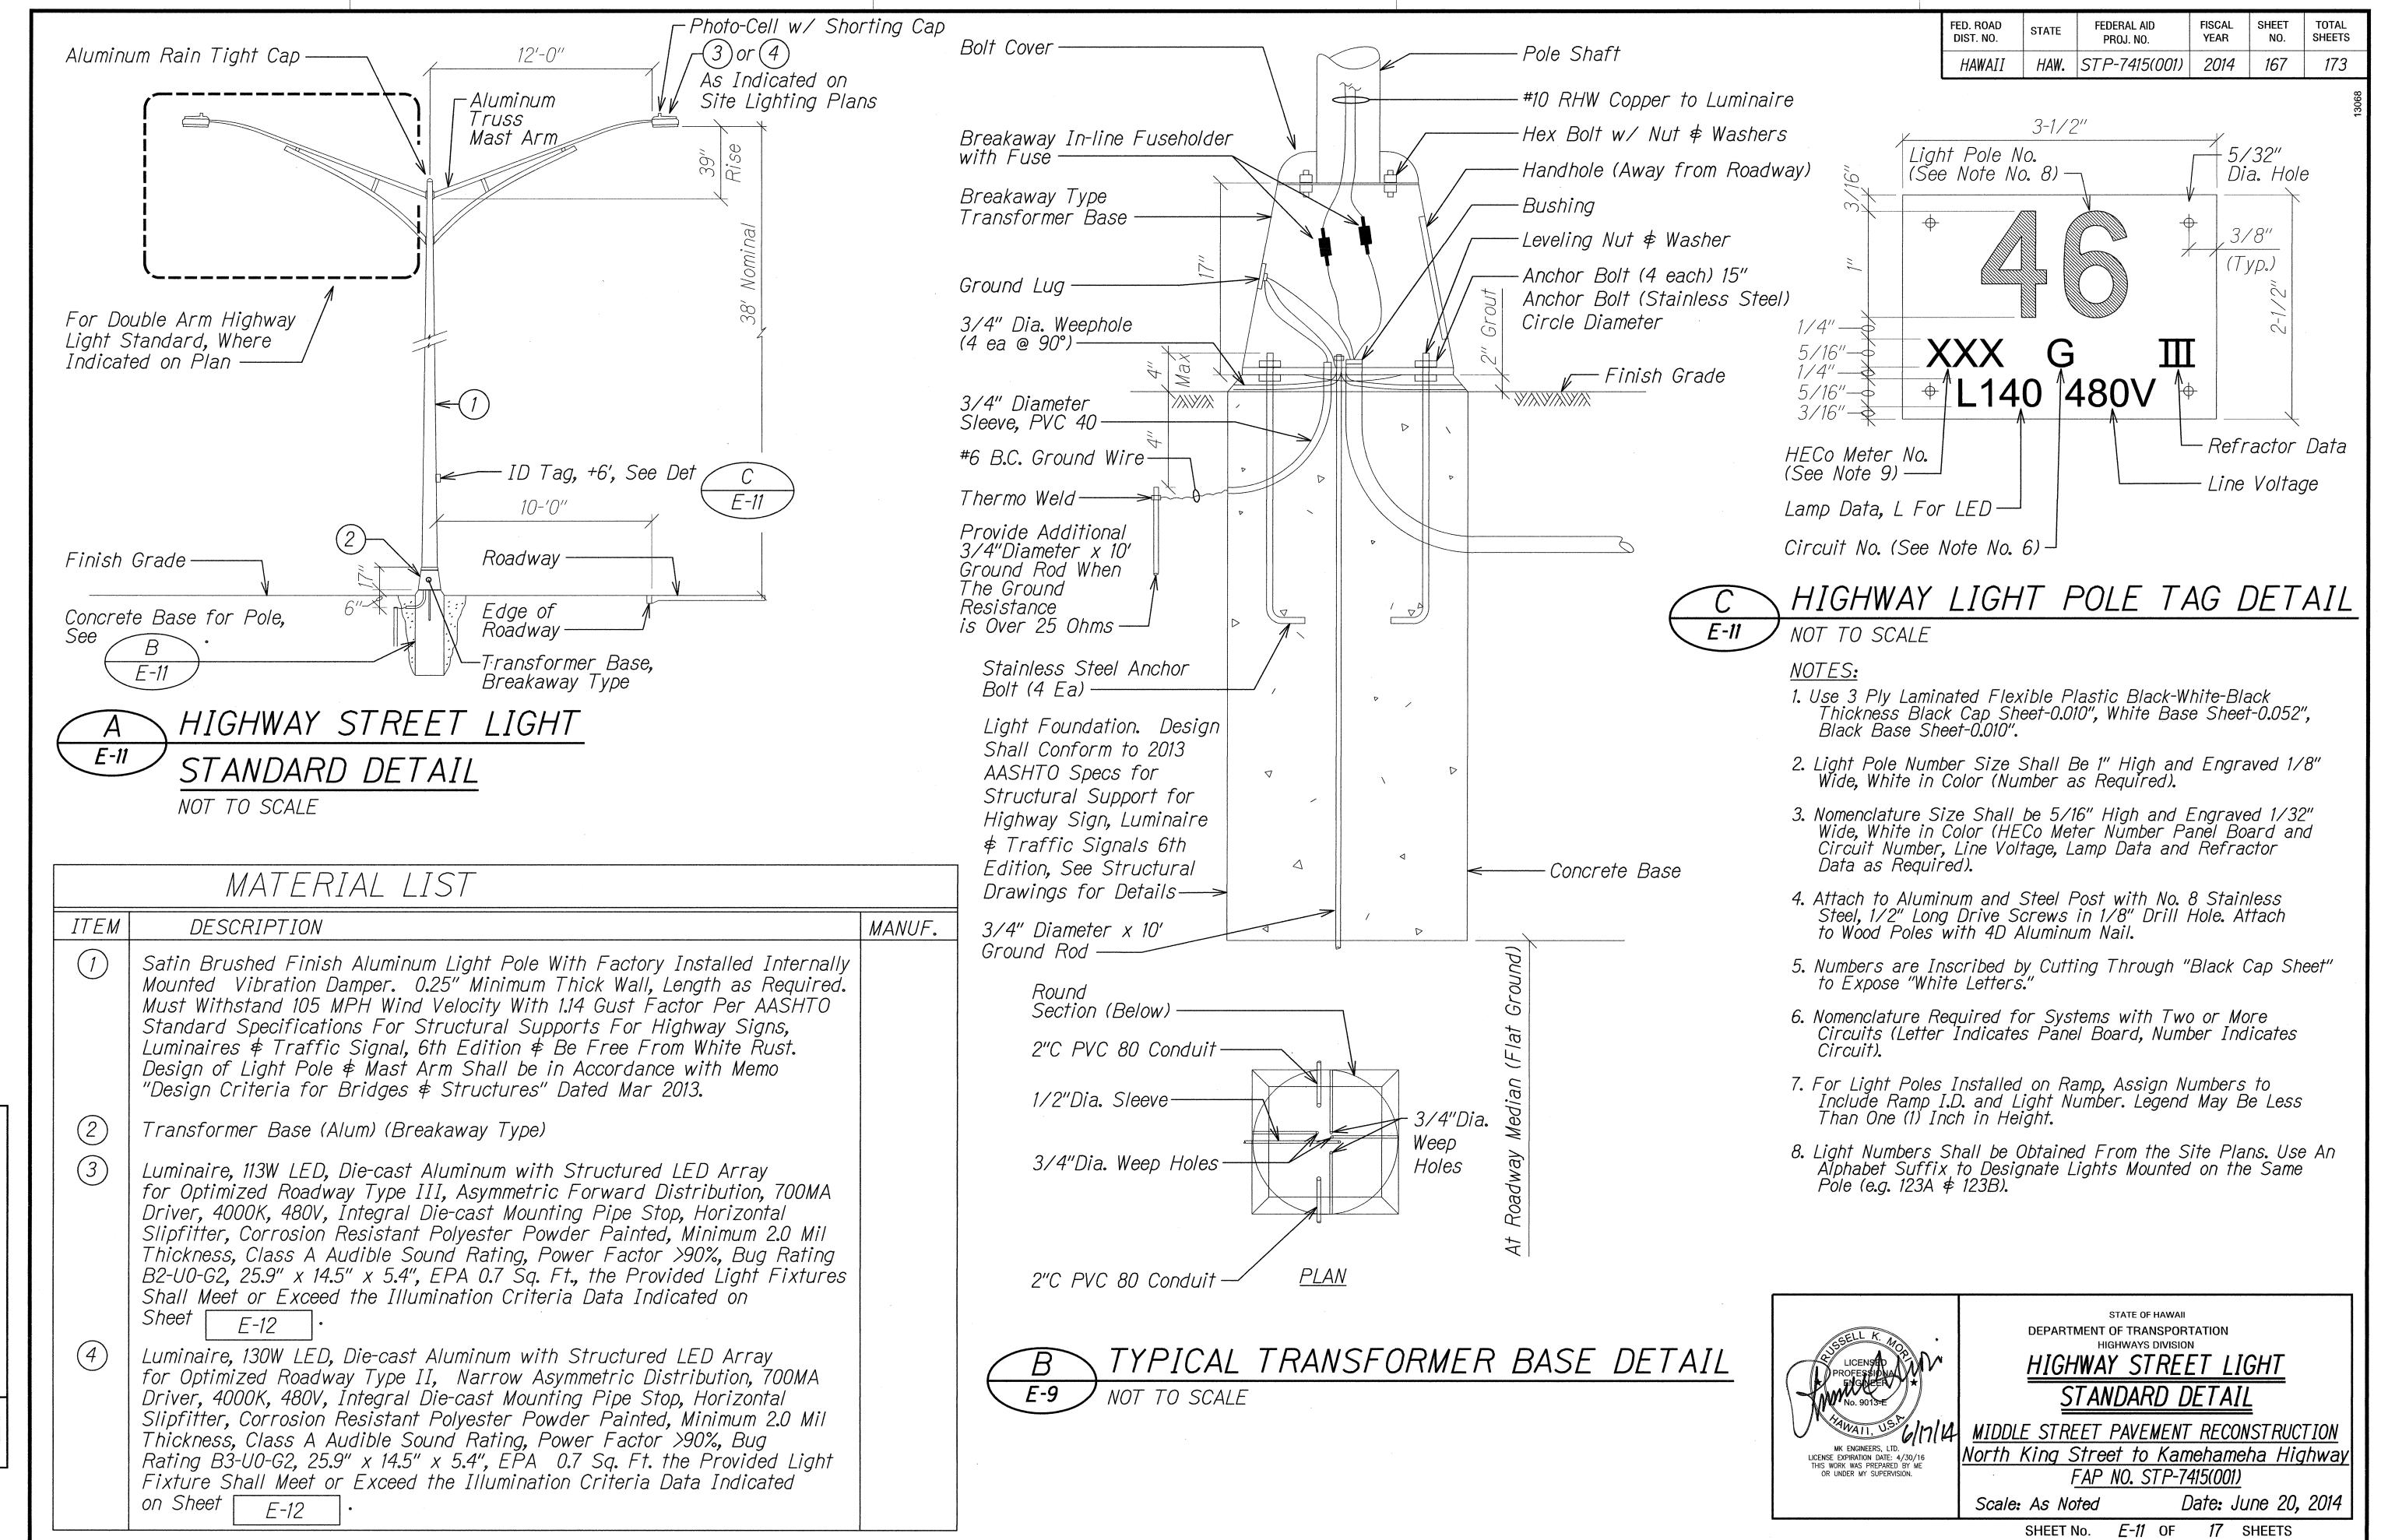

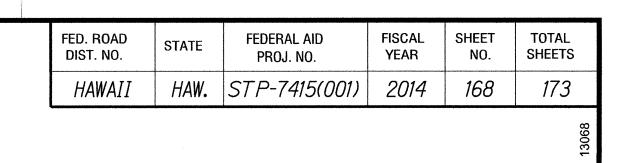

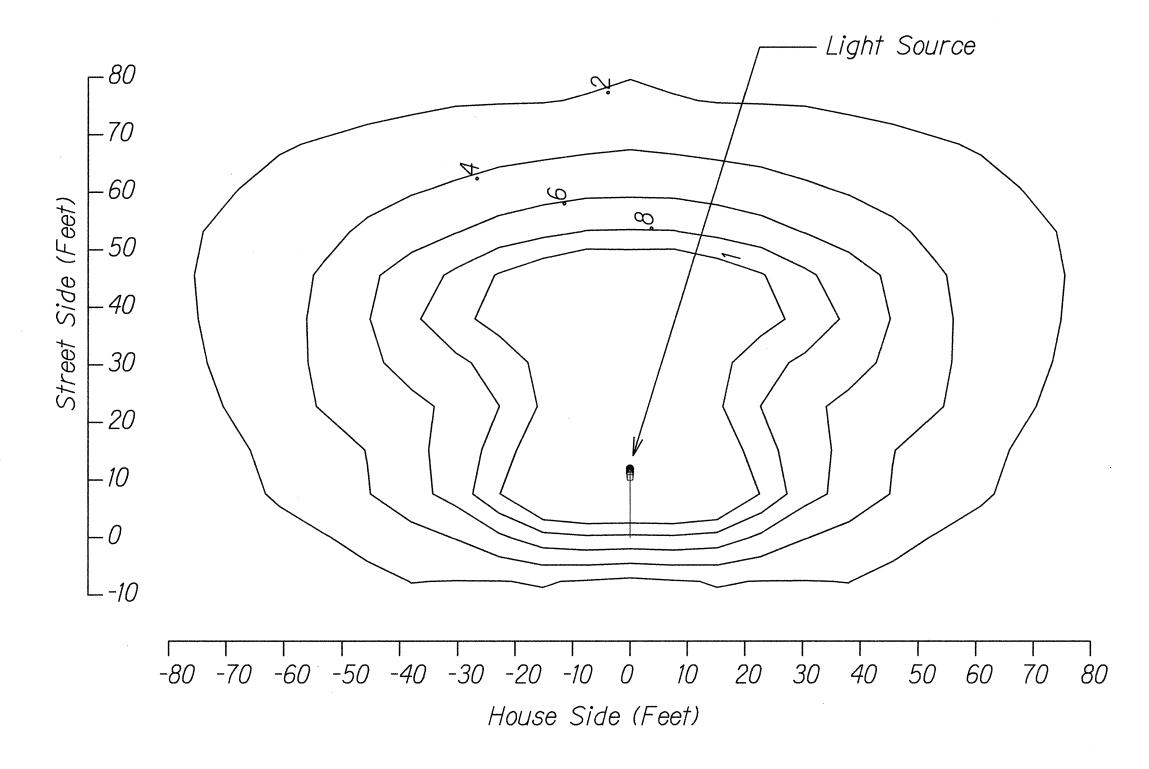

113W LED LUMINAIRE - ISO FOOT-CANDLE CURVE

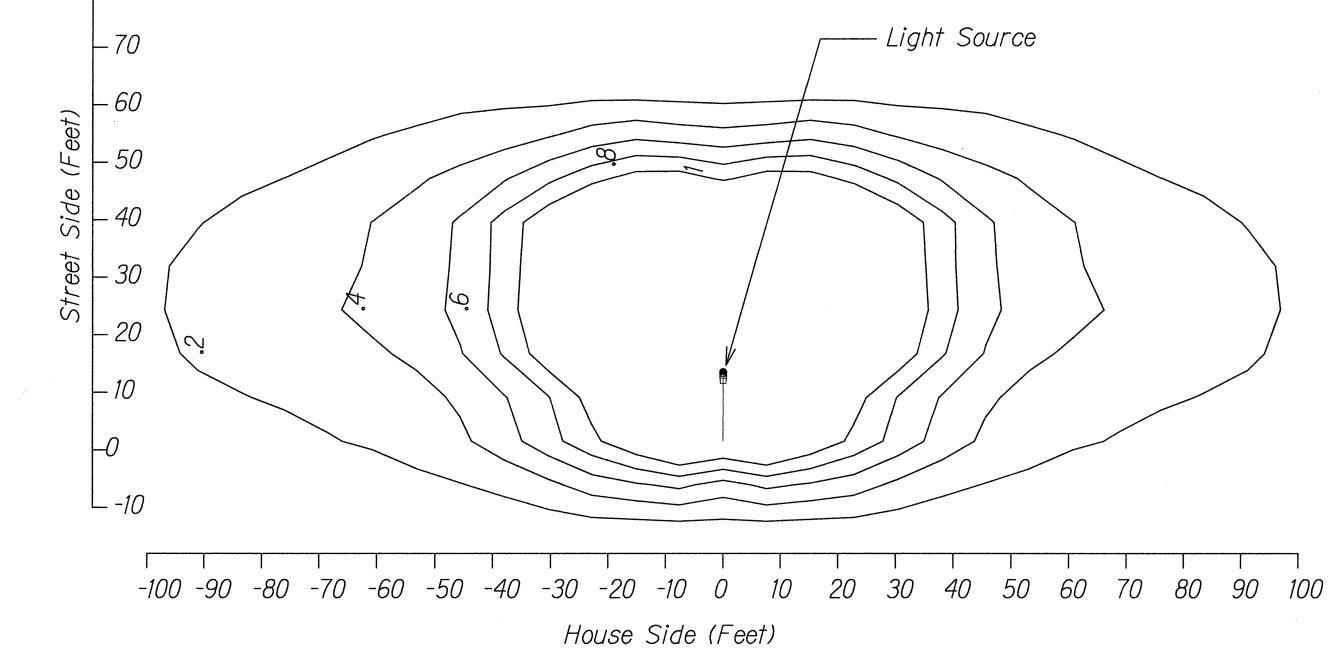


130W LED LUMINAIRE - ISO FOOT-CANDLE CURVE

PHOTOMETRIC DATA


NTS

NOTES:

1. Distance Shown in Feet. Values Shown are Initial Foot-Candle and are Based on the Luminaire Mounted 38'-0" Above Grade.

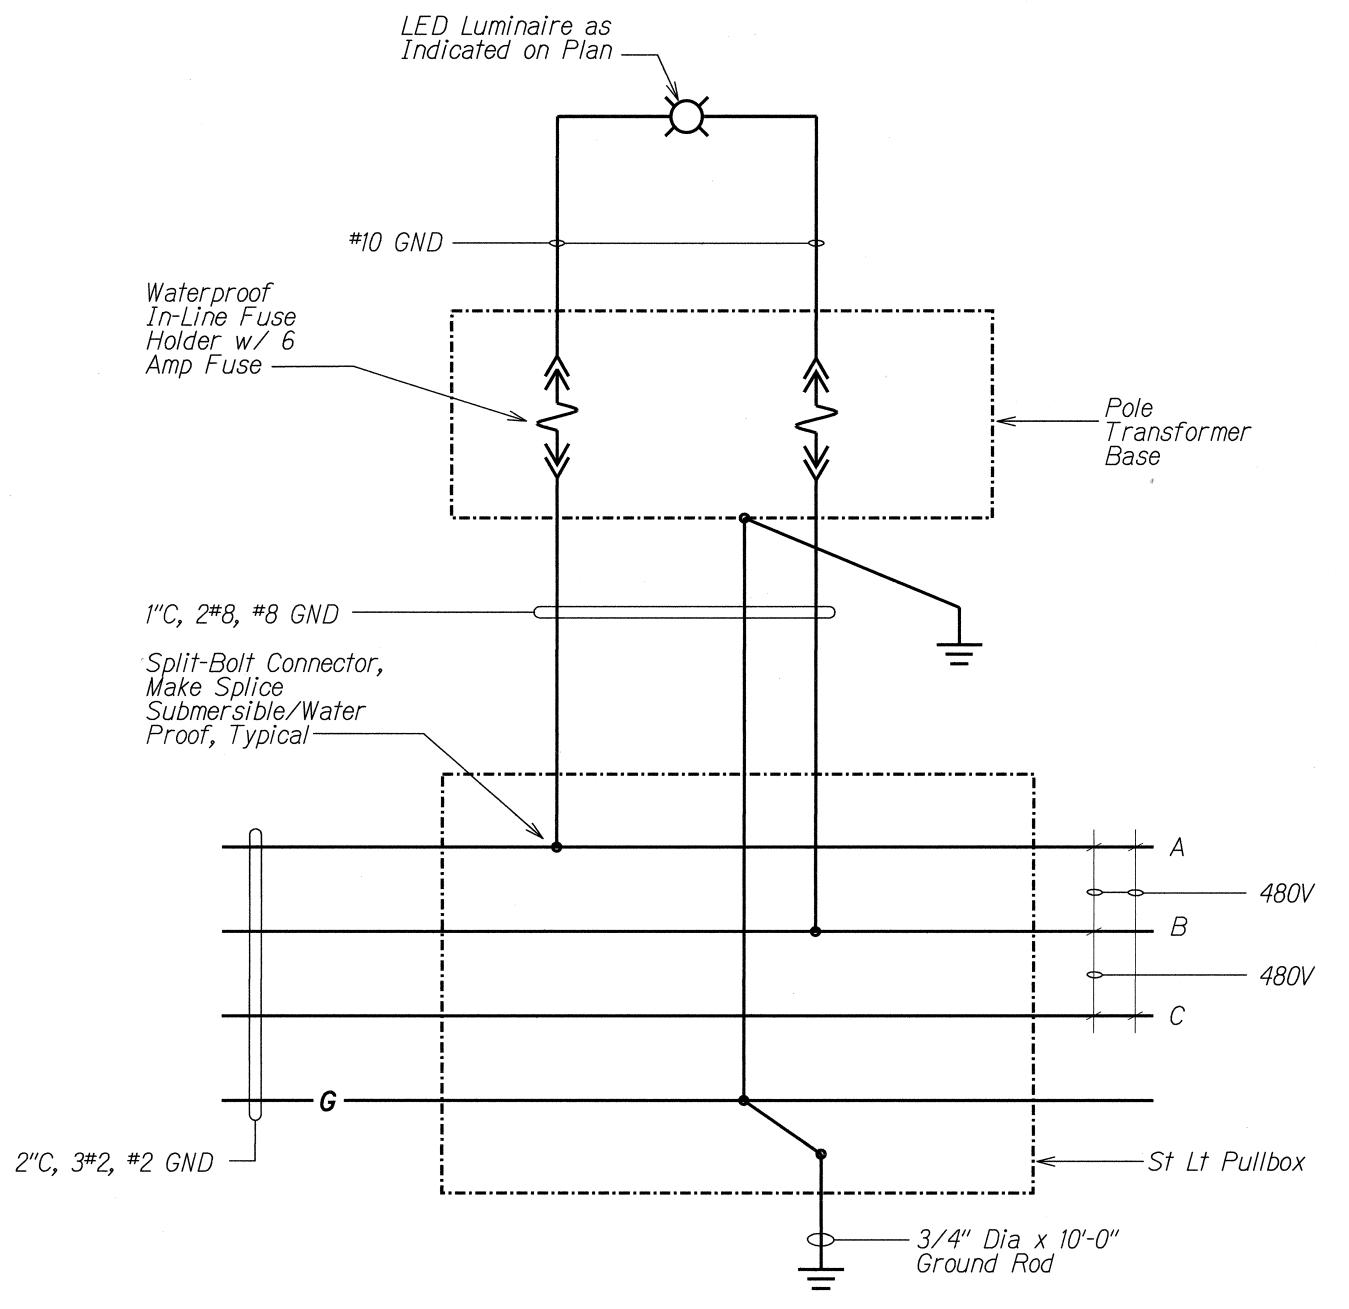

TYPICAL HIGHWAY LIGHT STANDARD WIRING DIAGRAM

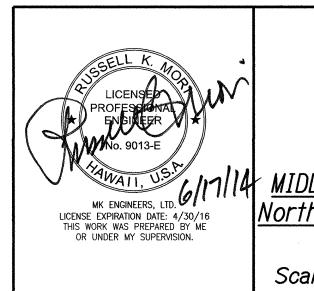

DEPARTMENT OF TRANSPORTATION
HIGHWAYS DIVISION

TYPICAL HIGHWAY LIGHT


STANDARD WIRING DIAGRAM

MIDDLE STREET PAVEMENT RECONSTRUCTION
North King Street to Kamehameha Highway
FAP NO. STP-7415(001)

Scale: As Noted


Date: June 20, 2014

SHEET No. E-12 OF 17 SHEETS

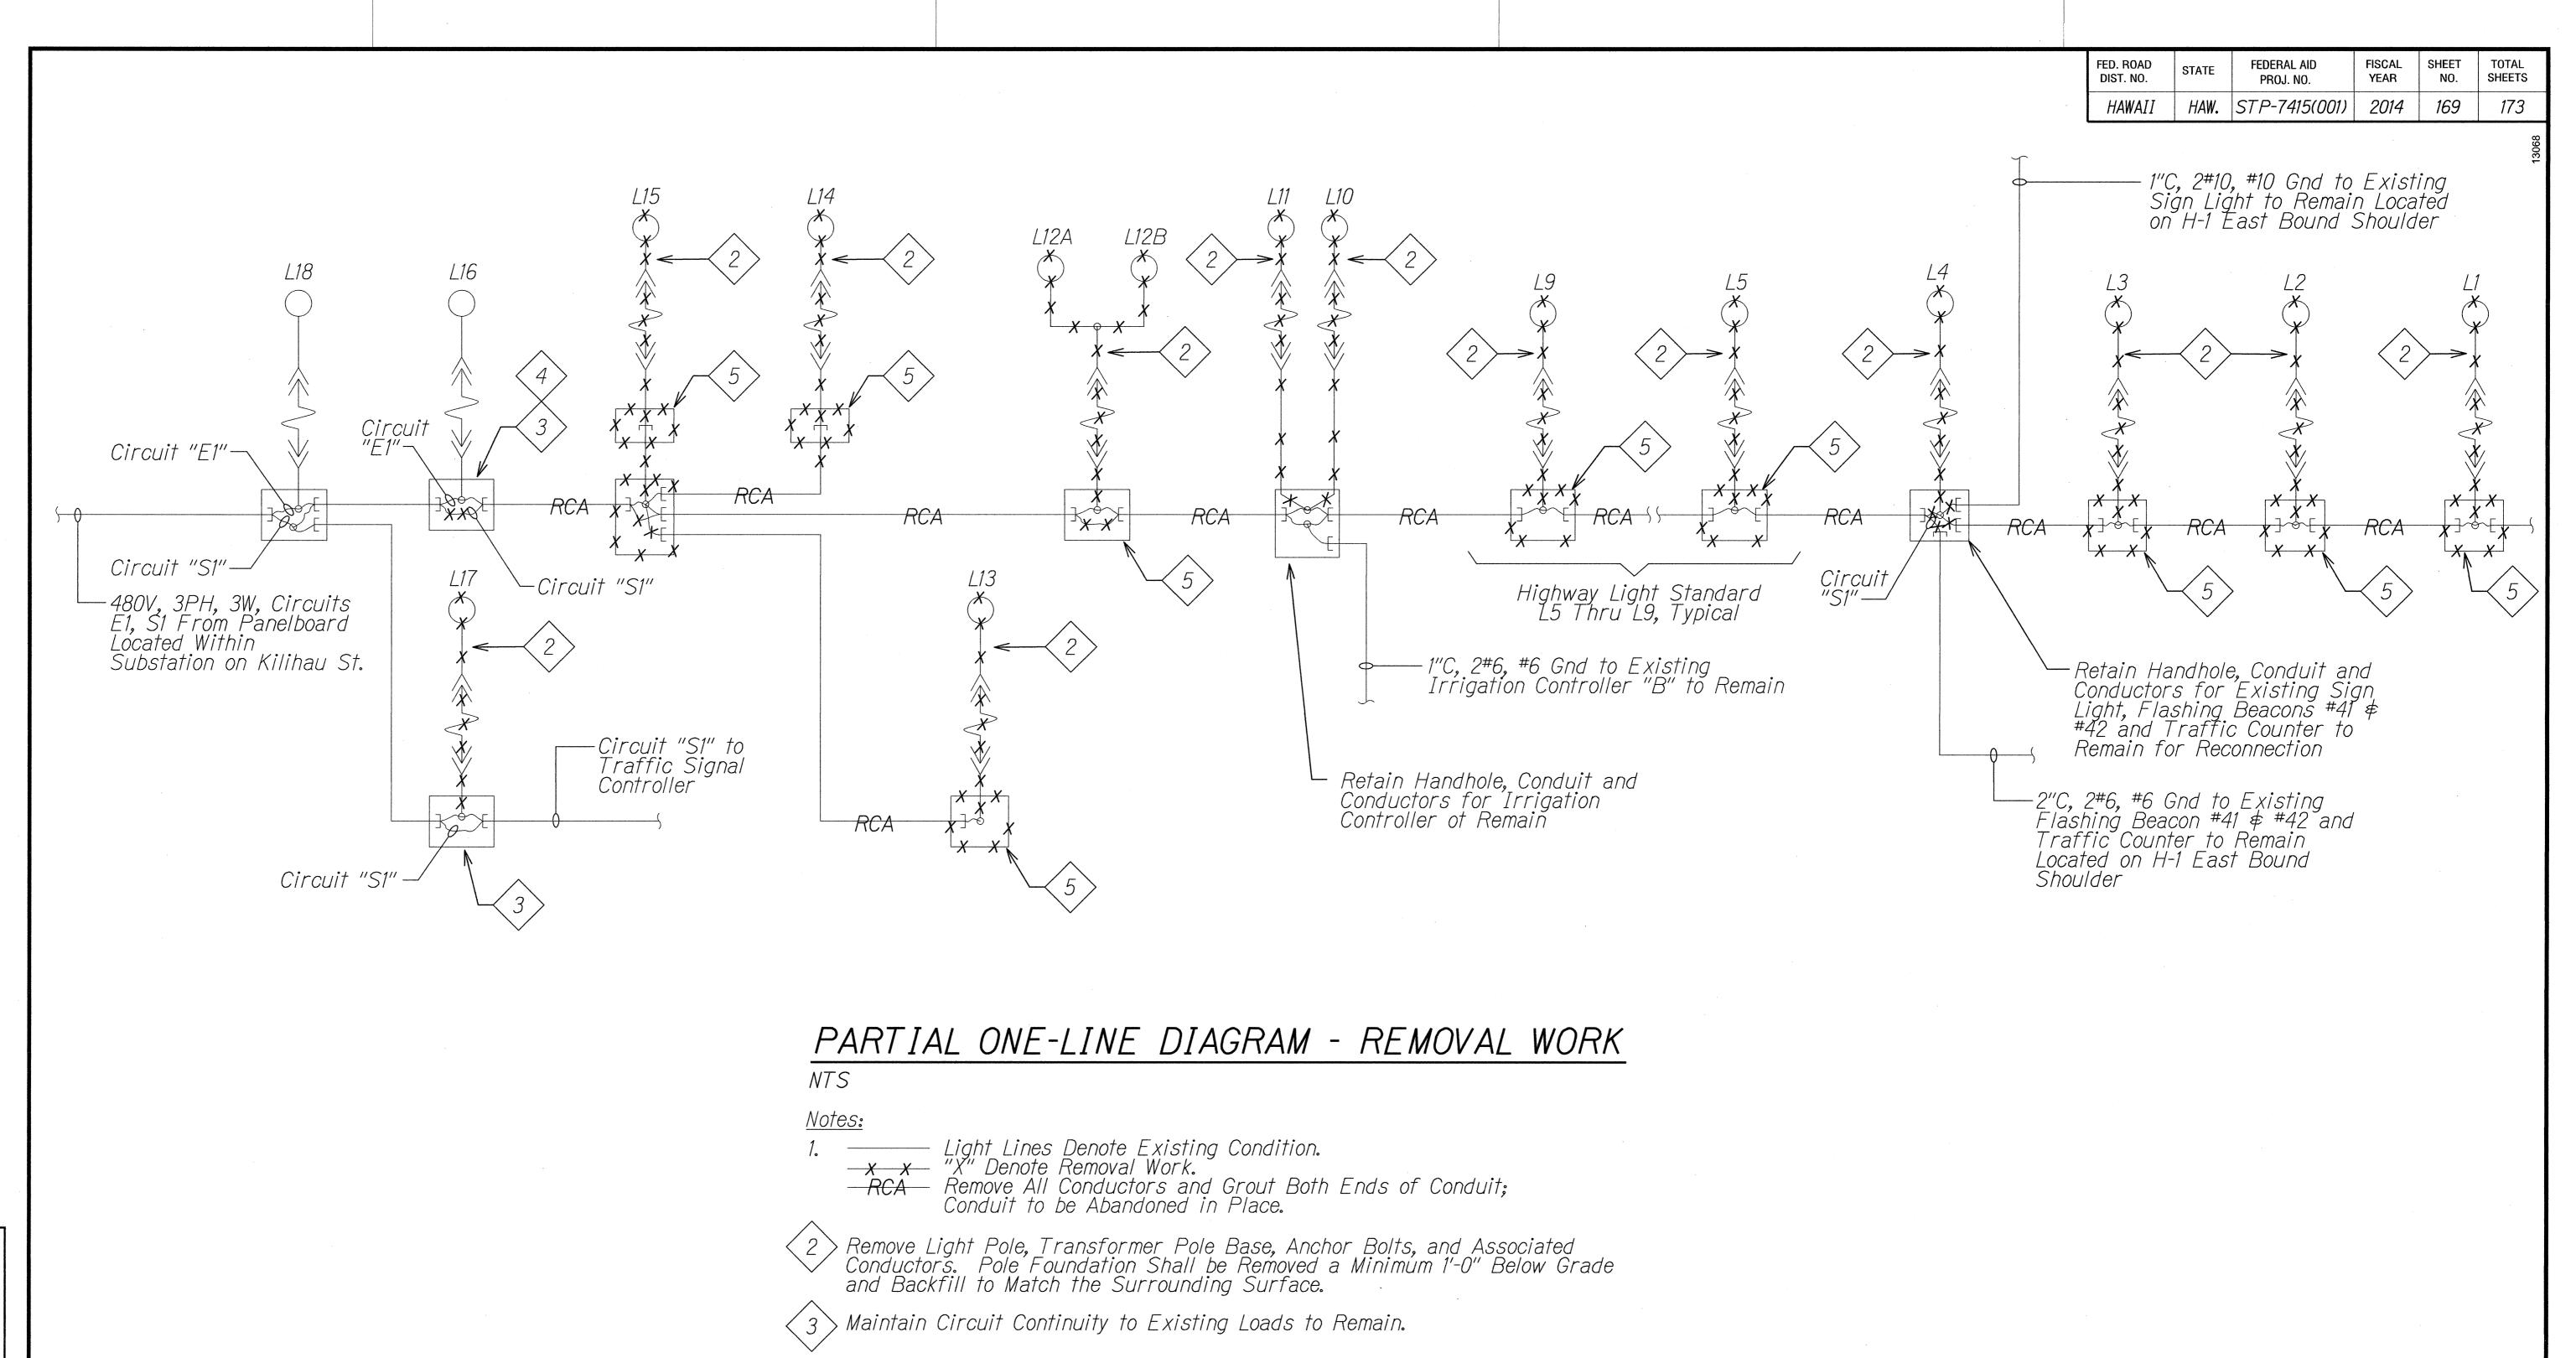

Temporarily Utilize Circuit "E1" to Provide Power for the New Highway Lighting System Until the Work at Existing Substation is Completed and the New Highway Lighting Circuit is Available. Schedule and Coordinate Cutover from Existing Circuit "E1" to the New Highway Lighting Circuit.

(5) Remove Highway Lighting Pullbox, Grout Existing Conduits, and Backfill to Match Surrounding Area.

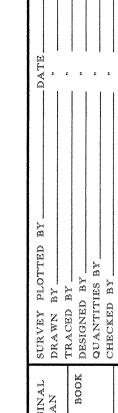

LICENSED
PROFESSIONATE
ENGINEER

No. 9013-E

MK ENGINEERS, LTD.

LICENSE EXPIRATION DATE: 4/30/16
THIS WORK WAS PREPARED BY ME
OR UNDER MY SUPERVISION.

STATE OF HAWAII
DEPARTMENT OF TRANSPORTATION
HIGHWAYS DIVISION
PARTIAL ONE-LINE

<u>PARTIAL ONE-LINE</u> <u>DIAGRAM - REMOVAL WORK</u>

MIDDLE STREET PAVEMENT RECONSTRUCTION


North King Street to Kamehameha Highway


FAP NO. STP-7415(001)

Scale: As Noted

Date: June 20, 2014


SHEET No. E-13 OF 17 SHEETS

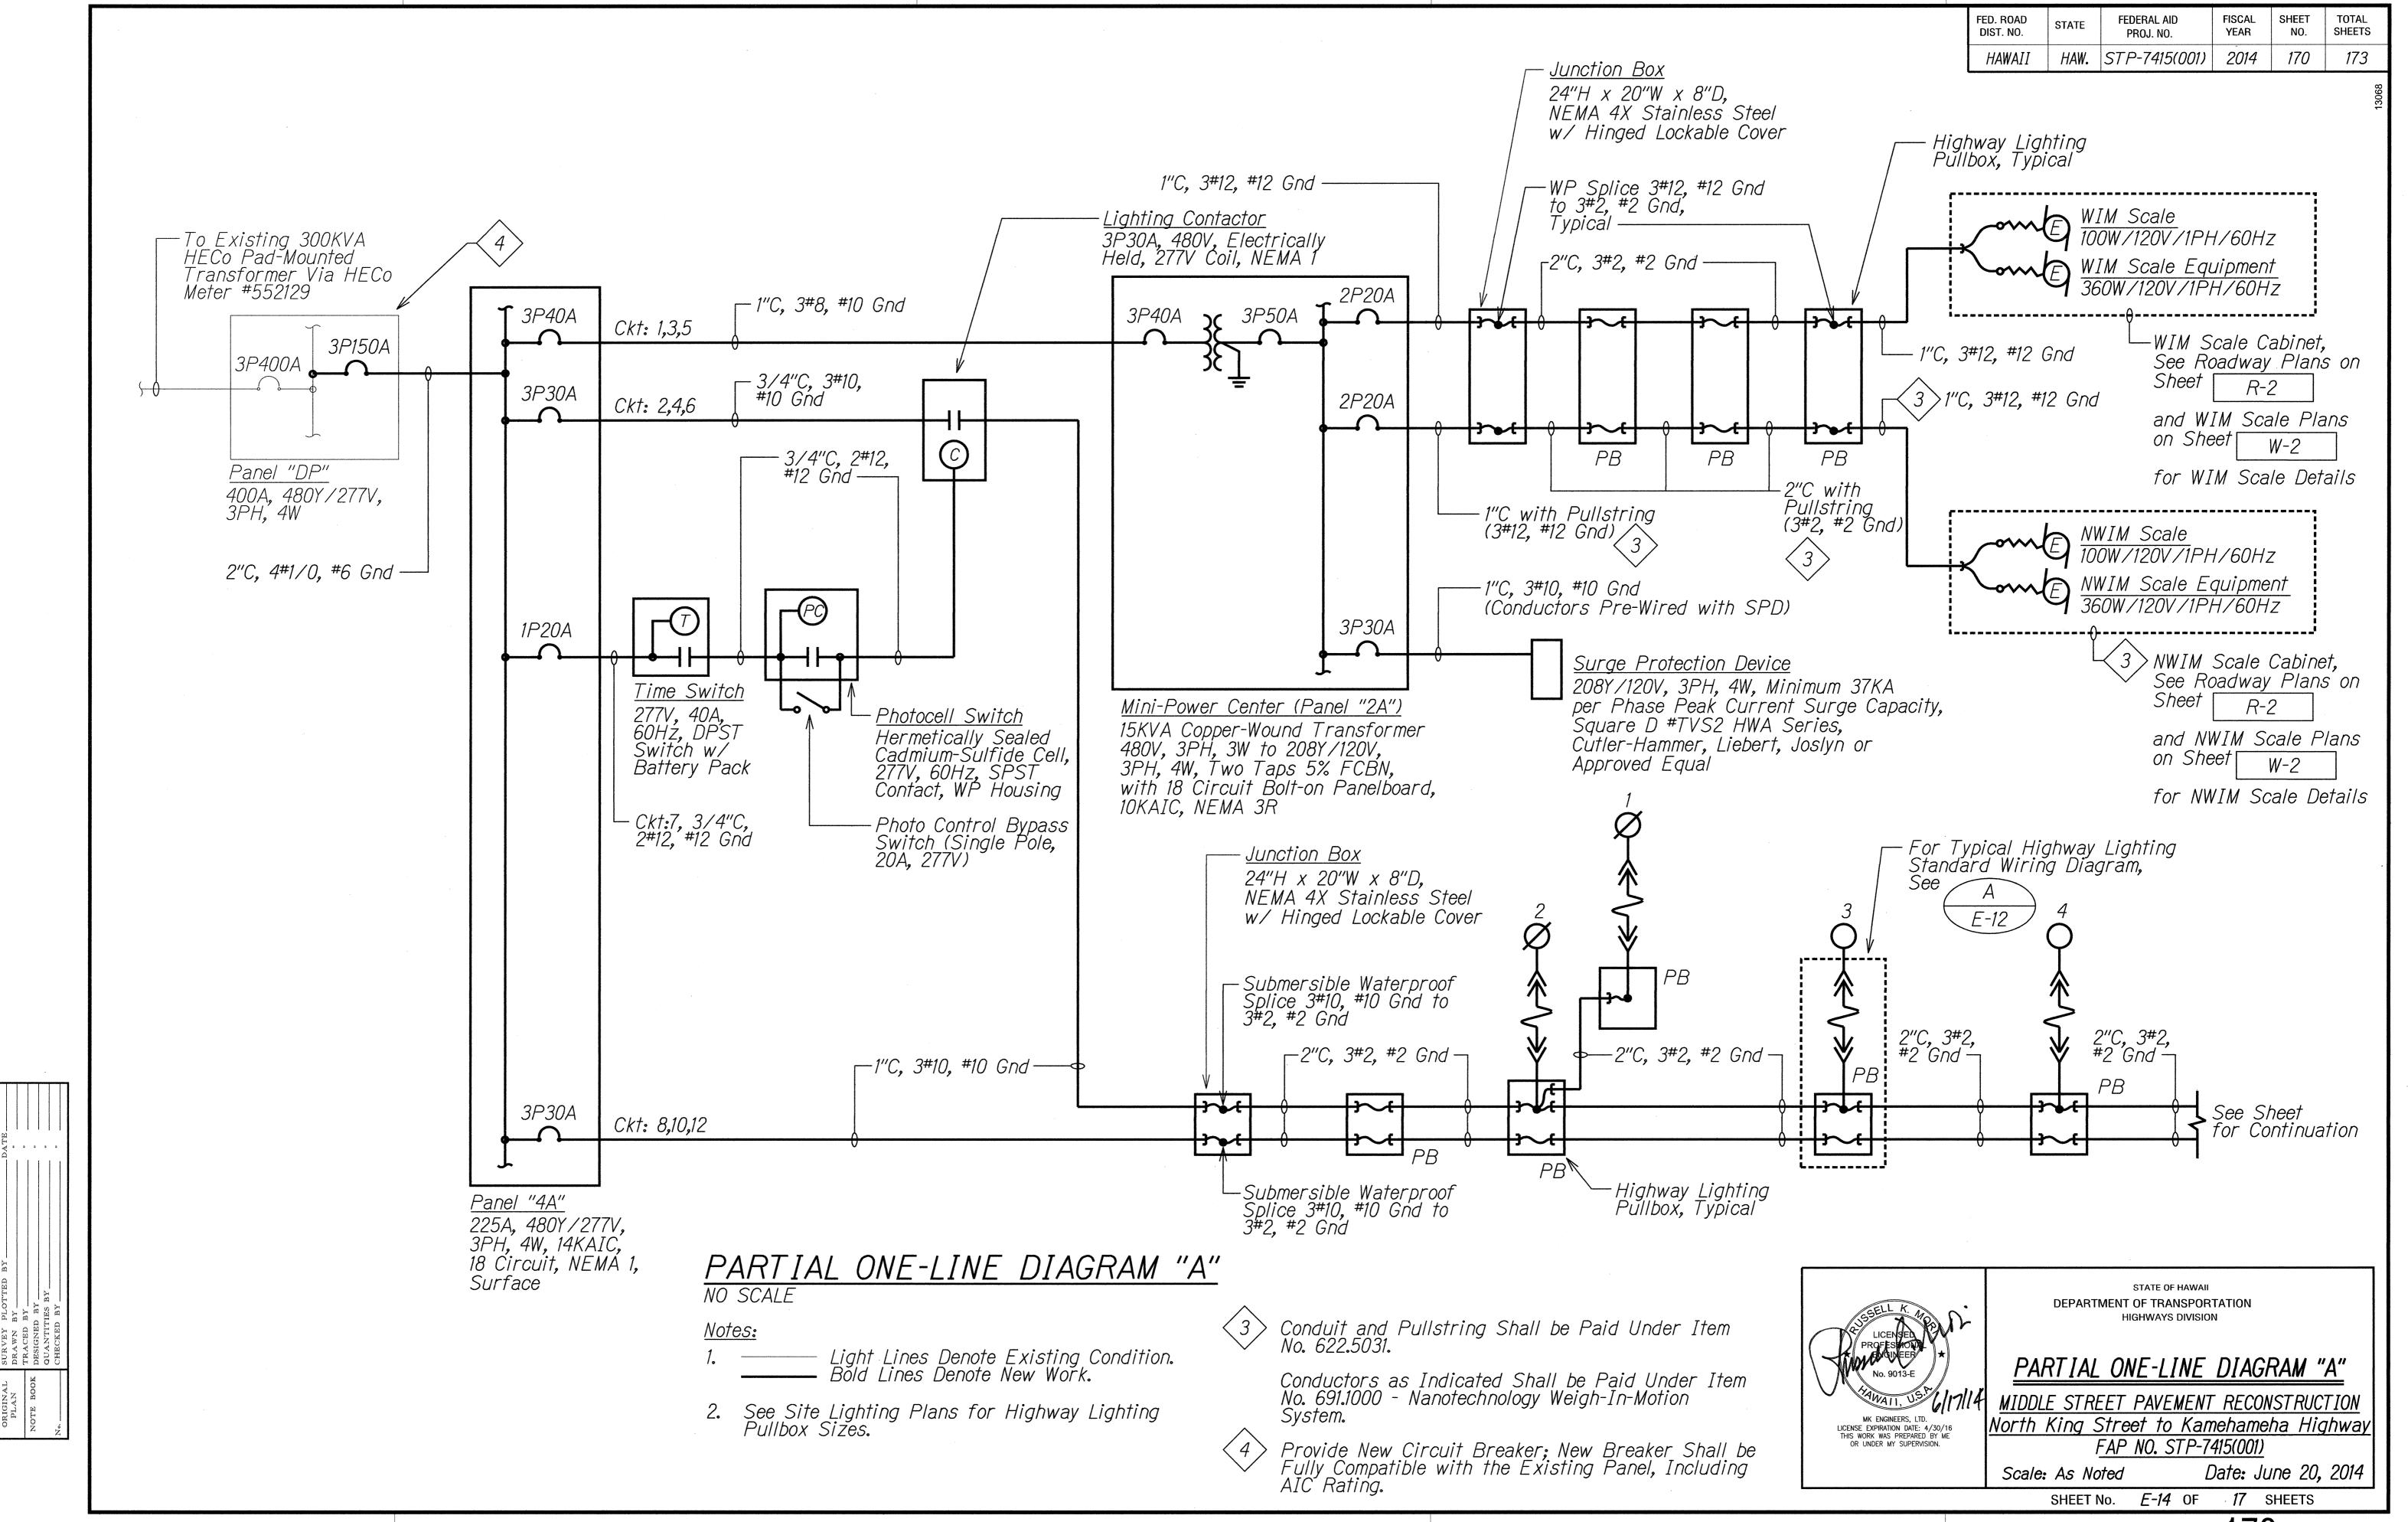

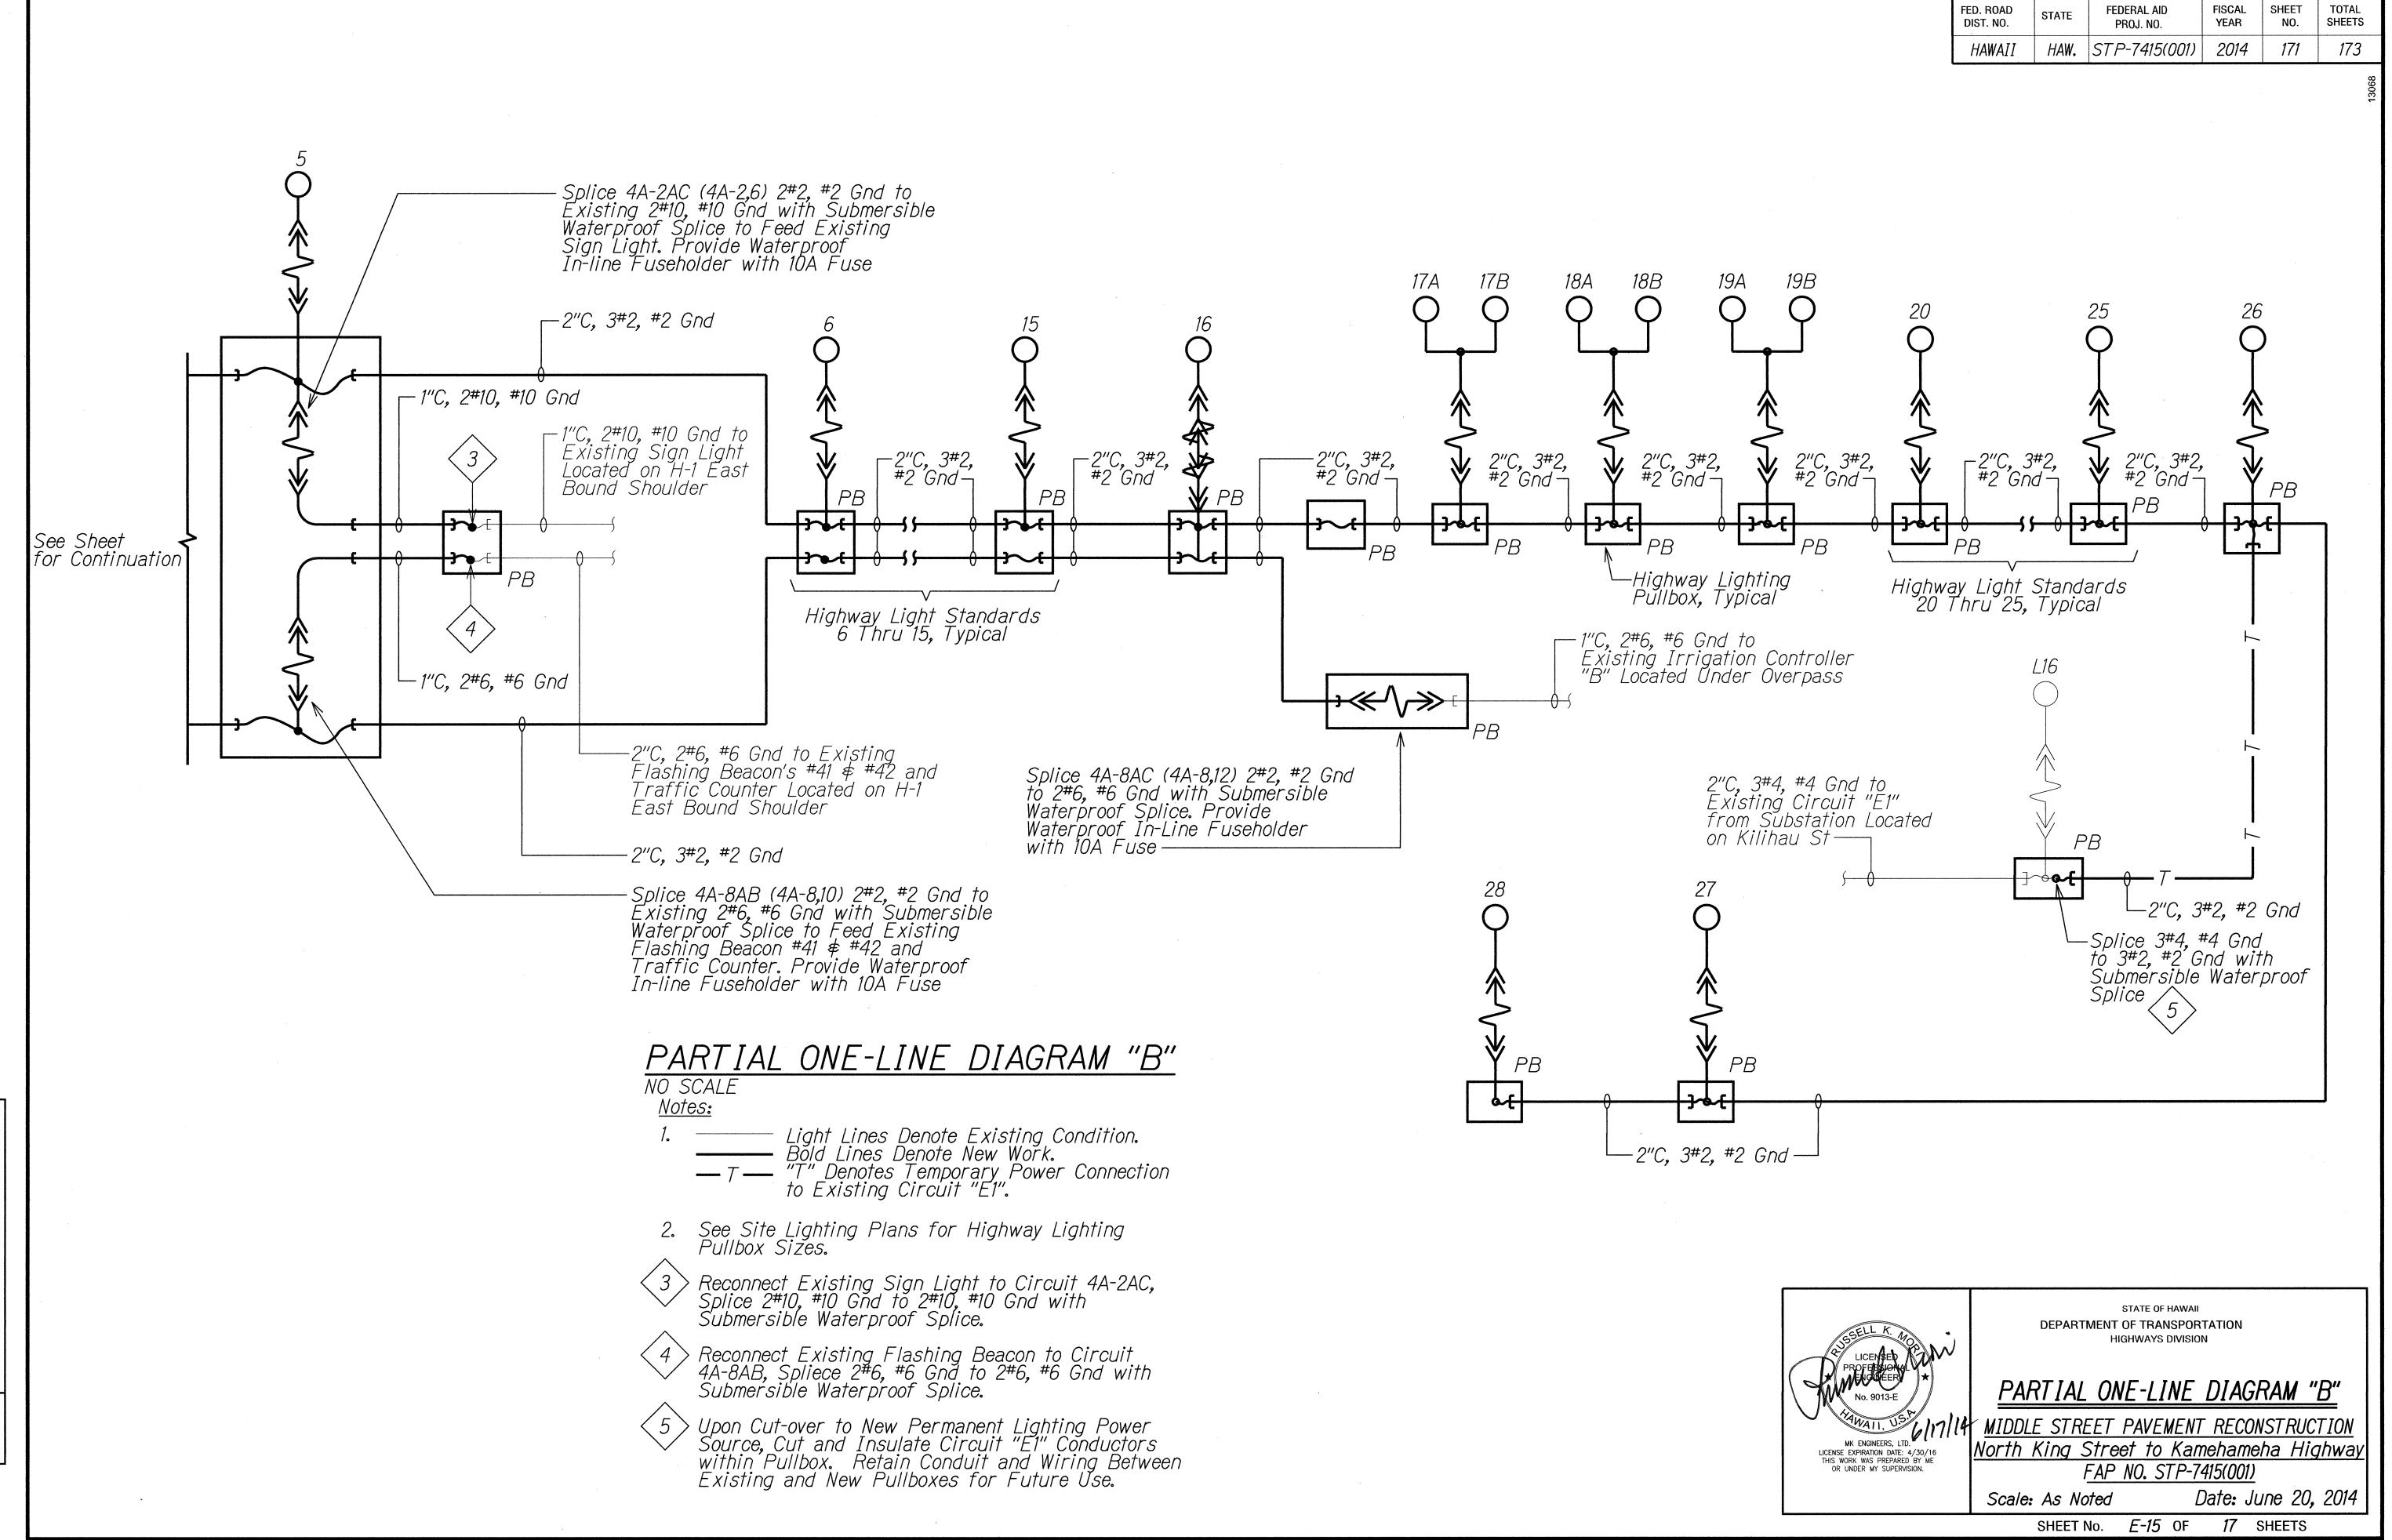

SURV DRAT TRAC DESIC

FISCAL YEAR FED. ROAD DIST. NO. PROJ. NO. HAW. STP-7415(001) 2014 172

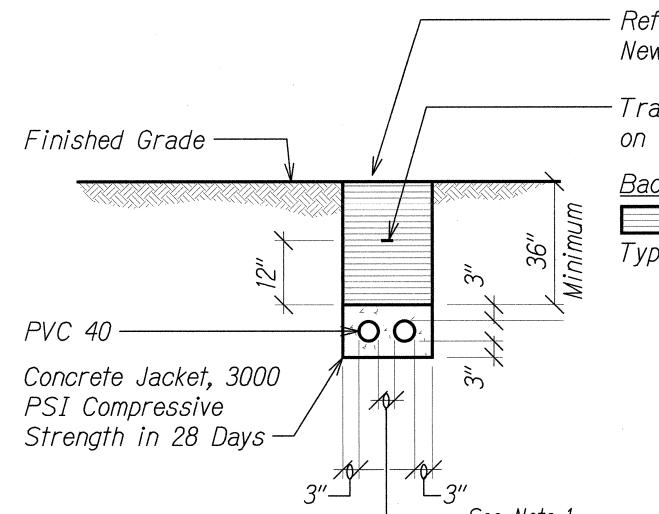


Refer to Pavement Plans on Sheets for Locations with and New Paved Areas.

Traceable Warning Tape With "Caution-Electric/Communications Cable below" Imprinted on Tape. Warning Tape Shall be Placed Over Entire Length of Ductline.

Backfill:

Non-contaminated Native Soil Material Which Does Not Contain More Than 50% Type "A" Gravel, and Also, Does Not Contain Hard Lumps of Earth 3 Inches in Greatest Dimension, Rocks Larger Than 3 Inches in Largest Dimension, Highly Plastic Clay, Poorly-graded Sand and Gravel (Classified as SP and GP Using the Unified Soil Classification System), Organics, Debris, or Other Unsuitable or Deleterious Materials.

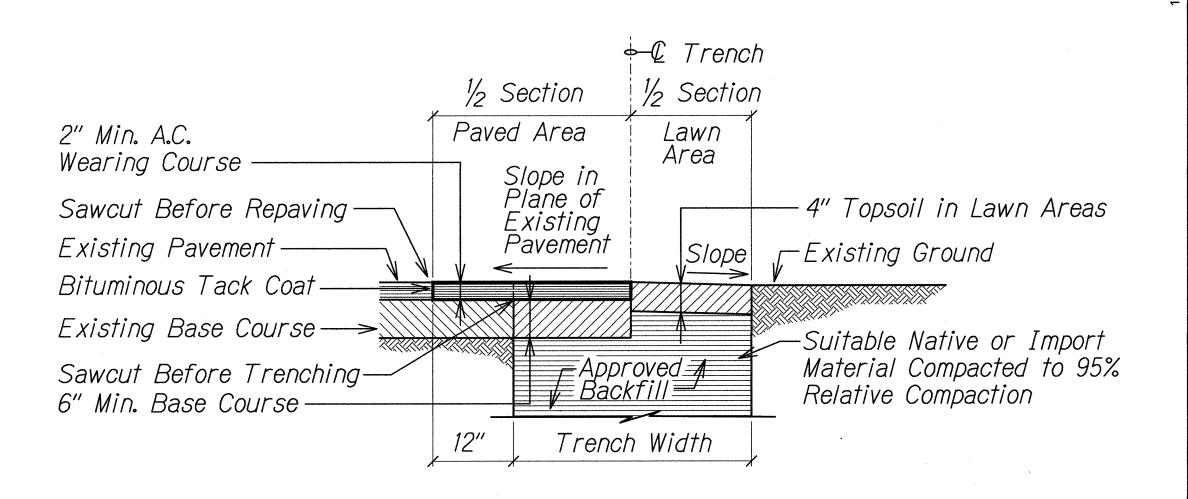

TRENCH RESTORATION DETAIL

NOTE:

E-16

1. This Detail Applies to Shared Use Path and Driveways Indicated on Plan.


E-16

TYPICAL DUCT SECTION (CONCRETE ENCASED) FOR UNPAVED AREAS


NOTES:

NOT TO SCALE


- 1. Provide 2" Separation between Ducts of Same System and 3" between Ducts of Different Systems.
- 2. Where Trench Encounters Grass or Landscaping, Provide 4" Top Soil After Trench is Backfilled, and Restore Landscaping to Match Existing Adjacent Area.
- 3. See Duct Section Details for Conduit Arrangement.

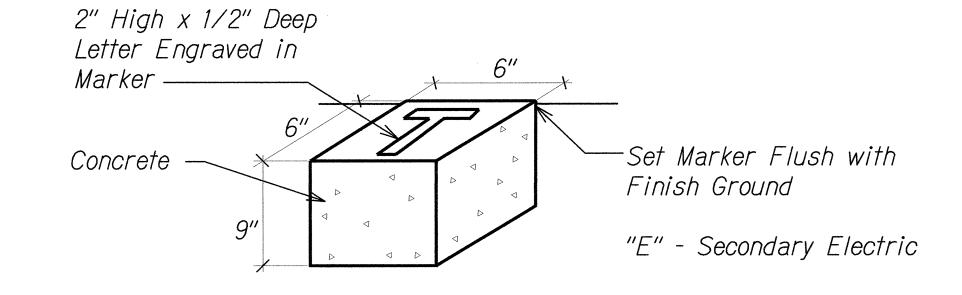



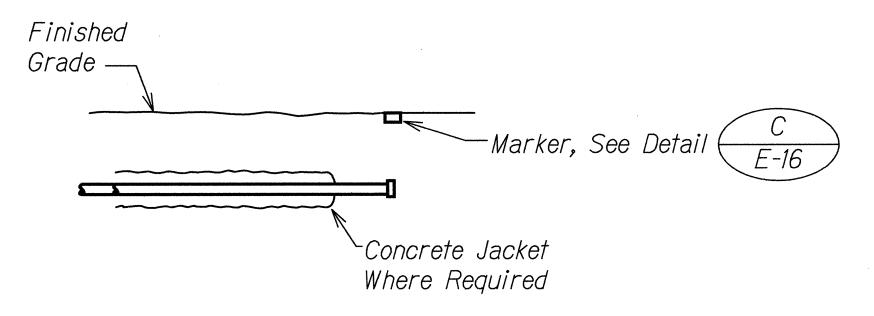

CONCRETE STUB OUT DETAIL NOT TO SCALE

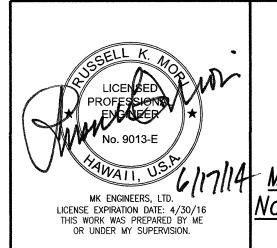

STATE OF HAWAII DEPARTMENT OF TRANSPORTATION

TRENCH RESTORATION DETAILS

MIDDLE STREET PAVEMENT RECONSTRUCTION North King Street to Kamehameha Highway FAP NO. STP-7415(001)

Scale: As Noted

Date: June 20, 2014

SHEET No. E-16 OF 17 SHEETS

