
#### **GENERAL NOTES:**

- 1. All Work shall be done in Accordance with the "Hawaii Standard Specifications for Road, Bridge, and Public Works Construction", 1994, State of Hawaii Department of Transportation, Highways Division, Except as Modified Herein or in the Special Provisions.
- 2. The Contractor shall verify with the Respective Utility Companies and Government Agencies, the Locations of all Electric, Telephone, Roadway Light, Water, Sewer, Drain, and other Lines Crossing the Excavation Path or in Excavation Areas.
- 3. The Contractor shall Notify all Affected Utility Companies and Government Agencies of their Intent to Begin Construction on any Intersection or Street at Least Two (2) Weeks prior to the Start of such Construction.
- 4. The Contractor shall Install all Roadway Lighting Luminaires, Poles, In-grade Roadway Lighting Pole Foundations, Risers from Pullboxes to Foundations, Metering Requirements, and Wiring as Specified In these Plans and the Specifications.
- 5. The Contractor shall Install Roadway Lighting Conductors and make Connections to Existing Conductors at or Past Project Interfaces as Required.
- 6. The Contractor shall Coordinate with the State Handling of all Salvageable Materials Indicated to be Removed.
- 7. The Contractor shall Provide Temporary Lights and Wiring as Required to Maintain Roadway Lighting During Contstruction.
- 8. Permanent Roadway Lighting Criteria:
  - a. minimum average maintained illumination level: Collector - Intermediate - 0.8 Fc
  - b. maximum (average to minimum maintained footcandle) Uniformity Ratio: 4 To 1
  - c. maintenance factor: 0.76
  - d. provide roadway illumination calculations (per aashto Recommendations) Certifying Conformance With Minimim Average Maintained Illumination Levels And Maximum (average To Minimum Maintained Footcandles) Uniformity Ratio
- 9. The Contractor Shall Submit Computerized Point To Point Foot-Candle Level For Approval.

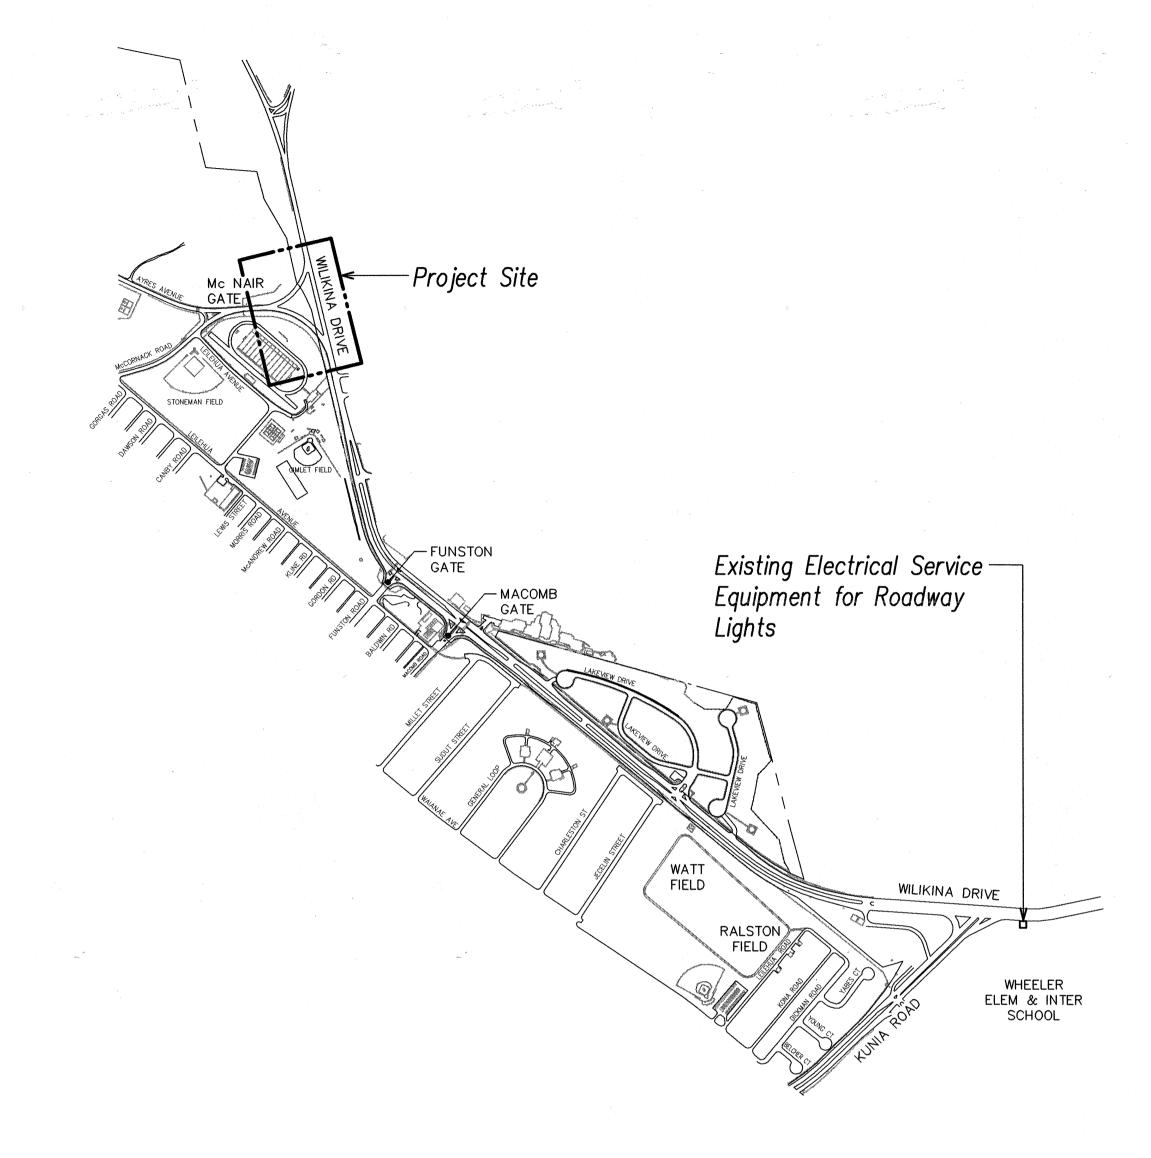

SYMBOL	DESCRIPTION
	Roadway Light Pole, Bracket Arm, and
	250 Watt HPS Luminaire, See Sheet 7
	Roadway Light Pole, Twin Bracket Arm, and
	250 Watt HPS Luminaires, See Sheet 7
	Frieling Dendum Light to La Dense
o⊖	Existing Roadway Light to be Removed
	Existing Roadway Light to Remain
$\bigcirc$	Existing Noduwdy Light to Nemain
	Temporary Roadway Light, See Sheet 10
<del></del>	Tomporary Nodaway Eight, Oct Onect 10
	Underground Wiring as Noted
e	Existing Underground Duct
<u>— ОН—</u>	Overhead Cable as Noted
— e/0H—	Existing Overhead Cable as Noted
	Pullbox, Type A, See Sheet 9
<u>PB</u>	Pullbox
(A)———	Duct Section Designator, Section "A" Indicated,
	See Details on Sheet 8

FED.ROAD DIST.NO.

ELECTRICAL SYMBOLS


STATE

FISCAL SHEET TOTAL YEAR NO. SHEETS

2001 | 37

PROJ. NO.

99C-02-00

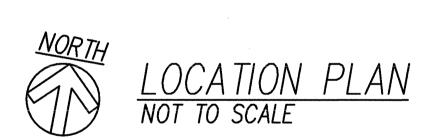



STATE OF HAWAII DEPARTMENT OF TRANSPORTATION HIGHWAYS DIVISION


> ELECTRICAL SYMBOLS, **GENERAL NOTES**


WILIKINA DR INTERSECTION IMPROVEMENTS AT McNAIR GATE


Project No. 99C-02-00 Scale: None

Date: Sep 2000 **SHEET No.** 1 **OF** 10 SHEETS


THIS WORK WAS PREPARED BY ME OR UNDER MY SUPERVISION.

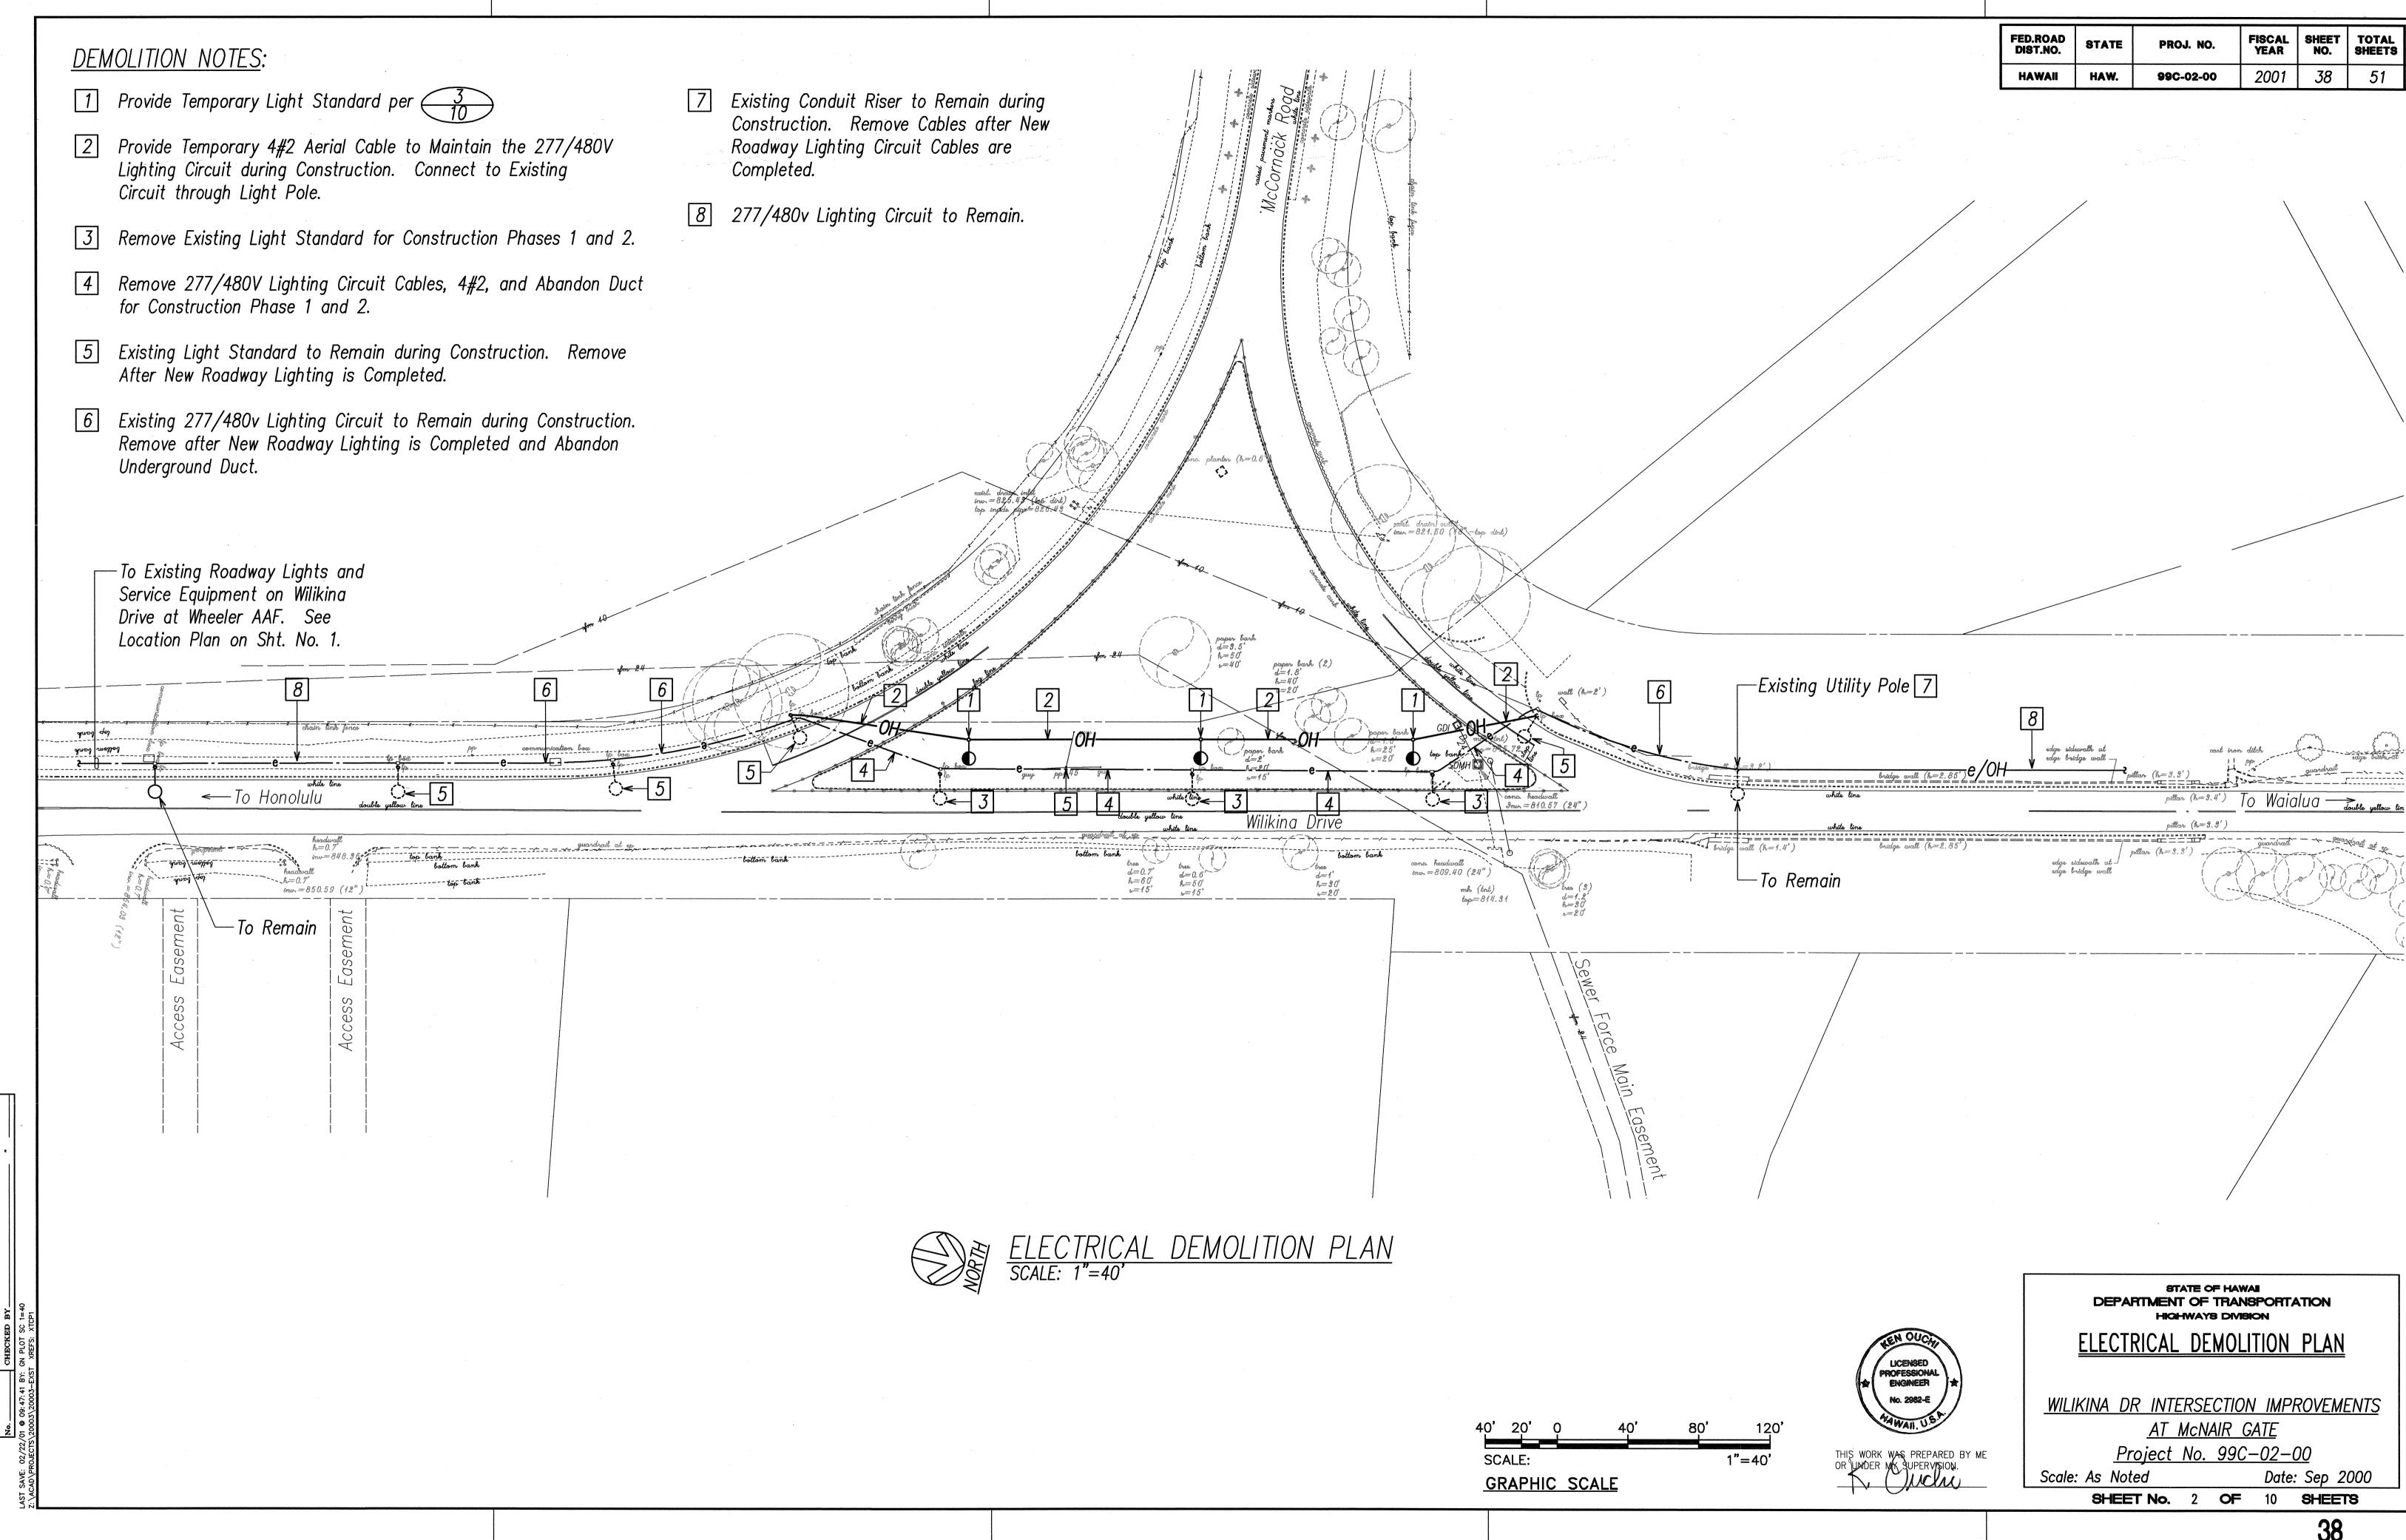

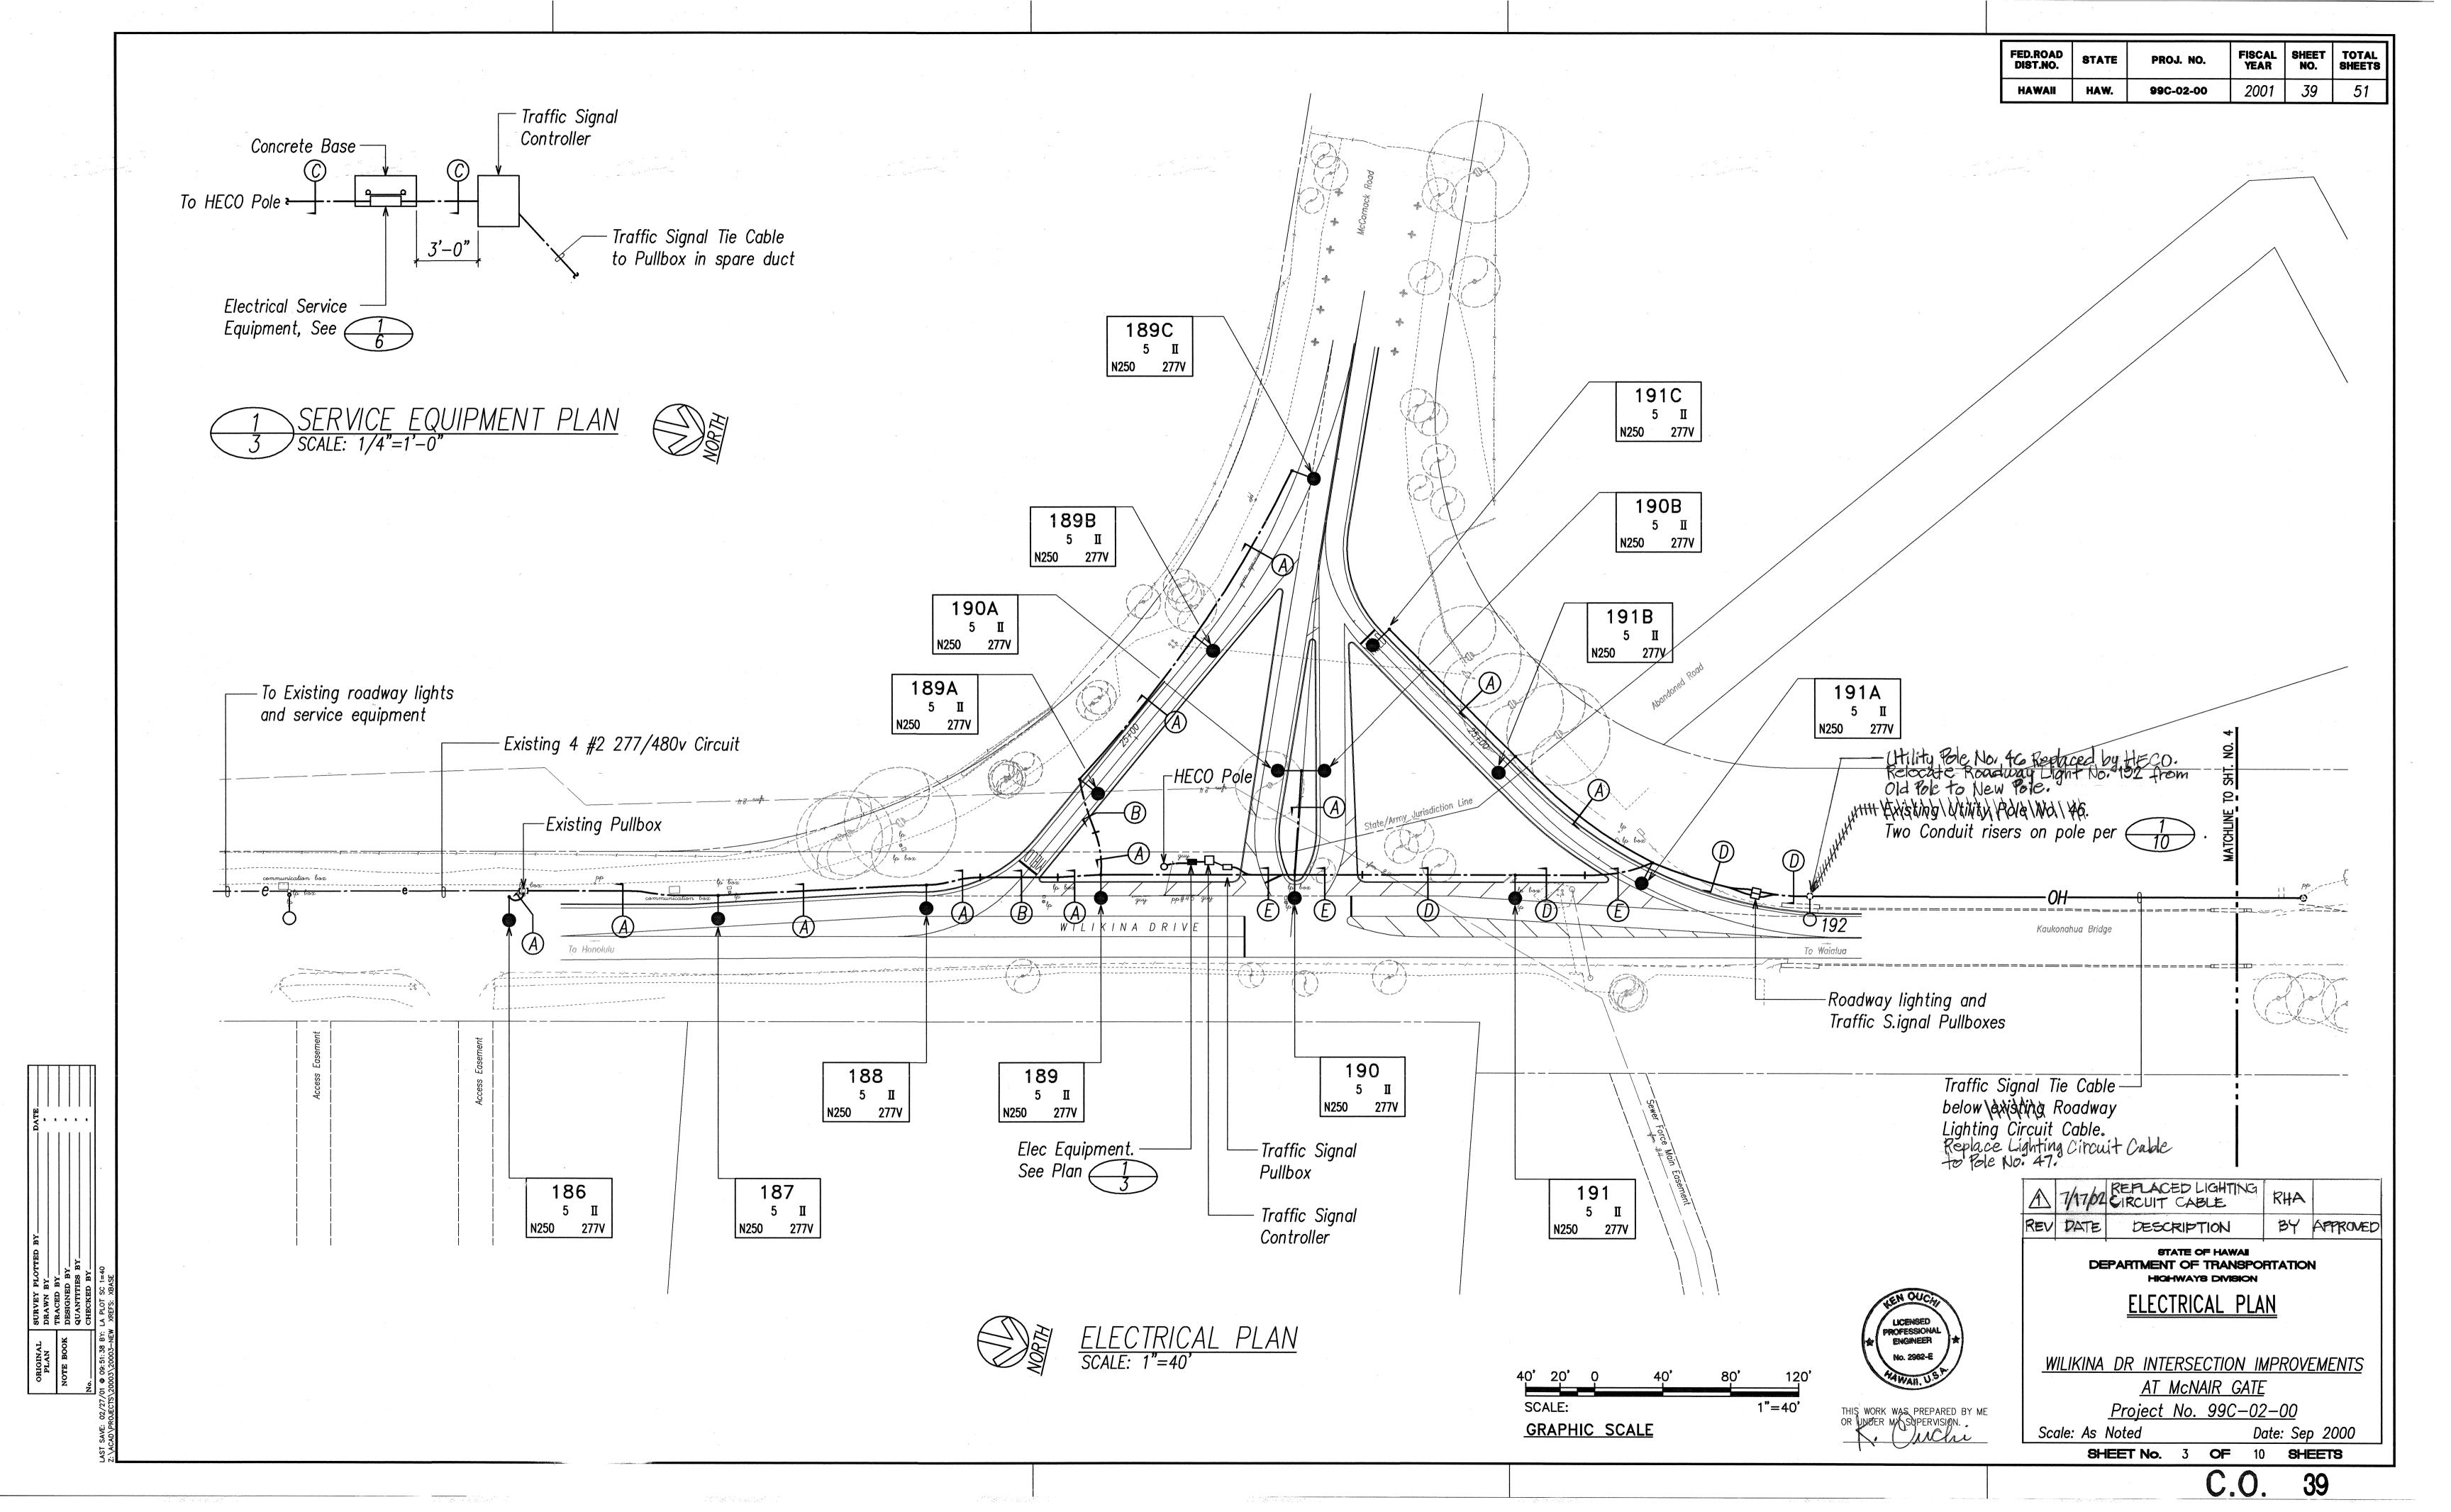

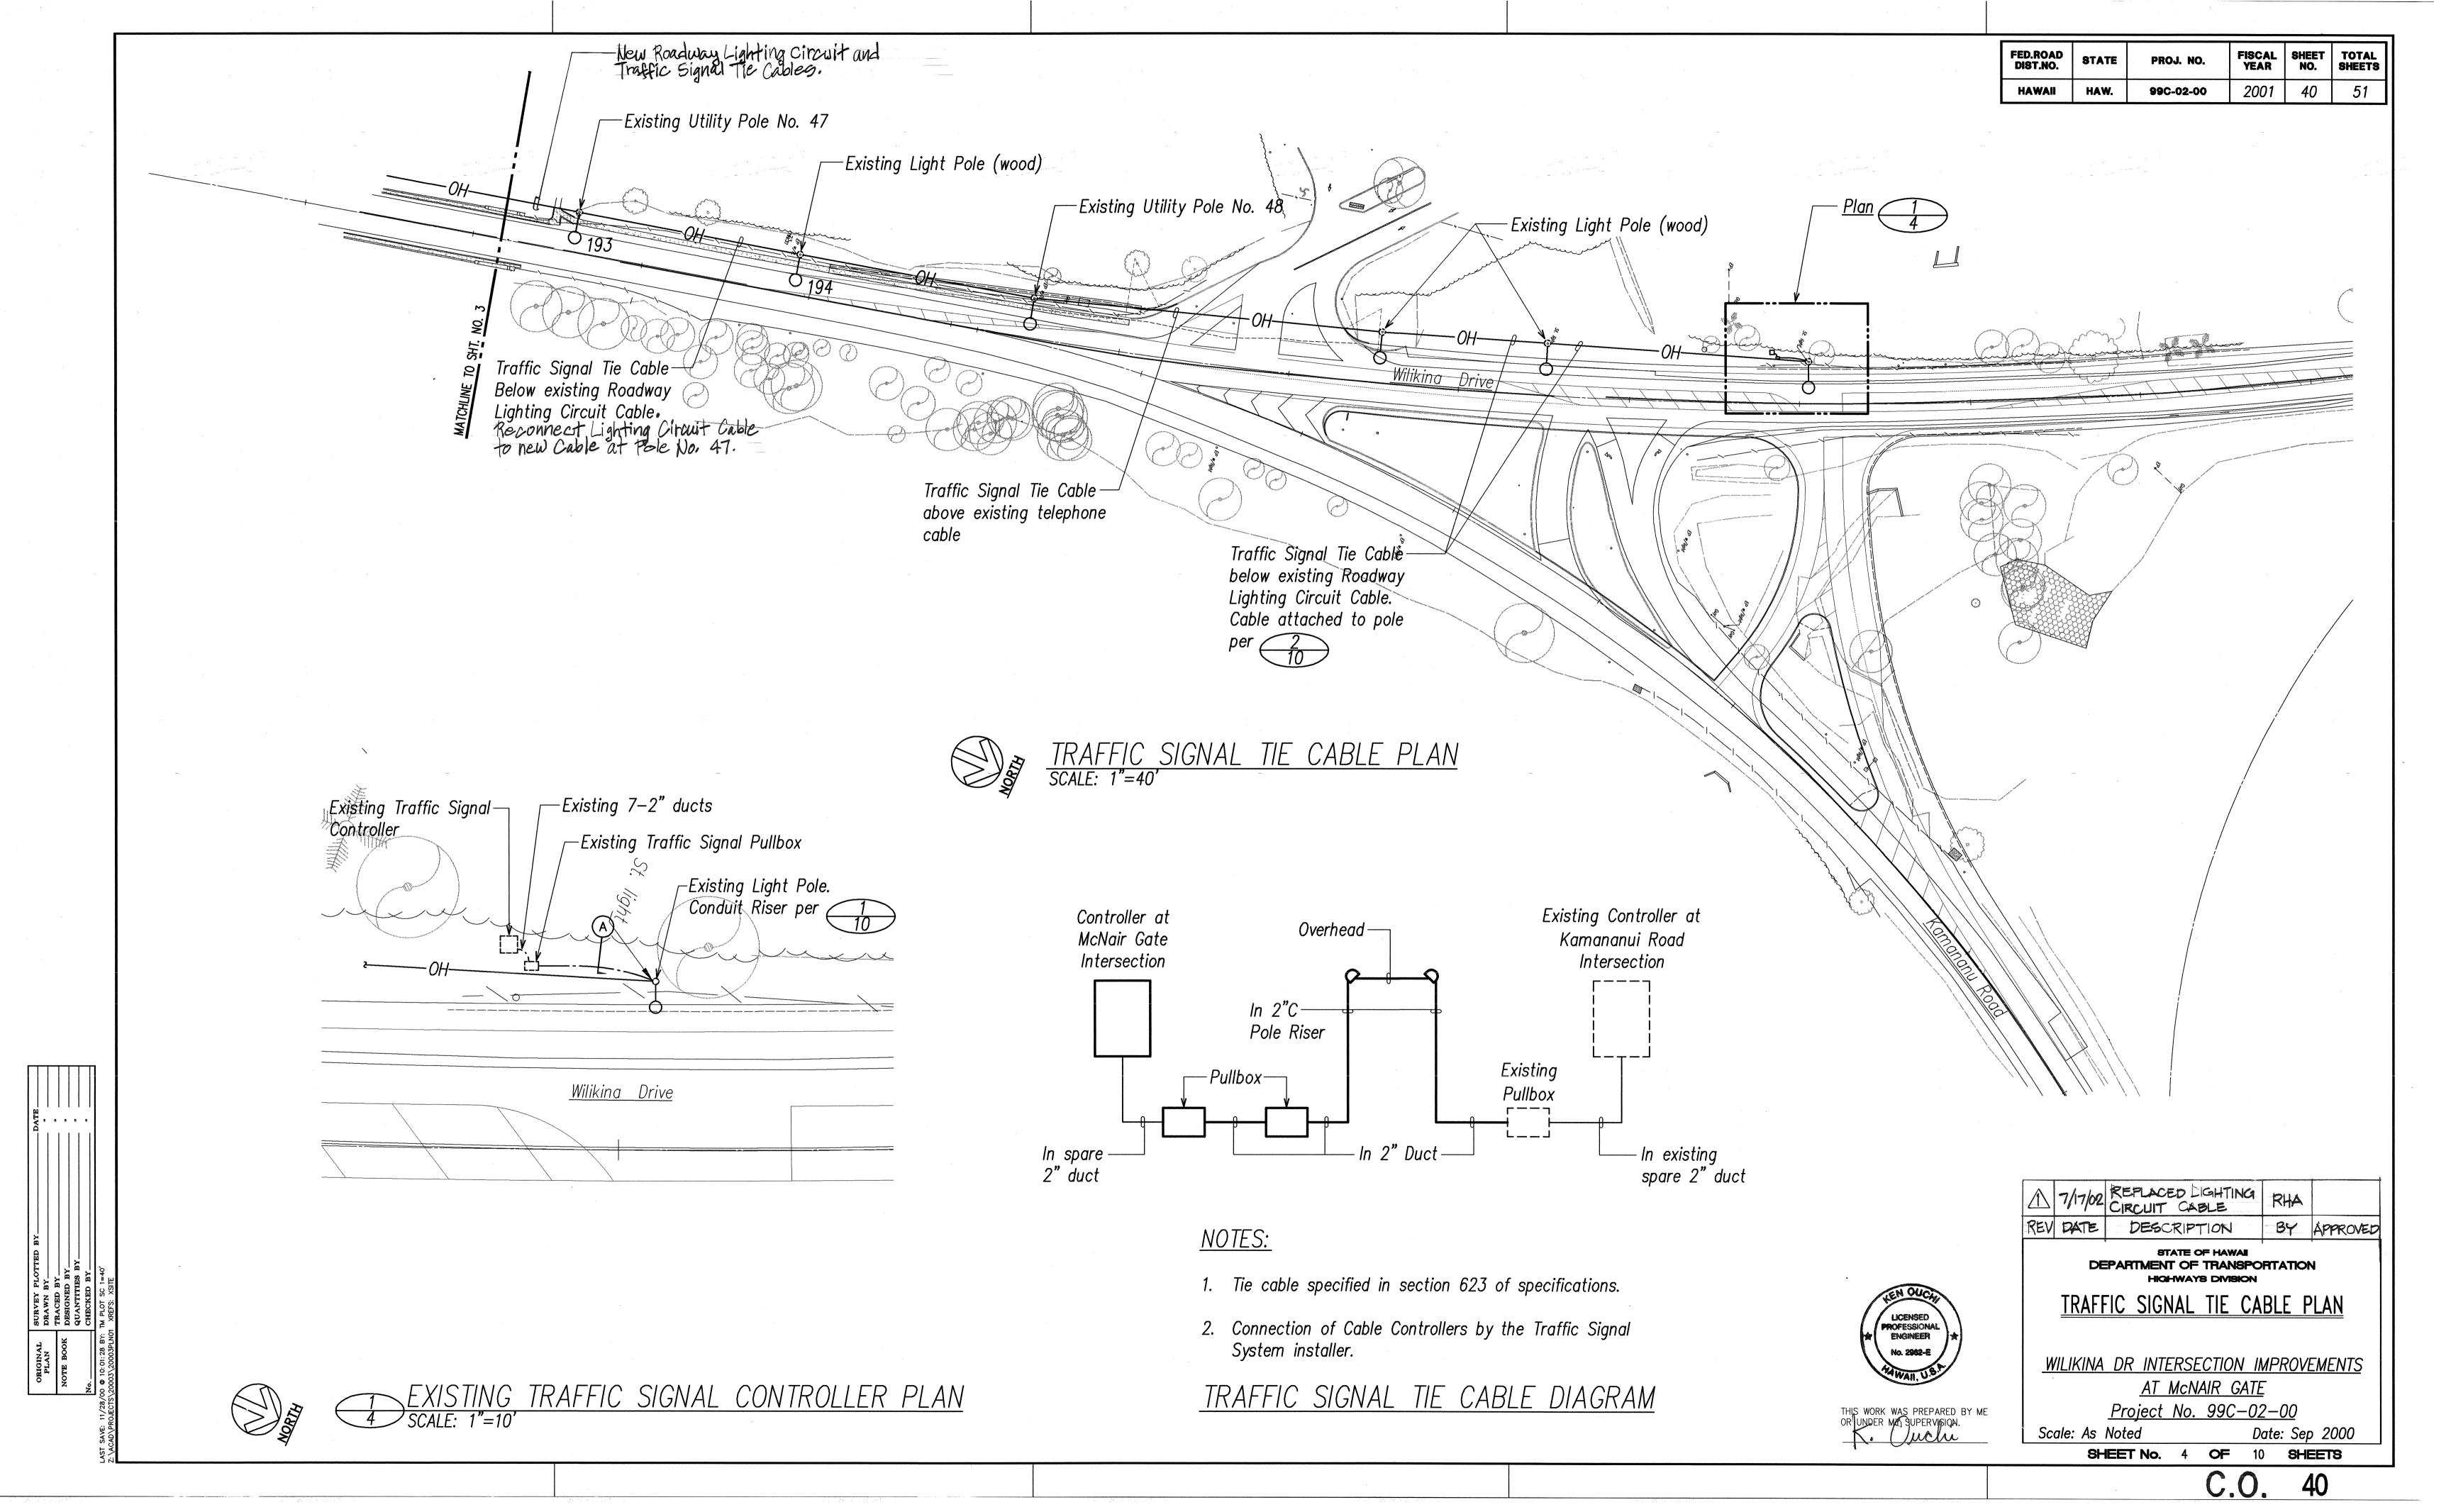


FED.ROAD DIST.NO.	STATE	PROJ. NO.	FISCAL YEAR	SHEET NO.	TOTAL SHEETS
HAWAII	HAW.	99C-02-00	2001	41	51

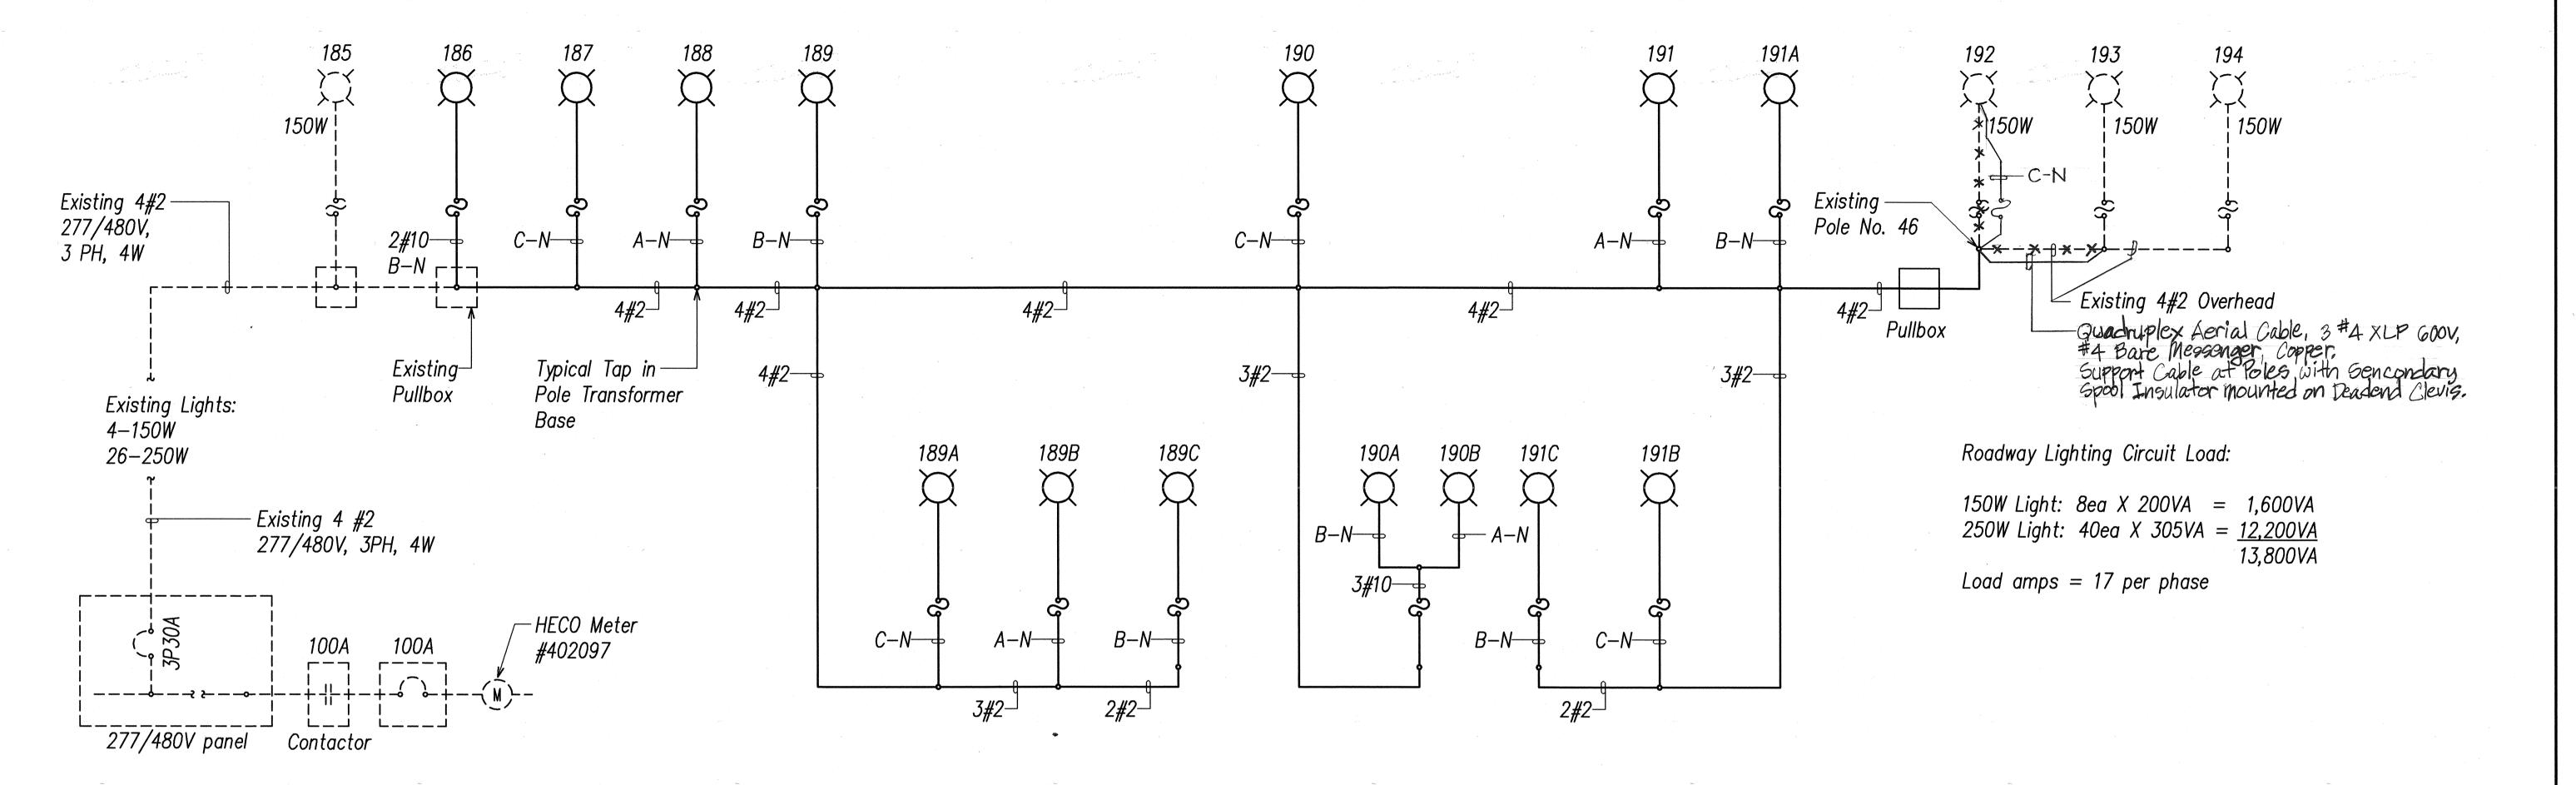


# EXISTING ROADWAY LIGHTING SERVICE EQUIPMENT

## ROADWAY LIGHTING CIRCUIT ONE-LINE DIAGRAM

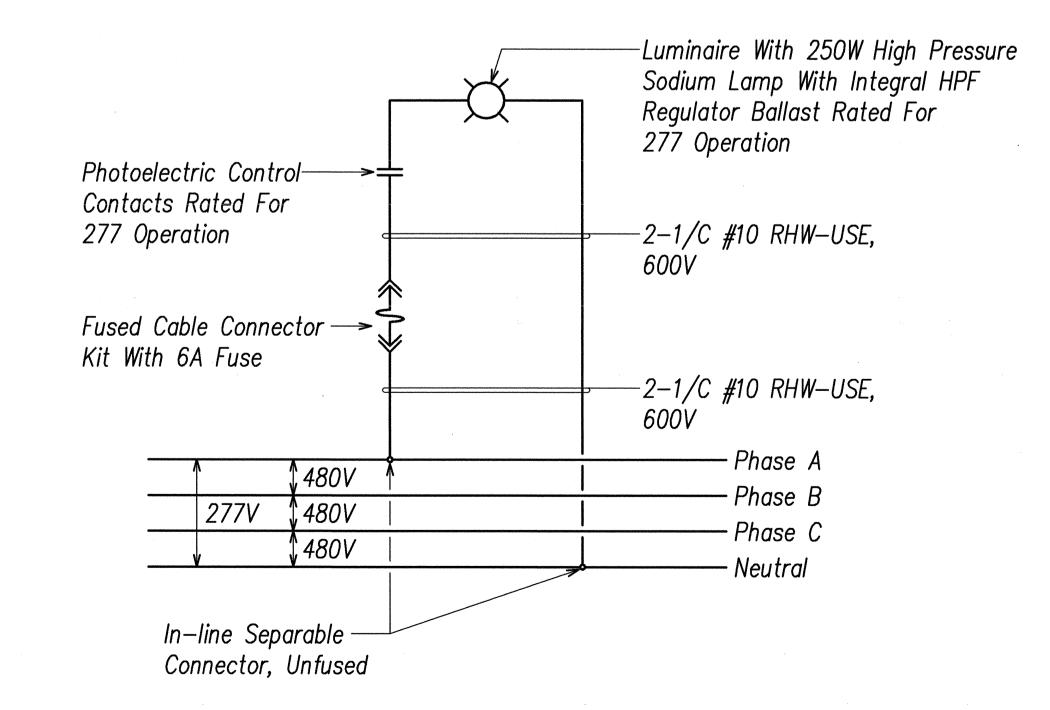

TYPICAL ROADWAY LIGHT WIRING CONNECTION DIAGRAM

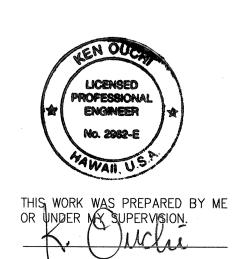

1/17/02	REPLACED LIGHTING CIRCUIT CABLE	RHA	
REV DATE	DESCRIPTION	BY	APPROVE

DEPARTMENT OF TRANSPORTATION

ROADWAY LIGHTING CIRCUIT ONE-LINE & WIRING CONNECTION DIAGRAMS

WILIKINA DR INTERSECTION IMPROVEMENTS

AT McNAIR GATE

Project No. 99C-02-00

Scale: None Date: Sep 2000
SHEET No. 5 OF 10 SHEETS

C.O. 41

FED.ROAD DIST.NO. FISCAL SHEET TOTAL YEAR NO. SHEETS PROJ. NO. STATE 2001 42 99C-02-00 HAWAII

2"C, 3#6,

Traffic Signal

Controller

#8 Gnd

- <u>Combination Meter Socket</u>

100A, 4-Jaw, 120/240V, 10

with Factory Installed Test

By-Pass Facilities, Main


Breaker as Indicated,

2P50A

Sealable

-2"C, 3#6,

1#8 Gnd

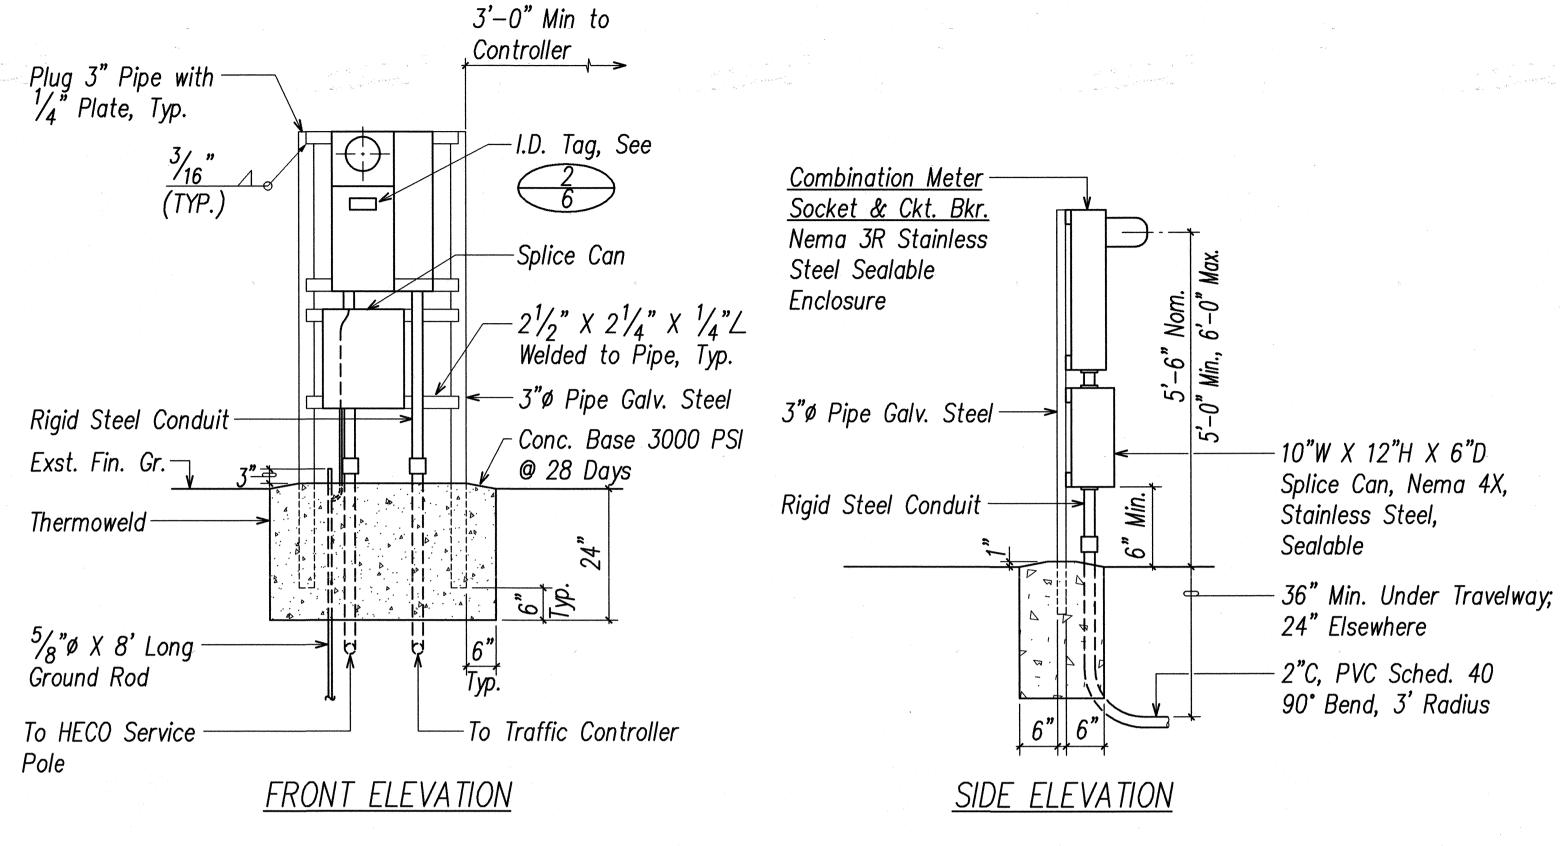

ELECTRICAL SERVICE DIAGRAM 13/16"\_\_\_ TRAFFIC SIGNAL VAULT NO. X

Splice Can, Sealable -

2"C, 3#2 -

 $\frac{3}{4}$ "C, 1#8 Gnd –

 $\frac{5}{8}$ " Dia. x 8'-0",

Copperclad Steel

Gnd Rod

Weatherhead -

Final Connection

by HECO

Secondary-

Cables

by HECO

#### NOTES:

- 1. Contractor shall make all Electrical Connection to Controller, Provide 2-1P50A Breakers, Ground and 2" Conduit.
- 2. All Conduits to Contain a Polyolefin Pull Line. (Jet Line Cat. #232 rr Equiv.)
- 3. Pedestal shall be Hot-dipped Galvanized after Fabrication.
- 4. All Fastening Bolts, Nuts & Washers shall be Stainless Steel. Provide One Coat Shop Primer & Two Coats Of Acrylic Enamel Finish, Color to Match Controller Cabinet.
- 5. Provide 4 Ft. Clearance in Front of Meter.



#### NOTES:

13/<sub>16</sub>"\_\_\_

- 1. Use 3 Ply Laminated Flexible Plastic, Black-White-Black. Thickness: Black Cap Sheet-0.010", White Base Sheet-0.052", Black Base Sheet-0.010".
- 2. Attach to Meter Socket using Scotch 3M Brand very High Bond (VHB) Double Coated Acrylic Foam Tape or Equivalent.
- 3. Letters/Numbers shall be  $\frac{3}{8}$ " High,  $\frac{1}{16}$ " Stroke, (White in Color).
- 4. Letters/Numbers are Inscribed by Cutting Through "Black Cap Sheet" to Expose White Letters/Numbers.
- 5. Coordinate Vault No. with the State, Highway Division.

T. S. METER I.D. TAG DETAIL

NOT TO SCALE



STATE OF HAWAII DEPARTMENT OF TRANSPORTATION


ELECTRICAL SERVICE EQUIPMENT **ELECTRICAL SERVICE DIAGRAM** 


WILIKINA DR INTERSECTION IMPROVEMENTS AT MCNAIR GATE

Project No. 99C-02-00 Scale: As Noted Date: Sep 2000

**SHEET No.** 6 **OF** 10 SHEETS

42

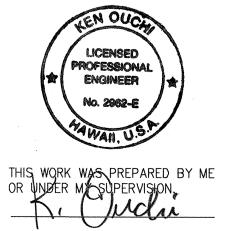

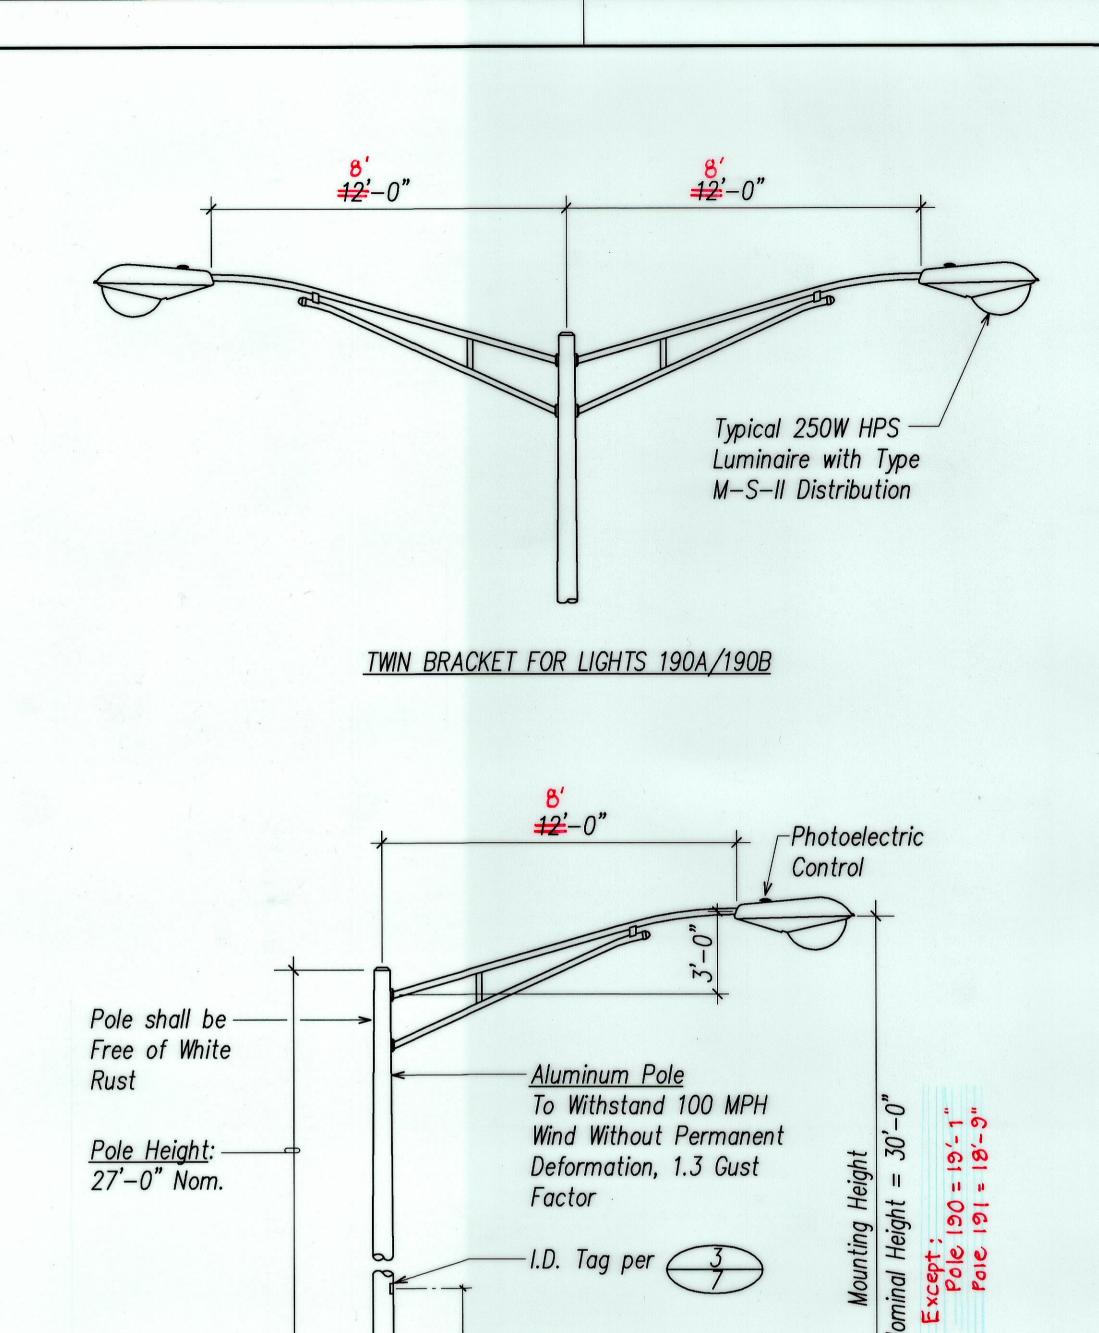

6'-0" to

Grade

Not to Scale

**ELEVATION** 

Transformer Base

Concrete Base per 2


Breakaway Type

— Final Grade


ROADWAY LIGHT STANDARD

Bolt Cover

Handhole-

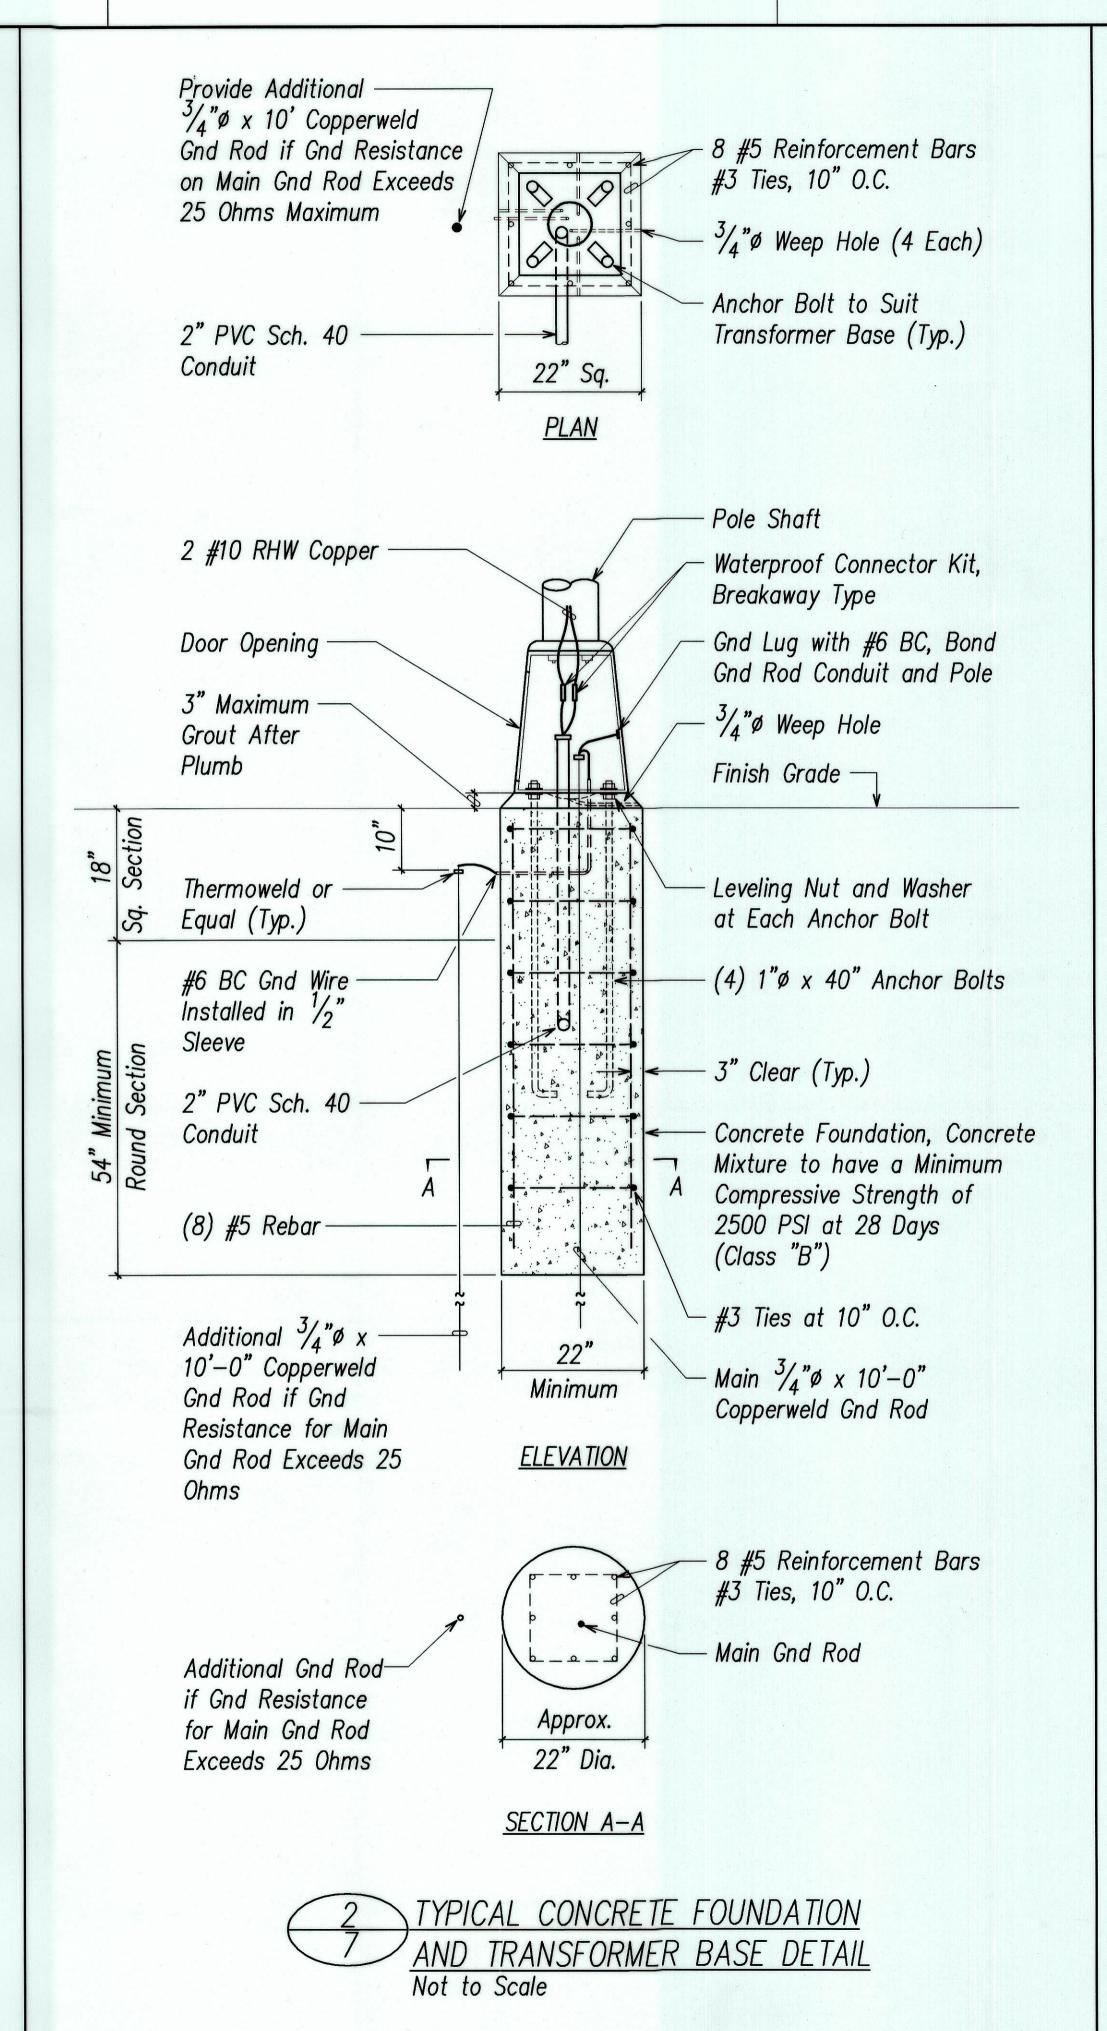



FISCAL SHEET TOTAL SHEETS FED.ROAD DIST.NO. PROJ. NO. STATE 2001 43 51 99C-02-00 HAWAII HAW.

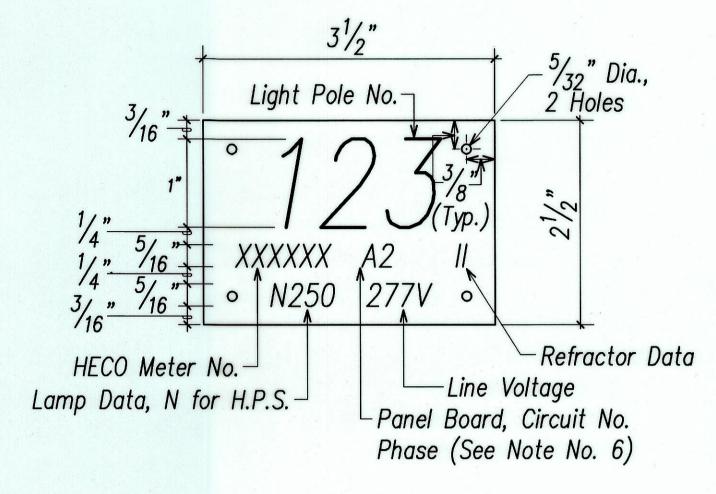

#### NOTES:

- Use 3 Ply Laminated Flexible Plastic Black—White—Black Thickness: Black Cap Sheet-0.010", White Base Sheet-0.052", Black Base Sheet-0.010".
- Light Pole Number Size shall be 1" High and Engraved  $\frac{1}{8}$ " Wide, White in Color (Number as Required).
- Nomenclature Size shall be  $\frac{5}{16}$ " High and Engraved  $\frac{1}{32}$ " Wide, White in Color (Meter Number, Circuit Number, Line Voltage, Lamp Data and Refractor Data as Required).
- Attach to Aluminum and Steel Poles with No. 8 Stainless Steel,  $\frac{1}{2}$ " Long Drive Screw in  $\frac{1}{8}$ " Drill Hole. Attach to Wood Poles with 4D Aluminum
- Numbers are Inscribed by Cutting through "Black Cap Sheet" to Expose "White Letters".
- Nomenclature Required for Systems with Two or More Circuits. First Letter Indicates Panel Board, Number Indicates Circuit.

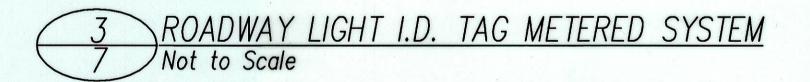

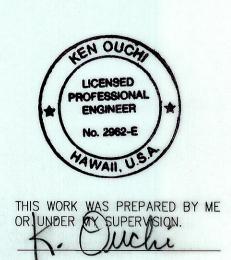

STATE OF HAWAII
DEPARTMENT OF TRANSPORTATION

ROADWAY LIGHT STANDARD

WILIKINA DR INTERSECTION IMPROVEMENTS AT MCNAIR GATE

Project No. 99C-02-00 Scale: As Noted


**SHEET No.** 7 **OF** 10

"AS-BUILT"

43

Date: Sep 2000

SHEETS

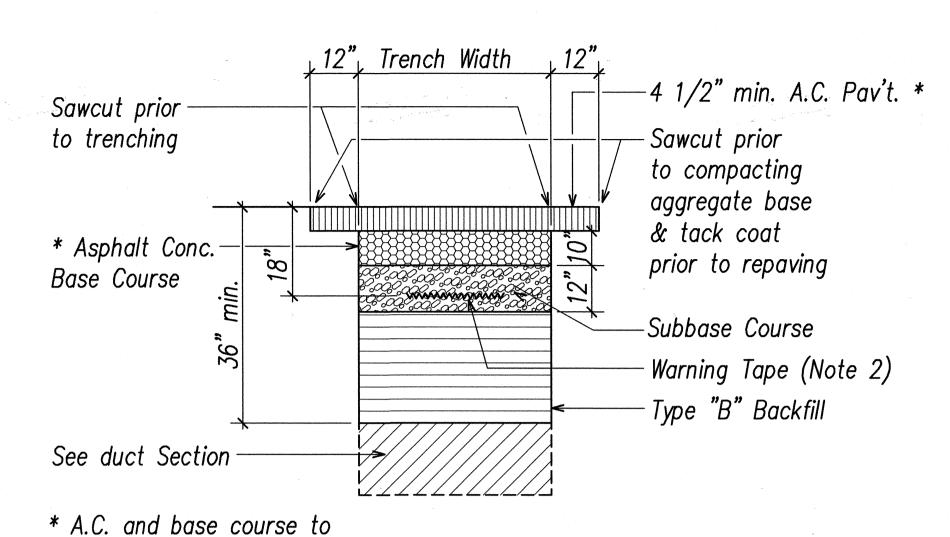


1) EXCAVATION AND BACKFILL SECTION

match existing thickness

or the minimum thickness

shown, whichever is greater.

Within State right-of-way under roadway & paved shoulder

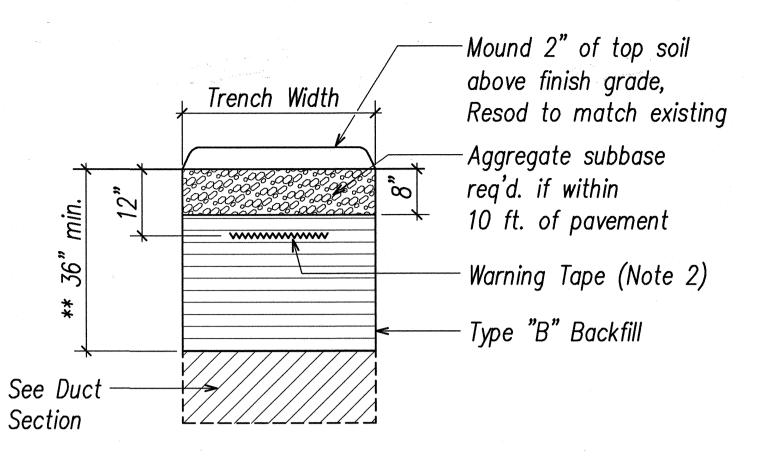


\*\* Exception is where ducts encounter water and drain lines at the same depth. The ducts shall cross over the water and drain lines with a minimum depth of 18".

> 2 EXCAVATION AND BACKFILL SECTION Within State right-of-way under unpaved shoulder

## STATE RIGHT-OF-WAY BACKFILL NOTES

Not to Scale

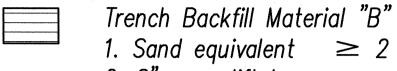

2. 8" max. lift loose

3. 95% compaction

Trench Backfill Material "A" 1. Sand equivalent ≥ 20

2. 8" max. lift loose


3. 95% compaction

If Material below duct is not equivalent to backfill material "A", excavate material & provide 3" backfill material


Concrete - 3" Encasement, 2500 PSI compressive strength within 3 days.

"A". See above

- Base course & sub-base course per 1994 State Standard Specifications for Highway Construction.
- 2. 3" wide red colored plastic tape. 1-mil continuous metallic backing, corrosion resistant, inscribed with: "CAUTION-ELECTRICAL LINE BURIED BELOW" in black lettering, repeated at thirty—six inch intervals.

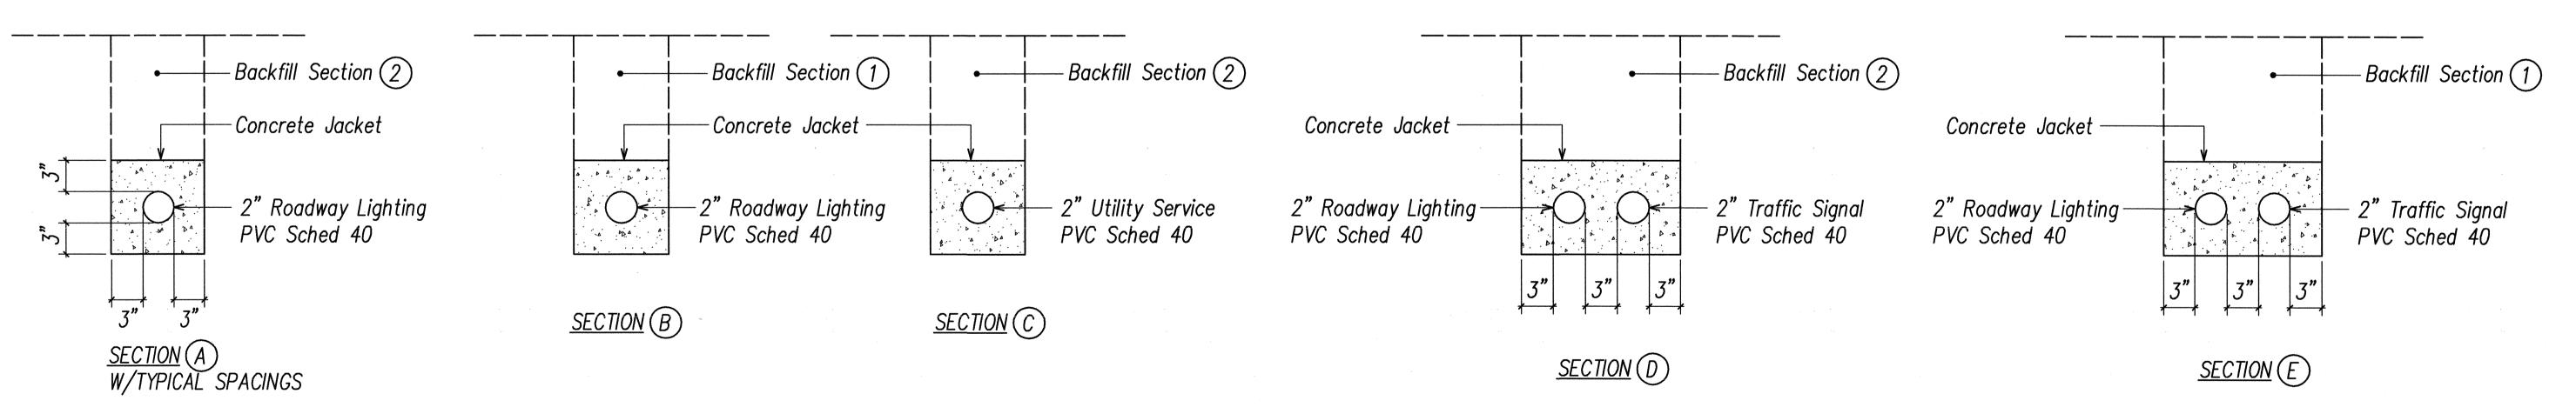

**DUCT SECTIONS** Not to Scale

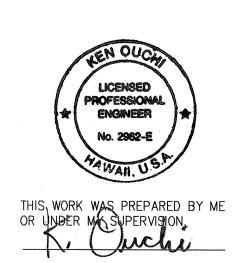

STATE OF HAWAII **DEPARTMENT OF TRANSPORTATION** HIGHWAYS DIVISION

**DUCT SECTIONS** 

WILIKINA DR INTERSECTION IMPROVEMENTS AT McNAIR GATE

Project No. 99C-02-00 Scale: As Noted Date: Sep 2000 SHEET No. 8 OF

SHEETS

FISCAL SHEET NO.

2001 44

FED.ROAD DIST.NO.

HAWAII


STATE


HAW.


PROJ. NO.

99C-02-00


44

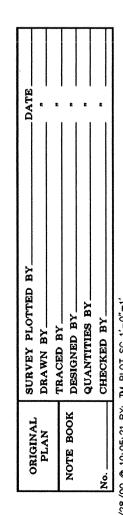


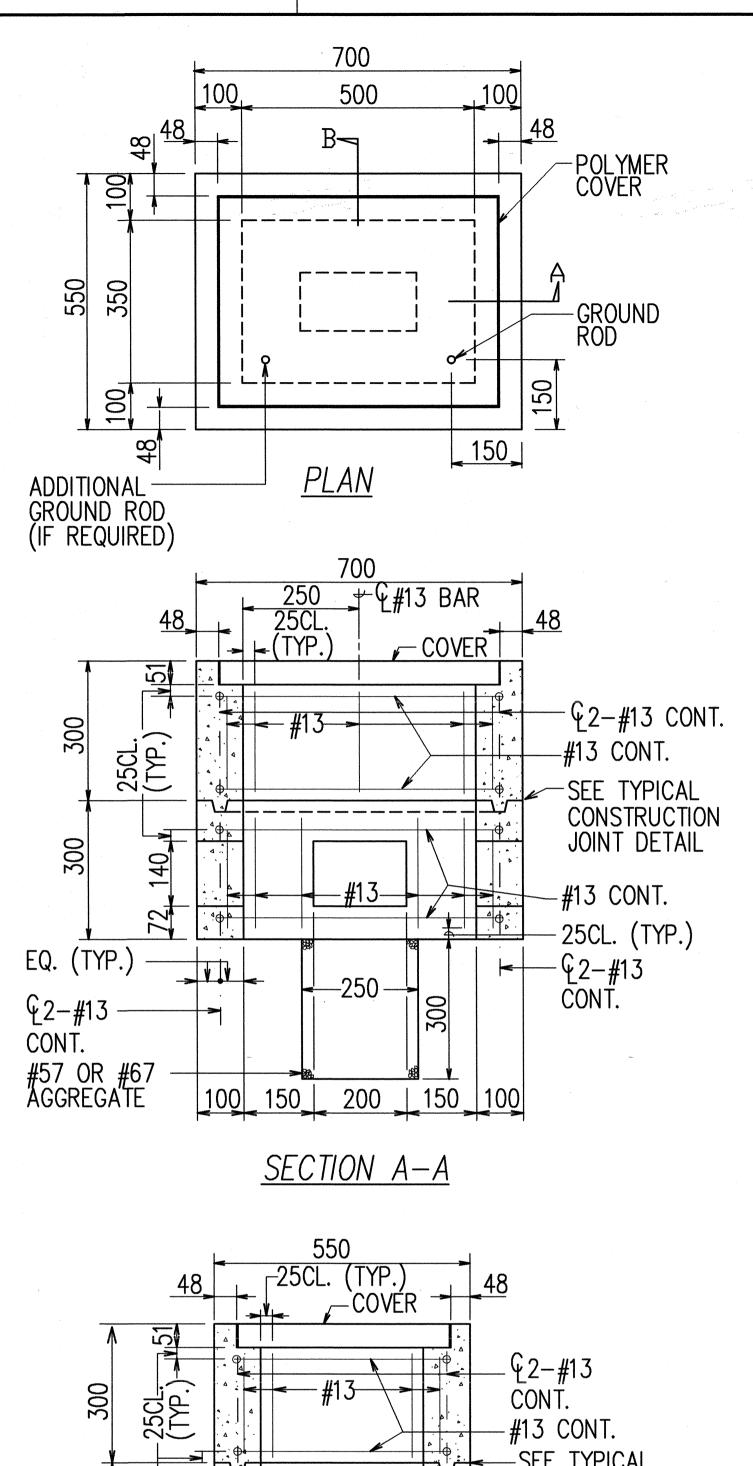

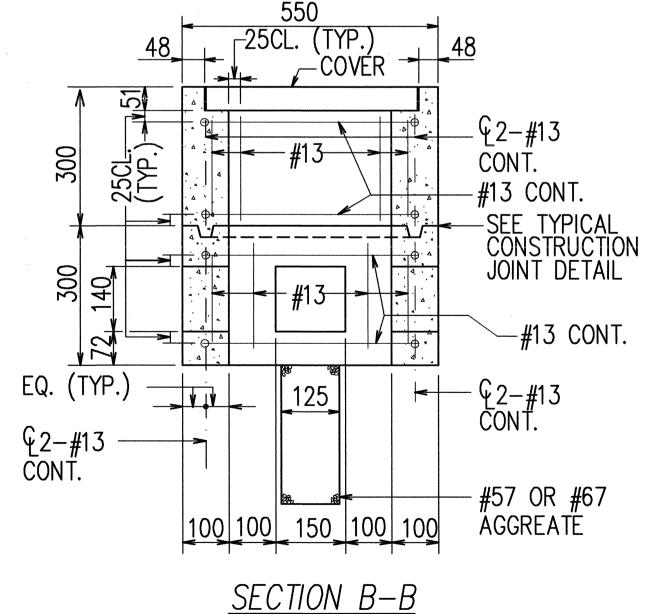


TYPE "A" PULLBOX (OLD TYPE "B")
NOT TO SCALE

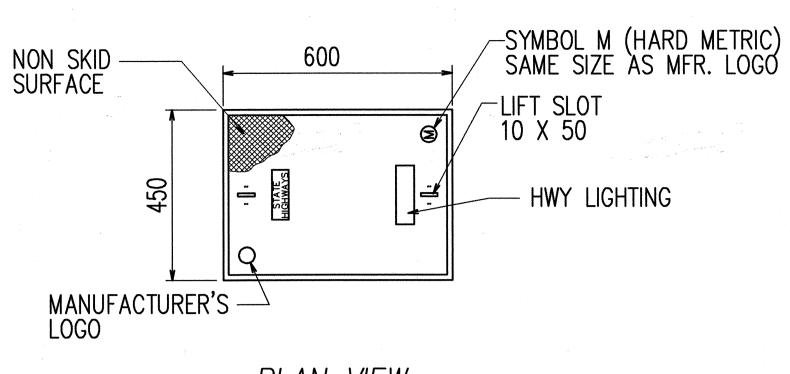


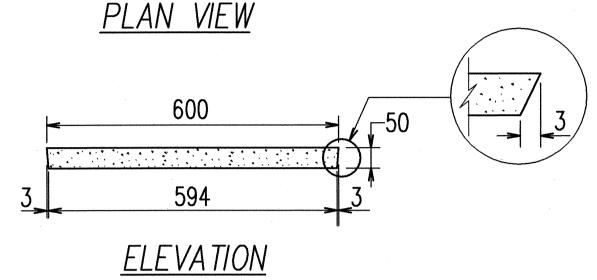

# POLYMER CONCRETE COVER NOT TO SCALE

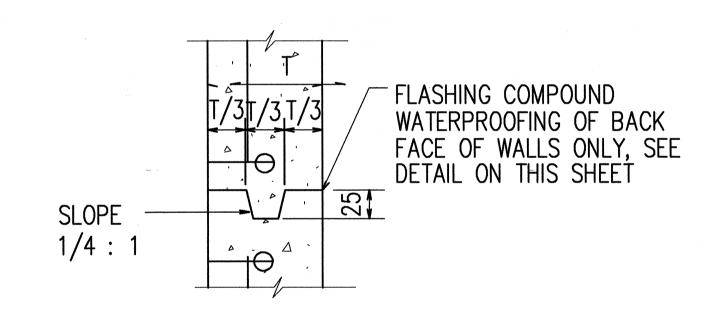

TYPICAL CONSTRUCTION JOINT DETAIL NOT TO SCALE

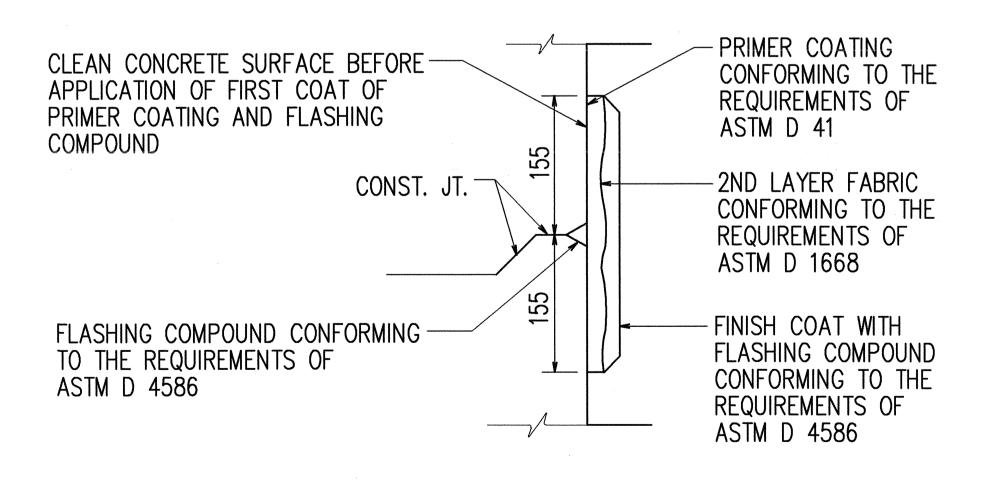

TYPICAL FLASHING COMPOUND
WATERPROOFING DETAILS
NOT TO SCALE

FED.ROAD<br/>DIST.NO.STATEPROJ. NO.FISCAL<br/>YEARSHEET<br/>NO.TOTAL<br/>SHEETSHAWAIIHAW.99C-02-0020014551

#### GENERAL NOTES FOR PULLBOX

- PROVIDE A MINIMUM OF ONE 16 X 2.5M COPPERWELD GROUND ROD IN EACH PULLBOX. WHEN DIRECTED BY THE TRAFFIC SIGNAL INSPECTOR/ENGINEER, INSTALL ADDITIONAL GROUND RODS. COST OF GROUND RODS SHALL BE INCIDENTAL TO THE PULLBOXES.
- ALL PRE-CAST CONCRETE PULLBOXES SHALL BE MANUFACTURED IN TWO PIECES.
- THE PULLBOX WITH COVER SHALL BE CAPABLE OF SUPPORTING AN MS 18 LOADING.
- 4. THE MAXIMUM WEIGHT OF THE PULLBOX COVER SHALL NOT EXCEED 27 KILOGRAMS.
- THE OPENINGS FOR THE CONDUITS ON ALL PULLBOXES SHALL BE PRE-CAST CONCRETE KNOCKOUTS.
- AFTER INSTALLING THE CONDUITS IN THE OPENINGS OF THE PULLBOXES, THE CONTRACTOR SHALL FILL THE EXCESS OPENING IN THE PRE—CAST KNOCKOUTS WITH CONCRETE MORTAR.
- 7. PRIOR TO INSTALLING THE PULLBOXES, THE CONTRACTOR SHALL LEVEL THE BOTTOM OF THE TRENCH AND ACHIEVE A MINIMUM OF 95% RELATIVE COMPACTION OF THE BOTTOM OF THE TRENCH.
- B. ALL CONCRETE SHALL BE CLASS A (25MPA, MIN.)
- 9. REBARS SHALL BE GRADE 300 AND ALL LAPPED SPLICES SHALL BE 360MM MINIMUM.
- 10. THE #57 OR #67 SIZE AGGREGATE SHALL CONFORM TO LATEST VERSION OF AASHTO M43 (ASTM D 448).
- 11. PULLBOX SHALL BE INSTALLED IN A LOCATION PROTECTED FROM VEHICULAR TRAFFIC BEHIND A.C. CURBS

ALL DIMENSIONS ON THIS SHEET ARE IN MILLIMETERS



STATE OF HAWAII
DEPARTMENT OF TRANSPORTATION
HIGHWAYS DIVISION

ROADWAY LIGHTING PULLBOX


<u>WILIKINA DR INTERSECTION IMPROVEMENTS</u>
<u>AT McNAIR GATE</u>

<u>Project No. 99C-02-00</u>

Scale: As Noted Date: Sep 2000

SHEET No. 9 OF 10 SHEETS

15

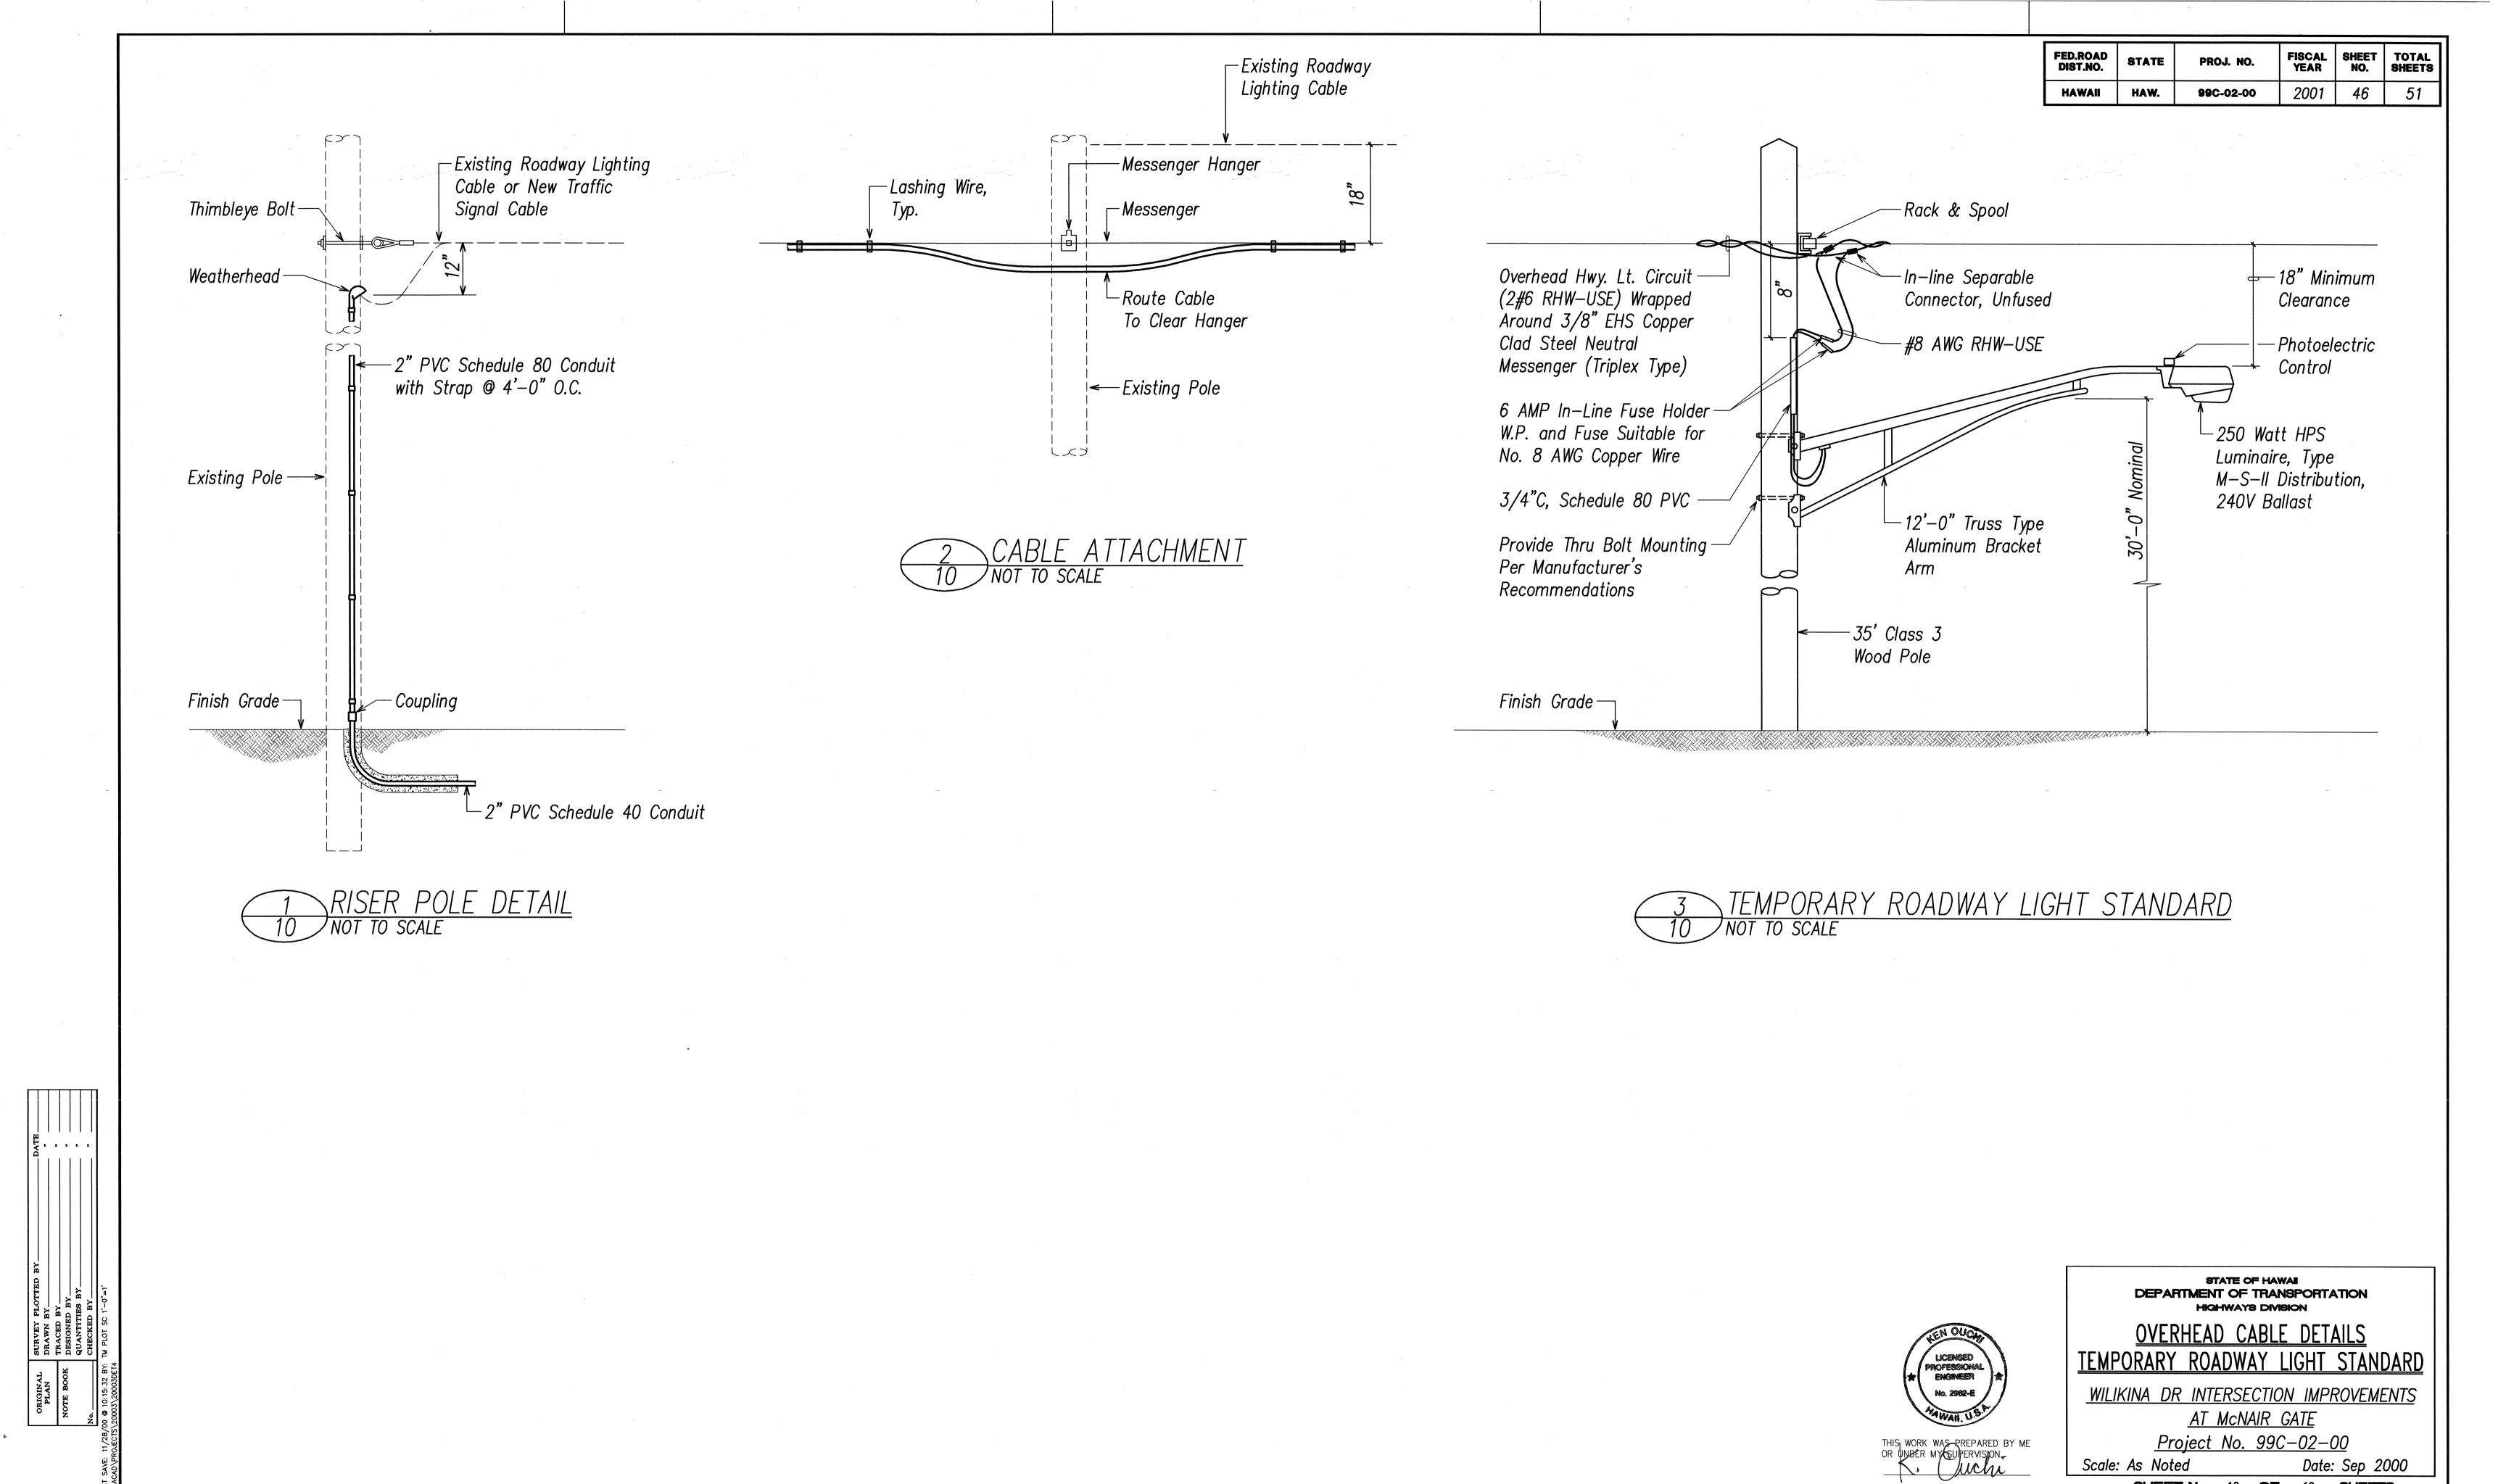

46

**SHEET No.** 10 **OF** 10