

ELECTRICAL SITE PLAN#1
SCALE: 1"=40'-0"


\$ Sta. 68+15±Rt. to \$ Sta.73+00±Rt. New Location of concealed Conduit Below Grade.

- 1. 2'x4' PULLBOX HTCO STANDARD 435TB WITH CHECKER PLATE COVERS, ENGRAVE COVER WITH "STREET LIGHTING!" IDENTIFIED ON PLAN BY "()".
- 2. PATCH ALL PAVEMENT, SIDWALKS, CURBS, ETC.
 DAMAGED BY INSTALLATION OF NEW HIGHWAY
 LIGHTING SYSTEM TO MATCH EXISTING CONDITIONS.

Notes:

- 1. Pull Boxes for Pole No. 5,7,9,11,12,14,16,18,20 and 22 to Remain at Same Original Location.
 2. 6-Foot Mast Arms for Pole No. 7,9,11,12,14,16,18 and 20 have been changed to 10-Foot Mast Arms.



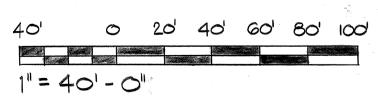



THIS WORK WAS PREPARED BY ME OR UNDER MY SUPERVISION

STATE OF HAWAII
DEPARTMENT OF TRANSPORTATION
HIGHWAYS DIVISION


ELECTRICAL SITE PLAN #1

KAMEHAMEHA HIGHWAY - INSTALLATION OF HIGHWAY LIGHTS

KIPAPA STREET TO WAIKALANI DRIVE PROJECT NO. NH-099-1(16)

> SCALE: NO SCALE DATE:

SHEET No. 5 OF 12 SHEETS

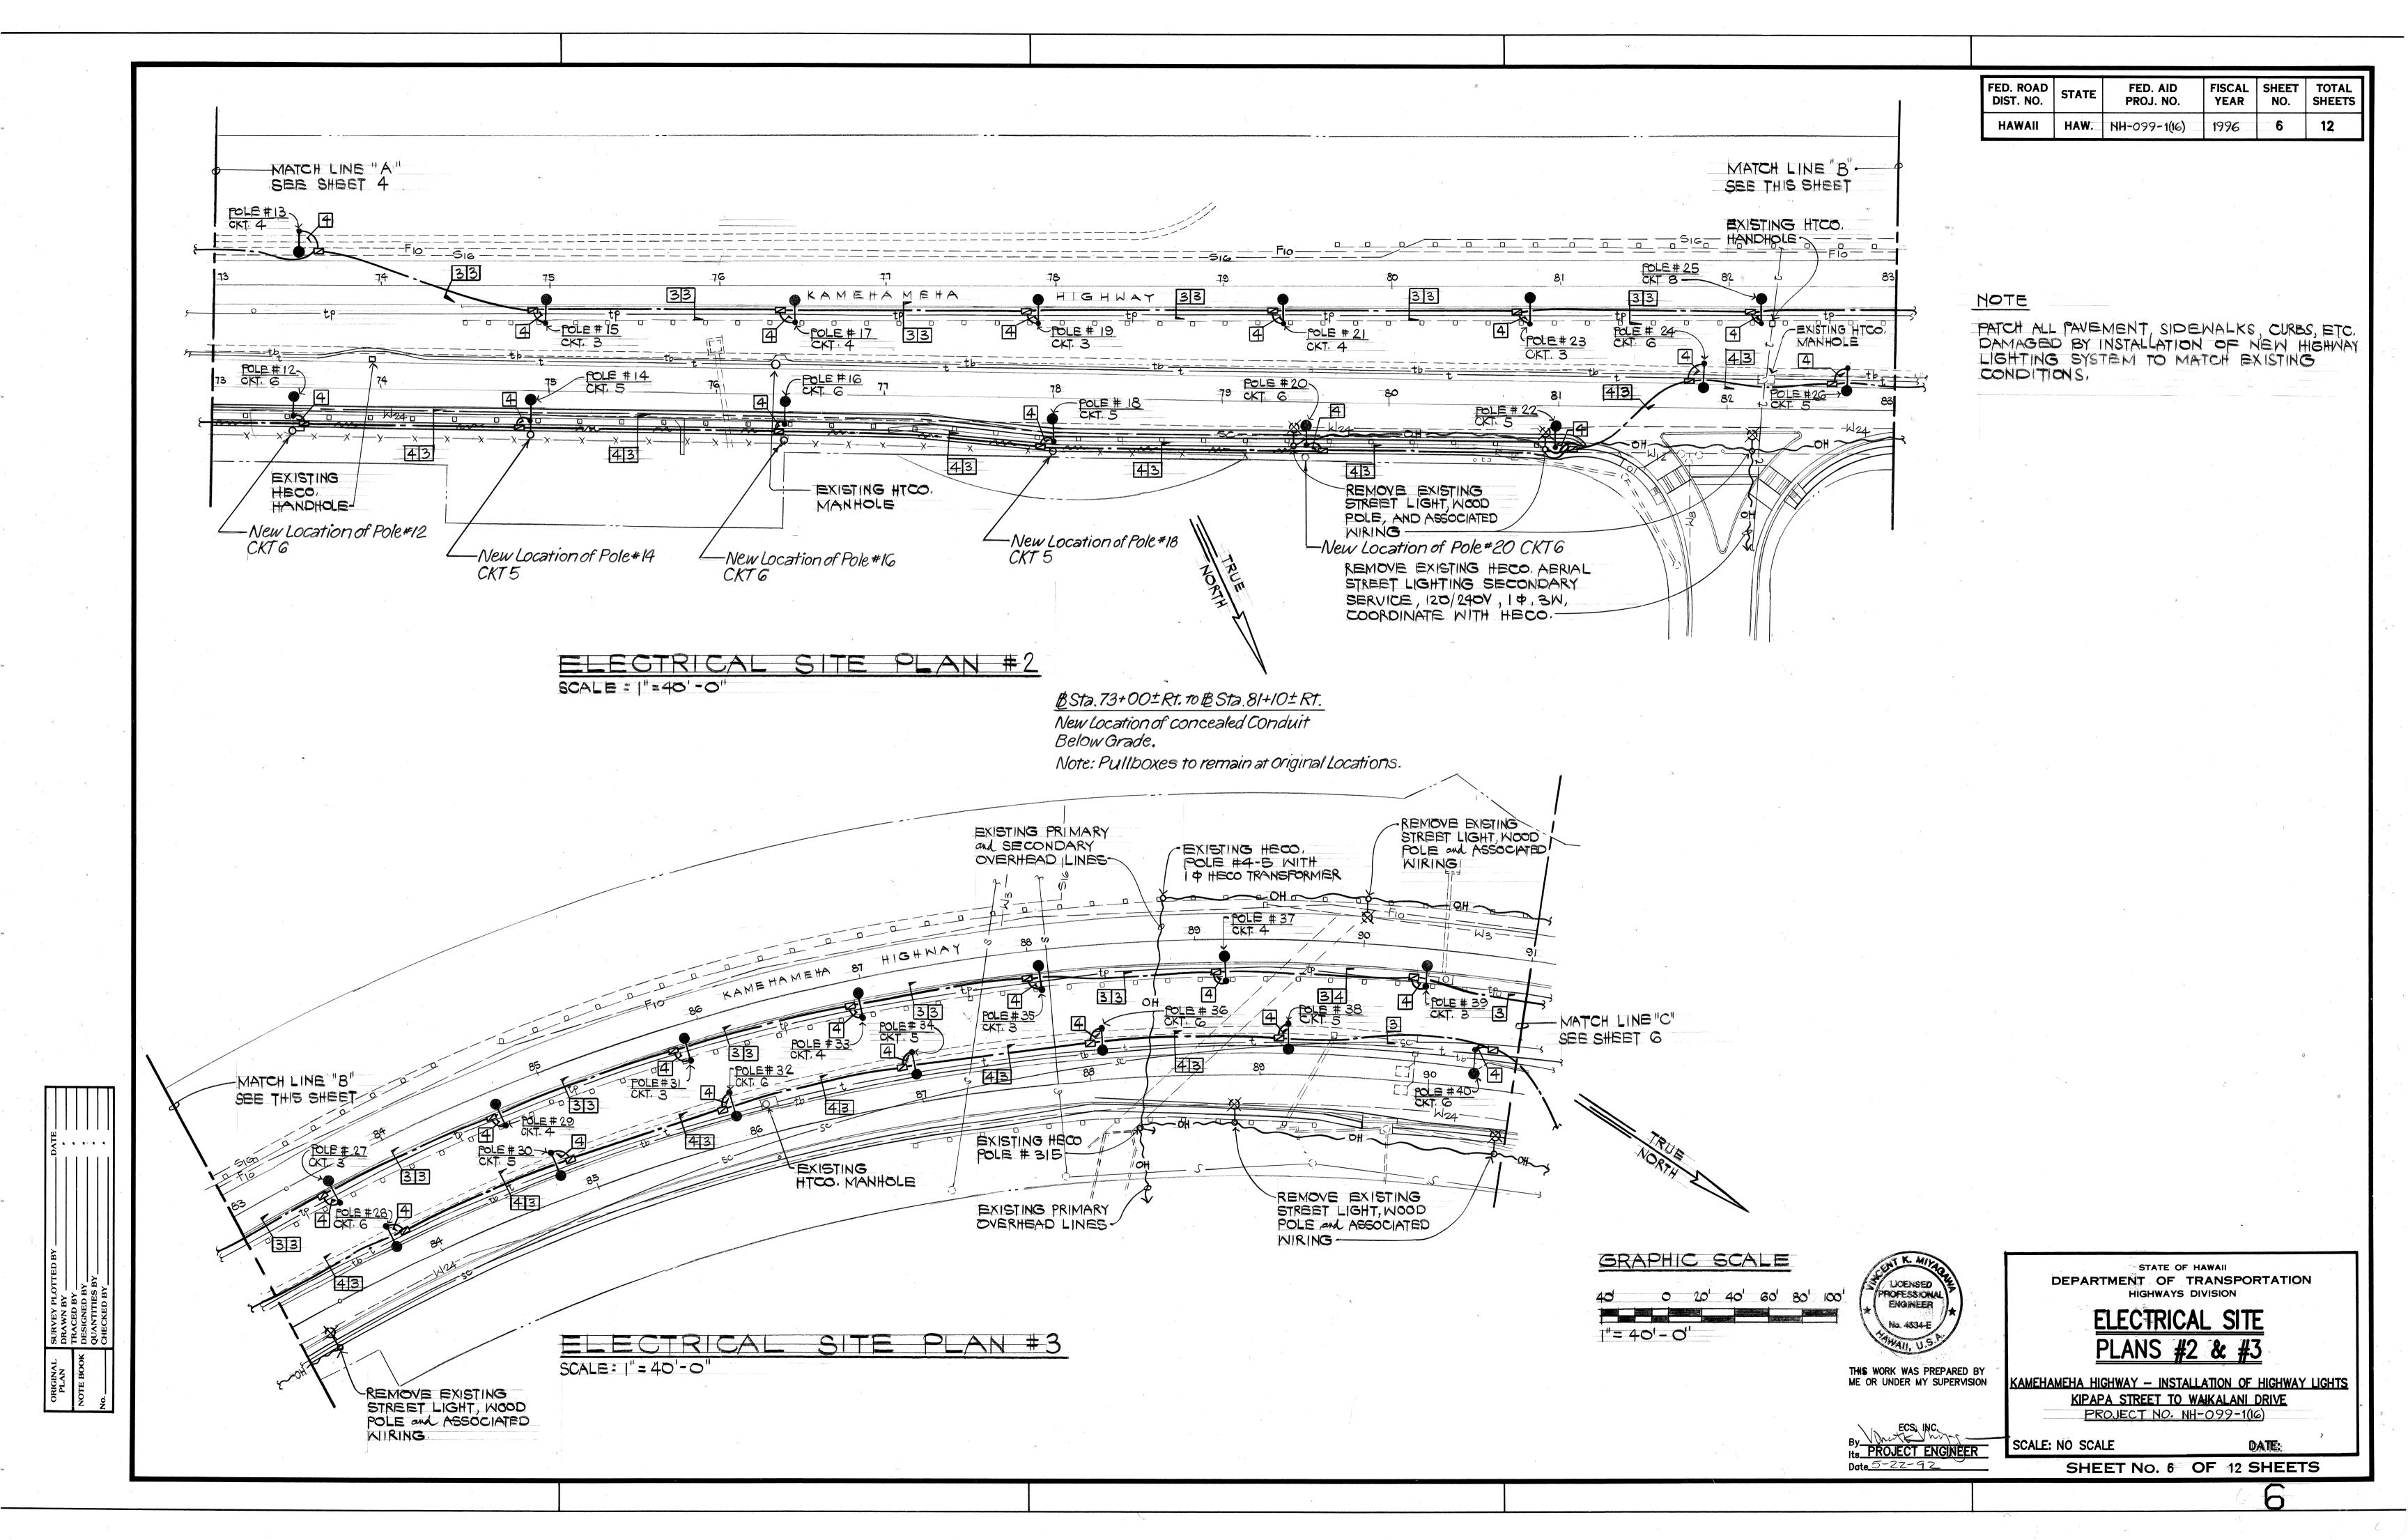

EXISTING HECO.

POLE 5/5

SCALE: |"= 40' - 0"

NOTES:

REMOVE EXISTING STREET LIGHT, WOOD POLE AND ASSOCIATED WIRING, IDENTIFIED ON PLAN BY """.

FED. ROAD	STATE	FED. AID	FISCAL	SHEET	TOTAL
DIST. NO.		PROJ. NO.	YEAR	NO.	SHEETS
HAWAII	HAW.	NH-099-1(16)	1996	and control on the control of the co	12

2 PATCH ALL PAVEMENT SIDEWALKS CURBS, ETC.
DAMAGED BY INSTALLATION OF NEW HIGHWAY
LIGHTING SYSTEM TO MATCH EXISTING CONDITIONS.

<u>.</u>		<u>.</u> 28	252 VOLTS, 1 PHASI	E, 2 W		•	
PANEL "			2P90A MAIN BREAKE	R			
anothis widen			SURFACE MOUNTED				
	<u>.</u>		10,000 MIN. AIC.				
CKT.	CKT.	BKR.	USE		LOAD VA)	WIRE	GND
No.	POLE	AMPS	v	A	В	SIZE	SIZE
1	2	30	HIGHWAY LIGHTS	0.7	0.7	4	8
2	2	30	HIGHWAY LIGHTS	1.1	1-1	4 ,	8
3	2	30	HIGHWAY LIGHTS	1.0	1.0	4	8
4	2	30	HIGHWAY LIGHTS	0.9	0.9	4	8
5	2	30	HIGHWAY LIGHTS	1.1	1.1	eon: 4 :-::s	~8
6	2	30	HIGHWAY LIGHTS	1.1	1.1	- 4	** 8 ***
7	2	30	HIGHWAY LIGHTS	0.9	0.9	4	-8
[.] 8	2	-30	HIGHWAY LIGHTS	0.9	0.9	4	8
9	2	20	CONTROL	0.1	0.1	12	12
10	2		PFB				
11	1		PFB				
12	1		PFB				
13	1		PFB				
14	1		PFB				
							Aller and the second se
			TOTAL LOAD/PHASE	7.8	7.8	r	
4 1			TOTAL LOAD	15.6 k	(VA		
Úř.			DEMAND FACTOR	1.0		•	
			DEMAND LOAD	15.6 K	(VA		

GRAPHIC SCALE

40' 0 20' 40' 60' 80' 100'

LIOENSED PROFESSIONAL ENGINEER **

No. 4534-E

MAII, U.S.A.

DEMAND AMPS

THIS WORK WAS PREPARED BY

By PROJECT ENGINEER

Date 5 22 9 2

STATE OF HAWAII
DEPARTMENT OF TRANSPORTATION
HIGHWAYS DIVISION

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ELECTRICAL SITE

MEHAMEHA HIGHWAY - INSTALLATION OF HIGHWAY LIGHT KIPAPA STREET TO WAIKALANI DRIVE PROJECT NO. NH-099-1(16)

SCALE: NO SCALE 0

NO SCALE O" DATE:
SHEET NO. 7 OF 12 SHEETS