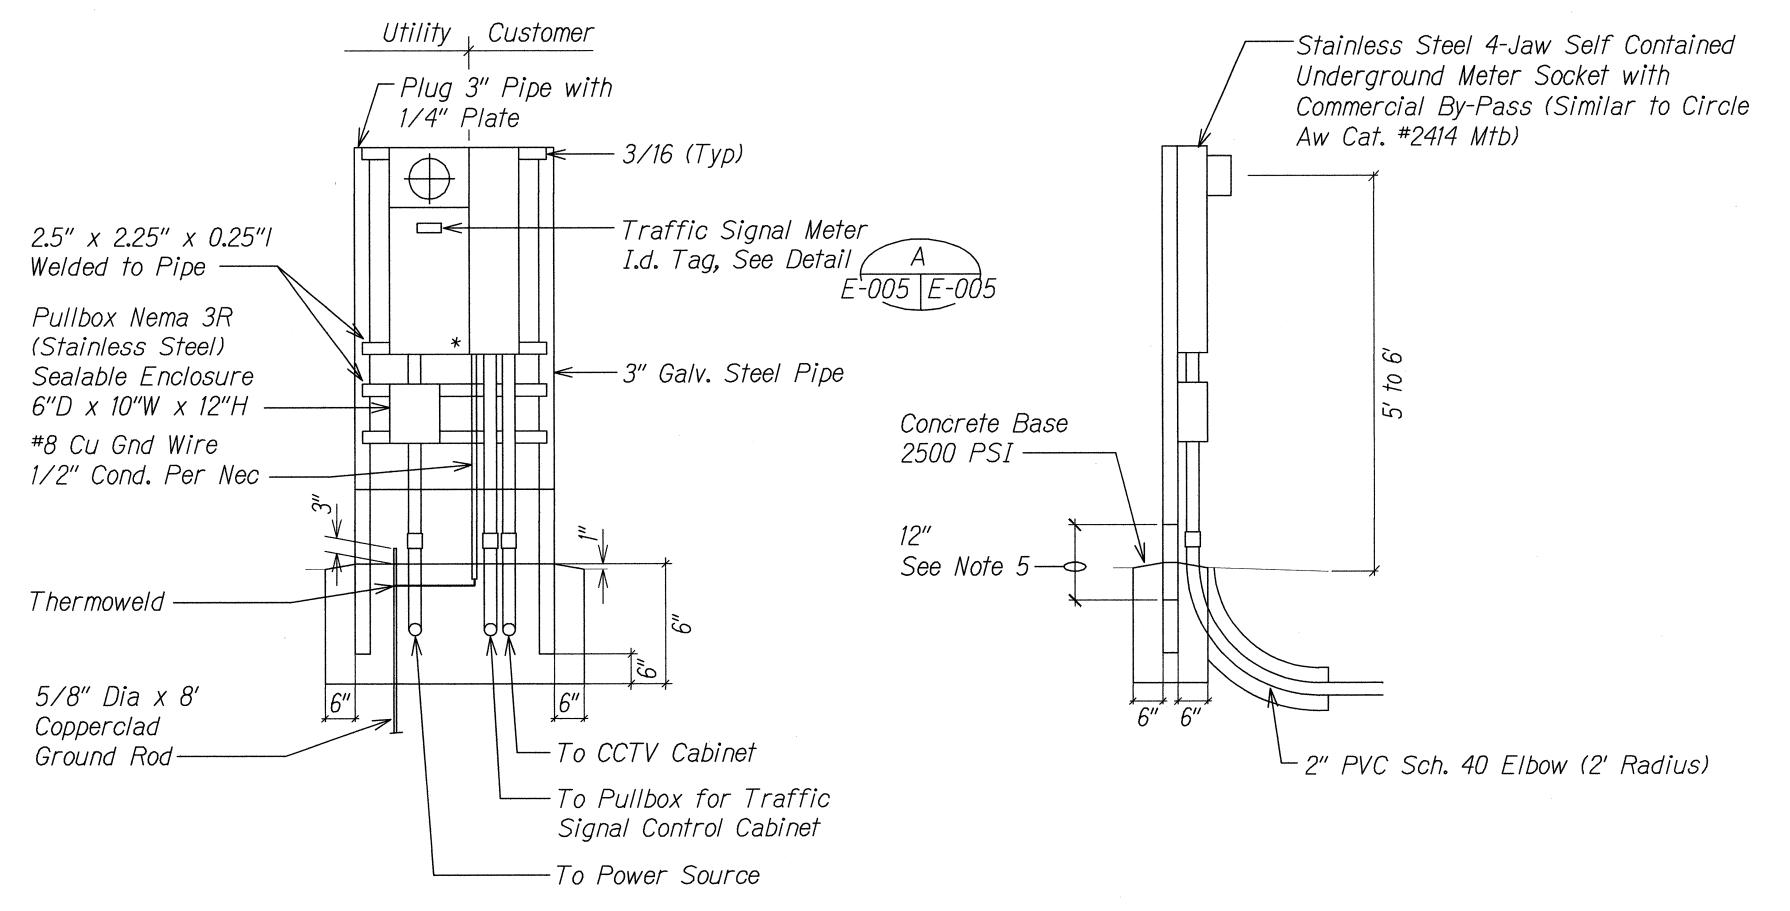




NOTES:

- 1. Use 3-Ply Laminated Flexible Plastic, Black-White-Black Tickness: Black Cap Sheet - 0.010", White Base Sheet -0.052", Black Base Sheet - 0.010".
- 2. Attach to Meter Box Using Scotch 3M Brand Very High Bond (VHB) Double Coated Acrylic Foam Tape or Equivalent.
- 3. Letters/Numbers Shall be 1/16" Stroke, (White in Color).
- 4. Leters/Numbers Shall be Inscribed by Cutting Through "Black Cap Sheet" to Expose White Letters/Numbers.


FED.ROAD DIST.NO.	STATE	PROJ. NO.	FISCAL YEAR	SHEET NO.	TOTAL SHEETS
OAHU	HAW.	99C-01-13	2014	37	41



METER PEDESTAL FOR UNDERGROUND SERVICE ELECTRICAL SERVICE DETAIL

NOTES:

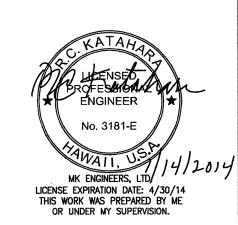- 1. Pedestal Shall be Hot Dipped Galvanized After Fabrication.
- 2. All Fastening Bolts, Nuts, and Washers Shall be Stainless Steel.
- 3. Provide 4 Ft. Clearance in Front of Meter.
- 4. * Denotes Sealable, Nema 3R.
- 5. Coat Portion of Post 6" Above \$ Below Conc Foundation with Two Coats Asphaltic Based Paint or Tape with Electrical Tape, Half Lapped.




STATE OF HAWAII DEPARTMENT OF TRANSPORTATION HIGHWAYS DIVISION


METER DETAILS

TRAFFIC OPERATIONAL IMPROVEMENTS AT VARIOUS LOCATIONS Vicinity of Kamehameha Highway and

<u>Lumiaina Street</u> <u>Project No. 99C-01-13</u> Scale: As Noted Date: Jan 2014

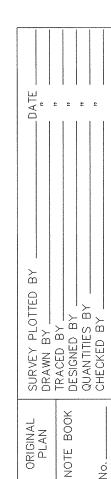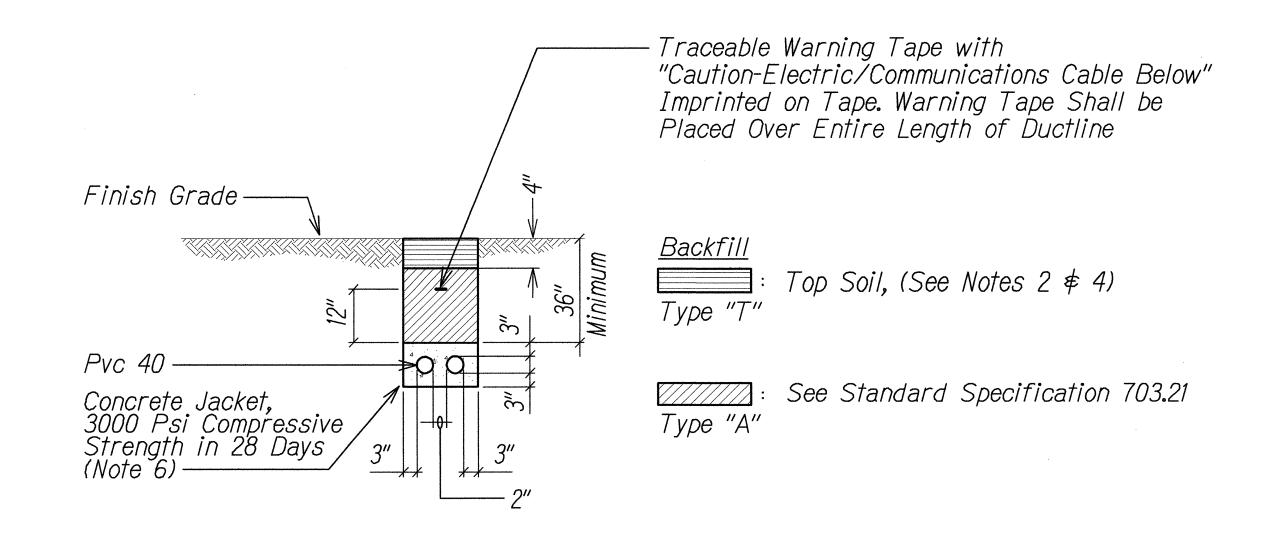SHEET No. E-005 OF 9 SHEETS







A TYPICAL DUCT SECTION FOR UNPAVED AREA E-006 E-006 NTS

NOTES:

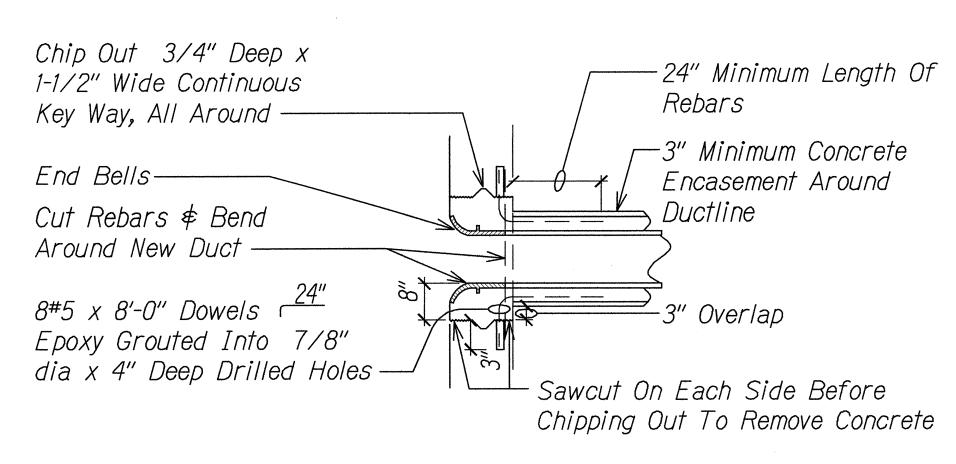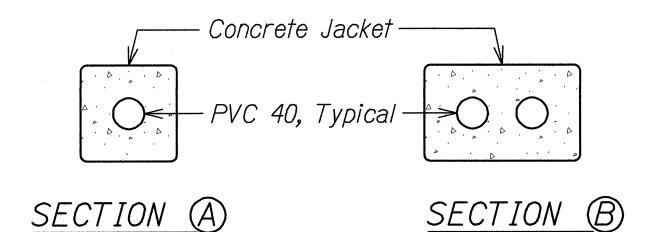- 1. Provide 2" Separation Between Ducts of Same System and 3" Between Ducts of Different Systems.
- 2. Where Trench Encounters Grass or Landscaping, Provide 4" Top Soil After Trench is Backfilled, and Restore Landscaping to Match Existing Adjacent Areas.
- 3. See Duct Section Details for Conduit Arrangement.
- 4. Where Trench Encounters Existing Concrete Sidewalk, Sidewalk Shall be Demolished. Backfill, Compact and Replace Sidewalk to Match Existing. Omit Top Soil in Trench Restoration and Provide Minimum 4" Thick Concrete Sidewalk to Match Oringinal Finish. Replace Entire Width of Sidewalk so that there is No Evidence that a Duct was Installed Below the Sidewalk.
- 5. For Trenching in AC Pavement Roadway the Minimum Required Depth is 36" to Top of Duct. For Trenching in All Other Areas, the Minimum Required Depth is 34" to Top of Duct.
- 6. Provide PVC 80 Conduit Where Concrete Jacket is Not Indicated on Duct Section Details.
- 7. See State Highway Standard Plan TE-36 for Trench Details at Asphalt Concrete Pavement Areas.
- 8. Refer to Civil Drawings for Trench Restoration Details.








DUCT SECTION DETAILS

NIS

NOTES:

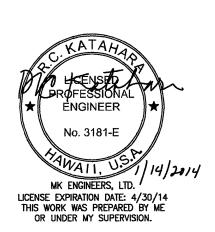- 1. See Standard Plan TE-36 for Trench Details in Asphalt Concrete Paved Areas.
- 2. See Details on this Sheet for Trench Details in Non-Traffic Areas.



STATE OF HAWAII
DEPARTMENT OF TRANSPORTATION
HIGHWAYS DIVISION

DUCT SECTION

TRAFFIC OPERATIONAL IMPROVEMENTS

AT VARIOUS LOCATIONS

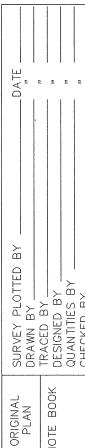
Vicinity of Kamehameha Highway and

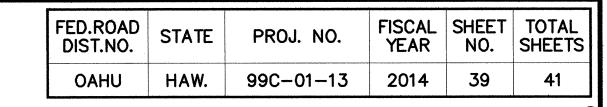
Lumiaina Street

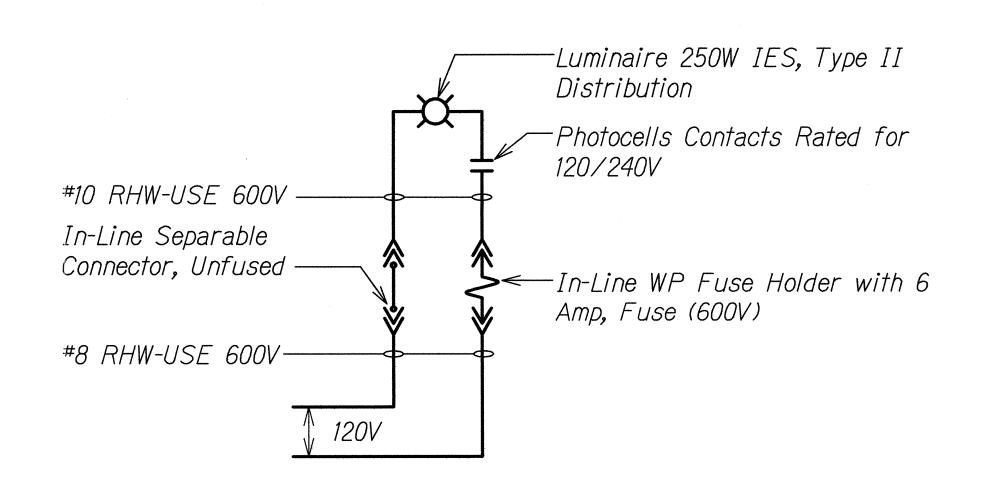
Project No. 99C-01-13

Scale: As Noted Date: Jan 2014

SHEET No. E-006 OF 9 SHEETS









NOTES:

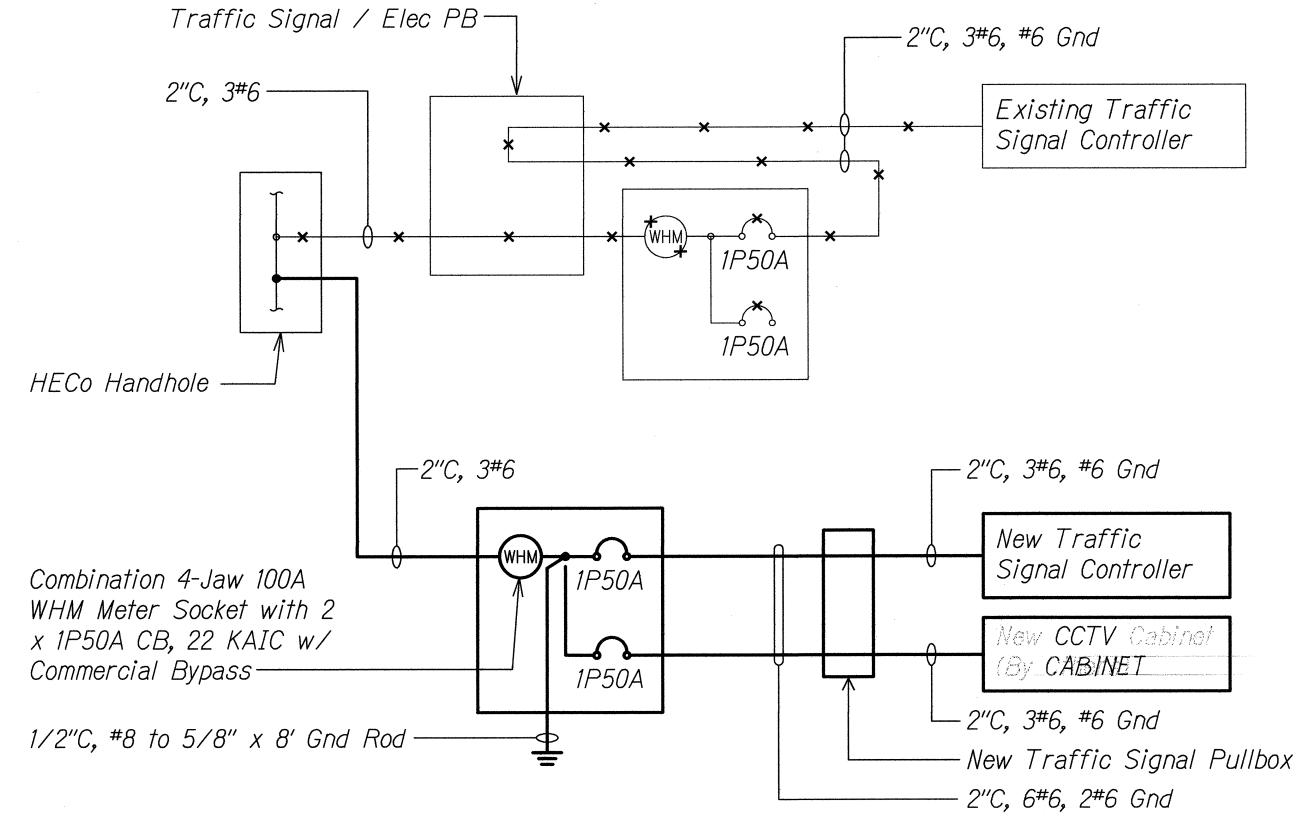All Neutral Conductors Must Have White Insulation. Any Other Method of Identification is Unacceptable.





ONE-LINE DIAGRAM

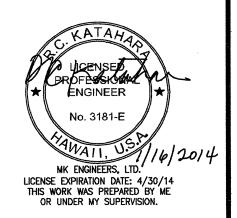

STATE OF HAWAII DEPARTMENT OF TRANSPORTATION HIGHWAYS DIVISION

ONE-LINE DIAGRAMS

TRAFFIC OPERATIONAL IMPROVEMENTS

AT VARIOUS LOCATIONS

Vicinity of Kamehameha Highway and

Lumiaina Street

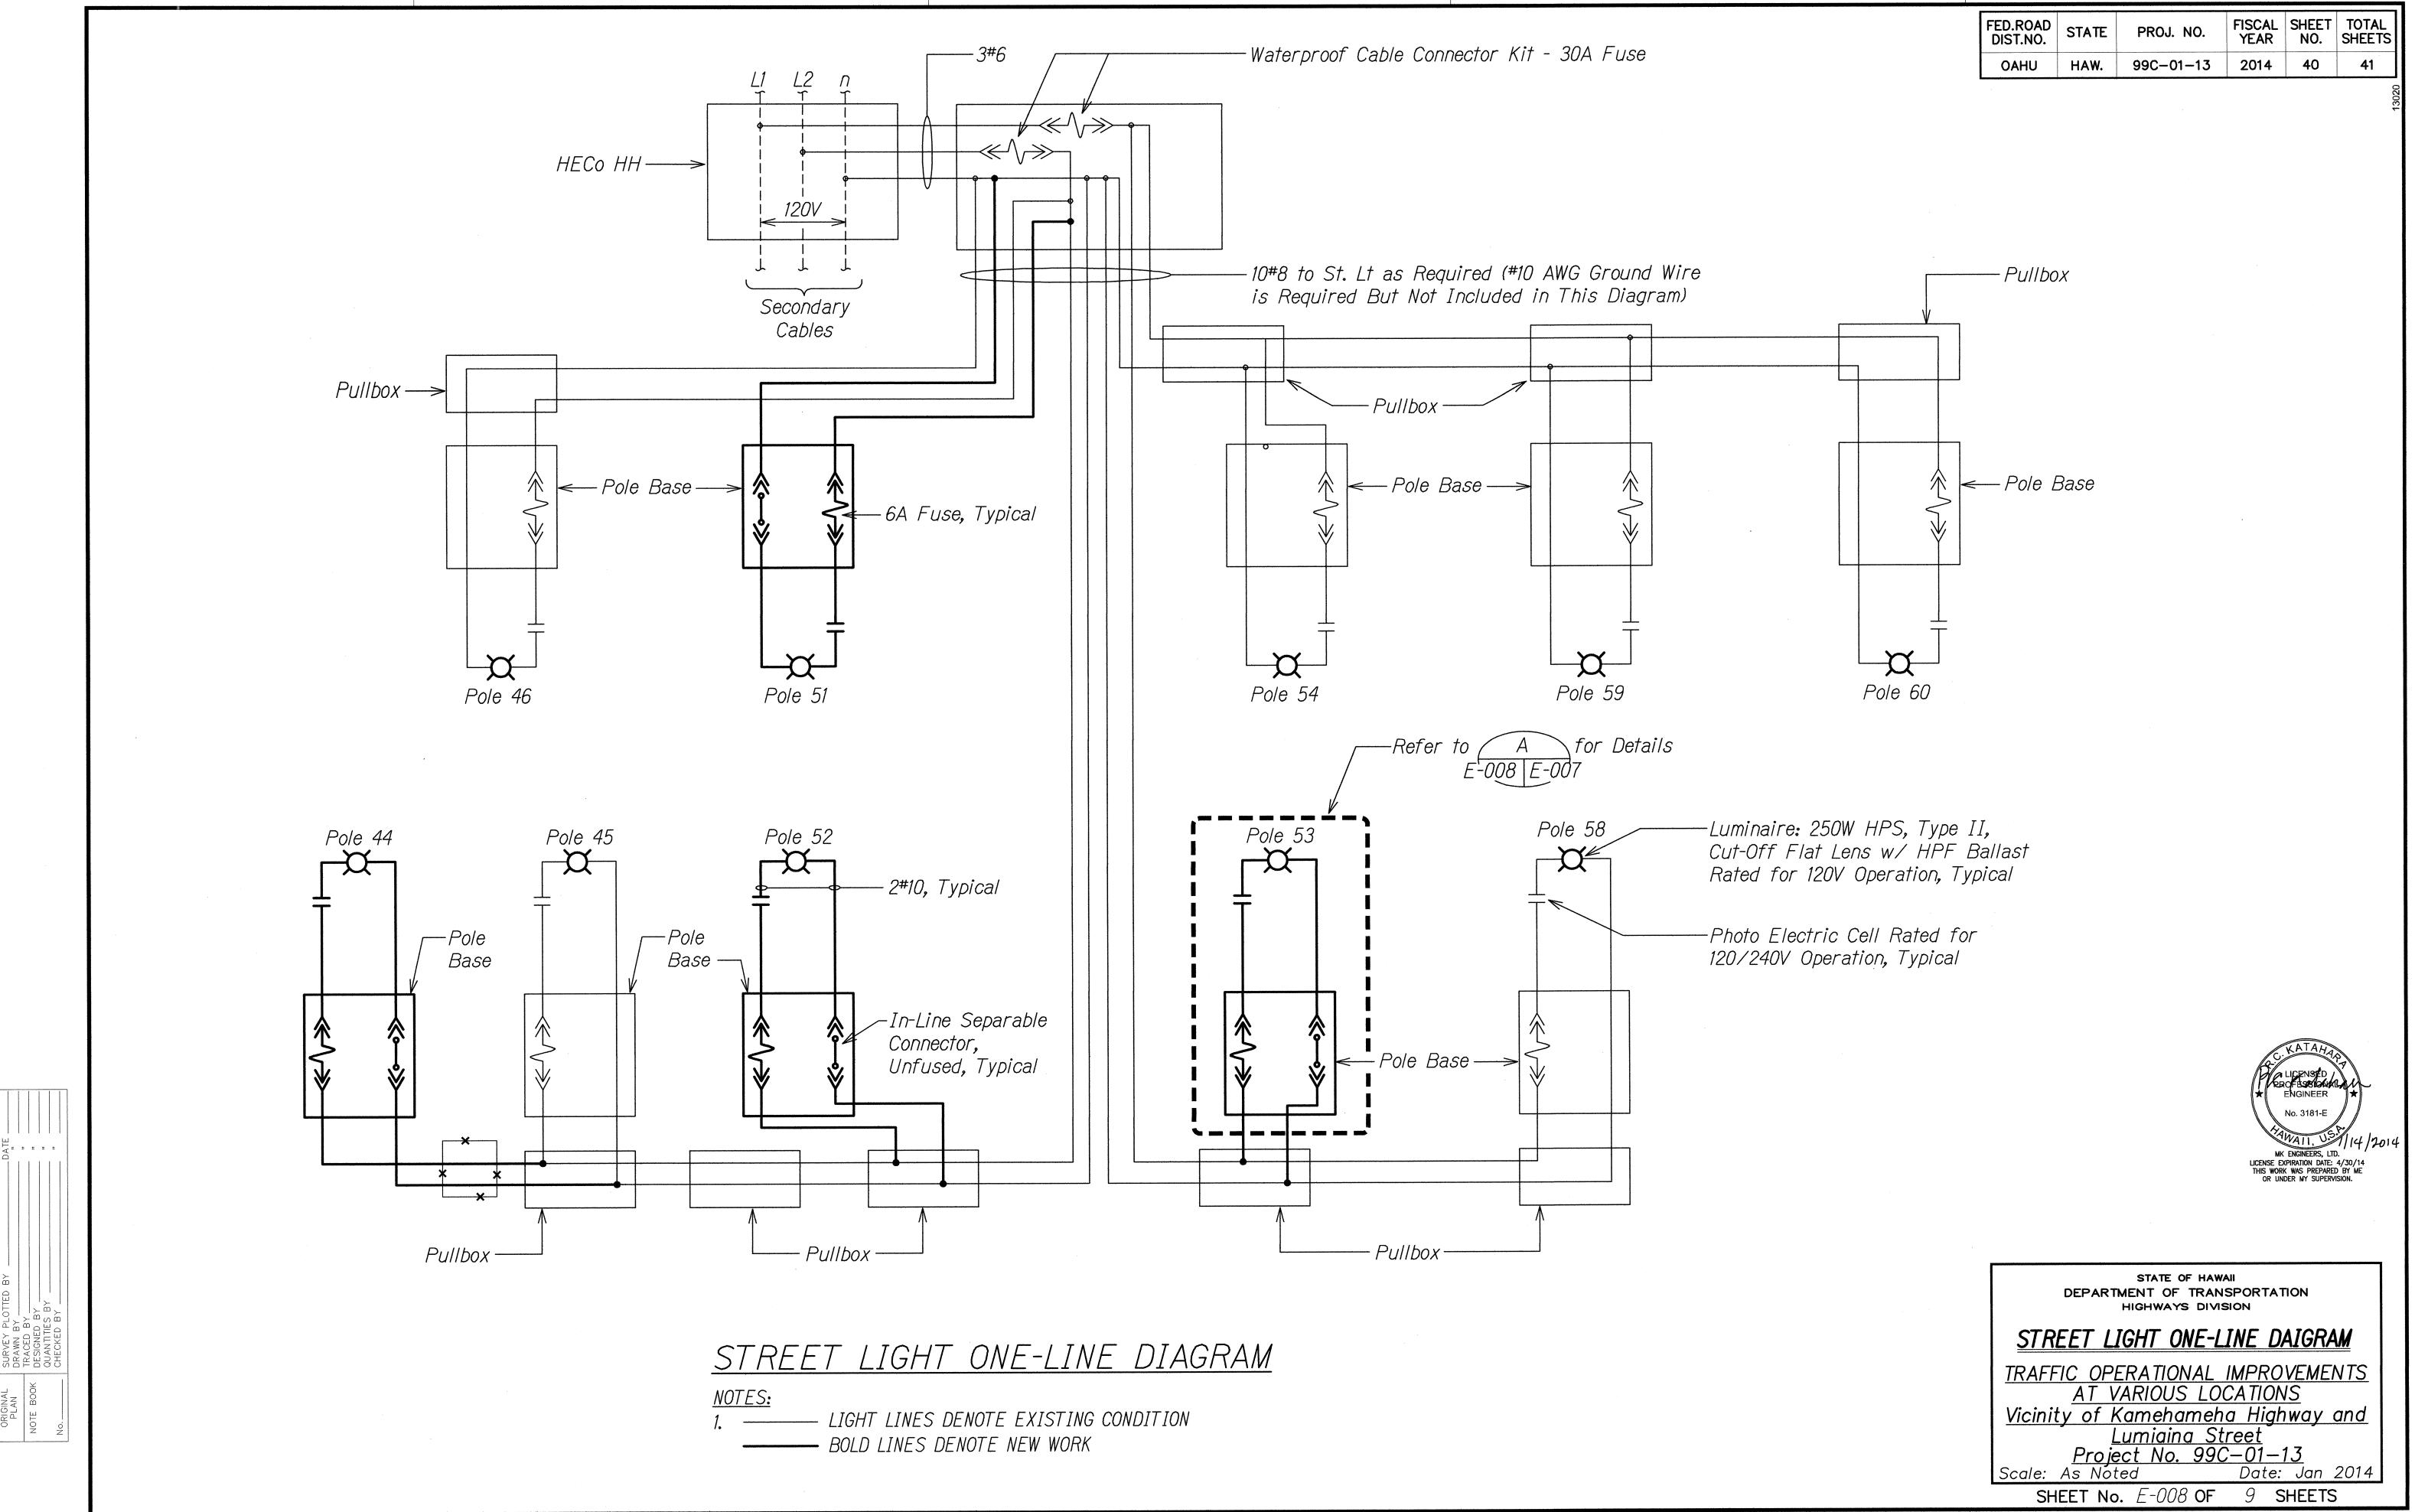
Project No. 99C-01-13

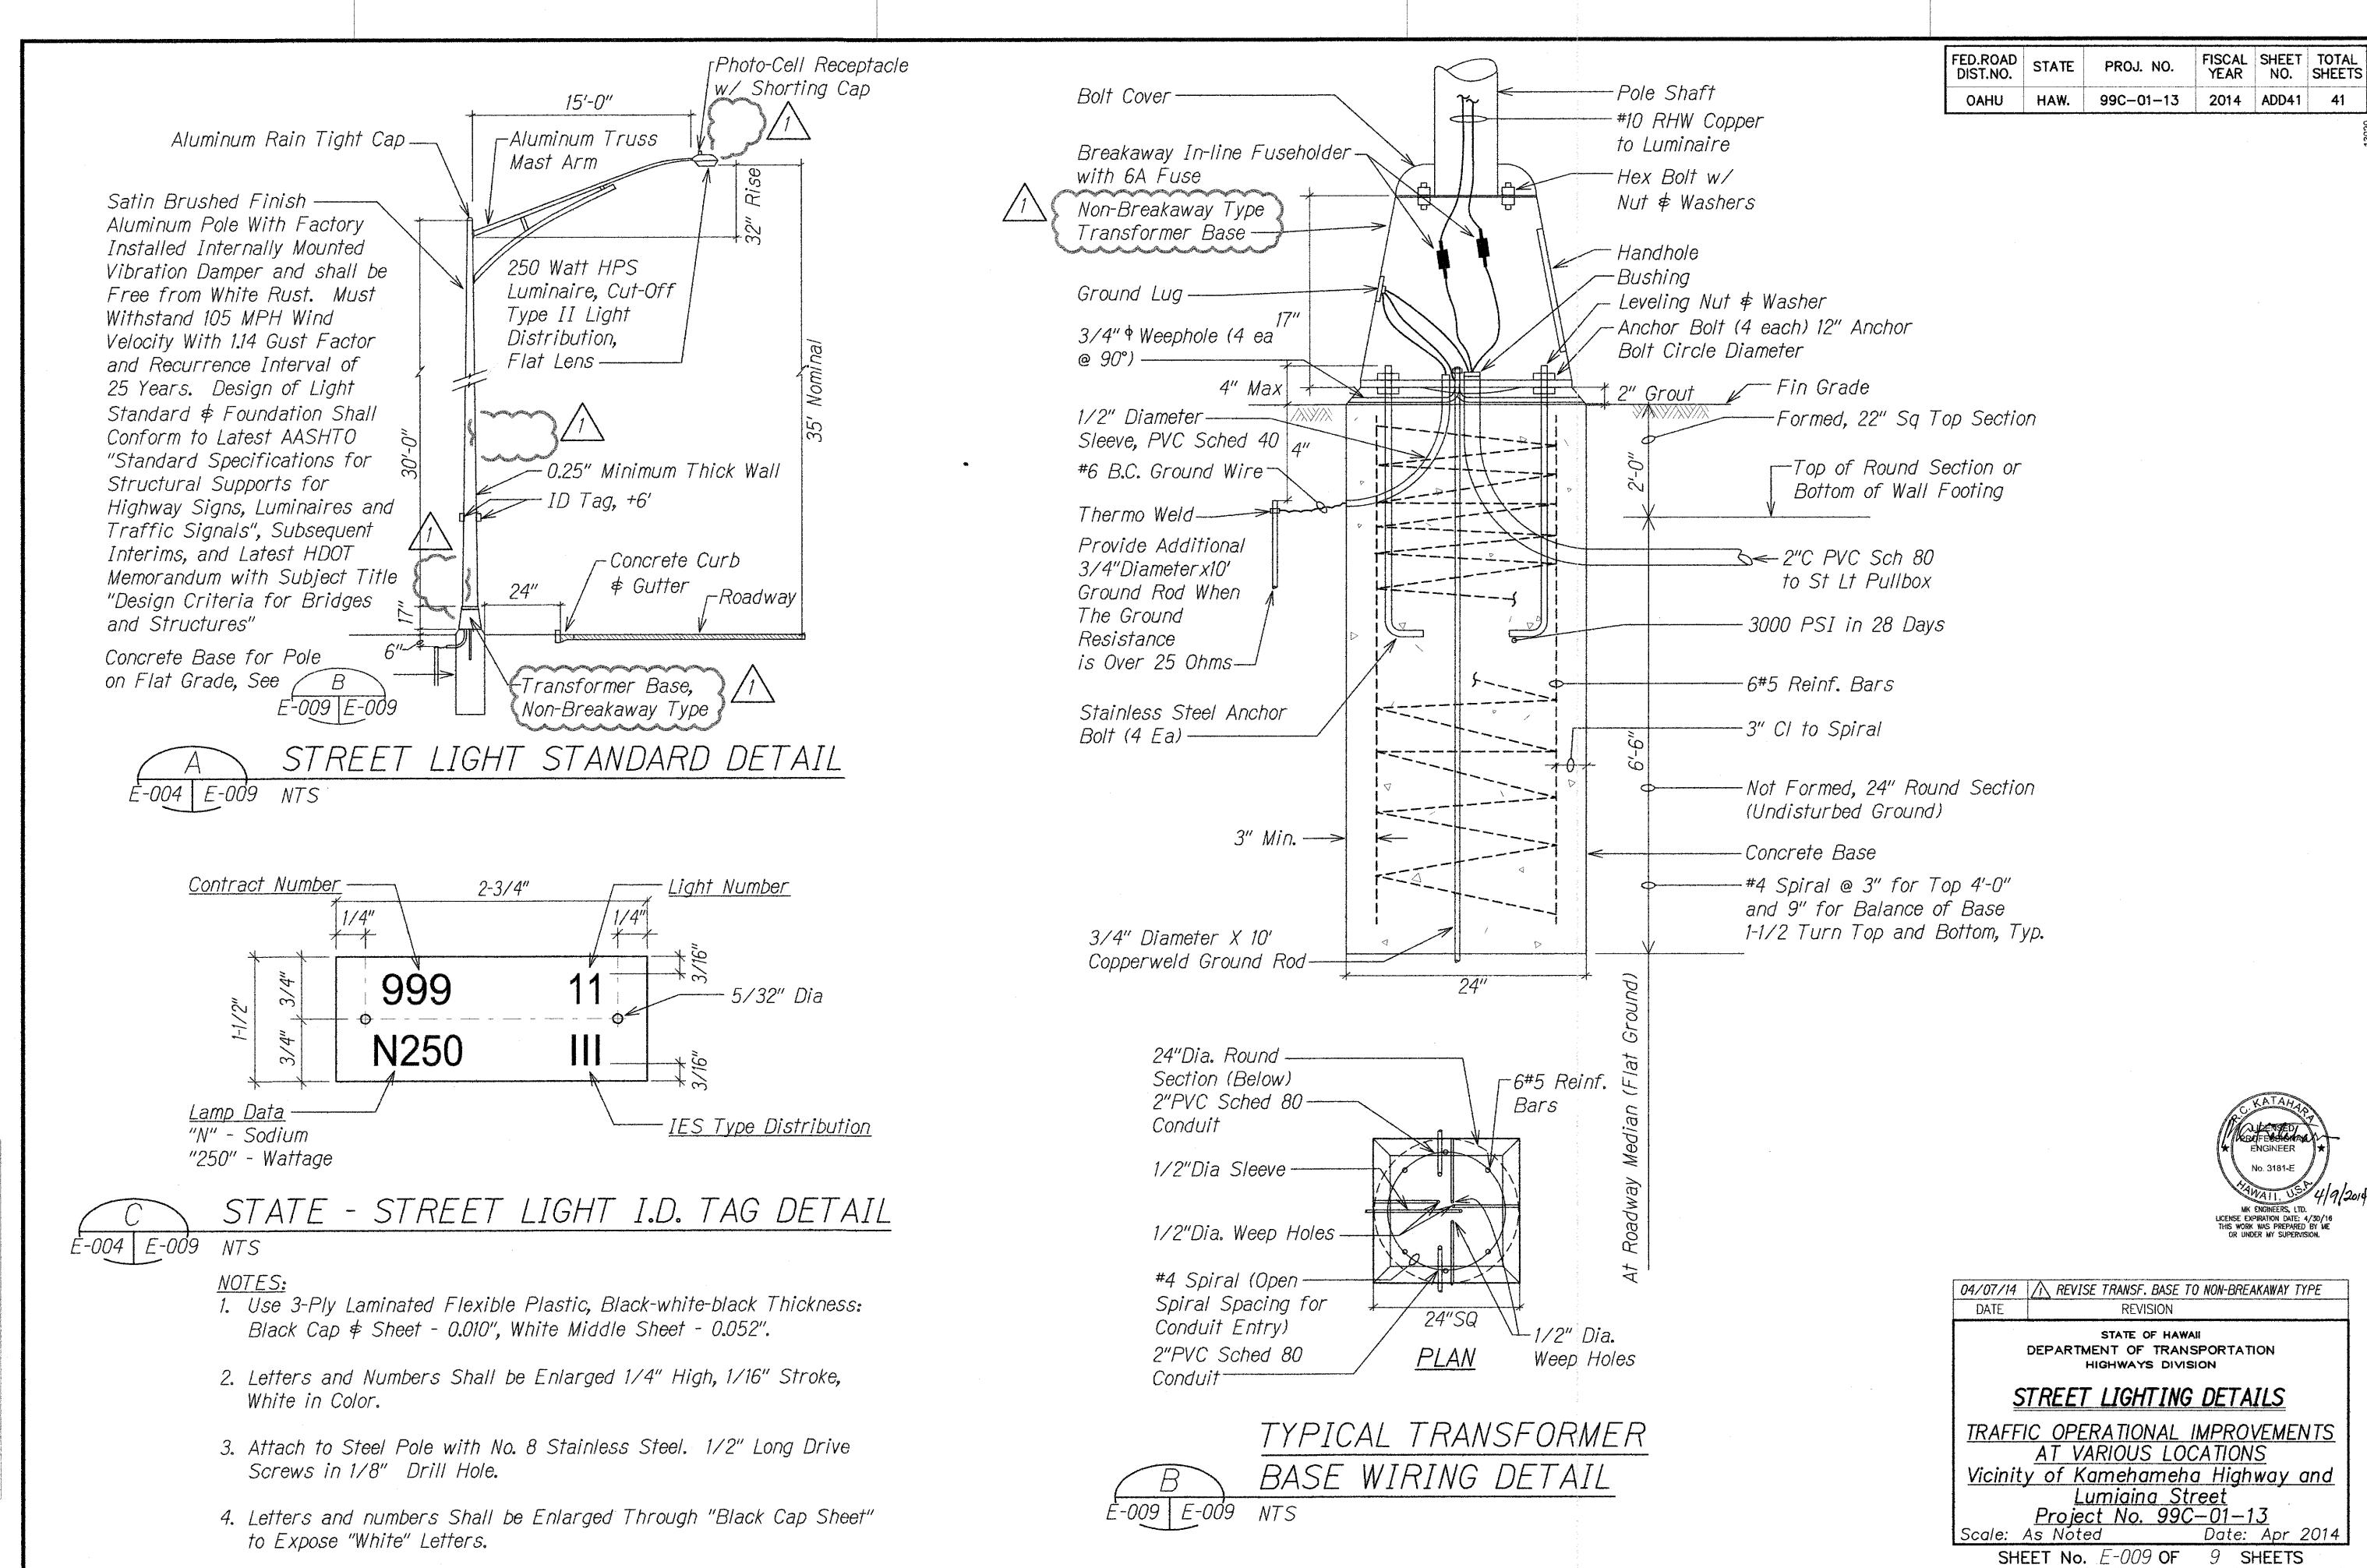
Scale: As Noted Date: Jan 2014

SHEET No. E-007 OF 9 SHEETS



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