


SCALE:

GRAPHIC SCALE

ELECTRICAL SITE PLAN

SCALE: 1"=20'-0"

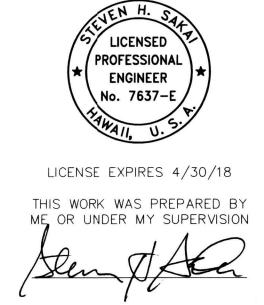


STATE OF HAWAII
DEPARTMENT OF TRANSPORTATION
HIGHWAYS DIVISION ELECTRICAL SITE PLAN


VINEYARD BOULEVARD TRAFFIC SIGNALS AT RIVER STREET PROJECT NO. 98A-01-15 Scale: AS NOTED

Date:Aug. 2017 SHEET No. E-4 OF 6 SHEETS

38

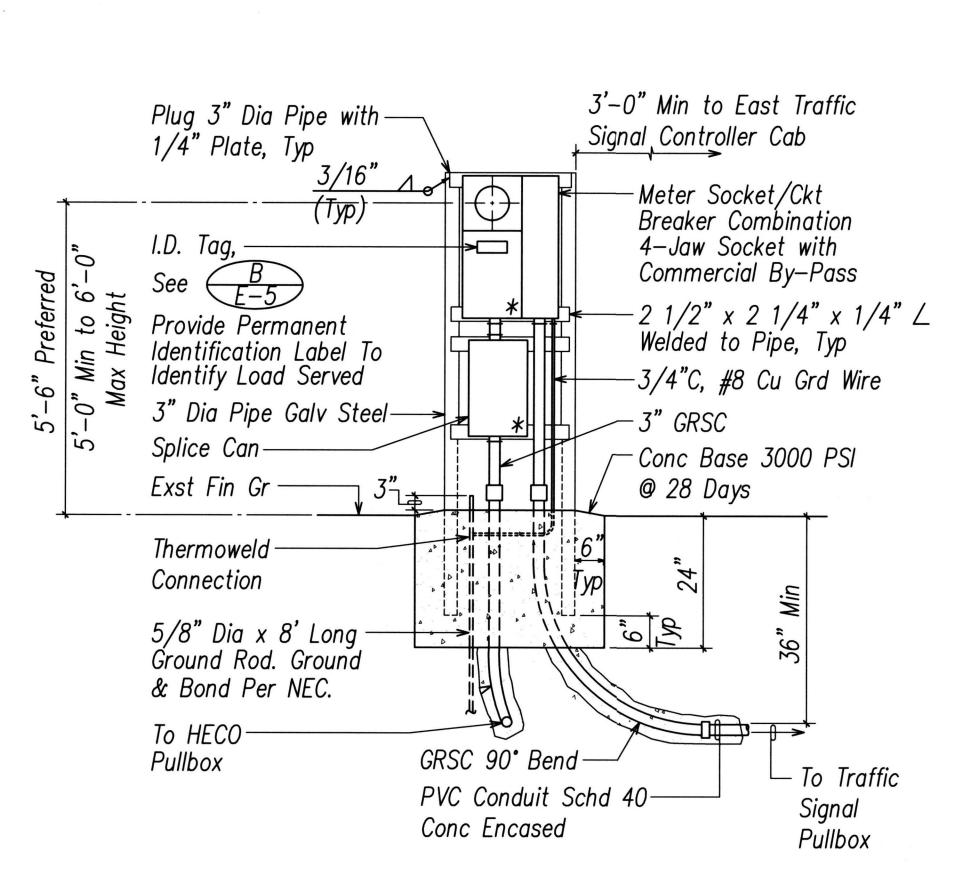


FRONT ELEVATION

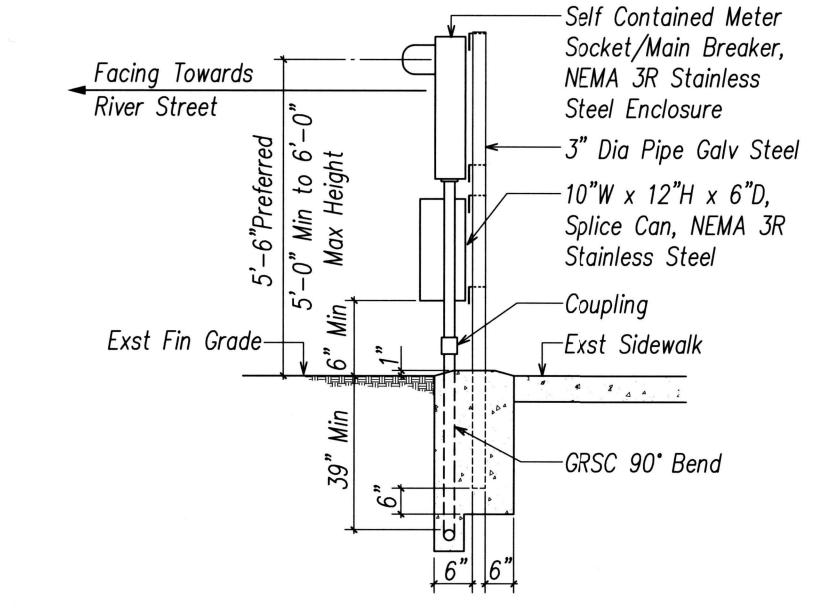


SIDE ELEVATION

METER SOCKET DETAIL (PEDESTAL)

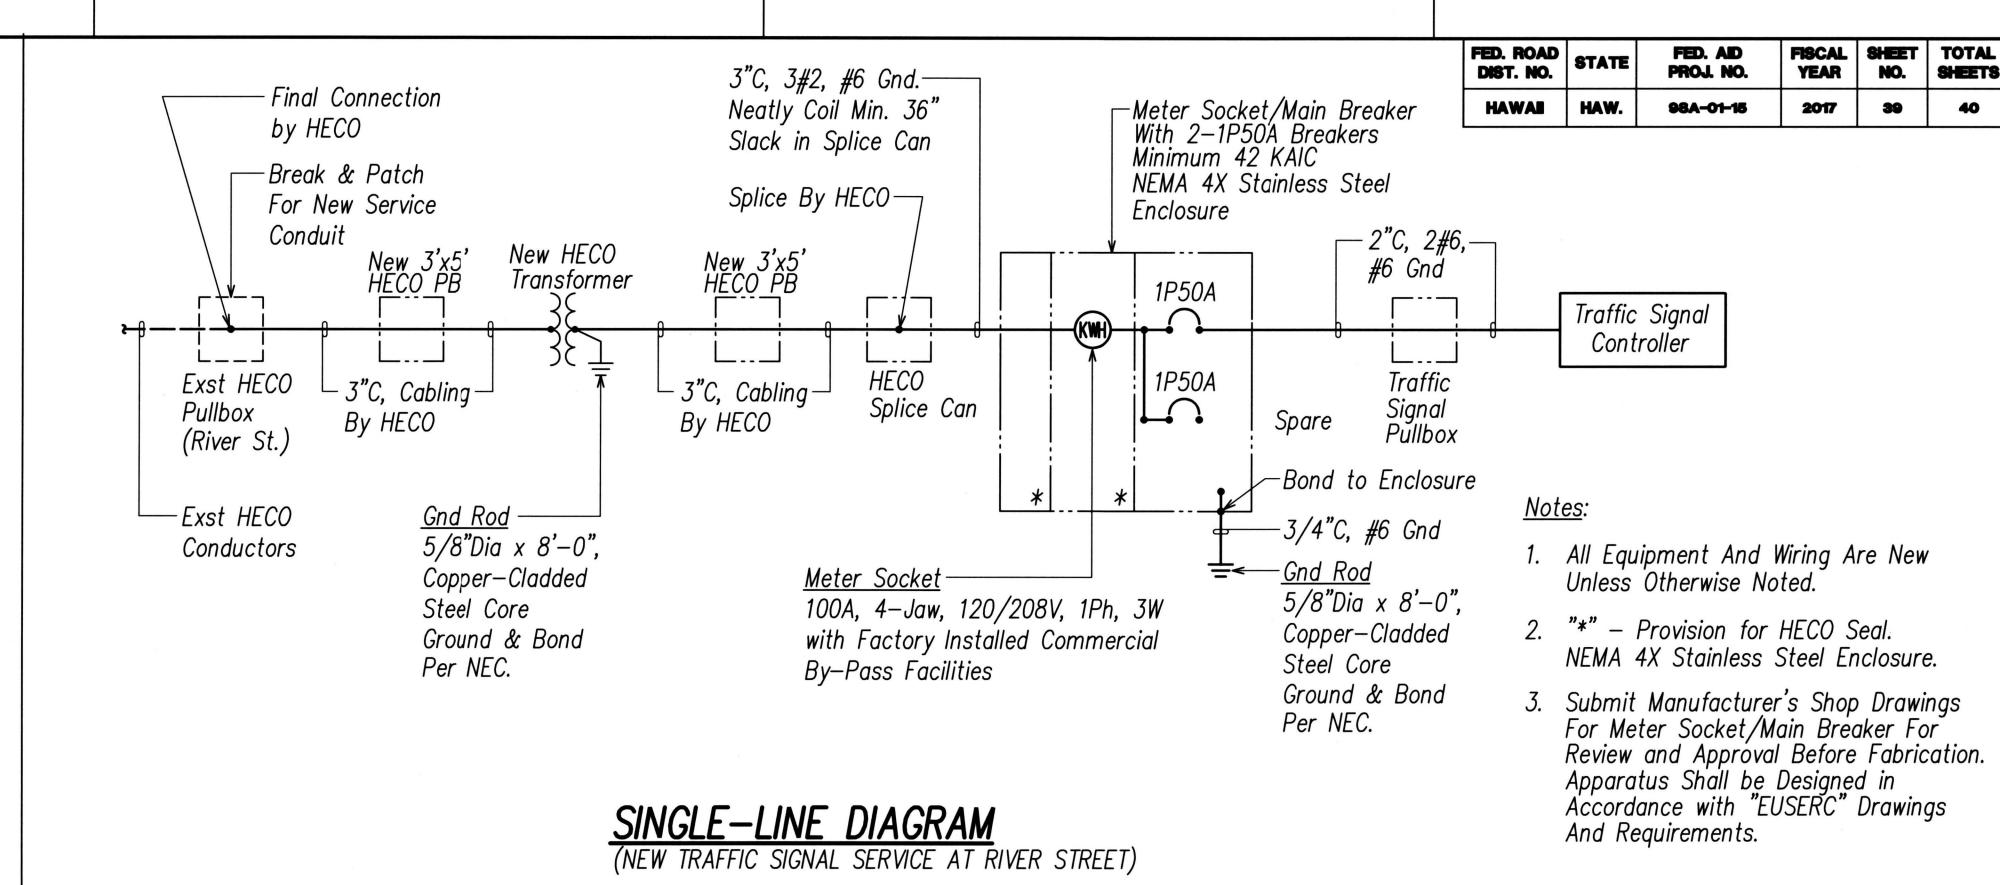

<u>Notes:</u>

- Contractor shall Make All Electrical Connection to Traffic Counting Station Cabinet, Provide 2-1P50A Breaker, Ground and 2" Conduit.
- 2. All Conduits to Contain a Polyolefin Pull Line. (Jet Line Cat #232 or Equiv)
- Pedestal shall be Hot-Dipped Galvanized After Fabrication.
- 4. All Fastening Bolts, Nuts & Washers shall be Stainless Steel. Provide One Coat Shop Primer & Two Coats of Acrylic Enamel Finish, Color to Match Traffic Signal Controller Cabinet.
- 5. Provide A Minimum Of 4 Feet Clear And Level Workspace Clearance In Front of Metering And Service Equipment.
- * Provision for HECO Seal. NEMA 3R Stainless Steel Enclosure.
- 7. At Time Of Installation, Provide And Install Meter Socket Covers (Plastic) And Bands For All Blank Meter Sockets. Identify Covers So They Can Be Returned.
- Provide Barrier Posts for Protection of Meter and Service Equipment Should Equipment have Vehicular Contact Exposure.

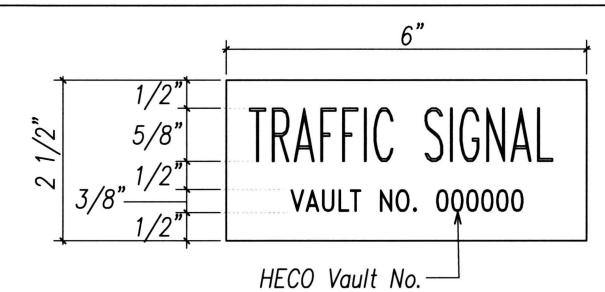

Notes:

- Use 3-Ply Laminated Flexible Plastic, Black-White-Black Thickness: Black Cap Sheet-0.010", White Base Sheet-0.052", Black Base Sheet-0.010".
- 2. Attach to Meter Socket Using Scotch 3M Brand Very High Bond (VHB) Double Coated Acrylic Foam Tape or Equivalent.
- 3. Letters/Numbers shall be 1/16" Stroke, (White in Color).
- Letters/Numbers Area Inscribed by Cutting through "Black Cap Sheet" to Expose White Letters/Numbers.





LICENSE EXPIRES 4/30/18 THIS WORK WAS PREPARED BY ME OR UNDER MY SUPERVISION SINGLE LINE DIAGRAM AND MISCELLANEOUS DETAILS

STATE OF HAWAII DEPARTMENT OF TRANSPORTATION

VINEYARD BOULEVARD TRAFFIC SIGNALS AT RIVER STREET PROJECT NO. 98A-01-15

Scale: AS NOTED Date: Aug. 2017 SHEET No. E-5 OF 6 SHEETS

Date

Hawaiian Electric Company

APPROVALS:

39