




FED. ROAD DIST. NO.	STATE	FED. AID PROJ. NO.	FISCAL YEAR	SHEET NO.	TOTAL SHEETS
HAWAII	HAW.	93B-01-11	2012	11	38

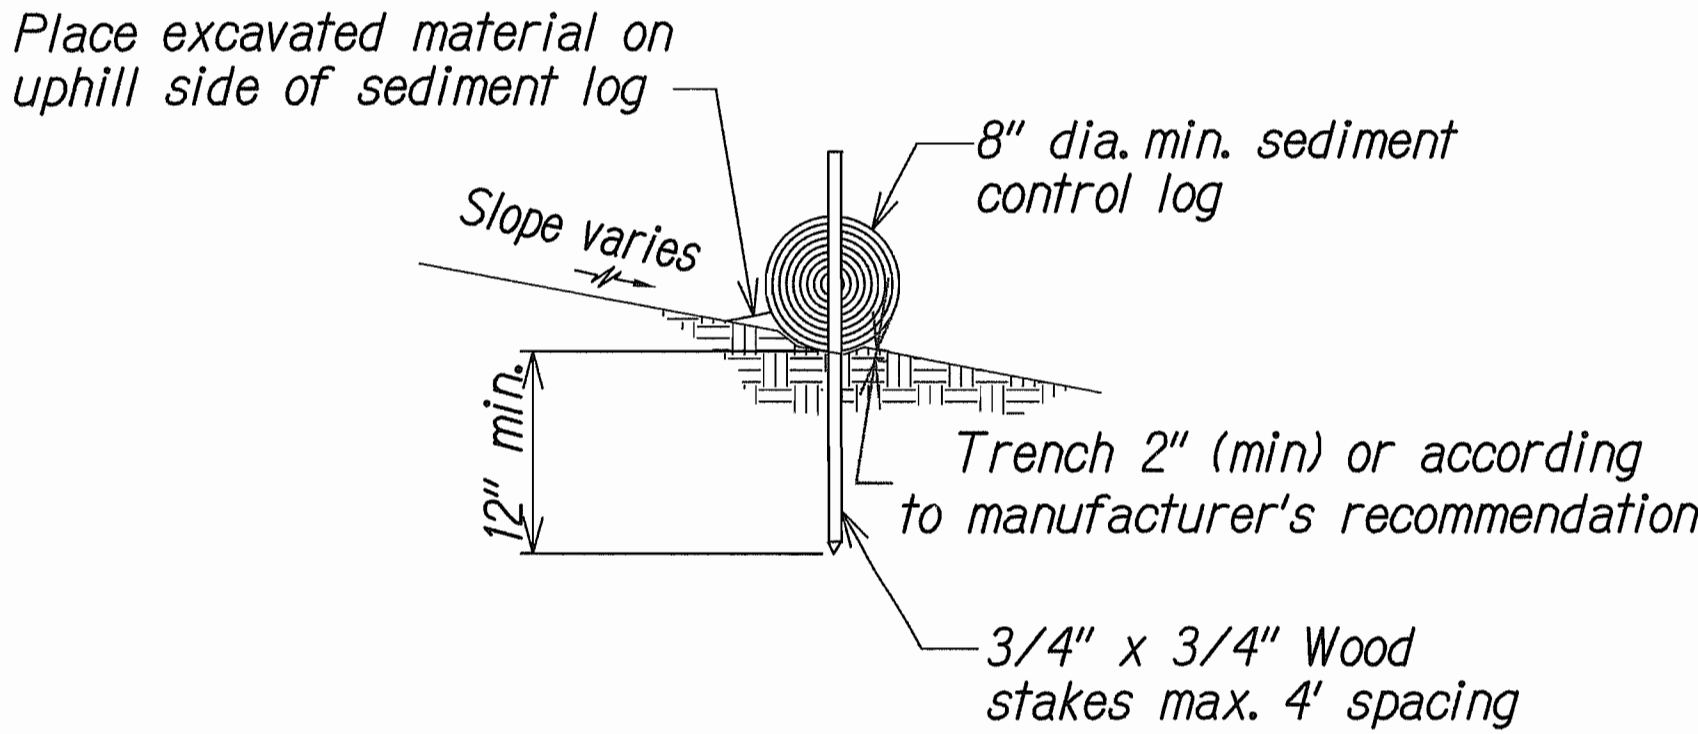

SECTION B-B STAKE DETAIL

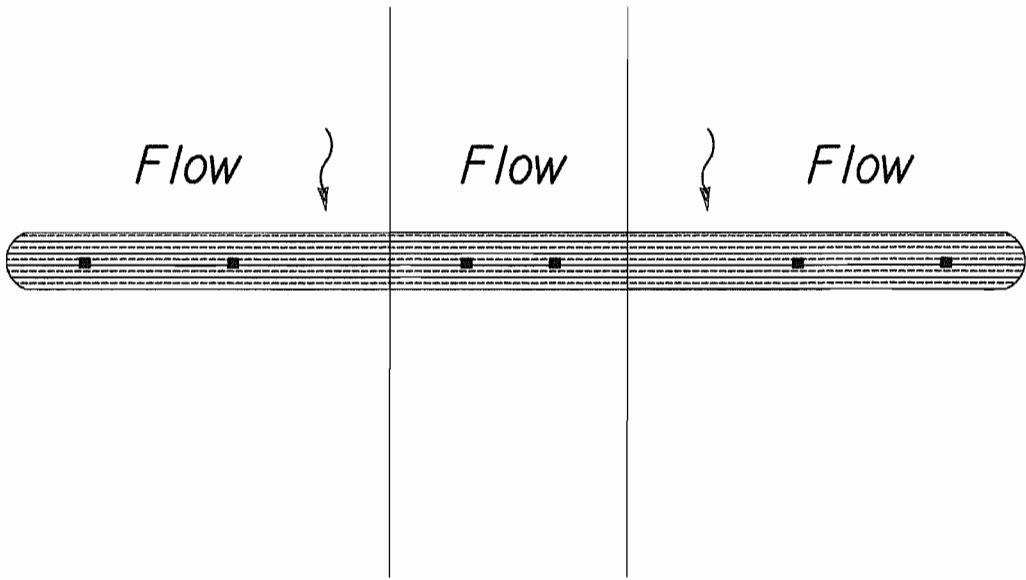


PLAN

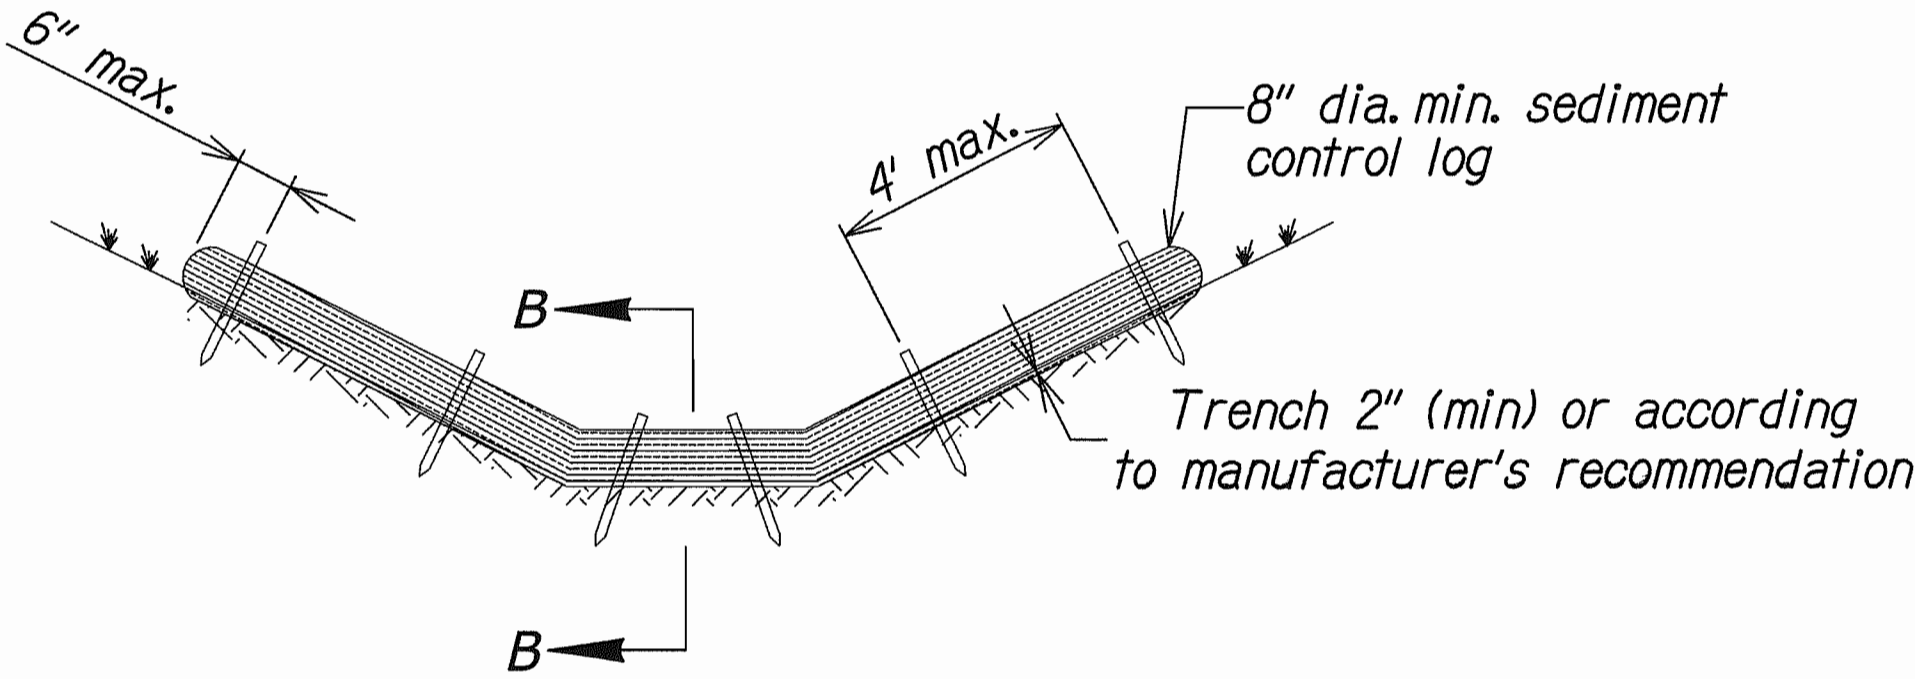


ELEVATION


EROSION CONTROL LOG DETAIL

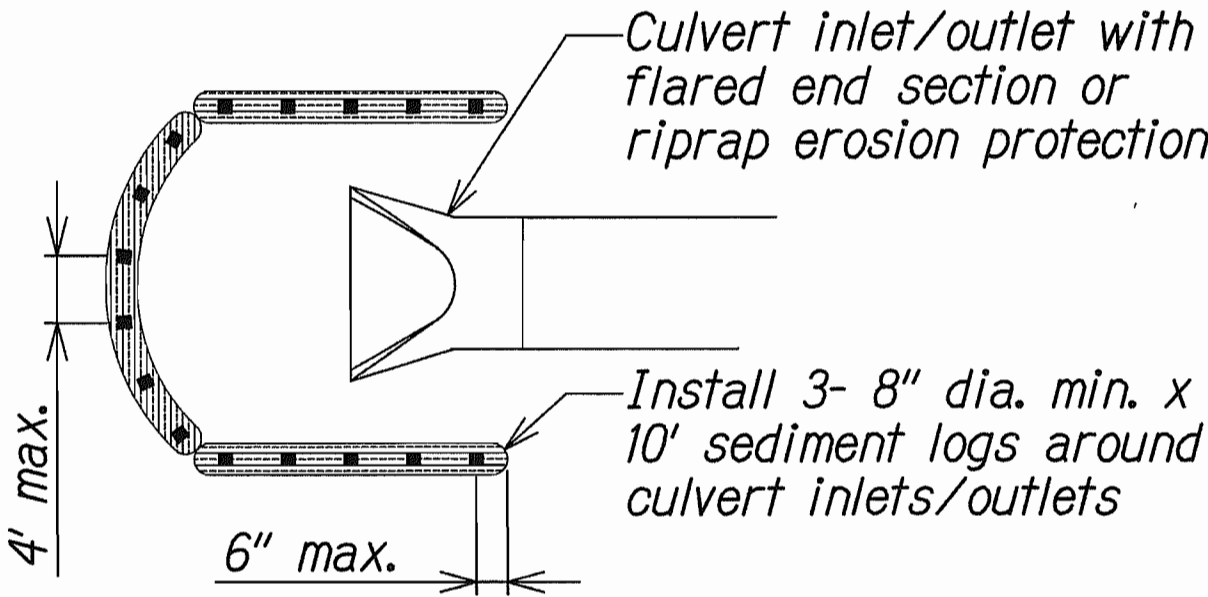

SEDIMENT LOG AT CULVERT INLET/OUTLET DETAIL

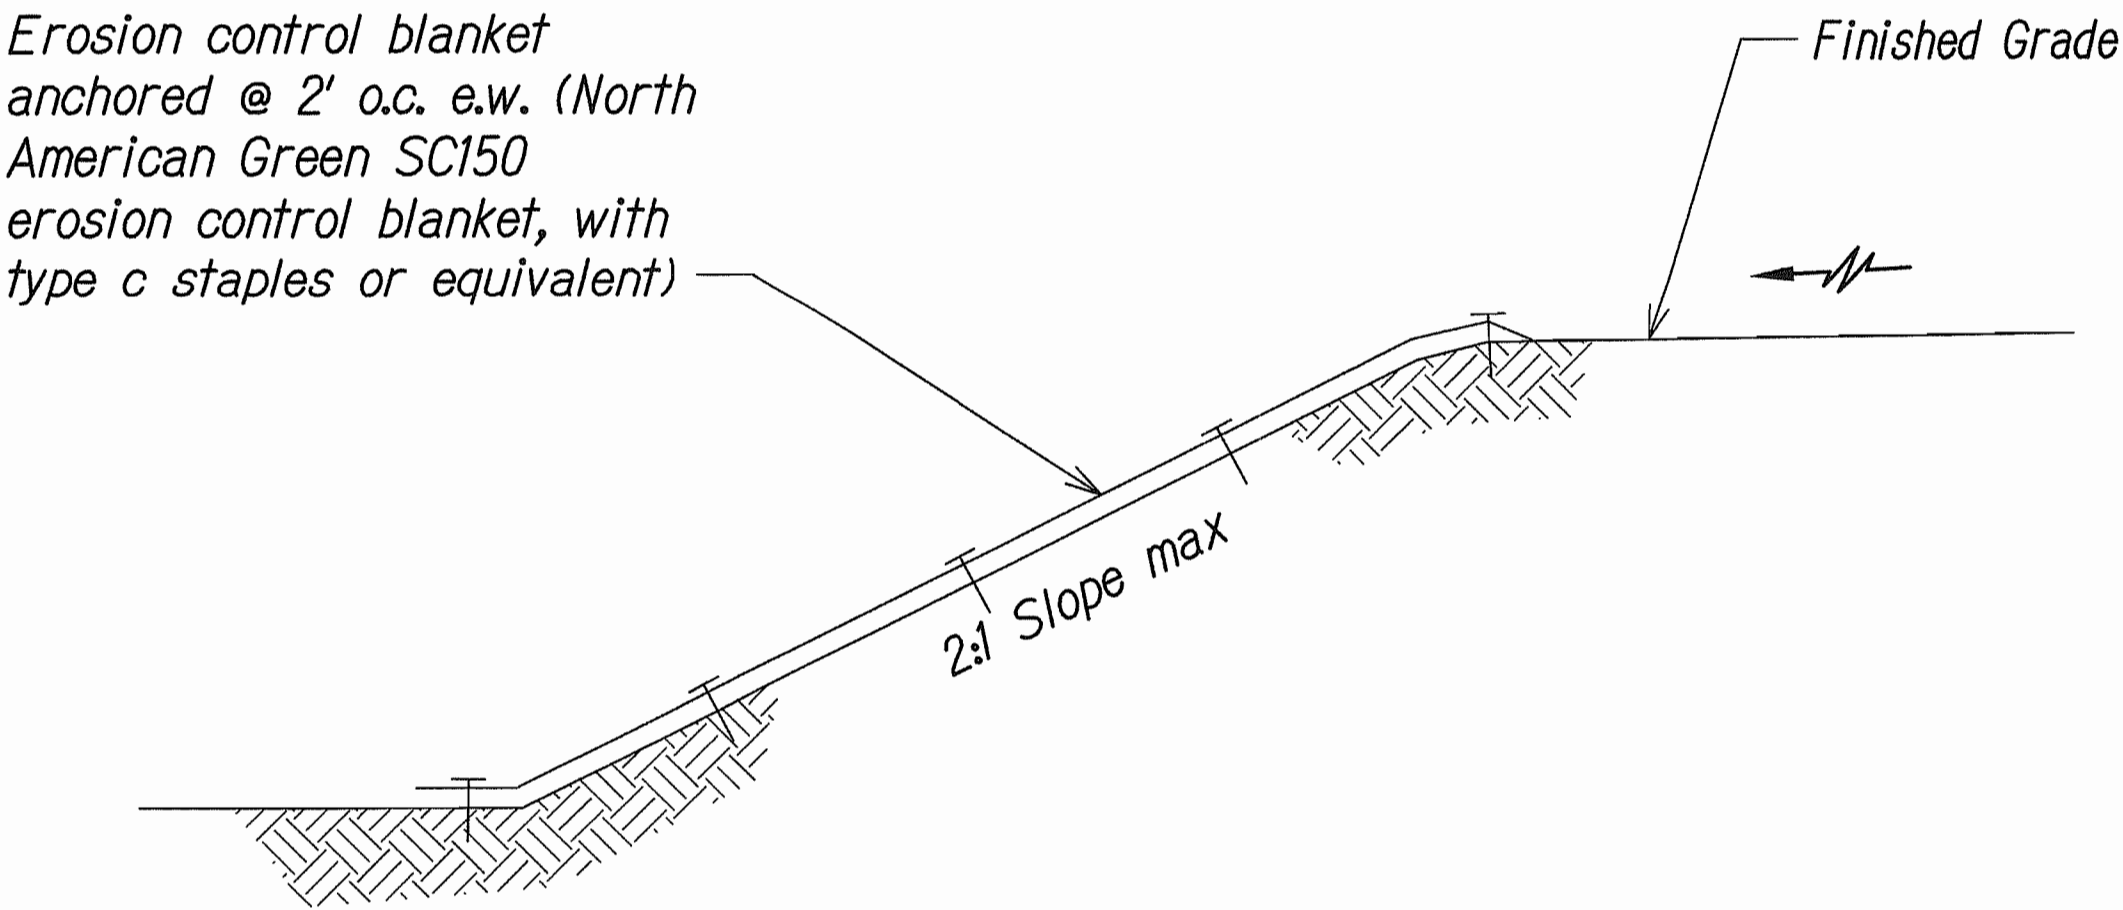

SLOPE PROTECTION DETAIL

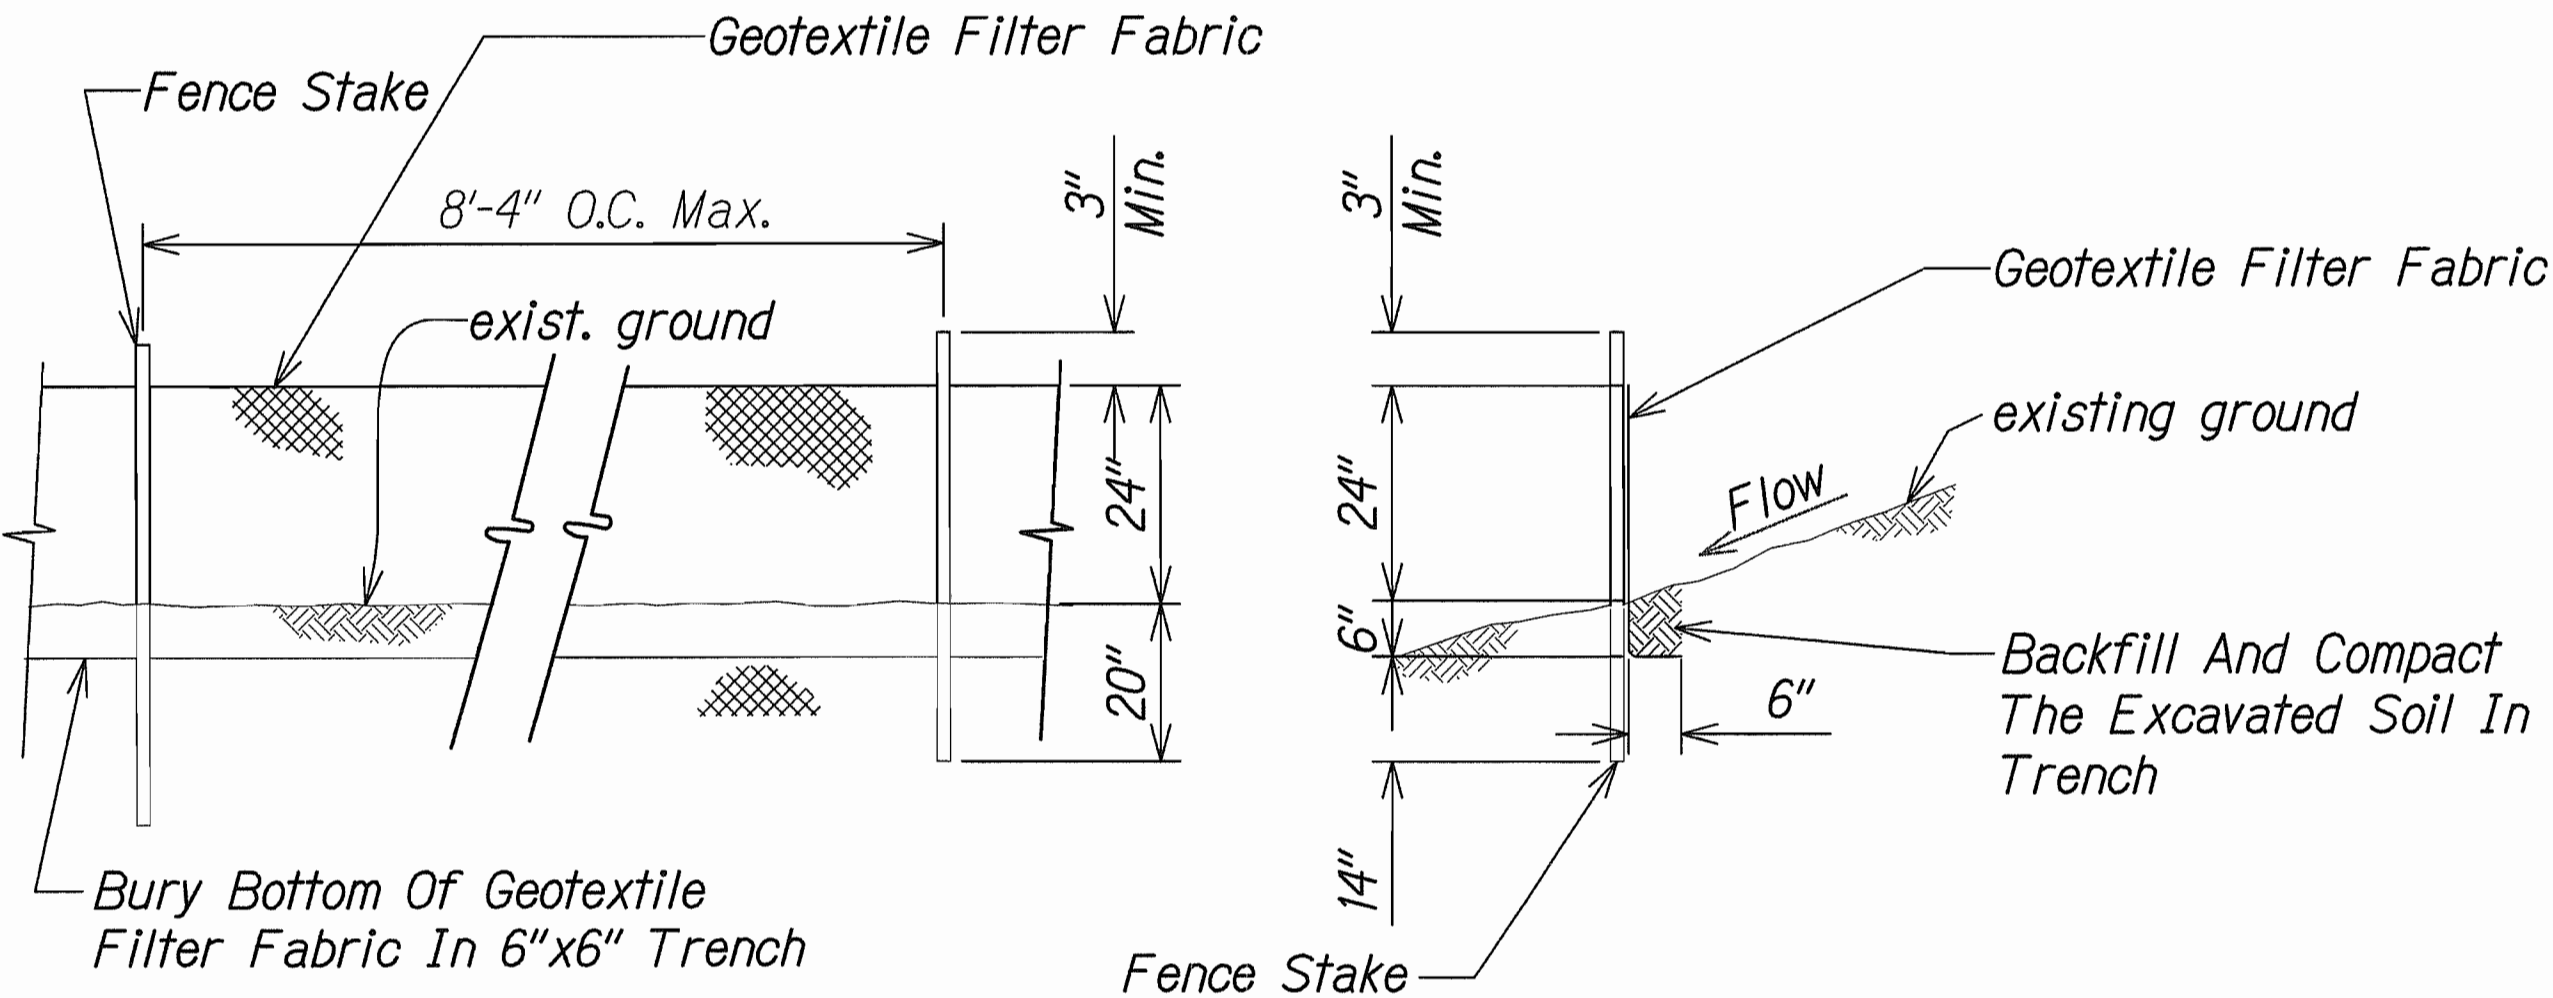

NOTES:

1. The Filter Fabric Shall Be A Minimum Of 36 Inches Wide.
2. If Silt Fence Is Obtained From Manufacturer As A Package (i.e. Fabric Attached To Post) The Manufacturer's Installation Instruction Shall Be Adhered To.
3. Fence Stakes May Be Wood Or Metal, Must Be Capable Of Supporting Anticipated Loads.
4. See Water Pollution and Erosion Control Notes on sheet 6.

SILT FENCE DETAIL

THIS WORK WAS PREPARED BY ME
OR UNDER MY SUPERVISION

Corey Matsuo
SIGNATURE

4/30/12
EXPIRATION
DATE OF THE
LICENSE

STATE OF HAWAII
DEPARTMENT OF TRANSPORTATION
HIGHWAYS DIVISION

EROSION CONTROL DETAILS

FARRINGTON HIGHWAY DRAINAGE IMPROVEMENTS

Vicinity of Orange St.

Project No. 93B-01-11

Scale: NTS Date: FEB 2012

SHEET No. 1 OF 1 SHEETS