
FED. ROAD DIST. NO.	STATE	FEDERAL AID PROJ. NO.	FISCAL YEAR	SHEET NO.	TOTAL SHEETS
HAWAII	HAW.	STP-093-1(22)	2013	C.O. 45	230

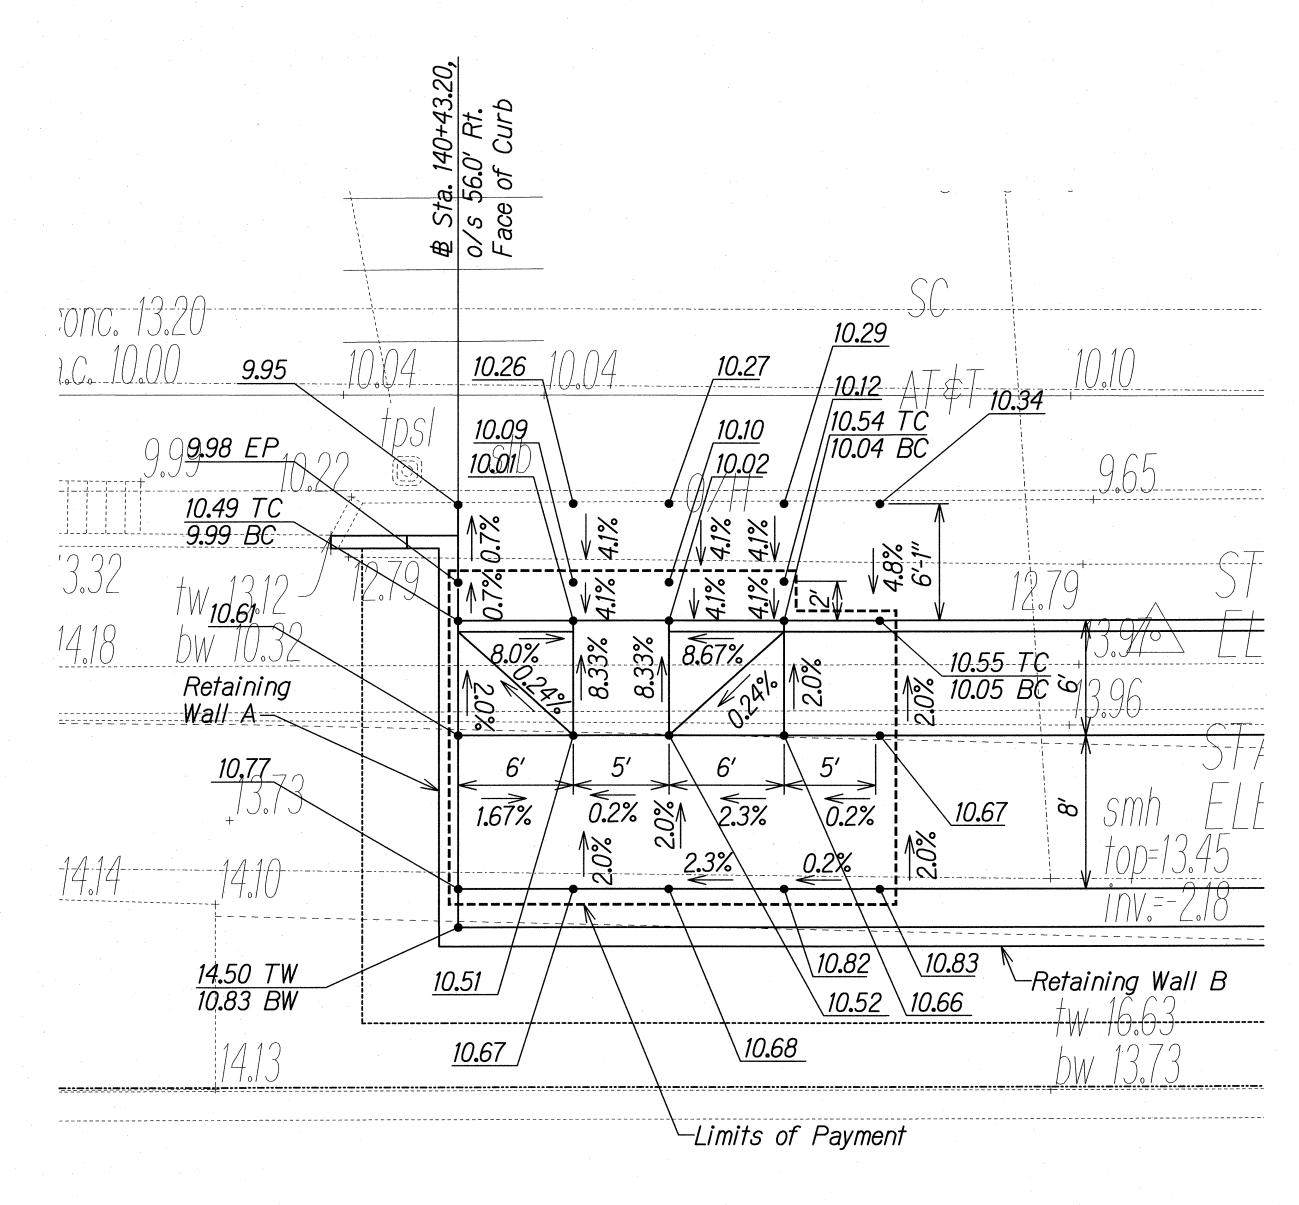


Limits of Payment 17.622 12.79 -Retaining Wall B


CURB RAMP A - TYPE "A"

Scale: 1"=5'

Note: Install detectable warning on all curb ramps. See Details on Sheet CR-14.

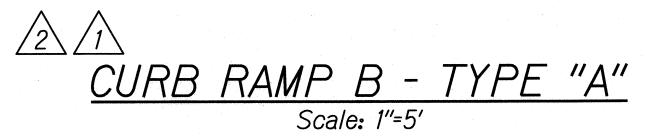

7/18/17 🛕 Revised Curb 🕏 Spot Elevations 10/5/16 ⚠ Revised Curb \$ Spot Elevations DATE REVISION

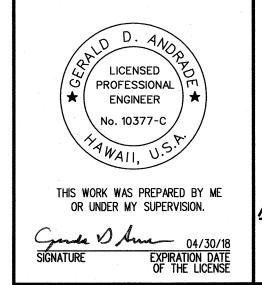

DEPARTMENT OF TRANSPORTATIONHIGHWAYS DIVISION


CURB RAMPS FARRINGTON HIGHWAY

FARRINGTON HIGHWAY INTERSECTION IMPROVEMENTS
AT NANAKULI AVENUE AND HALEAKALA AVENUE
Federal-Aid Project No. STP-093-1(22) Scale: 1"=5" Date: April 2013

SHEET No. CR-1 OF 14 SHEETS

CONTRACT CHANGE ORDER NO. 33

C.O. 45

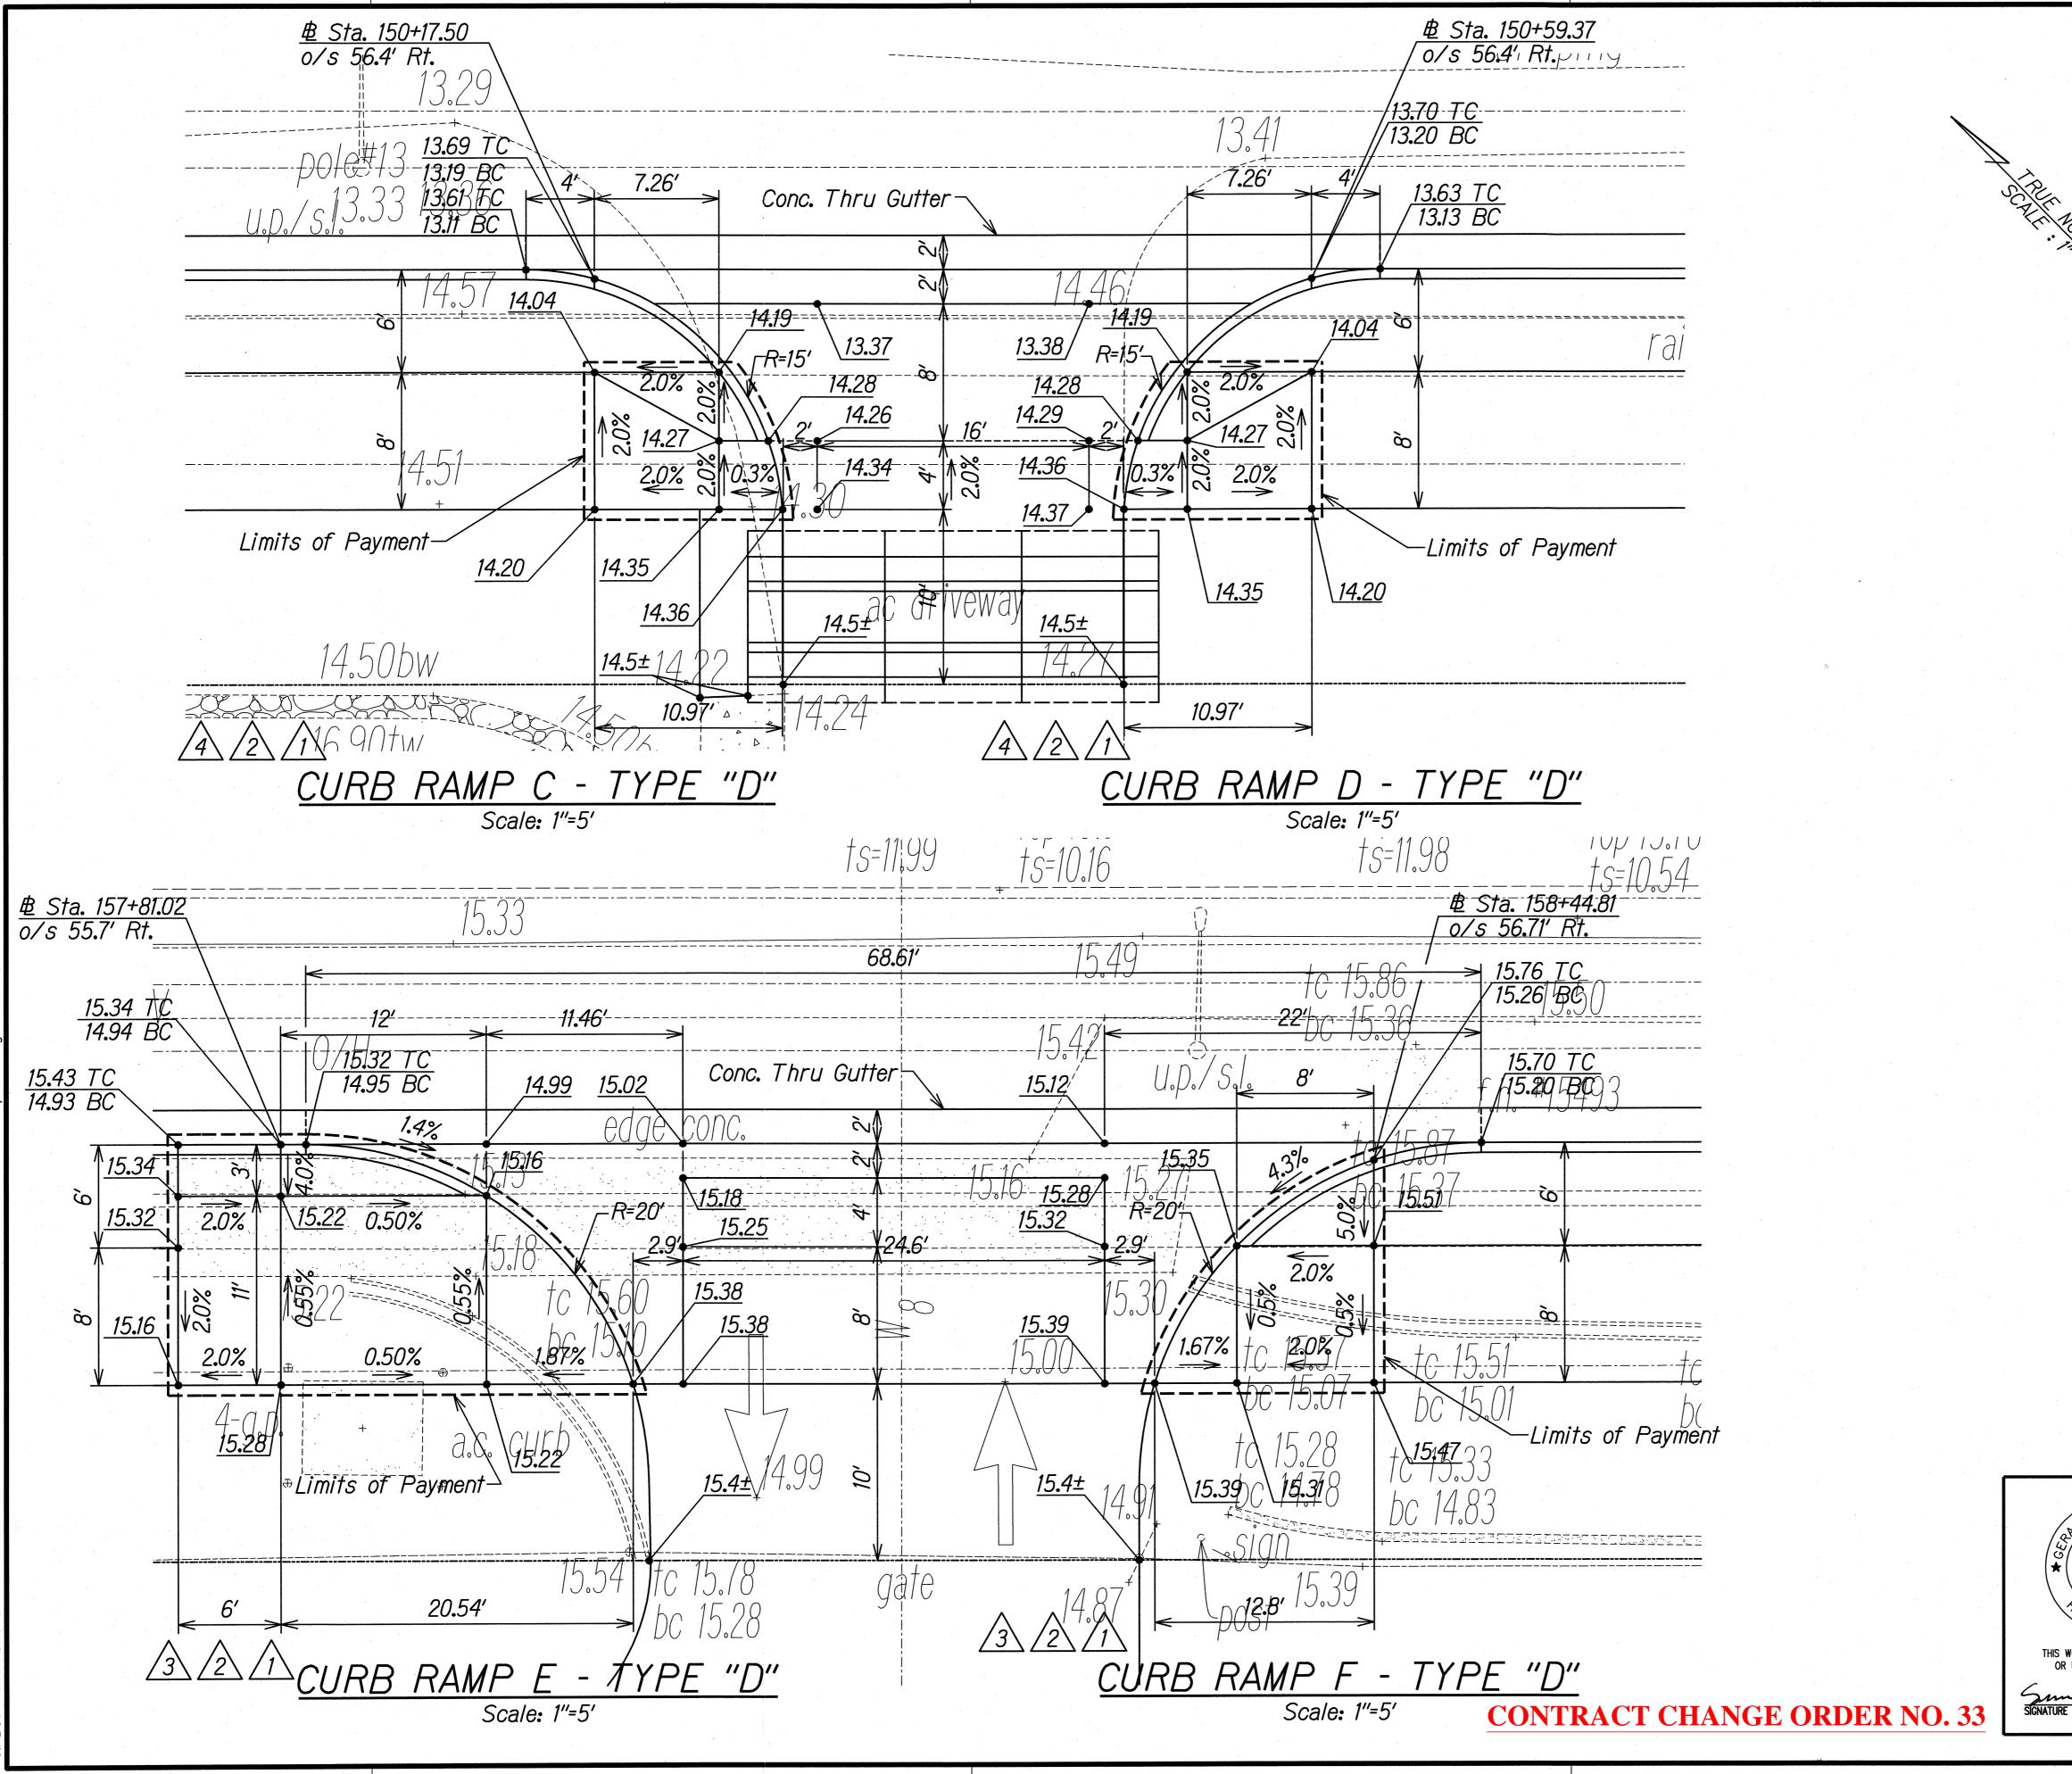


FED. ROAD DIST. NO. STATE FEDERAL AID PROJ. NO. FISCAL SHEET NO. SHEETS

HAWAII HAW. STP-093-1(22) 2013 C.O. 46 230

Note: Install detectable warning on all curb ramps. See Details on Sheet CR-14.

2/9/18	A Revised Curb ♦ Spot Elevations	
11/17/17	🛕 Revised Curb Ramps	
7/18/17	À Revised Curb ♦ Spot Elevations	
10/5/16	⚠ Revised Curb 🛊 Spot Elevations	
DATE	REVISION	

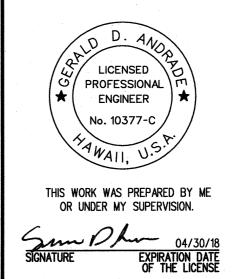

STATE OF HAWAII

DEPARTMENT OF TRANSPORTATION

HIGHWAYS DIVISION


<u>CURB RAMPS</u> FARRINGTON HIGHWAY


FARRINGTON HIGHWAY INTERSECTION IMPROVEMENTS
AT NANAKULI AVENUE AND HALEAKALA AVENUE
Federal-Aid Project No. STP-093-1(22)

Scale: 1"=5' Date: April 2013

SHEET No. CR-2 OF 14 SHEETS

C.O. 46

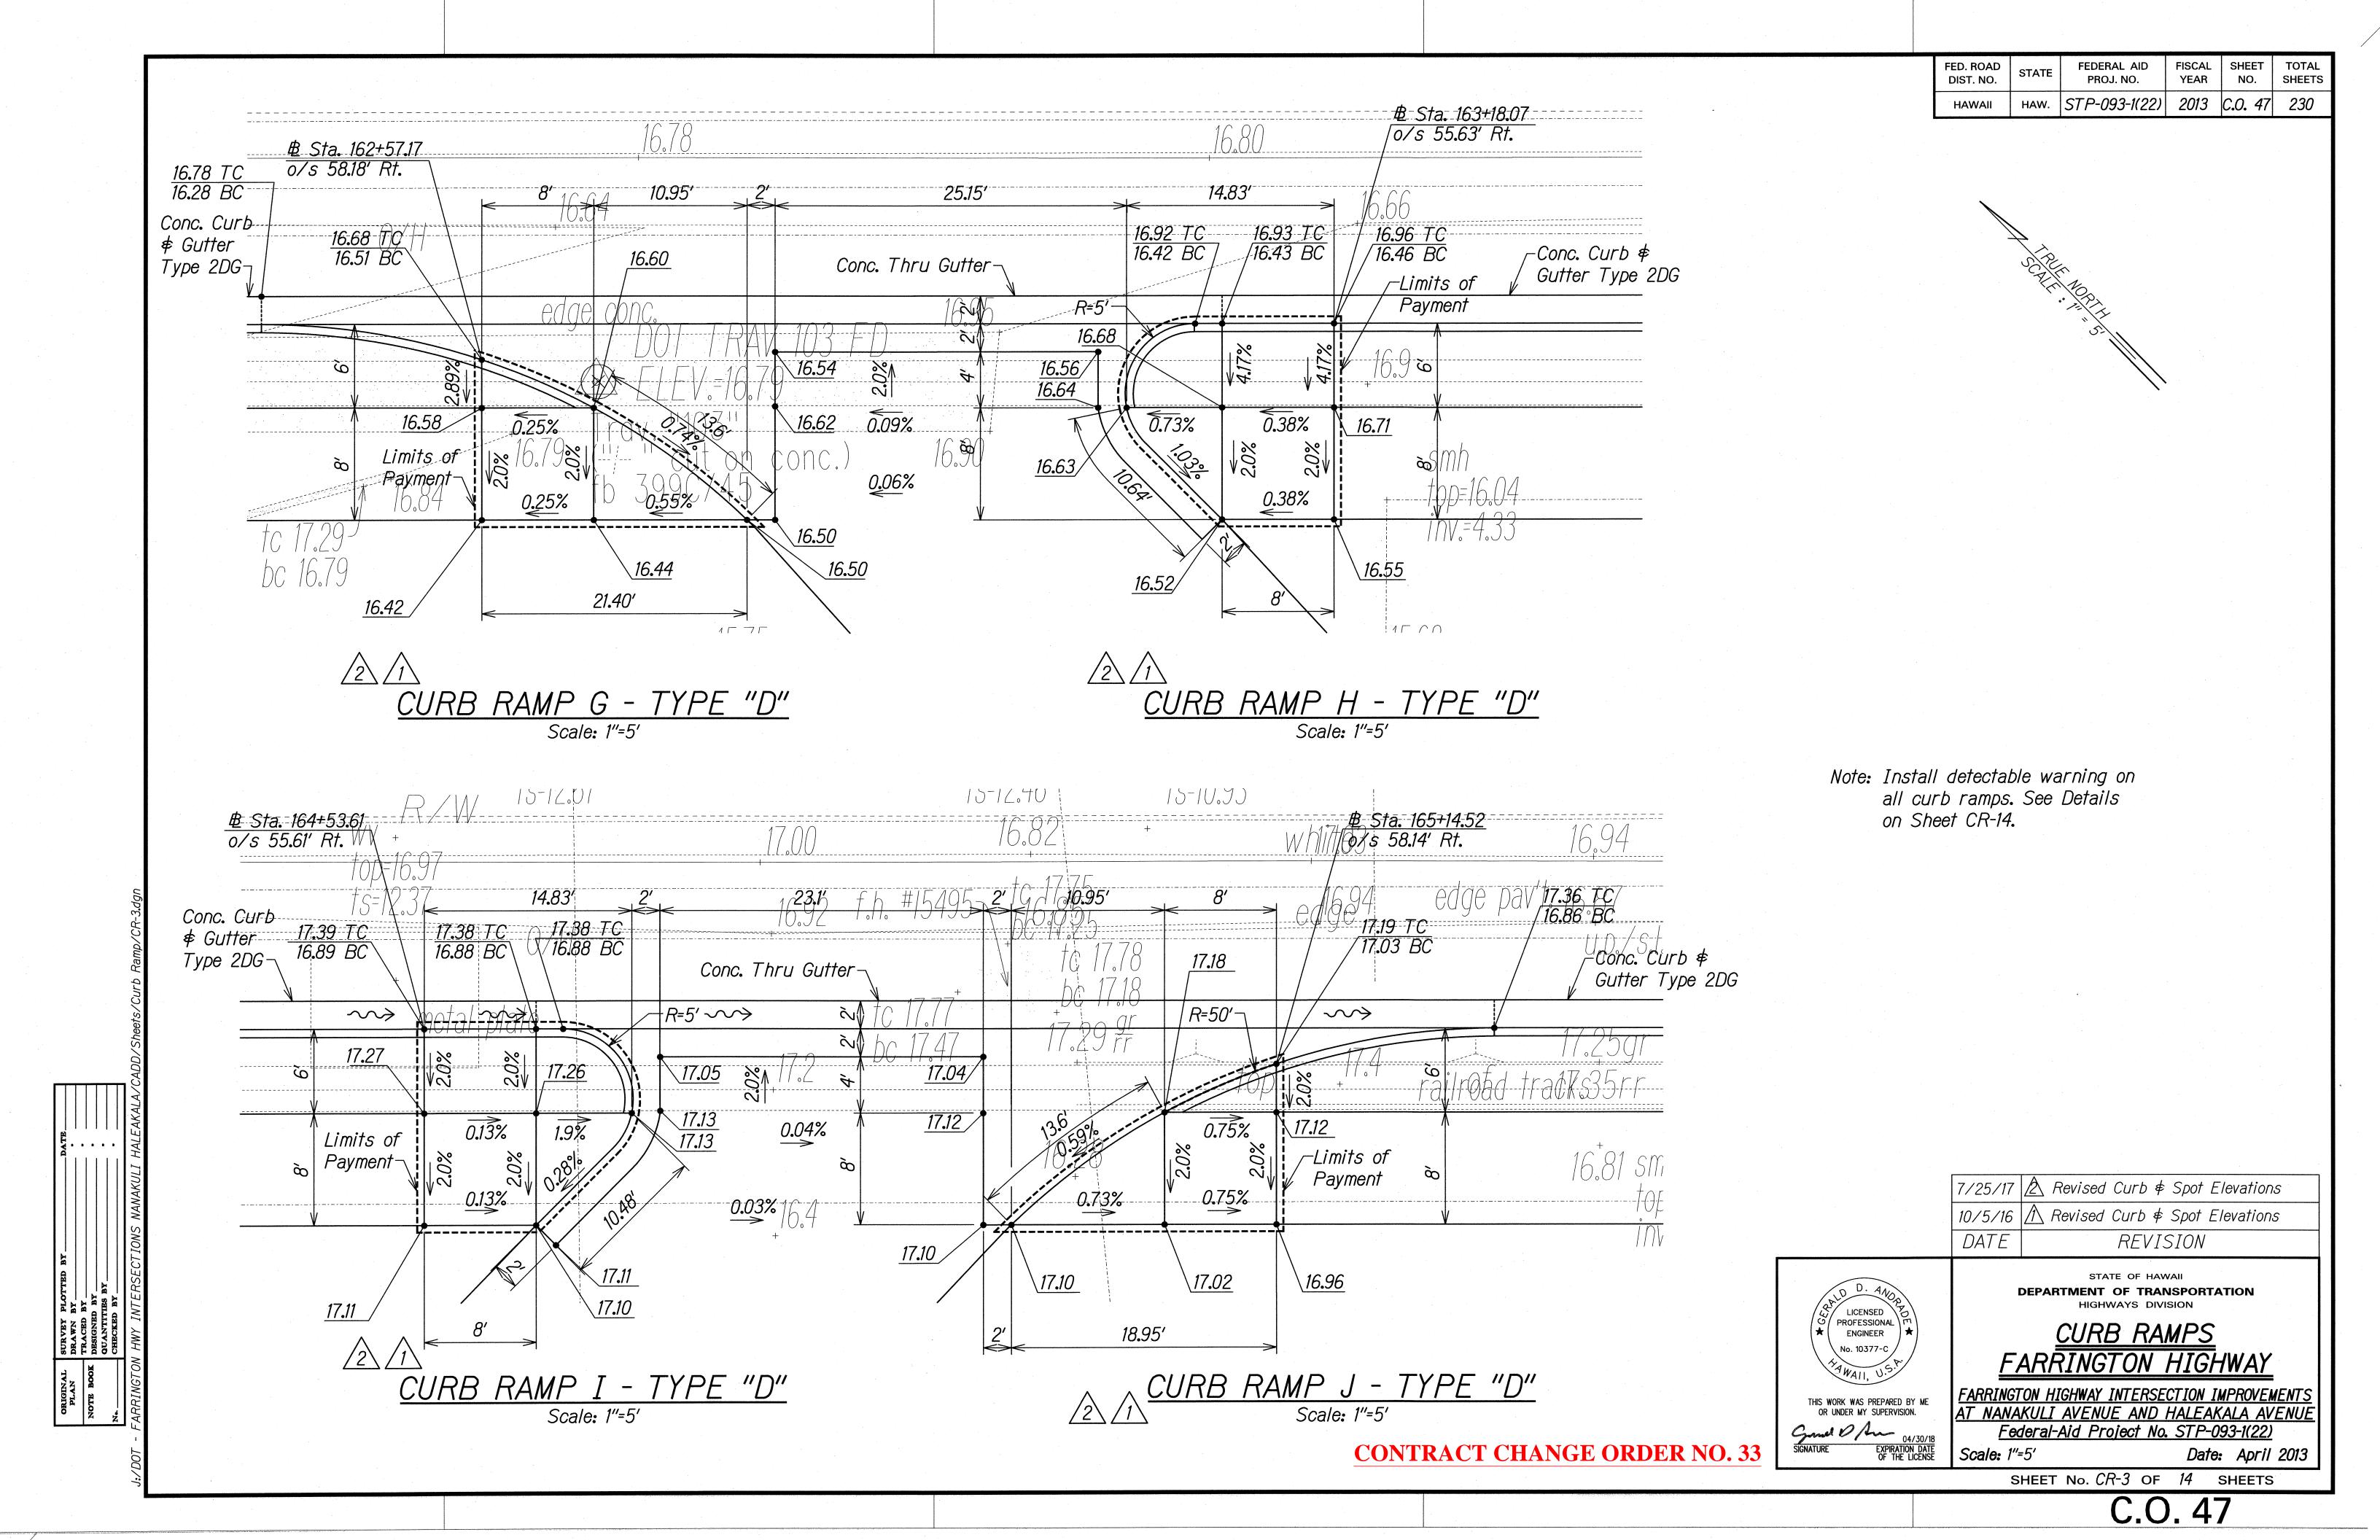

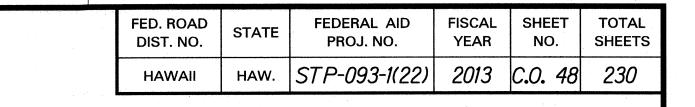

SCAPEROPA

Note: Install detectable warning on all curb ramps. See Details on Sheet CR-14.

<u>CURB RAMP K - TYPE "D"</u>

Scale: 1"=5'

17.19

10.97'

Conc. Thru Gutter

16.98

17.25

17.25

16.97

<u>17.24</u>

17.24

17.18

10.97′

<u>₿ Sta. 166+38.22</u> o/s 56.12' Rt.

> 17.36 TC 16.86 BC

17.32 TC 16.82 BC

Limits of

17.30

Conc. Curb ♦ Gutter Type 2DG—

CURB RAMP L - TYPE "D"

Scale: 1"=5'

<u>B Sta. 166+79.29</u> o/s 56.12' Rt.

17.34 TC /16.84 BC

17.30 TC | 16.80 BC


-Limits of

├─Conc. Curb ♦ Gutter Type 2DG

7/25/17 A Revised Curb \$ Spot Elevations

10/5/16 Revised Curb \$ Spot Elevations

DATE REVISION

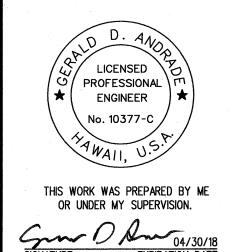

STATE OF HAWAII

DEPARTMENT OF TRANSPORTATION
HIGHWAYS DIVISION


<u>CURB RAMPS</u> FARRINGTON HIGHWAY

FARRINGTON HIGHWAY INTERSECTION IMPROVEMENTS
AT NANAKULI AVENUE AND HALEAKALA AVENUE
Federal-Aid Project No. STP-093-1(22)

Scale: 1"=5' Date: April 2013


SHEET No. CR-4 OF 14 SHEETS

C.O. 48

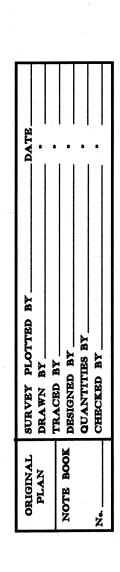

CONTRACT CHANGE ORDER NO. 33

FED. ROAD DIST. NO.	STATE	FEDERAL AID PROJ. NO.	FISCAL YEAR	SHEET NO.	TOTAL SHEETS
HAWAII	HAW.	STP-093-1(22)	2013	C.O. 49	230

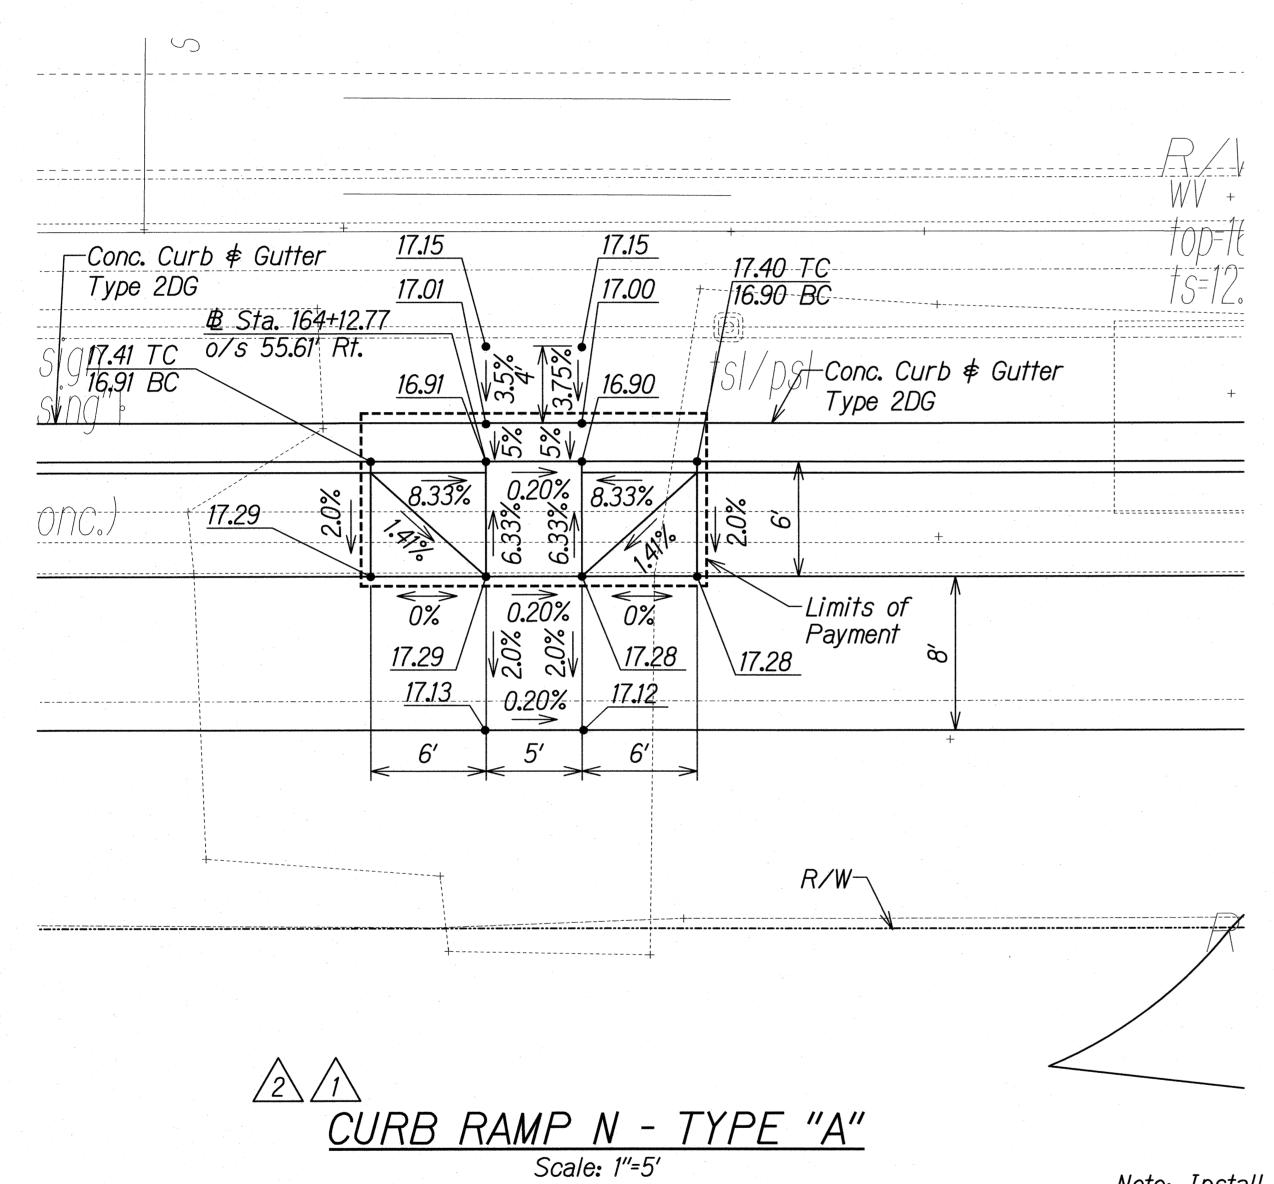


—Conc. Curb Type 2D ₿ Sta. 170+33.70 o/s 55.52' Rt. *16.65* 17.15 TC Limits of Payment— R/W-CURB RAMP 0 - TYPE "A"

Scale: 1"=5"

Note: Install detectable warning on all curb ramps. See Details on Sheet CR-14.

7/25/17 A Revised Curb \$ Spot Elevations 10/5/16 ⚠ Revised Curb \$ Spot Elevations DATE REVISION

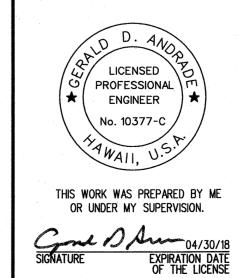

STATE OF HAWAII DEPARTMENT OF TRANSPORTATION

CURB RAMPS FARRINGTON HIGHWAY

FARRINGTON HIGHWAY INTERSECTION IMPROVEMENTS
AT NANAKULI AVENUE AND HALEAKALA AVENUE
Federal-Aid Project No. STP-093-1(22) Date: April 2013 Scale: 1"=5"

SHEET No. CR-5 OF 14 SHEETS


C.O. 49


CONTRACT CHANGE ORDER NO. 33

CURB RAMP AND SIDEWALK NOTES:

- 1. These typical details are intended as curb ramp guidelines for design and construction. These guidelines shall not replace site specific curb ramp plans.
- 2. A 2% maximum cross slope shall be maintained in the direction of pedestrian traffic.
- 3. Subject to field conditions, the Engineer shall determine the final location of curb ramps.
- 4. All pullboxes shall be installed away from the curb ramp and within the sidewalk/unpaved area to the maximum extent feasible.
- 5. Where necessary, existing pullboxes, handholes, manholes, etc. shall be adjusted to match curb ramp grade. Adjustments shall not be paid for separately but shall be considered incidental to the various curb ramp items unless indicated otherwise.
- 6. Transitions from ramps to gutters and roadways shall be flush.
- 7. Curb ramps and sidewalks shall be constructed to eliminate ponding to the maximum extent feasible.
- 8. The pedestrian push button shall meet operational and reach requirements of the American with Disabilities Act Accessibility Guidelines (ADAAG): a) Forward Reach. The maximum height for forward reach shall be 48".
- b) Side Reach. The maximum height for side reach shall be 48".
- c) Operation. Controls and operating mechanisms shall be operable with one hand and shall not require tight grasping, pinching, or twisting of the wrist. The force required to activate controls shall be no greater than 5 lbf.
- 9. The maximum slopes of adjoining gutters or road surface immediately fronting the curb ramp shall not exceed 5% for Type A, D and Combination ramps and 8.33% for Type B, C, and E ramps.
- 10. There shall be a 30"x48" level ground surface (2% max. cross slope, both directions) for a forward or side approach, as appropriate, to a pedestrian push button.
- 11. Construction joints are required to join curb ramps with sidewalks.
- 12. Unless otherwise noted, new gutters are required as shown.
- 13. All curb ramps shall be reinforced with 6x6 W1.4/W1.4 welded wire fabric.
- 14. Surface of sidewalks and curb ramps shall be firm, stable, and slipresistant. This includes the surfaces of pullboxes, valve covers, manhole covers, etc.
- 15. Bed course material is required for curb ramps, sidewalks, and gutters.
- 16. All sidewalks shall provide a minimum clear width of 3'-0" (excluding curb) for pedestrian circulation. If this cannot be met, a minimum 32-inch clear width is allowed for a distance of 24-inches.
- 17. Passing spaces along new sidewalks with 5' clear width or less shall be provided at maximum 200' intervals as required by ADA guidelines. The passing area shall be a minimum 5' wide by 5' long as feasible.
- 18. If possible, install utility poles, fire hydrants, light poles, sign posts, pullboxes, etc. off of sidewalk but within the right-of-way.

- 19. Objects protruding from utility poles and walls adjacent to the sidewalks (i.e. wall mounted fire hydrants, telephones, meters on poles, etc.) shall be mounted to meet the current American with Disabilities Act Accessibility Guidelines (ADAAG) and will be subject to Engineer's approval.
- 20. If a curb ramp is not constructed according to the plans, the Contractor shall reconstruct the curb ramp at no cost to the State. Construction tolerance for Portland Cement Concrete shall be based on 1/2 inch per 10 ft. (±0.2%). Remedial measures will not be accepted.

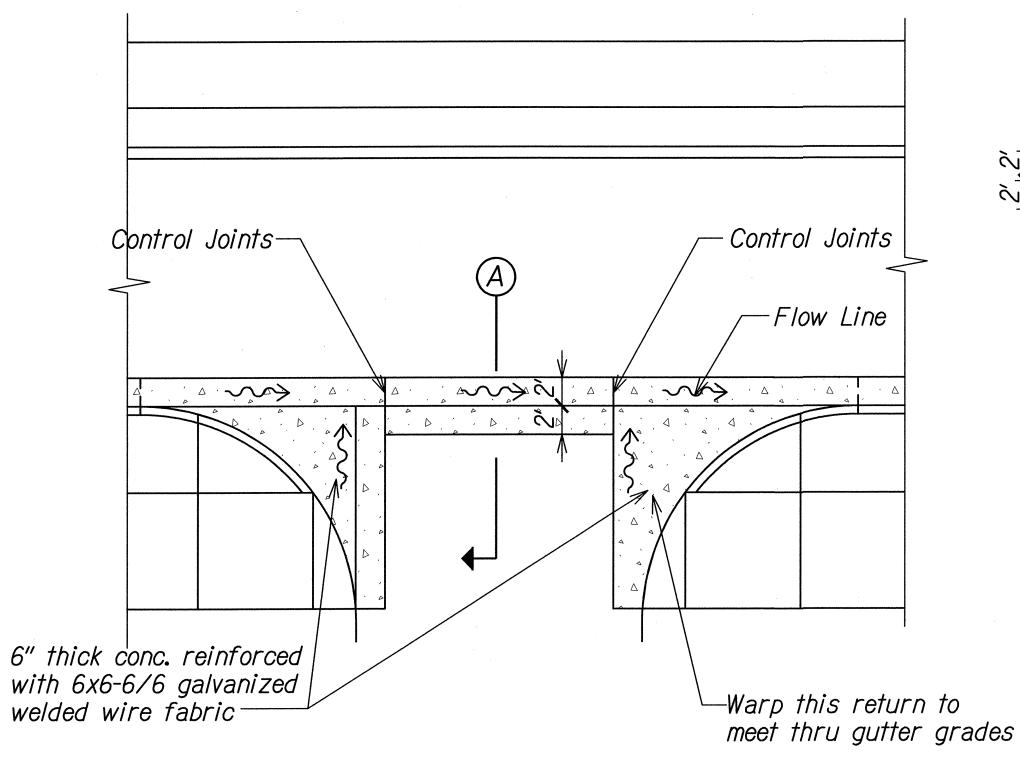


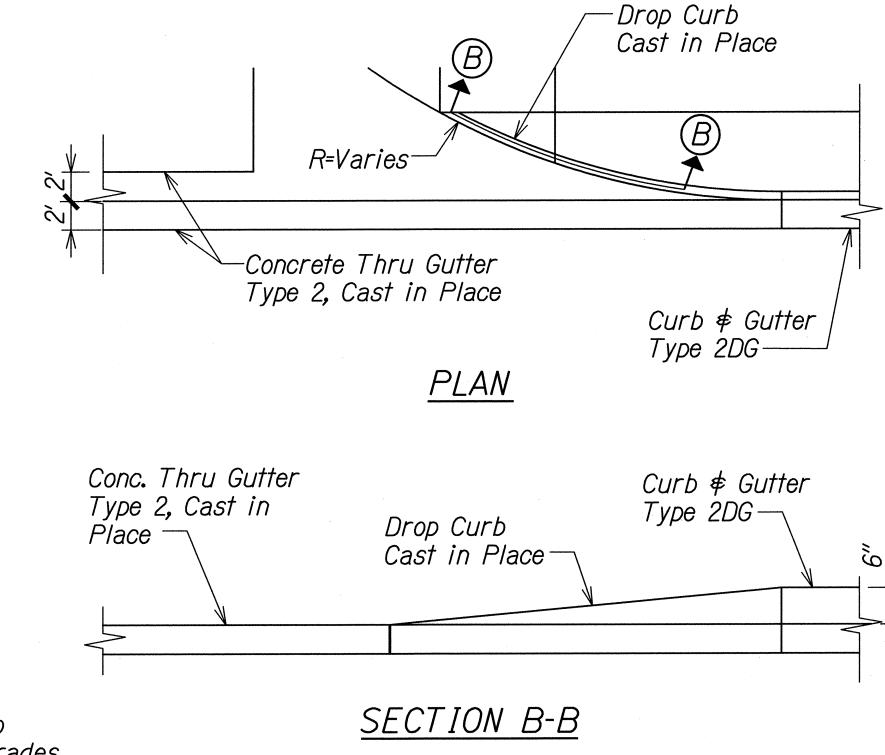

DROP CURB CAST IN PLACE

FED. ROAD

DIST. NO.

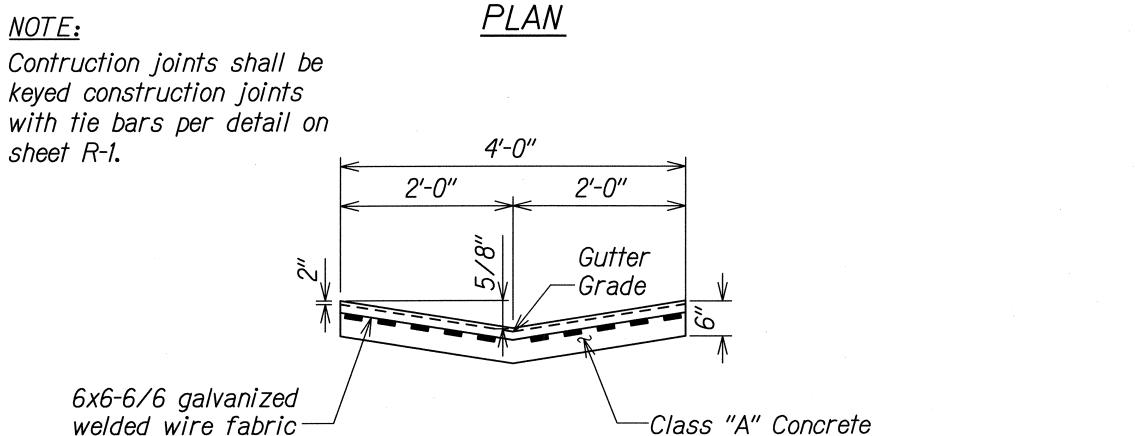

CONCRETE THRU-GUTTER TYPE 2 CAST IN PLACE

SECTION A-A

STATE OF HAWAII **DEPARTMENT OF TRANSPORTATION**

CURB RAMP AND SIDEWALK NOTES

FARRINGTON HIGHWAY INTERSECTION IMPROVEMENTS AT NANAKULI AVENUE AND HALEAKALA AVENUE Federal-Aid Project No. STP-093-1(22)


SHEET No. CR-6 OF 14 SHEETS

50


Date: April 2013


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FEDERAL AID PROJ. NO. SHEETS HAW. STP-093-1(22) 2013 50 230

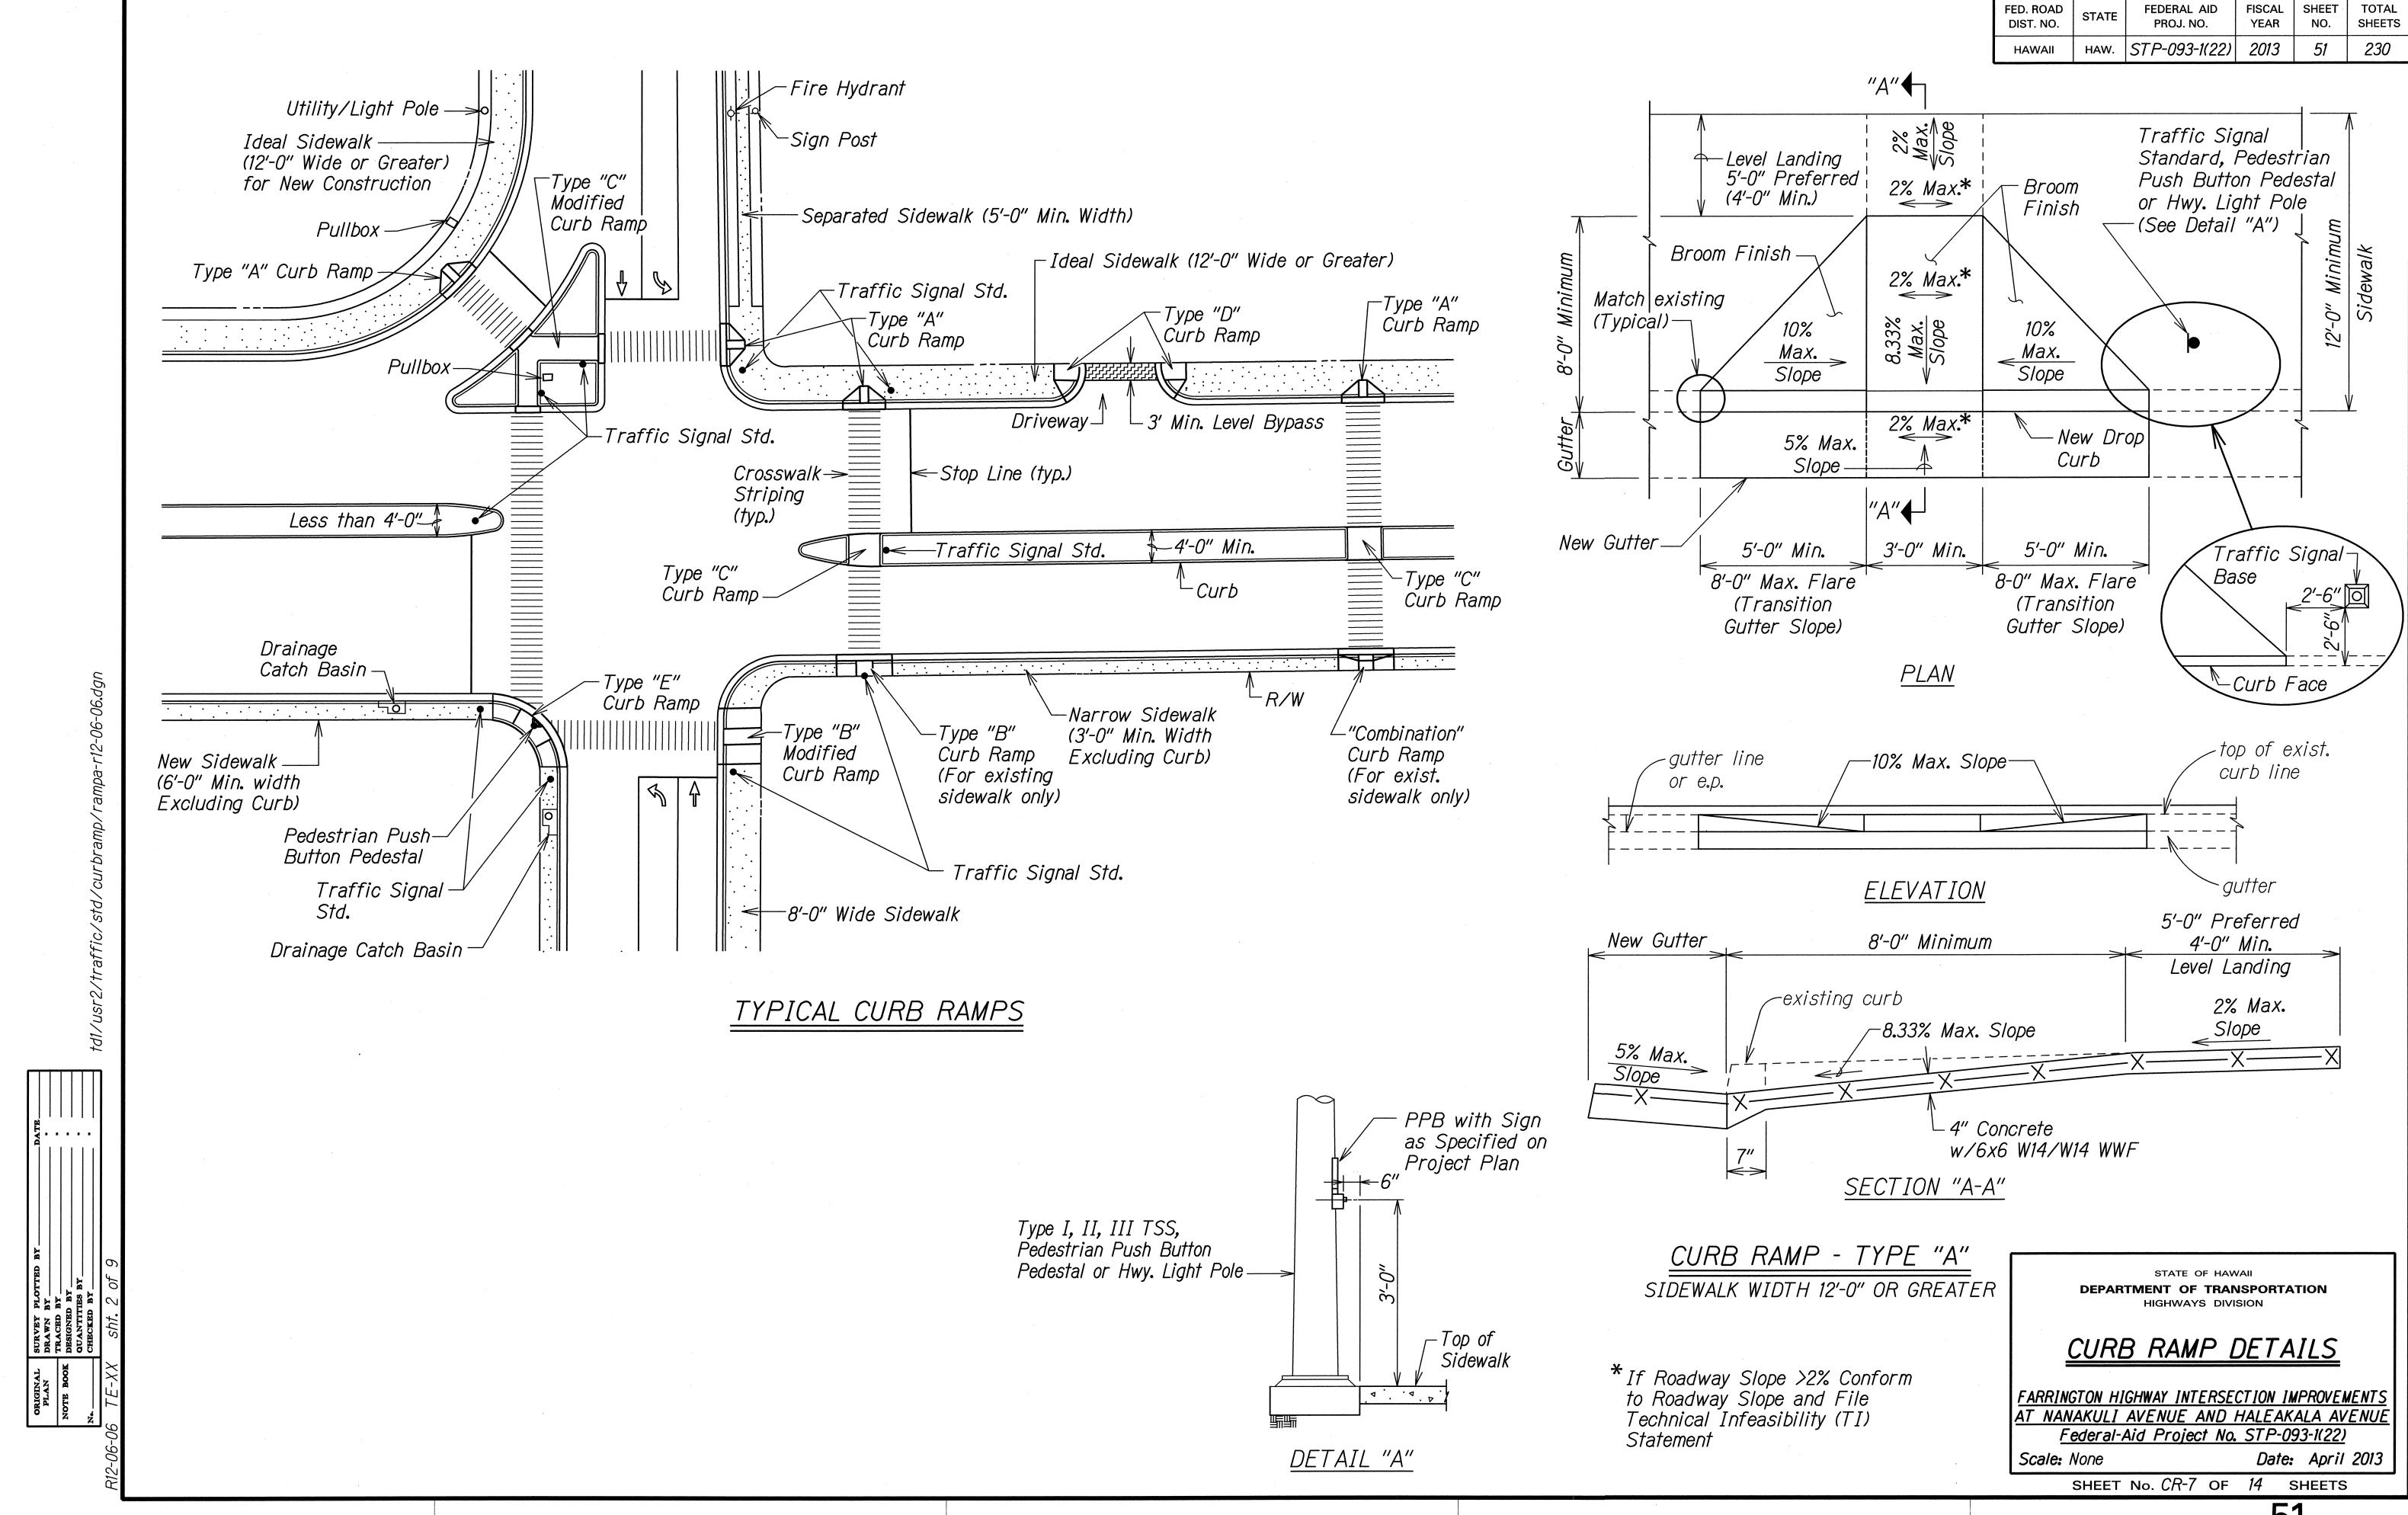


51




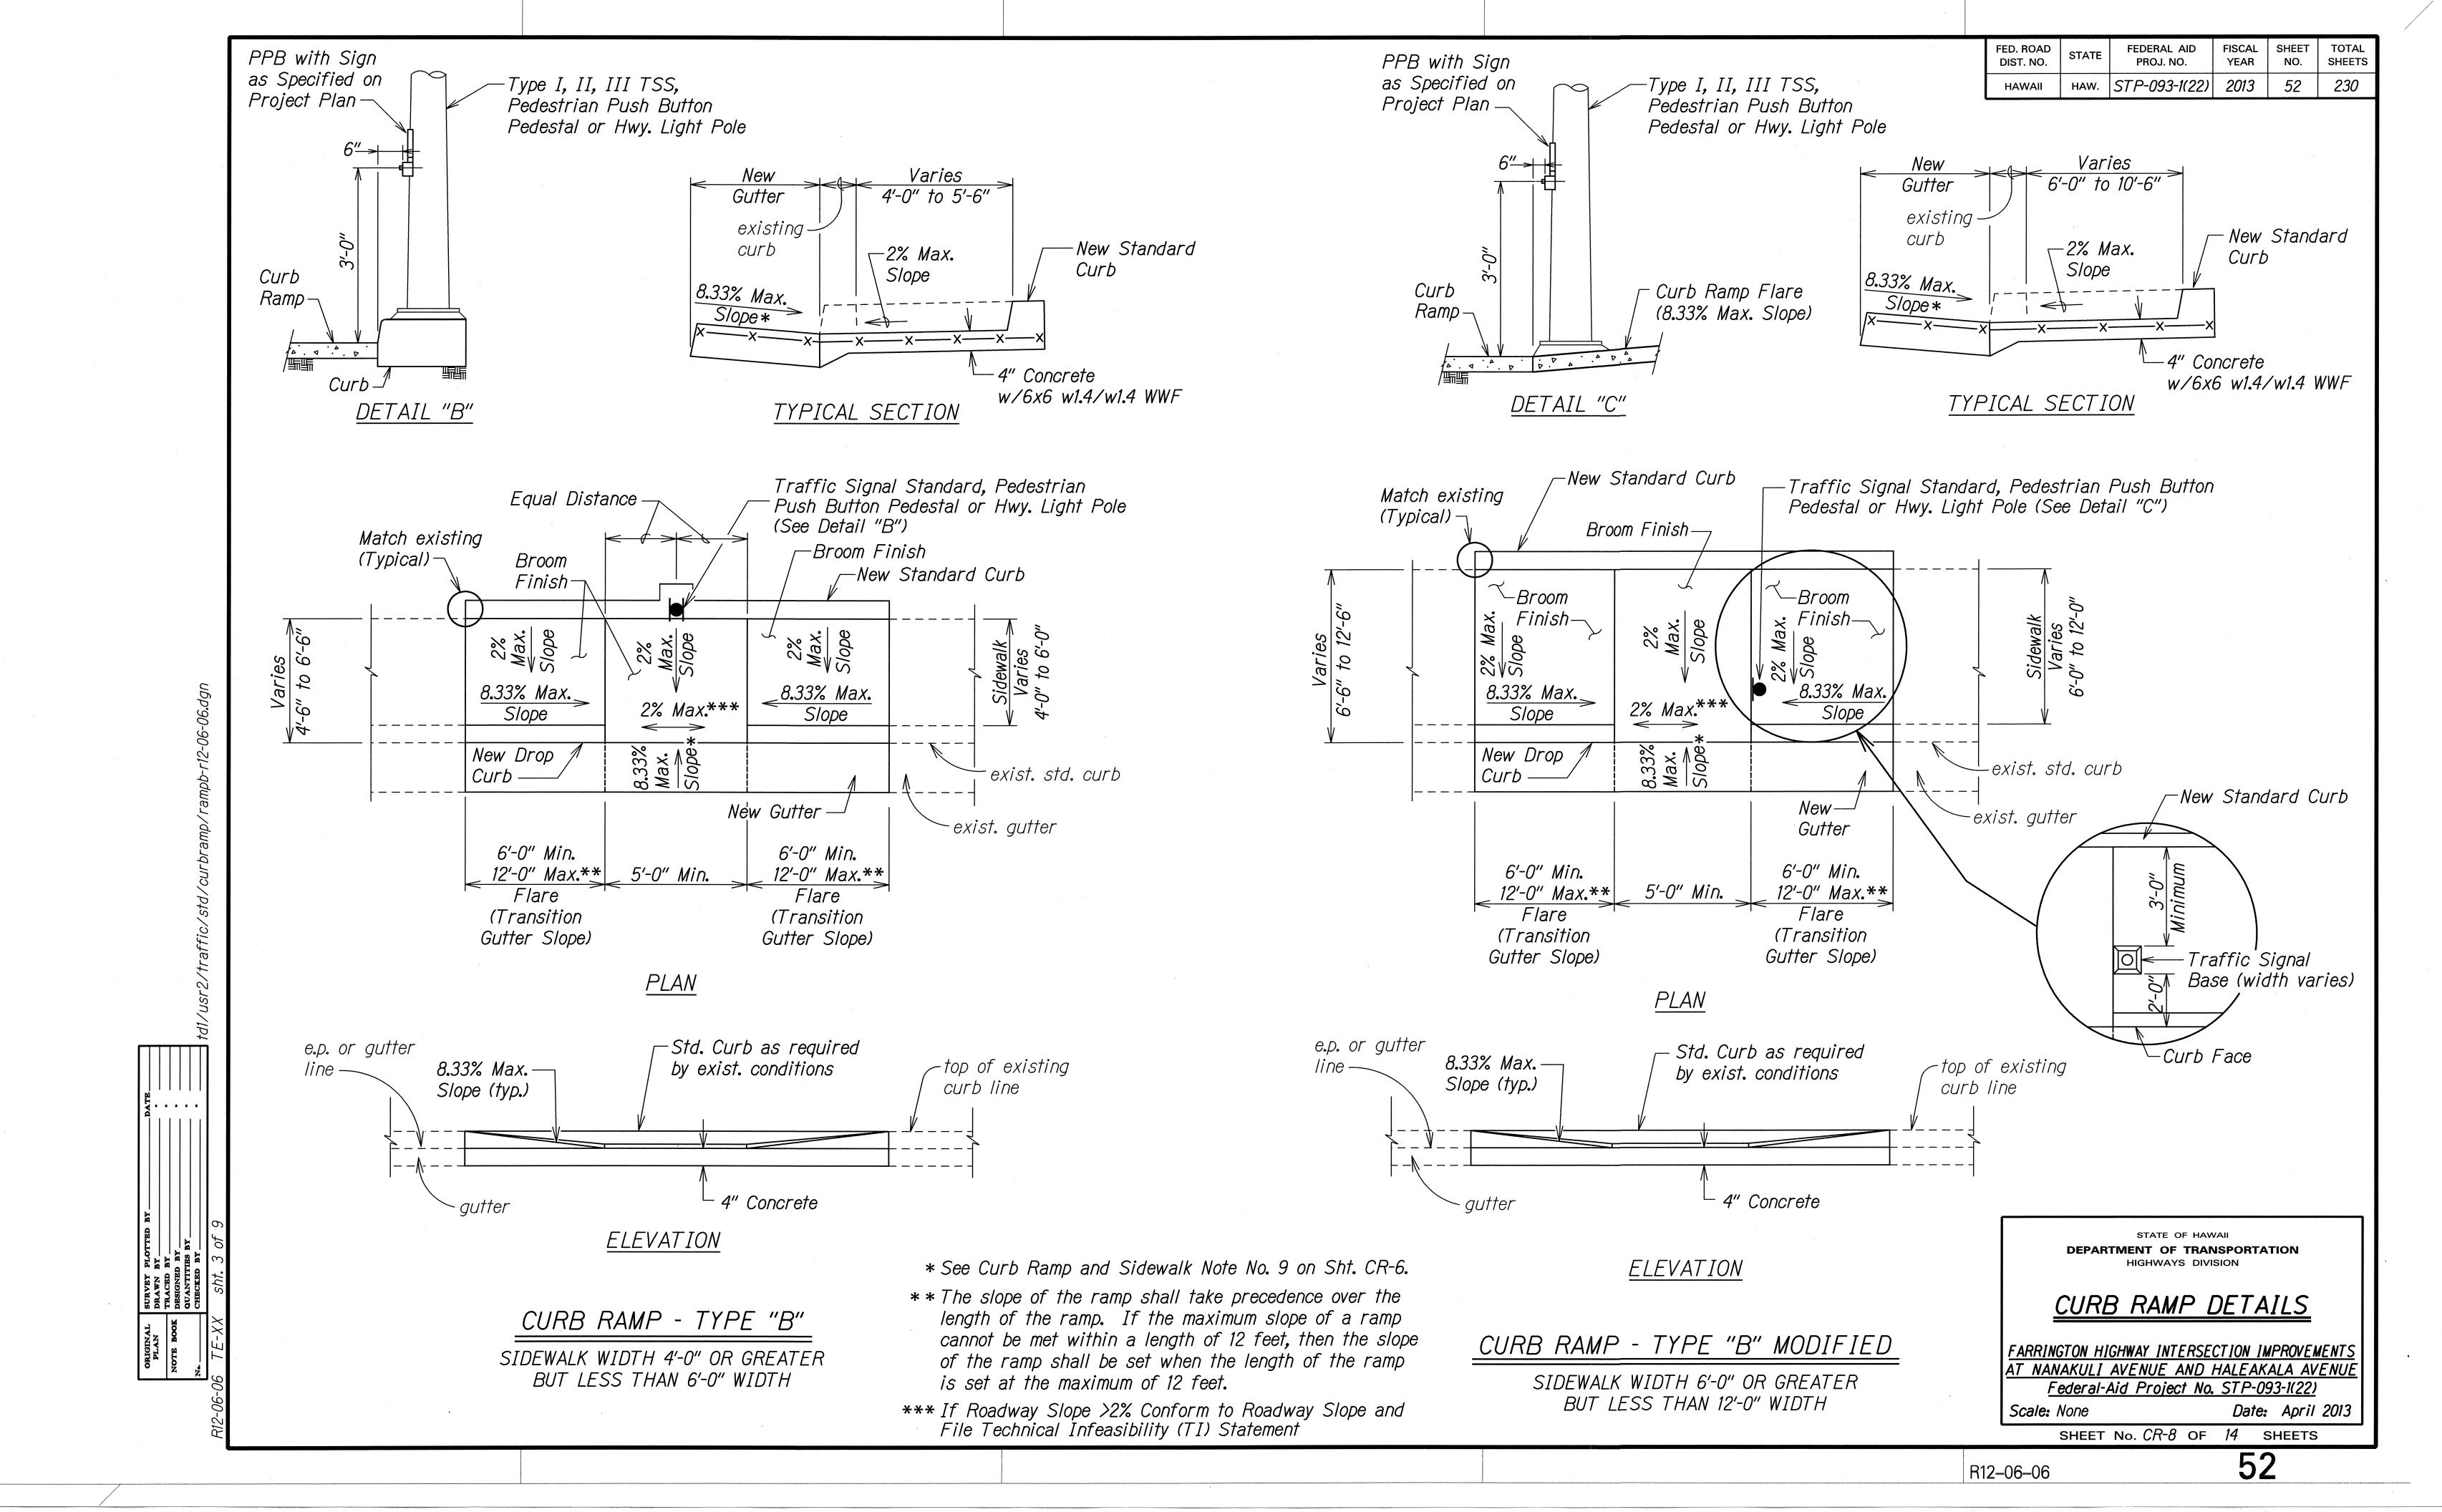

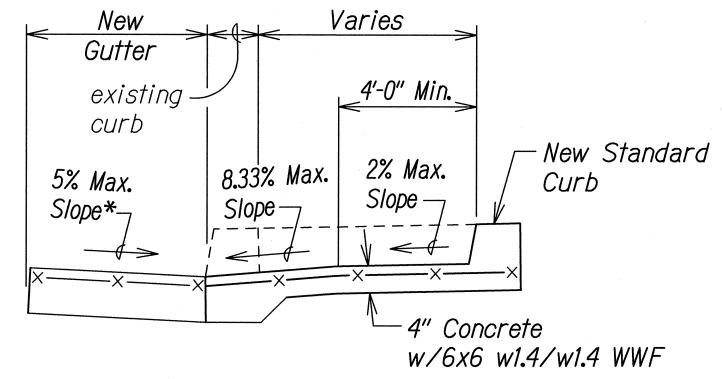TYPICAL SECTION

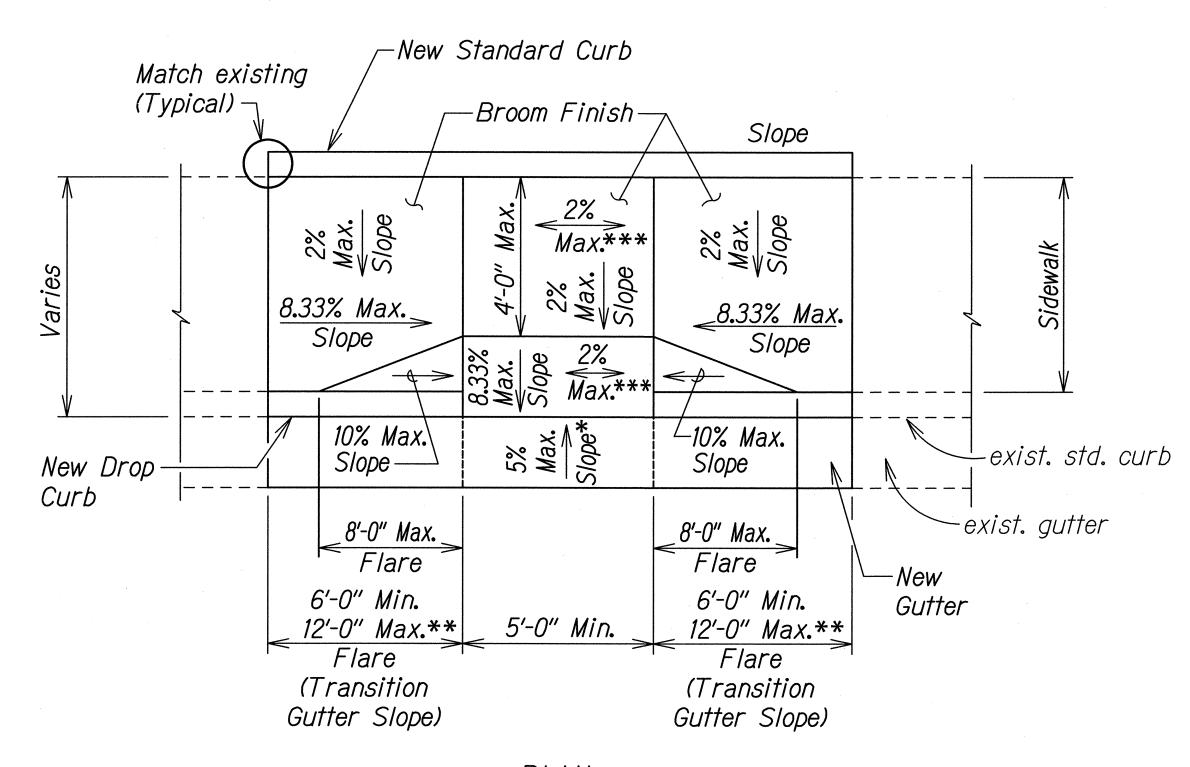

<u>PLAN</u>

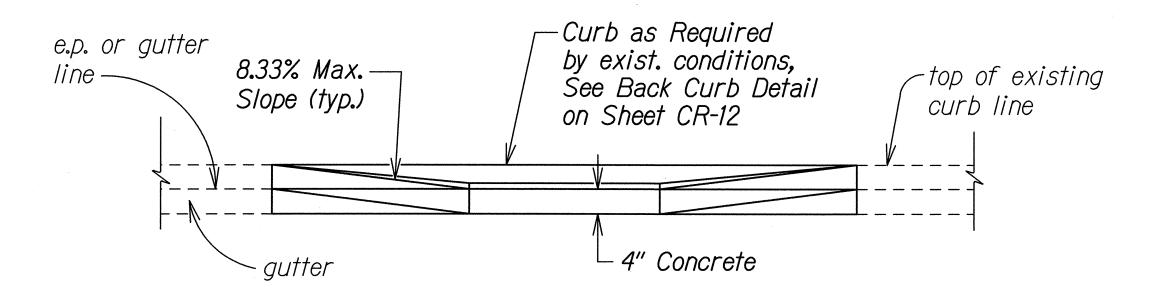

ELEVATION

CURB RAMP - COMBINATION

- * See Curb Ramp and Sidewalk Note No. 9 on Sht. CR-6.
- ** The slope of the ramp shall take precedence over the length of the ramp. If the maximum slope of a ramp cannot be met within a length of 12 feet, then the slope of the ramp shall be set when the length of the ramp is set at the maximum of 12 feet.
- *** If Roadway Slope >2% Conform to Roadway Slope and File a Technical Infeasibility (TI) Statement

STATE OF HAWAII

DEPARTMENT OF TRANSPORTATION
HIGHWAYS DIVISION


CURB RAMP DETAILS


FARRINGTON HIGHWAY INTERSECTION IMPROVEMENTS
AT NANAKULI AVENUE AND HALEAKALA AVENUE
Federal-Aid Project No. STP-093-1(22)


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SHEET No. CR-9 OF 14 SHEETS

Date: April 2013



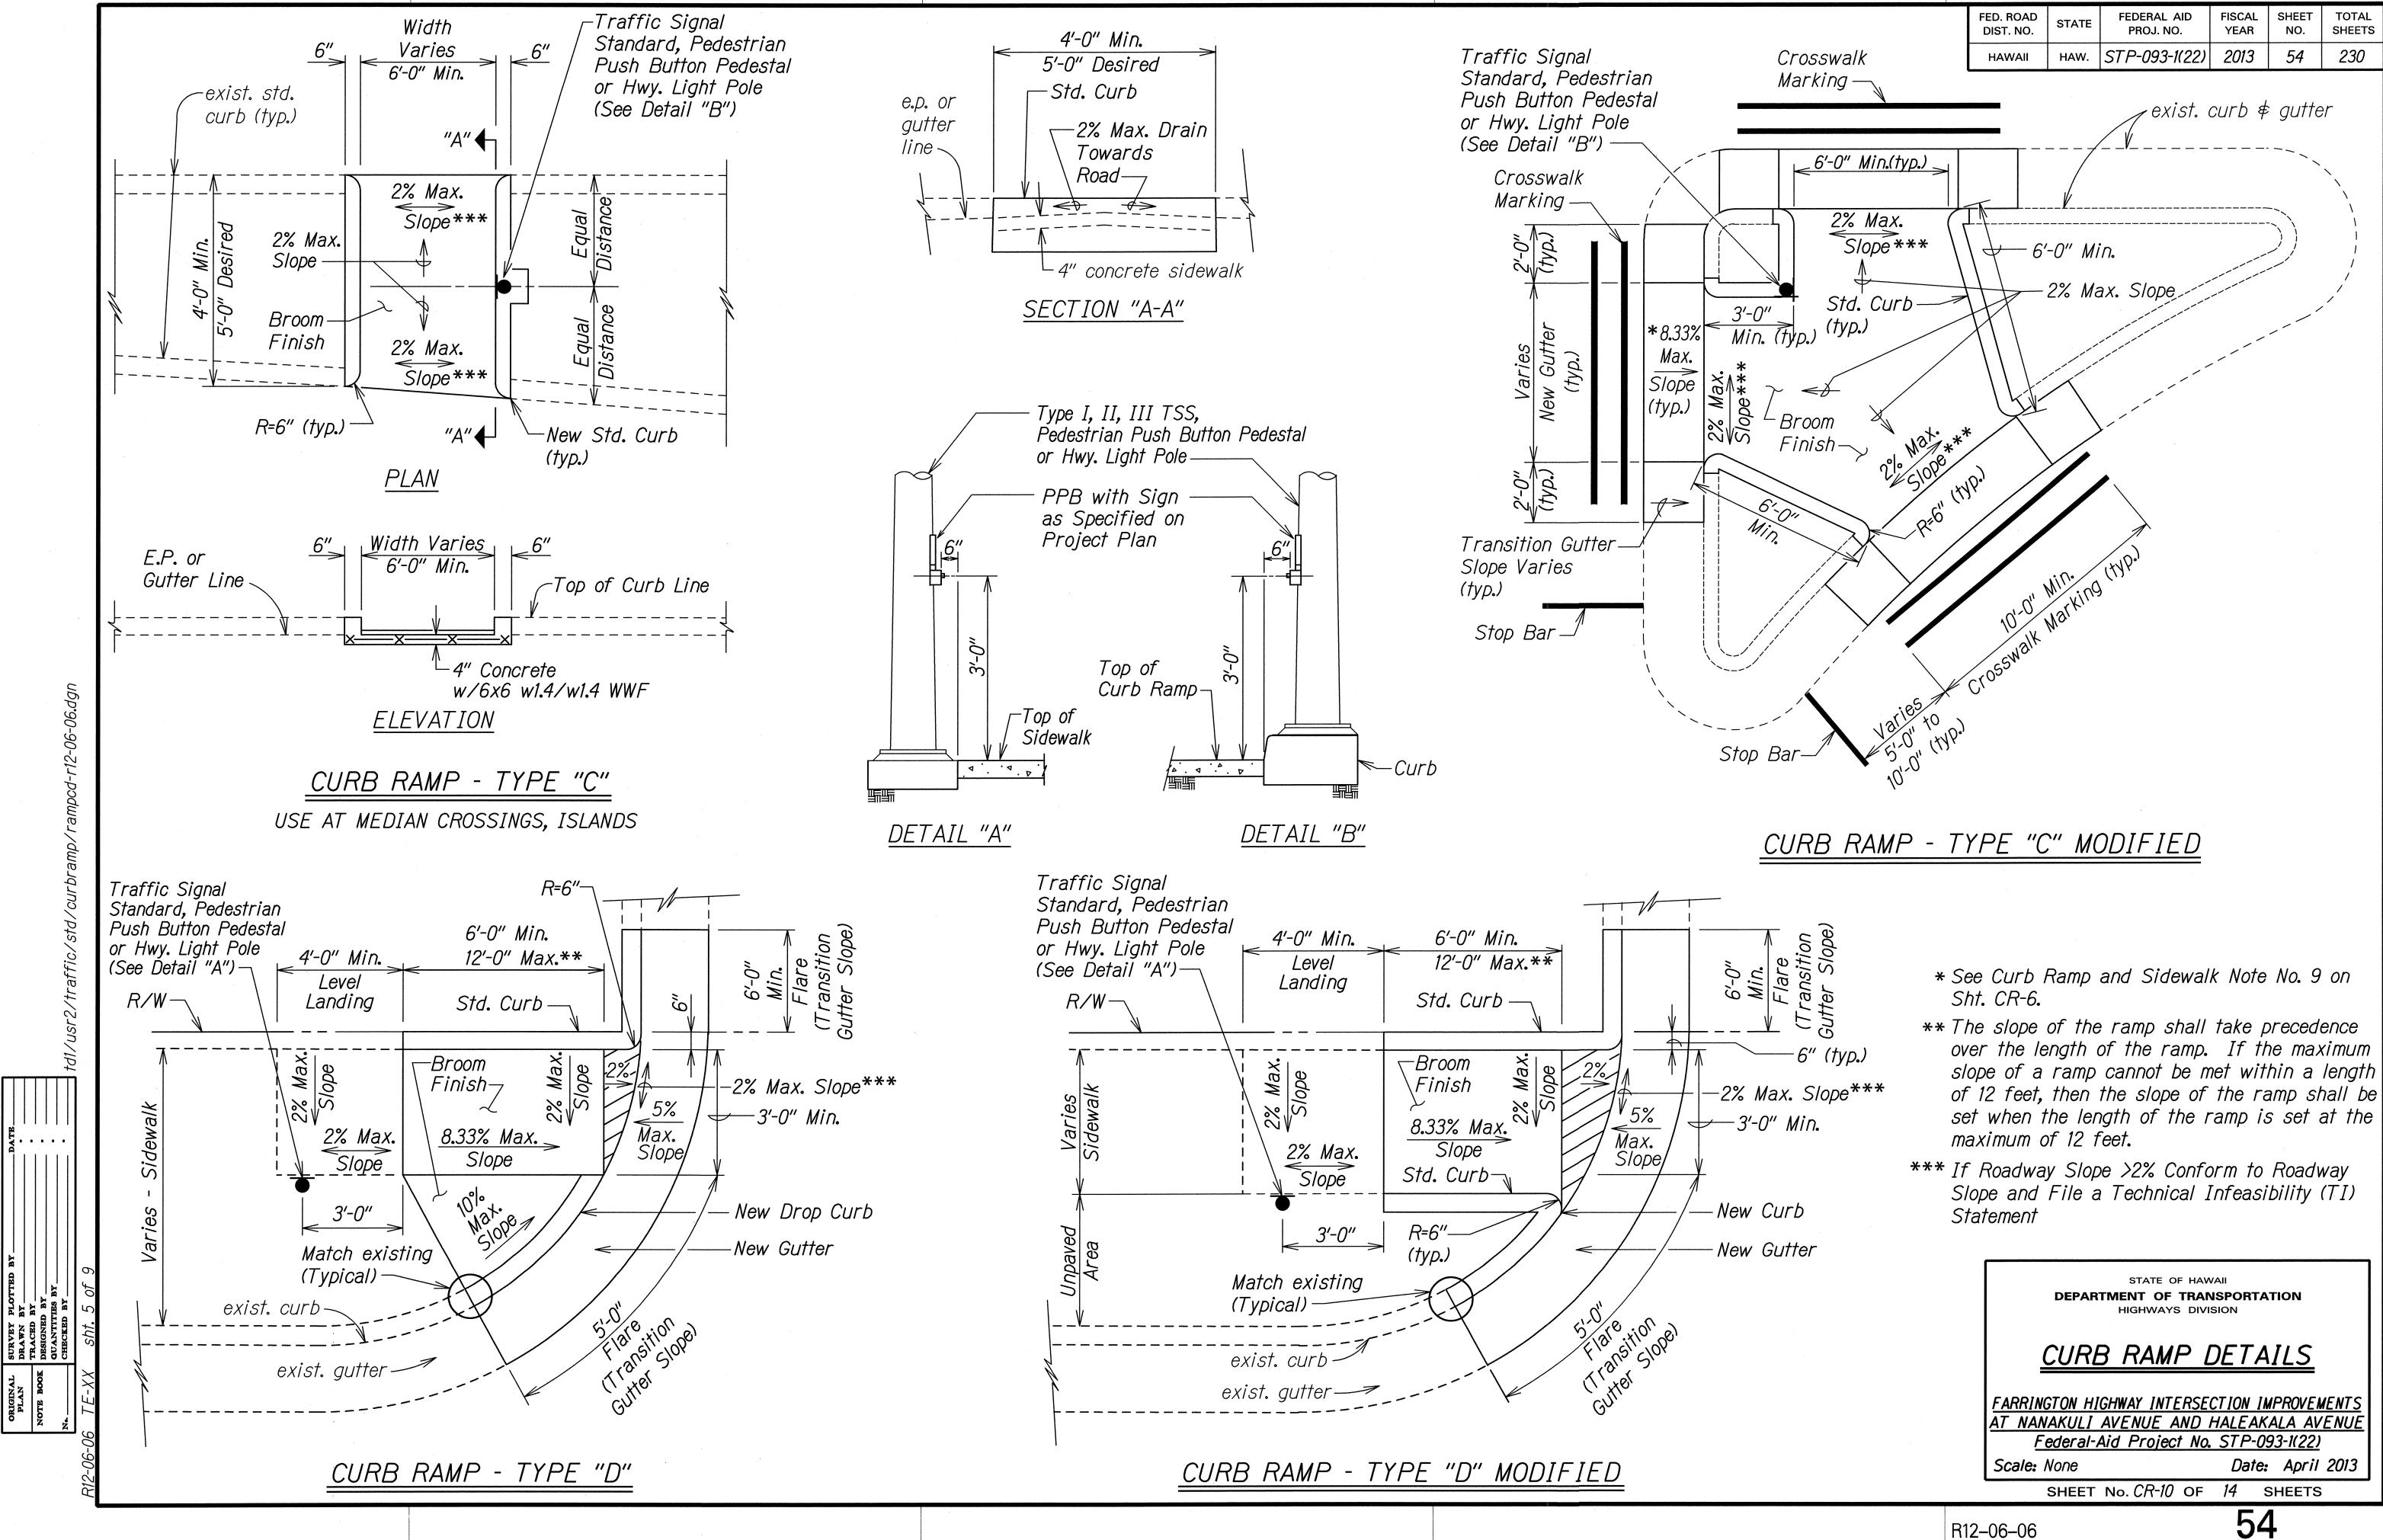

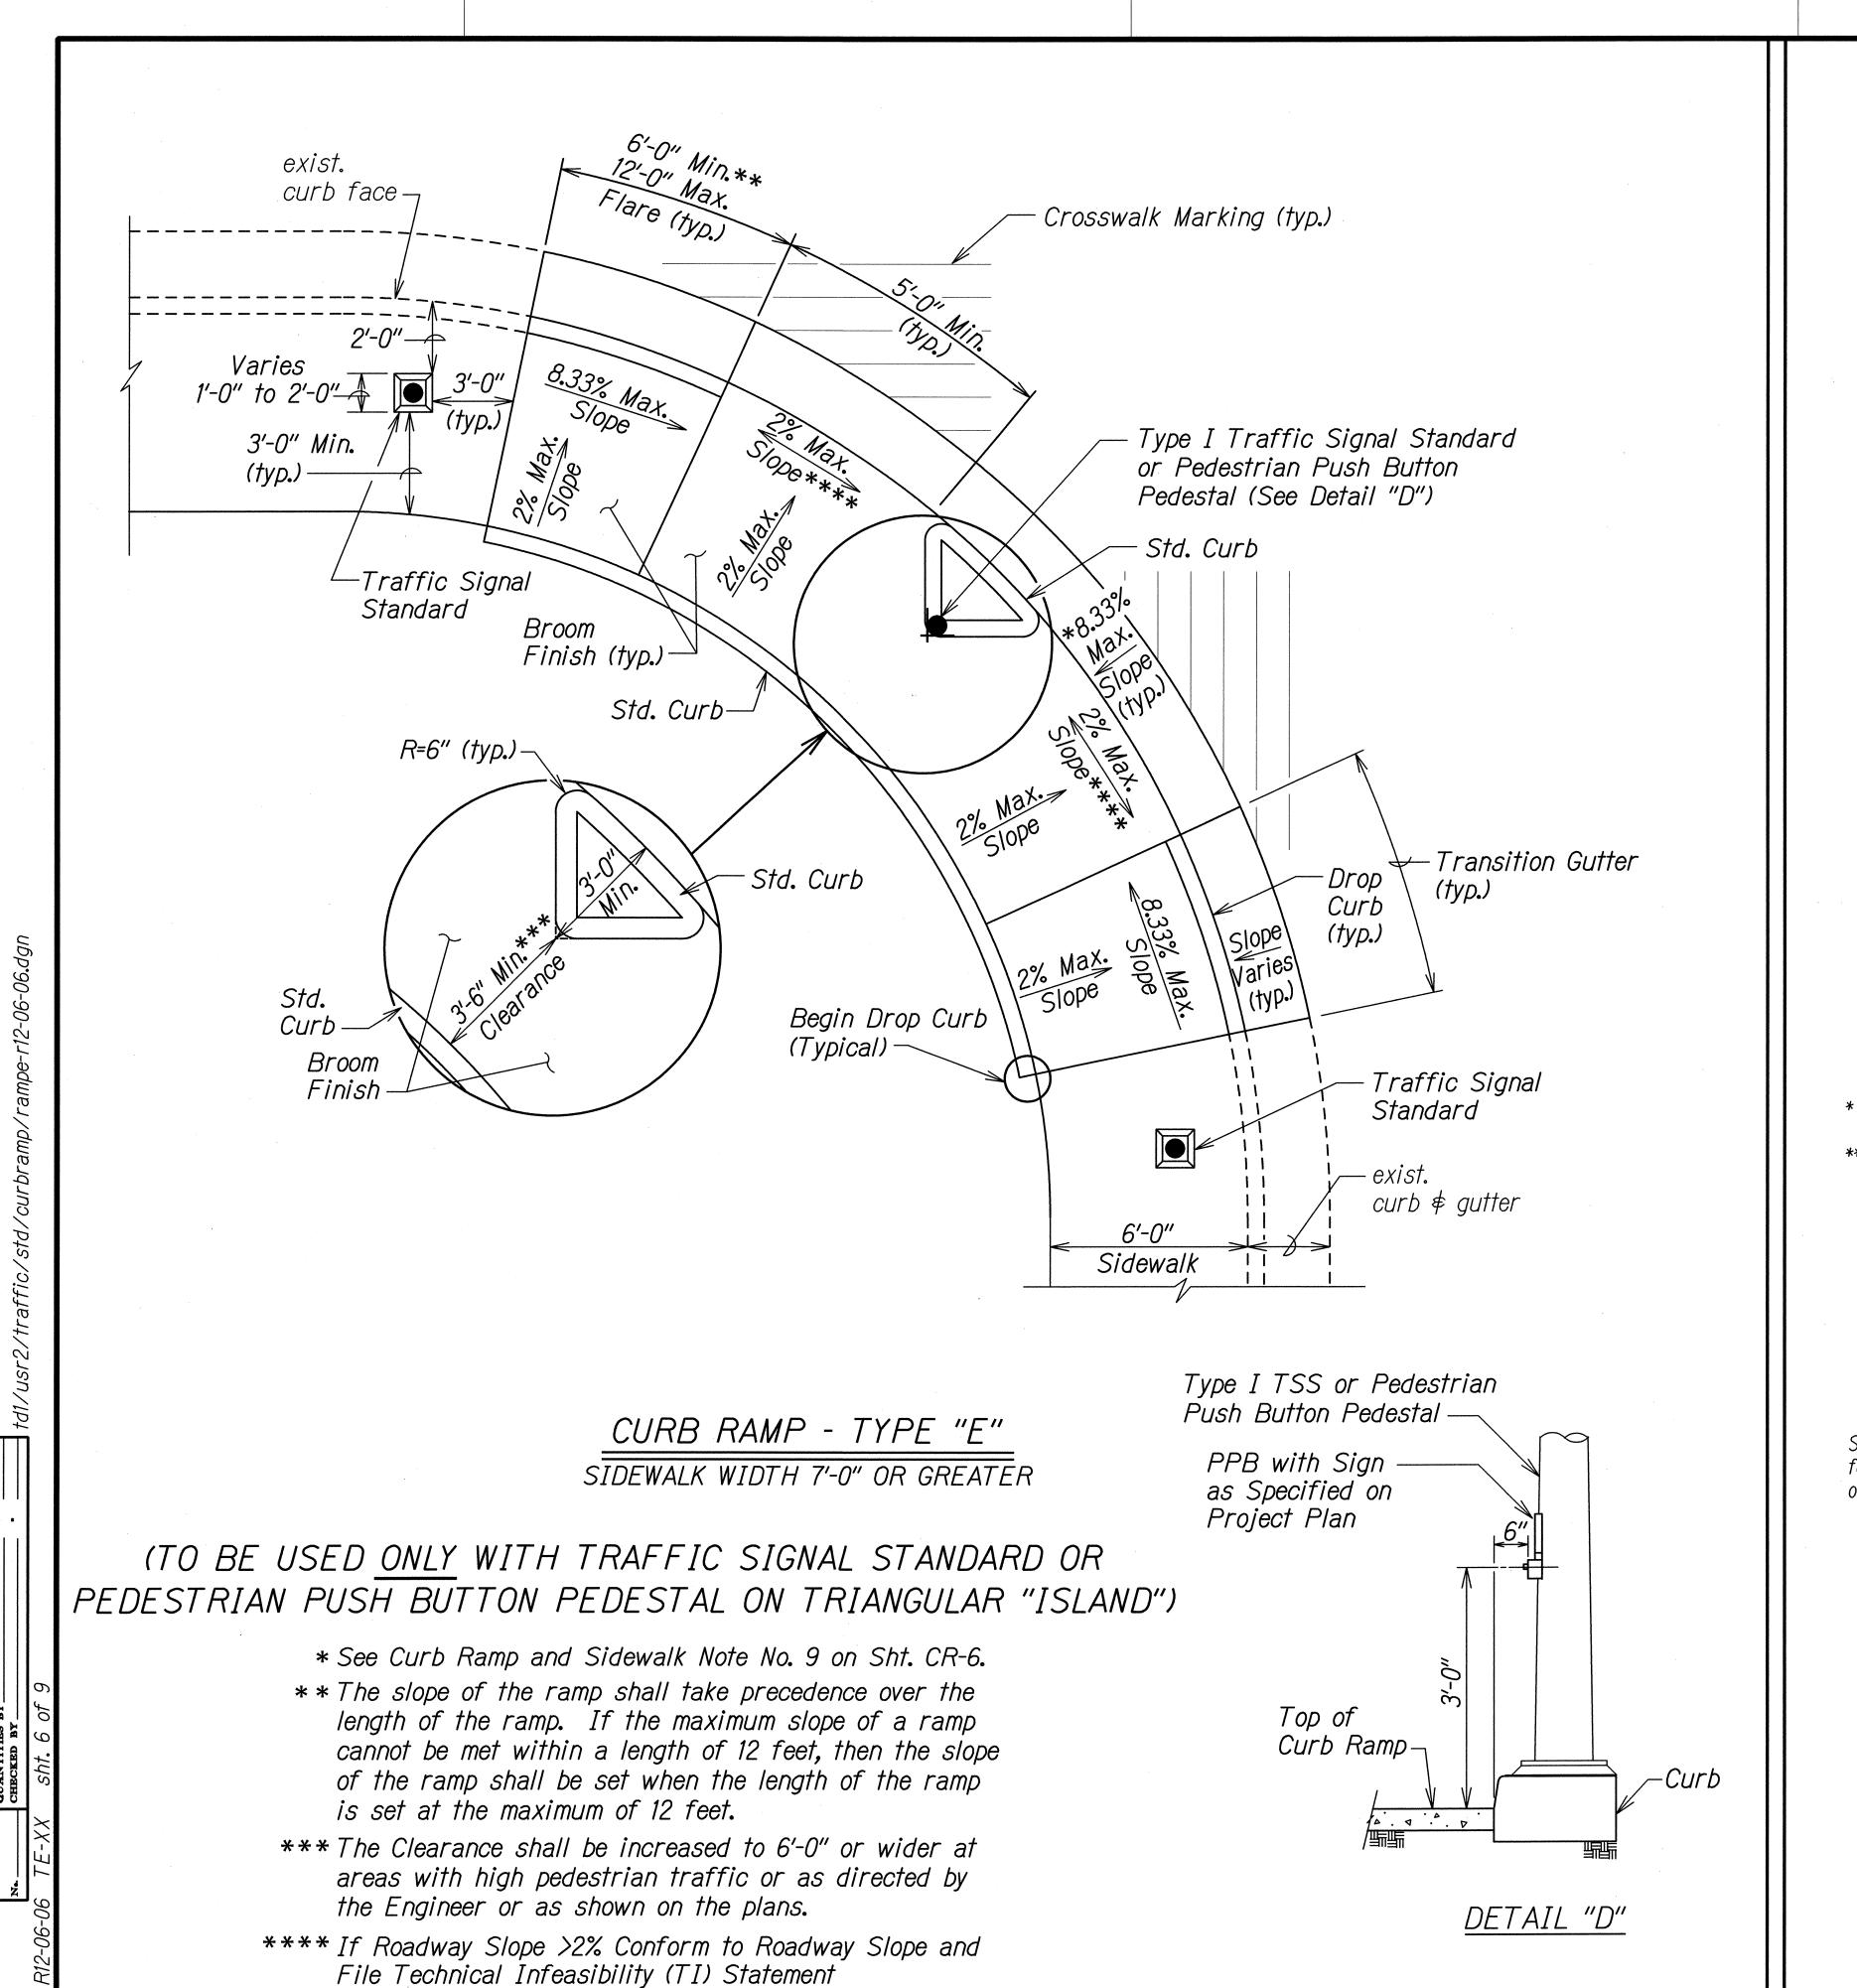

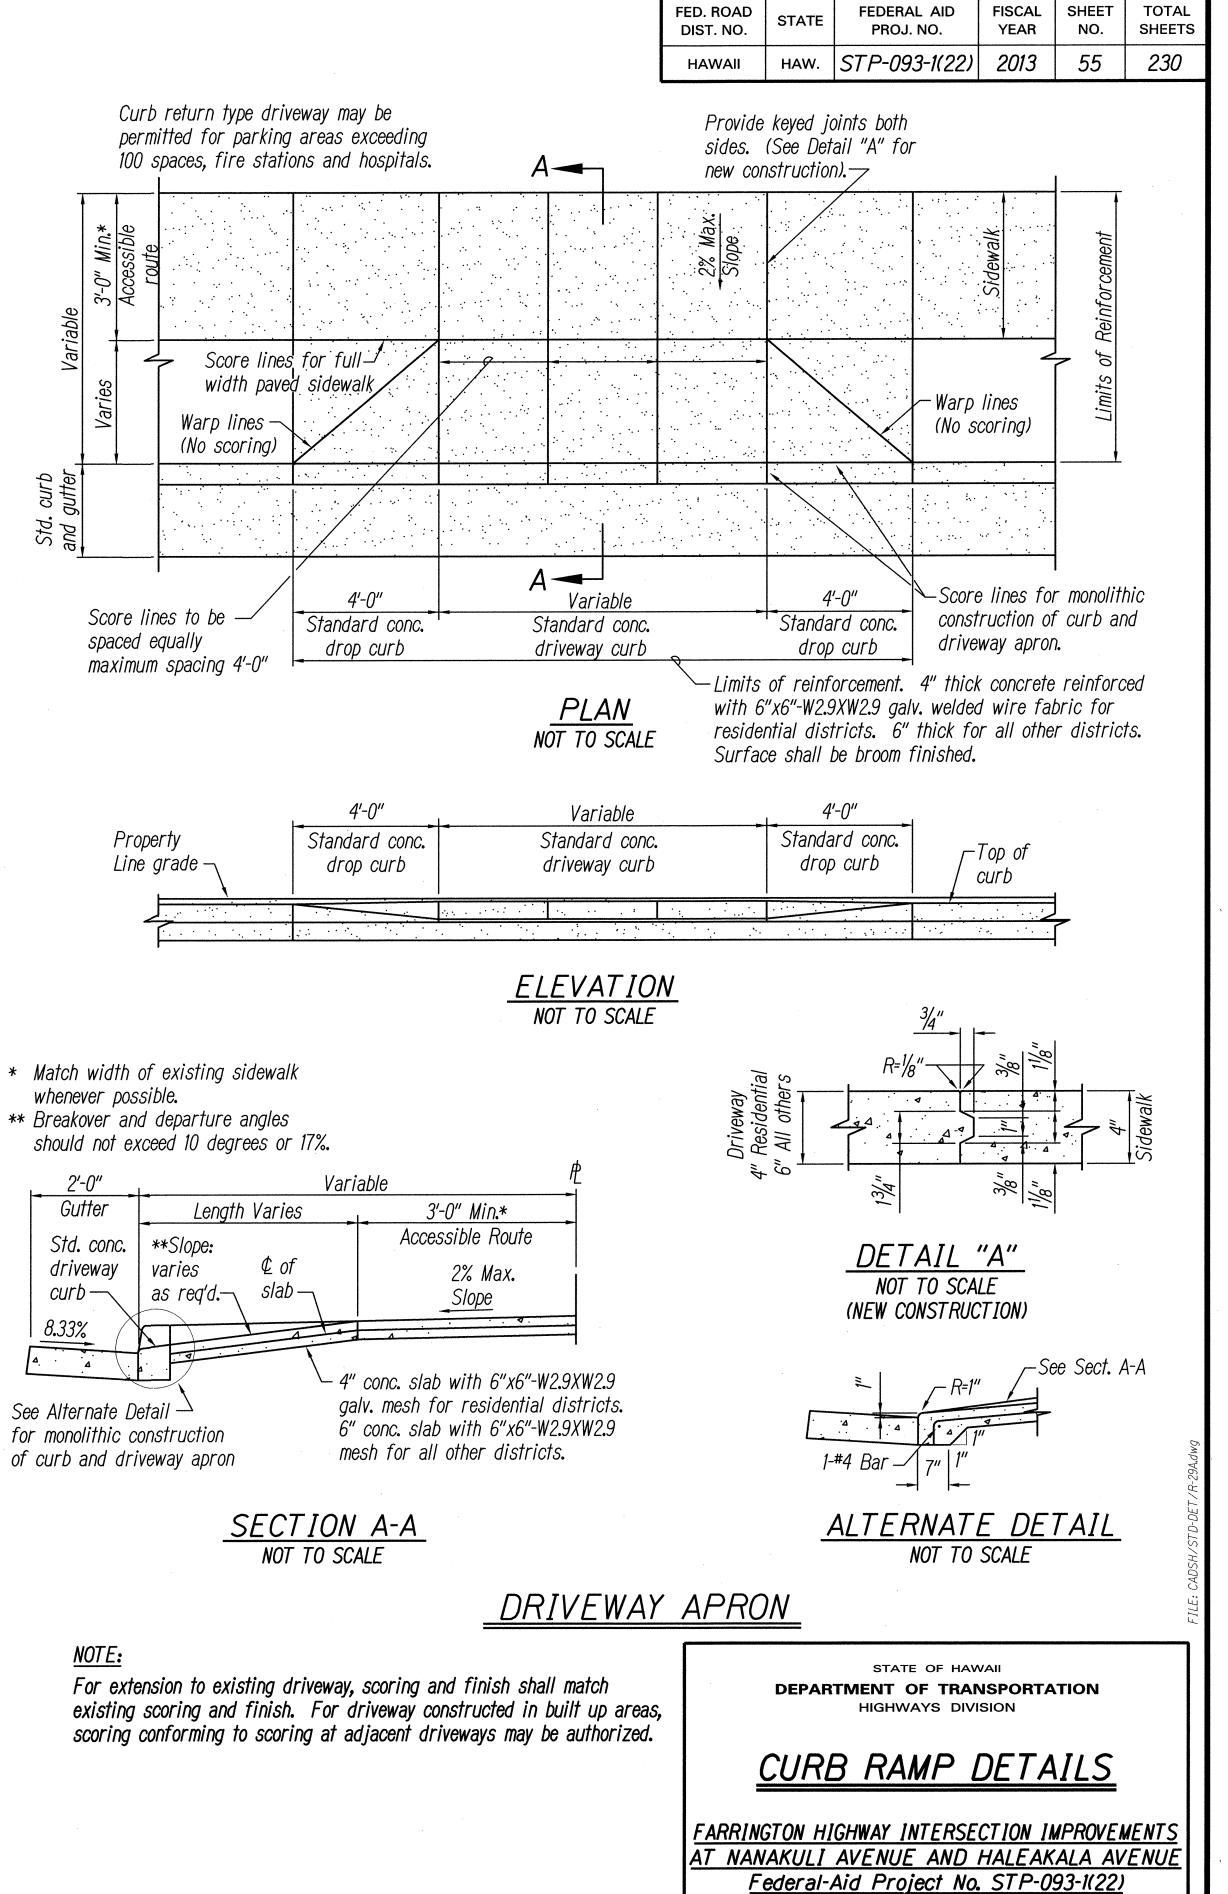
FEDERAL AID


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SHEET No. CR-11 OF 14 SHEETS

Date: April 2013

Scale: None




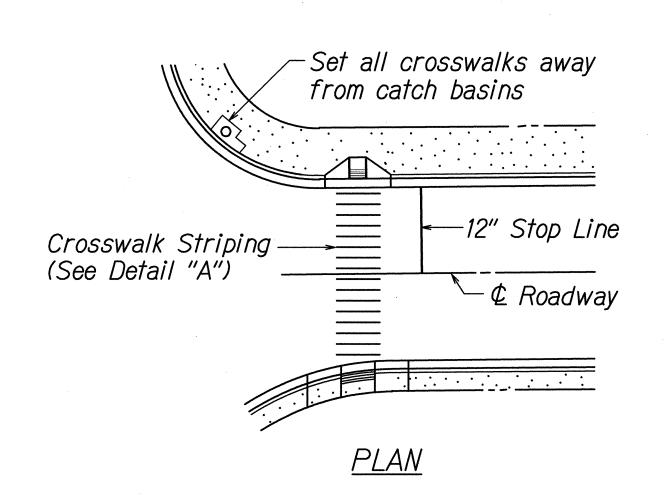

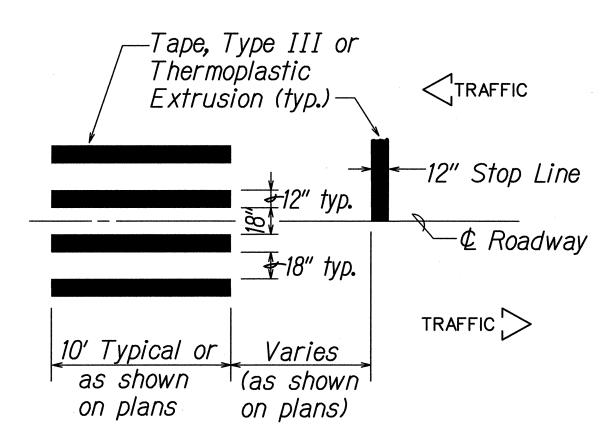
DETAIL "A"

CROSSWALK STRIPING DETAIL


NOTE: Longitudinal lines shall be parallel to traffic flow.

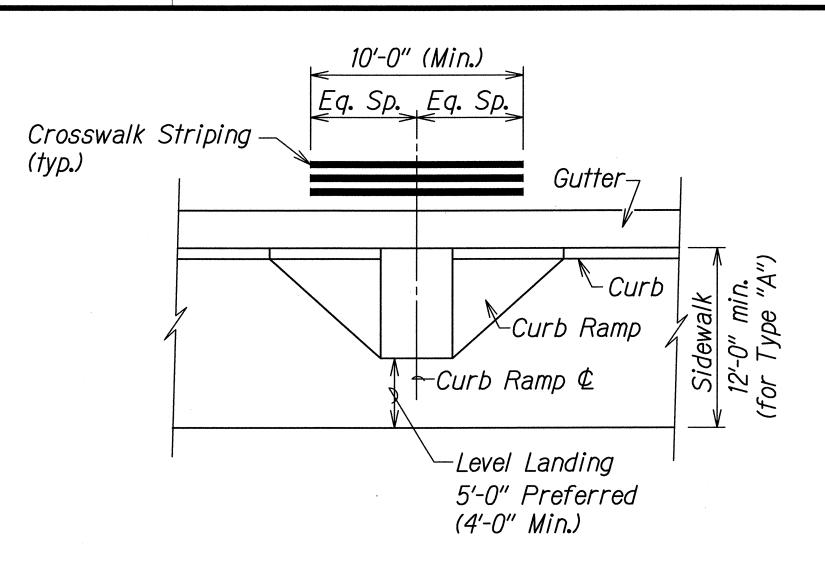

TYPICAL CROSSWALK STRIPING AT CURB RAMP

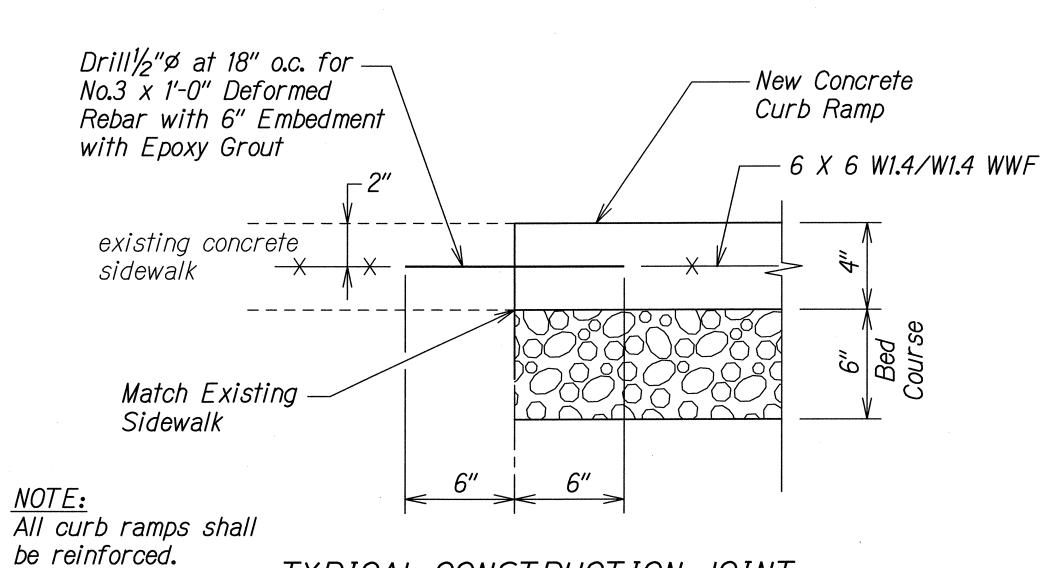



TYPICAL CONSTRUCTION JOINT AT EXISTING SIDEWALK

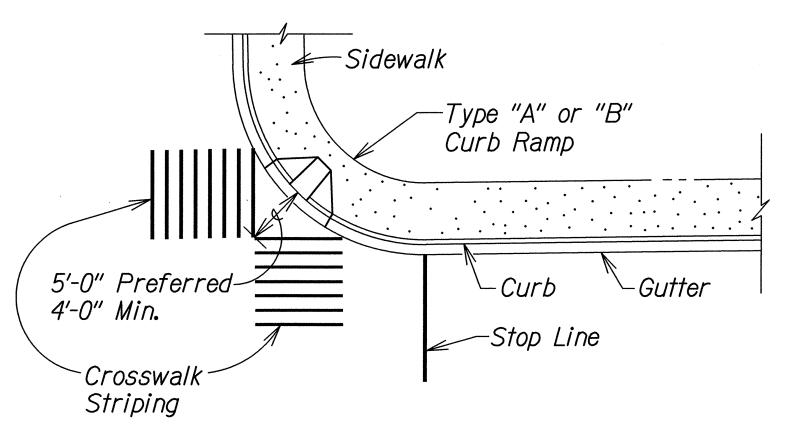

TYPICAL CROSSWALK STRIPING AT DIAGONAL CURB RAMP

FISCAL YEAR FED. ROAD DIST. NO. FEDERAL AID PROJ. NO. NO. SHEETS HAW. | STP-093-1(22) | 2013 *56* 230 HAWAII

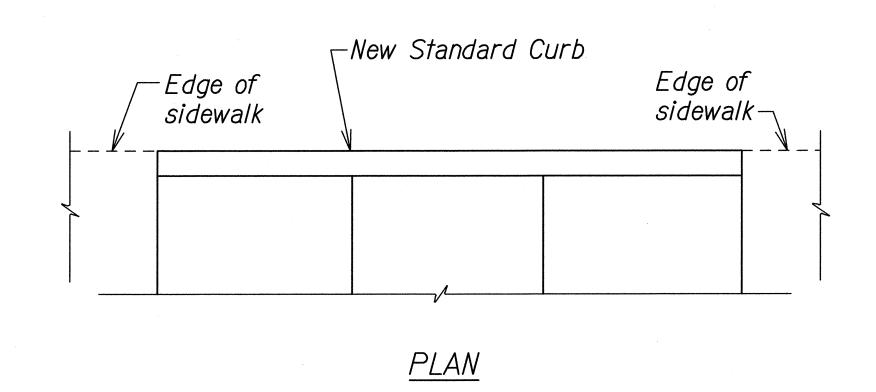

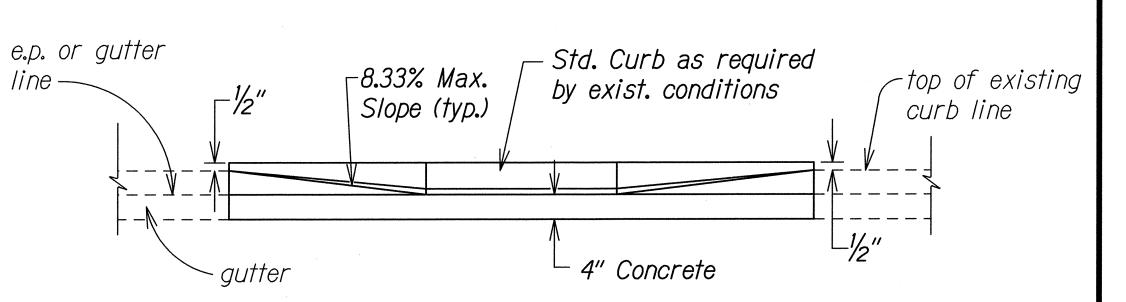

ELEVATION

DETAIL - BACK CURB

NOTE:

This detail can be used in situations where the edge of sidewalk cannot be flush with the face of (back) curb due to right of way restrictions.


> STATE OF HAWAII **DEPARTMENT OF TRANSPORTATION** HIGHWAYS DIVISION


MISCELLANEOUS DETAILS


FARRINGTON HIGHWAY INTERSECTION IMPROVEMENT AT NANAKULI AVENUE AND HALEAKALA AVENUE Federal-Aid Project No. STP-093-1(22) Scale: None Date: April 2013

SHEET No. CR-12 OF 14 SHEETS

R12-06-06

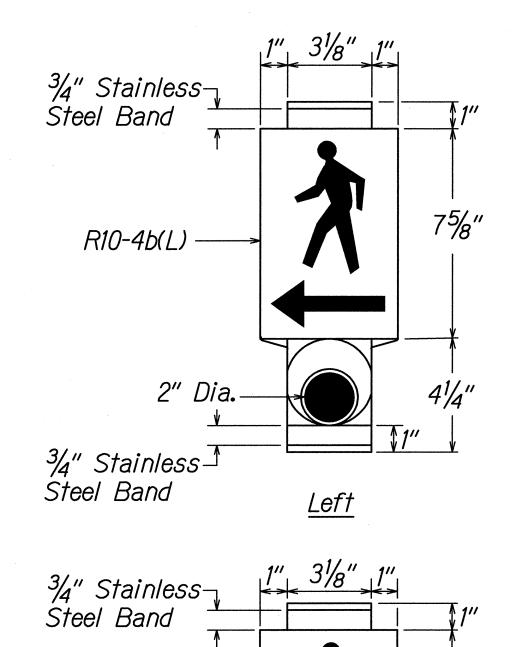


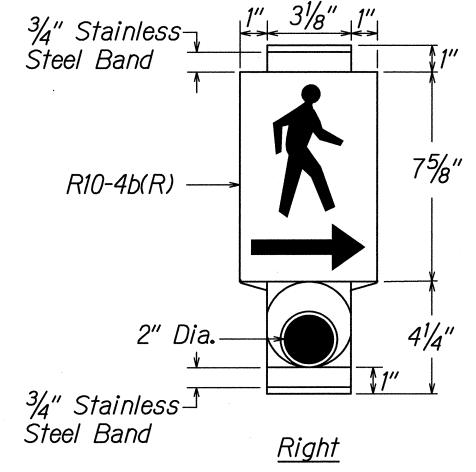

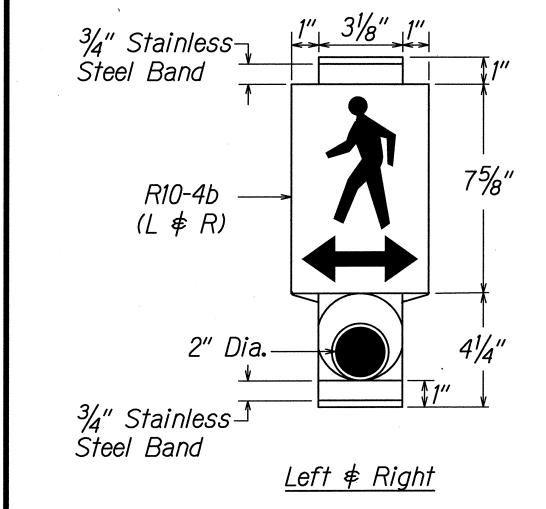

PEDESTRIAN PUSH BUTTON WITH SIGN

Man, Arrow ♦ Push Button - White Background - Black

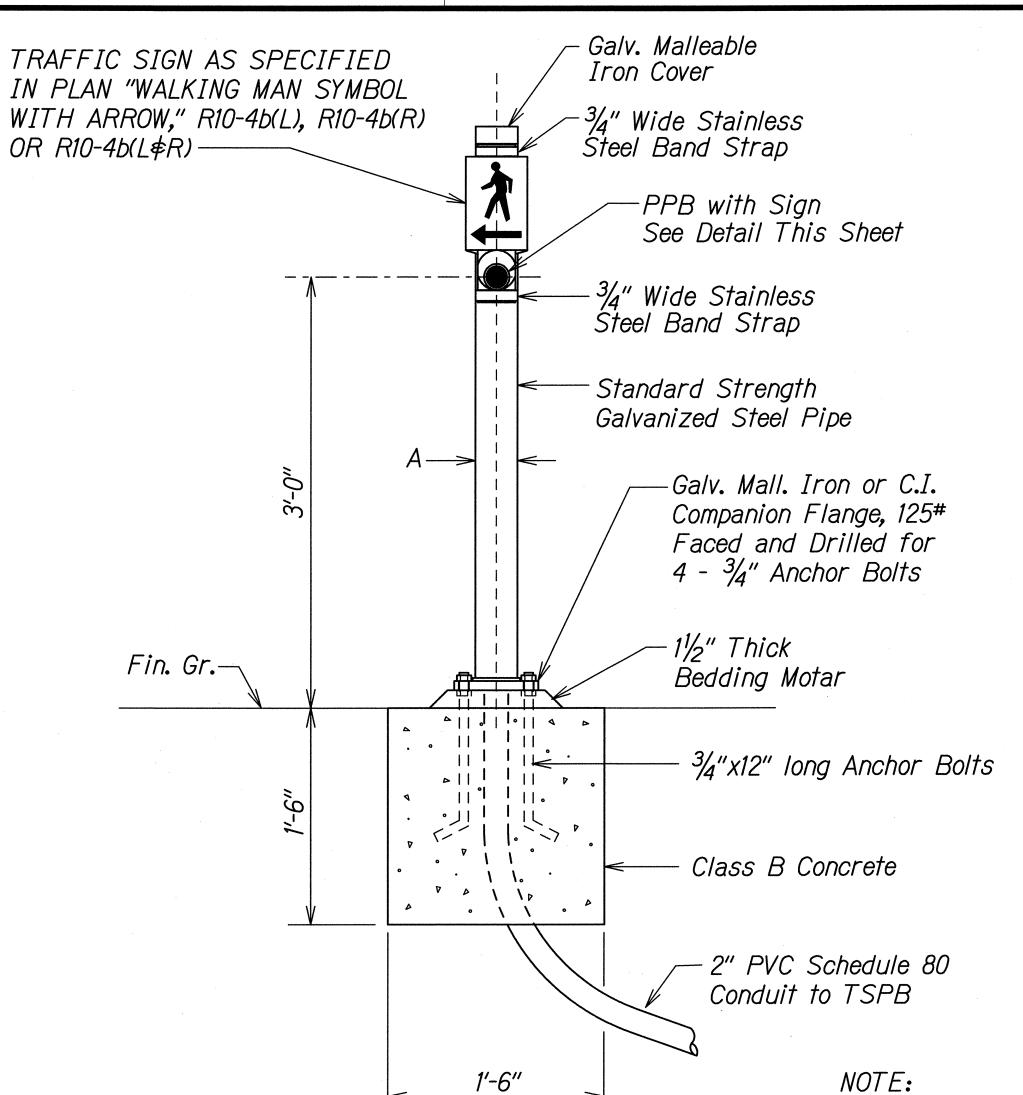

DATA TABLE FOR PPB POST			
DIMENSIONS			
Α	В		
31/2"	8"		
41/2"	9"		
	DIMEN A 3½"		


PPB POST AND FOOTING DETAIL


Square

- 1. Conduits shall protrude 2" max. above finished surface of foundation.
- 2. Conduits shall slope away from post foundation.

GENERAL NOTES:


- 1. There shall be a 30" x 48" level ground surface (2% max. cross slope, both directions) for a forward or side approach, as appropriate, to a pedestrian push button. Location of pedestrian push button shall be shown on Civil Plans in addition to Electrical Plans.
- 2. At intersection corners where two pedestrian push buttons are provided, the push buttons should be separated by a distance of at least 10 ft. and located as follows:
 - A. adjacent to a level all-weather surface to provide access from a wheelchair and, where there is an all-weather surface, wheelchair accessible route to the ramp
 - B. within 5 ft. of the crosswalk extended
 - C. within 10 ft. of the edge of the curb, shoulder or pavement
 - D. parallel to the crosswalk to be used

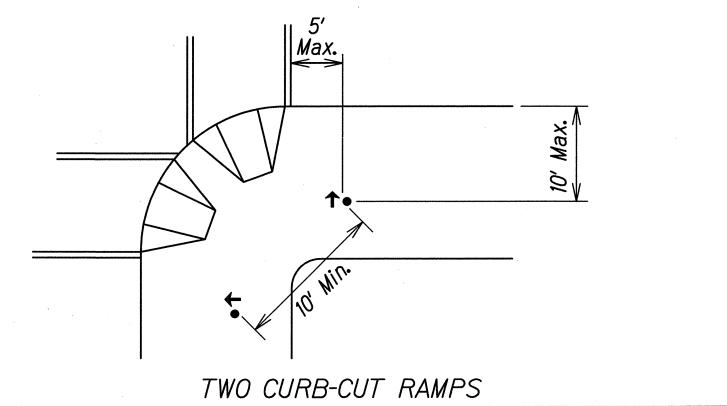


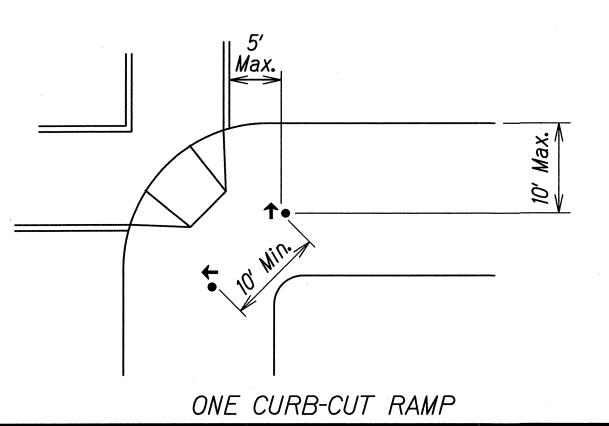

FED. ROAD DIST. NO. STATE FEDERAL AID PROJ. NO. SHEETS

HAWAII HAW. STP-093-1(22) 2013 57 230

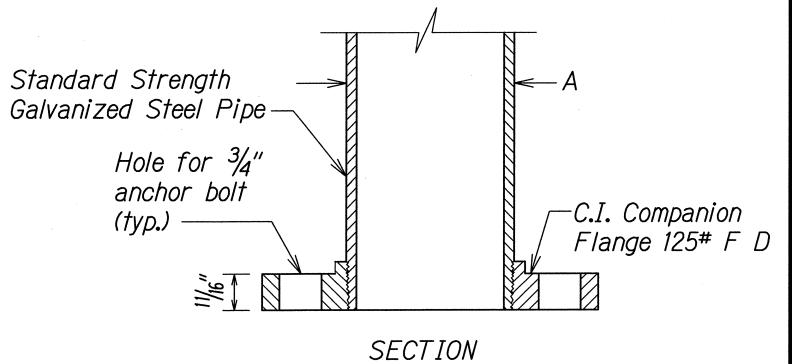

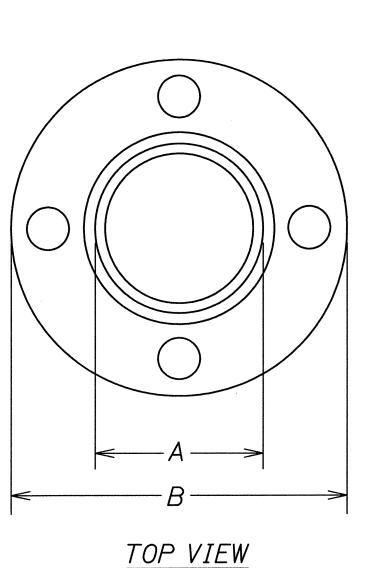

FLANGE DETAIL

STATE OF HAWAII

DEPARTMENT OF TRANSPORTATION

HIGHWAYS DIVISION


PEDESTRIAN PUSH BUTTON DETAILS

FARRINGTON HIGHWAY INTERSECTION IMPROVEMENTS
AT NANAKULI AVENUE AND HALEAKALA AVENUE
Federal-Aid Project No. STP-093-1(22)


Scale: None
Date: April 2013

SHEET No. CR-13 OF 14 SHEETS


57

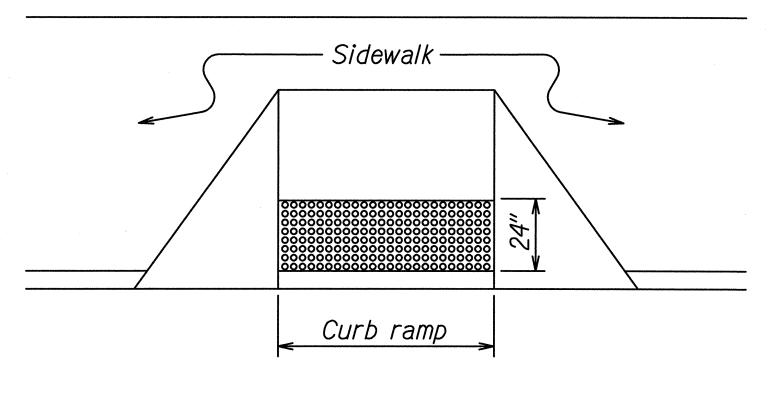

DETECTABLE WARNING AT CURB RAMP

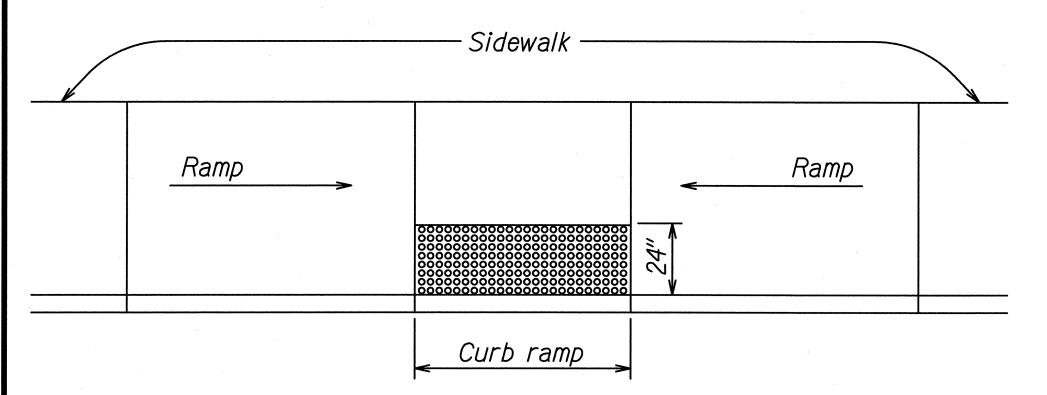

TRANSITION RAMP WITH DETECTABLE WARNING

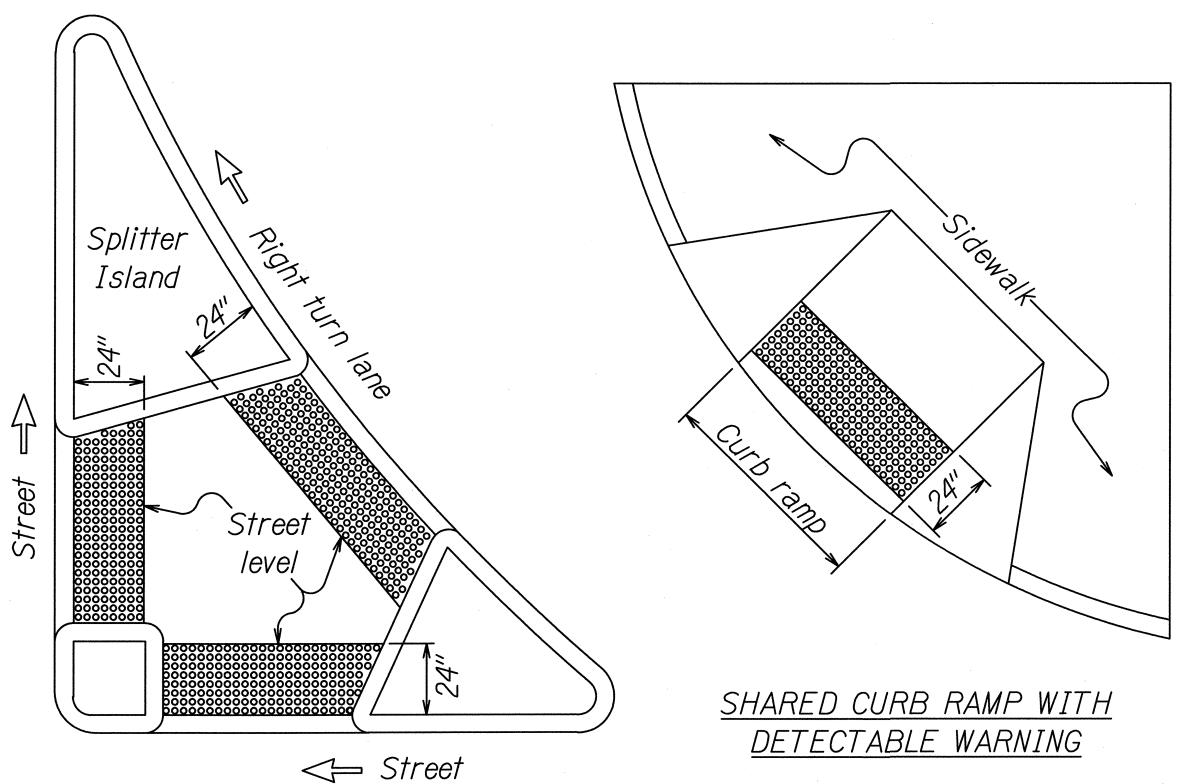


REFUGE ISLAND WITH

DETECTABLE WARNING

FED. ROAD DIST. NO. STATE FEDERAL AID PROJ. NO. FISCAL SHEET TOTAL SHEETS

HAWAII HAW. STP-093-1(22) 2013 58 230

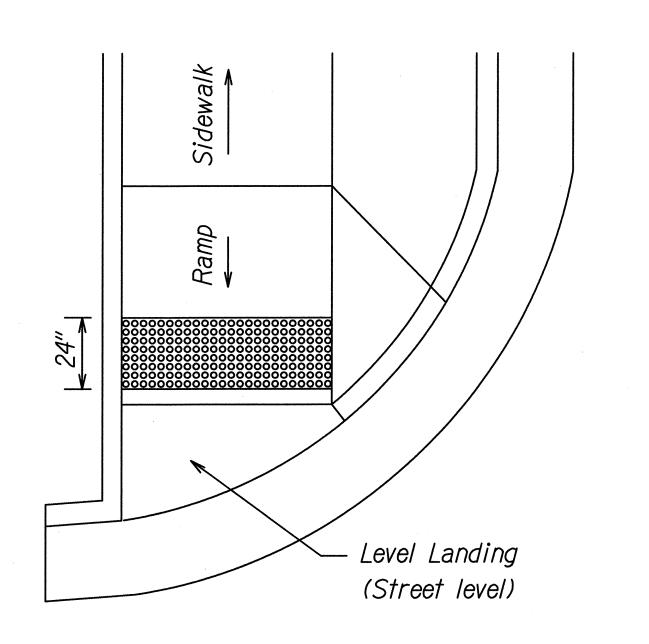

END OF SIDEWALK CURB RAMP WITH


DETECTABLE WARNING

TYPICAL INSTALLATION OF DETECTABLE WARNINGS

Not to Scale

NOTES:


- 1. Detectable warnings shall be 24 inches in the direction of travel and extend the full width of the curb ramp or flush surface (does not include flares).
- 2. Truncated domes shall have a diameter of 0.9 to 1.4 inch at the bottom, a diameter of 50%-65% of the base diameter at the top, a height of 0.2 inch and a center-to-center spacing of 1.6 to 2.4 inches measured along one side of a square arrangement.
- 3. Domes shall be aligned on a square grid in the predominant direction of travel to permit wheels to roll between the domes.
- 4. There shall be a minimum of 70 percent contrast in light reflectance between the detectable warning and an adjoining surface, or the detectable warning shall be "safety yellow".
- 5. The material used to provide visual contrast shall be an integral part of the detectable warning surface.
- 6. The detectable warning shall be located so that the edge nearest the curb line or other potential hazard is 6 to 8 inches from the curb line.

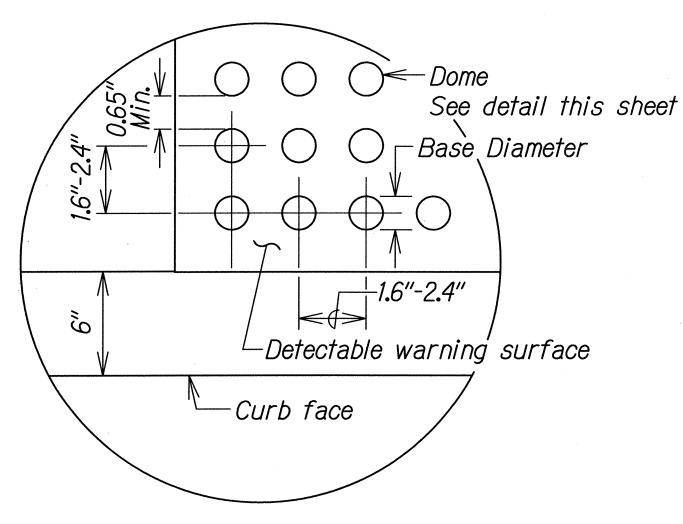

<u>ENLARGEMENT</u>

DETECTABLE WARNING DETAIL

Not to Scale

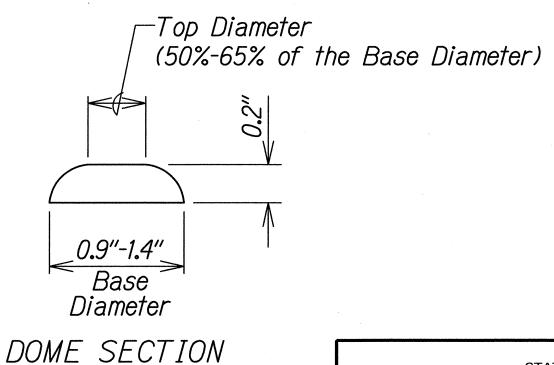

STATE OF HAWAII

DEPARTMENT OF TRANSPORTATION
HIGHWAYS DIVISION

DETECTABLE WARNING DETAILS

FARRINGTON HIGHWAY INTERSECTION IMPROVEMENTS
AT NANAKULI AVENUE AND HALEAKALA AVENUE
Federal-Aid Project No. STP-093-1(22)

Scale: None
Date: April 2013

SHEET No. CR-14 OF 14 SHEETS

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R12-06-06

