



NOTE(S):


- DIGITAL POSITION AND ZOOM CONTROL FEEDBACK USING "D" PROTOCOL.
- UL LISTED, RATED FOR FULL CONTINUOUS DUTY, CE CLASS B.
- ASSEMBLY RATED FOR 90 MPH OPERATION.




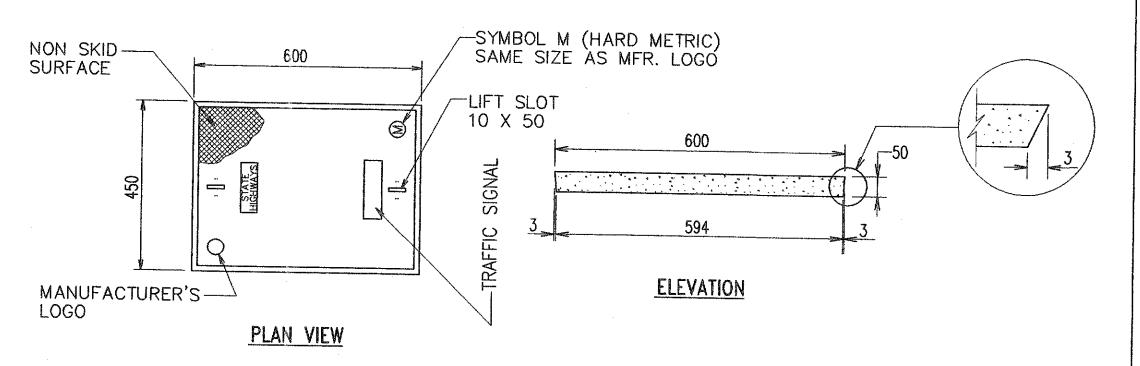

POLYMER CONCRETE COVER DETAIL NOT TO SCALE

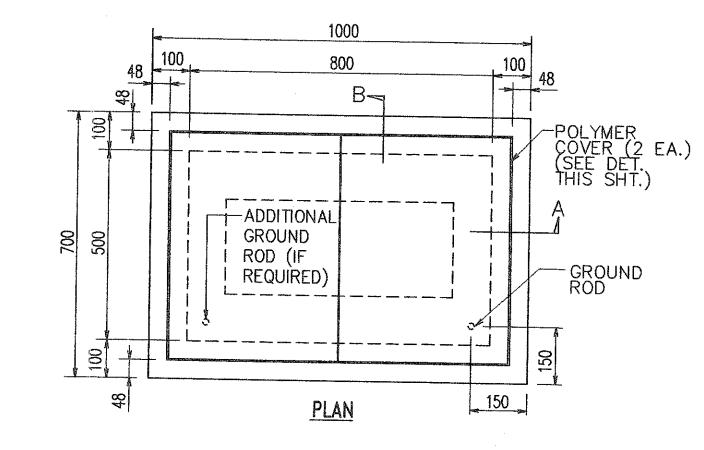

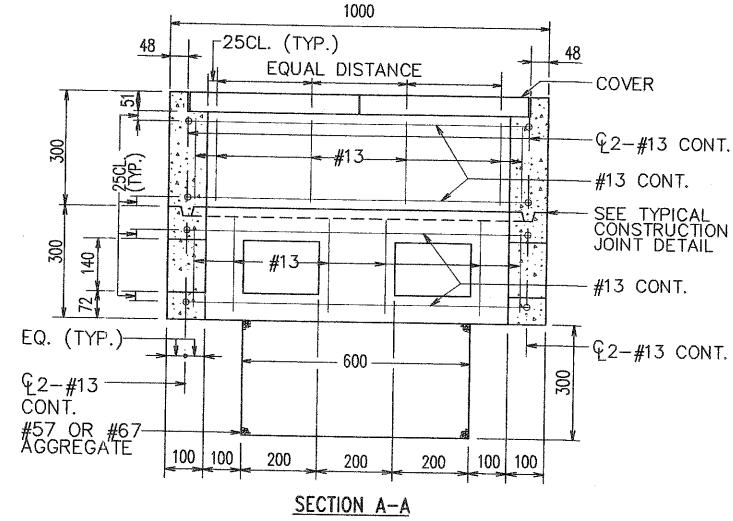

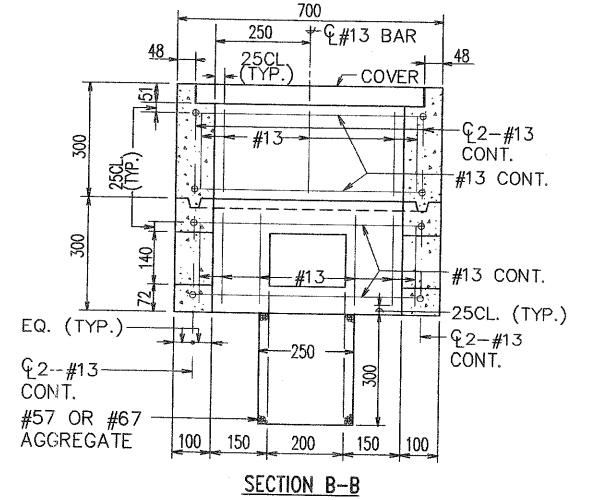


B TYPE "B" PULLBOX (OLD TYPE "C") E-40 NOT TO SCALE

GENERAL NOTES

DIST. NO.	STATE	FED. AID PROJ. NO.	FISCAL YEAR	SHEET NO.	TOTAL SHEET:
HAWAII	HAW.	STP-0001 (30)	2007	42	89

- PROVIDE A MINIMUM OF ONE 16 X 2.5M COPPERWELD GROUND ROD IN EACH PULLBOX. WHEN DIRECTED BY THE TRAFFIC SIGNAL INSPECTOR/ENGINEER, INSTALL ADDITIONAL GROUND RODS. COST OF GROUND RODS SHALL BE INCIDENTAL TO THE
- 2. ALL PRE-CAST CONCRETE PULLBOXES SHALL BE MANUFACTURED IN TWO PIECES.
- 3. THE PULLBOX WITH COVER SHALL BE CAPABLE OF SUPPORTING AN MS 18 LOADING.
- 4. THE MAXIMUM WEIGHT OF THE PULLBOX COVER SHALL NOT EXCEED 27 KILOGRAMS.
- 5. THE OPENINGS FOR THE CONDUITS ON ALL PULLBOXES SHALL BE PRE-CAST CONCRETE
- 6. AFTER INSTALLING THE CONDUITS IN THE OPENINGS OF THE PULLBOXES, THE CONTRACTOR SHALL FILL THE EXCESS OPENING IN THE PRE—CAST KNOCKOUTS WITH CONCRETE MORTAR.
- TRENCH AND ACHIEVE A MINIMUM OF 95% RELATIVE COMPACTION OF THE BOTTOM OF THE TRENCH.
- 8. ALL CONCRETE SHALL BE CLASS A (25MPA, MIN.)
- 9. REBARS SHALL BE GRADE 300 AND ALL LAPPED SPLICES SHALL BE 360MM MINIMUM.
- 10. THE #57 OR #67 SIZE AGGREGATE SHALL CONFORM TO LATEST VERSION OF AASHTO M43 (ASTM D 448).
- 11. TYPE "C" PULLBOX SHALL BE INSTALLED IN A LOCATION PROTECTED FROM VEHICULAR TRAFFIC (I.E. RAISED SIDEWALK, BEHIND A.C. CURBS, TRAFFIC SIGNAL STANDARD OR PIPE GUARDS).

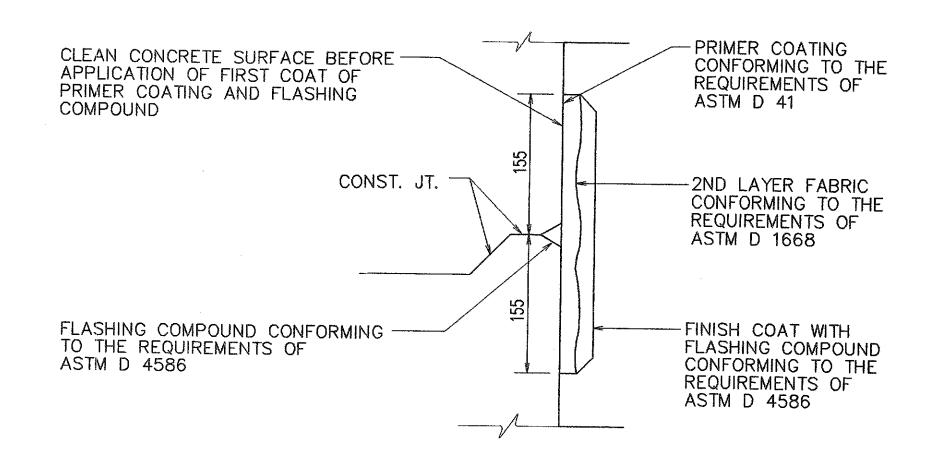



C TYPICAL FLASHING COMPOUND WATERPROOFING DETAILS NOT TO SCALE

ALL DIMENSIONS ARE IN MILLIMETERS UNLESS OTHERWISE SHOWN

		REVISION	DATE	BRIE	F	BY	APPROVED
	LICENGED PROFESSIONAL ENGINEER No. 7637-6 AWAII, U.S.**	C: FE	ITY A Dera	NT OF TRANS	STP-000 STP-000 SE 9	NOLU 01(30	LU))
	THIS WORK WAS PREPARED BY ME OR UNDER MY SUPERVISION. LIC. EXPIRATION: 4/30/08	ENGINEER. DRAFTSMA CHK. BY APPROVED DIRECTOR		GTN SS	O/316.	RCH 20 S NOTE	
) .	47 of 48 Sheets	E 40	ſ				teringger of another grades, as a fix on agin for an


Sheet No. 42 of 48 Sheets **E-40**

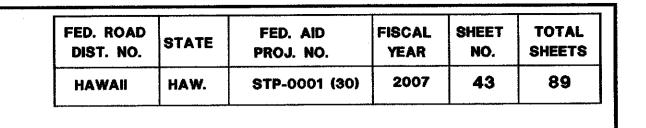

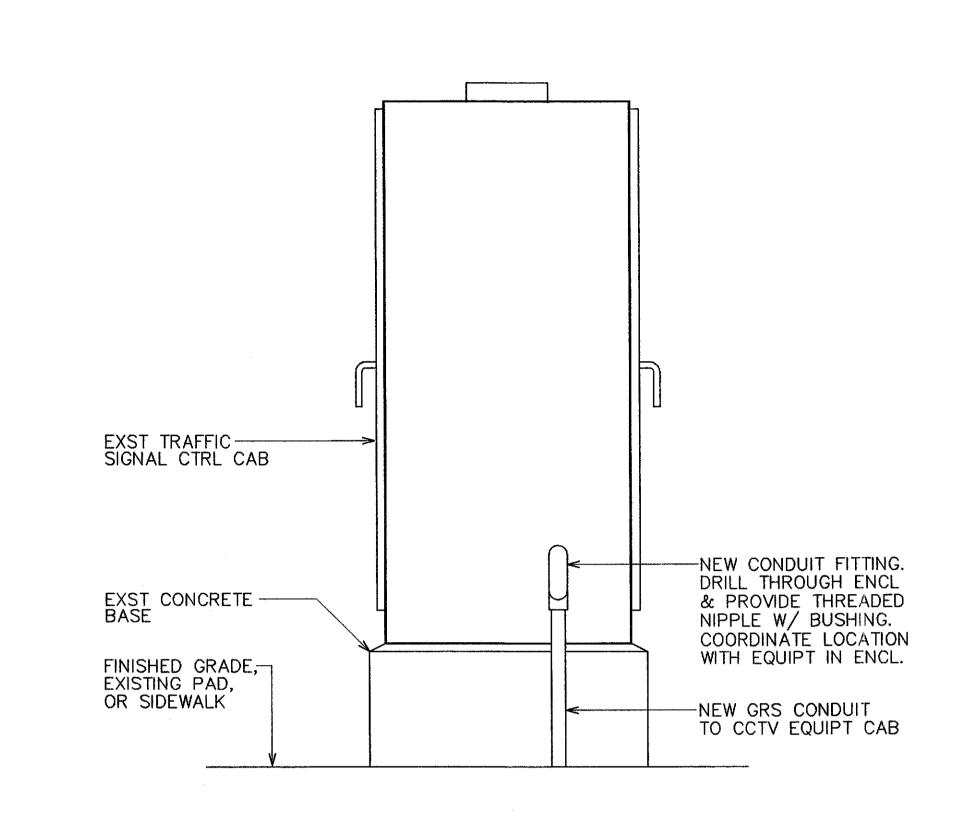


SIDE VIEW

C DETAIL - EQUIPMENT CABINET PENETRATION NOT TO SCALE

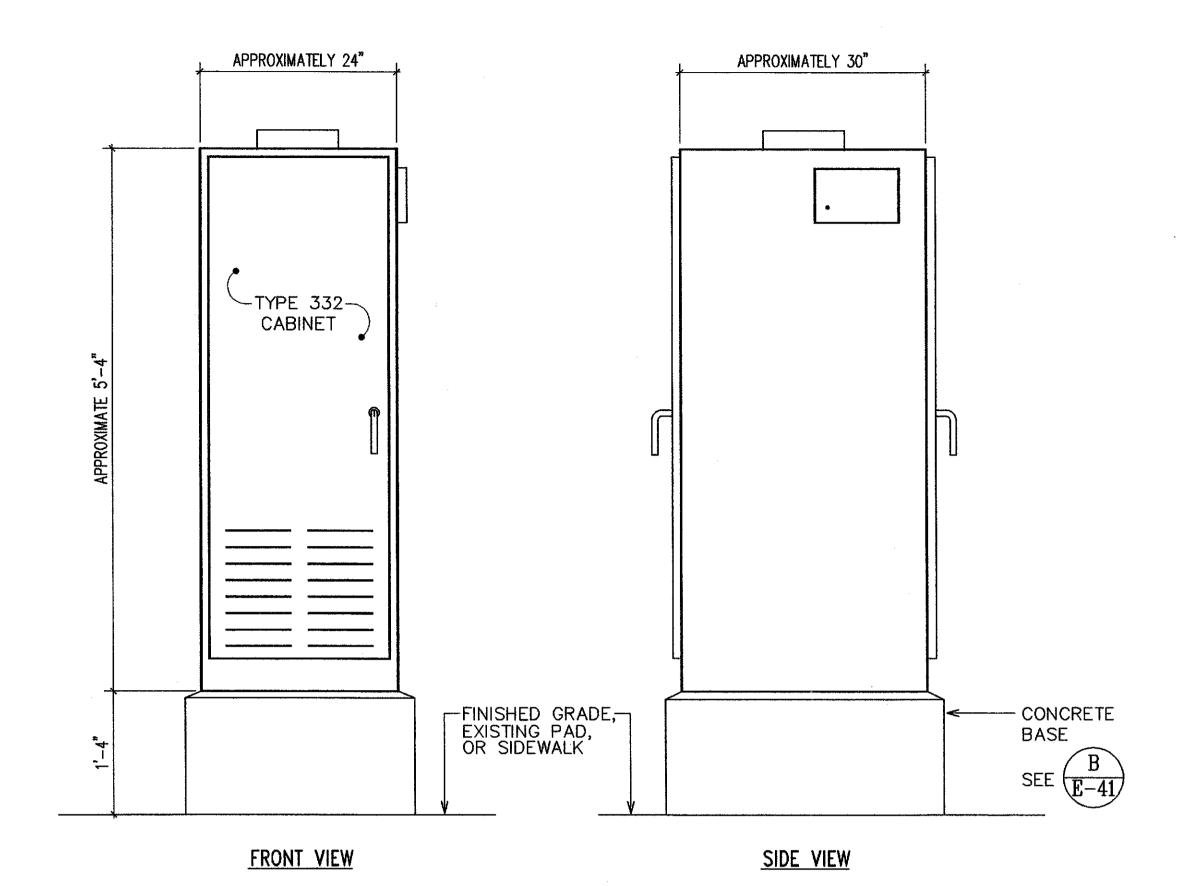


A TYPE 332 VIDEO EQUIPMENT CABINET E-41 NOT TO SCALE

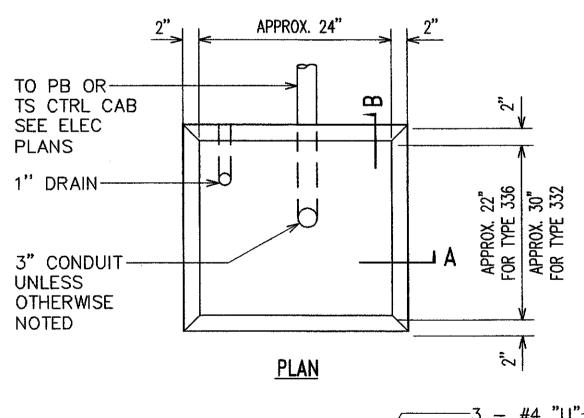

NOTE(S):

- 1. CONCRETE SHALL BE CLASS "B".
- 2. DIMENSIONS SHALL BE ALTERED TO SUIT CONTROLLER CABINET ACTUALLY FURNISHED.
- 3. CONDUIT BENDS AND DRAIN ARE INCIDENTAL TO CONCRETE BASE.
- 4. REFER TO CABINET MANUFACTURER'S SPECIFICATIONS FOR DETAILS OF ANCHOR BOLTS AND BASE SETTING.
- 5. ALL EXPOSED SURFACES OF CONCRETE BASE SHALL BE GIVEN A CLASS 2, RUBBED FINISH.

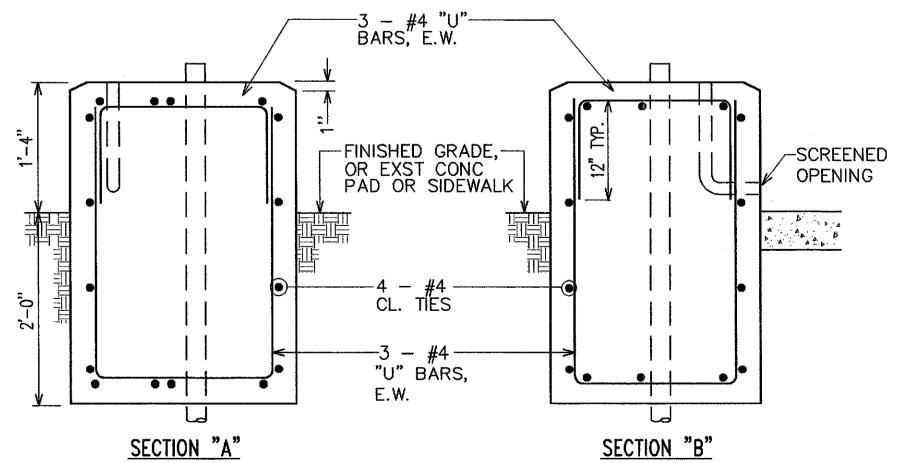

B TYPE "D" CONCRETE BASE EQUIPMENT CABINET E-41 NOT TO SCALE

BY APPROVED REVISION DATE DEPARTMENT OF TRANSPORTATION SERVICES CITY AND COUNTY OF HONOLULU FEDERAL AID NO. STP-0001(30) COMPUTERIZED TRAFFIC CONTROL SYSTEM PHASE 9

MISCELLANEOUS DETAILS

ENGINEERGTN	MARCH 2007 AS NOTED
CHK. BYSS	REF
APPROVED:	APPROVED:
DIRECTOR	DIVISION ENGINEER

DATE	LICENSED PROFESSIONAL ENGINEER No. 7837-E
DATE	
DATE	THIS WORK WAS PREPARED BY ME OR UNDER MY SUPERVISION


DATE	130	lu	XX	1-0-1 1/70/08	APPROVED:		APPR	OVED:		
	LIC	. EXPIR	ATIUN: 4	4/30/08	DIRECTOR		DIVISI	ON ENGINEER		
Sheet N	o. 43	of	48	Sheets	E-41	FILE	POCKET	FOLDER	NO.]

APPROVED BY:


HAWAIIAN TELCOM

OCEANIC CABLEVISION

HAWAIIAN ELECTRIC COMPANY, INC.

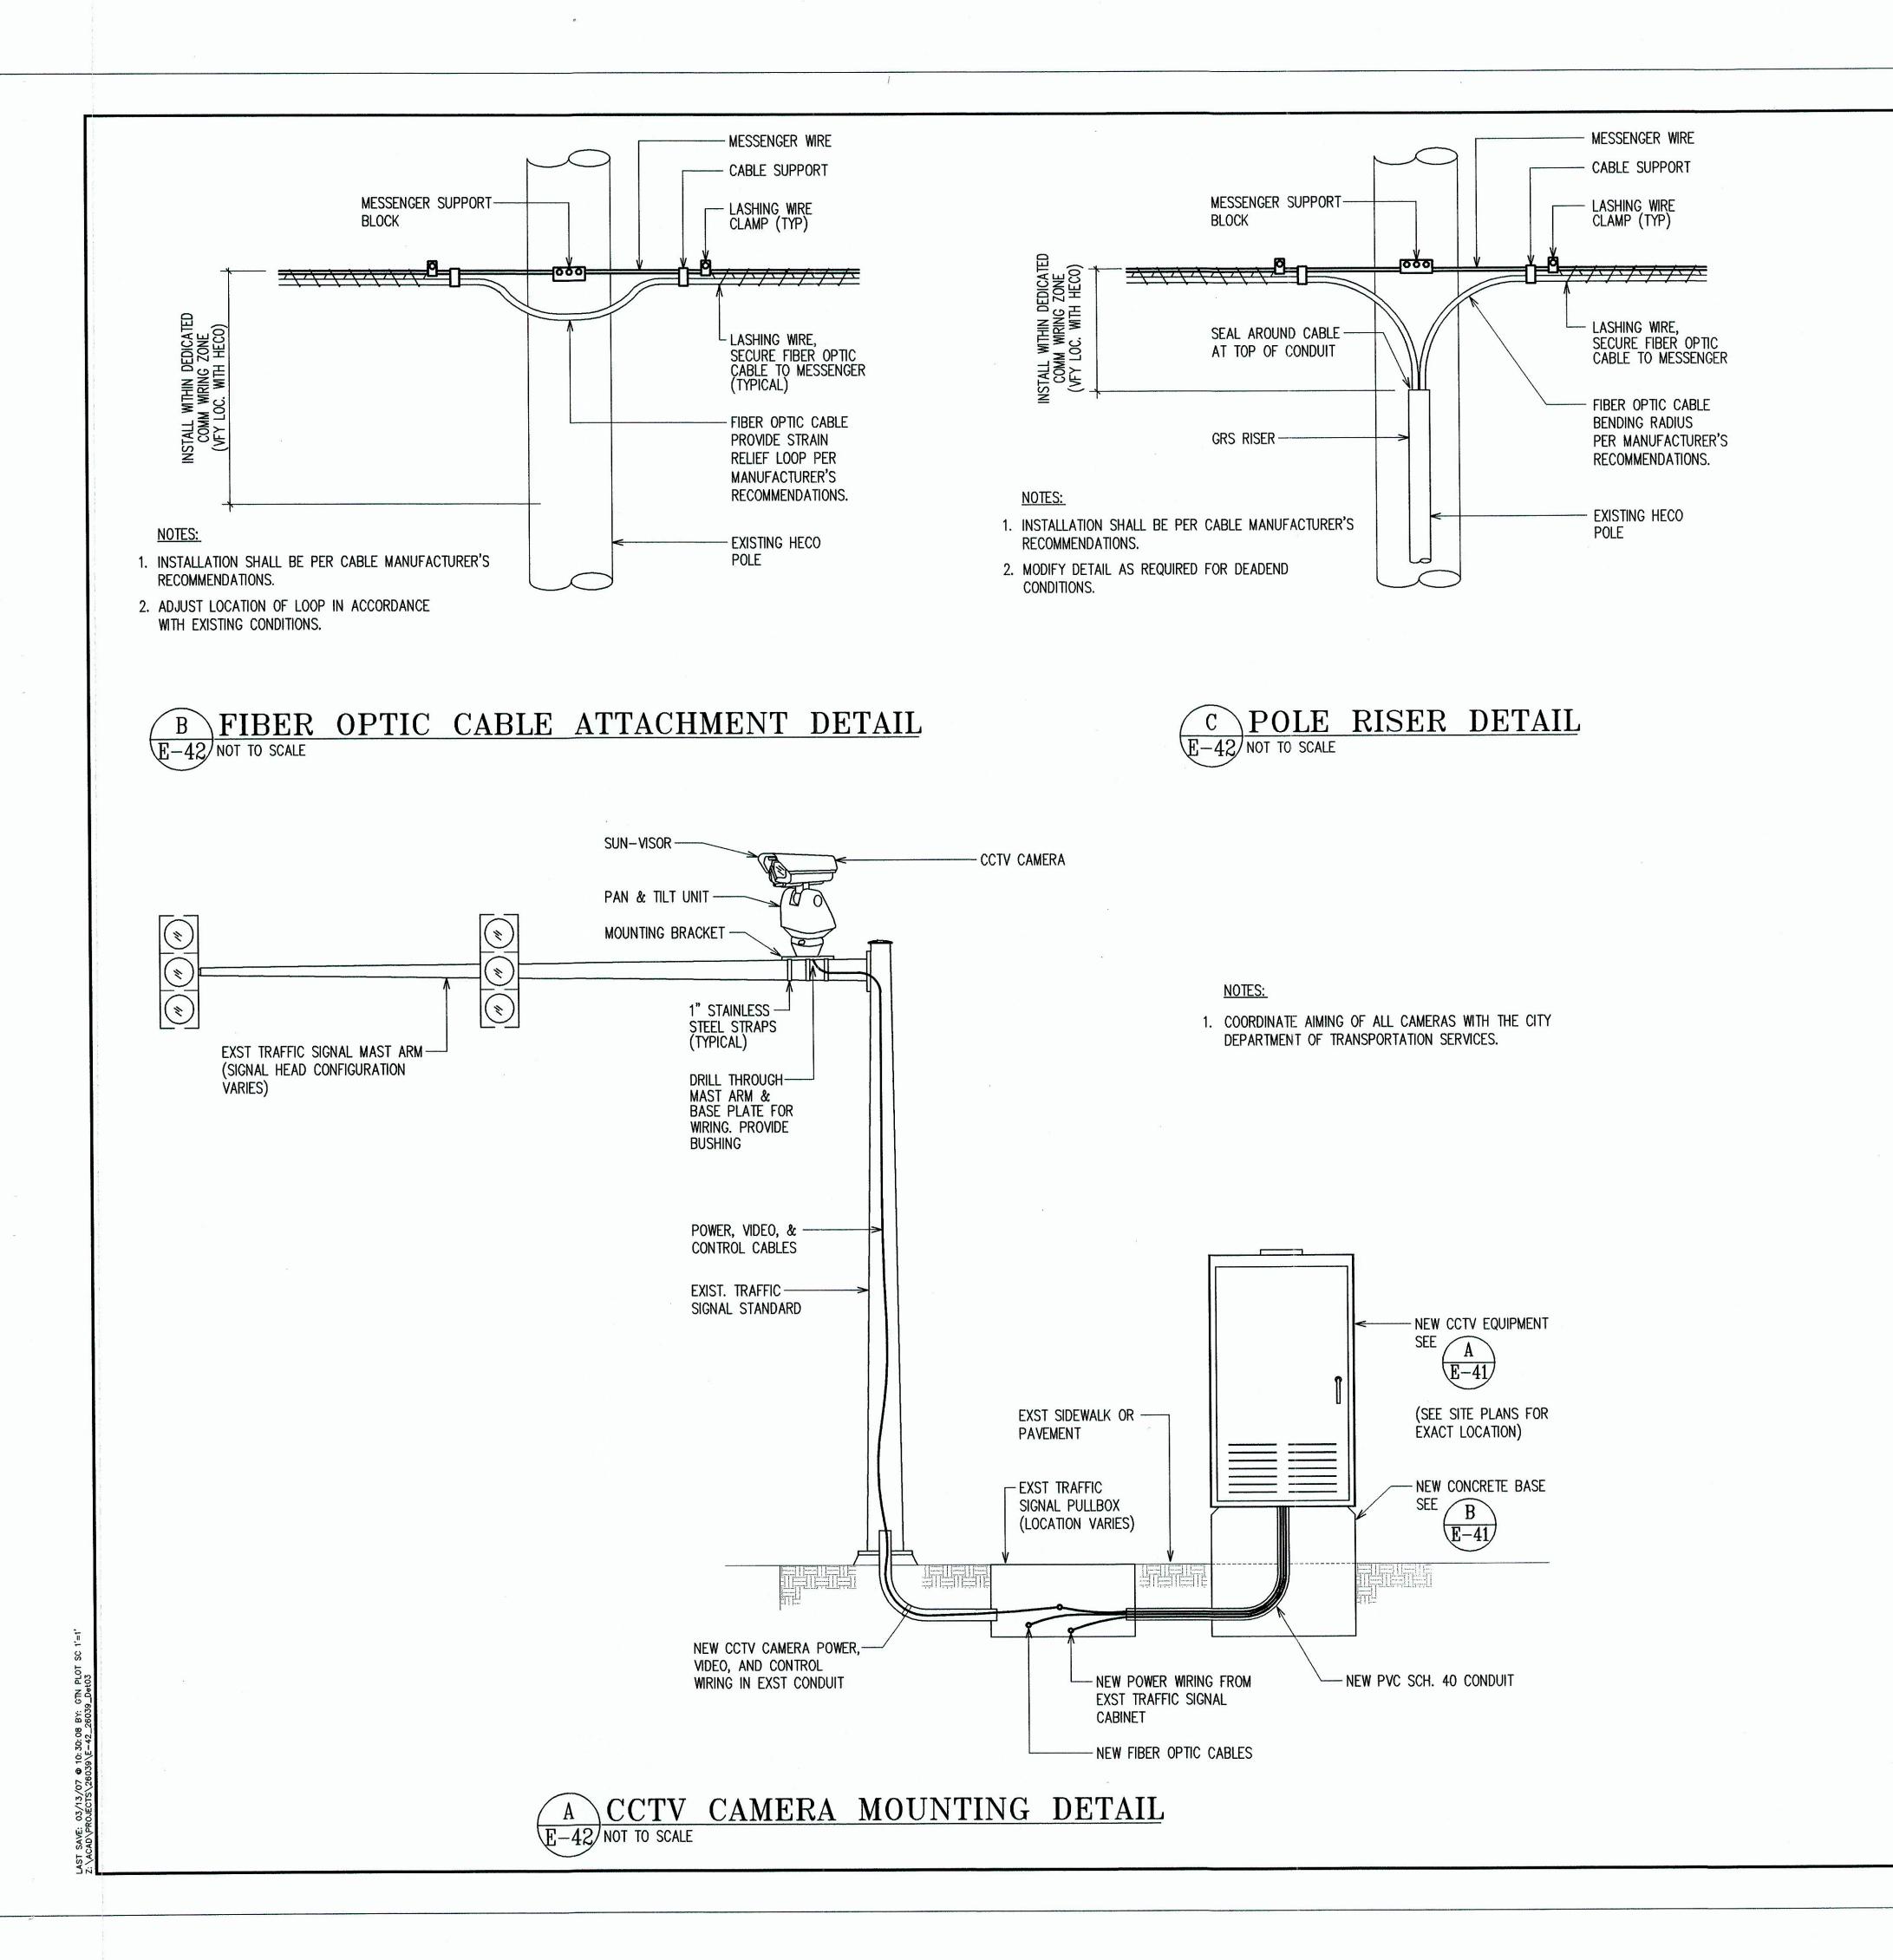

FISCAL SHEET YEAR NO. FED. ROAD FED. AID DIST. NO. PROJ. NO. SHEETS 44 2007 HAW. STP-0001 (30)

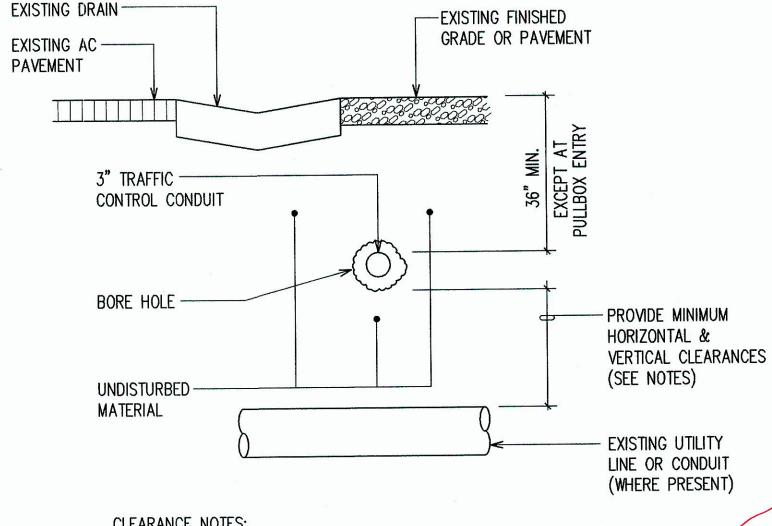

CLEARANCE NOTES:


1. PROVIDE MINIMUM 36"HORIZONTAL AND VERTICAL CLEARANCE BETWEEN NEW CONDUIT AND EXISTING SEWER LINES, LATERALS AND MANHOLES.

2. PROVIDE MINIMUM 36"HORIZONTAL AND VERTICAL CLEARANCE BETWEEN NEW CONDUIT AND EXISTING WATER LINES, LATERALS, BOXES AND MANHOLES.

3. PROVIDE MINIMUM 24"HORIZONTAL AND VERTICAL CLEARANCE BETWEEN NEW CONDUIT AND EXISTING DRAIN LINES, LATERALS AND BASINS.

4. PROVIDE MINIMUM 24" CLEARANCE BETWEEN NEW CONDUIT AND EXISTING HECO, VERIZON, OCEANIC DTS CONDUITS AND MANHOLES.


D HORIZONTAL DIRECTIONAL DRILLING - TYPICAL SECTION E-42 NOT TO SCALE

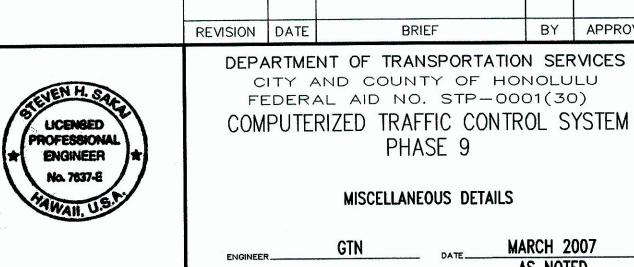



MARCH 2007 AS NOTED

BY APPROVED

E-42 Sheet No. 44 of 48 Sheets

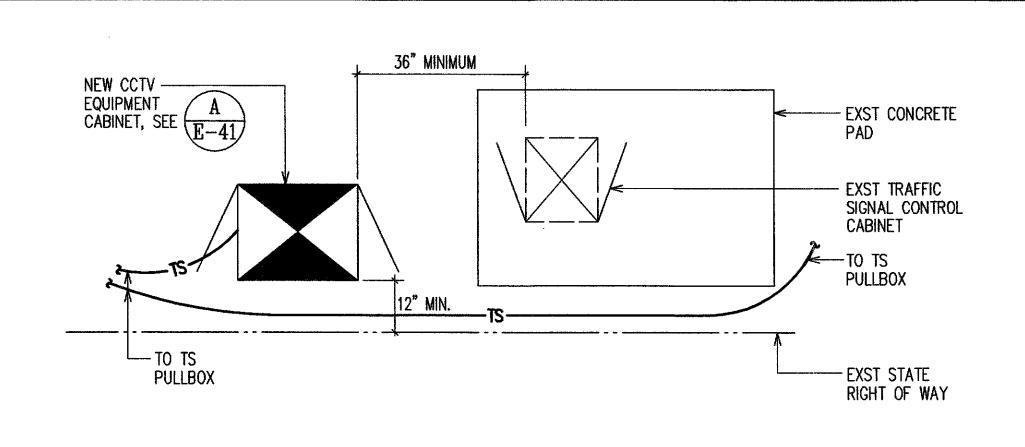

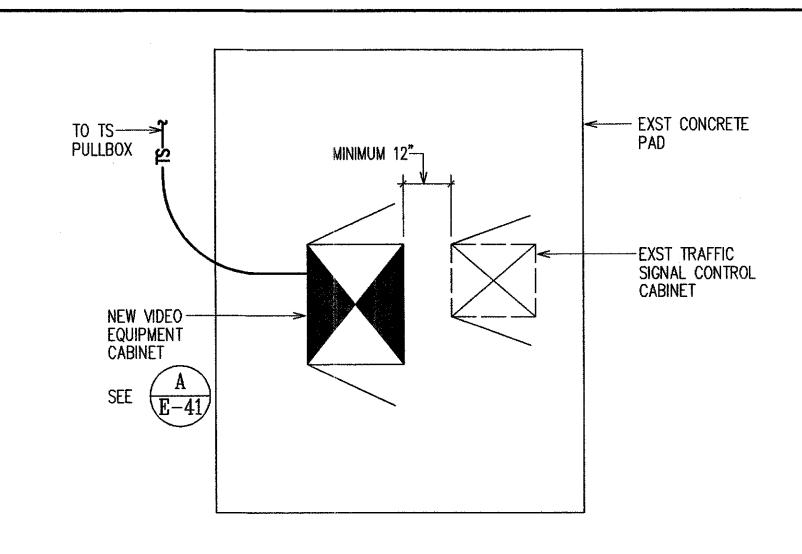


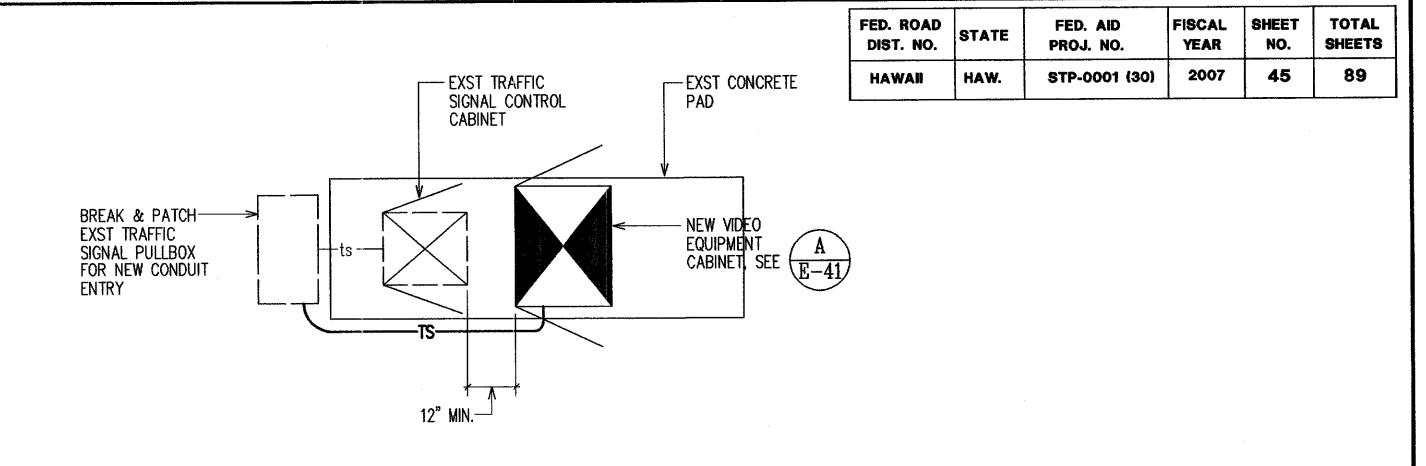

EQUIPMENT PLAN-HALEKOU INTERCHANGE (KANEOHE SIDE)

B EQUIPMENT PLAN-HALEKOU INTERCHANGE E-43 (KAILUA SIDE) NOT TO SCALE

C EQUIPMENT PLAN-LIKELIKE HIGHWAY/ ANOI ROAD INTERSECTION NOT TO SCALE

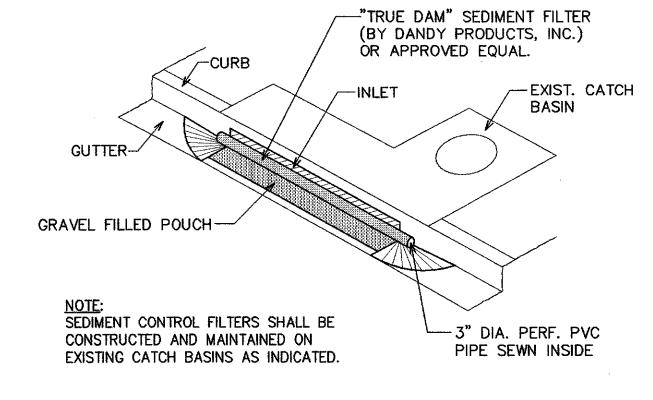


NOT TO SCALE

BEST MANAGEMENT PRACTICES (BMP) NOTES:

- 1. THE CONTRACTOR SHALL INSTALL THE EROSION CONTROL MEASURES AS DIRECTED BY THE ENGINEER, AS SOON PRATICABLE.
- 2. ALL BEST MANAGEMENT PRACTICES (BMP's) SHALL NOT BE REMOVED UNTIL ALL WORK IN THE PROJECT AREA HAS BEEN COMPLETED.
- 3. THE CONTRACTOR SHALL COVER THE OPENINGS TO ALL EXISTING AND PROPOSED STORM DRAIN INLETS WITH A FILTER SYSTEM ("TRUE-DAM" BY DANDY PRODUCTS OR ACCEPTED EQUAL) UNTIL PERMANENT GROUND COVER IS ESTABLISHED. MAINTENANCE OF THE INLET FILTERS BY THE CONTRACTOR SHALL BE INCLUDED FOR THE DURATION OF THE PROJECT.
- 4. AT THE ENDING OF TRENCHING OPERATIONS, EXISTING STORM DRAIN INLETS AND MANHOLES SURROUNDING THE PROJECT SITE SHALL BE INSPECTED AND ANY ACCUMULATED SEDIMENT AND DEBRIS FOUND IN THE DRAIN STRUCTURES SHALL BE REMOVED. FLUSHING INTO THE INLETS AND MANHOLES IS PROHIBITED.

SEDIMENT CONTROL FILTER

D AT CATCH BASIN DETAIL

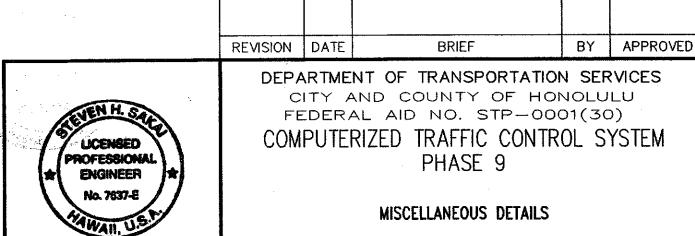

IGINEER GTN	MARCH 2007
RAFTSMAN	SCALE AS NOTED
K. BY SS	REF
PPROVED:	APPROVED:

Sheet No. 45 of 48 Sheets

E-43