

FED. ROAD DIST. NO.	STATE	FED. AID PROJ. NO.	FISCAL YEAR	SHEET NO.	TOTAL SHEETS
HAWAII	HAW.	NH-083-1(32)	1995	4	5

## GENERAL NOTES

### REPAIR NOTES:

- All deteriorated, damaged, cracked, spalled, honeycombed concrete or concrete over rusted reinforcing bars shall be removed as shown and repaired with hand-placed mortar or shotcrete.
- Provide minimum 2" concrete cover over reinforcement or welded wire fabric. See specifications for welded wire fabric requirements.
- Reinforcing bars that have rusted more than 25% of their original cross sectional area shall be cleaned and strengthened as shown on "Reinforcing Bar Repair Splice Detail", this sheet.
- The Engineer shall determine all areas to be repaired and the limits of repair at each area.
- Apply silane waterproofing as approved by the Engineer. Application shall be according to the Manufacturer's recommendations.

**INCIDENTAL ITEMS:** The following items shall be considered incidental to the various pay items for repairs and will not be paid for separately:

- Cleaning of all exposed, corroded reinforcing steel to sound metal.
- Reinforcing bars for repair splice.
- Furnishing and application of silane waterproofing material.

### GENERAL:

- All reinforcing steel to be ASTM A 615 Grade 40.
- All welding shall be done in accordance with the current edition of the Reinforcing Steel Welding Code AWS D1.4.
- Maintenance & control of traffic--See Special Provisions sub-section 104.04.


### SYMBOLS AND ABBREVIATIONS:

Spall or unsound surface area.	Exposed reinf. bars	S.S. - Surface spall (Concrete)
		S.C. - Surface crack (Concrete)
		H.C. - Hairline crack
		S.F. or sq. ft. - Square feet
		L.F. - Linear feet

### ESTIMATED QUANTITIES

ITEM NO.	ITEM	UNIT	*QUANTITY
676.1000	Repair of Spalls	S.F.	2,325 sq. ft.
677.1000	Soffit Crack Repair	L.F.	26 ft.

\* Includes estimated overrun.

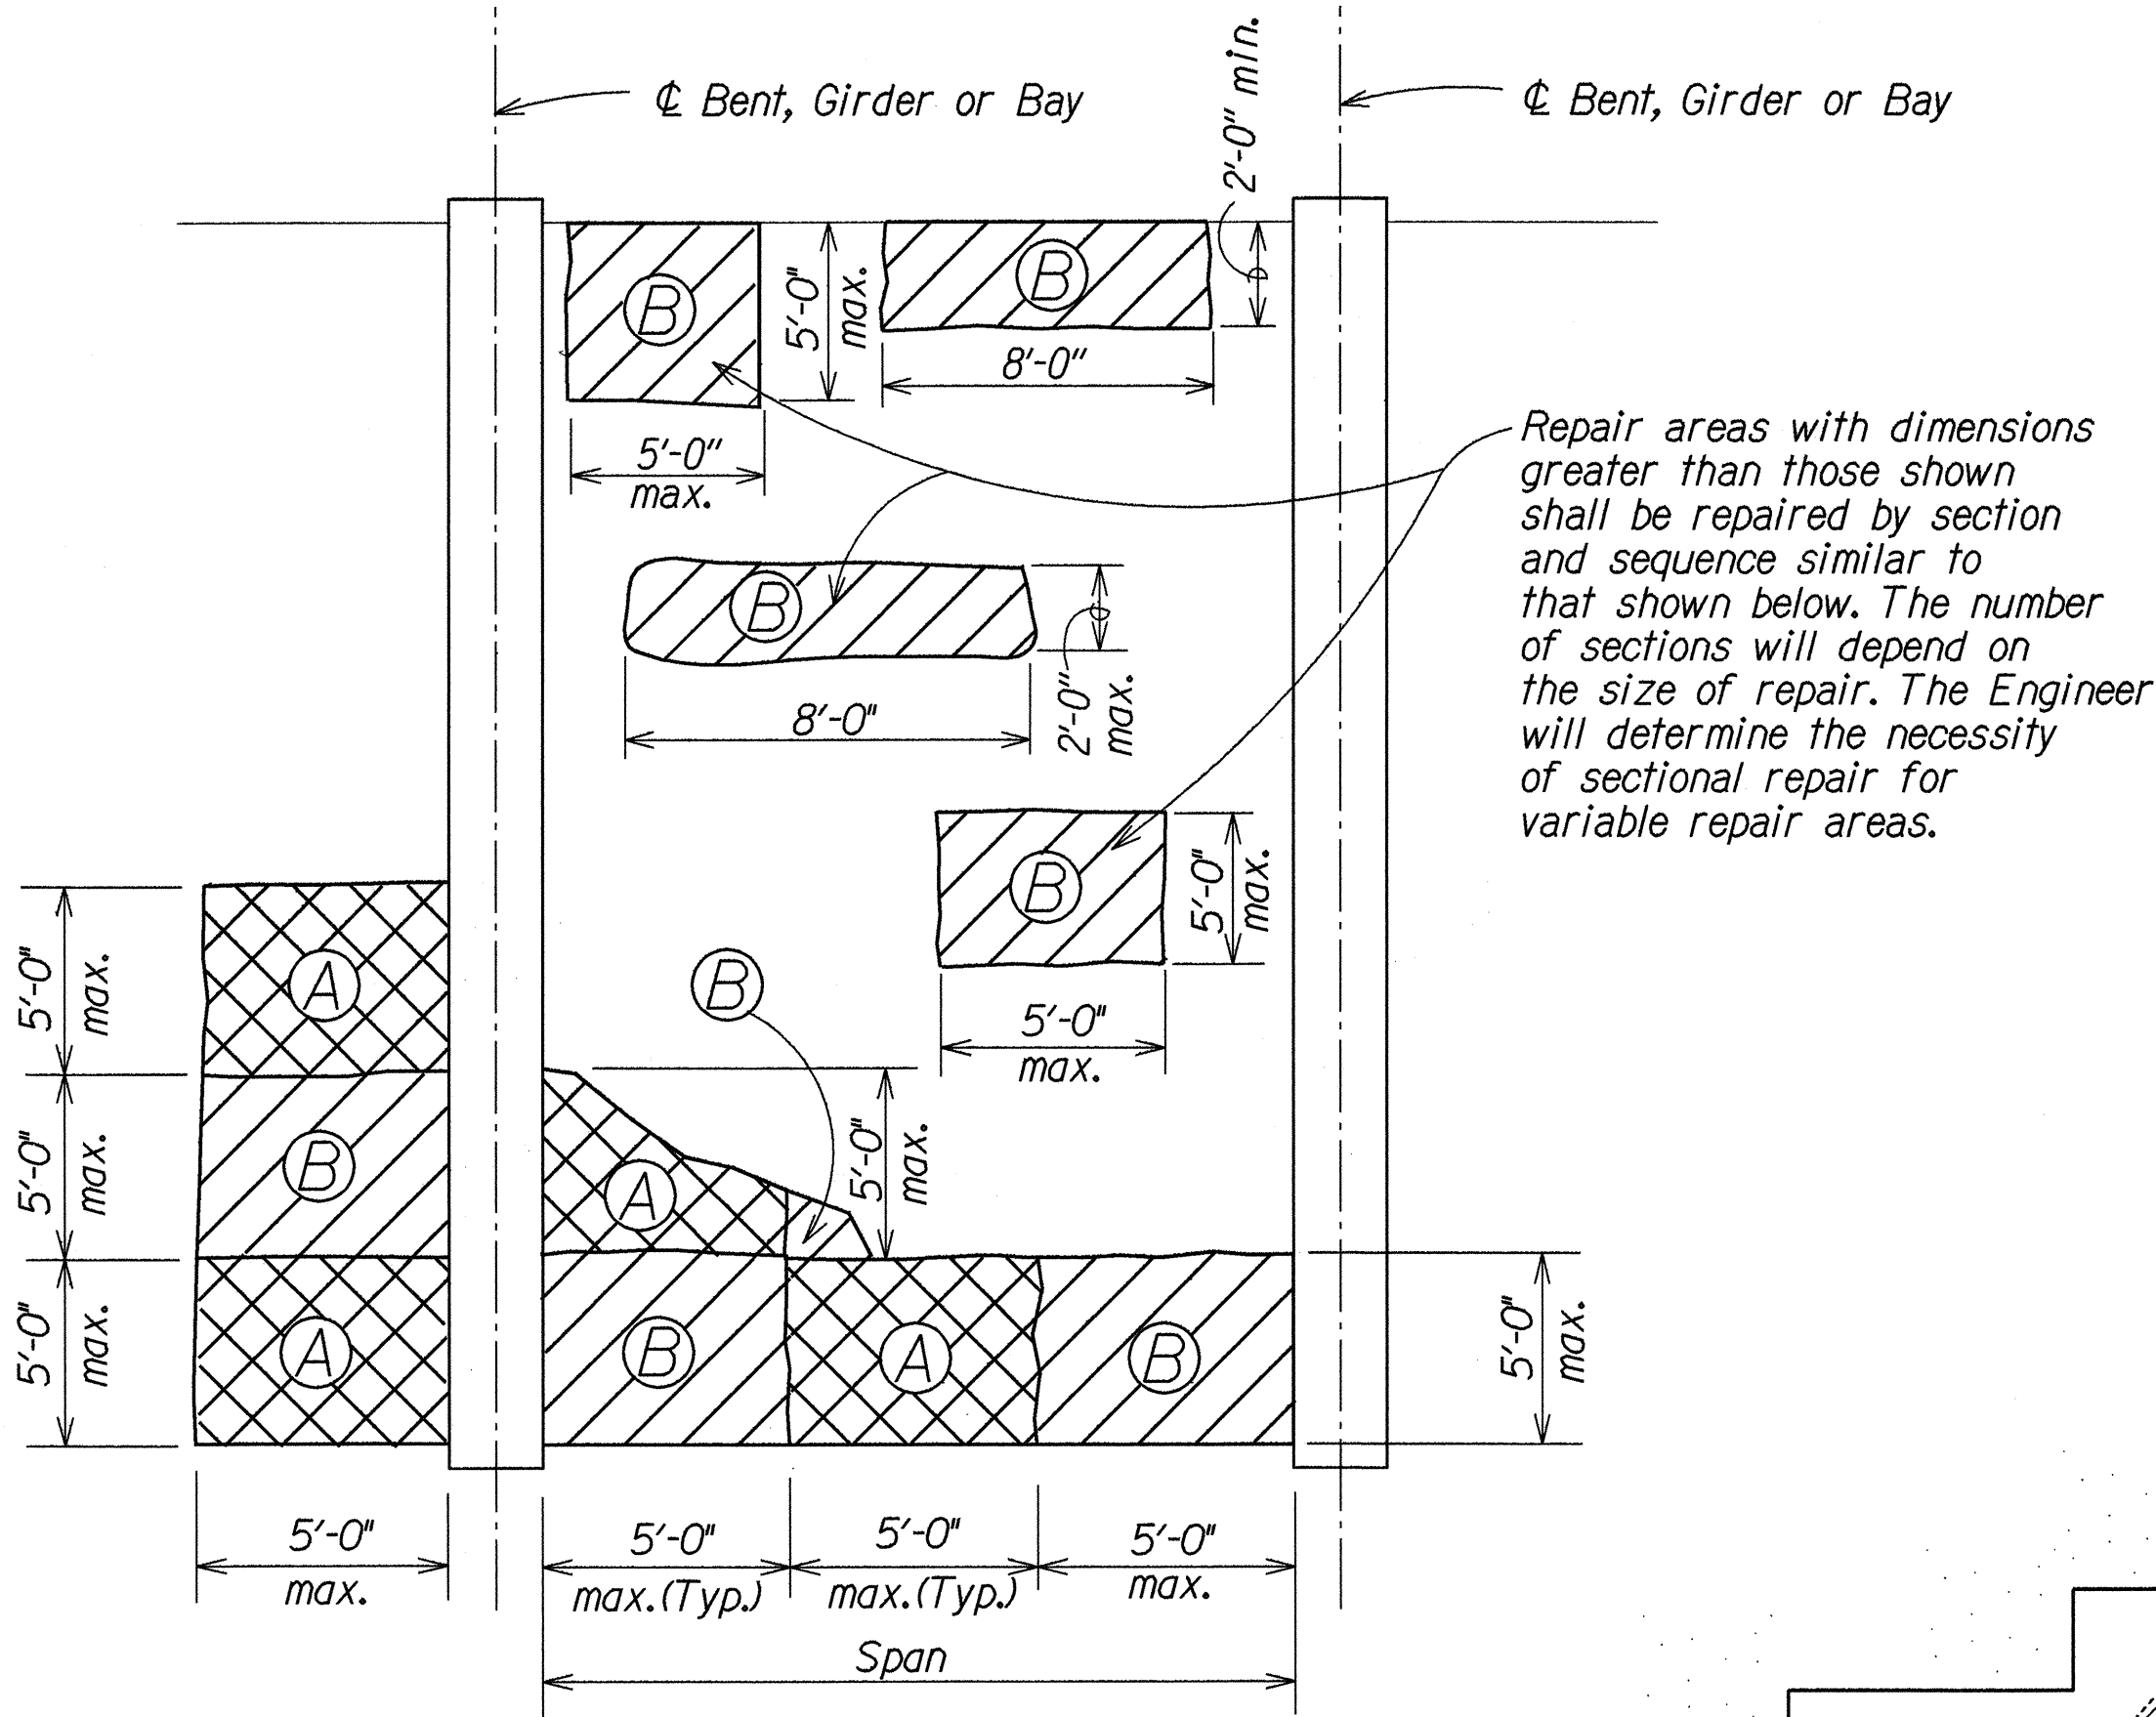


**REFLECTED CEILING PLAN**  
Not to Scale

#### NOTE:


Slab damage over a large area shall be repaired in sections (A) & (B) as shown. The sequence of repair for each section shall be as follows:

- Repair section (A).
- Start repair of section (B) 7 days after placing mortar for section (A).


The necessity for sectional repairs will depend on the amount of reinforcing bars that has to be exposed and cleaned. The Engineer will determine the necessity for sectional repairs after portions of the steel have been exposed.

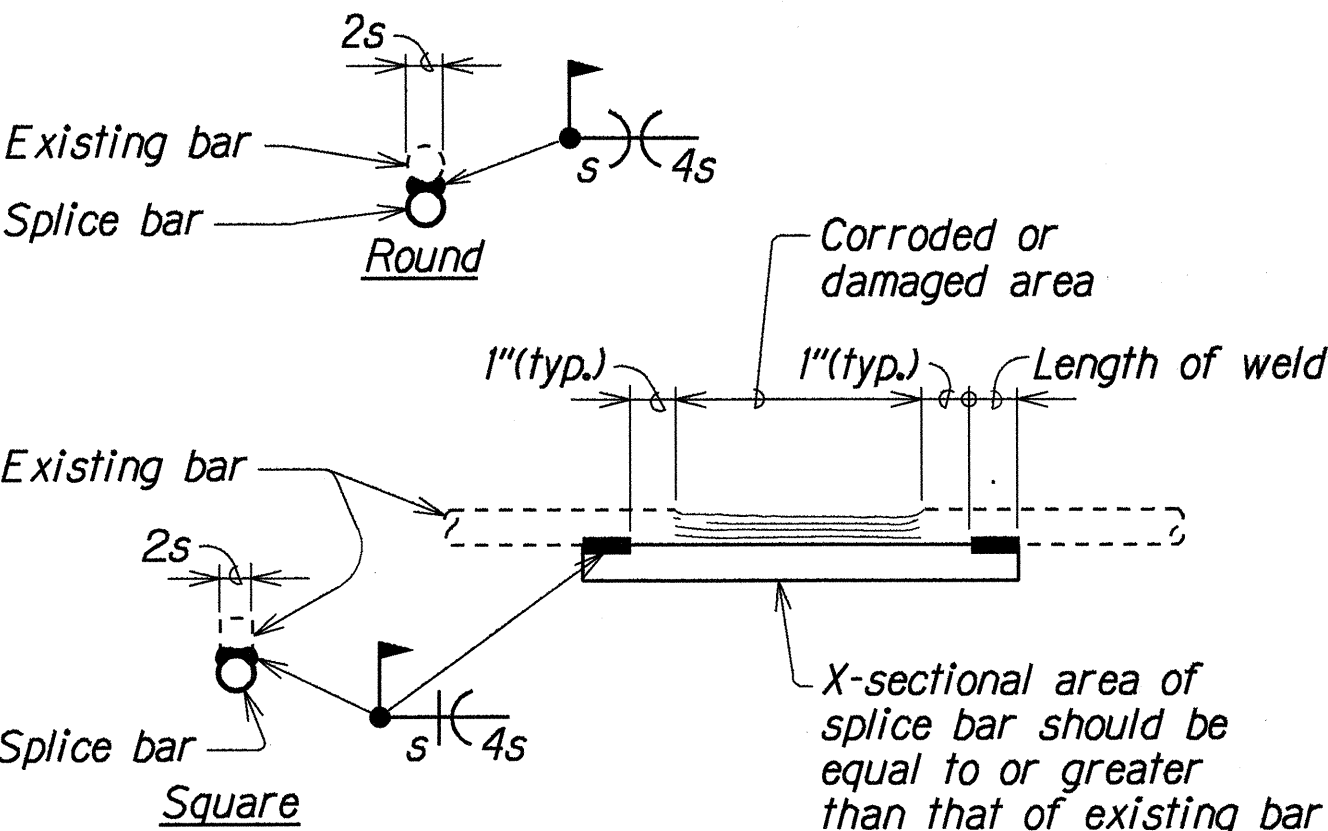

**REINFORCING BAR REPAIR SPLICE DETAIL**  
Not to Scale

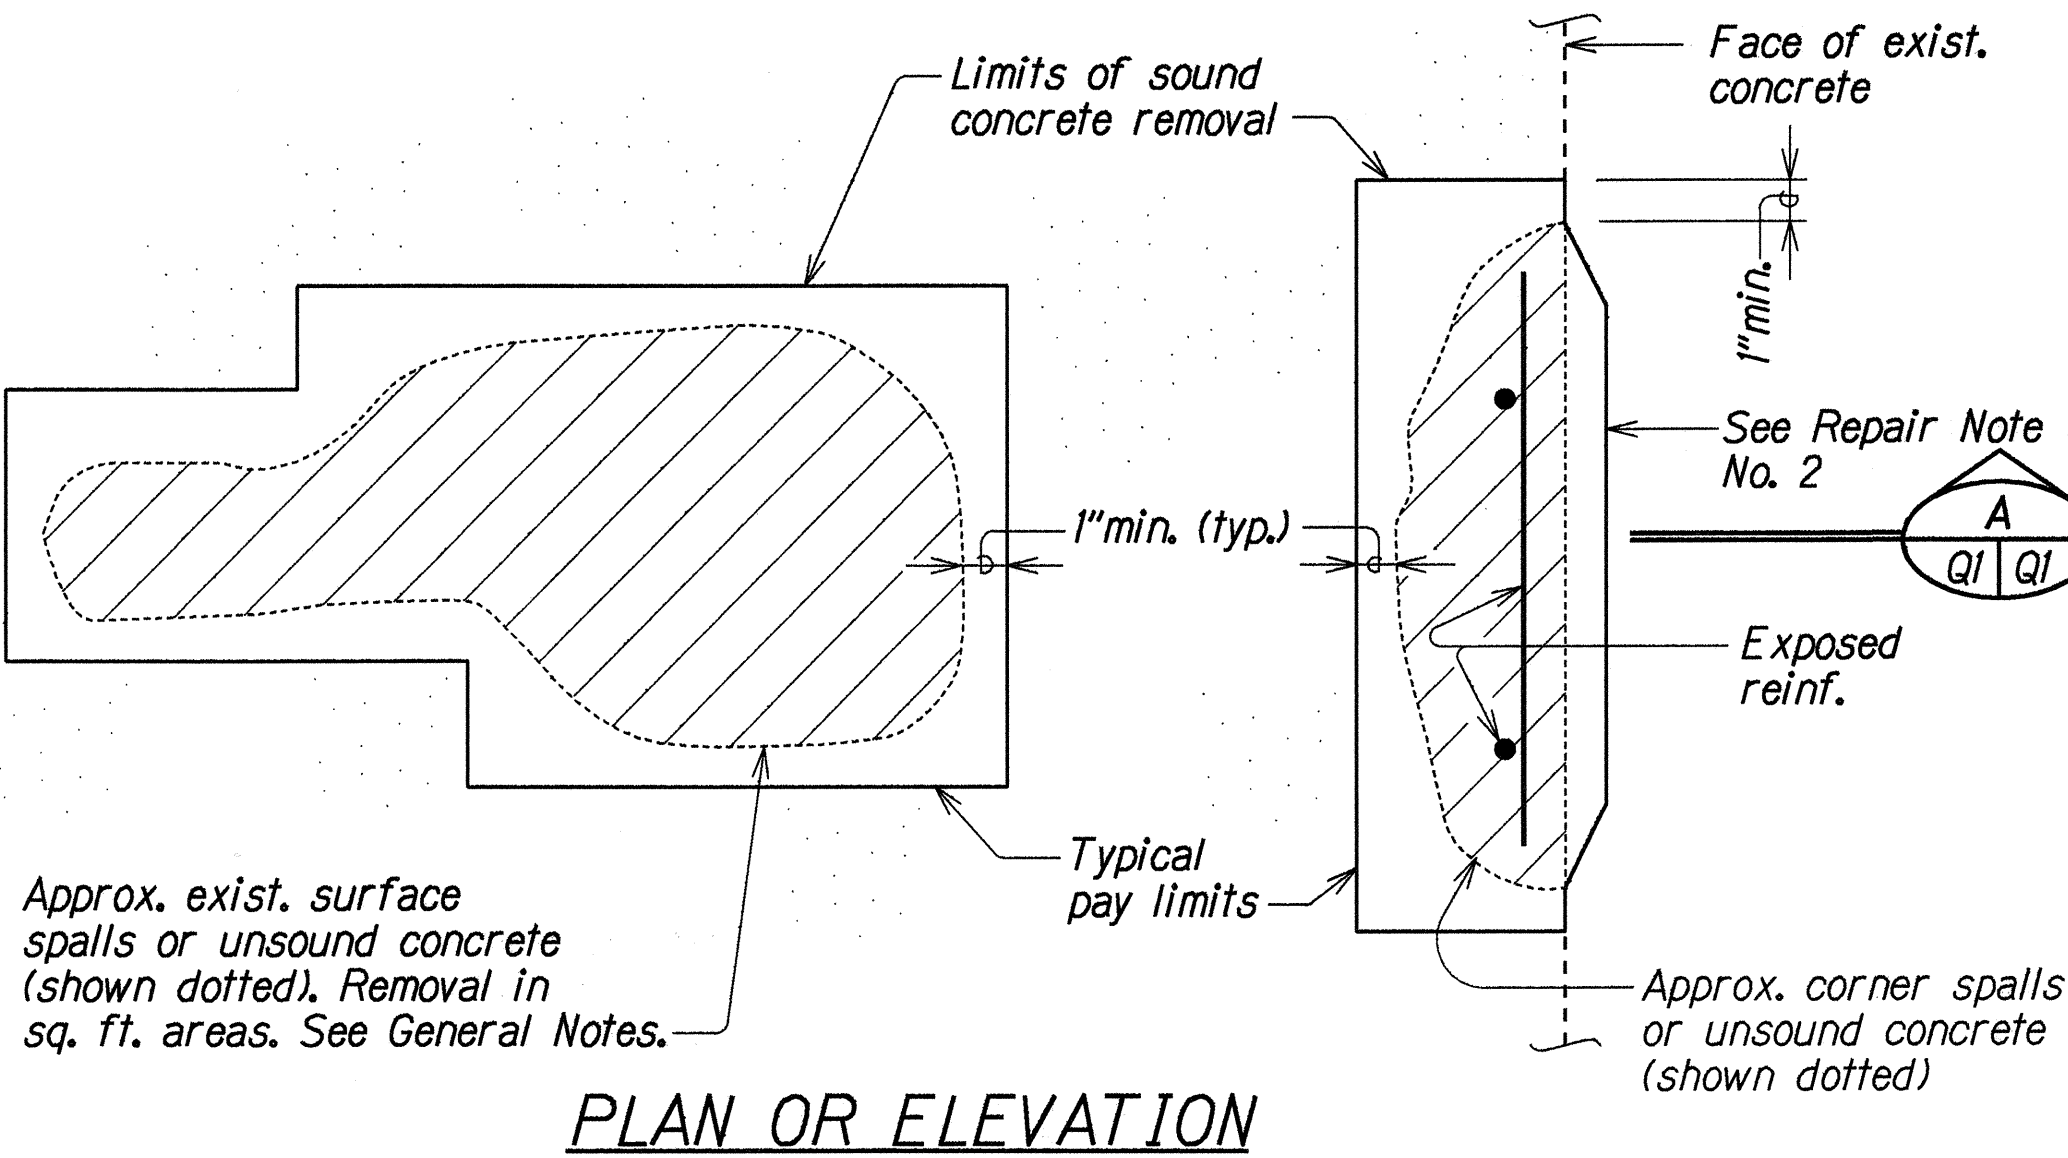

**PLAN OR ELEVATION**

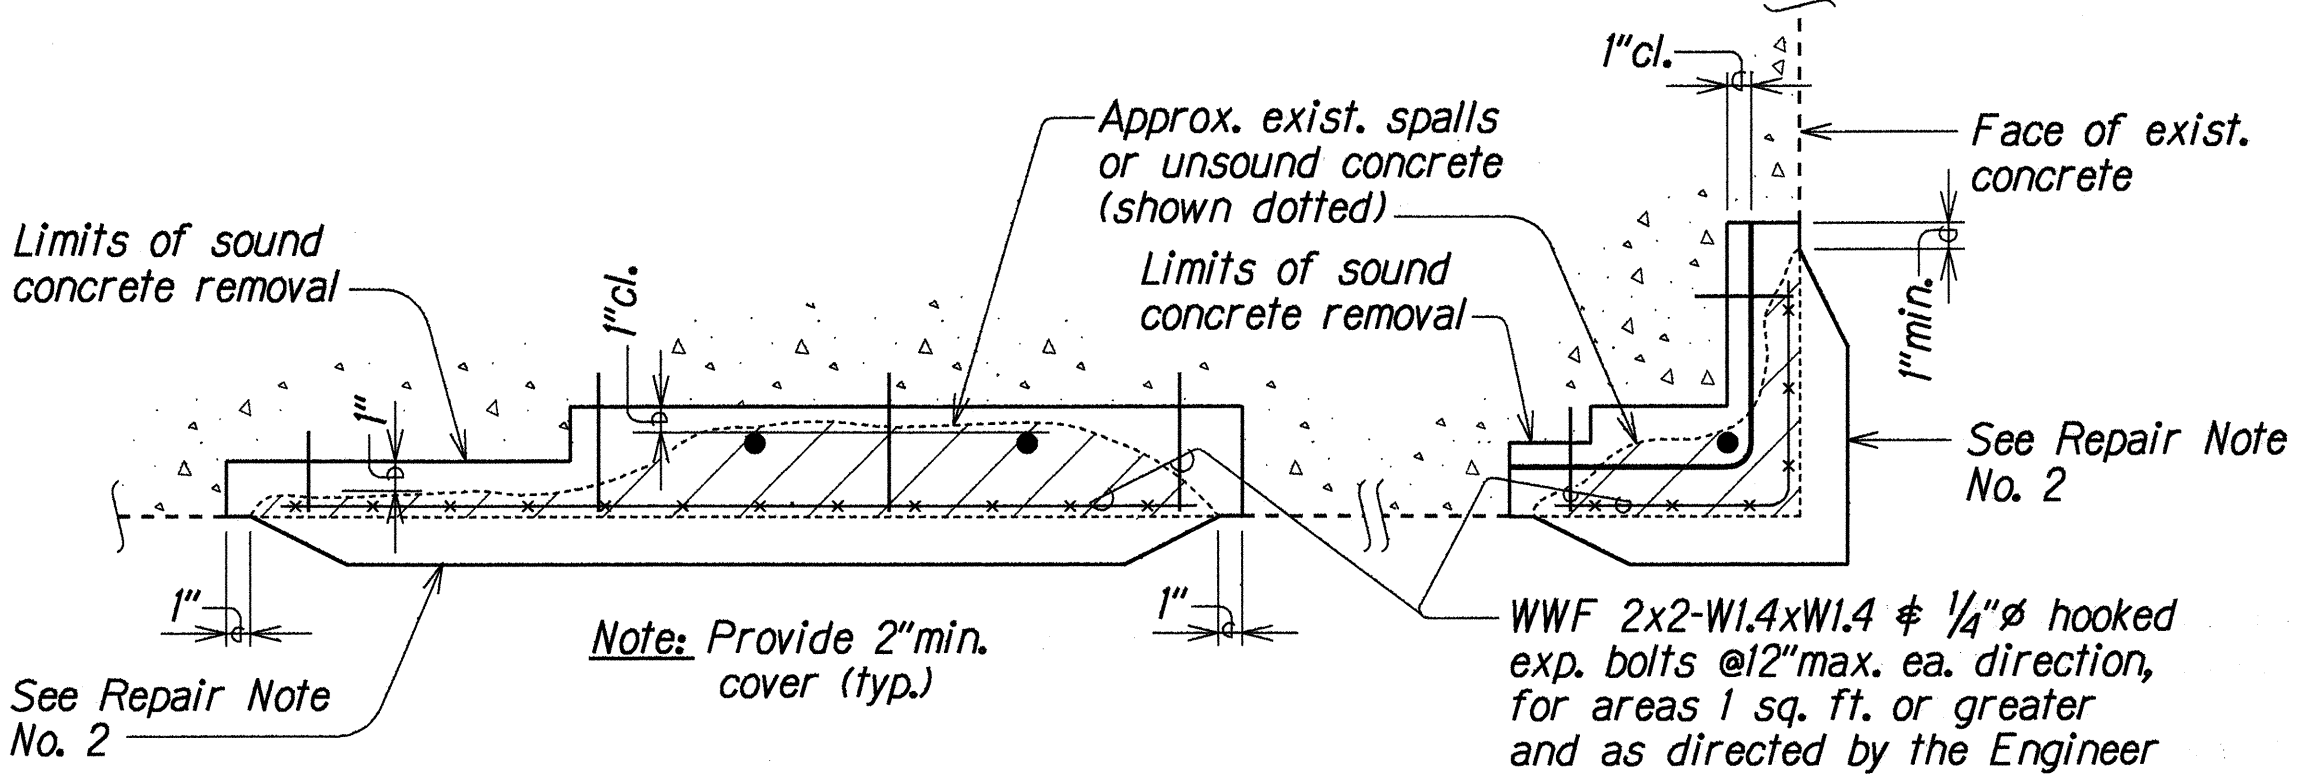

**TYPICAL SECTIONS**

**TYPICAL CONCRETE REPAIRS**  
Not to Scale

STATE OF HAWAII  
DEPARTMENT OF TRANSPORTATION  
HIGHWAYS DIVISION

**KALUANUI STREAM BRIDGE**  
**REPAIR PILES AND PIER CAPS**

GENERAL NOTES, TYPICAL CONCRETE REPAIRS  
REINFORCING BAR REPAIR SPLICE DETAIL  
KAMEHAMEHA HIGHWAY REPAIR OF KALUANUI STREAM BRIDGE  
Fed. Aid Proj. No. NH-083-1(32)  
Scale: As Noted Date: APRIL 1995

