

FED. AID PROJ. NO. FISCAL SHEET TOTAL YEAR NO. SHEETS FED. ROAD 2013 | C.O.39 | 85 HAW. NH-072-1(056)

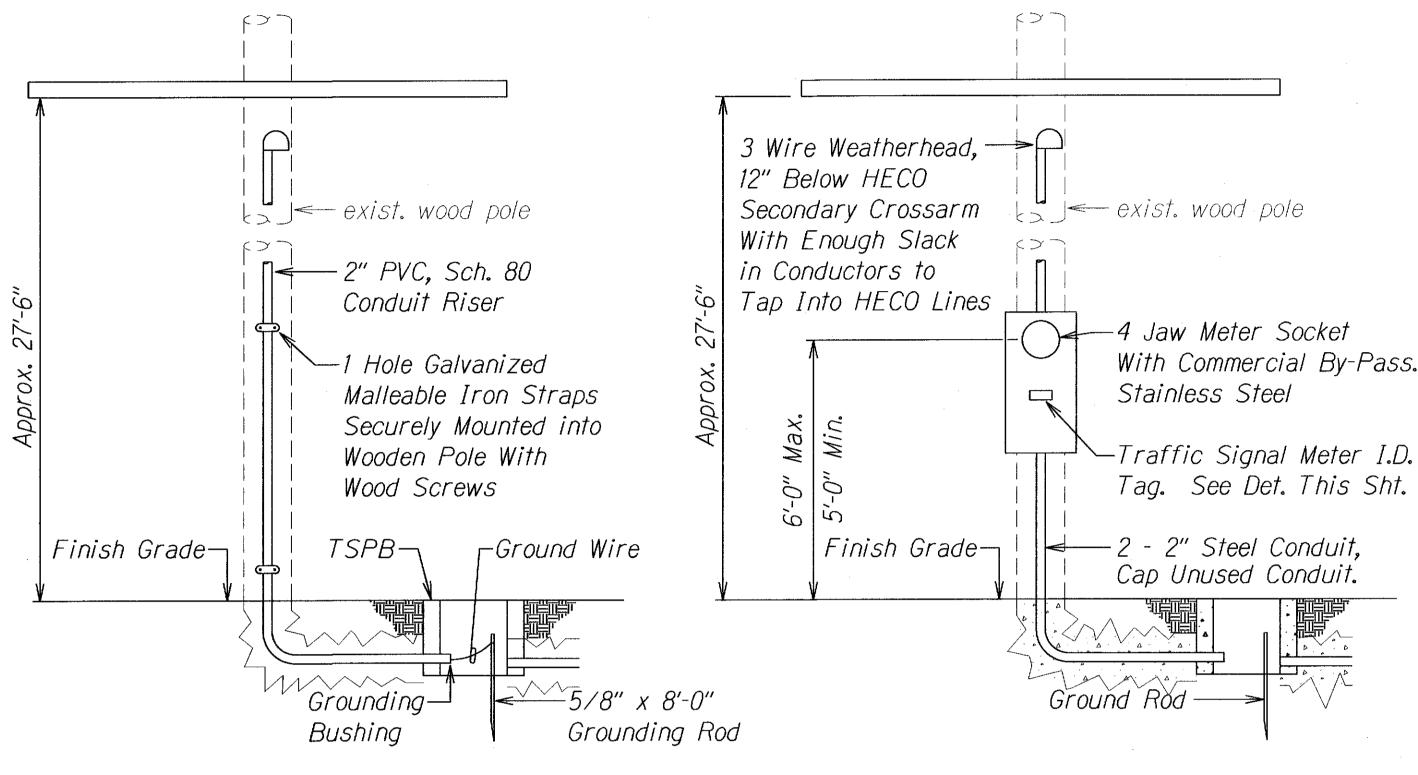

Note: Maintain 4'-0" Clear and face Meter so that a Meter Reader will face Oncoming Traffic.

SERVICE RISER AT EXISTING WOOD POLE Not To Scale

NEW METER INSTALLATION ON EXISTING WOOD POLE Not To Scale

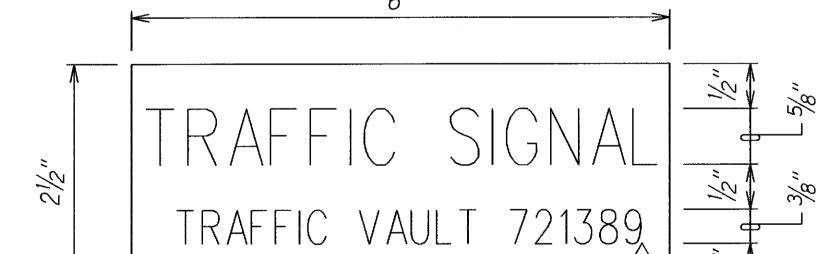

- 2. Attach to Meter Box using Scotch 3M Brand Very High Bond (VHB) Double Coated Acrylic Foam Tape or Equivalent.
- 3. Letters/Numbers shall be  $\frac{1}{16}$ " Stroke, (White in Color).
- 4. Letters/Numbers shall be Inscribed by cutting through "Black Cap Sheet" to expose White Letters/Numbers.

METER I.D. TAG DETAIL Not To Scale

┌─ 4 Jaw, 100A Meter Socket 2P50A Breaker and Final Connection — Factory Installed Commercial — HECO by HECO By-Pass (Sealable) Pullbox Pullbox 2P50A 2" Schedule 80 -└─ 2" Conduit, 3#6 \$ PVC 3-1/C#2 2" Schedule 80 — 1#8 Ground PVC 3-1/C#2 + Gnd -Gnd/Bond Per NEC #8 Ground to -Ground Rod SERVICE DATA 1. Service Voltage: 1 Phase 3 Wire 120/240V Connected - 5 KVA

All Conduits to Contain a Polyolefin Pull Line. (Jet Line Cat #232 or Equiv)

Contractor Shall Make All Electrical Connection to Counter, Provide 2P50A Breaker, Ground and 2" Conduit.

4. All Fastening Bolts, Nuts \$ Washers Shall Be Stainless Steel. Provide One Coat ShopPrimer \$ Two Coats

6. Sweep Radius Must Meet Both Hawaiian Electric Company and Hawaiian Telcom Sweep Requirements.

25 ohms. If resistance is greater than 25 ohms, add additional ground rods 6 feet apart until less

 $\frac{2}{2}$  7. Metal conduits should be grounded as required by NESC. Ground rods should be tested for less than

2. Load Data: Estimated Demand - 2 KVA

\* HECO Sealable, NEMA 3R

ONE-LINE DIAGRAM Not To Scale

2/11/15 Added note. Added concrete encased and 2 conduits. Removed Meter Pedestal For Underground Service detail. DATE REVISION STATE OF HAWAII **DEPARTMENT OF TRANSPORTATION** HIGHWAYS DIVISION

HECO AND HTEL SERVICE DETAILS KALANIANAOLE HIGHWAY RESURFACING

West Hind Drive to Vicinity of Hanauma Bay Road

Federal Aid Project No. NH-072-1(056)

Scale: As Noted Date: August, 2013 SHEET No. *E-1* OF 1 SHEETS

C.O. 39

SURVEY PLOTTE
DRAWN BY
TRACED BY
DESIGNED BY
OUANTITIES BY
CHECKED BY

*Notes:* 

Pedestal Shall Be Stainless Steel.

5. Provide 4 Ft. Clearance in Front of Meter.

of Acrylic Enamel Finish.

than 25 ohms is achieved.

Notes: 1. Use 3-Ply Laminated Flexible Plastic, Black-White-Black Thickness: Black Cap Sheet - 0.010", White Base Sheet - 0.052", Black Base Sheet - 0.010".