STRUCTURAL GENERAL NOTES

FED. ROAD DIST. NO. STATE PROJECT NO. FISCAL SHEET NO. SHEETS

HAWAII HAW. 72A-02-06 2008 44 66

- 1. <u>General Specifications:</u> Hawaii Department of Transportation, 2005 Standard Specifications for Road and Bridge Construction, together with Special Provisions prepared for this Contract.
- 2. <u>Design Specifications:</u>
 - (A) AASHTO 2007 LRFD Bridge Design Specifications (Fourth Edition) and its subsequent interim specifications with interim supplements and modifications by the Highways Division, Department of Transportation, State of Hawaii.
 - (B) AASHTO 2001 Standard specifications for structural supports for Highway Signs, Luminaries and Traffic Signals (Fourth Edition) and its subsequent interim specifications with interim supplements and modifications by the Highways Division, Department of Transportation, State of Hawaii.

3. <u>Loads:</u>

- (A) Wind Load: 105 mph. Value is a 3 second gust speed at 32.8-ft above ground for Exposure C category and is associated with an anuual probability of 0.02 (50 year mean recurrence interval).
- (B) Recurrence Interval of 50 Years.
- (C) Vortex shedding induced loads shall be considered for cantilevered mast arms and pole shafts that do not have tapers or have tapers of less than 0.14 in/ft.

4. <u>Materials:</u>

(A) All concrete strengths shall be as noted below:

Item No.	Structural Parts	Classes of Concrete	Specified Compressive Strength, f'c (28 Days)
(1)	Drilled shafts	· _	4500 PSI
(2)	Except as noted others	A	3000 PSI

All concrete with a 28 days compressive strenght of 4000 psi or greater shall have a maximum W/C Ratio of 0.45. The W/C Ratio for other class of concrete shall follow the Standard Specifications.


- (B) All reinforcing steel shall be ASTM A615 Grade 60 unless otherwise noted.
- (C) All structural steel shall be not dip galvanized after fabrication, unless otherwise noted.
- (D) All anchor bolts, washers and nuts shall be not dip galvanized after fabrication, unless otherwise specified.

5.	Reinfor	cement:

- (A) The minimum covering measured from the surface of the concrete to the face of any reinforcing bars shall be as follows, except as otherwise shown:
 - (1) Concrete cast against and permanently exposed to earth = 3"
 - (2) All others unless otherwise noted = 2"
- (B) Reinforcing bars shall be detailed in accordance with the latest edition of the design specification in note 2 unless otherwise noted.
- (C) Minimum clear spacing between parallel bars shall be 1 1/2 times the diameter of bars (for non bundled bars). In no case shall the clear distance between the bars be less than 1 1/2 times the maximum size of the coarse aggregate or 1 1/2".
- (D) All dimensions relating to reinforcing bars are to centers of bars unless otherwise noted.
- (E) Reinforcing bars shall be securely tied at all intersections and lap splices except where the spacing of intersections is less than one foot in each direction, in which case alternate intersections shall be tied.

6. Construction Notes:

- (A) See Standard Specifications and Special Provisions.
- (B) Except as otherwise noted, all vertical dimensions are measured plumb.
- (C) The Contractor shall verify all site conditions and not rely upon these plans for stream location, etc. Conditions may differ from those shown.
- (D) The Contractor shall tone and verify the location of all utility lines and notify the respective owners before commencing with excavation, and any temporary piling or sheeting.
- (E) For concrete finish see Standard Specifications and Special Provisions.
- (F) Construction joints may be relocated or additional ones added subject to the approval of the Engineer.
- (G) Unless otherwise noted, all exposed concrete edges shall be chamfered 3/4"x3/4".

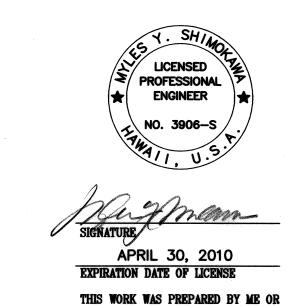

STATE OF HAWAII

DEPARTMENT OF TRANSPORTATION


HIGHWAYS DIVISION

STRUCTURAL GENERAL NOTES


KALANIANAOLE HIGHWAY MEDIAN
IMPROVEMENTS VICINITY OF OLOMANA
GOLF COURSE PROJECT NO. 72A-02-06

SCALE: None DATE: June 2008

SHEET No. SO.1 OF 8 SHEETS

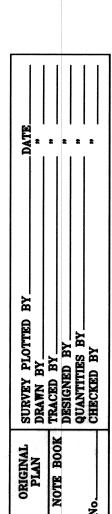


FED. ROAD DIST. NO.	STATE	PROJECT NO.	FISCAL YEAR	SHEET NO.	TOTAL SHEETS
HAWAII	HAW.	72A-02-06	2008	45	66

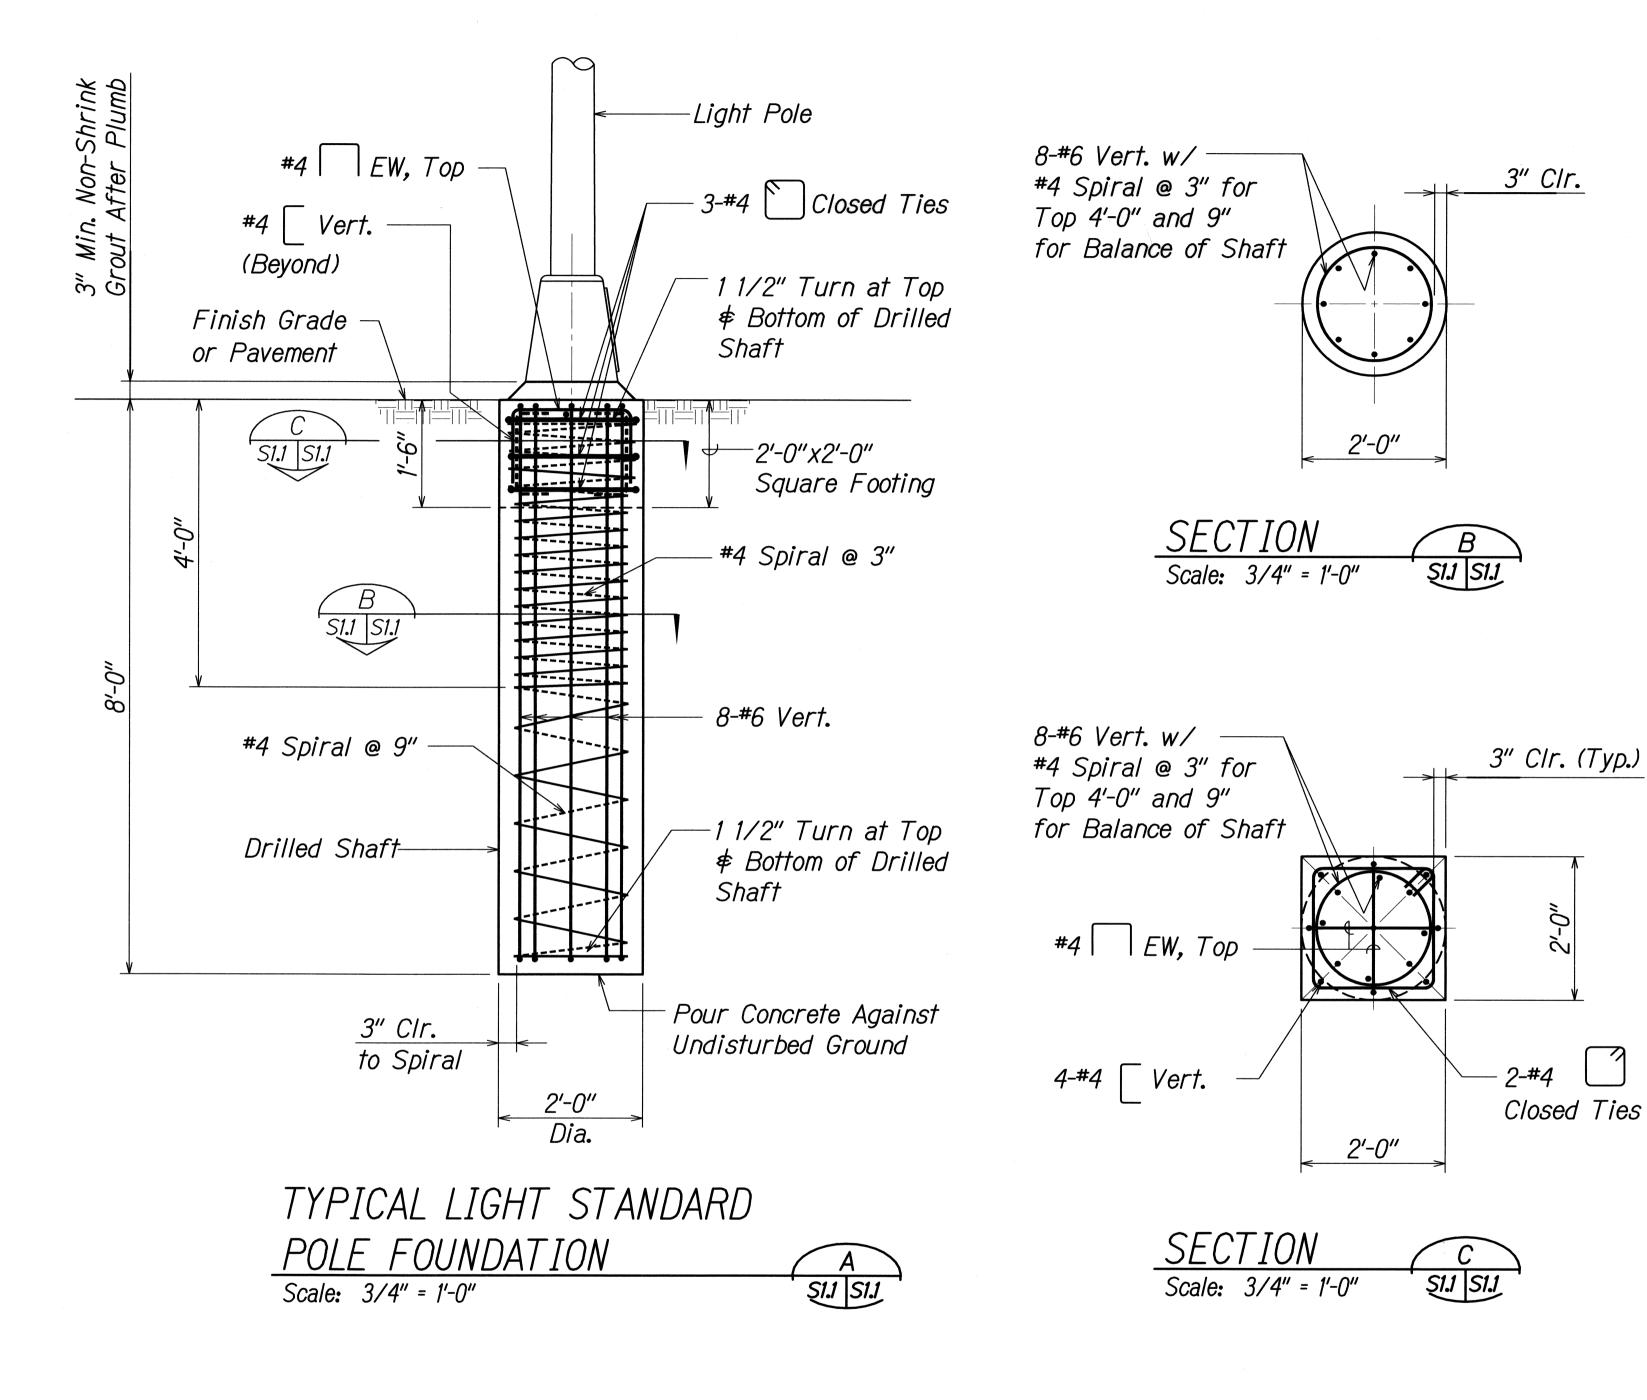

NOTES:

Closed Ties

- 1. See electrical drawings for additional details.
- 2. Follow traffic signal pole manufacturer's recommendations for anchor bolts, base plate and traffic signal poles.

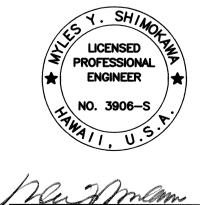

APRIL 30, 2010
EXPIRATION DATE OF LICENSE THIS WORK WAS PREPARED BY ME OR UNDER MY SUPERVISION


STATE OF HAWAII
DEPARTMENT OF TRANSPORTATION
HIGHWAYS DIVISION TYPICAL LIGHT STANDARD

POLE FOUNDATION SECTIONS KALANIANAOLE HIGHWAY MEDIAN

IMPROVEMENTS VICINITY OF OLOMANA GOLF COURSE PROJECT NO. 72A-02-06 SCALE: As Noted DATE: June 2008

SHEET No. S1.1 OF 8 SHEETS

FED. ROAD DIST. NO.	STATE	PROJECT NO.	FISCAL YEAR	SHEET NO.	TOTAL SHEETS
HAWAII	HAW.	72A-02-06	2008	46	66

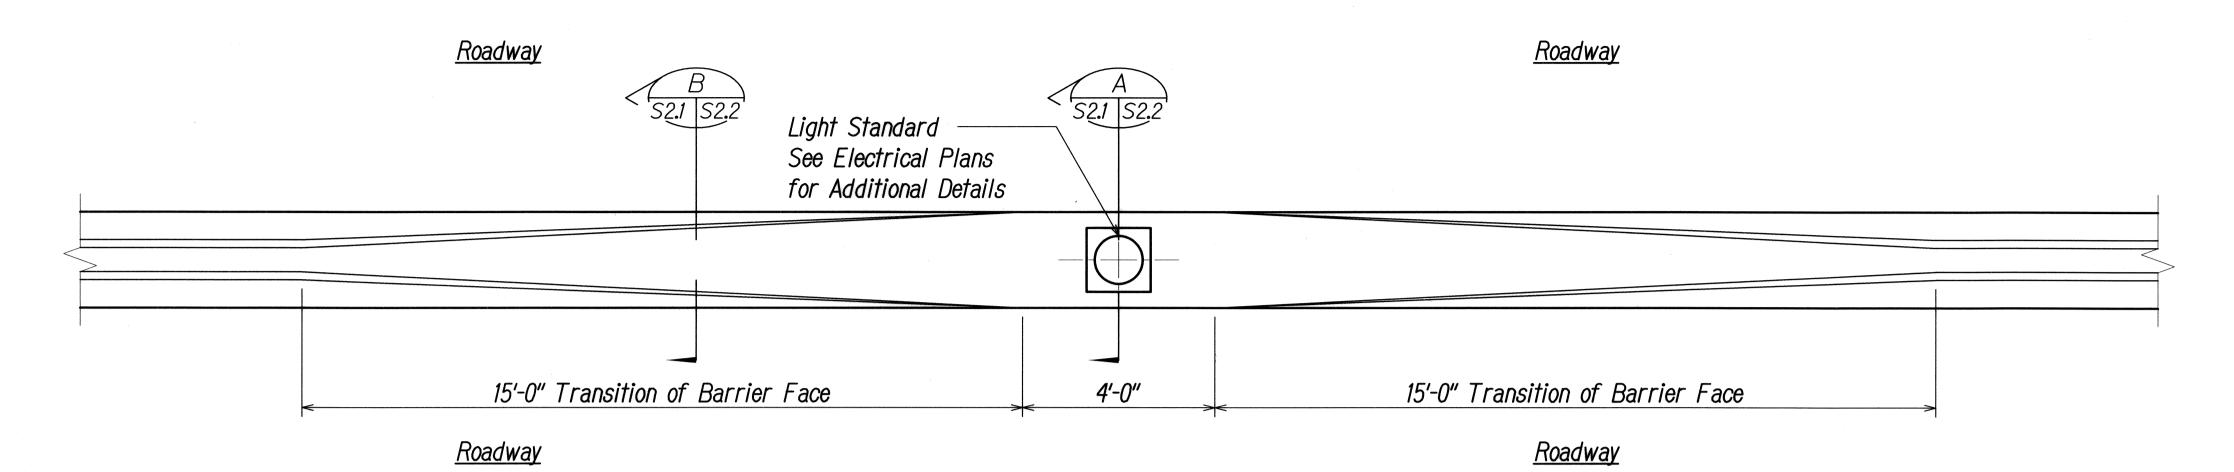


TYPICAL LIGHT POLE BARRIER PLAN (A)

Scale: 1/2" = 1'-0"


NOTES:


- 1. No expansion joints shall be located in typical light pole barrier and light pole barrier transition.
- 2. Traffic light pole barrier shall be paid for under Section 606 Guardrail Type 4 Rigid Barrier.

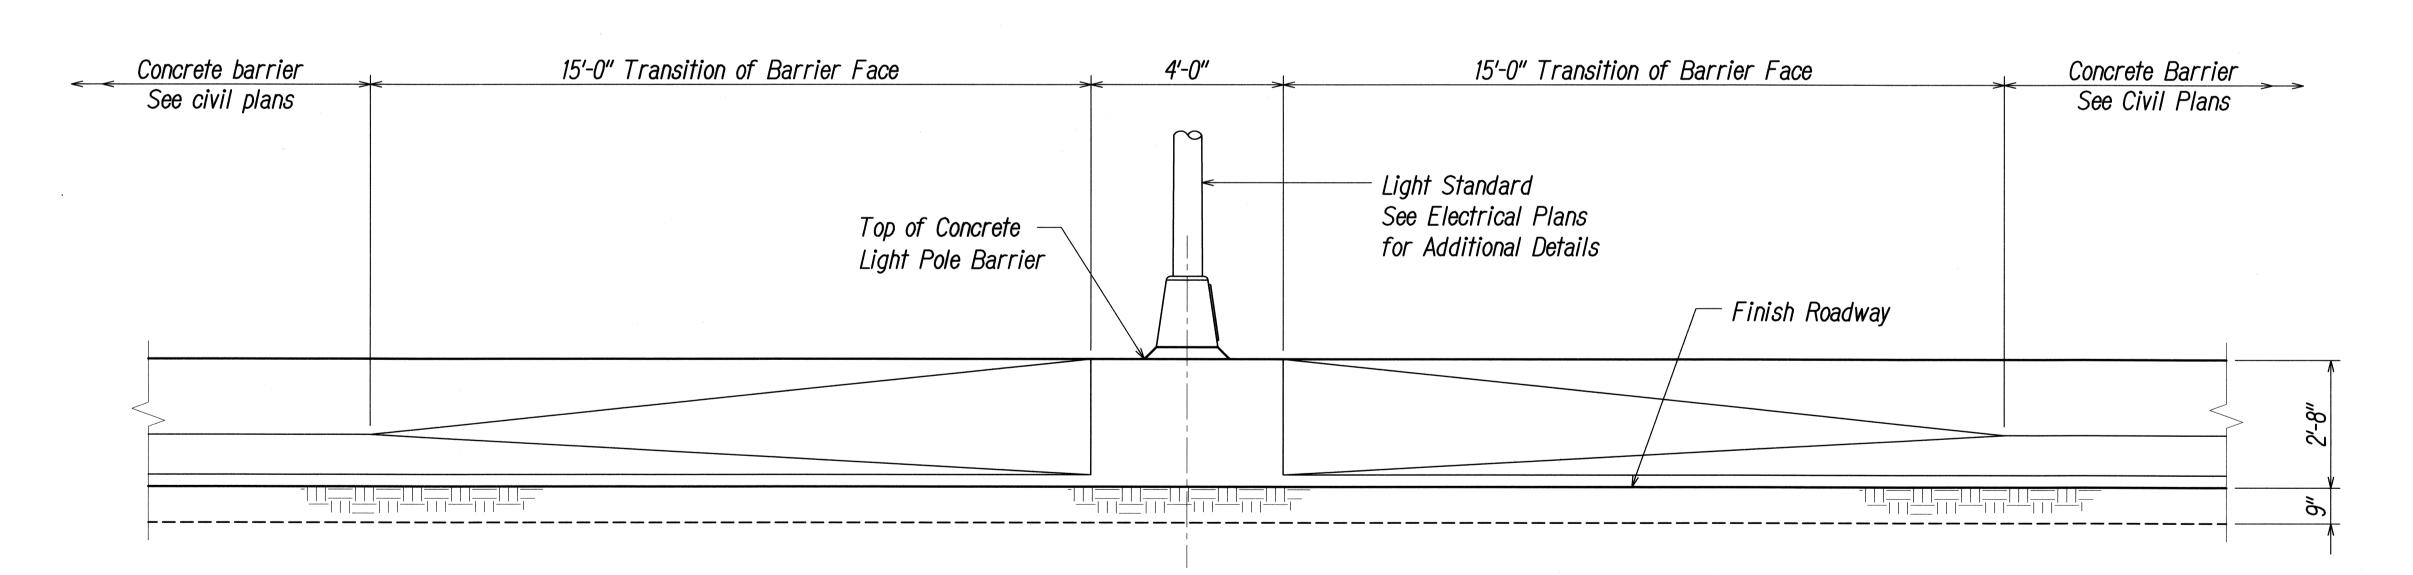

TYPICAL LIGHT POLE BARRIER ELEVATION

Scale: 1/2" = 1'-0"

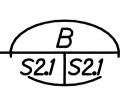

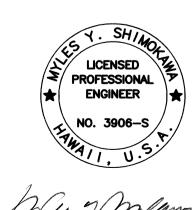

SIGNATURE

APRIL 30, 2010

EXPIRATION DATE OF LICENSE

THIS WORK WAS PREPARED BY ME OR UNDER MY SUPERVISION

STATE OF HAWAII
DEPARTMENT OF TRANSPORTATION
HIGHWAYS DIVISION

TYPICAL LIGHT POLE BARRIER

PLAN AND ELEVATION

KALANIANAOLE HIGHWAY MEDIAN

IMPROVEMENTS VICINITY OF OLOMANA

GOLF COURSE PROJECT NO. 72A-02-06


SCALE: As Noted DATE: June 2008


SHEET No. S2.1 OF 8 SHEETS



46

FED. ROAD DIST. NO.	STATE	PROJECT NO.	FISCAL YEAR	SHEET NO.	TOTAL SHEETS
HAWAII	HAW.	72A-02-06	2008	47	66

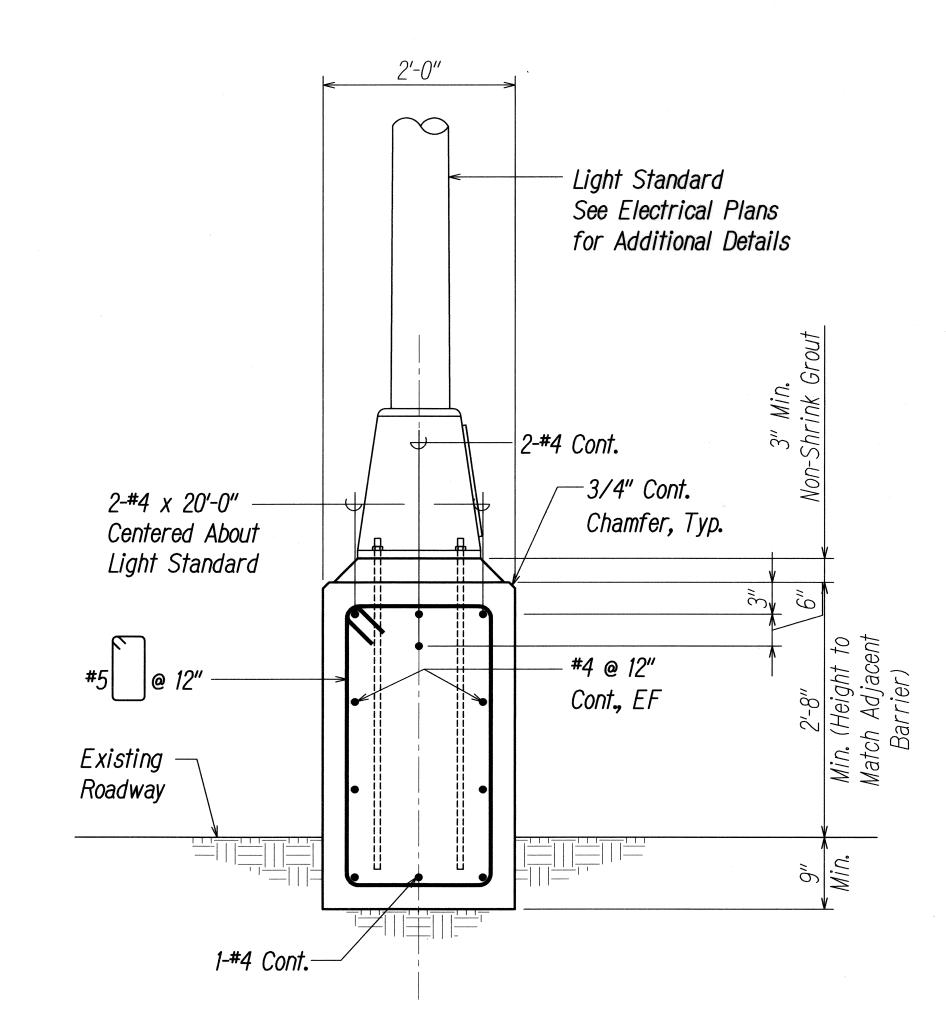

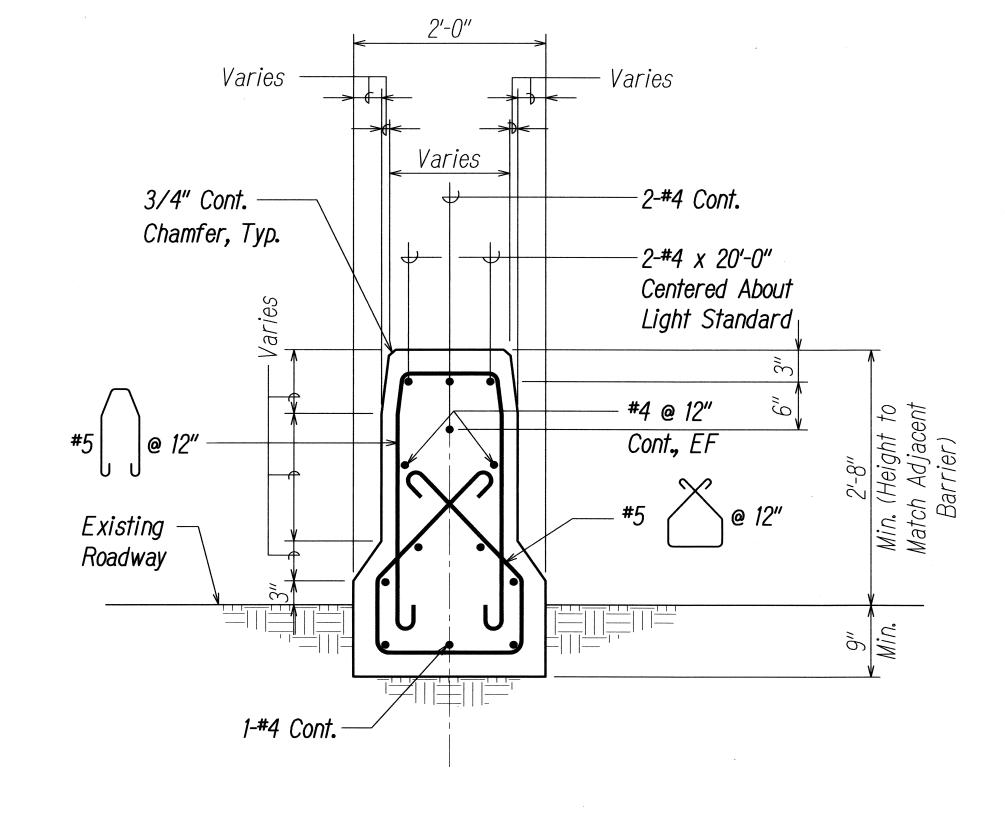


LIGHT STANDARD BARRIER SECTION

Scale: 1" = 1'-0"

Scale: 1" = 1'-0"

LIGHT POLE BARRIER TRANSITION SECTION B
Scale: 1" = 1'-0"

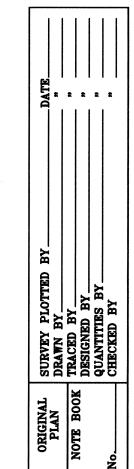

*.D**W**G 1 = 1



THIS WORK WAS PREPARED BY ME OR UNDER MY SUPERVISION

DEPARTMENT OF TRANSPORTATION
HIGHWAYS DIVISION

TYPICAL LIGHT POLE BARRIER


<u>IYPICAL LIGHT POLE BARRIER</u> <u>SECTIONS</u>

<u>KALANIANAOLE HIGHWAY MEDIAN</u> <u>IMPROVEMENTS VICINITY OF OLOMANA</u> <u>GOLF COURSE PROJECT NO. 72A-02-06</u>

SCALE: As Noted DATE: June 2008

SHEET No. S2.2 OF 8 SHEETS

SHEET NO. FED. ROAD DIST. NO. FISCAL YEAR TOTAL SHEETS PROJECT NO. STATE 72A-02-06 2008 48 HAW. HAWAII STATE OF HAWAII
DEPARTMENT OF TRANSPORTATION
HIGHWAYS DIVISION LICENSED PROFESSIONAL ENGINEER

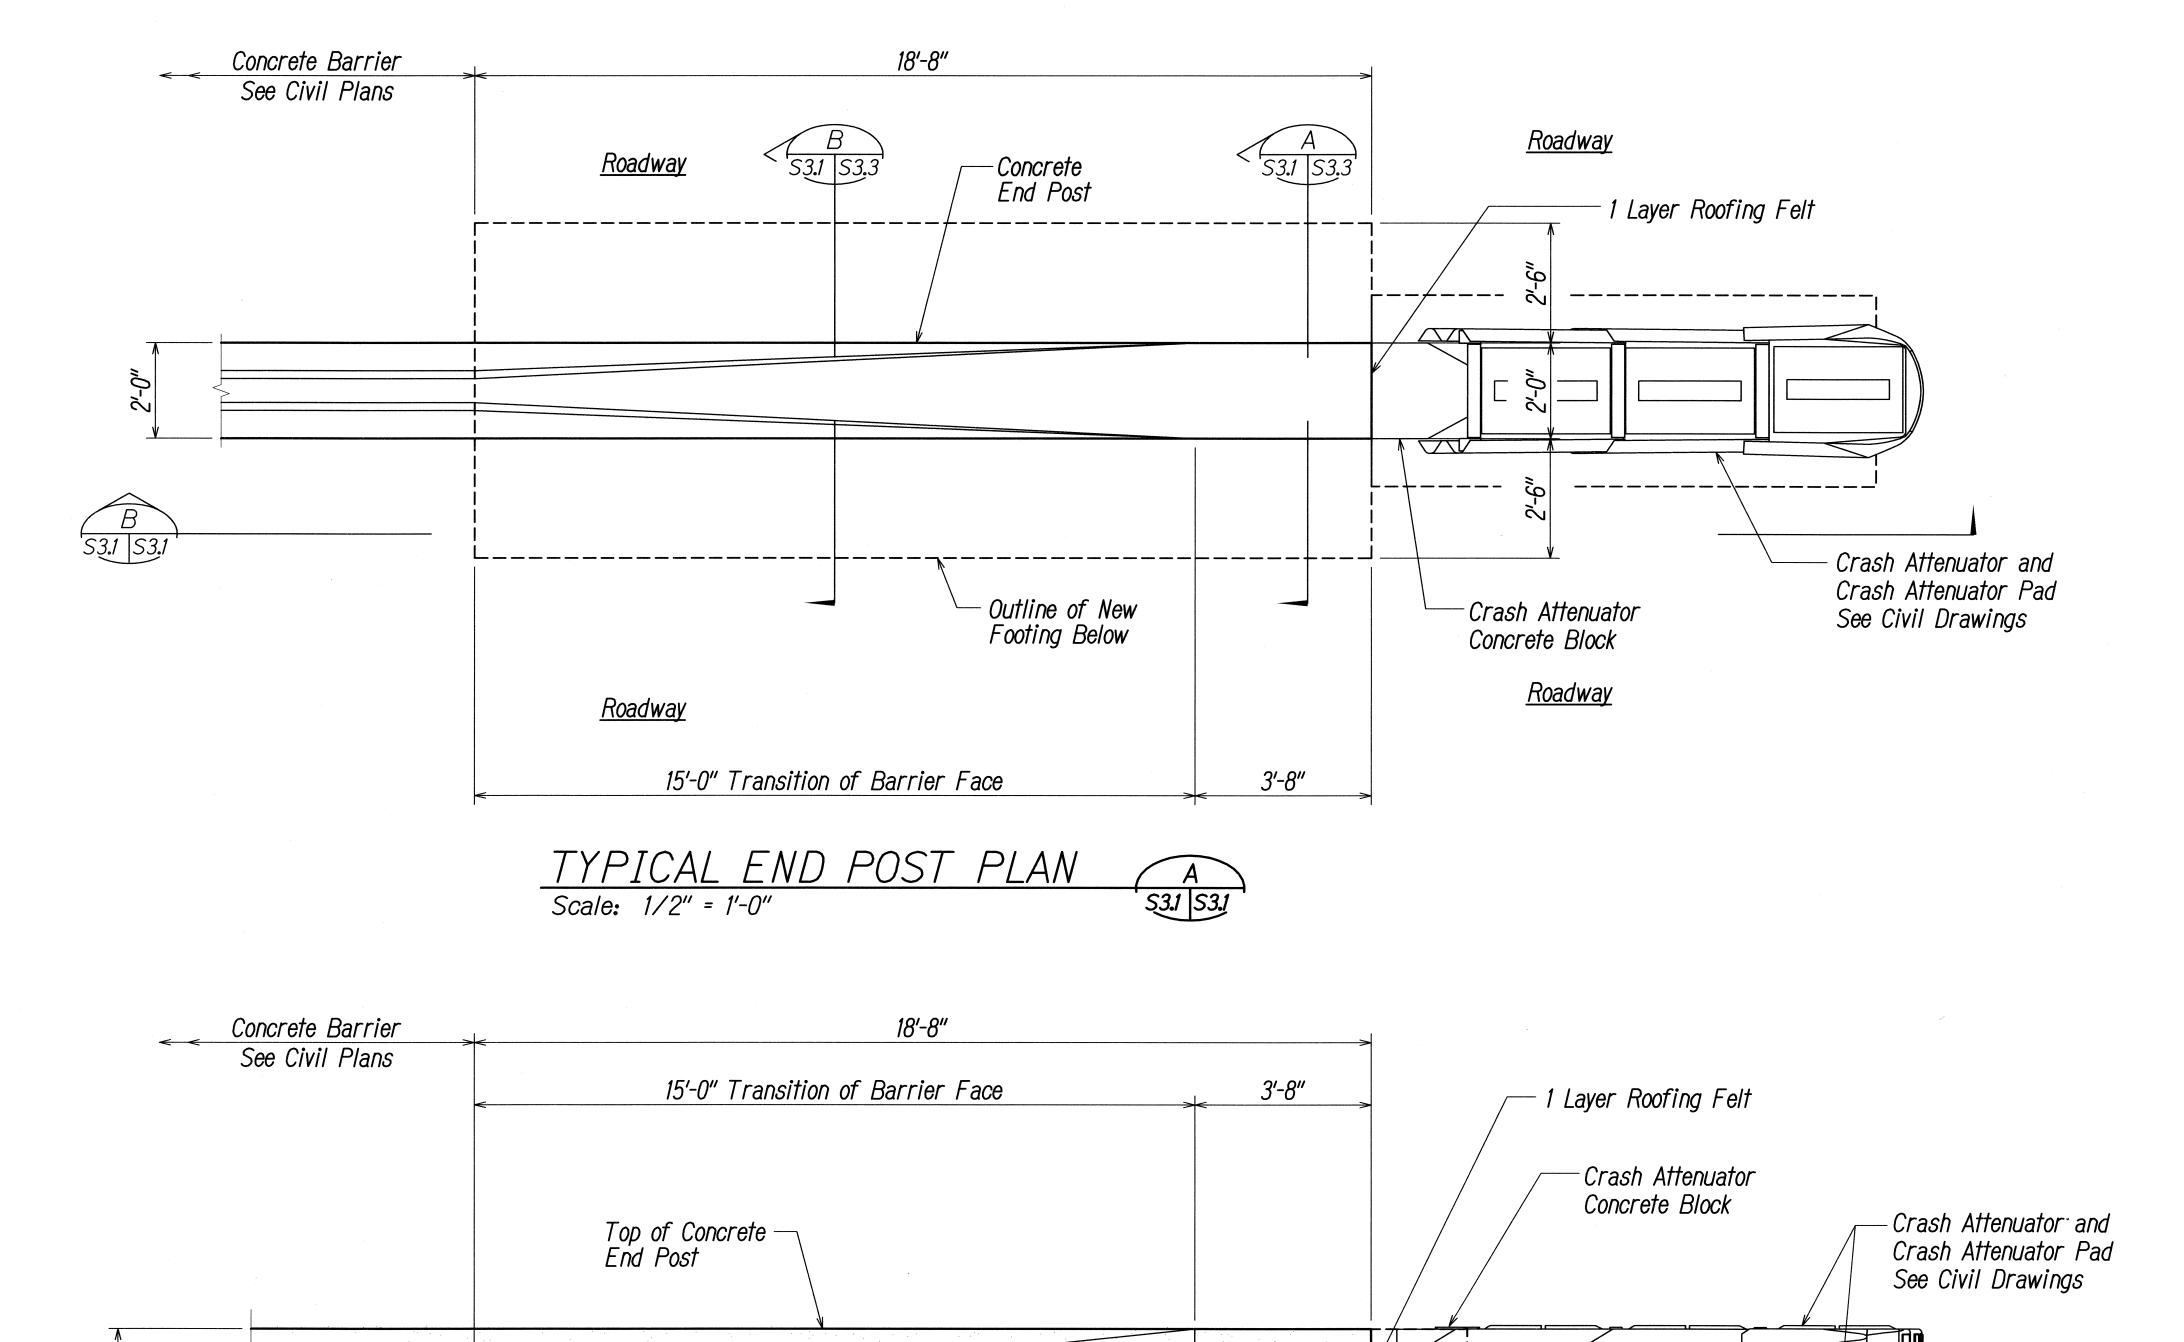

TYPICAL END POST ELEVATION

Scale: 1/2" = 1'-0"

-<u>|||=|||</u>

2'-0" Min.

ORIGINAL SURVEY PLOTTED BY—
PLAN DRAWN BY—
NOTE BOOK TRACED BY—
QUANTITIES BY—
QUANTITIES BY—
CHECKED BY—
CHECKED BY—

*.D**W**G 1 = 1



┌─ Finish

Roadway


My Marve SIGNATURE THIS WORK WAS PREPARED BY ME OR UNDER MY SUPERVISION

TYPICAL END POST PLAN AND ELEVATION

KALANIANAOLE HIGHWAY MEDIAN IMPROVEMENTS VICINITY OF OLOMANA GOLF COURSE PROJECT NO. 72A-02-06


SCALE: As Noted DATE: June 2008 SHEET No. S3.1 OF 8 SHEETS

FED. ROAD DIST. NO.	STATE	PROJECT NO.	FISCAL YEAR	SHEET NO.	TOTAL SHEETS
HAWAII	HAW.	72A-02-06	2008	49	66

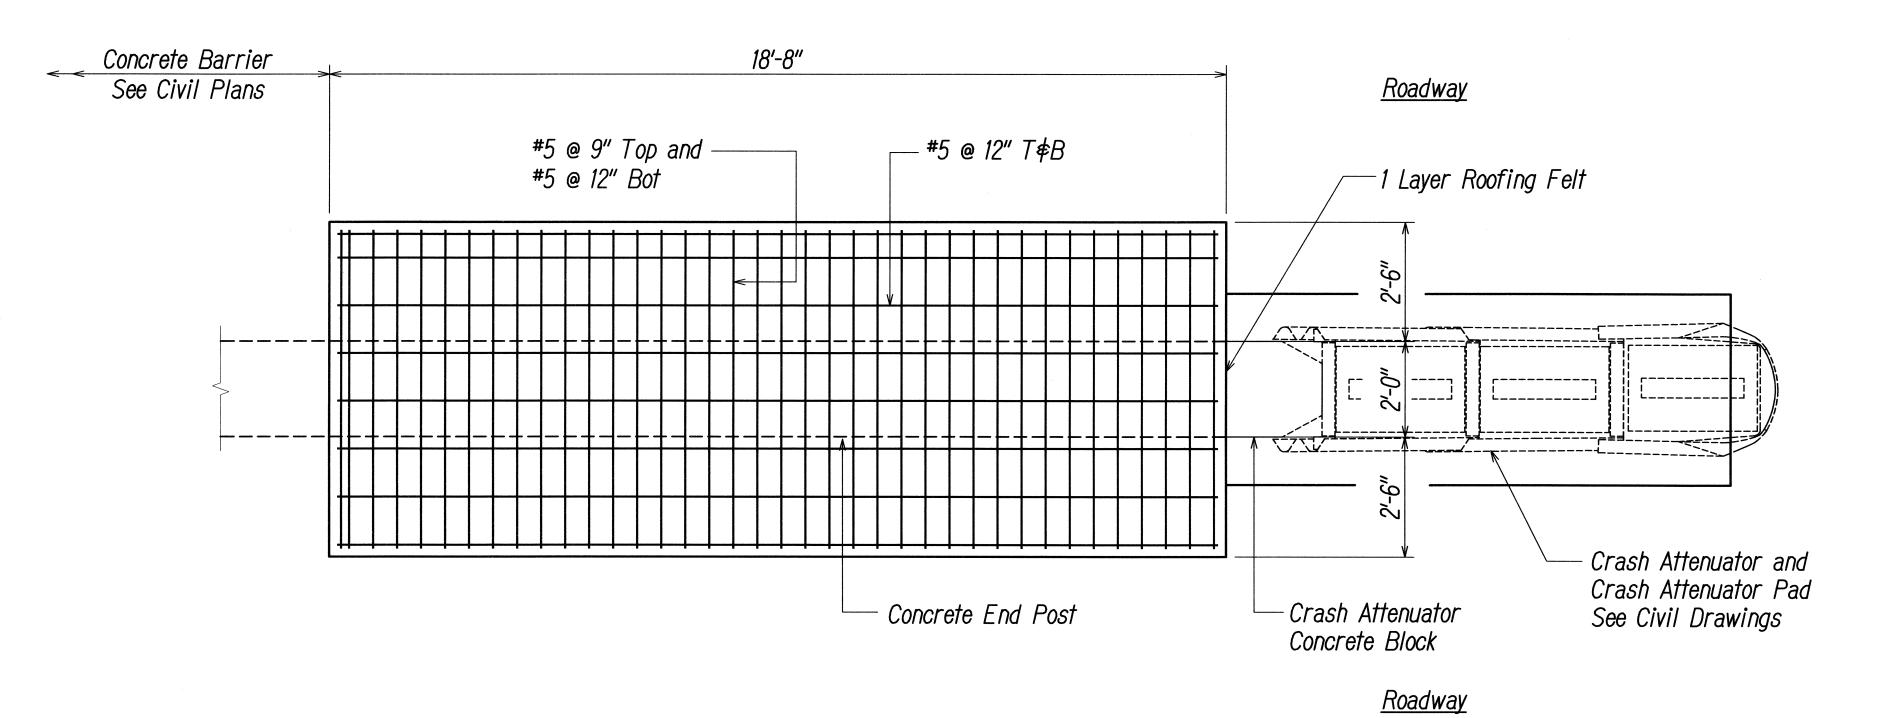


TYPICAL END POST FOUNDATION PLAN

Scale: 1/2" = 1'-0"

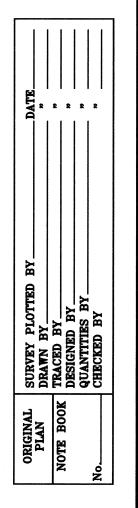

*.DWG 1 = 1

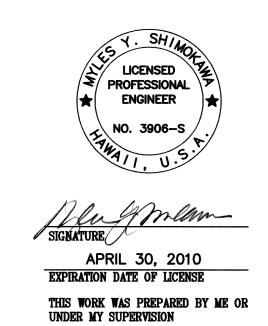

STATE OF HAWAII
DEPARTMENT OF TRANSPORTATION
HIGHWAYS DIVISION

TYPICAL END POST
FOUNDATION PLAN

KALANIANAOLE HIGHWAY MEDIAN

KALANIANAOLE HIGHWAY MEDIAN


IMPROVEMENTS VICINITY OF OLOMANA


GOLF COURSE PROJECT NO. 72A-02-06


SCALE: As Noted DATE: June 2008


SHEET No. S3.2 OF 8 SHEETS

FED. ROAD DIST. NO.	STATE	PROJECT NO.	FISCAL YEAR	SHEET NO.	TOTAL SHEETS
HAWAII	HAW.	72A-02-06	2008	50	66

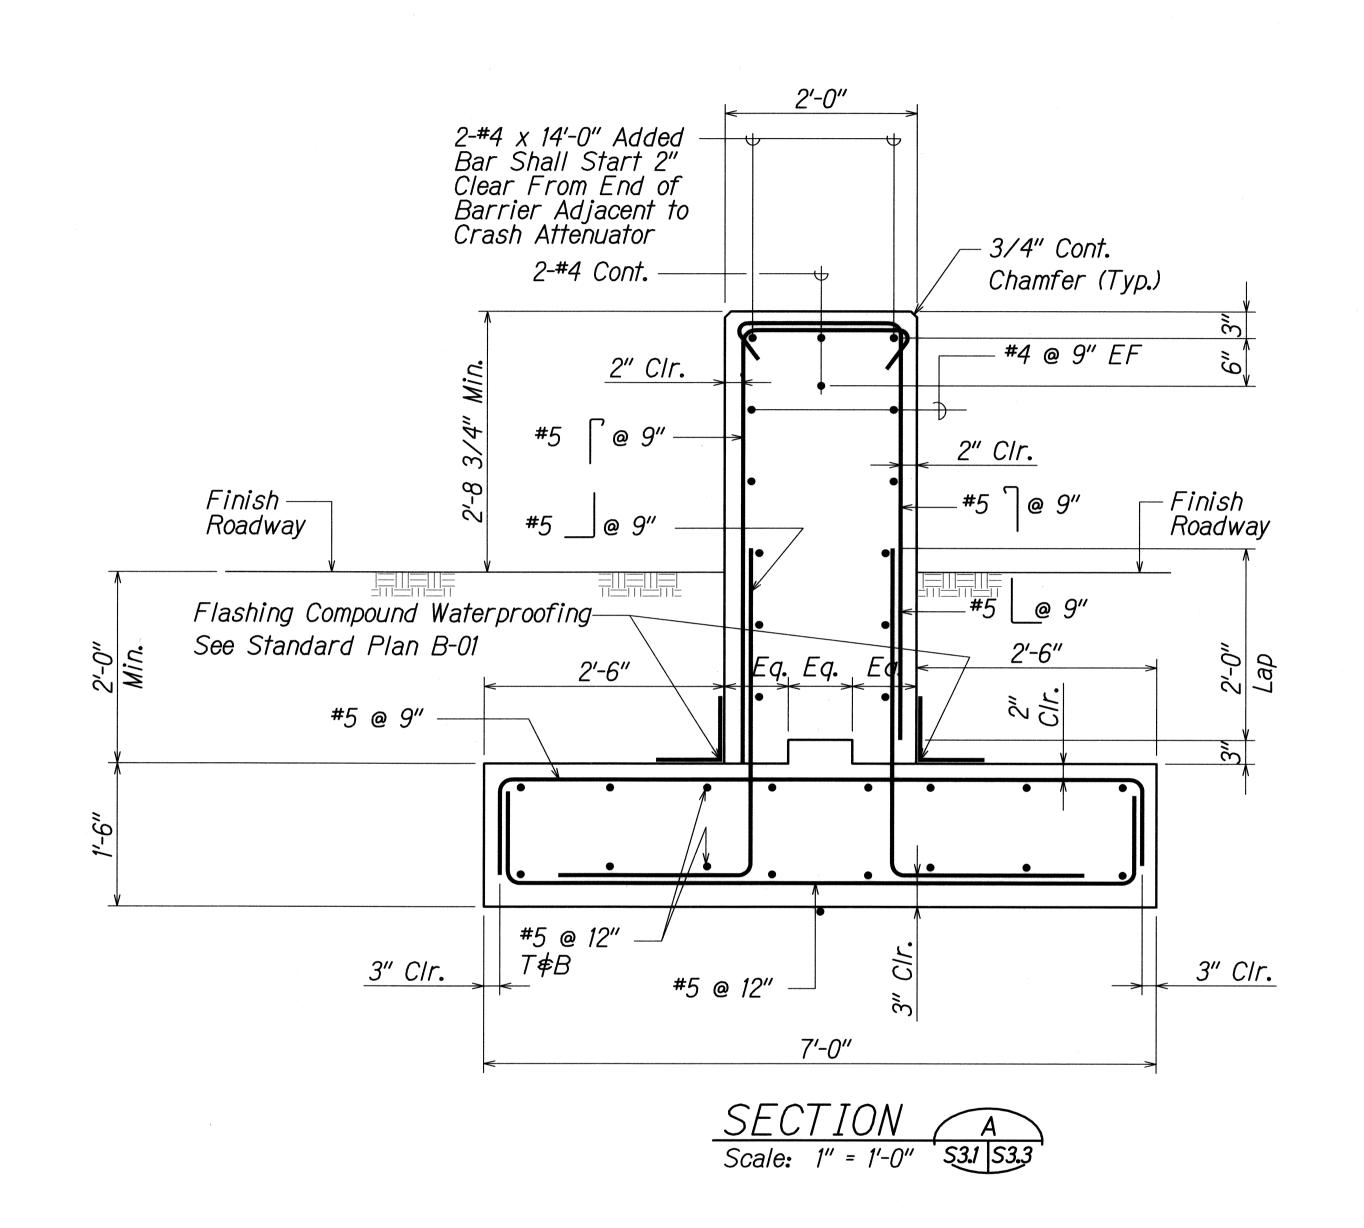

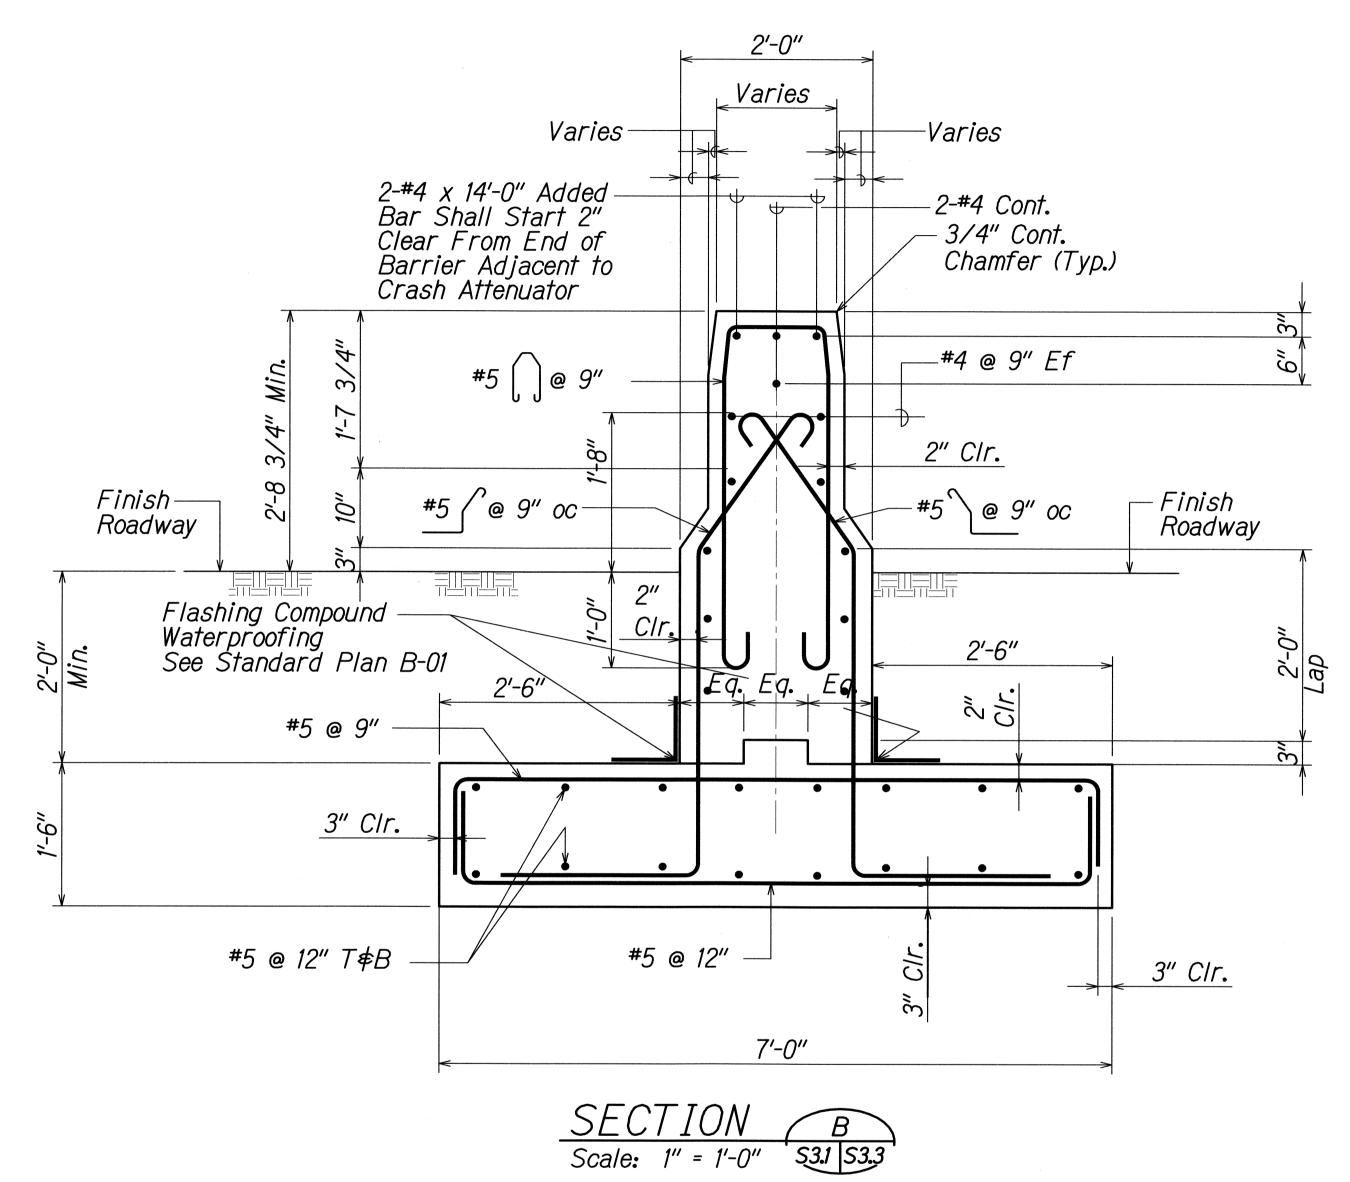

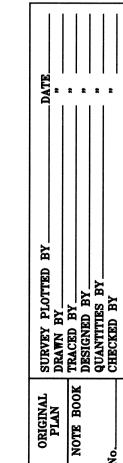

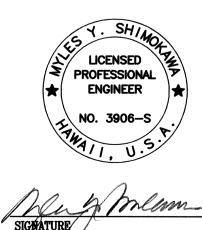

APRIL 30, 2010
EXPIRATION DATE OF LICENSE THIS WORK WAS PREPARED BY ME OR UNDER MY SUPERVISION STATE OF HAWAII
DEPARTMENT OF TRANSPORTATION
HIGHWAYS DIVISION TYPICAL END POST **SECTIONS**


KALANIANAOLE HIGHWAY MEDIAN IMPROVEMENTS VICINITY OF OLOMANA GOLF COURSE PROJECT NO. 72A-02-06


SCALE: As Noted DATE: June 2008

SHEET No. S3.3 OF 8 SHEETS

FED. ROAD DIST. NO. STATE PROJECT NO. FISCAL SHEET NO. SHEETS


HAWAII HAW. 72A-02-06 2008 51 66

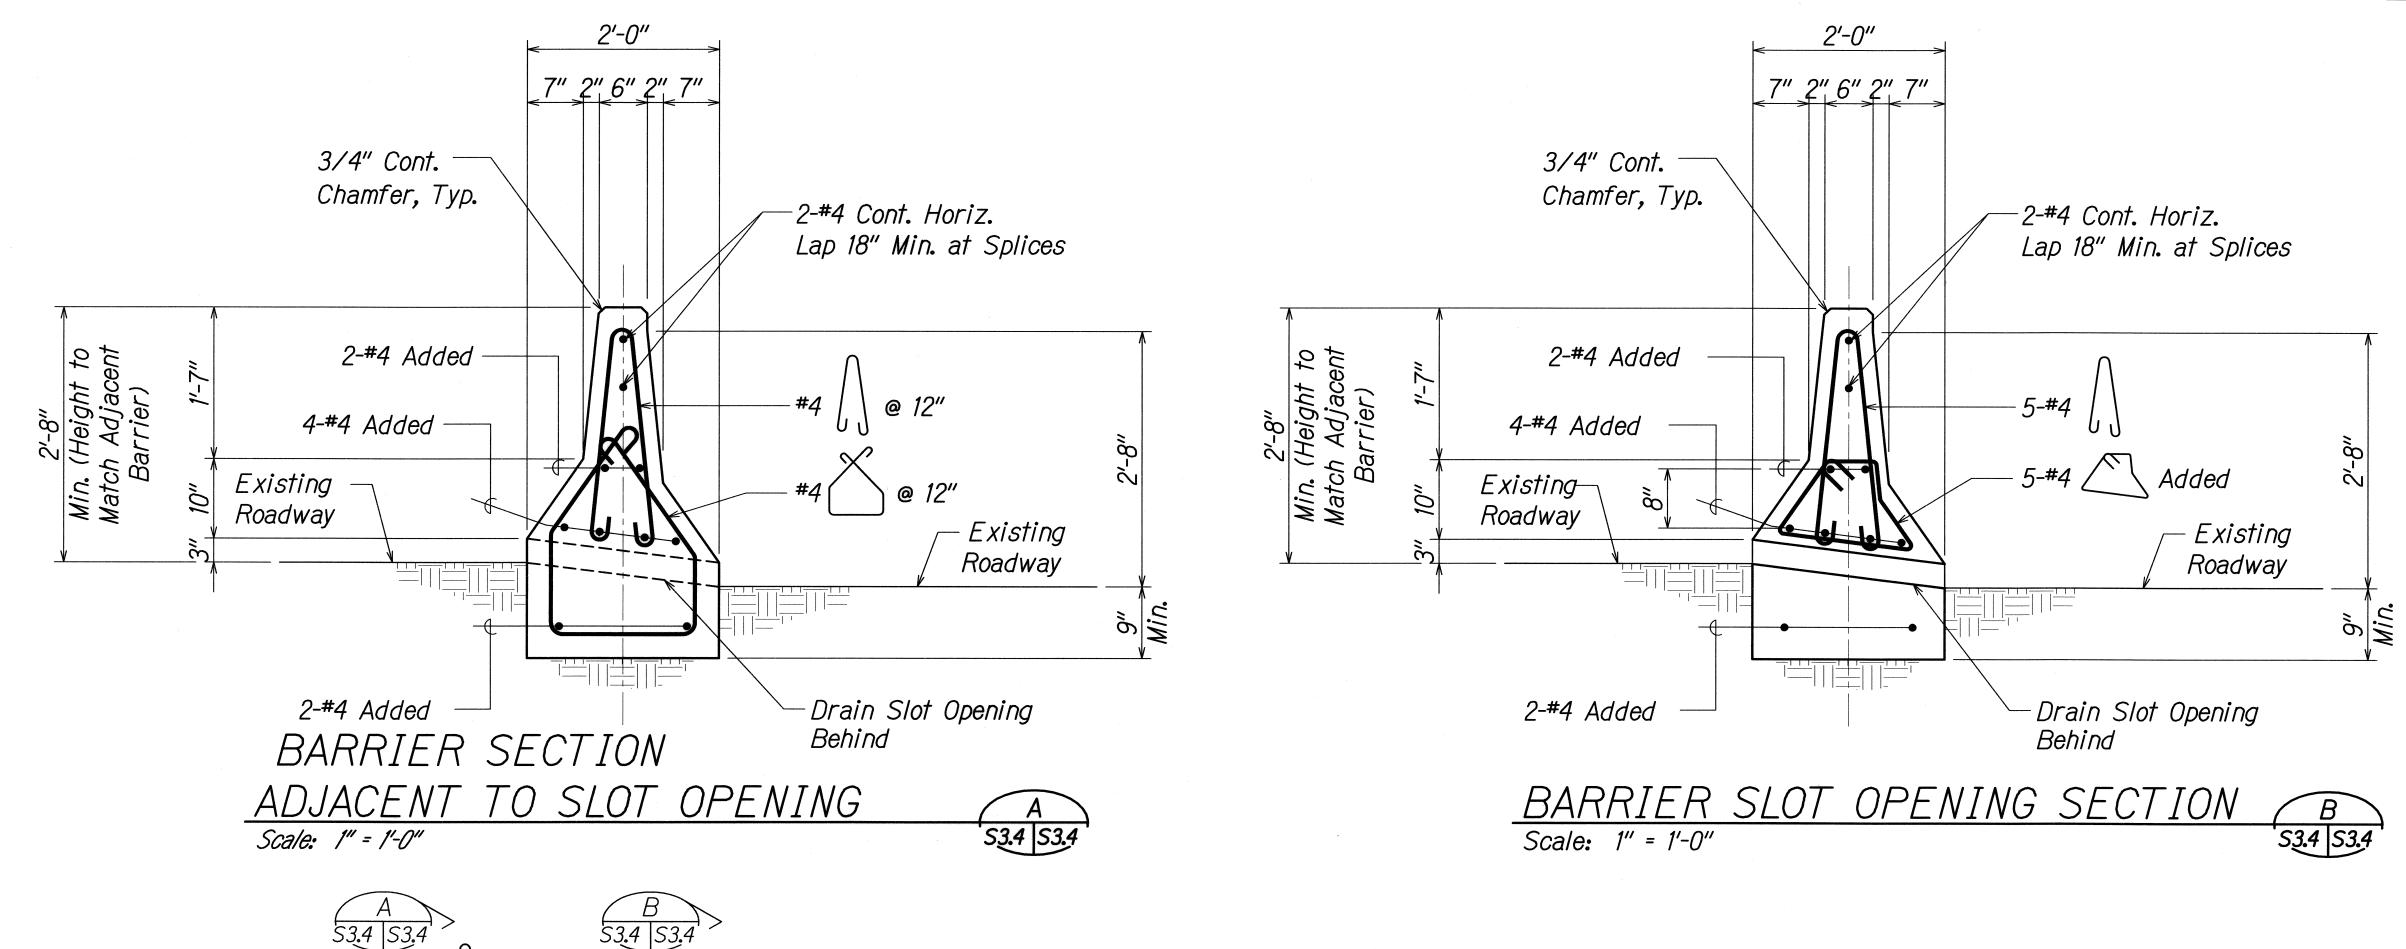

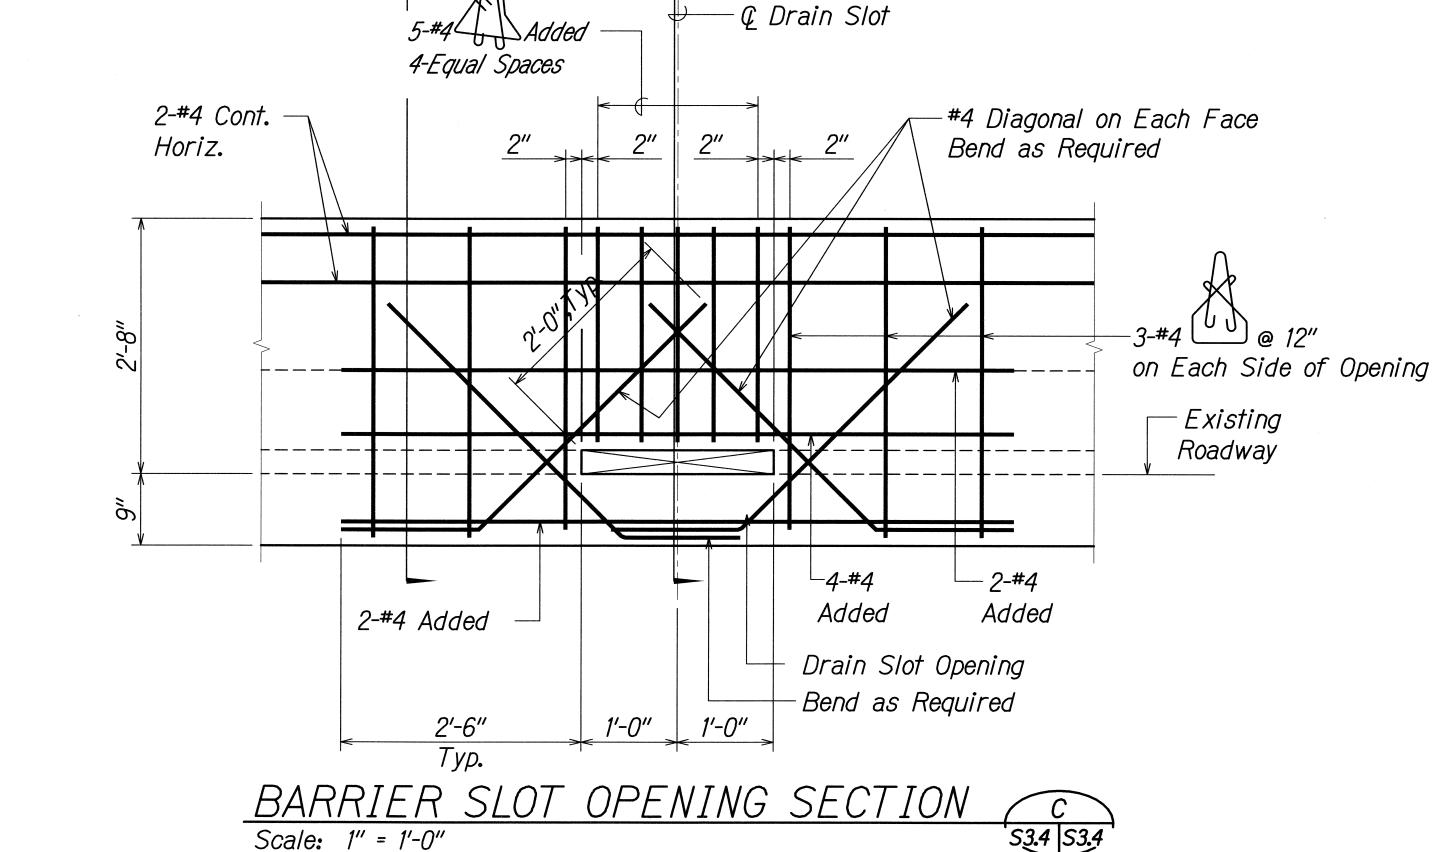

NOTE:

See Civil drawings for slot opening locations.

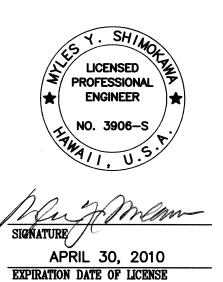

THIS WORK WAS PREPARED BY ME OR UNDER MY SUPERVISION

DEPARTMENT OF TRANSPORTATION
HIGHWAYS DIVISION

TYPICAL BARRIER SLOT OPENING

SECTIONS

KALANIANAOLE HIGHWAY MEDIAN

IMPROVEMENTS VICINITY OF OLOMANA

GOLF COURSE PROJECT NO. 72A-02-06

SCALE: As Noted DATE: June 2008

SHEET No. S3.4 OF 8 SHEETS

*.D**W**G 1 = 1 SURVEY PLOTTED E
DRAWN BY
TRACED BY
DESIGNED BY
QUANTITIES BY
CHECKED BY

51