



FED. ROAD DIST. NO.	STATE	FED. AID PROJ. NO.	FISCAL YEAR	SHEET NO.	TOTAL SHEETS
HAWAII	HAW.	NH-072-1(51)	2007	69	106

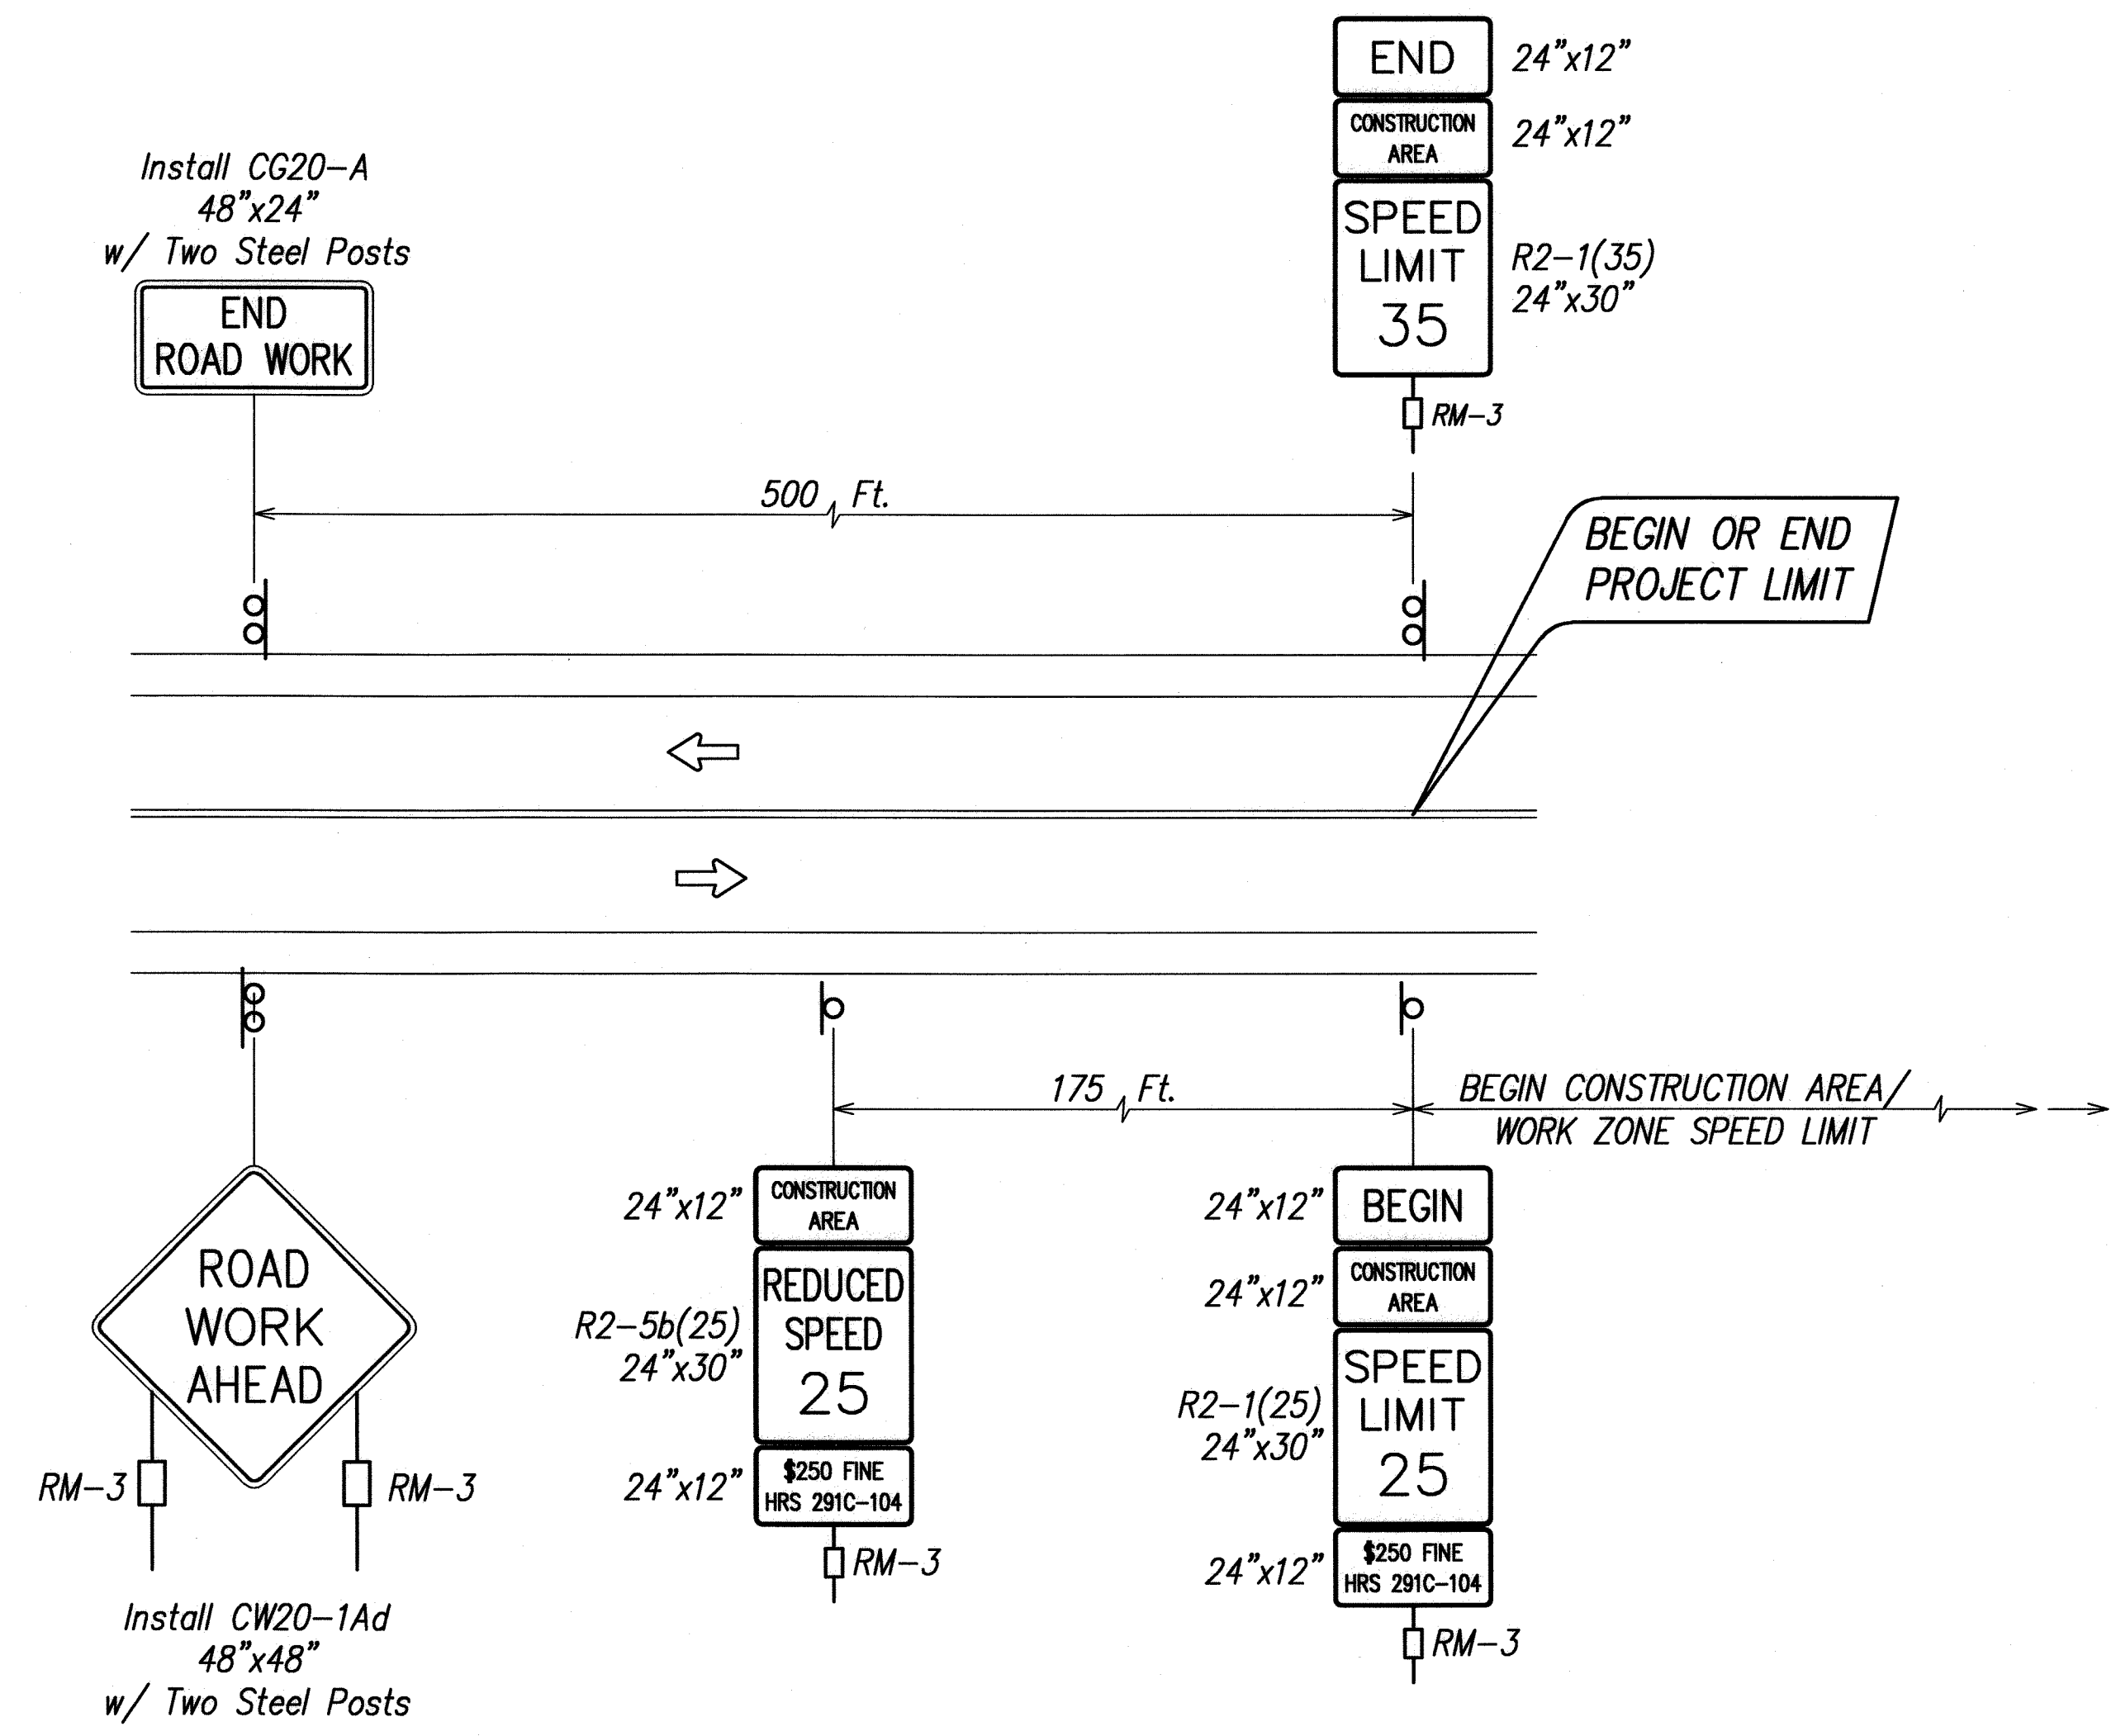


**TYPICAL DETAIL FOR CONSTRUCTION SIGNS
ON TWO LANE LOW SPEED HIGHWAY**
NOT TO SCALE

Work Zone Notes:


1. This Work Zone Sign Plan is intended for use on long-term stationary work zones/construction phases (3 days or more). All work zones or construction phases less than 3 days duration will use Traffic Control Plans shown in Section 645 of the Special Provisions.
2. All existing regulatory speed limit signs with posts within the work zone/project limits shall be removed and replaced with work zone speed limit sign assemblies (R2-1(25) and R2-5b(25) with "CONSTRUCTION AREA" and "\$250 FINE HRS 291C-104" Supplemental Signs).
3. Construction sign assemblies shall be installed on both the approaching and trailing ends of each work zone as shown on this plan.
4. Each construction warning sign shall have a minimum of four (4) Type III reflective markers (RM-3), 2 facing in each direction of traffic. Each work zone speed limit assembly shall have a minimum of two (2) RM-3, 1 facing each direction of traffic. Installation of each RM-3 shall be considered incidental to Item No. 645.7100, Construction Signs with Posts.
5. Upon the completion of all physical work or as directed by the Engineer, all construction signs and work zone speed limit assemblies shall be removed. All speed limit signs and posts that were existing at the start of the project within the work zone/project limits shall be restored back to their original locations and configurations.
6. Placement of construction signs shall not obstruct the path of pedestrians and bicyclists.
7. The removal and restoration of existing regulatory speed limit signs with new posts along with the installation, maintenance and removal of work zone speed limit sign assemblies shall be considered incidental to Item No. 645.7100, Construction Signs with Posts.

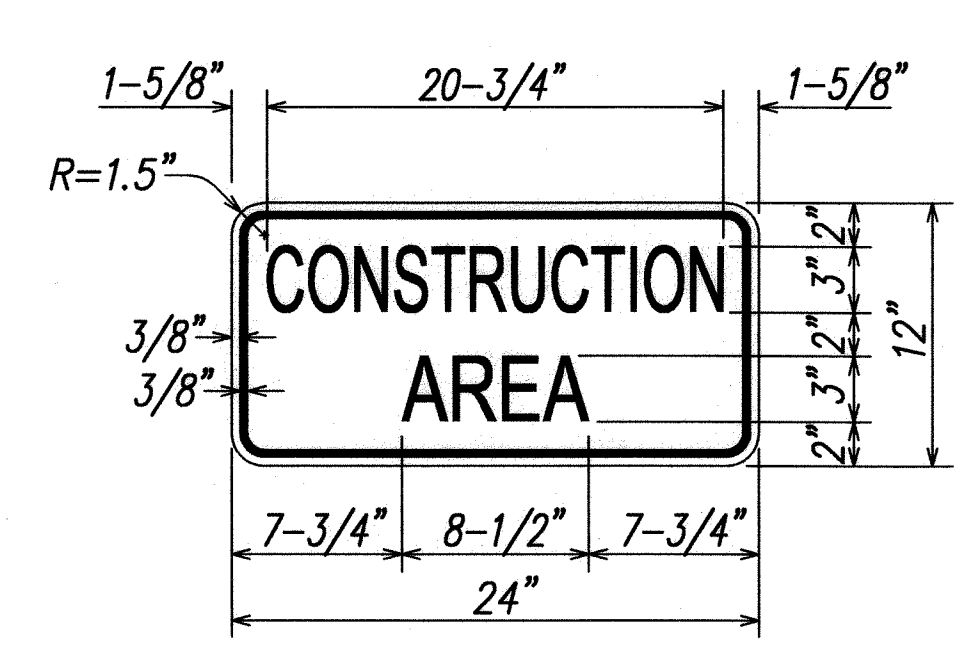


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Background: Orange

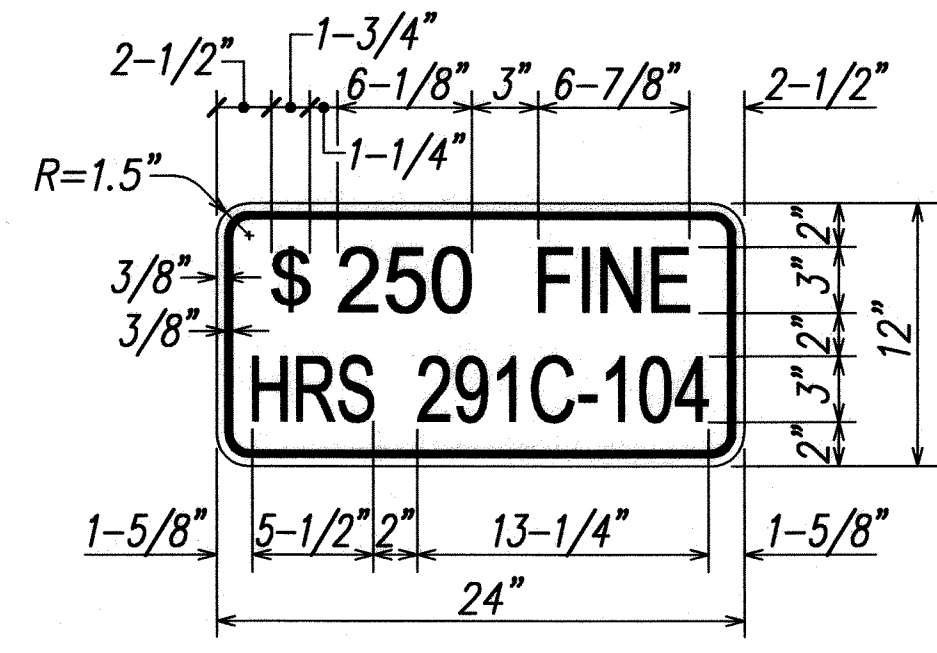


Legend: Black
Background: White

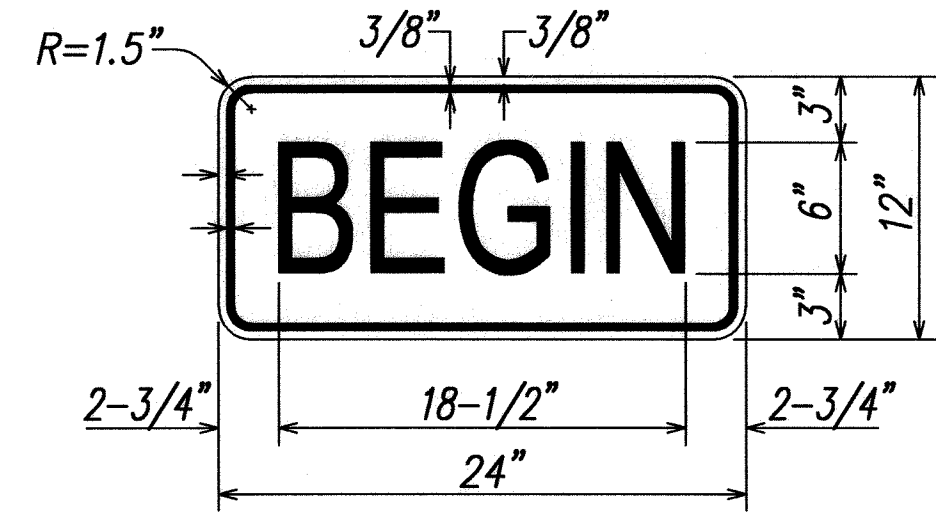

Legend: Black
Background: Orange

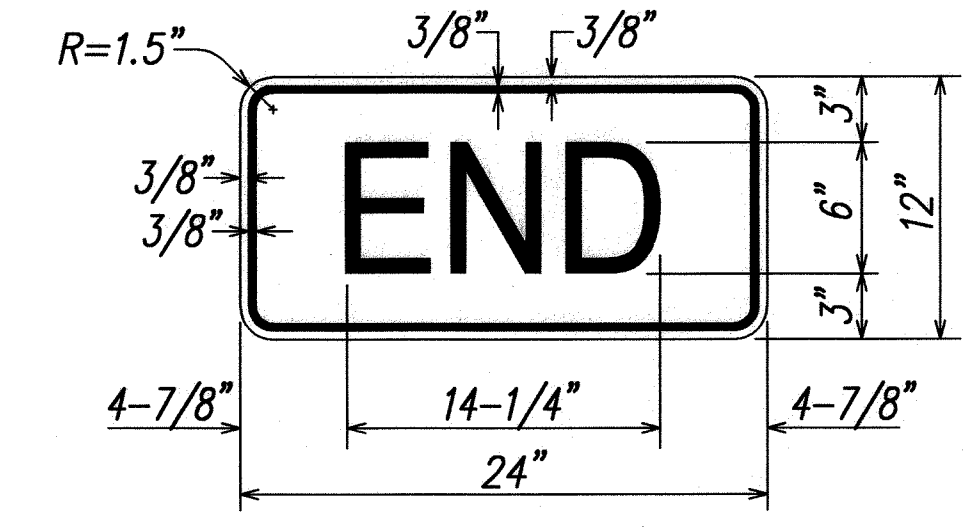

Legend: Black
Background: Orange

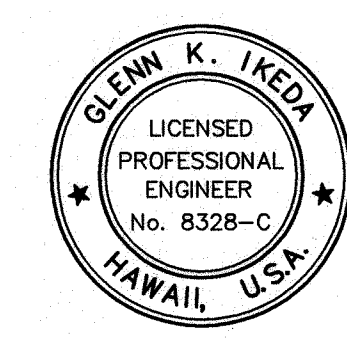

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8-10-07
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dba PARK ENGINEERING
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DEPARTMENT OF TRANSPORTATION
HIGHWAYS DIVISION

**WORK ZONE SIGNING PLAN
NOTES & DETAILS**


*Kalaniana'ole Highway Improvements
Retaining Wall at Makapuu, Oahu
Federal-Aid Project No. NH-072-1(51)*

Scale: As Noted Date: APR. 2007

SHEET No. 1 OF 8 SHEETS

FED. ROAD DIST. NO.	STATE	FED. AID PROJ. NO.	FISCAL YEAR	SHEET NO.	TOTAL SHEETS
HAWAII	HAW.	NH-072-1(51)	2007	71	106

- Legend:
- Cone Or Delineator
 - p Construction Sign
 - Work Zone
 - Police Officer
 - Arrow Board
 - Traffic Direction

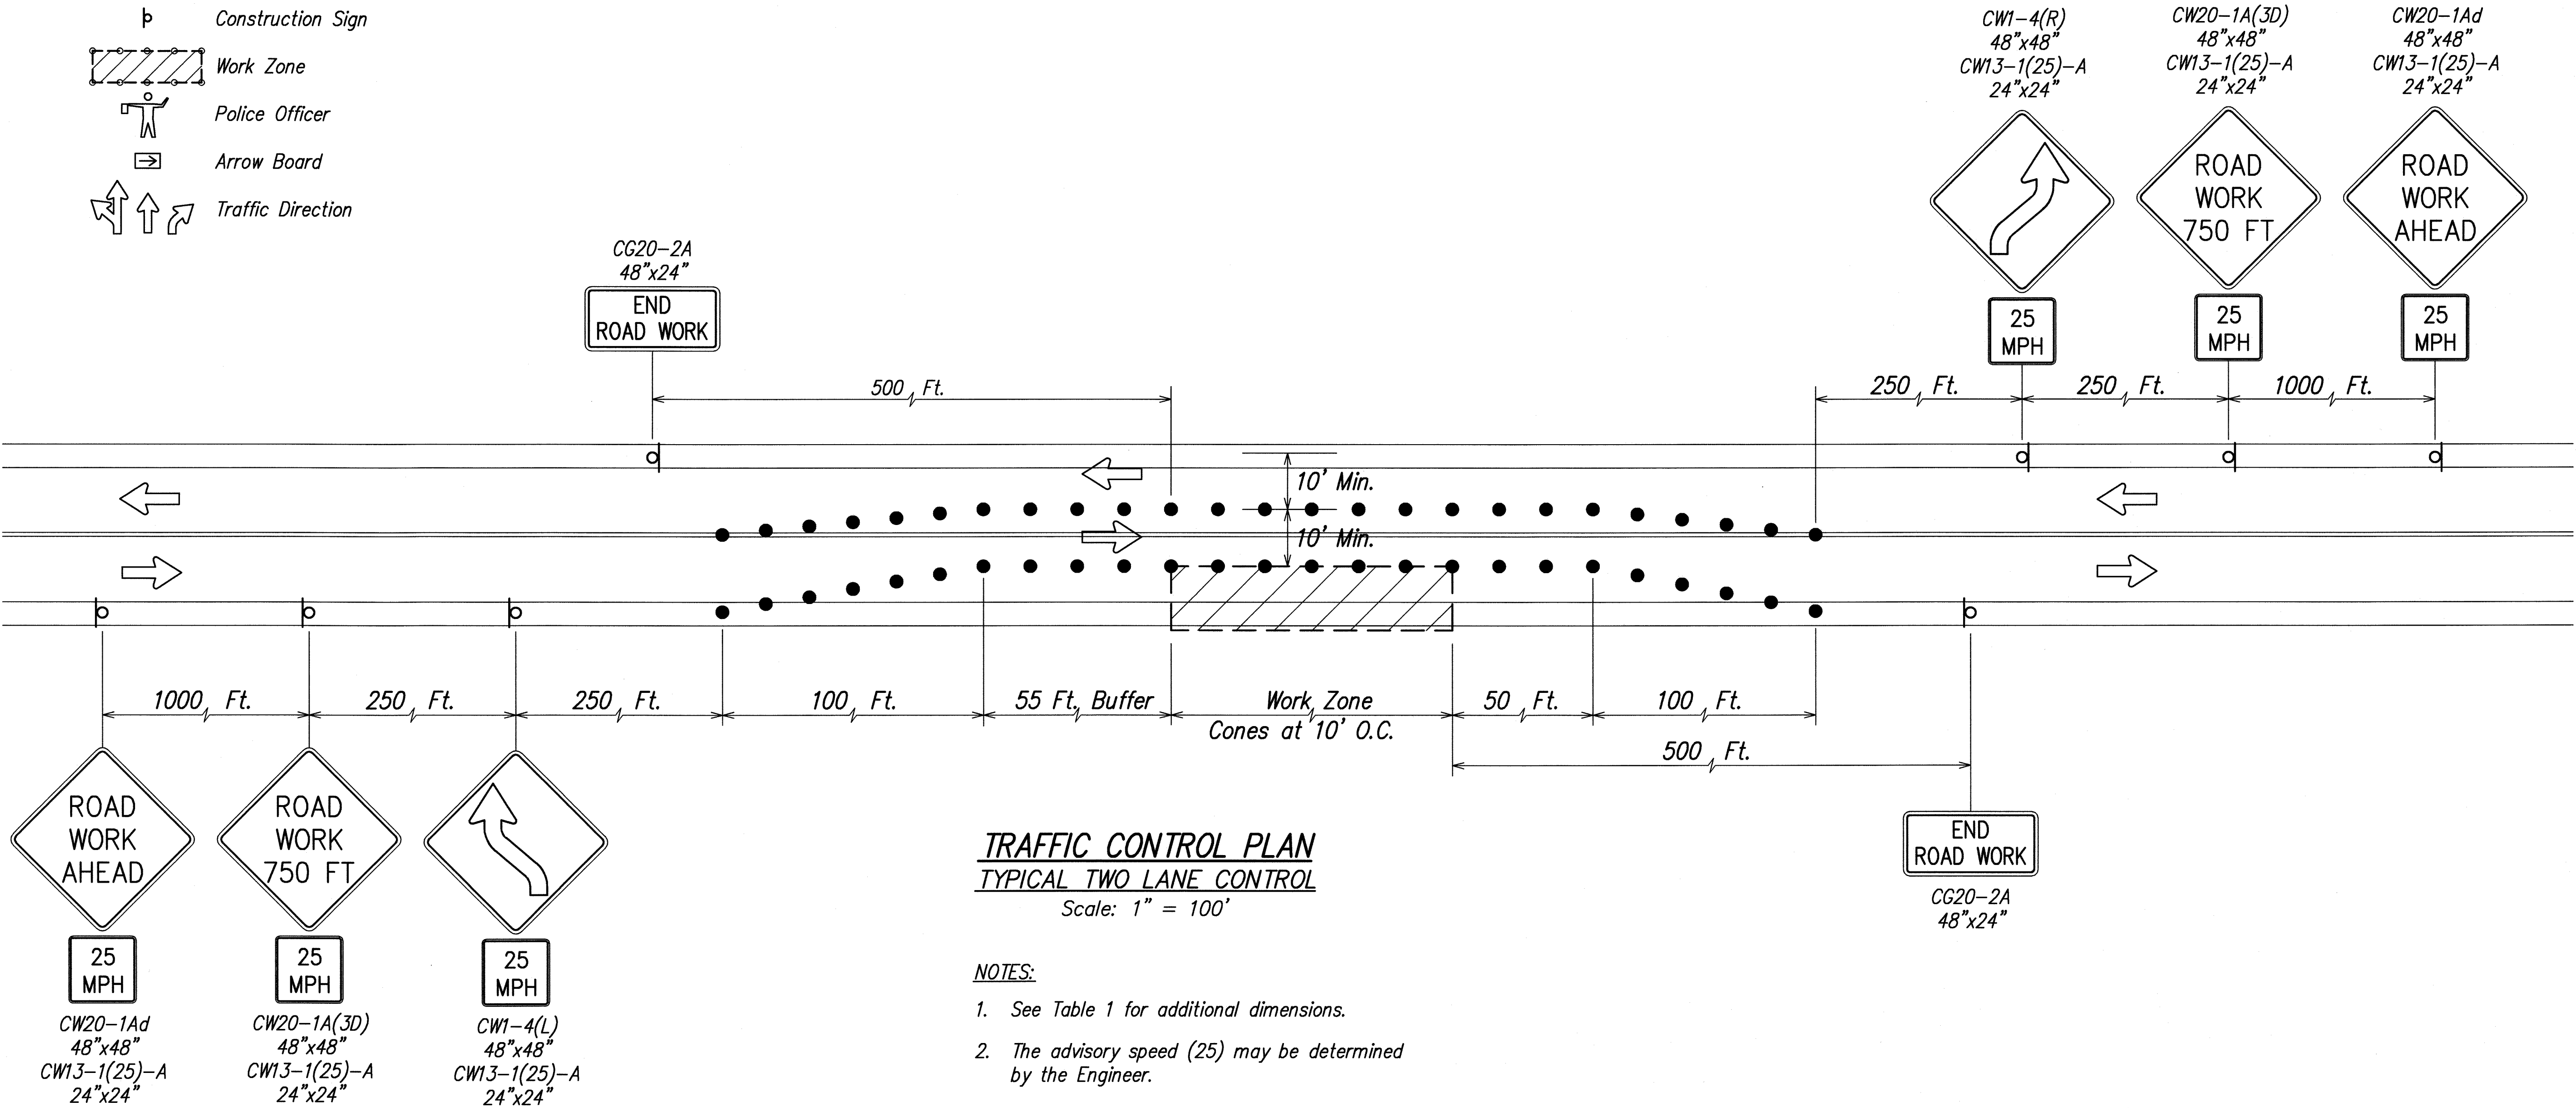

ORIGINAL PLAN	DATE
NOTED BY	DESIGNED BY
QUANTITIES BY	CHECKED BY
No.	

LIB2: STATE\DOT\KALANIANA'OLE\RETAINING WALL\CADD\ KALRW-71-TCP2LANE.dwg 6/19/06



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 HIGHWAYS DIVISION


TRAFFIC CONTROL PLAN
TYPICAL TWO LANE CONTROL

Kalaniana'ole Highway Improvements
Retaining Wall at Makapuu, Oahu
Federal-Aid Project No. NH-072-1(51)


Scale: As Noted Date: APR. 2007

SHEET No. 3 OF 8 SHEETS


FED. ROAD DIST. NO.	STATE	FED. AID PROJ. NO.	FISCAL YEAR	SHEET NO.	TOTAL SHEETS
HAWAII	HAW.	NH-072-1(51)	2007	72	106

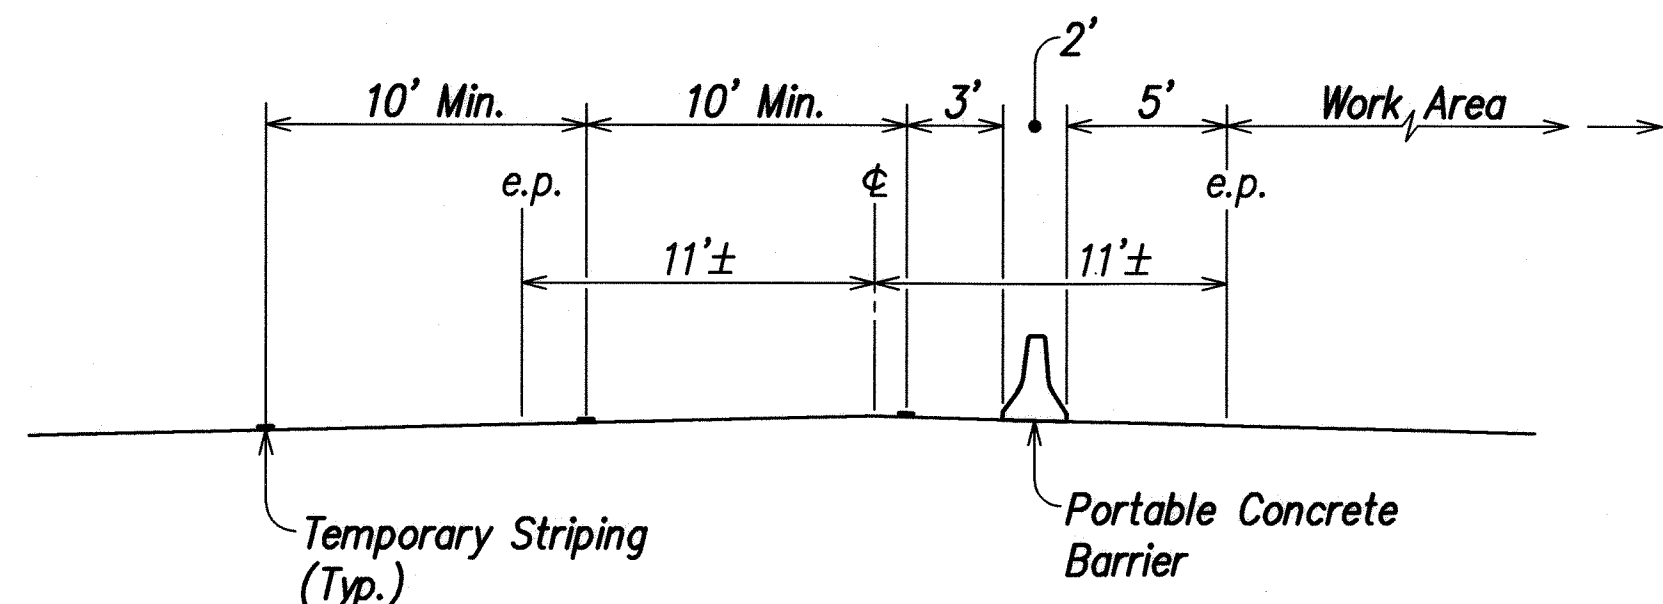

SECTION A-A

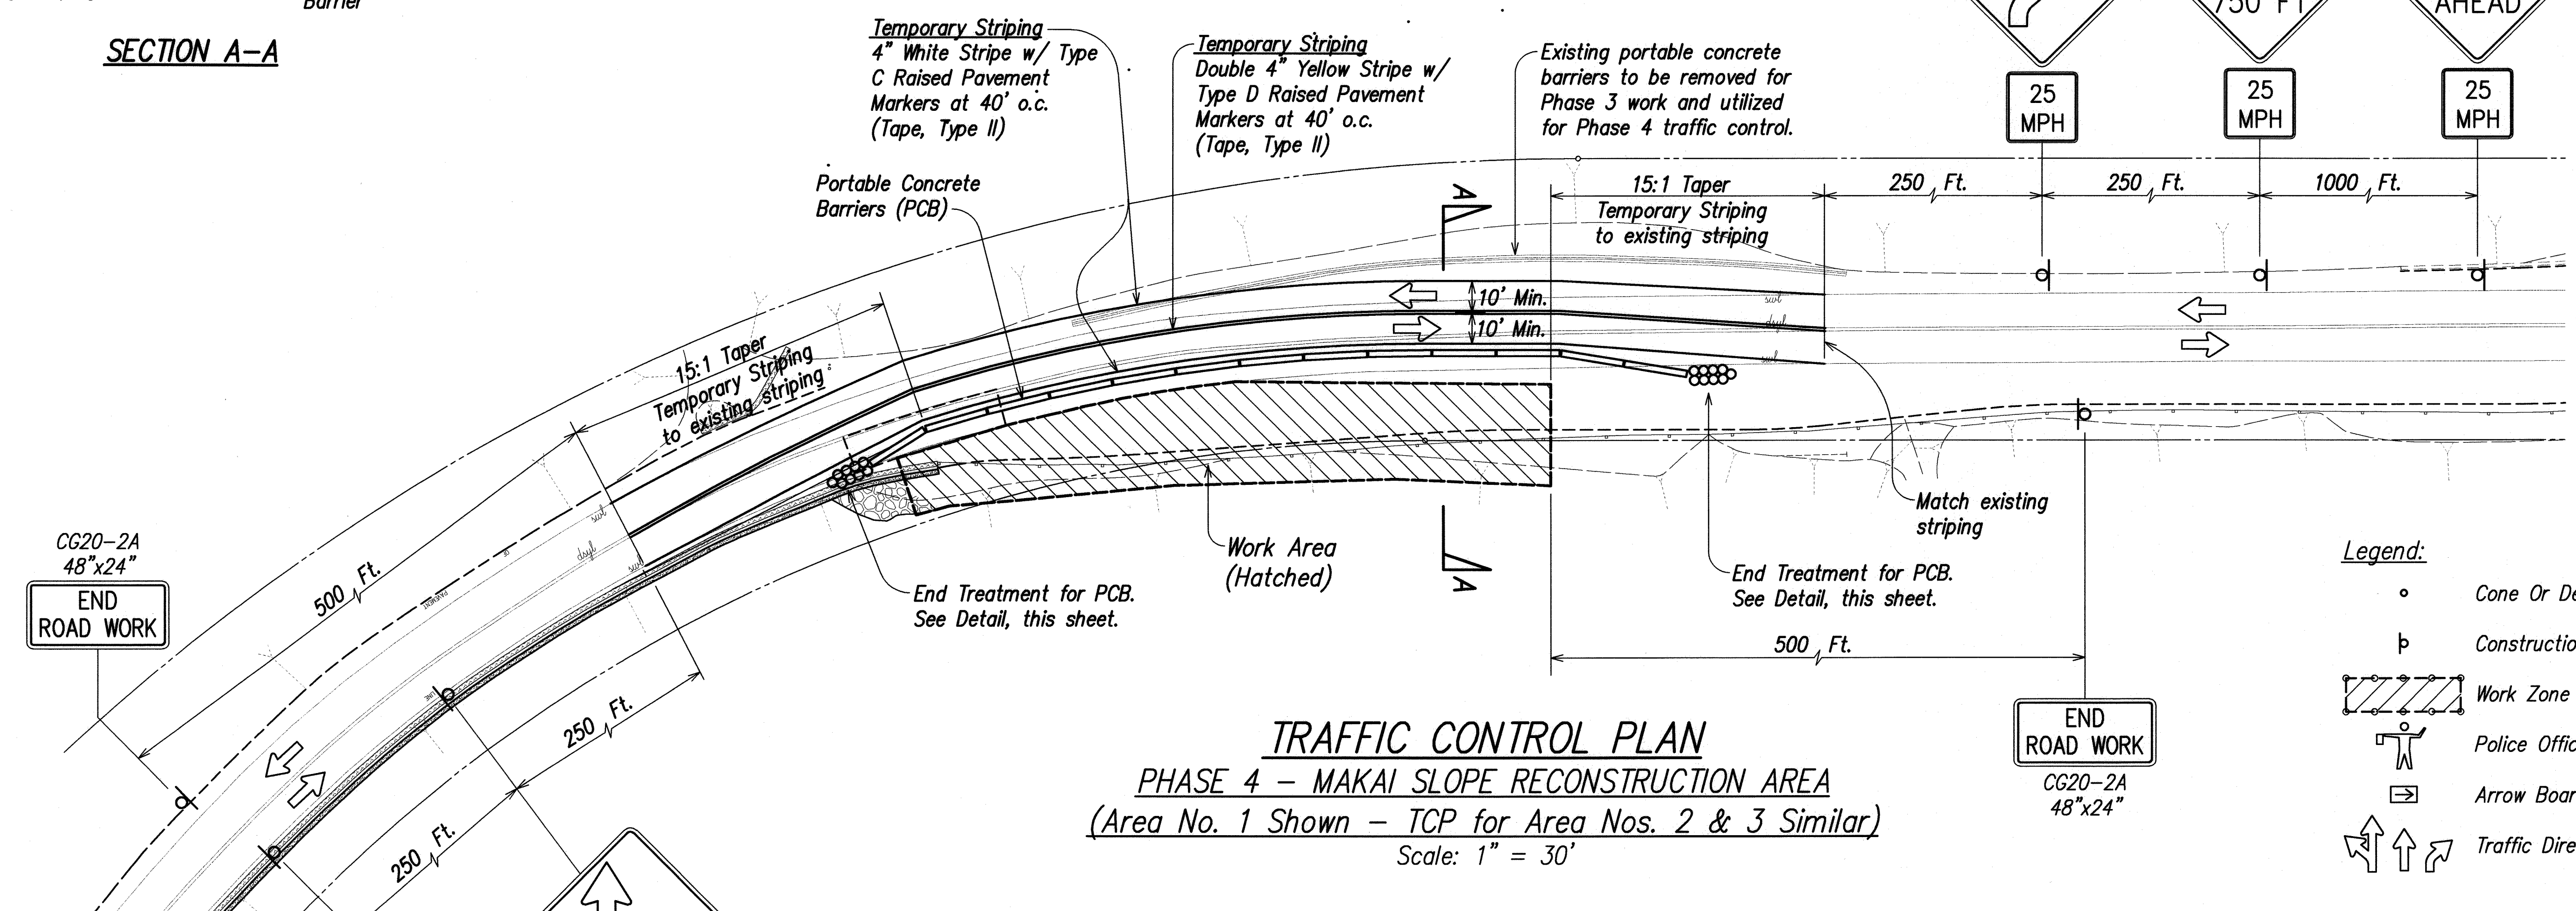


TRAFFIC CONTROL PLAN
PHASE 4 - MAKAI SLOPE RECONSTRUCTION AREA
(Area No. 1 Shown - TCP for Area Nos. 2 & 3 Similar)
Scale: 1" = 30'

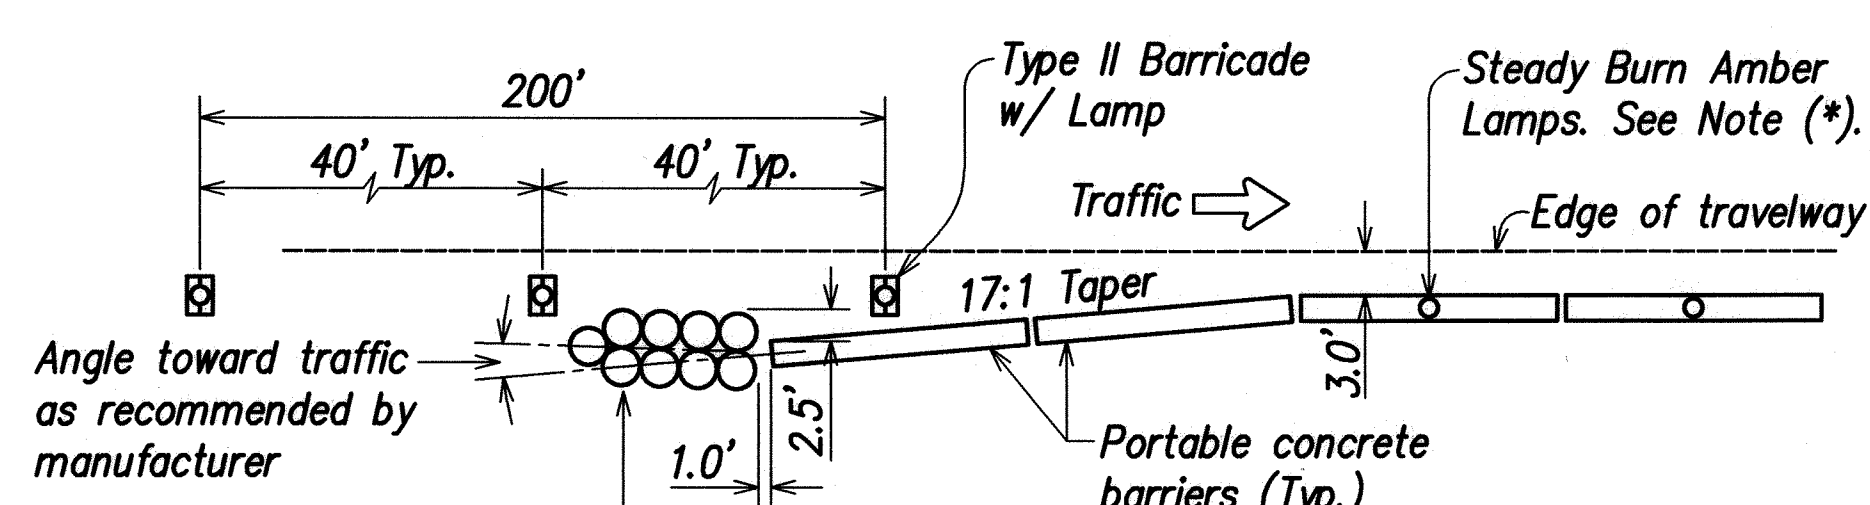

(* Note:
Install steady burn amber lamps on PCB at 20' o.c. Installing, maintaining and removing each steady burn amber lamp shall be considered incidental to the various items in Section 645.

Number indicates module weight in hundreds of pounds.
INERTIAL BARRIER SIZES

PCB END TREATMENT
Not To Scale

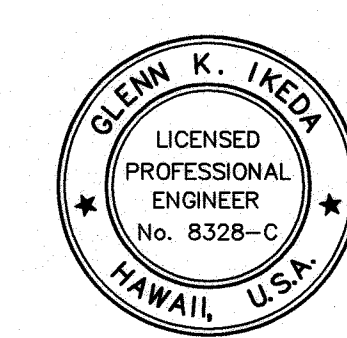


THIS WORK WAS PREPARED BY ME OR UNDER MY SUPERVISION
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STATE OF HAWAII
DEPARTMENT OF TRANSPORTATION
HIGHWAYS DIVISION
TRAFFIC CONTROL PLAN
TYPICAL PHASE 4 CONTROL
Kalaniana'ole Highway Improvements
Retaining Wall at Makapuu, Oahu
Federal-Aid Project No. NH-072-1(51)
Scale: As Noted Date: APR. 2007
SHEET No. 4 OF 8 SHEETS


SURVEY PLOTTED BY	DATE
DESIGNED BY	
TRACED BY	
NOTE BOOK	
QUANTITIES BY	
CHECKED BY	
NO.	

LUB2: STATE DOT \XALANAOLE\RETAINING WALL\CA000\KALRW-72-TCPPH4.dwg 4/16/07

FED. ROAD DIST. NO.	STATE	FED. AID PROJ. NO.	FISCAL YEAR	SHEET NO.	TOTAL SHEETS
HAWAII	HAW.	NH-072-1(51)	2007	73	106

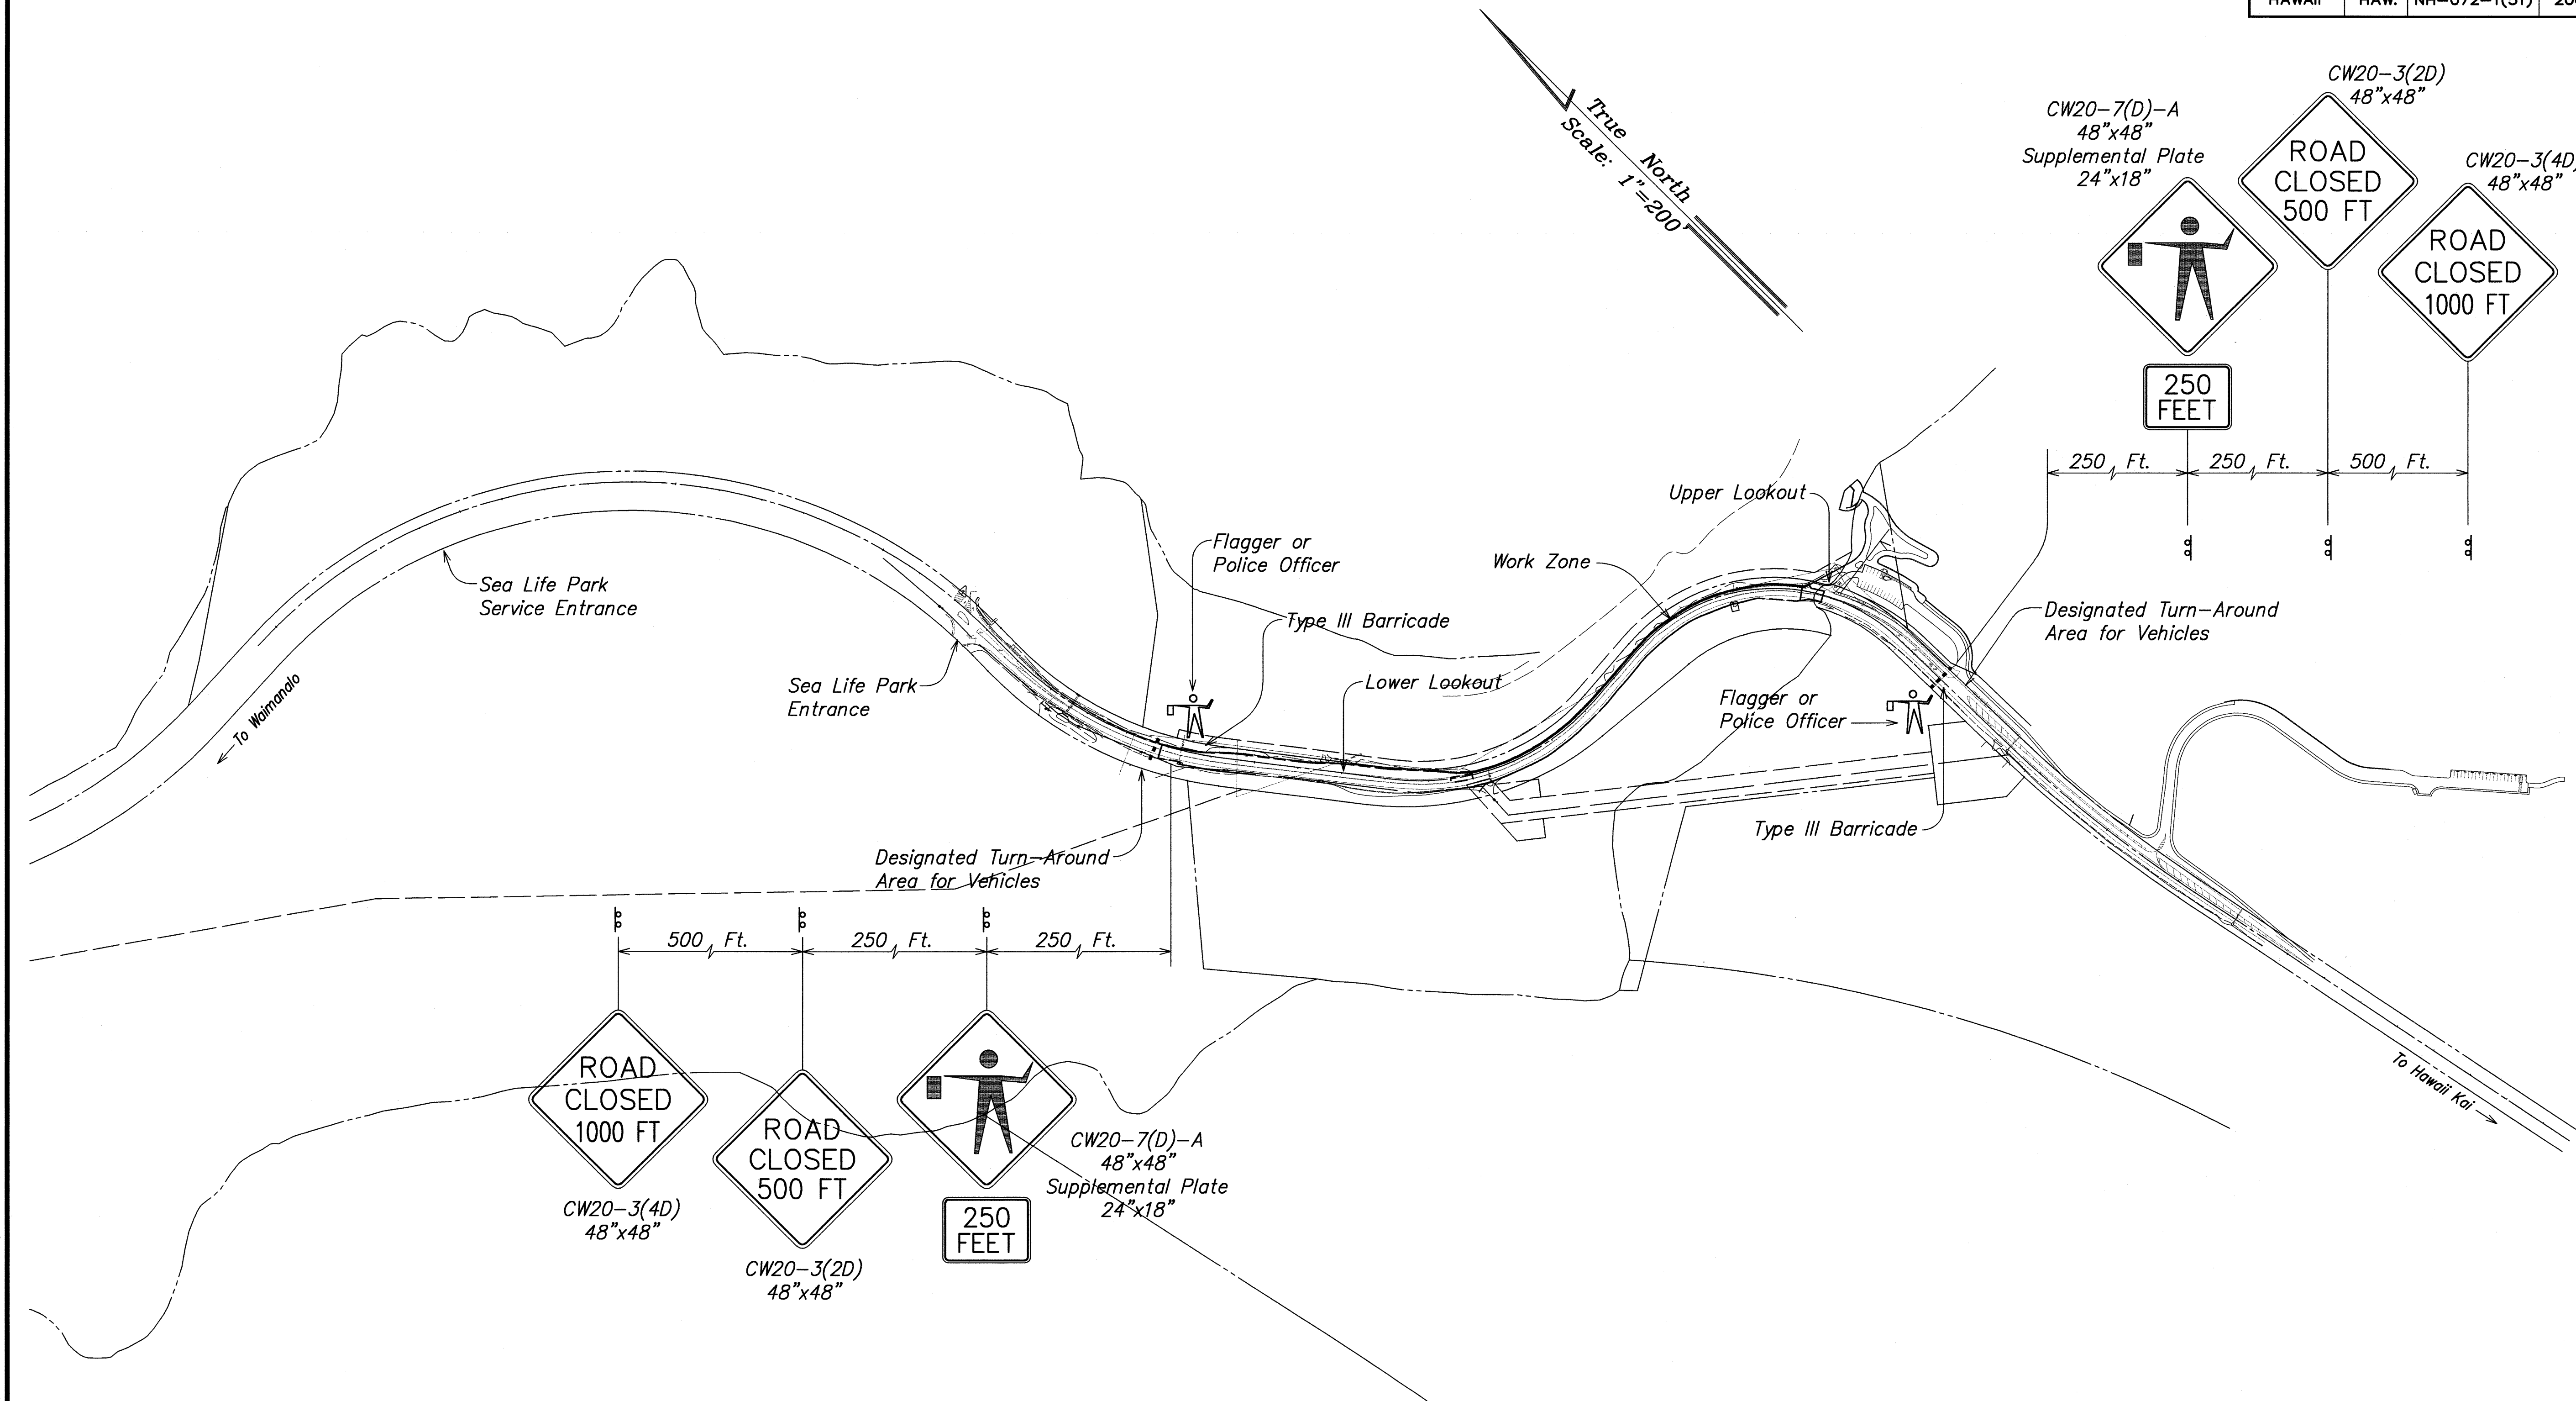

TRAFFIC CONTROL PLAN
TYPICAL TOTAL HIGHWAY CLOSURE
 SCALE: 1" = 200'

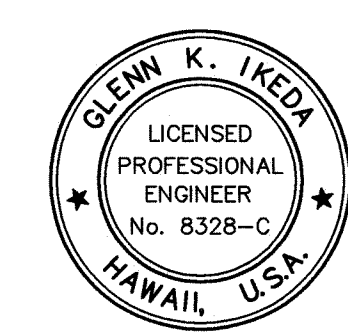

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STATE OF HAWAII
 DEPARTMENT OF TRANSPORTATION
 HIGHWAYS DIVISION

TRAFFIC CONTROL PLAN
TYPICAL TOTAL HIGHWAY CLOSURE

Kalaniana'ole Highway Improvements
Retaining Wall at Makapuu, Oahu
Federal-Aid Project No. NH-072-1(51)


Scale: As Noted Date: APR. 2007

SHEET No. 5 OF 8 SHEETS

ORIGINAL PLAN	SURVEY PLOTTED BY	DATE
NOTE BOOK	DRAWN BY	
	DESIGNED BY	
	CHECKED BY	

LIE2: STATE\DOT\KALANIANA'OLE\RETAINING WALL\CAADD\ KALRW-73-TOPCLOSE.dwg 4/16/07

FED. ROAD DIST. NO.	STATE	FED. AID PROJ. NO.	FISCAL YEAR	SHEET NO.	TOTAL SHEETS
HAWAII	HAW.	NH-072-1(51)	2007	74	108

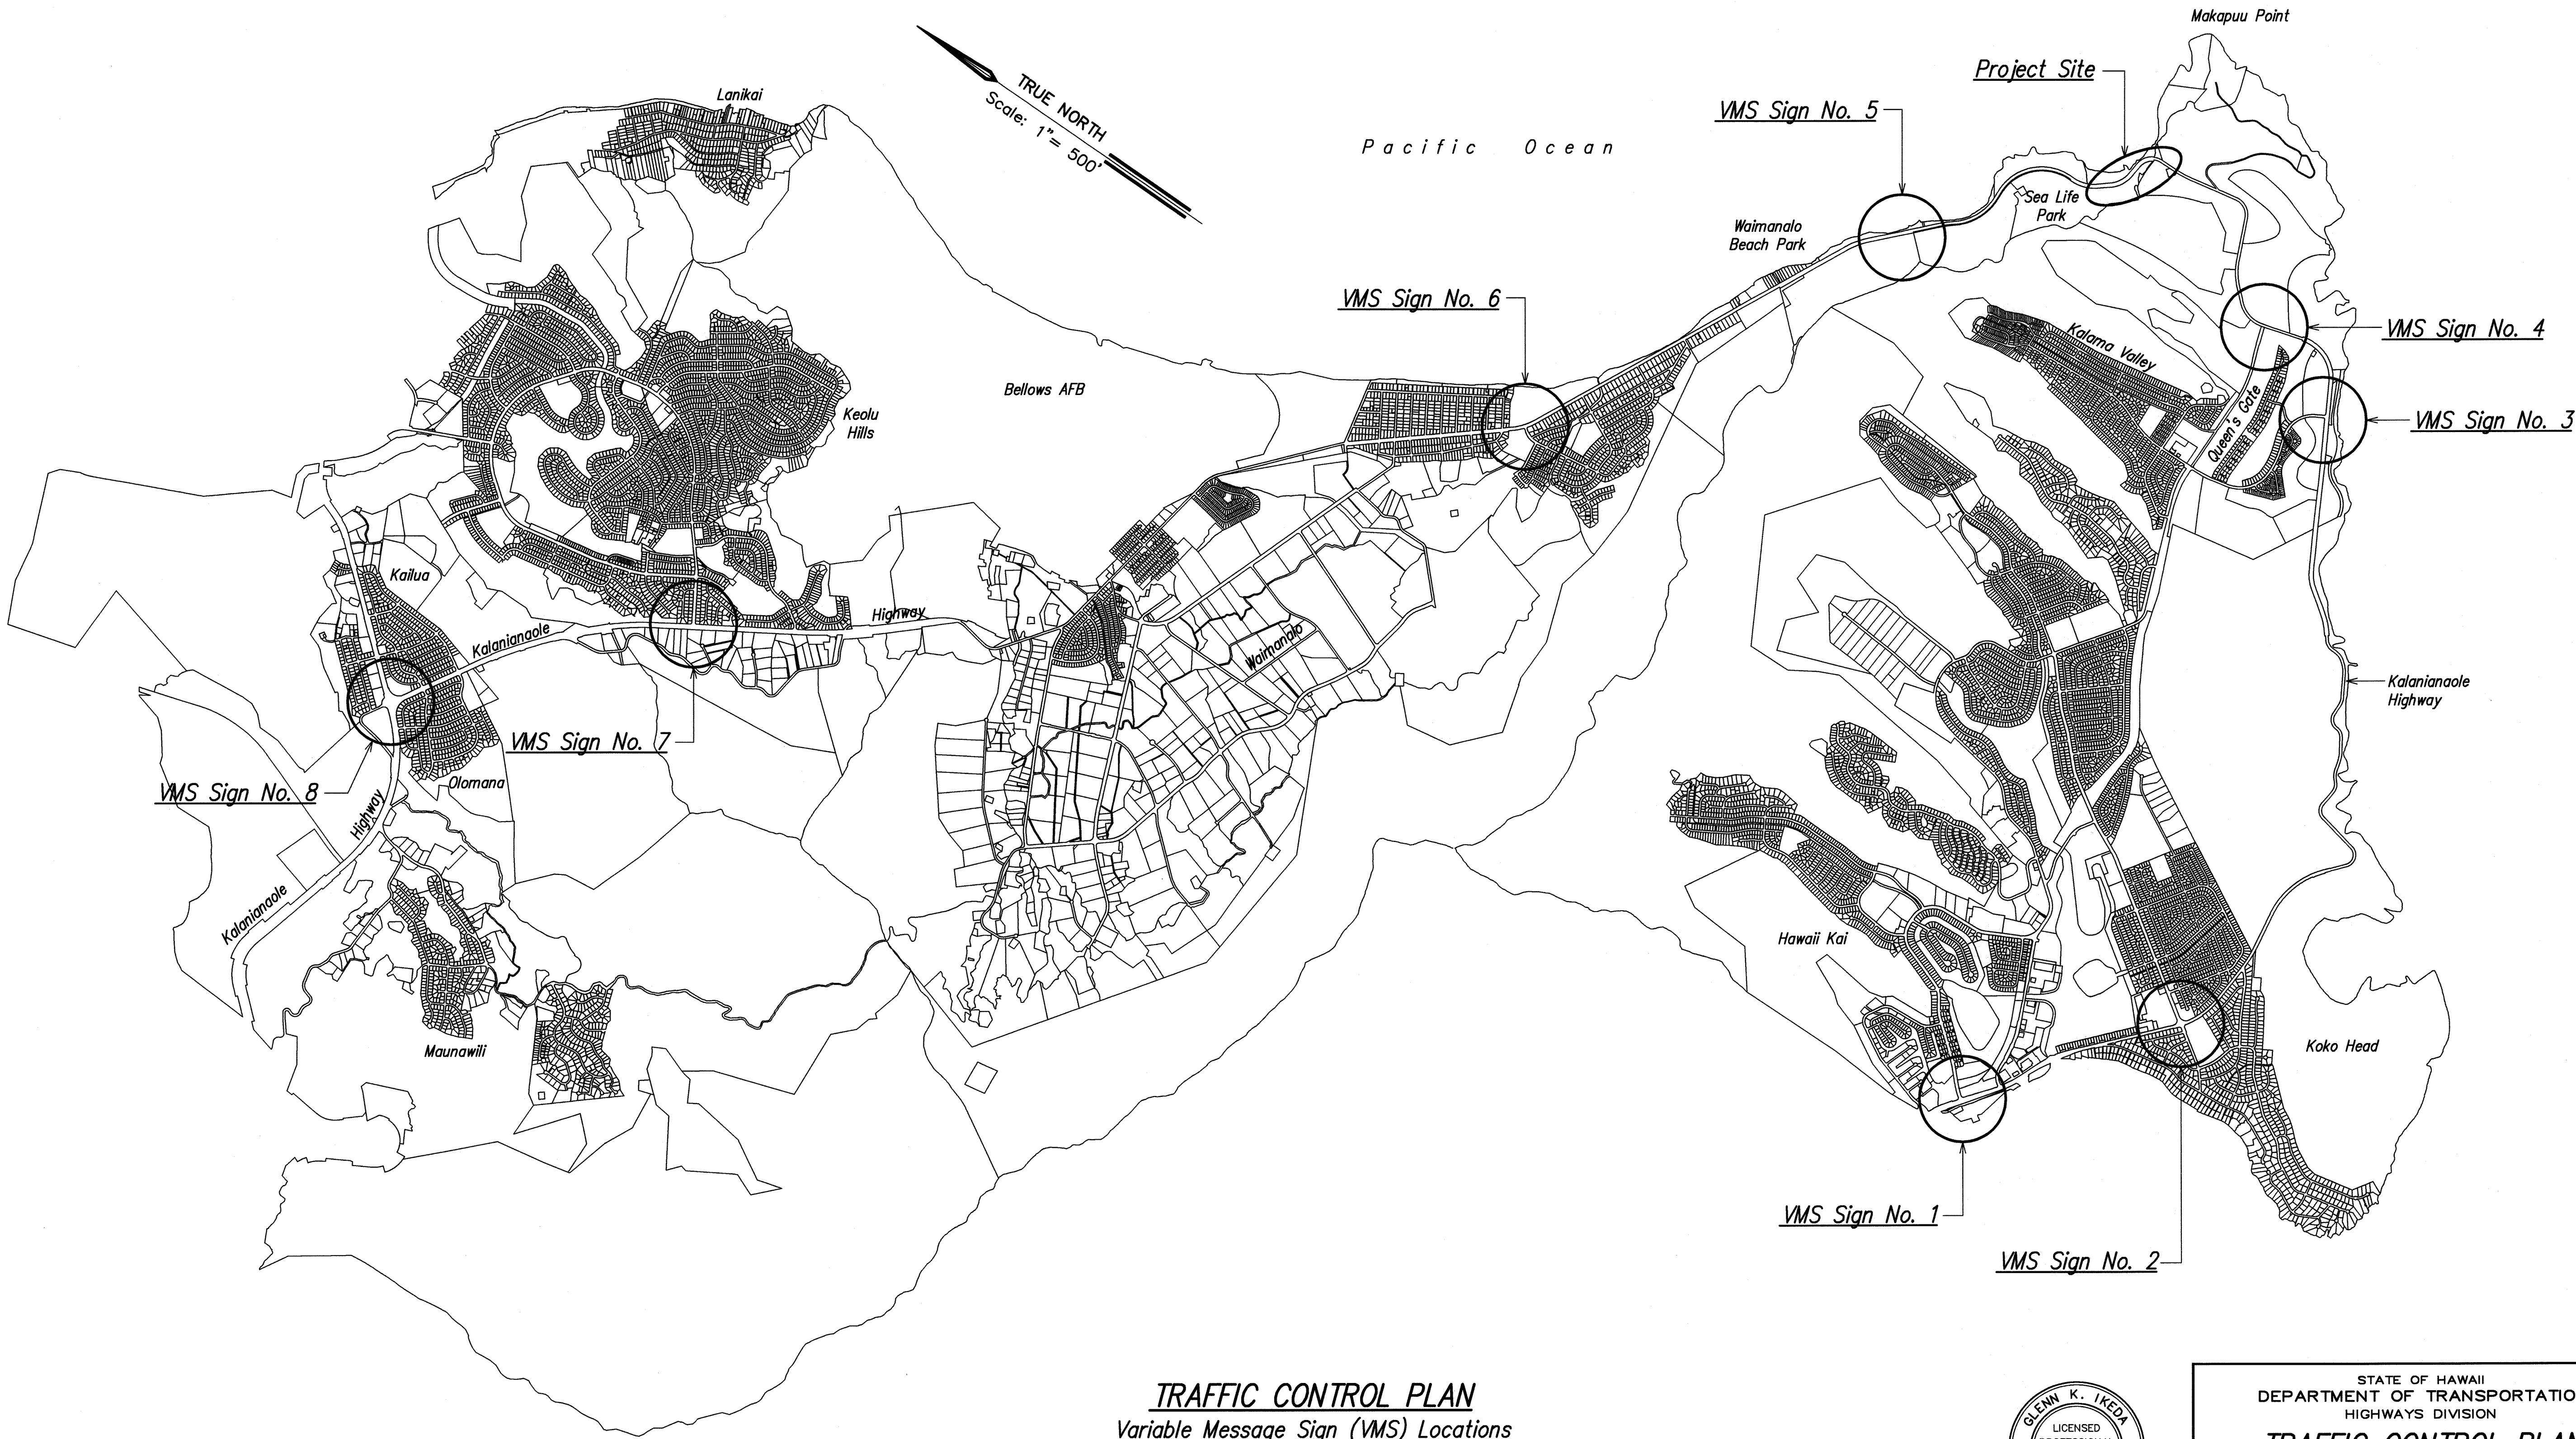

TRAFFIC CONTROL PLAN
Variable Message Sign (VMS) Locations
 Scale: 1" = 500'



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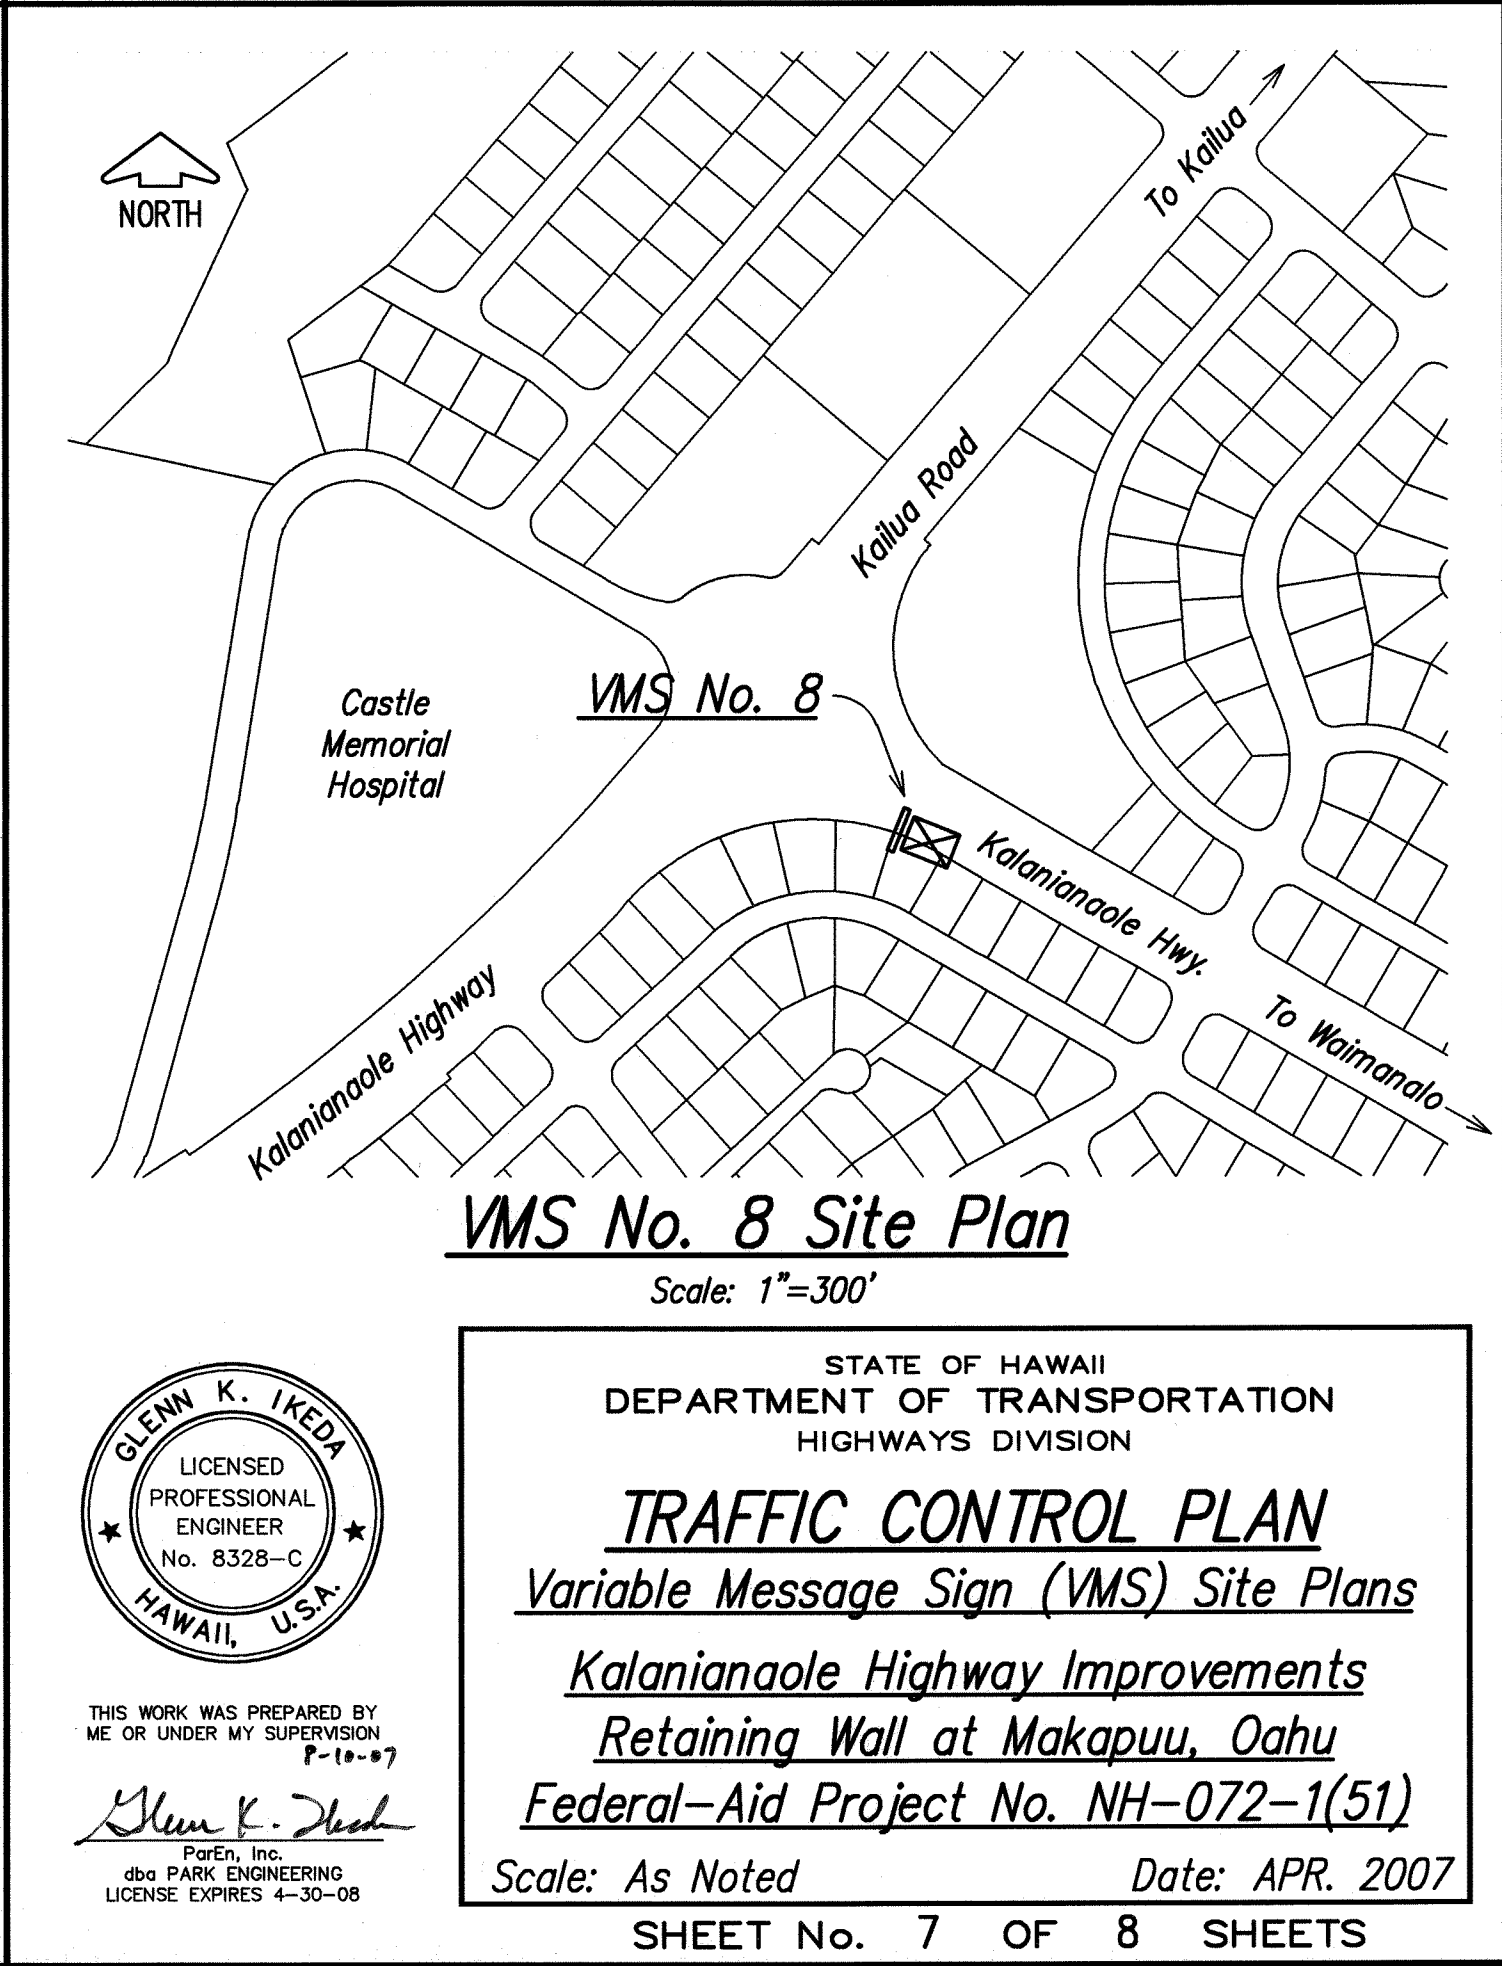
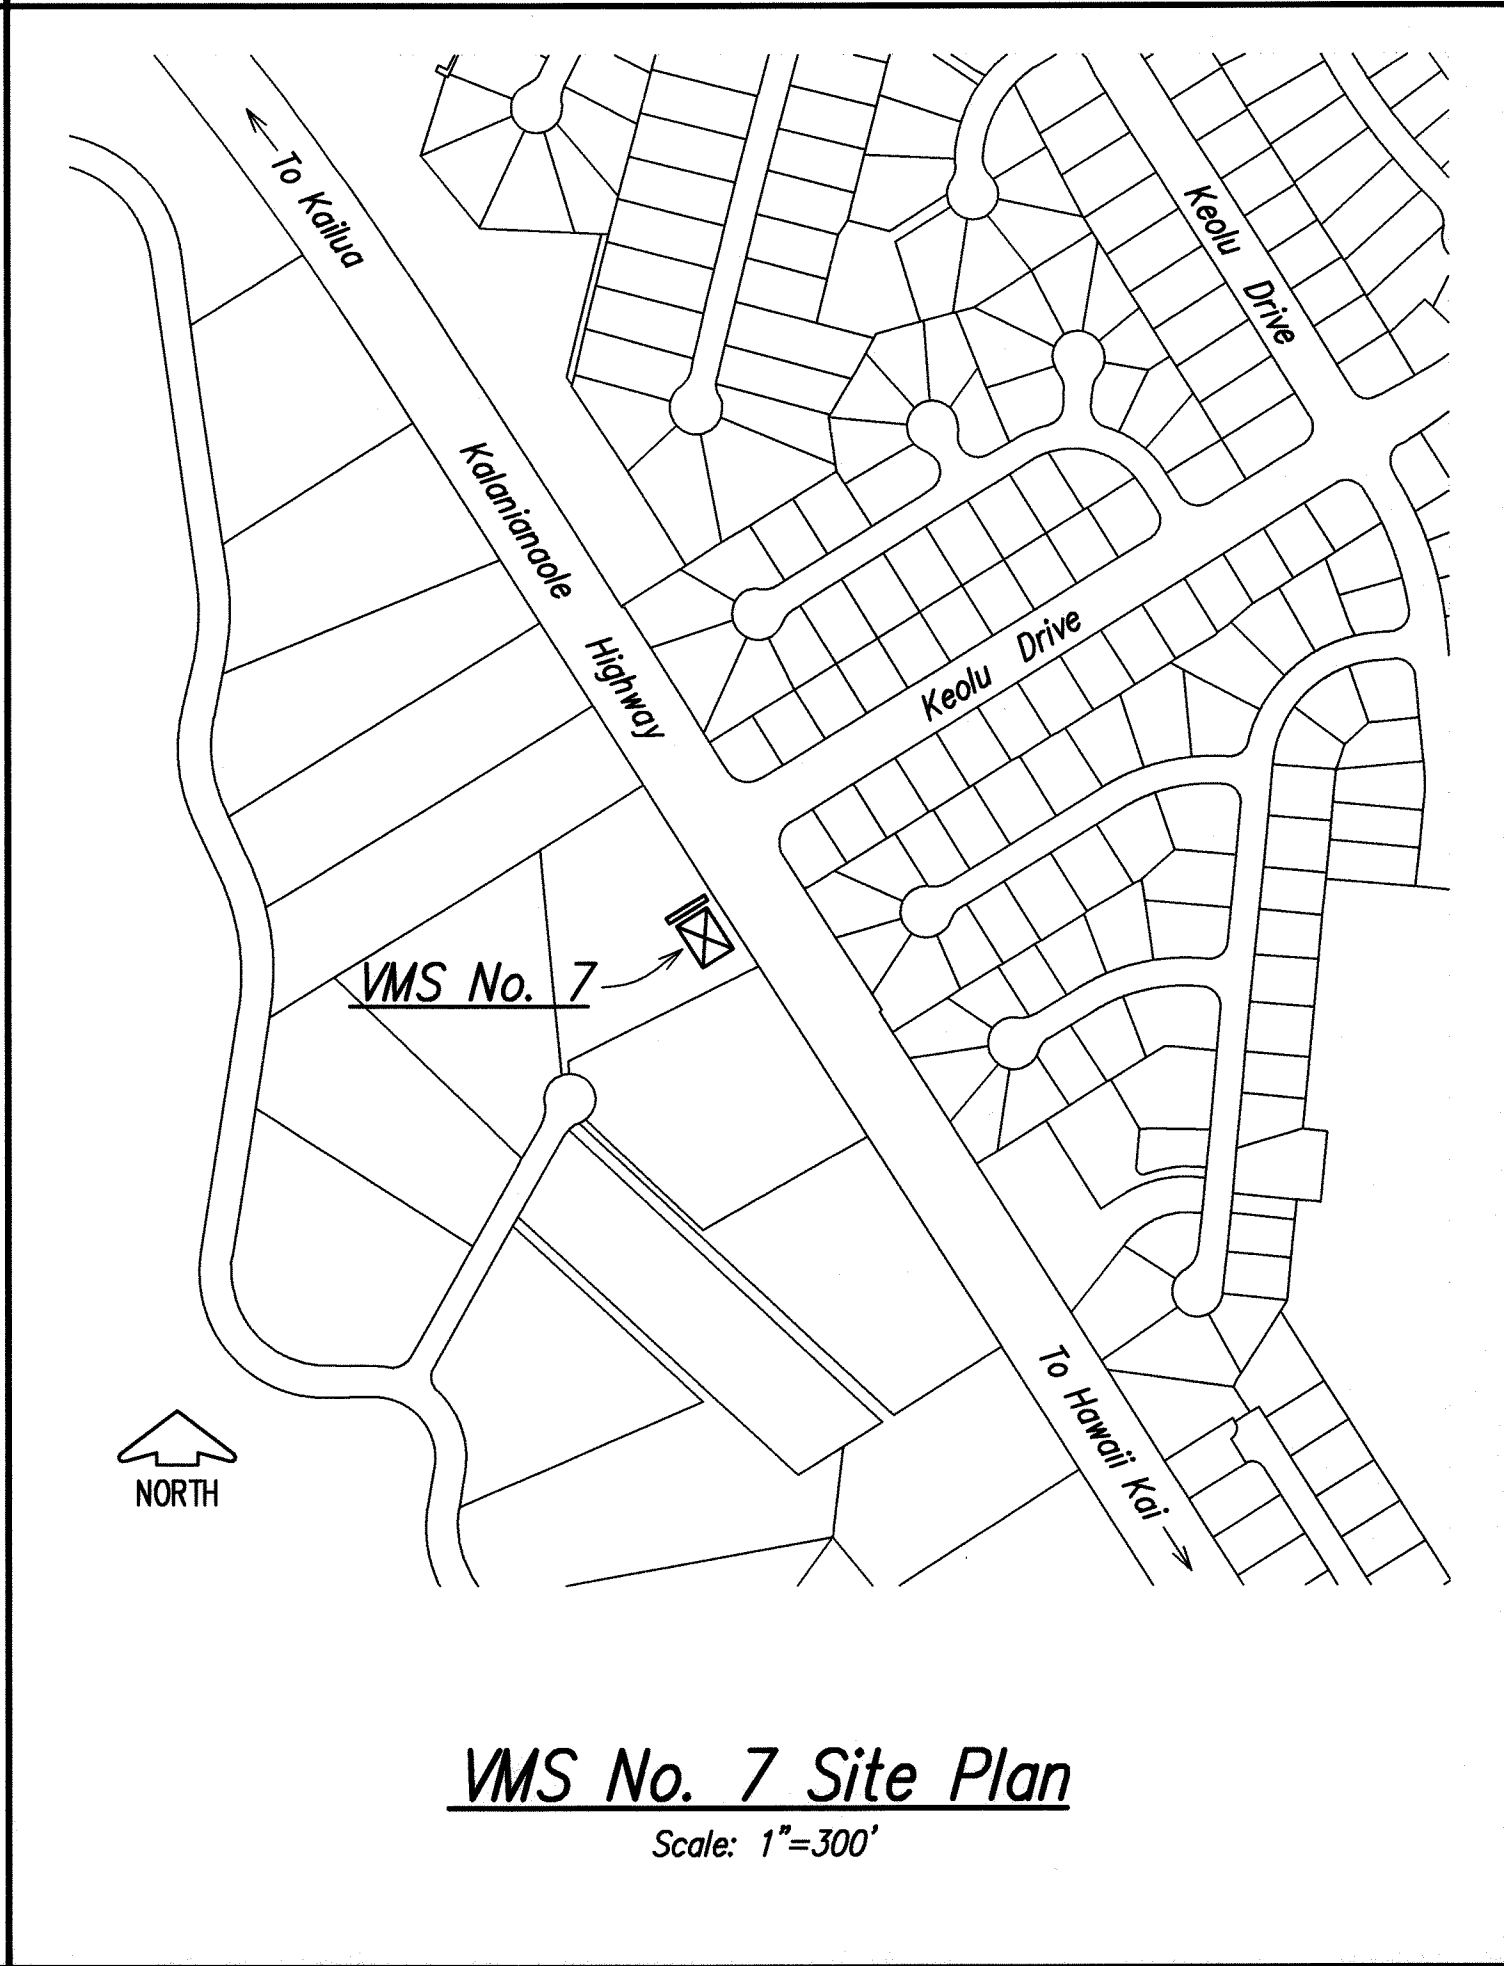
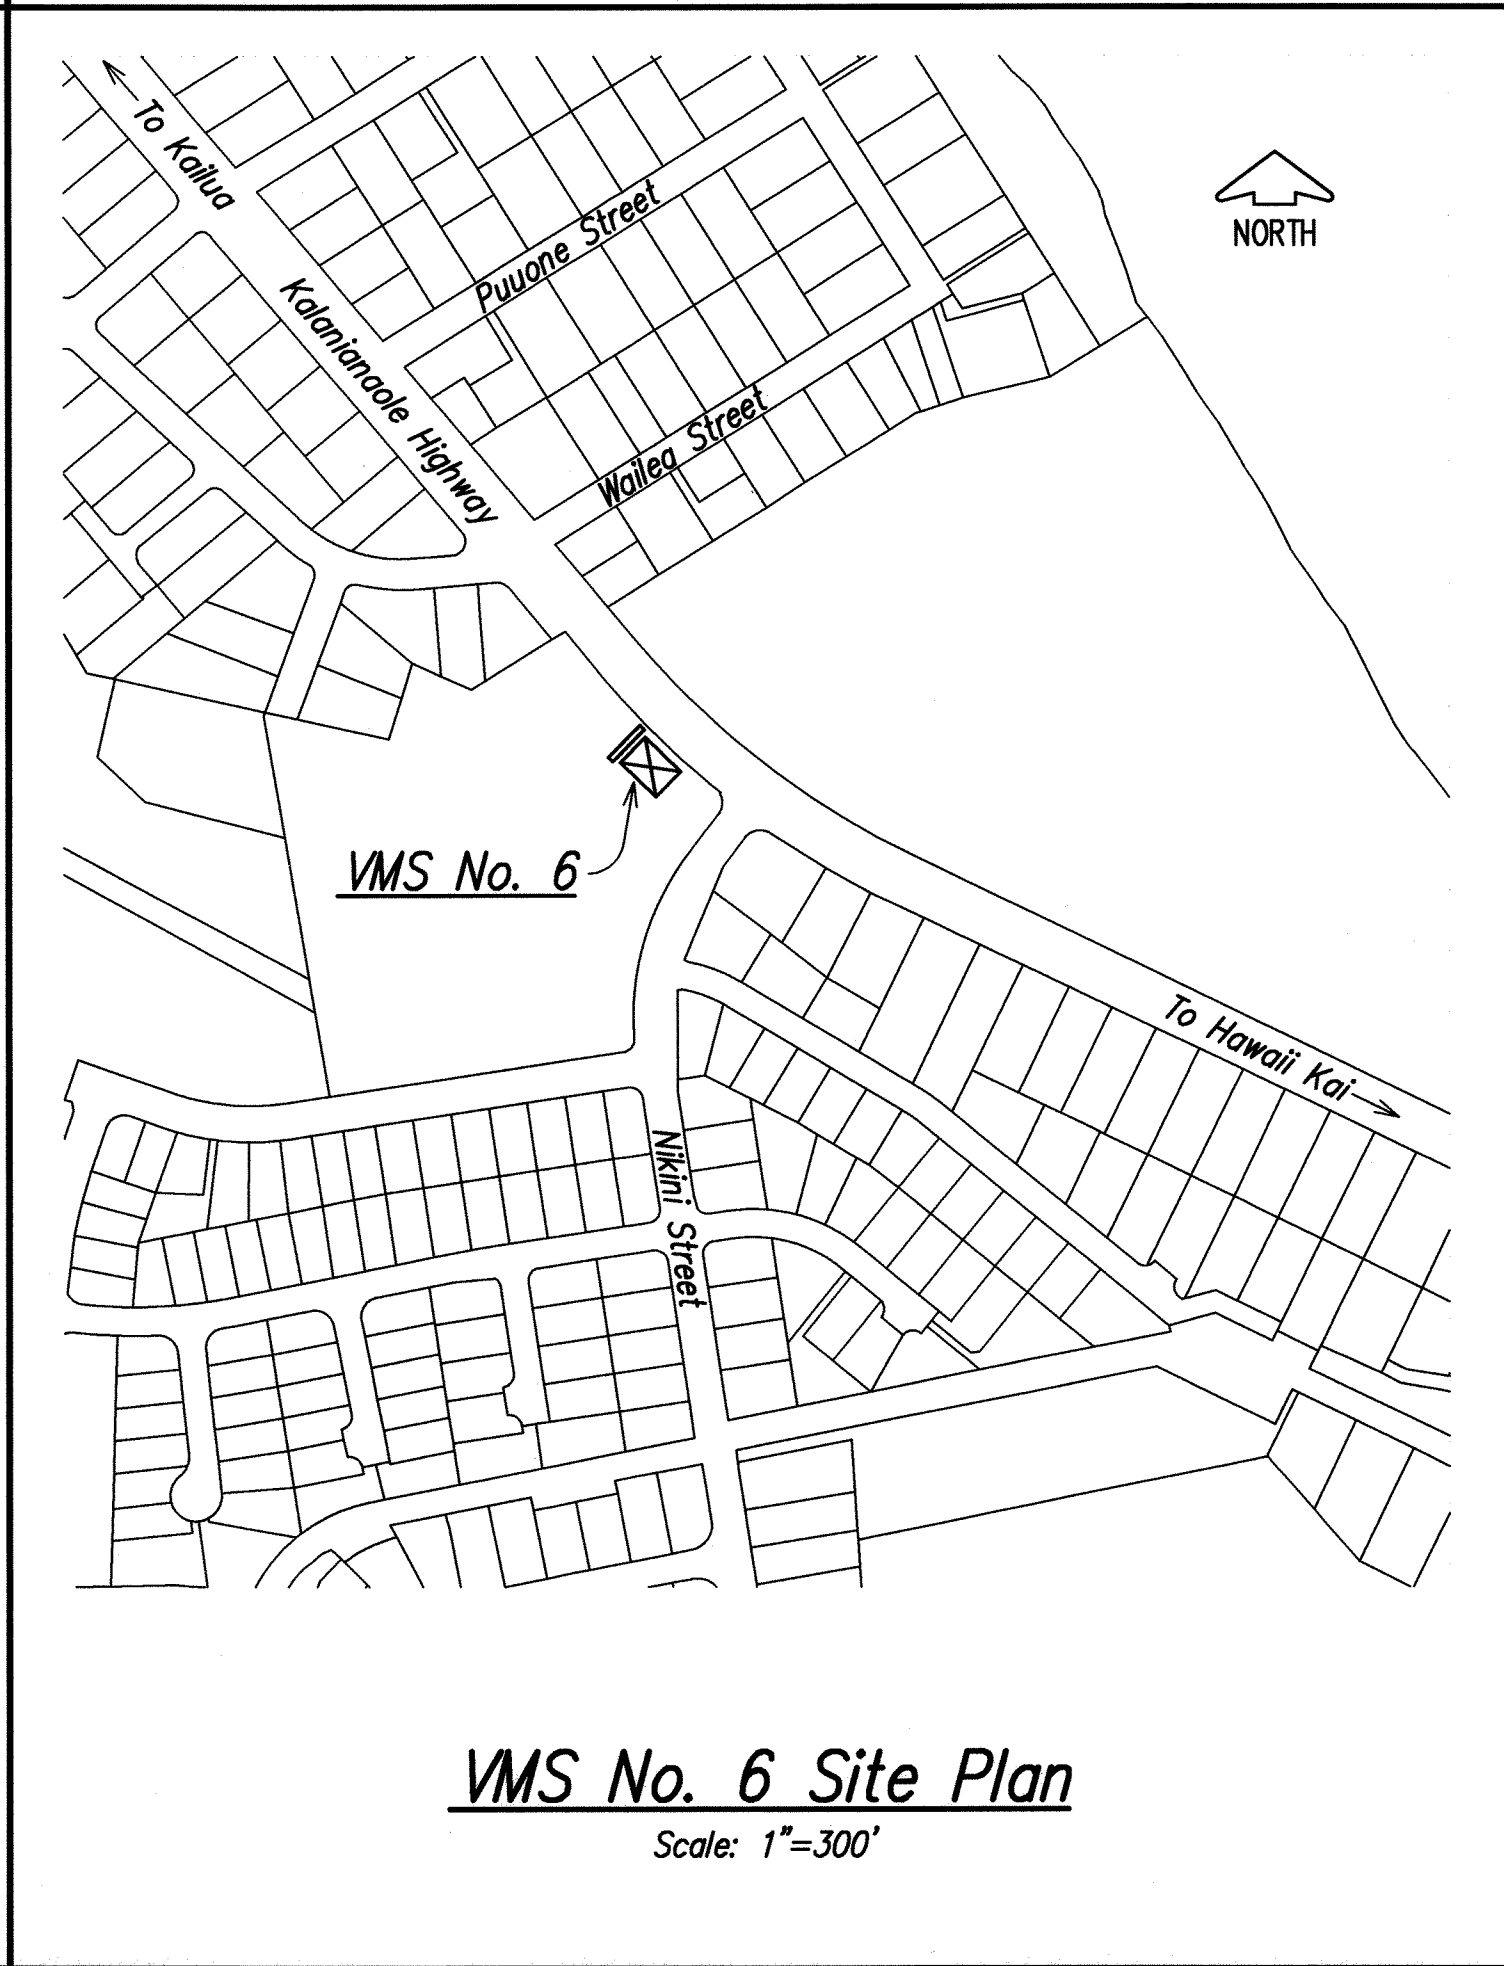
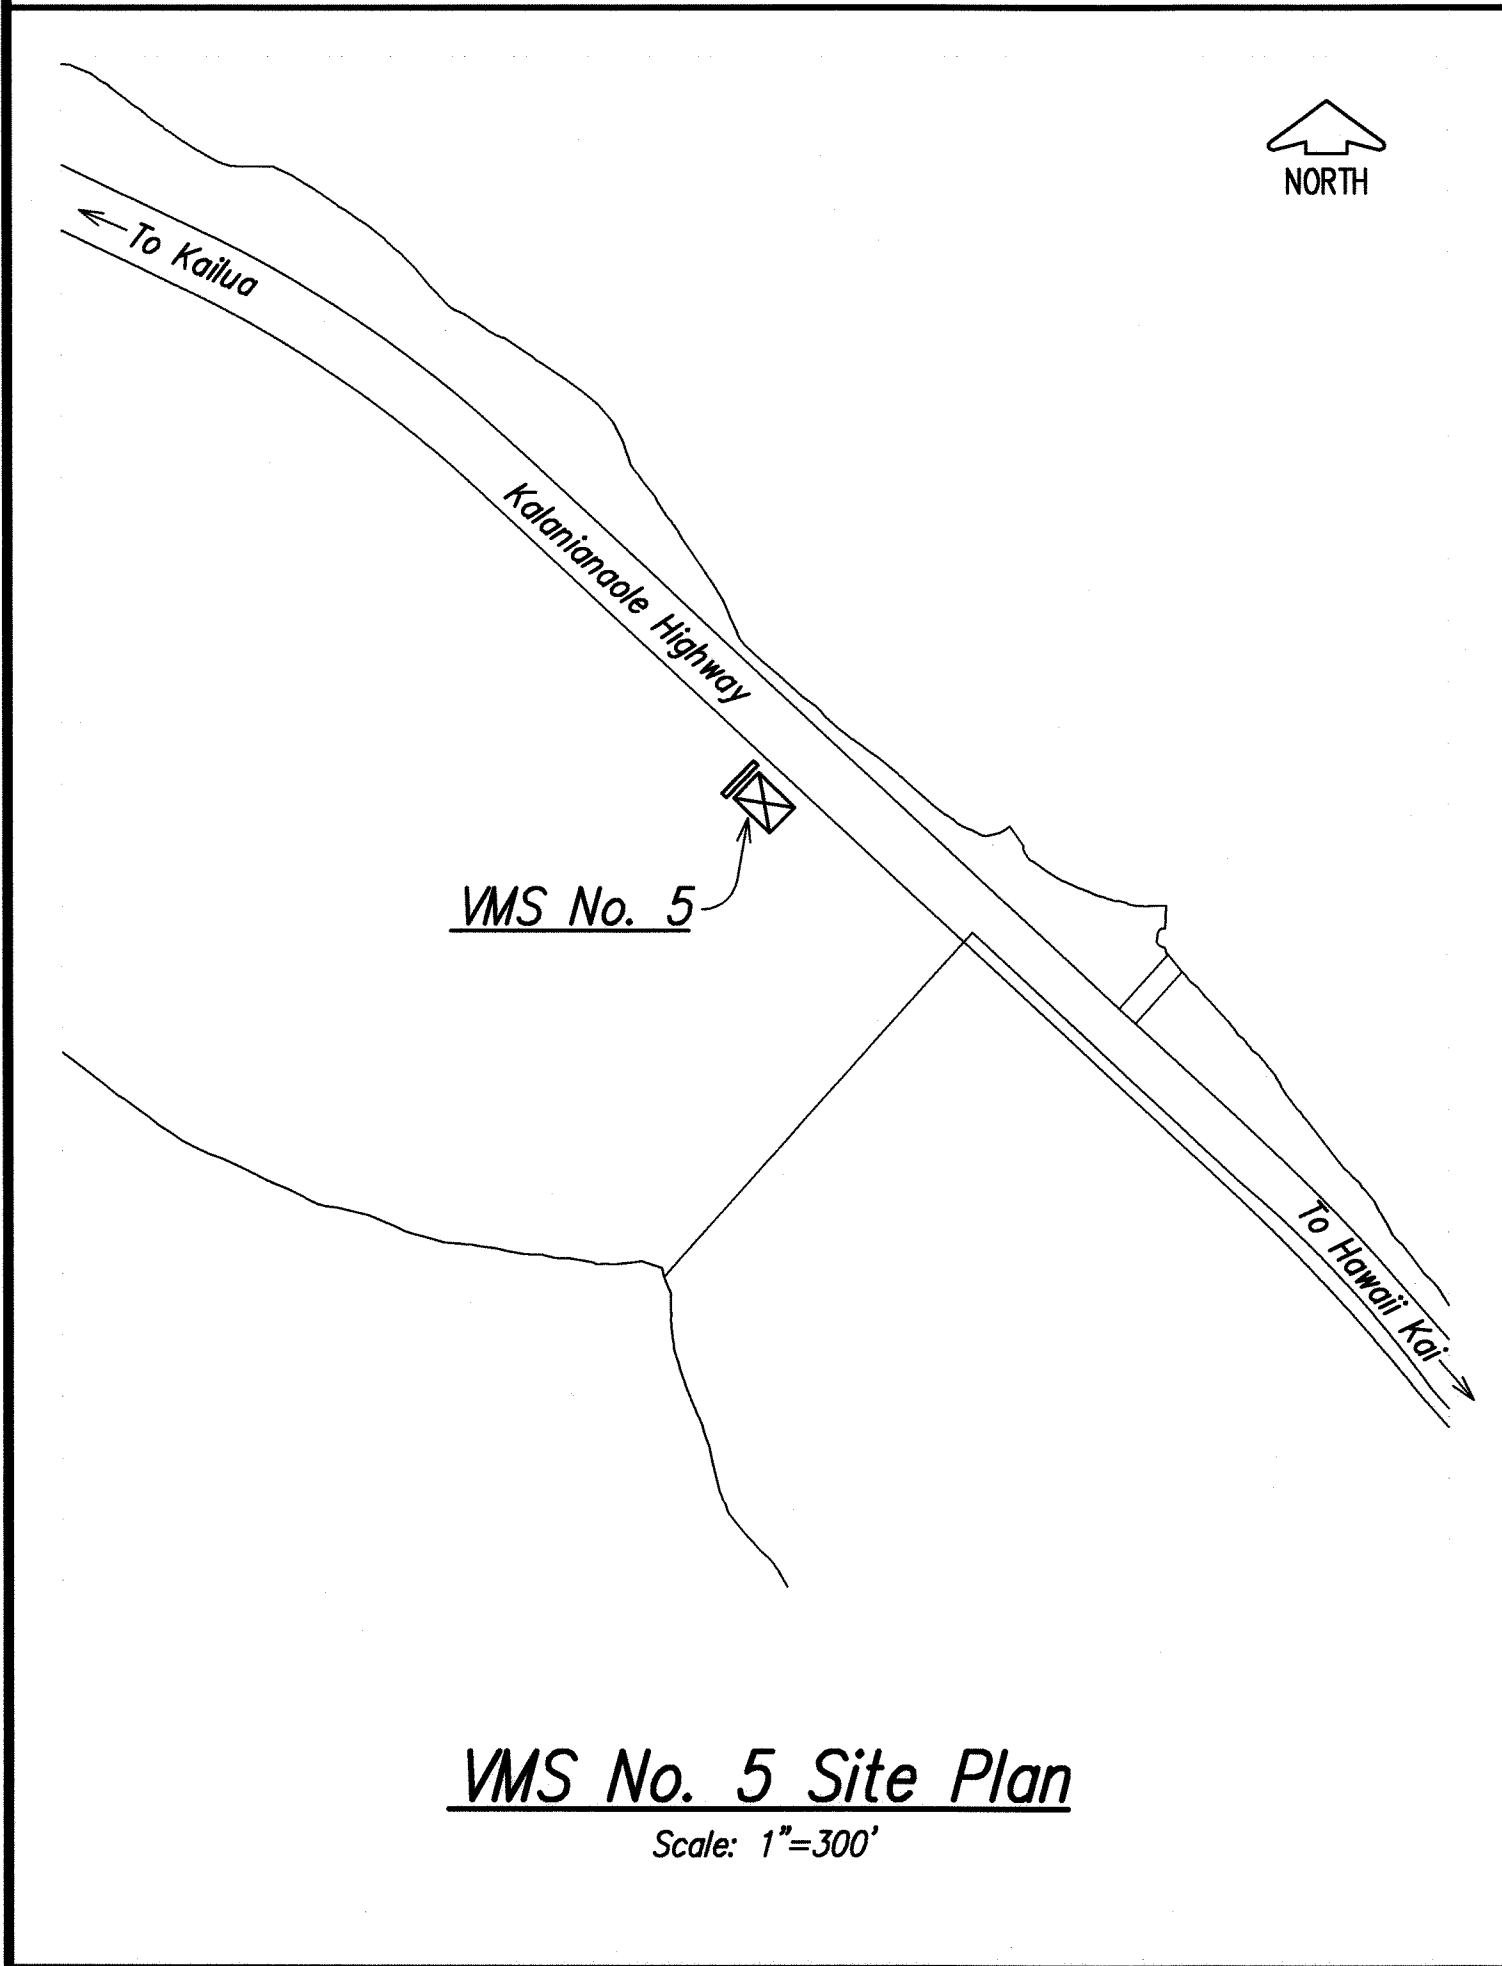
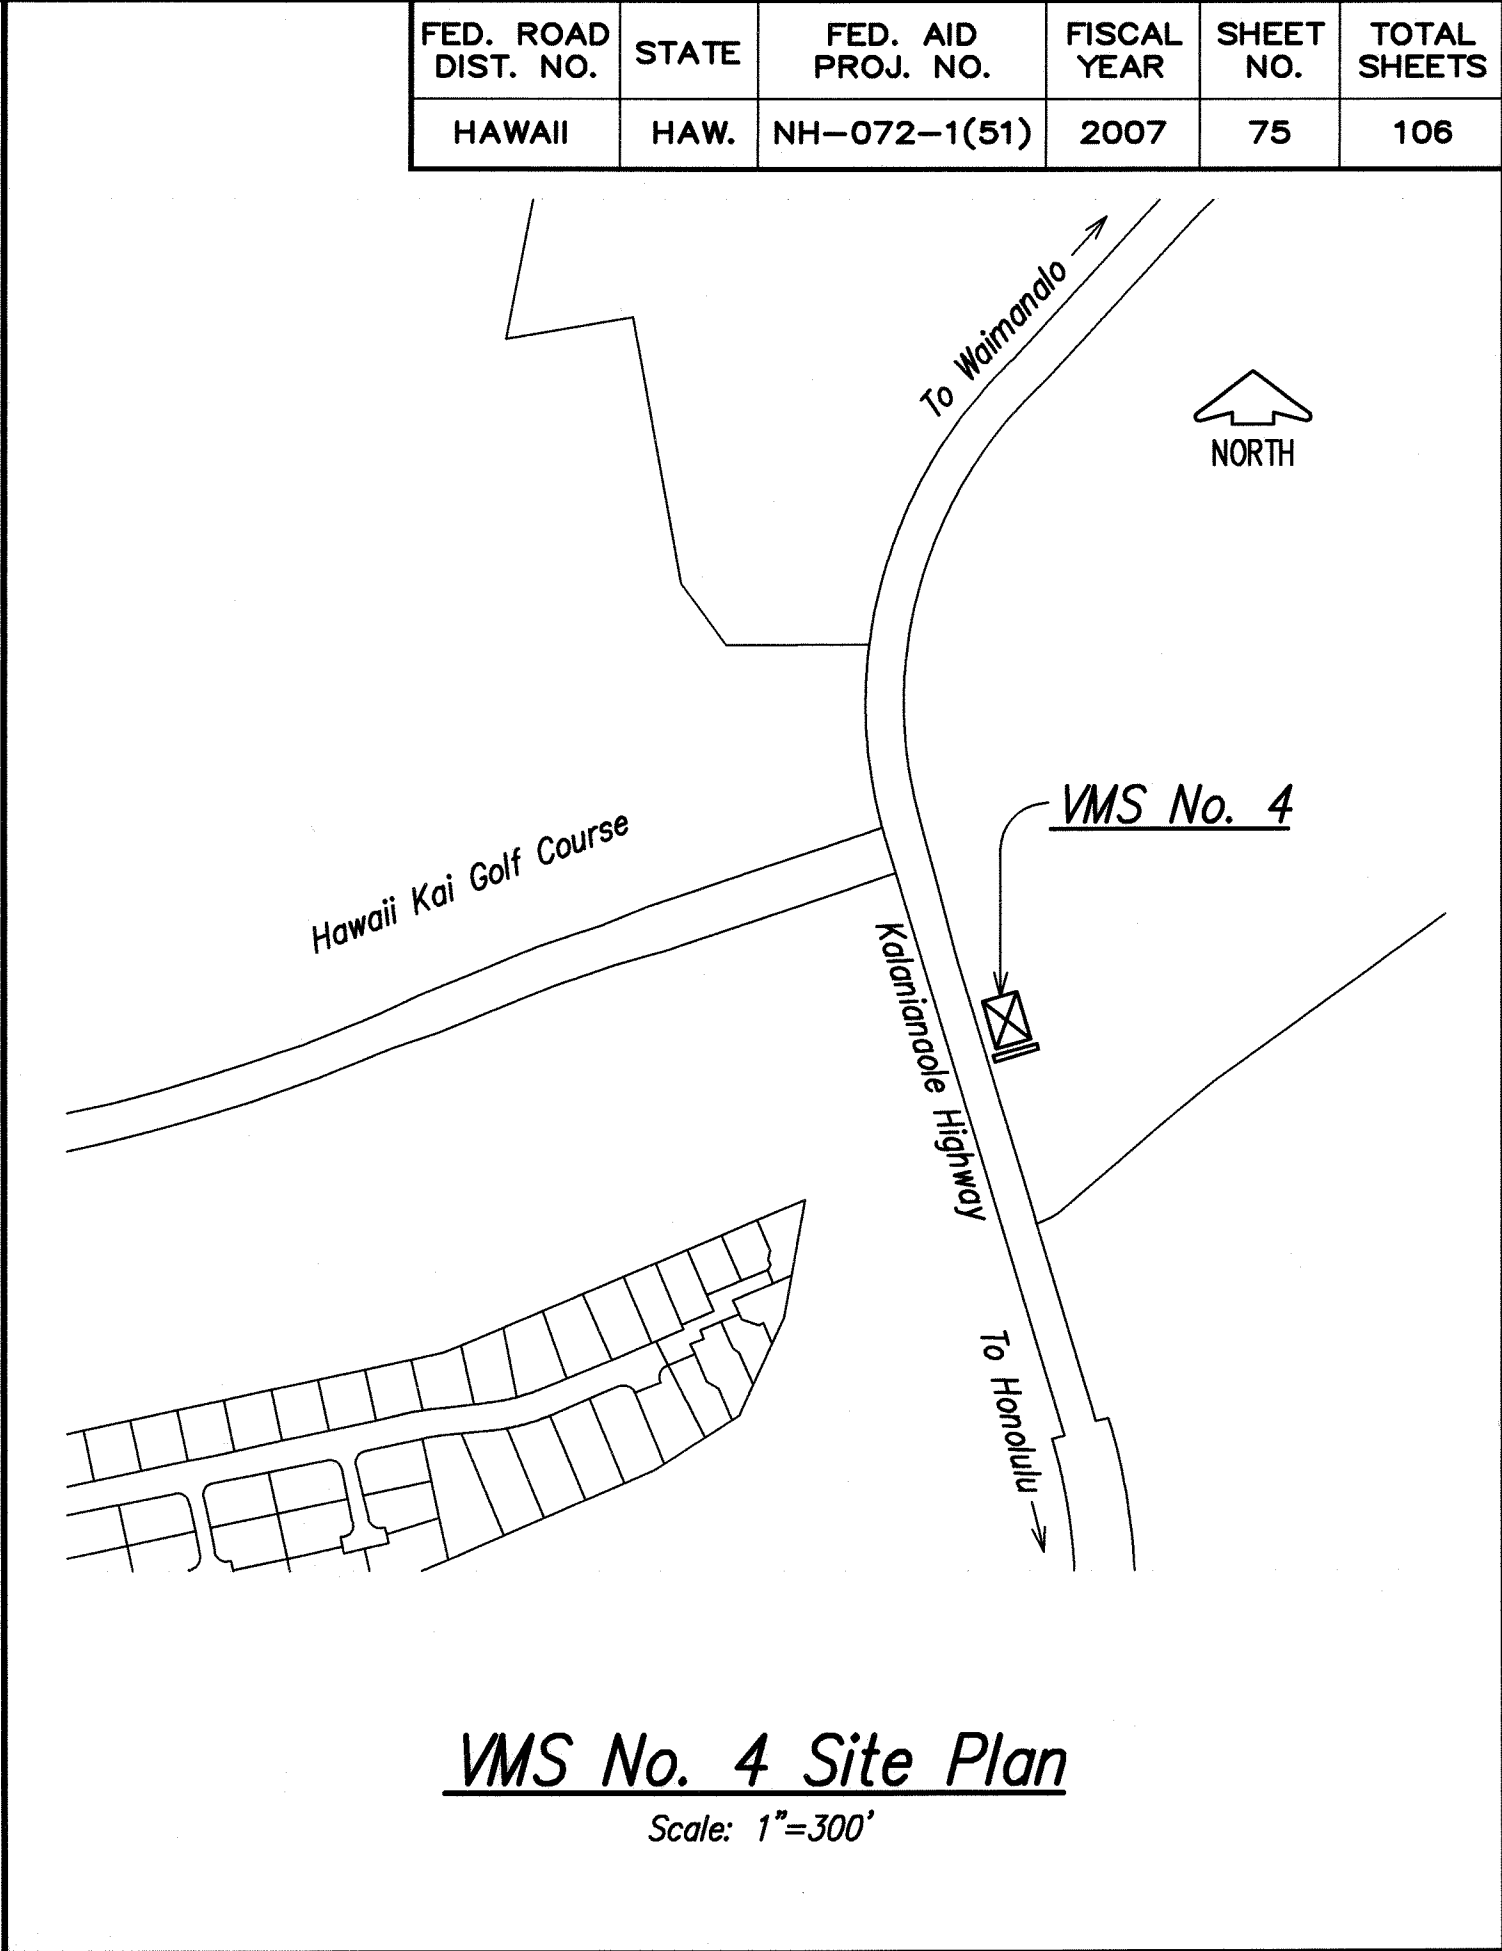
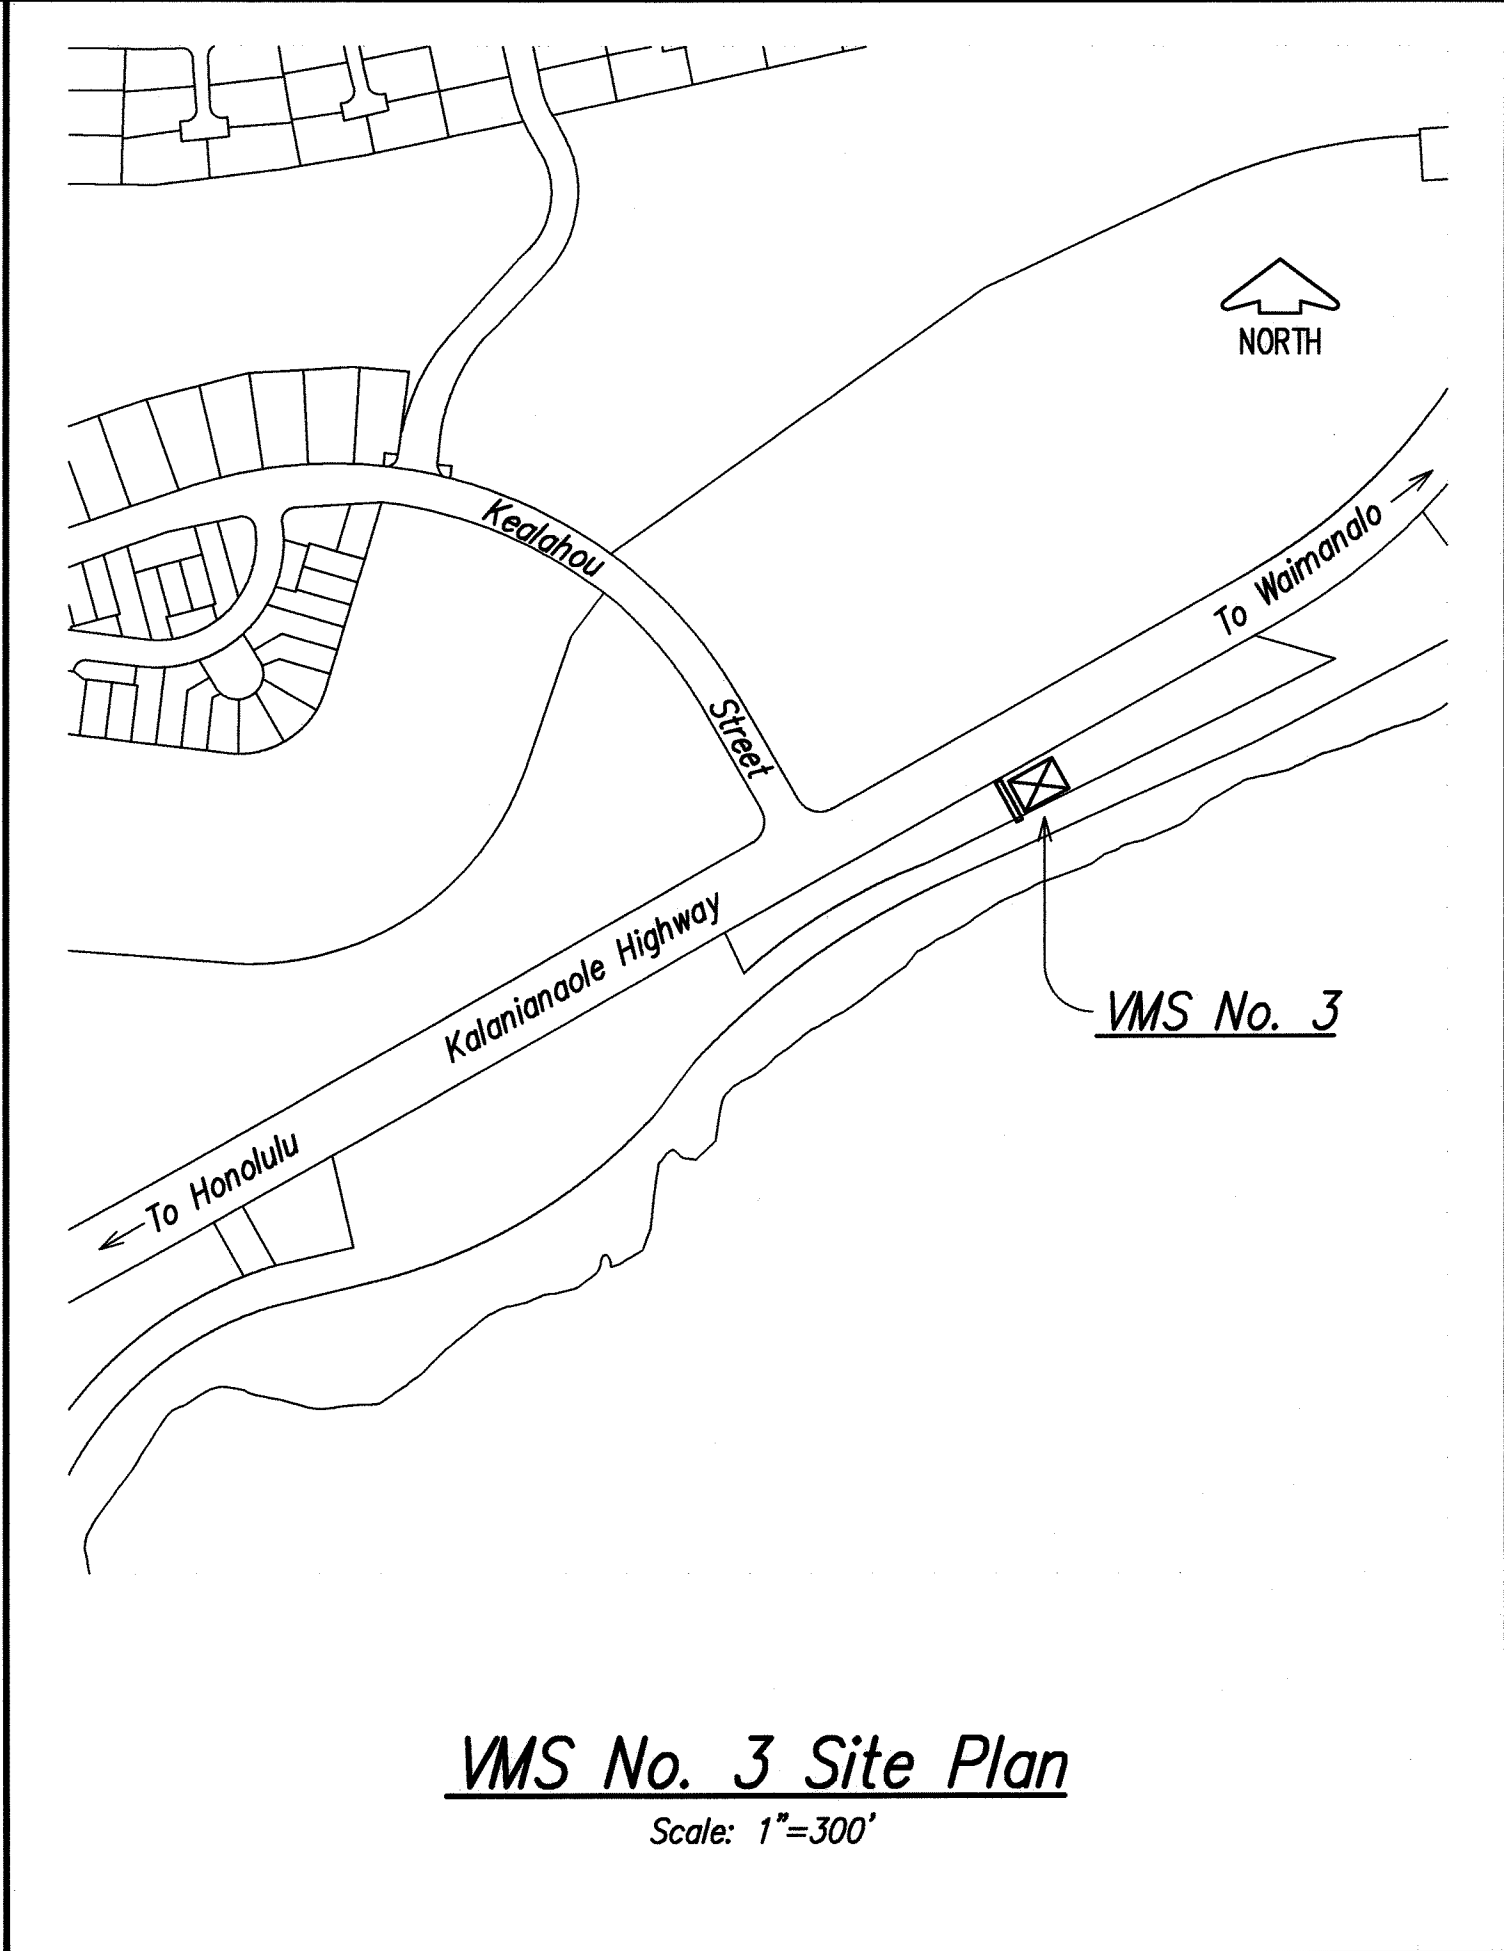
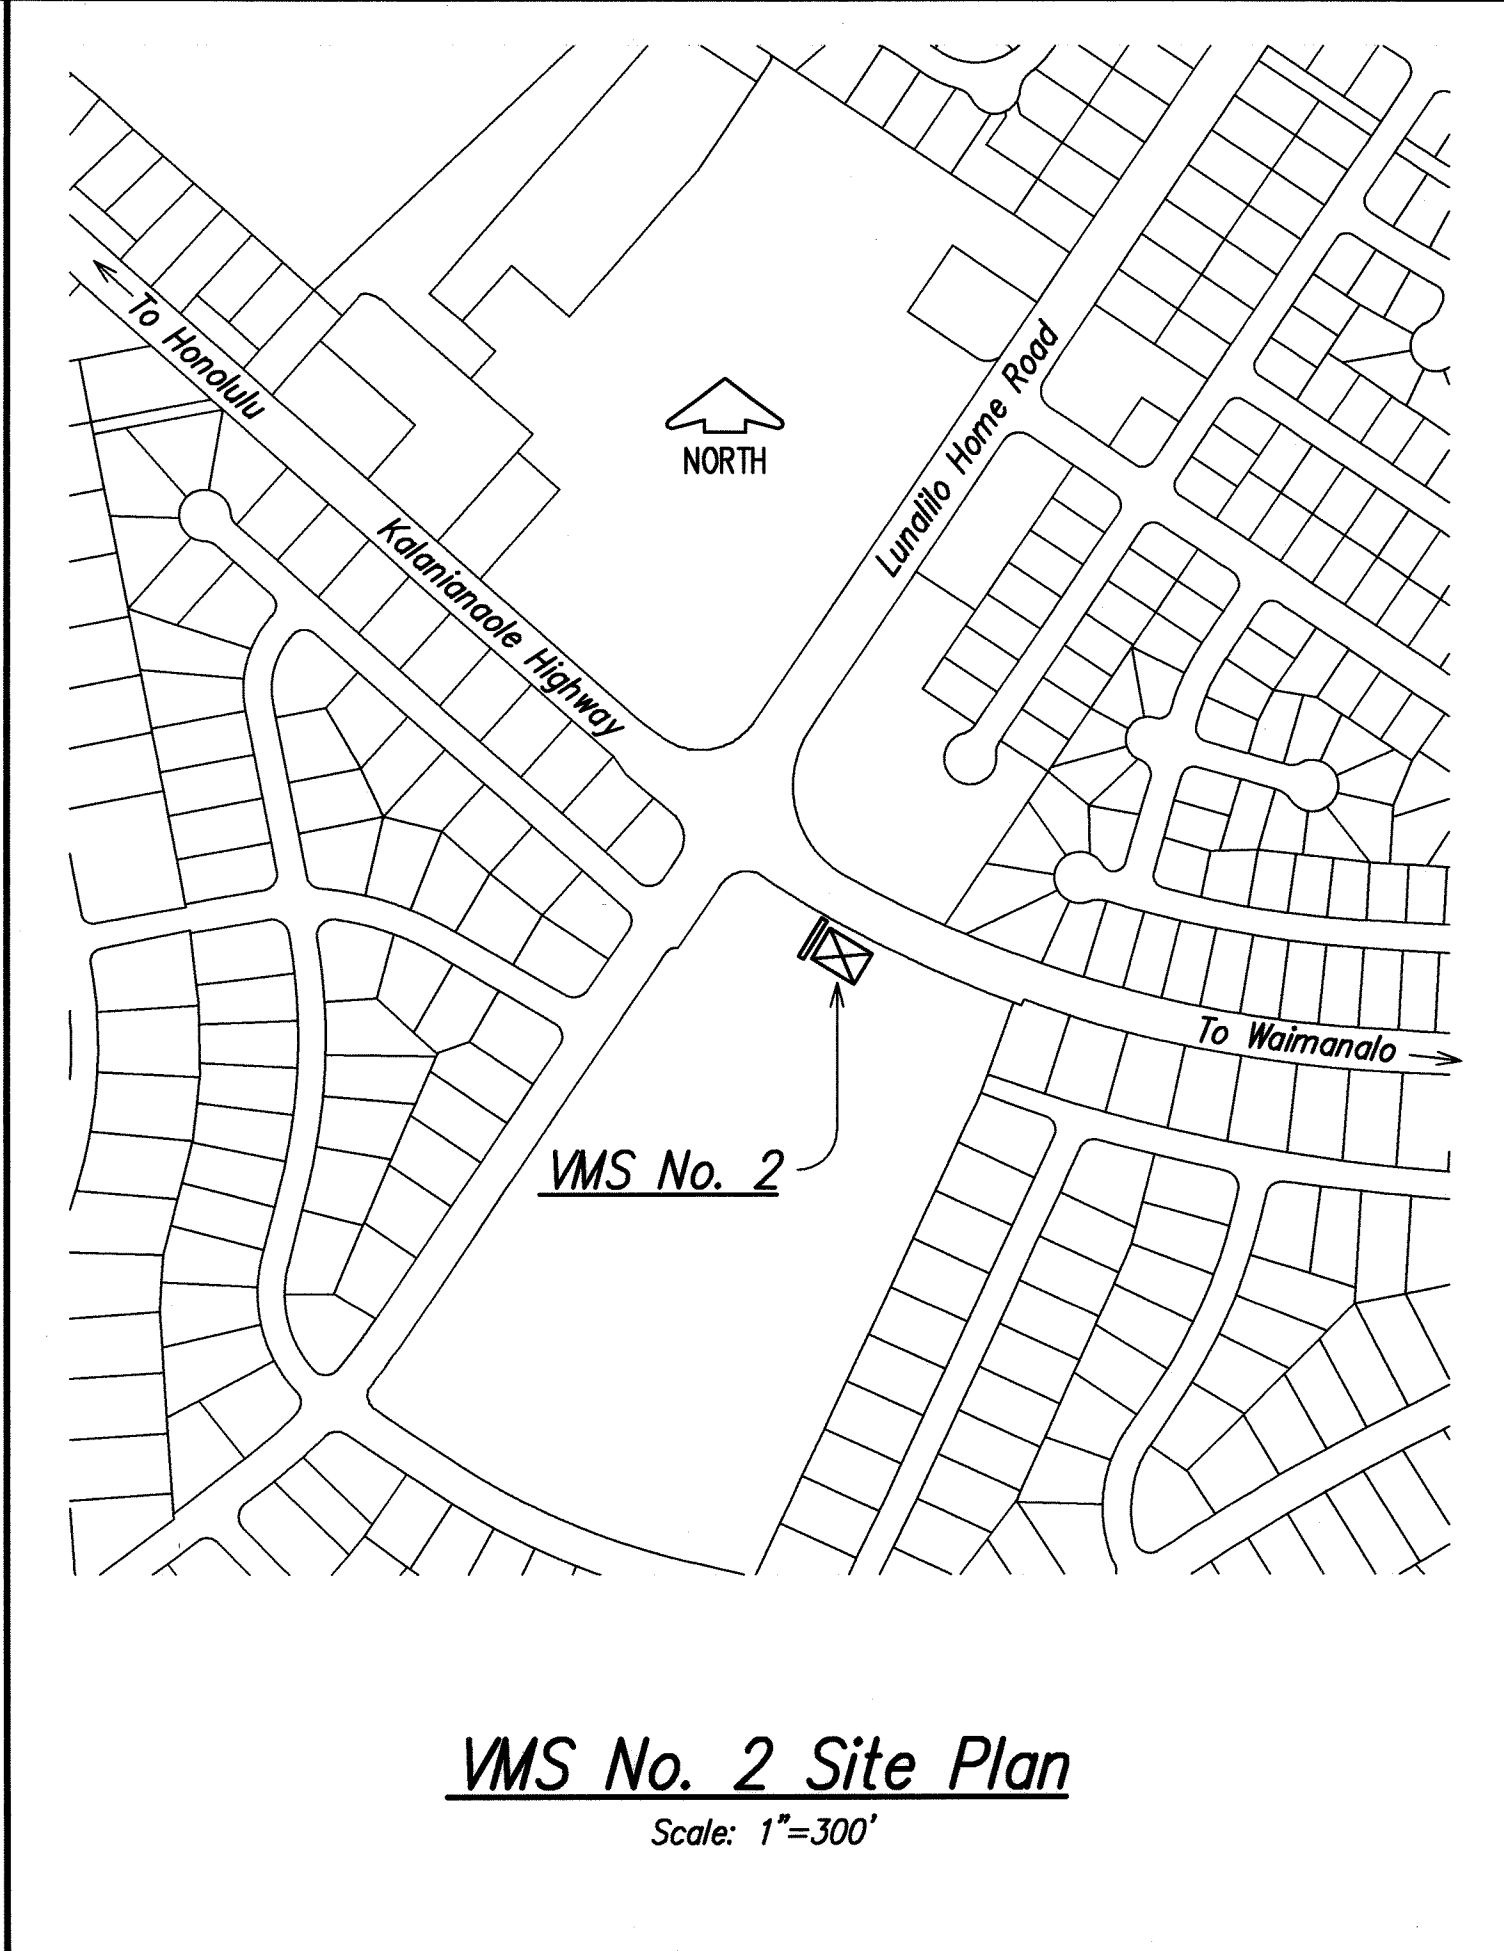
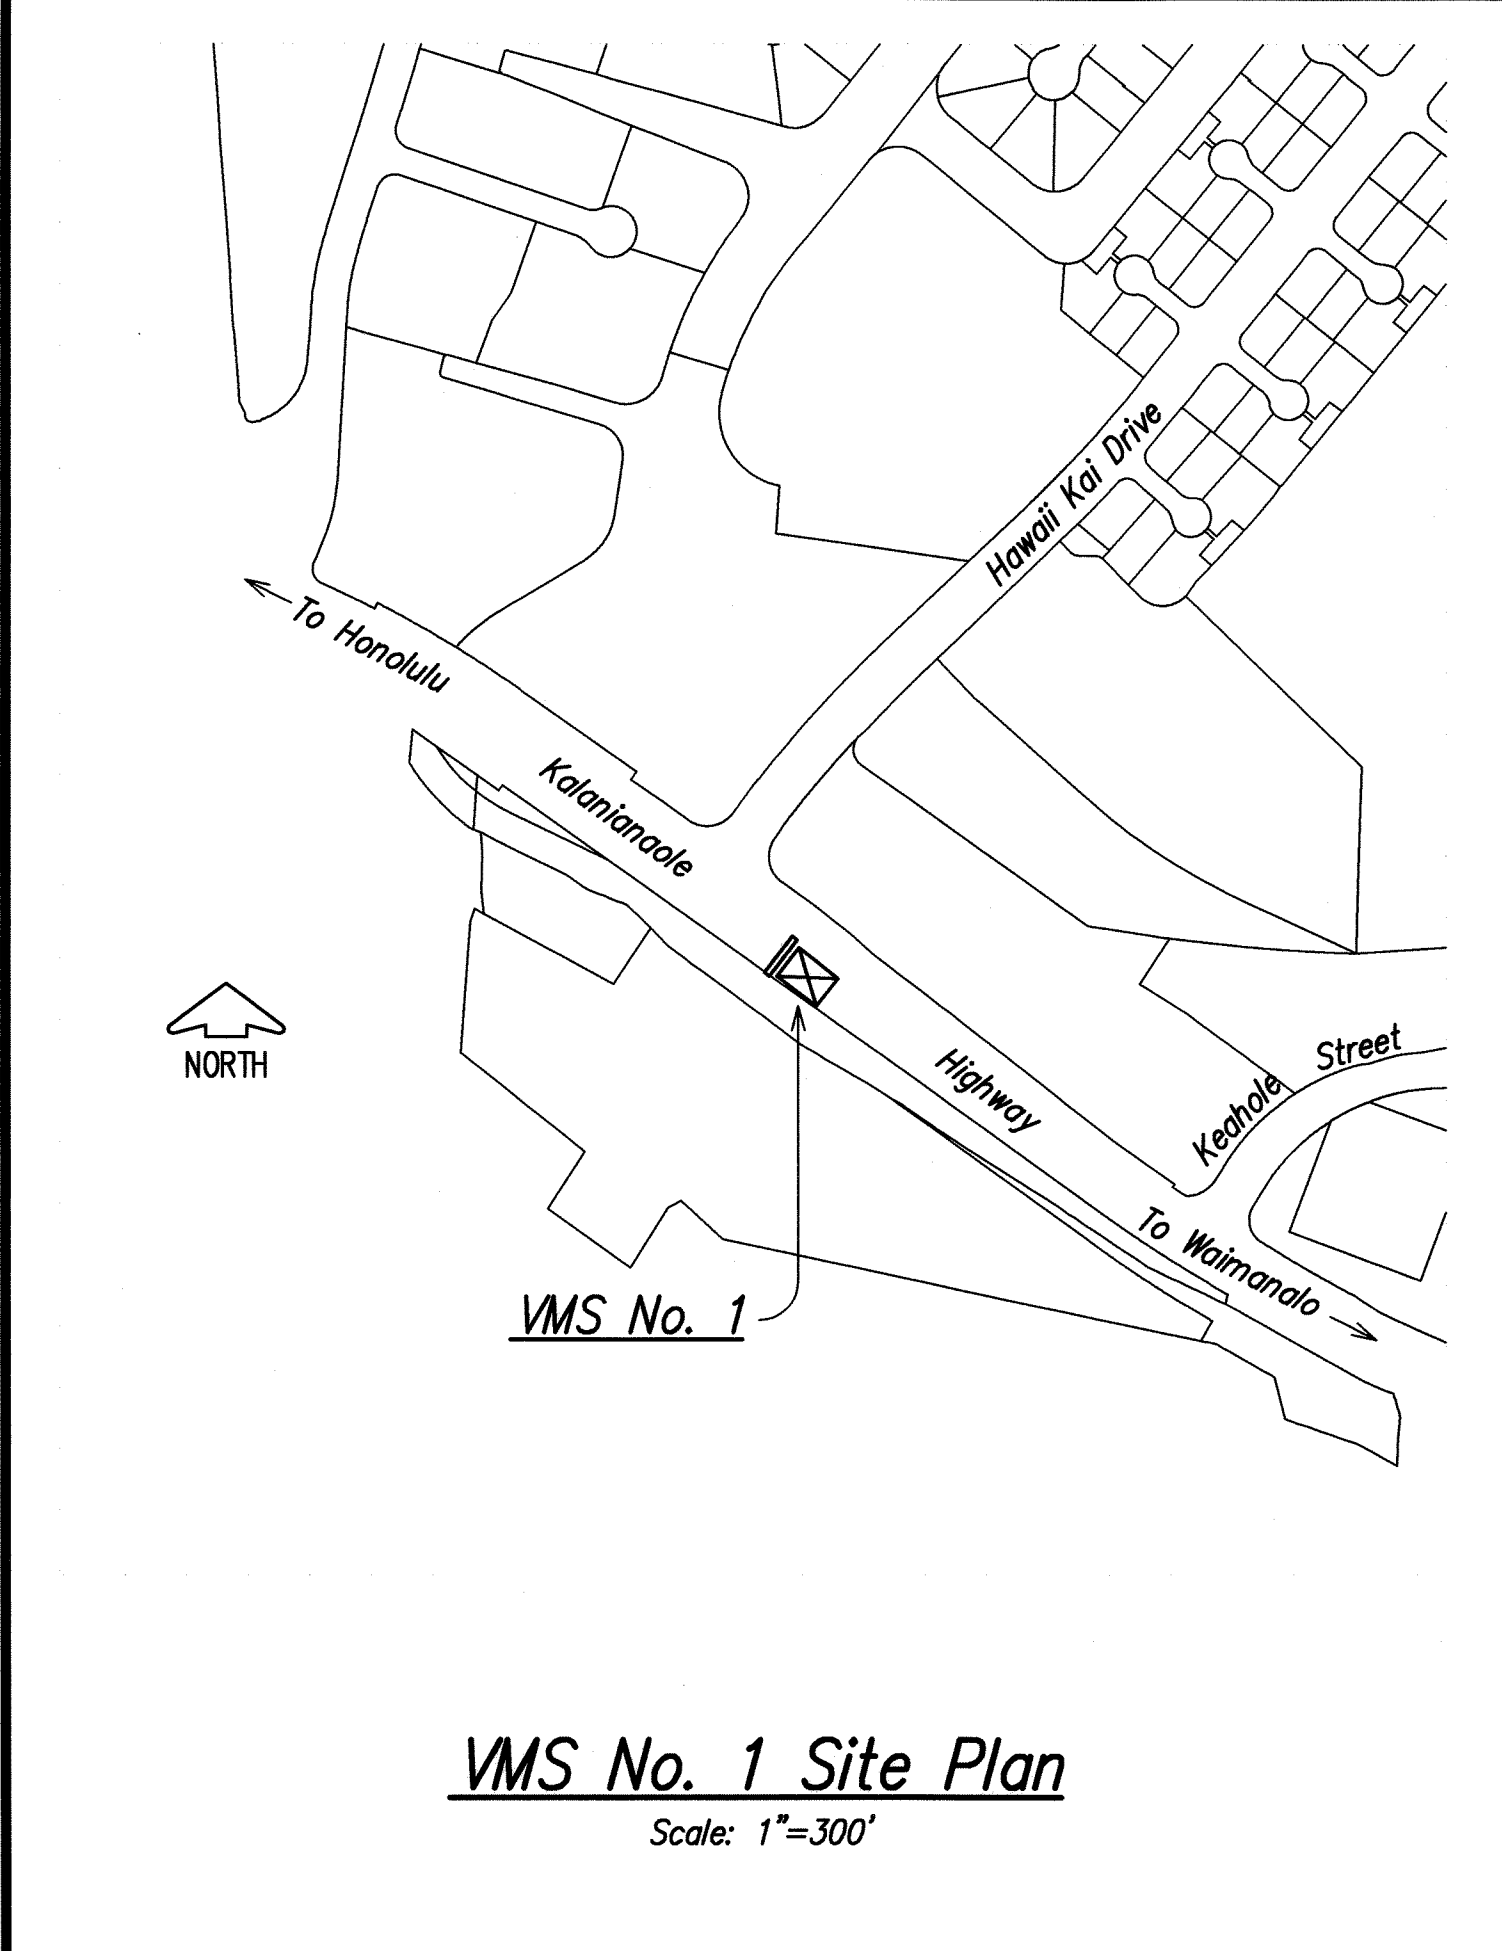
STATE OF HAWAII
 DEPARTMENT OF TRANSPORTATION
 HIGHWAYS DIVISION

TRAFFIC CONTROL PLAN
Variable Message Sign (VMS) Locations
Kalaniana'ole Highway Improvements
Retaining Wall at Makapuu, Oahu
Federal-Aid Project No. NH-072-1(51)
 Scale: As Noted Date: APR. 2007
 SHEET No. 6 OF 8 SHEETS

ORIGINAL PLAN	DRAWN BY	DATE
NOTE BOOK	DESIGNED BY	
No.	CHECKED BY	

LIB2: STATE\DOT\KALANIANA'OLE RETAINING WALL\CADD\ KALEW-74-TCPALL.dwg 4/16/07

FED. ROAD DIST. NO.	STATE	FED. AID PROJ. NO.	FISCAL YEAR	SHEET NO.	TOTAL SHEETS
HAWAII	HAW.	NH-072-1(51)	2007	75	106



ORIGINAL PLAN	SURVEY PLOTTED BY	DATE
NOTE BOOK	DRAWN BY	
	DESIGNED BY	
	CHECKED BY	

LIB2: STATE DOT \KALANIANAʻOLE\RETAINING WALL\CADD\ KALRW-75-TCP\WMS.dwg 4/16/07



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STATE OF HAWAII
DEPARTMENT OF TRANSPORTATION
HIGHWAYS DIVISION
TRAFFIC CONTROL PLAN
Variable Message Sign (VMS) Site Plans
Kalanianaʻole Highway Improvements
Retaining Wall at Makapuu, Oahu
Federal-Aid Project No. NH-072-1(51)
Scale: As Noted Date: APR. 2007
SHEET No. 7 OF 8 SHEETS

Suggested Variable Messages to be Posted During Construction

		Phase 1			Phase 2			Phase 3			Phase 4, Miscellaneous				
		Highway Open	One Lane Closure	Total Closure (Night Only)	Highway Open	One Lane Closure	Total Closure (Night Only)	Highway Open	One Lane Closure	Total Closure (Night Only)	Highway Open	One Lane Closure	Total Closure (Night Only)		
VMS No. 1	Seq. #1	N.A.	ROAD WORK AT MAKAPUU	ROAD CLOSED	N.A.	ROAD WORK AT MAKAPUU	ROAD CLOSED	N.A.	N.A.	N.A.	N.A.	N.A.	N.A.	Seq. #1	VMS No. 1
	Seq. #2	N.A.	not used	AT GOLF COURSE	N.A.	not used	AT GOLF COURSE	N.A.	N.A.	N.A.	N.A.	N.A.	N.A.		
VMS No. 2	Seq. #1	N.A.	ONE LANE OPEN AT MAKAPUU	ROAD CLOSED 1 MI.	N.A.	ONE LANE OPEN AT MAKAPUU	ROAD CLOSED 1 MI.	N.A.	N.A.	N.A.	N.A.	N.A.	N.A.	Seq. #1	VMS No. 2
	Seq. #2	N.A.	8: 30 TO 3: 30	8: 30 TO 4: 30	N.A.	8: 30 TO 3: 30	8: 30 TO 4: 30	N.A.	N.A.	N.A.	N.A.	N.A.	N.A.		
VMS No. 3	Seq. #1	N.A.	ONE LANE OPEN AT MAKAPUU	ROAD CLOSED 1/8 MILE	N.A.	ONE LANE OPEN AT MAKAPUU	ROAD CLOSED 1/8 MILE	N.A.	N.A.	N.A.	N.A.	N.A.	N.A.	Seq. #1	VMS No. 3
	Seq. #2	N.A.	8: 30 TO 3: 30	8: 30 TO 4: 30	N.A.	8: 30 TO 3: 30	8: 30 TO 4: 30	N.A.	N.A.	N.A.	N.A.	N.A.	N.A.		
VMS No. 4	Seq. #1	N.A.	ONE LANE OPEN AHEAD	ROAD CLOSED AHEAD	N.A.	ONE LANE OPEN AHEAD	ROAD CLOSED AHEAD	ROAD WORK AT MAKAPUU	N.A.	N.A.	ROAD WORK AT MAKAPUU	N.A.	N.A.	Seq. #1	VMS No. 4
	Seq. #2	N.A.	8: 30 TO 3: 30	REOPEN AT 4: 30	N.A.	8: 30 TO 3: 30	REOPEN AT 4: 30	8: 30 TO 3: 30	N.A.	N.A.	8: 30 TO 3: 30	N.A.	N.A.		
VMS No. 5	Seq. #1	N.A.	ONE LANE OPEN AHEAD	ROAD CLOSED AHEAD	N.A.	ONE LANE OPEN AHEAD	ROAD CLOSED AHEAD	ROAD WORK AT MAKAPUU	N.A.	N.A.	ROAD WORK AT MAKAPUU	N.A.	N.A.	Seq. #1	VMS No. 5
	Seq. #2	N.A.	8: 30 TO 3: 30	REOPEN AT 4: 30	N.A.	8: 30 TO 3: 30	REOPEN AT 4: 30	8: 30 TO 3: 30	N.A.	N.A.	8: 30 TO 3: 30	N.A.	N.A.		
VMS No. 6	Seq. #1	N.A.	ONE LANE OPEN AT MAKAPUU	ROAD CLOSED AHEAD	N.A.	ONE LANE OPEN AT MAKAPUU	ROAD CLOSED AHEAD	N.A.	N.A.	N.A.	N.A.	N.A.	N.A.	Seq. #1	VMS No. 6
	Seq. #2	N.A.	8: 30 TO 3: 30	8: 30 TO 4: 30	N.A.	8: 30 TO 3: 30	8: 30 TO 4: 30	N.A.	N.A.	N.A.	N.A.	N.A.	N.A.		
VMS No. 7	Seq. #1	N.A.	ONE LANE OPEN AT MAKAPUU	ROAD CLOSED	N.A.	ONE LANE OPEN AT MAKAPUU	ROAD CLOSED	N.A.	N.A.	N.A.	N.A.	N.A.	N.A.	Seq. #1	VMS No. 7
	Seq. #2	N.A.	EXPECT DELAYS	AT SEA LIFE PARK	N.A.	EXPECT DELAYS	AT SEA LIFE PARK	N.A.	N.A.	N.A.	N.A.	N.A.	N.A.		
VMS No. 8	Seq. #1	N.A.	ROAD WORK AT MAKAPUU	ROAD CLOSED	N.A.	ROAD WORK AT MAKAPUU	ROAD CLOSED	N.A.	N.A.	N.A.	N.A.	N.A.	N.A.	Seq. #1	VMS No. 8
	Seq. #2	N.A.	not used	AT SEA LIFE PARK	N.A.	not used	AT SEA LIFE PARK	N.A.	N.A.	N.A.	N.A.	N.A.	N.A.		

VARIABLE MESSAGE SIGN NOTES

- The Variable Message Signs (VMS's) shall be placed at the locations shown on the VMS Site Plan for the duration of the Project.
- The VMS's shall display the appropriate message to motorists according to the Table shown on this sheet.
- The Contractor may alter the messages with the approval of the State Engineer.
- The suggested messages are based on a maximum of 2 sequences, each with a maximum of three (3) lines and eight (8) characters per line.

ORIGINAL PLAN	SURVEY PLOTTED BY	DATE
NOTE BOOK	DESIGNED BY	
	QUANTITIES BY	
	CHECKED BY	

LB2: STATE DOT KALANIAOLE RETAINING WALL CAD001 KALRW-76-TCP VMS2.dwg 4/16/07



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STATE OF HAWAII
DEPARTMENT OF TRANSPORTATION
HIGHWAYS DIVISION

TRAFFIC CONTROL PLAN
SUGGESTED VARIABLE MESSAGES

Kalaniana'ole Highway Improvements
Retaining Wall at Makapuu, Oahu
Federal-Aid Project No. NH-072-1(51)

Scale: As Noted Date: APR. 2007
SHEET No. 8 OF 8 SHEETS