FED. ROAD DIST. NO. FED. AID PROJ. NO. TOTAL SHEETS FISCAL YEAR 2002 HWY-0-05-00 28

Sawcut, See Note 3 Warning Tape, See Note 1 Replace Conc -Exst. conc Sidewalk to sidewalk Match Exst Edge of Conc -Siďewalk


NOTES:

- 1. 8 mil thick orange colored plastic warning tape 3" wide entire length of duct. Tape to have continuous metalic backing and corrosion resistant foil core. Warning and identification to be imprinted on tape and shall read "CAUTION BURIED ELECTRIC CABLE BELOW". Message shall be repeated approximately every ten feet...
- 2. Type "A" Backfill: Beach sand, earth or earth and gravel used, the maximum rock size shall be 1" and the mixture shall contain not more than 50% by volume of rock particles.

Type "B" Backfill:Same as type "A' except that if earth \$ gravel used, the mixture must pass a 1/2" mesh screen \& contain not more than 20% by volume of rock particles. 95% compaction

Note A: If the normal material in the bottom of trench is not type "B", an additional 3" shall be excavated \$ type "B" backfill shall be provided.

3. Sawcut at score joint. Replace concrete sidewalk within that area. See detail

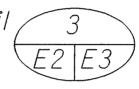

E2 E3 Not to scale


2" Schedule 80

PVC, Typical


DIRECT BURIED CONDUIT (UNDER CONC. SIDEWALK)

Exst Metal Guard Rail Planting Area - Warning Tape, See Note 1 Finish Grade — Exst Roadway Concrete Jacket 2" Schedule 80 2500 PSI PVC, Typical Compressive Strength

CONCRETE ENCASED (NON-ROADWAY AREA) Not to scale

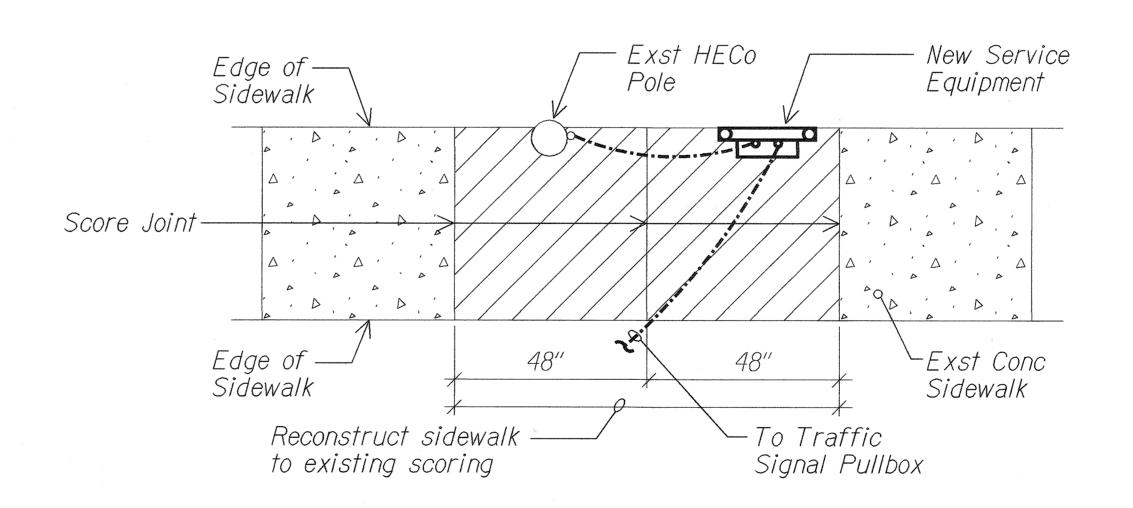



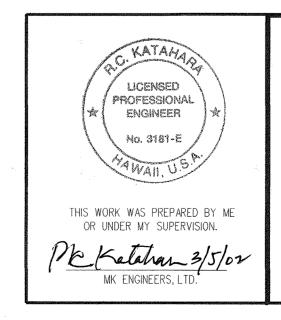



STATE OF HAWAII DEPARTMENT OF TRANSPORTATION ELECTRICAL DETAILS SAND ISLAND ACCESS ROAD Intersection Improvements at Road No. 2

Project No. Hwy-0-05-00

Scale: As Shown Date: Feb. 2002 SHEET No. E-3 OF


SHEETS

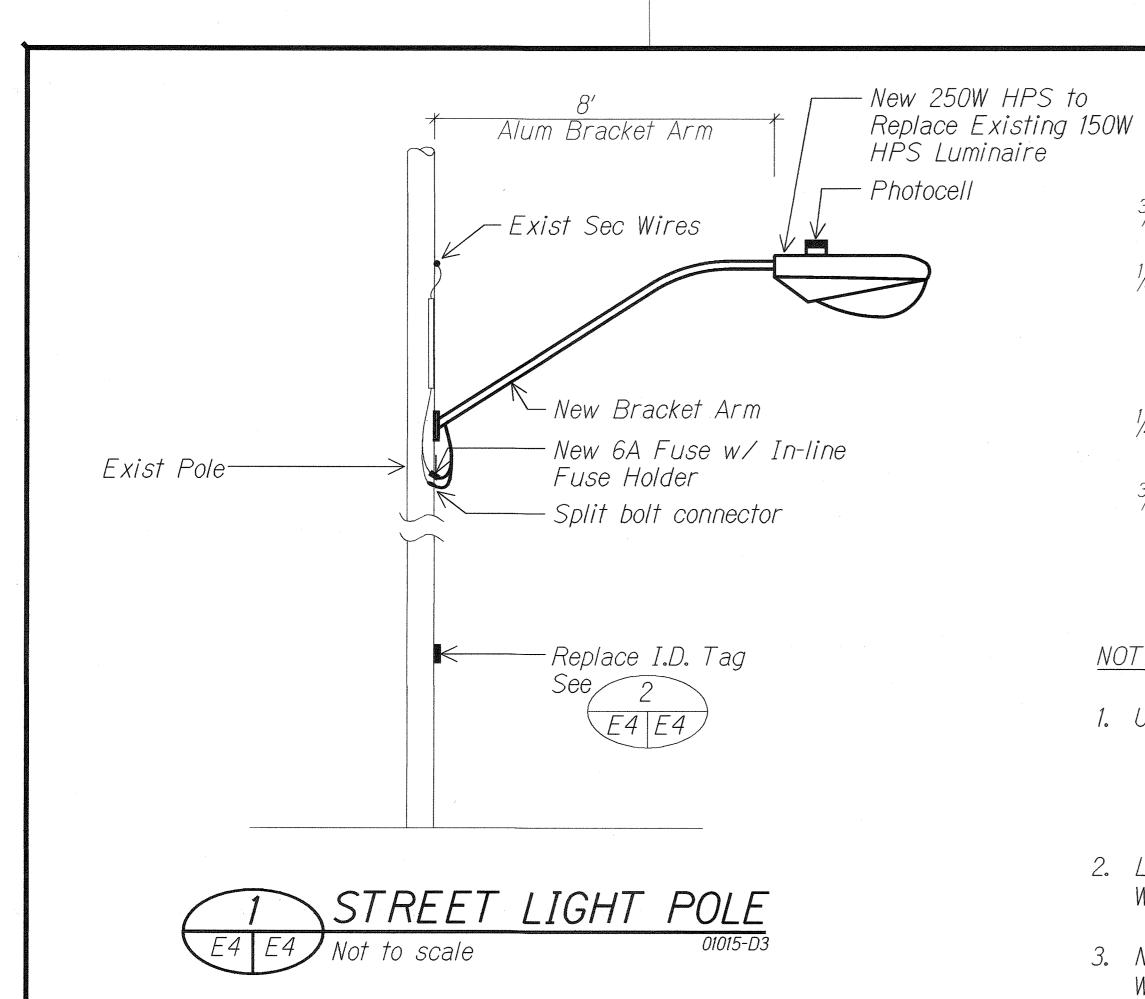

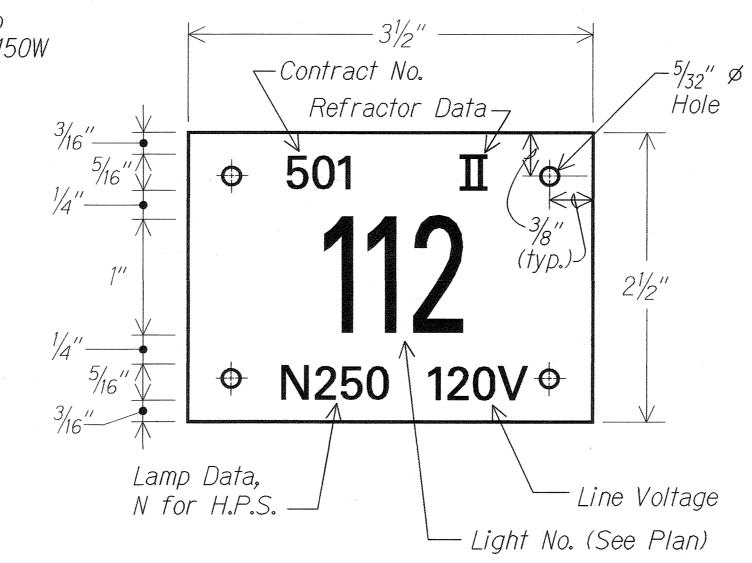

NOTES:

- 1. Use 3 Ply Laminated Flexible Plastic Black-White-Black Thickness: 0.010" - Black Cap Sheet 0.052" - White Base Sheet 0.010" - Black Base Sheet
- 2. Light Number Size shall be 1-inch high and engraved $\frac{1}{8}$ " wide, White in color (Number as required).
- 3. Nomenclature Size shall be $\frac{5}{16}$ " high and engraved $\frac{1}{32}$ " wide, White in color (Contract No., Line Voltage, Lamp Data and Refractor Data as required).
- 4. Attach to Aluminum and Steel Poles with no. 8 Stainless Steel, 1/2" long Drive Screws in 1/8" drilled hole. Attach to Wood Pole with 4D Aluminum Nails.
- 5. Numbers are inscribed by cutting through "Black Cap Sheet" to expose "White Letters".
- 6. Contract Number and Light Number shall be obtained from the State. Use an alphabet suffix to designate lights mounted on the same pole (e.g. 123A \≠ 123B).
- 7. For Light Poles installed on Ramp, assign Numbers to include Ramp I.D. and Light Number. Legend may be less that one inch in height.

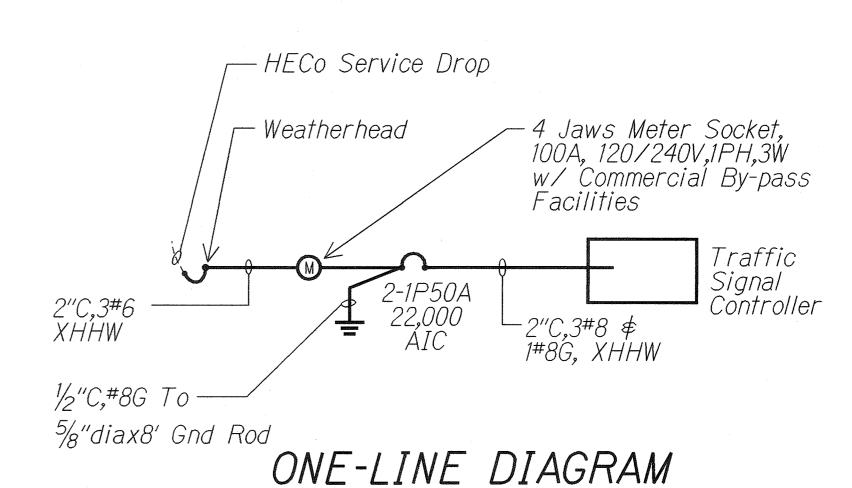

No scale

FED. ROAD DIST. NO.

HAW.

FISCAL YEAR

2002


SHEET NO.

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SHEETS


FED. AID PROJ. NO.

HWY-0-05-00

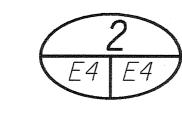

HIGHWAY LIGHT POLE TAG DETAIL - UNMETERED SYSTEM

Not to scale

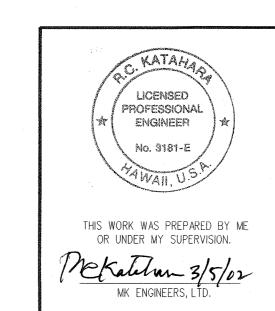

STATE OF HAWAII **DEPARTMENT OF TRANSPORTATION**

ELECTRICAL DETAILS

SAND ISLAND ACCESS ROAD Intersection Improvements at Road No. 2 Project No. Hwy-0-05-00

Scale: As Shown Date: Feb. 2002

SHEET No. E-4 OF 5 SHEETS

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