




FED. ROAD DIST. NO.	STATE	FED. AID PROJ. NO.	FISCAL YEAR	SHEET NO.	TOTAL SHEETS
HAWAII	HAW.	NH-064-1(5)	1994	24	95

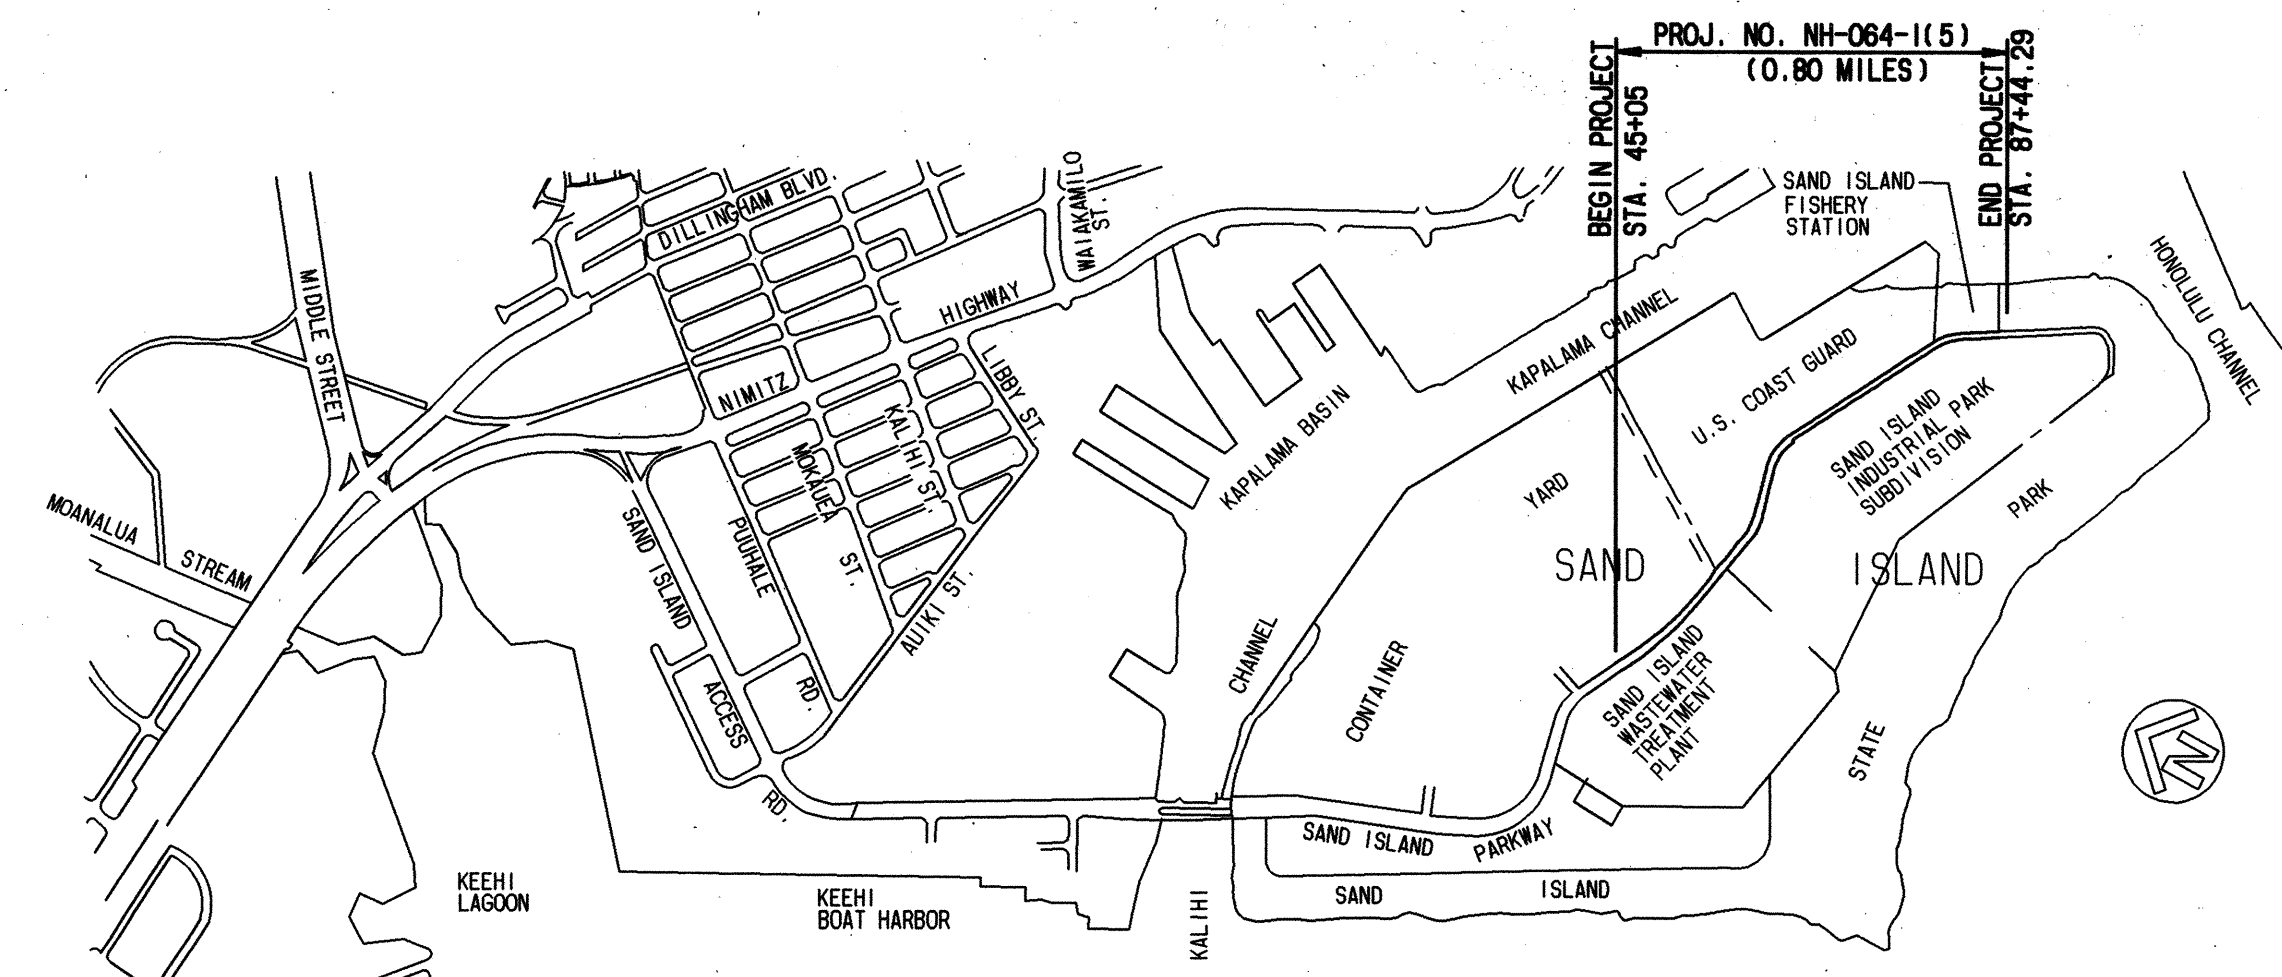


LOCATION MAP
NOT TO SCALE

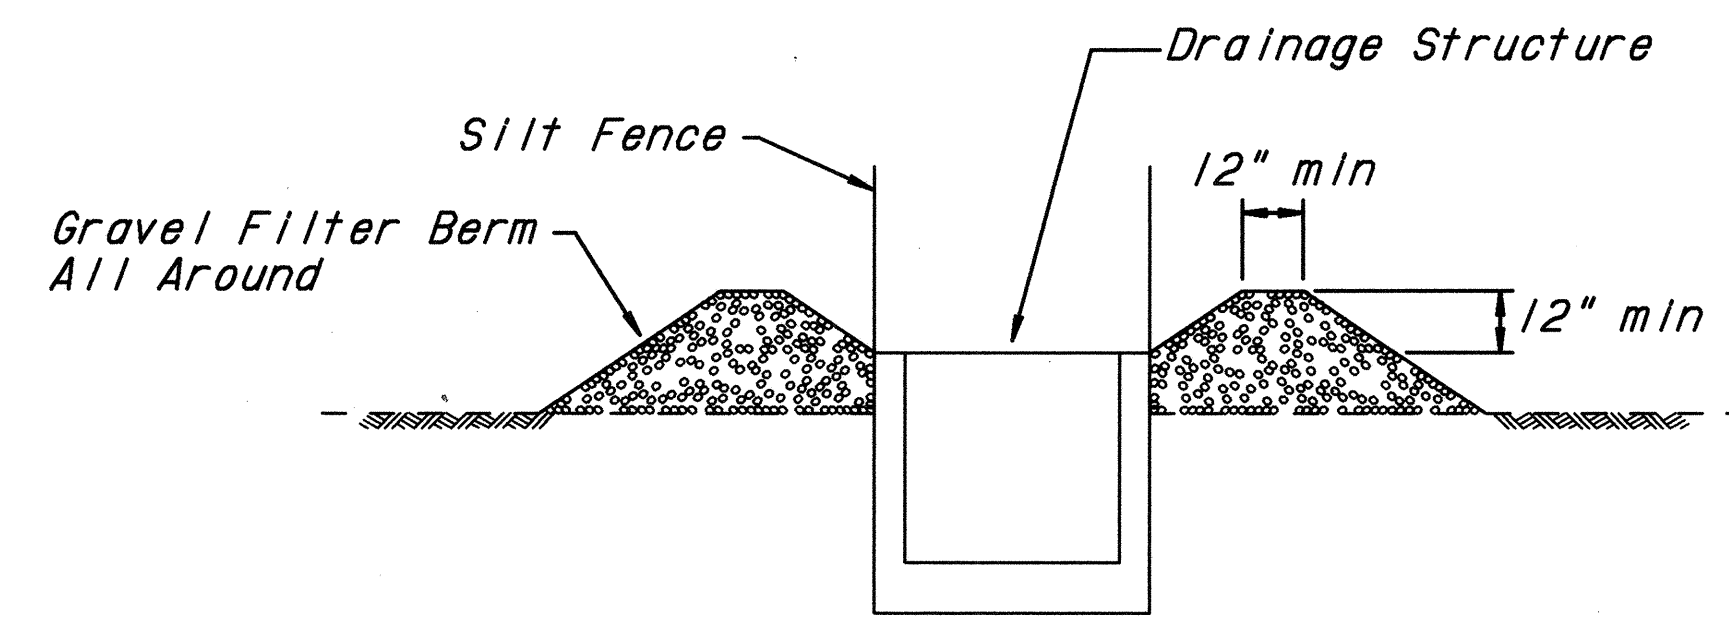


TYPICAL SECTION - TEMPORARY FILTER BERM
NOT TO SCALE

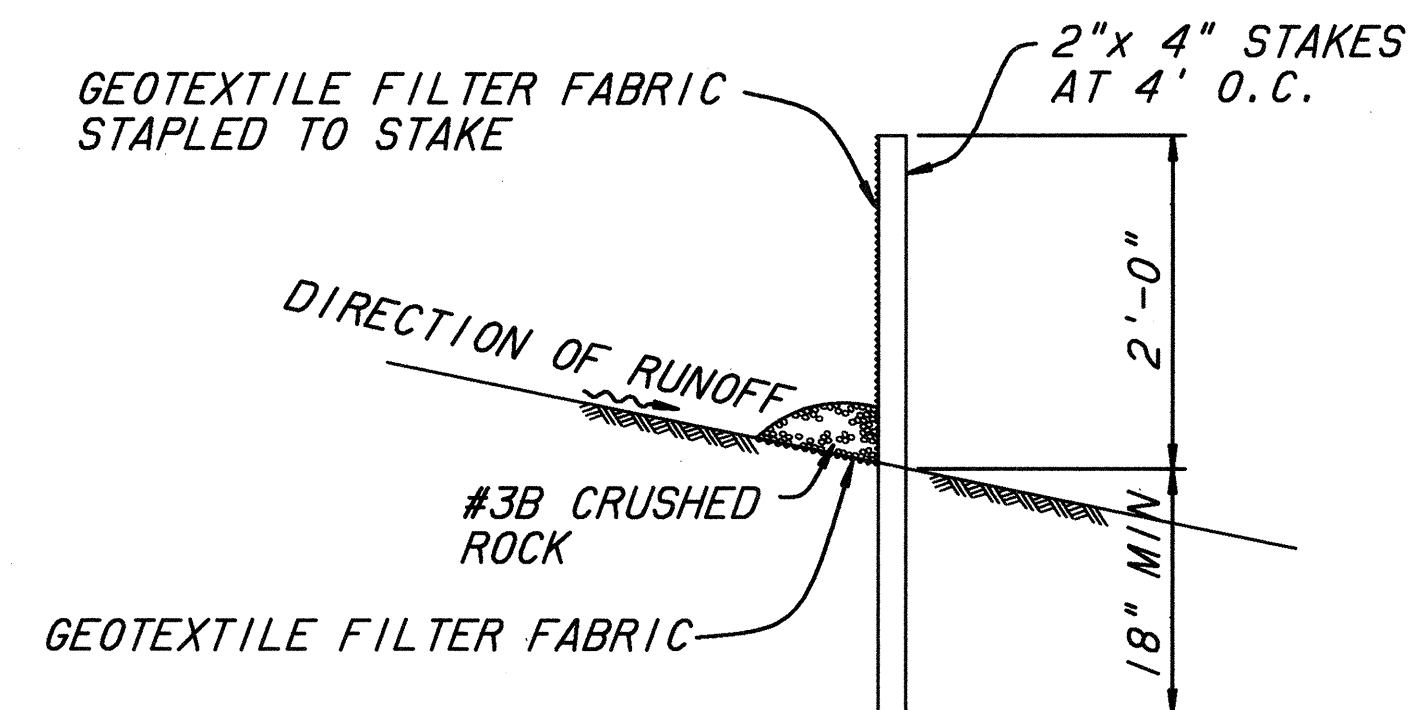

DETAIL - SILT FENCE
NOT TO SCALE

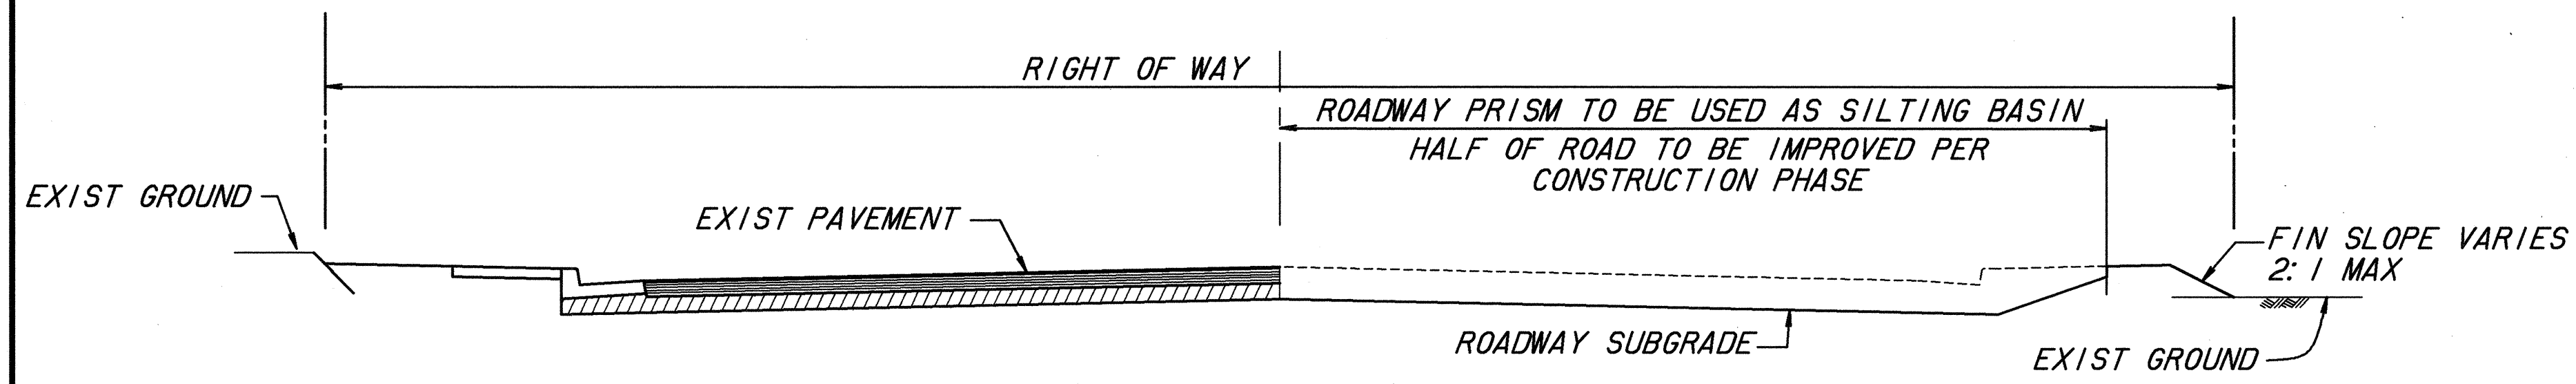


TYPICAL SECTION OF ROADWAY FOR SILTING BASIN
SCALE: 1/4" = 1'-0"

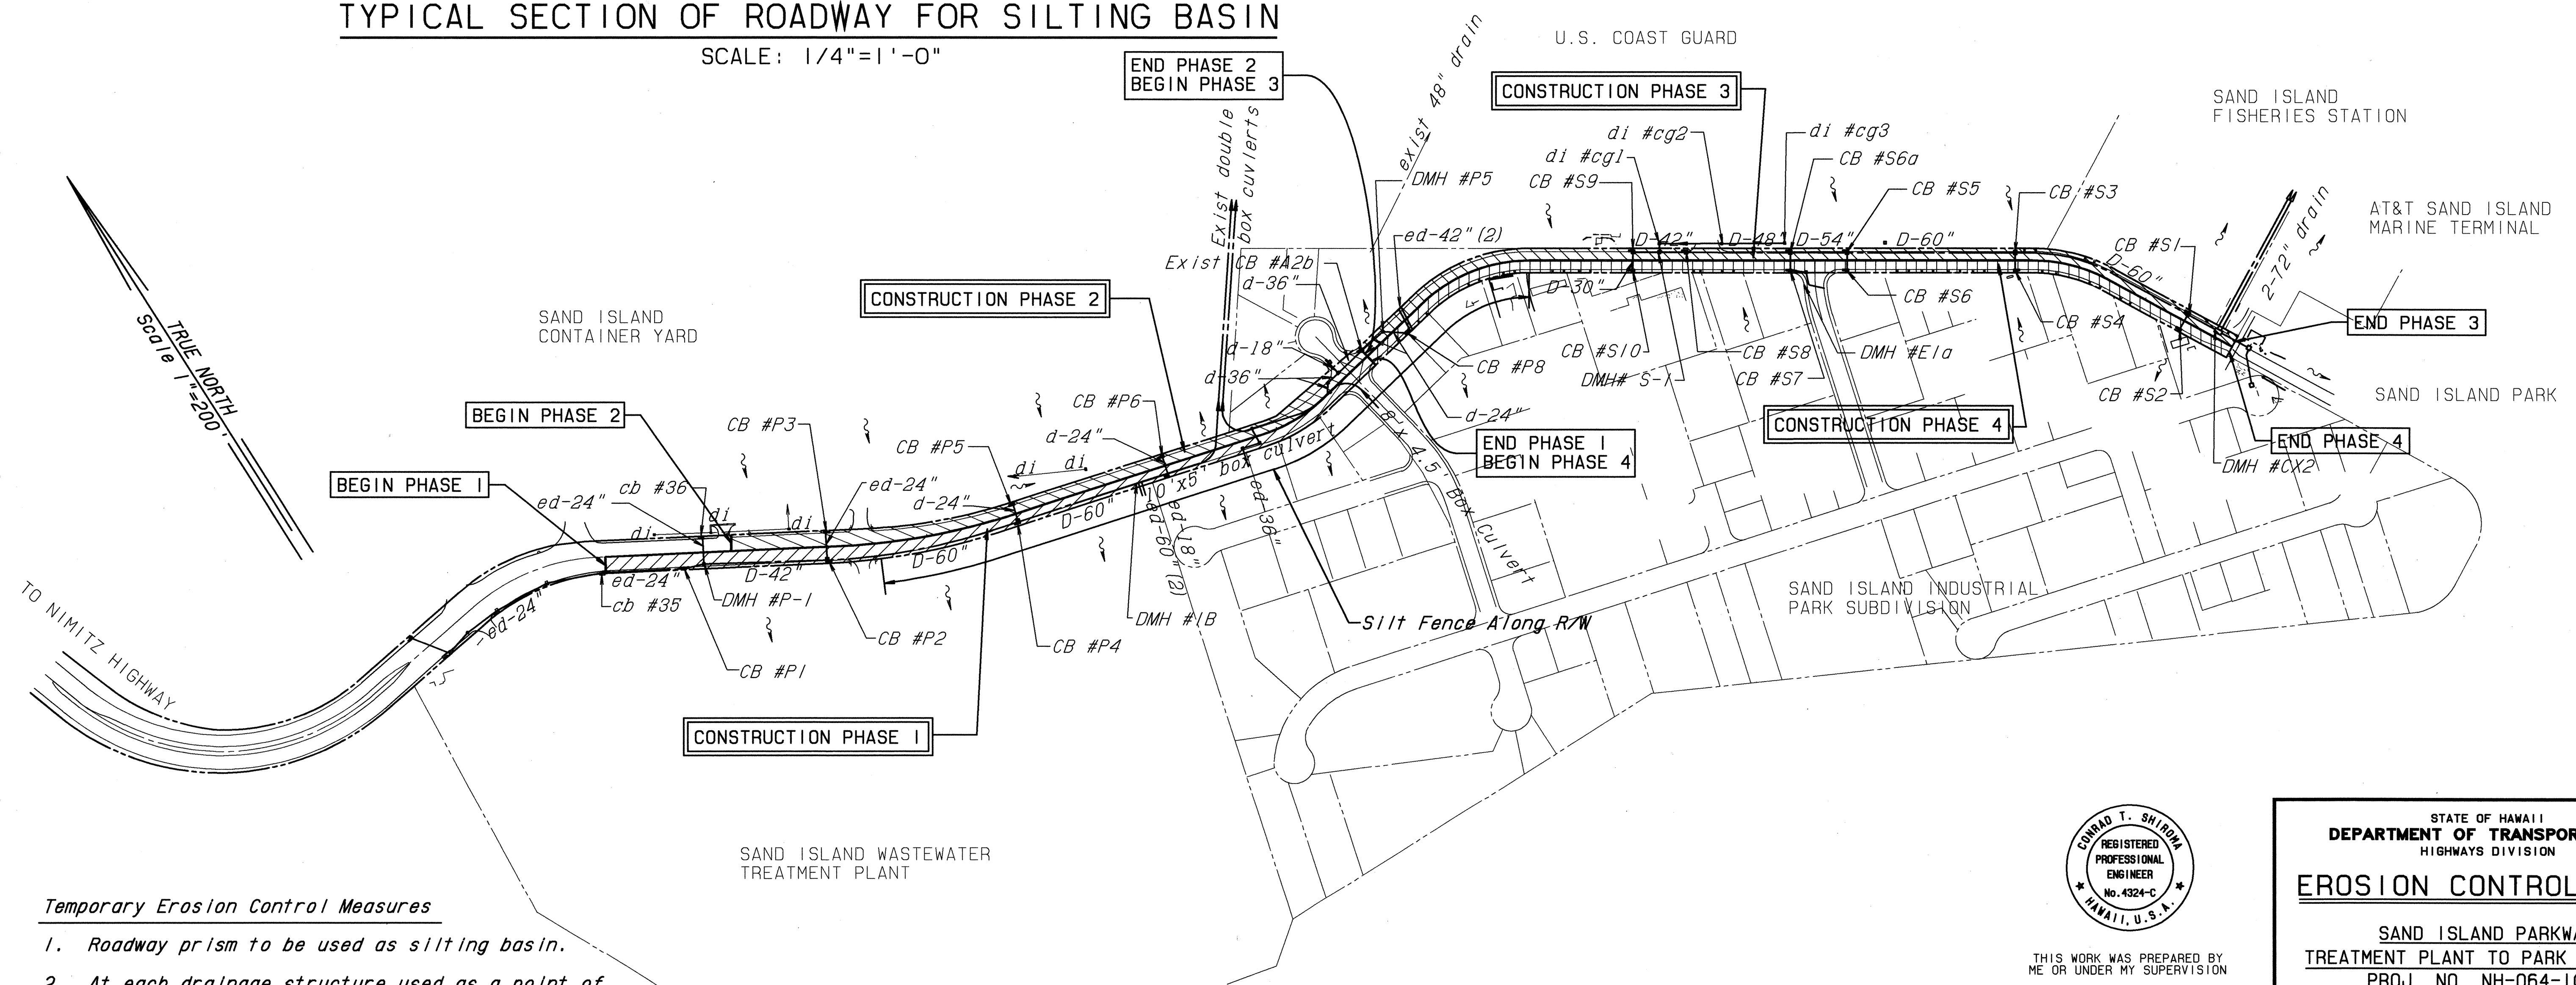

EROSION CONTROL PLAN
SCALE: 1" = 200'

Temporary Erosion Control Measures

- Roadway prism to be used as silting basin.
- At each drainage structure used as a point of discharge during construction, provide sediment surrounding each drainage structure.

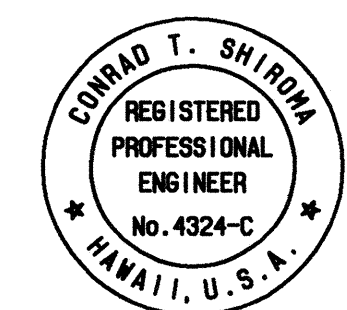

THIS WORK WAS PREPARED BY ME OR UNDER MY SUPERVISION

APPROVED:
(FOR EROSION CONTROL ONLY)
DATE: 7/14/93
CALVIN KIM & ASSOC., INC.

STATE OF HAWAII
DEPARTMENT OF TRANSPORTATION
HIGHWAYS DIVISION
EROSION CONTROL PLAN
SAND ISLAND PARKWAY
TREATMENT PLANT TO PARK ENTRANCE
PROJ. NO. NH-064-1(5)
SCALE: 1" = 200' DATE: SEPT 1993
SHEET No. H190F 23 SHEETS

ORIGINAL PLAN	DATE
DESIGNED BY	
TRACED BY	
NOTED BY	
CHECKED BY	
NO.	