



ELECTRICAL & MECHANICAL REPAIRS AT BASCULE BRIDGE

HONOLULU, OAHU, HAWAII

JOB No. H.C. 1451

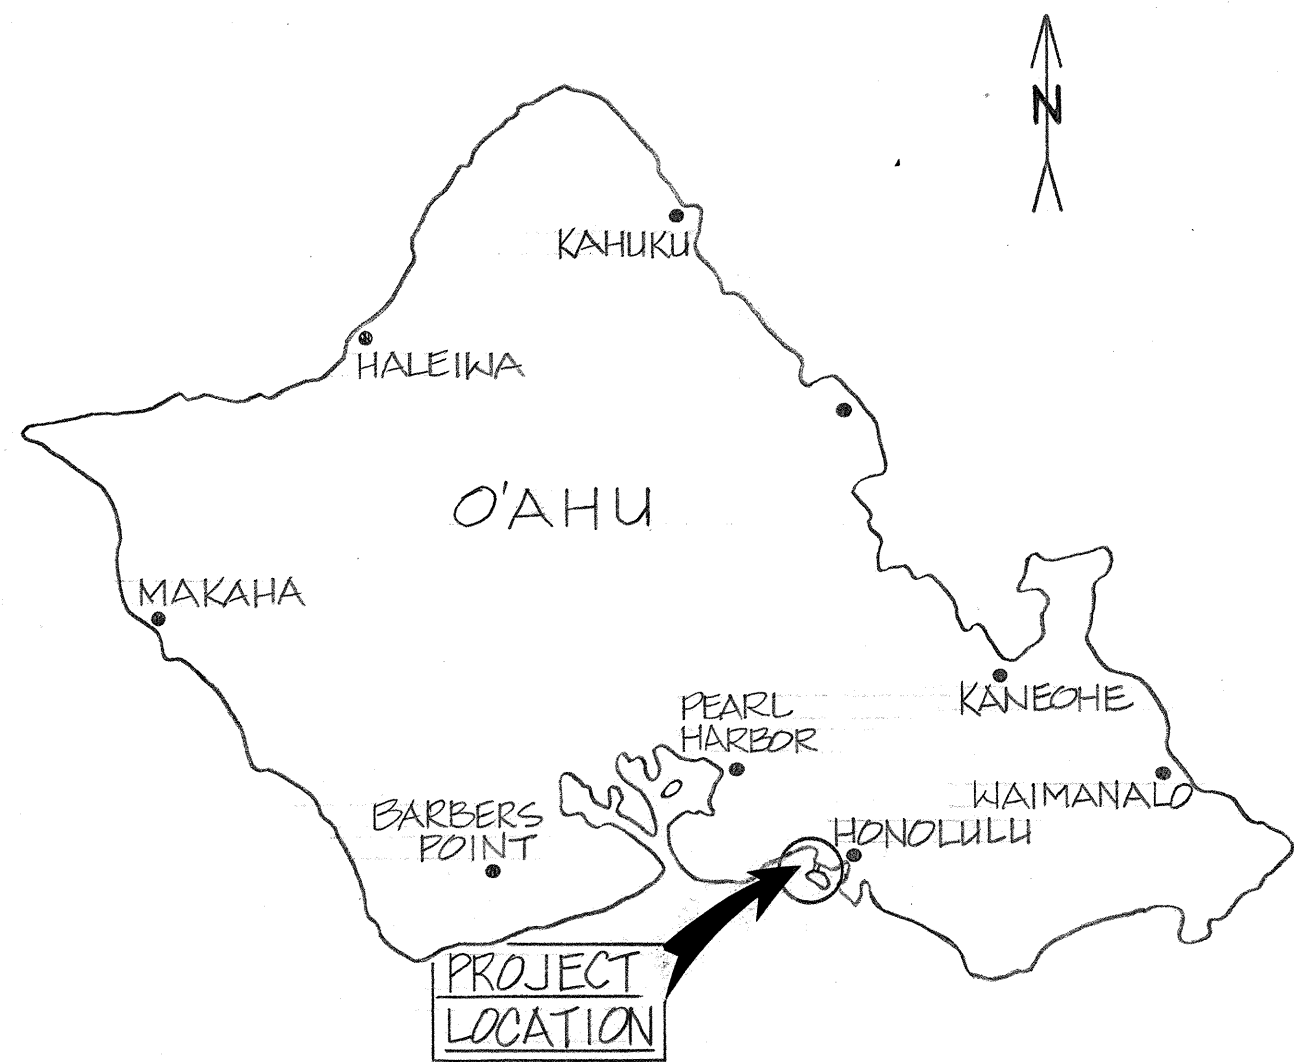


LOCATION MAP
SCALE: 1" = APPROX. 6 MILES

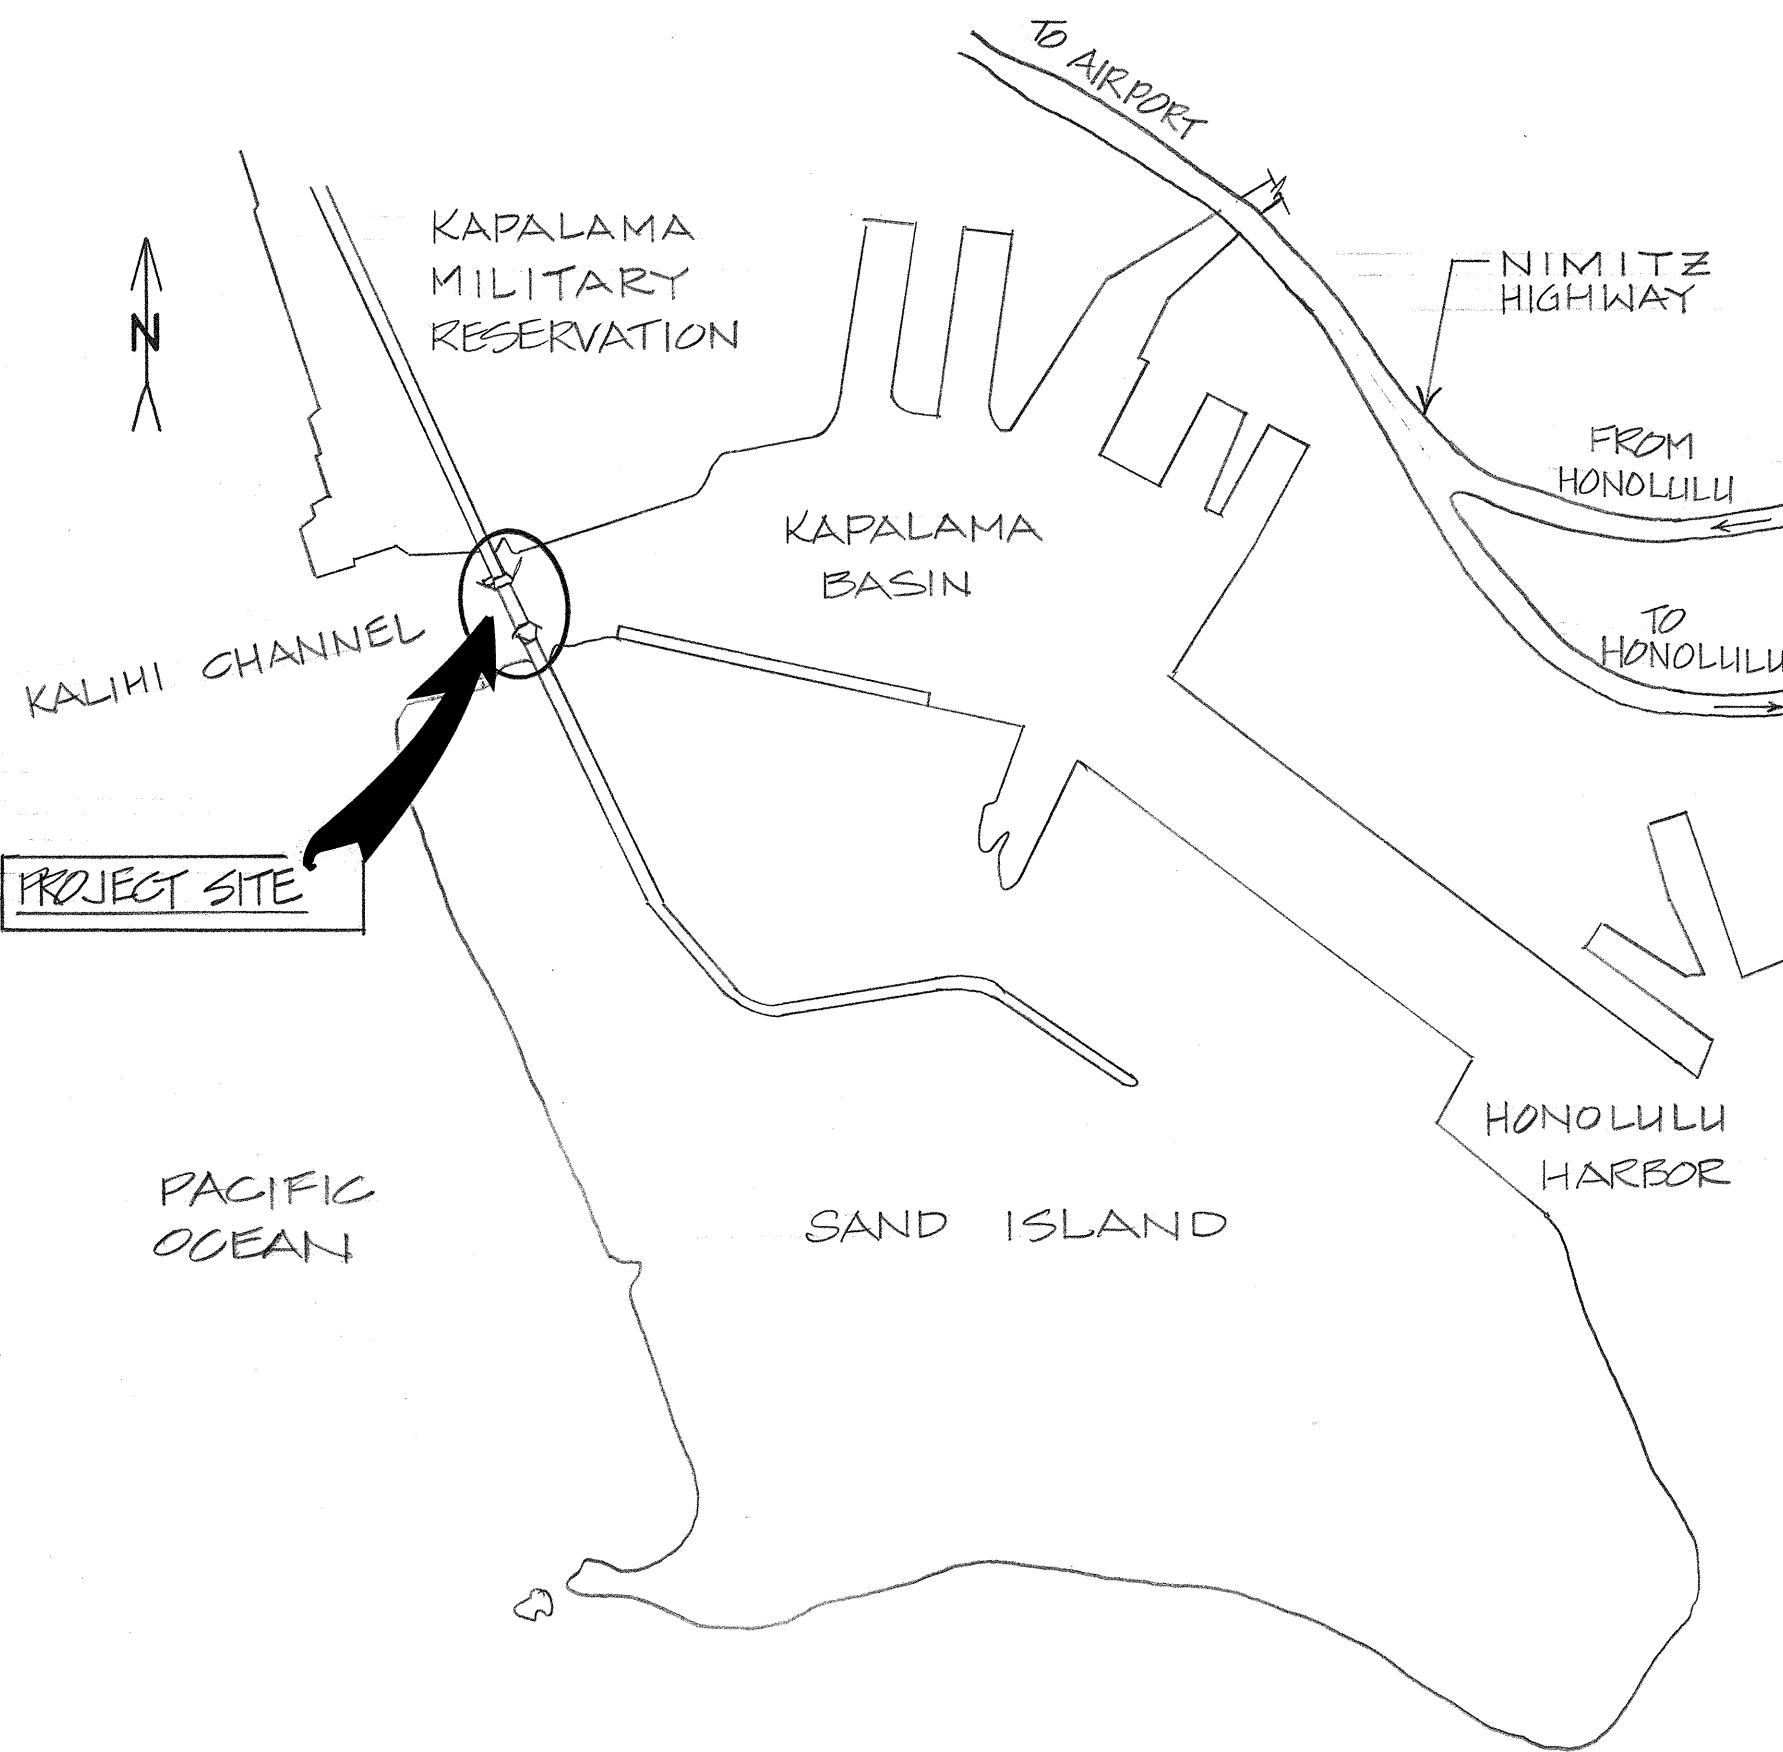

VICINITY MAP
SCALE: 1" = APPROX. 50 FEET

INDEX OF DRAWINGS

SHEET NO.	SHEET TITLE
1	TITLE, LOCATION MAP, VICINITY MAP, INDEX OF DRAWINGS
2	BRIDGE ELEVATION & PLAN, DETAILS AND NOTES
3	LOWER & UPPER LEVEL PLANS (KAPALAMA END), CENTER LOCK UNIT PLAN, REPAIR SCHEDULE
4	UPPER & LOWER LEVEL PLANS (SAND ISLAND END), REPAIR SCHEDULE
5	ROADWAY BARRIER ELEVATION, PIER 3 & 4 PLANS, SUPPORT RING DETAIL
6	ROOF PLAN, ELEVATION AND DETAILS
7	LOWER LEVEL PLAN, ELEVATIONS AND DETAILS

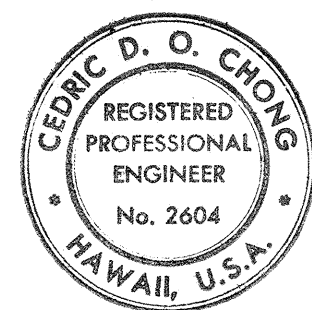

THIS WORK WAS PREPARED BY ME
OR UNDER MY SUPERVISION.
Cedric D. O. Chong
4/5/02

REV	DATE	DESCRIPTION	BY	APPROVED
STATE OF HAWAII DEPARTMENT OF TRANSPORTATION HARBORS DIVISION				
JOB TITLE ELECTRICAL & MECHANICAL REPAIRS AT BASCULE BRIDGE HONOLULU, OAHU, HAWAII				
SHEET TITLE TITLE, LOCATION MAP, VICINITY MAP, INDEX OF DRAWINGS				
SUBMITTED BY: <i>Richard H. Esaki</i> SECTION HEAD		RECOMMENDED BY: <i>Harry H. Murchison</i> ASSISTANT CHIEF FOR ENGINEERING		
DESIGNED BY: RL	APPROVED BY: <i>[Signature]</i>	SHEET 1		
DRAWN BY: ZHM	CHIEF, HARBORS DIVISION	JOB NUMBER H.C. 1451		
CHECKED BY: CDCC		DATE: 4/5/02		
SCALE: AS NOTED		1 OF 7 SHTS.		