




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|------------------------|-------|--------------|----------------|--------------|-----------------|
| HAWAII | HAW. | HWY-0-21-98M | 2001 | 15 | 77 |

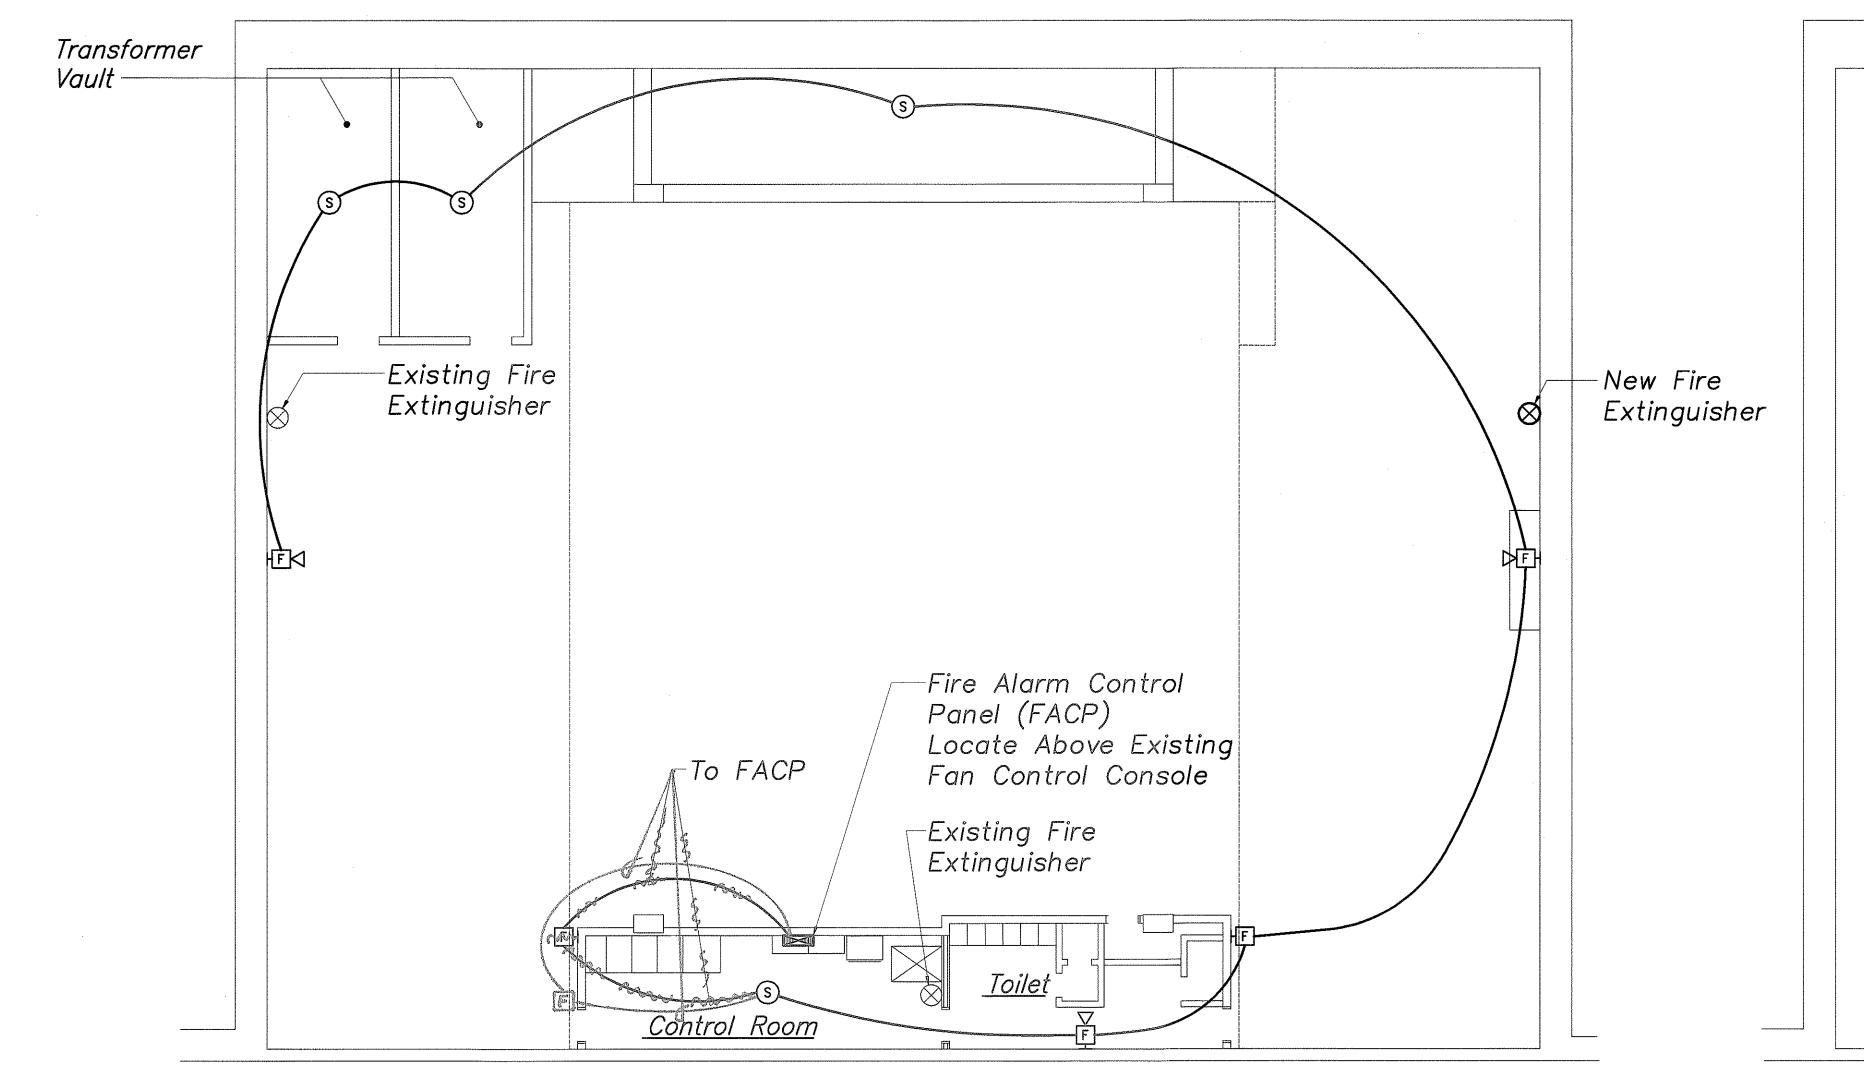

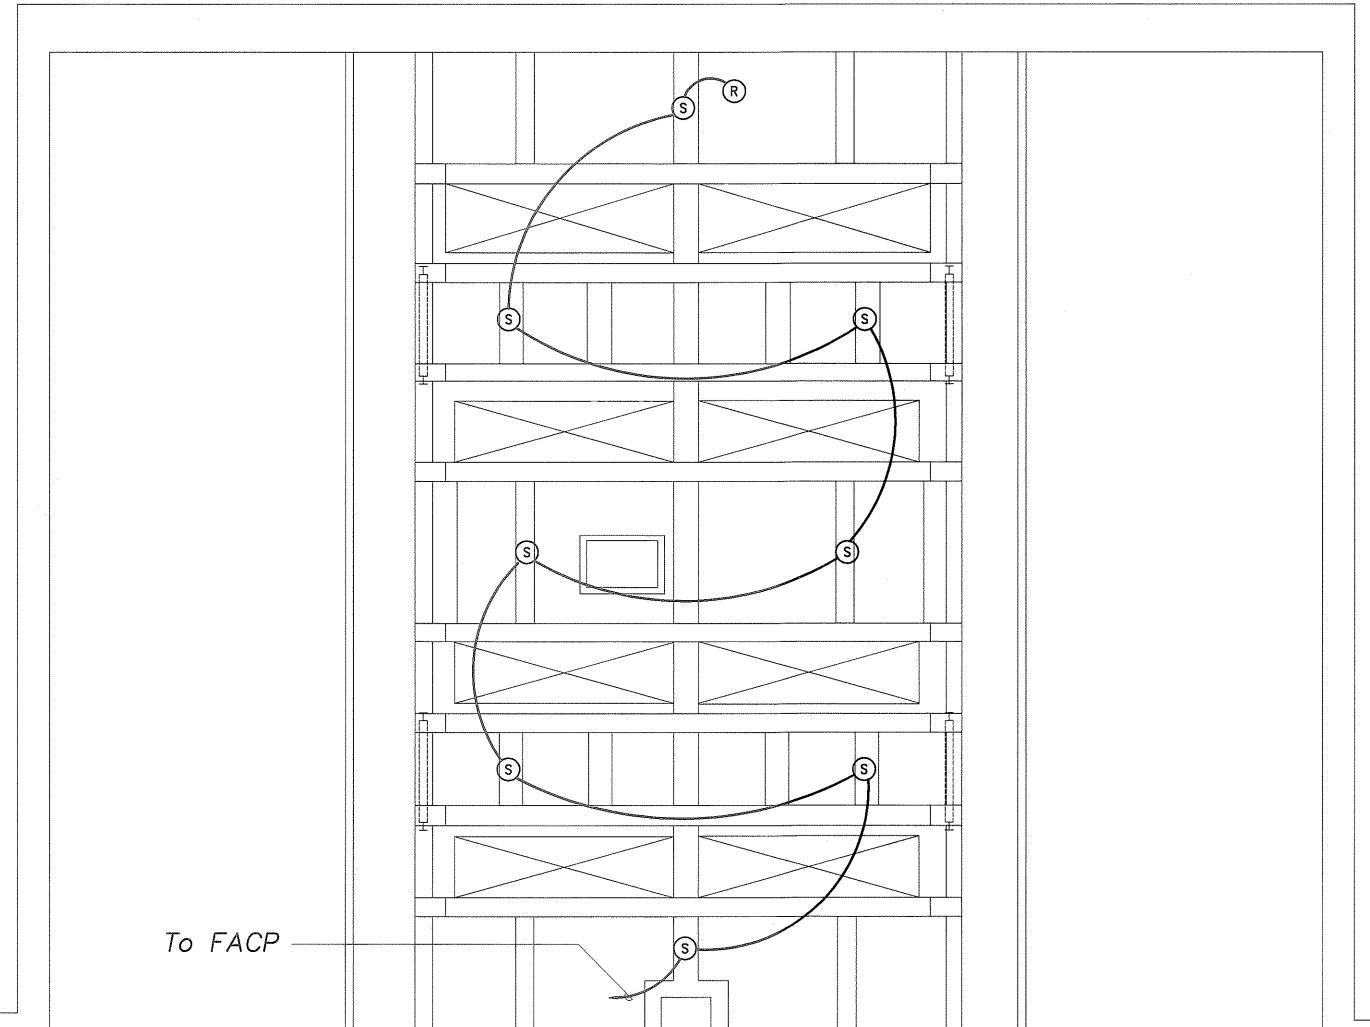

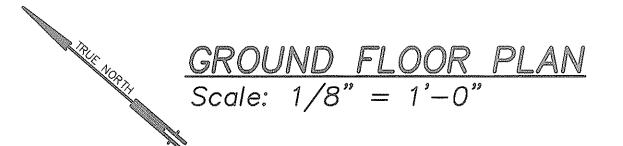

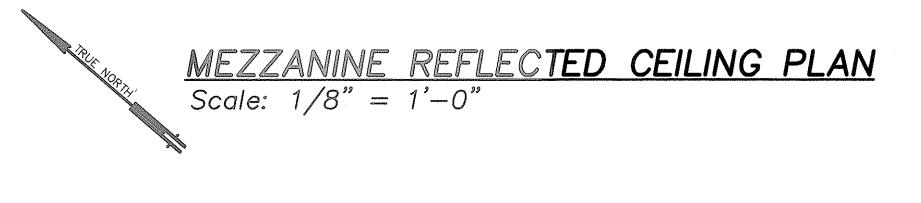

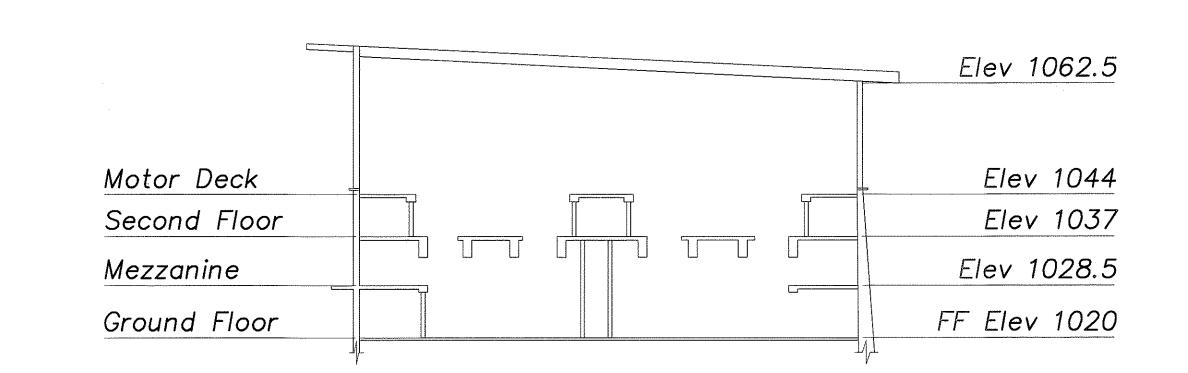



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STATE OF HAWAI'I
DEPARTMENT OF TRANSPORTATION
HIGHWAYS DIVISION

GRD FLR & MEZZ CLG FIRE ALARM PLANS


WILSON TUNNEL IMPROVEMENTS
SCADA UPGRADE


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Scale: As Noted Date: JULY 2000

SHEET No. FP-1 OF FP-4 SHEETS

"AS-BUILT"

| FED. ROAD DIST. NO. | STATE | PROJ. NO. | FISCAL YEAR | SHEET NO. | TOTAL SHEETS |
|------------------------|-------|--------------|----------------|--------------|-----------------|
| HAWAII | HAW. | HWY-0-21-98M | 2001 | 16 | 77 |

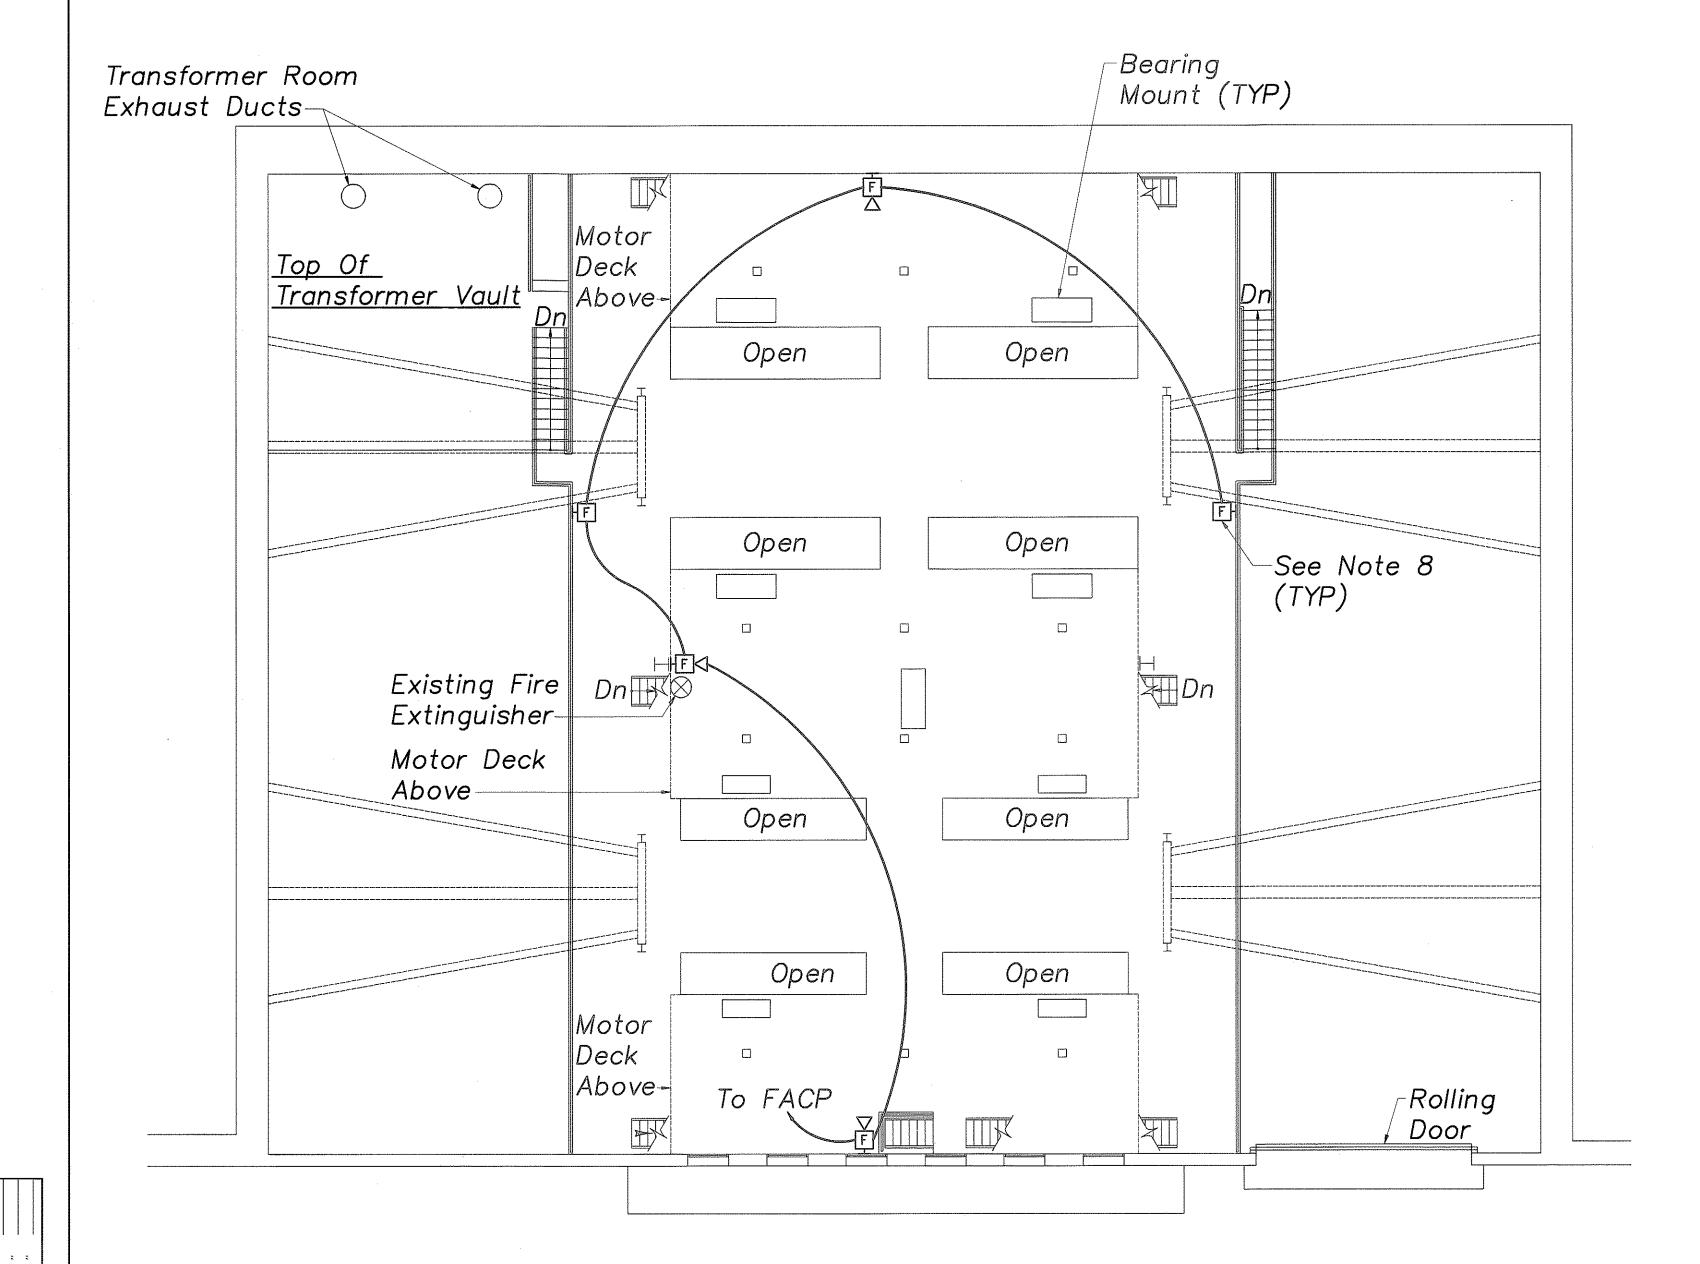

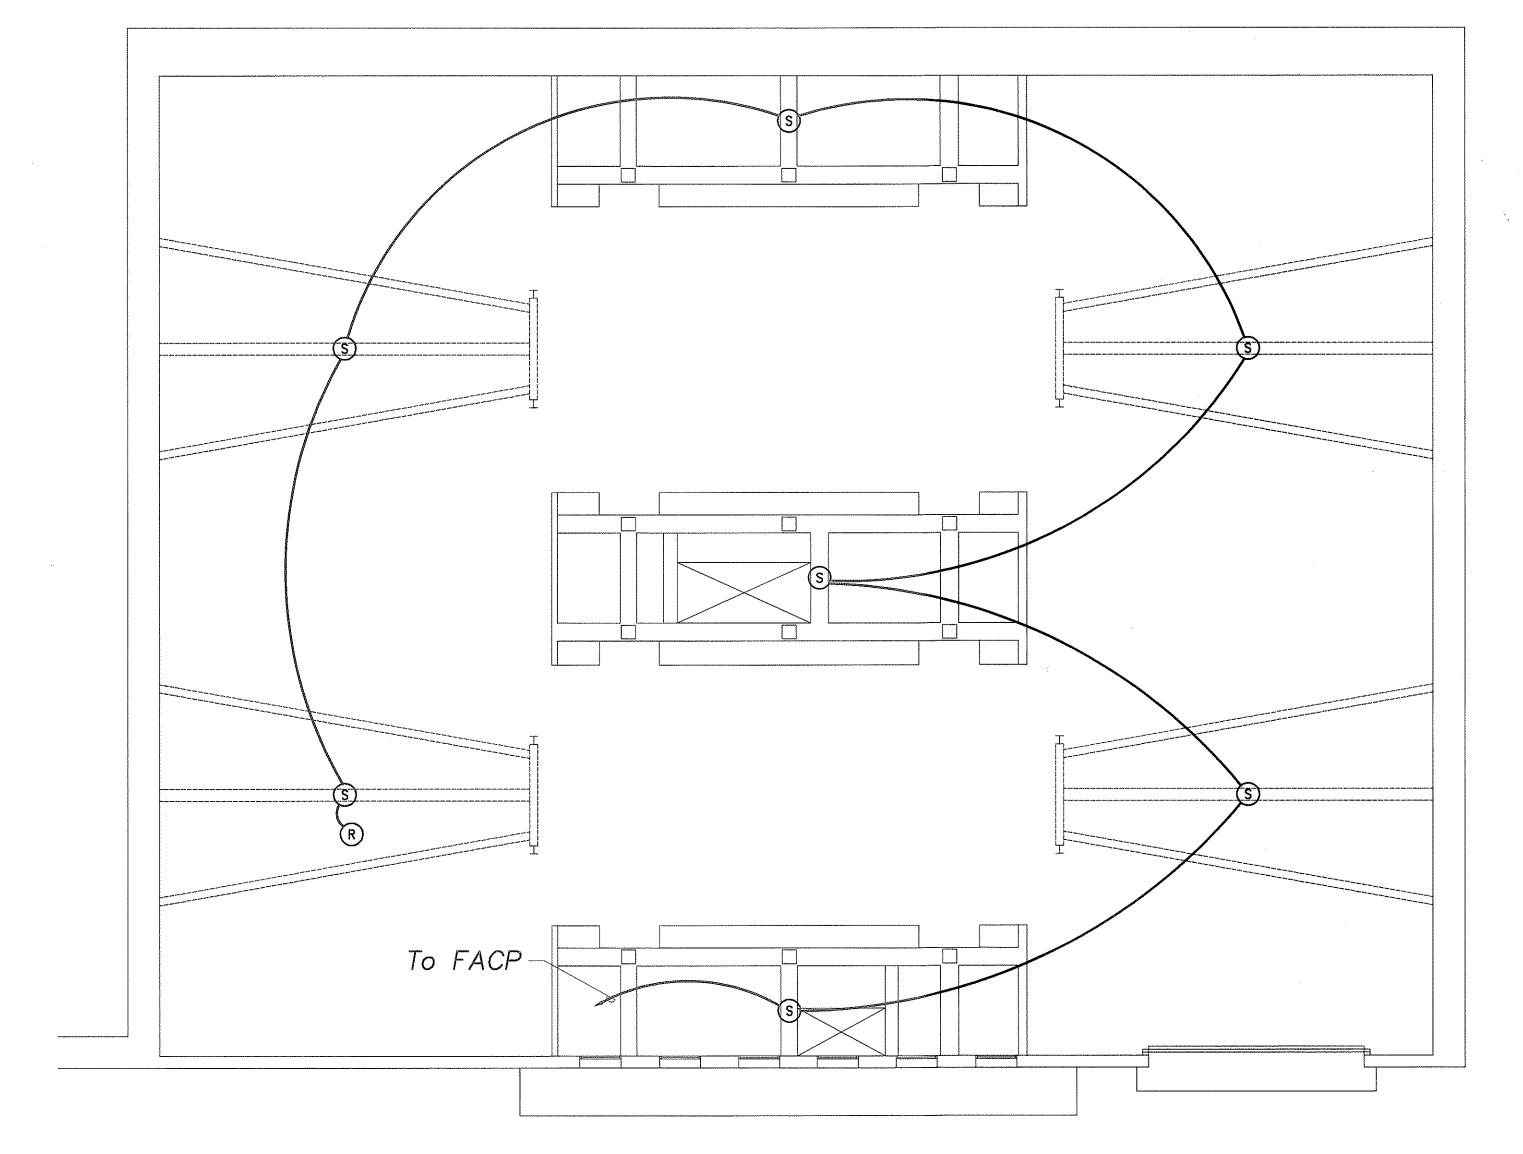

SECOND FLOOR PLAN

Scale: 1/8" = 1'-0"

SECOND FLOOR REFLECTED CEILING PLAN

Scale: 1/8" = 1'-0"



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STATE OF HAWAI'I
DEPARTMENT OF TRANSPORTATION
HIGHWAYS DIVISION

2ND FLOOR AND CEILING

FIRE ALARM PLANS

WILSON TUNNEL IMPROVEMENTS
SCADA UPGRADE


PROJECT NO. HWY-0-21-98M

Scale: As Noted Date: JULY 2000

SHEET No. FP-2 OF FP-4 SHEETS

16



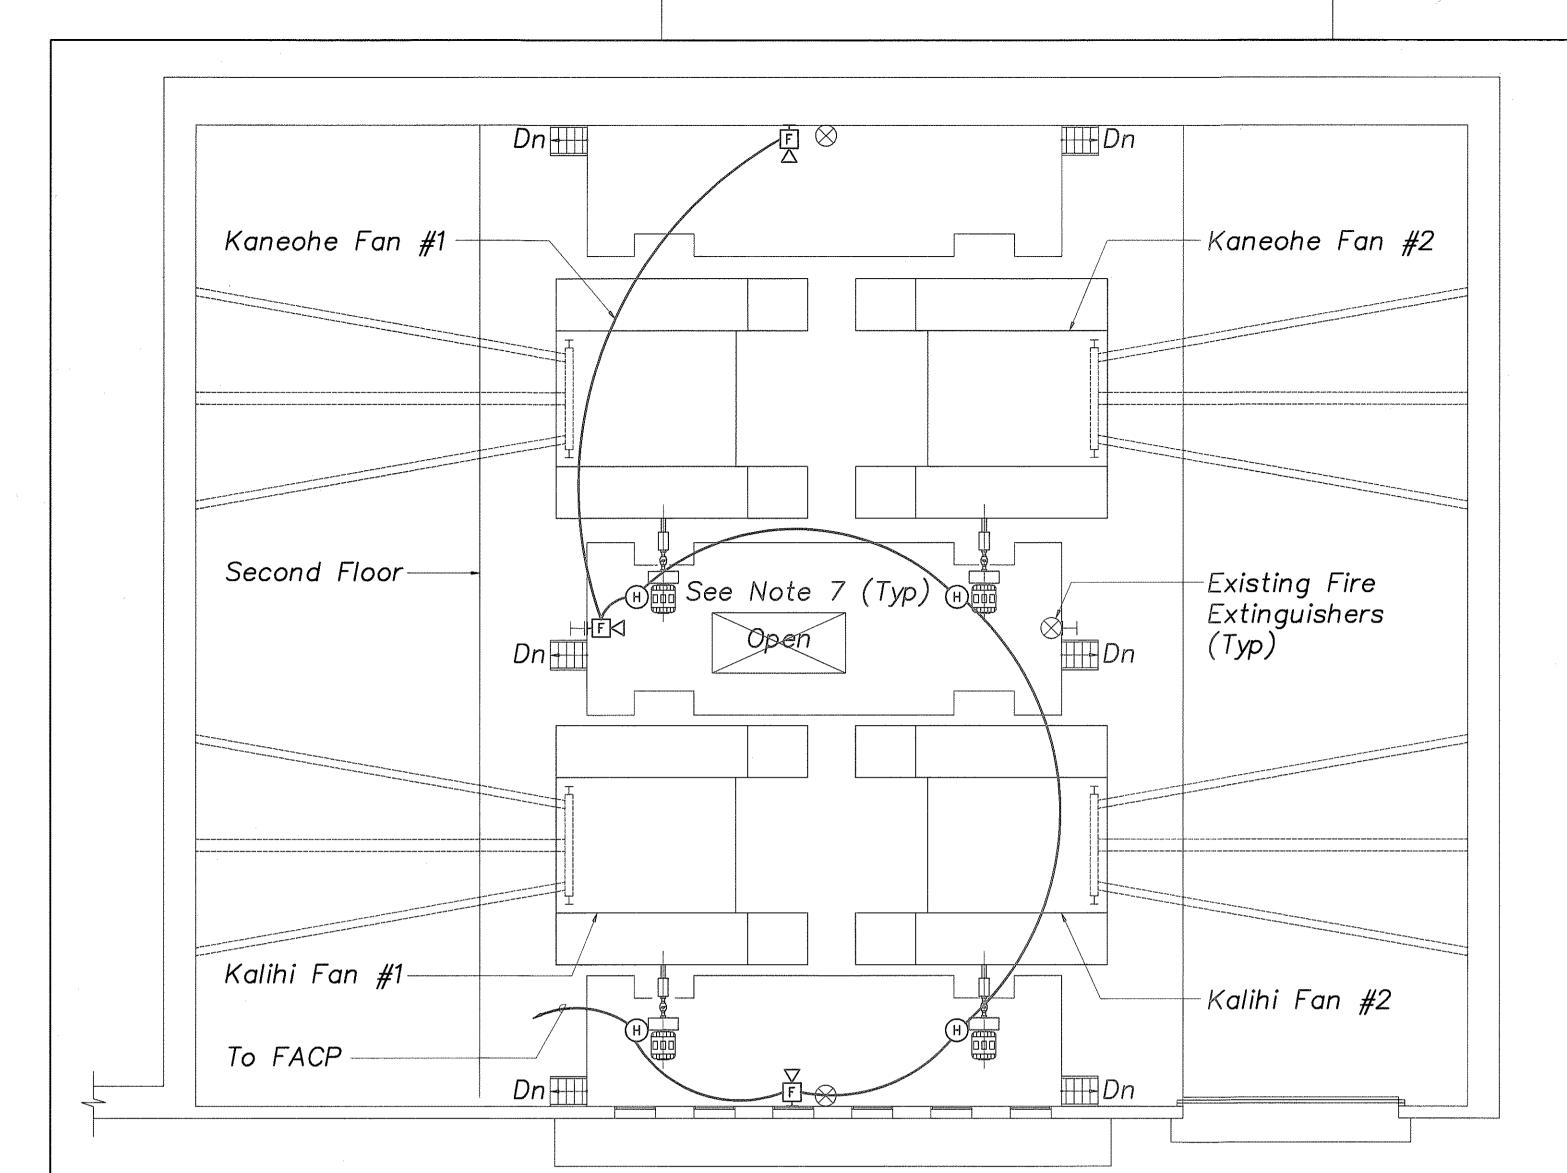

MOTOR DECK PLAN

Scale: 1/8" = 1'-0"

-Mount On Bottom Of Purlin -To FACP

NOTES:

1. All Items Shown Are New Unless Otherwise Noted.


2. All Conduits Shall Be 3/4" Minimum Unless Otherwise Noted.

- 3. Fire Alarm System Wiring (Initiating & Signaling) Shall Be #14 AWG Minimum. Verify Exact Wire Count With The Equipment Supplier.
- 4. The Fire Alarm System Shall Conform To The Requirements Of NFPA 72, The Uniform Fire Code Of The City And County Of Honolulu And The Applicable Sections Of NFPA 101.
- 5. Provide End-Of-Line Resistor Per Equipment Supplier Recommendation.
- 6. Mount Smoke Detector To Bottom Of Concrete Beams And Steel Purlins As Applicable.

- 7. Provide Minimum L2x2x1/4 Steel Support Stanchions To Locate Heat Detectors Above And To The Side Of Motors.
- 8. Provide Minimum L2x2x1/4 Steel Support Stanchions To Locate Manual Pull Śtations At +3'-6" AFF.

FIRE ALARM LEGENDS

- HE Manual Fire Alarm Station, +3'-6" AFF
- IE⊲ Fire Alarm Audio/Visual Signaling Device, +6'-8" AFF
- © Smoke Detector, Ceiling Mounted
- Rate Of Rise Heat Detector, Ceiling Mounted (sec note 7)
- Monitor Module
- Junction Box
- End Of Line Resistor
- Fire Alarm Control Panel (FACP), +6'-0" AFF To Top Of Panel
- Exposed Conduit And Wiring
- Homerun To Fire Alarm Control Panel

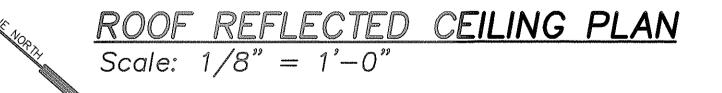



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DEPARTMENT OF TRANSPORTATION MOTOR DECK & ROOF

PROJ. NO.

HAWAII HAW. HWY-0-21-98M


2001

FIRE ALARM PLANS & NOTES WILSON TUNNEL IMPROVEMENTS


SCADA UPGRADE PROJECT NO. HWY-0-21-98M Date: JULY 2000 Scale: As Noted

SHEET No. FP-3 OF FP-4 SHEETS


"AS-BUILT",

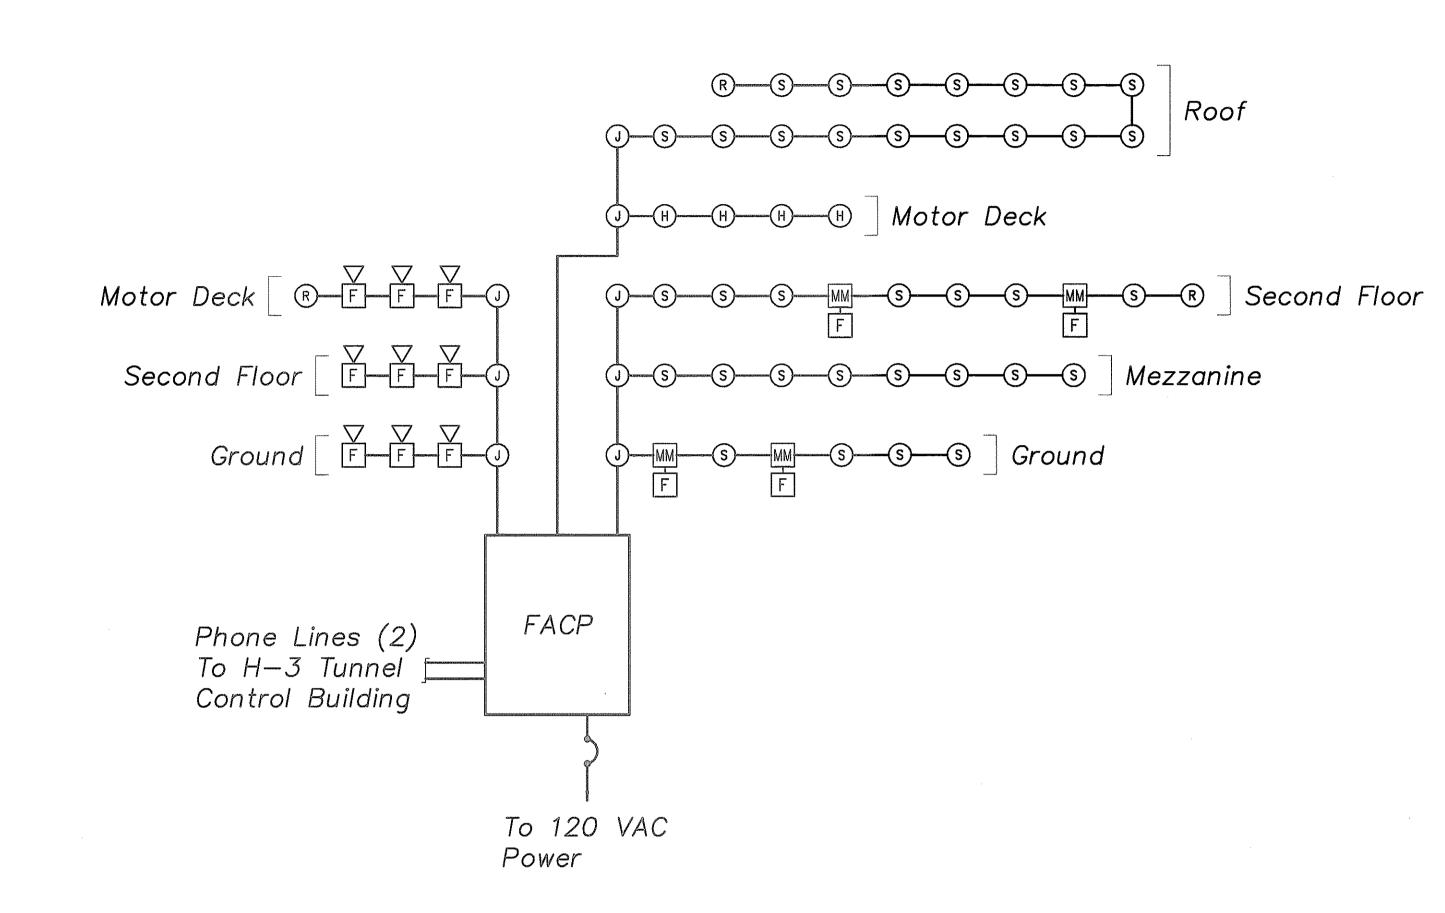

FIRE ALARM RISER DIAGRAM
Scale: None

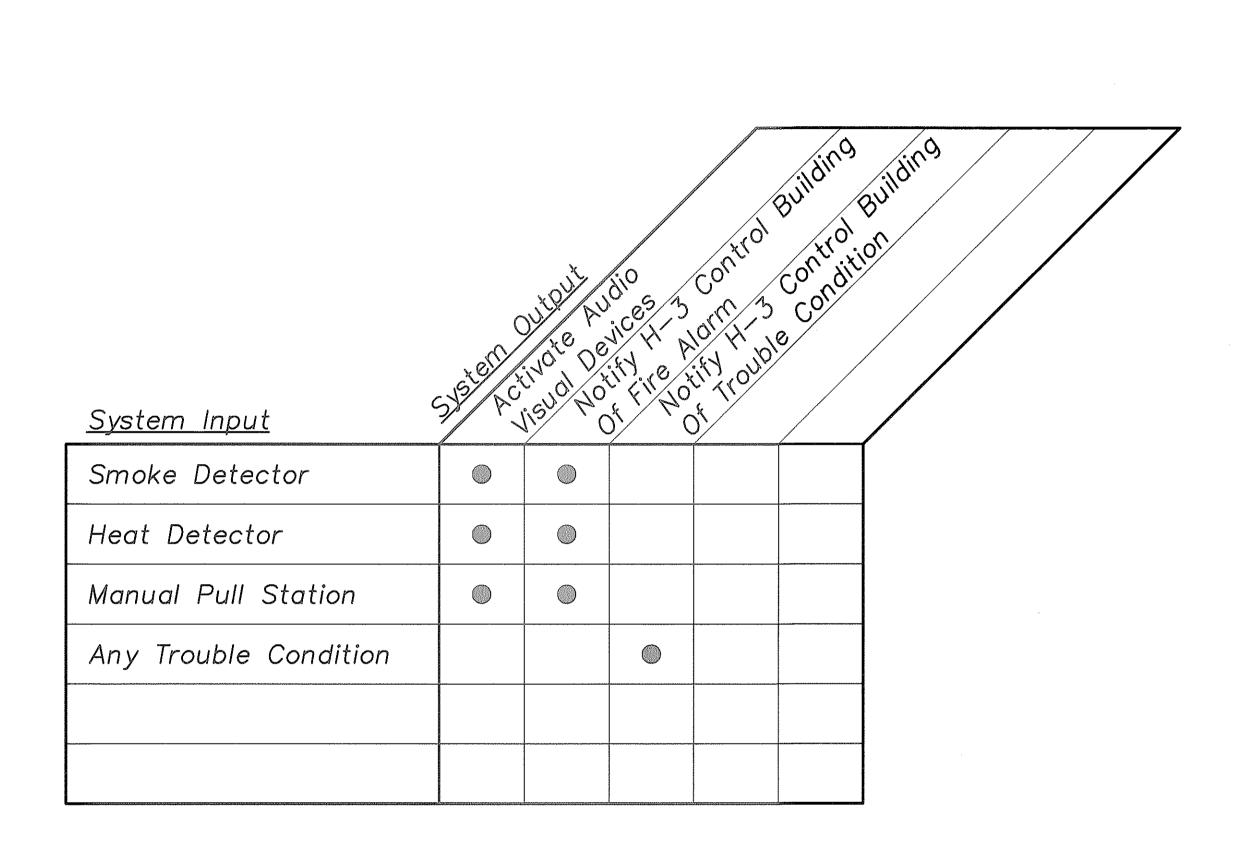

FIRE ALARM MATRIX

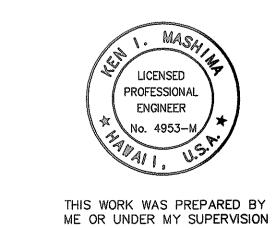

DEPARTMENT OF TRANSPORTATION
HIGHWAYS DIVISION
FIRE ALARM RISER
DIAGRAM & MATRIX

WILSON TUNNEL IMPROVEMENTS
SCADA UPGRADE

PROJECT NO. HWY-0-21-98M
Scale: As Noted Date: JULY 2000

SHEET No. FP-4 OF FP-4 SHEETS

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18

NOTEBOOK DESIGNED BY

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