



## ONE-LINE DIAGRAM

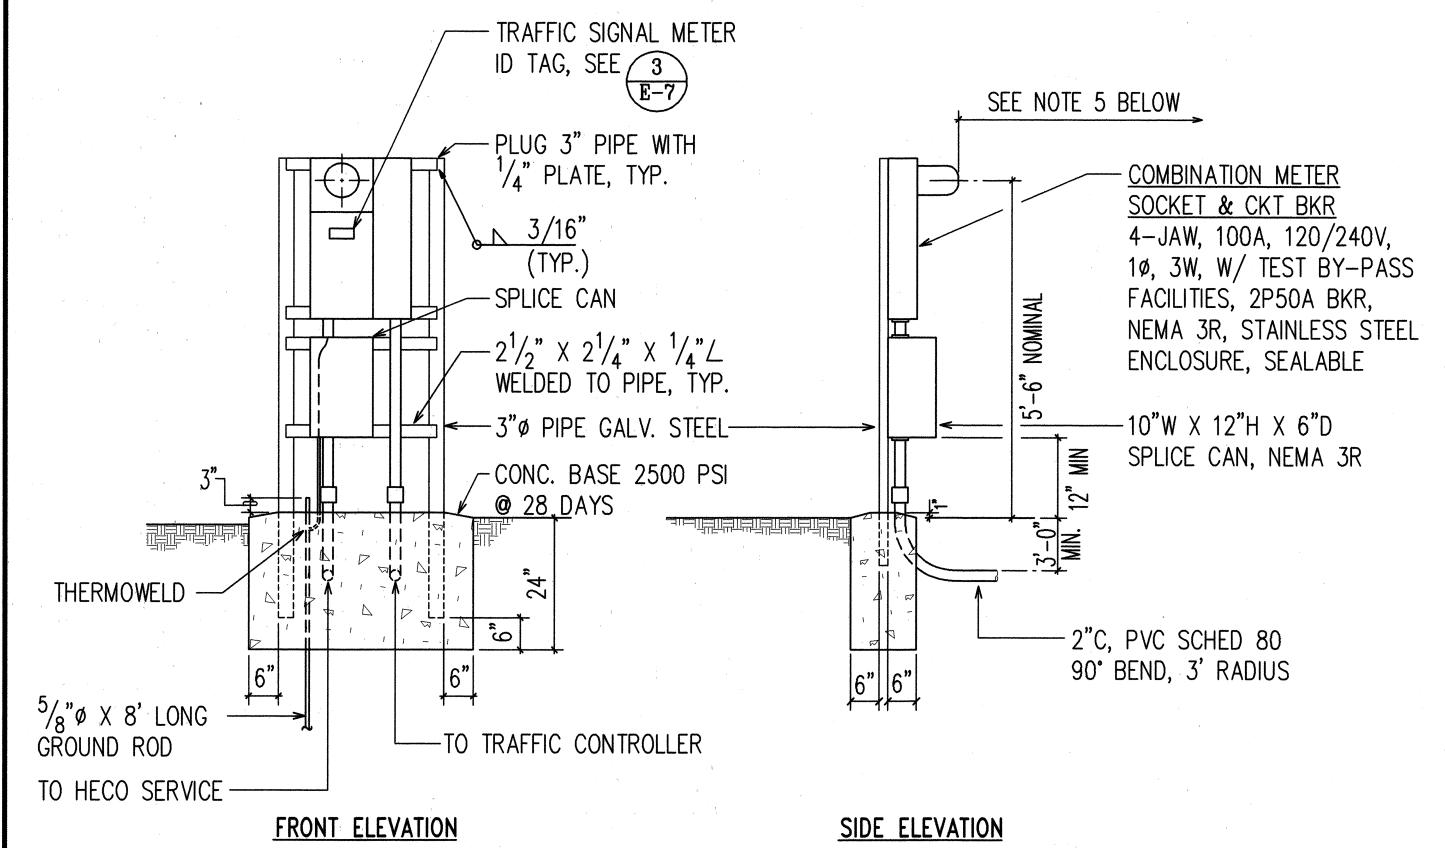


NOTES: 1. ALL CONDUITS TO CONTAIN A POLYOLEFIN PULL LINE (JET LINE CAT #232 OR EQUIV)

- 2. THE INSTALLATION OF THE METER PEDESTAL FOR UNDERGROUND SERVICE WILL NOT BE PAID FOR SEPARATELY BUT CONSIDERED INCIDENTAL TO THE METER SOCKET AND BREAKER.
- 3. PEDESTAL SHALL BE HOT-DIPPED GALVANIZED AFTER FABRICATION.
- 4. ALL FASTENING BOLTS, NUTS & WASHERS SHALL BE STAINLESS STEEL.
- 5. PROVIDE 4 FT CLEARANCE IN FRONT OF METER.

2 ELECTRICAL SERVICE DETAIL E-7 NOT TO SCALE

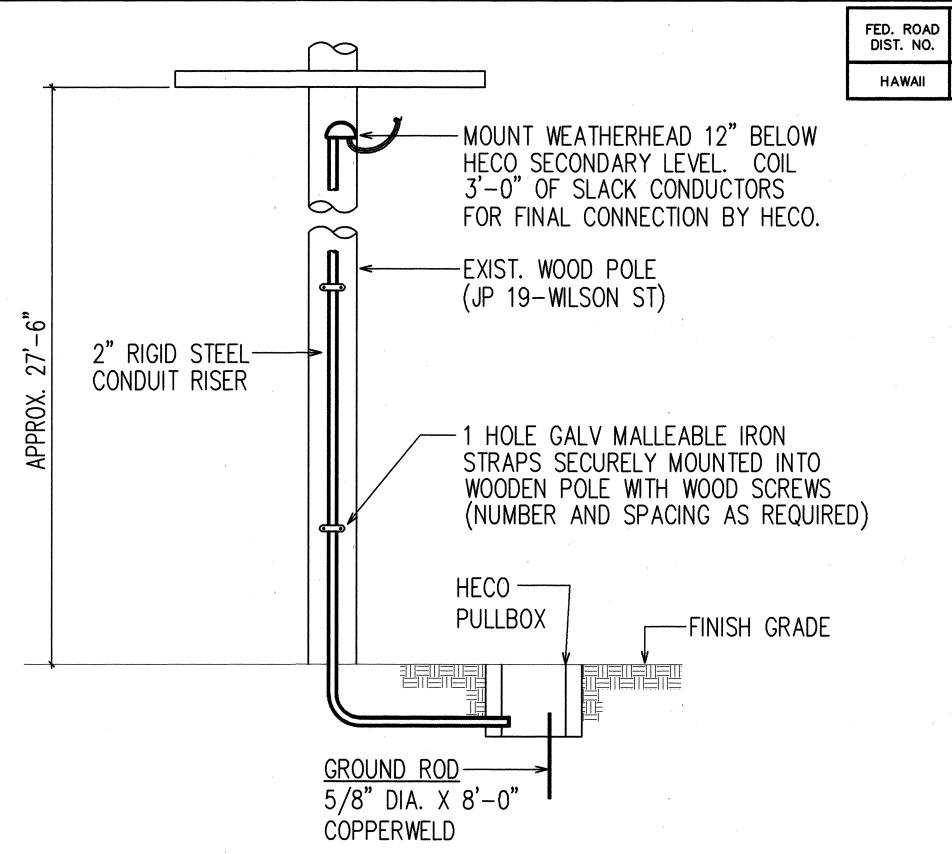

1 NEW CONDUIT RISER ON EXIST WOOD POLE E-7 NOT TO SCALE

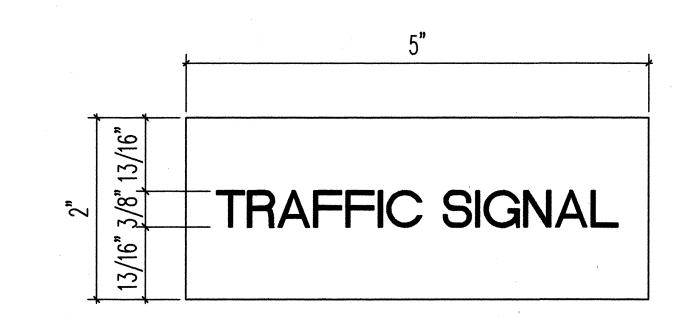

- NOTES: 1. USE 3-PLY LAMINATED FLEXIBLE PLASTIC, BLACK-WHITE-BLACK THICKNESS: BLACK CAP SHEET - 0.010", WHITE BASE SHEET - 0.052", BLACK BASE SHEET - 0.010".
  - 2. ATTACH TO METER SOCKET USING SCOTCH 3M BRAND VERY HIGH BOND (VHB) DOUBLE COATED ACRYLIC FOAM TAPE OR EQUIVALENT.
  - 3. LETTERS/NUMBERS SHALL BE 3/8" HIGH, 1/16" STROKE (WHITE IN COLOR).
  - 4. LETTERS/NUMBERS AREA INSCRIBED BY CUTTING THROUGH "BLACK CAP SHEET" TO EXPOSE WHITE LETTERS/NUMBERS.

3 METER ID TAG DETAIL E-7 NOT TO SCALE



2/0/97

andrew J. Migasak 2/6/91

LICENSED PROFESSIONAL **ENGINEER** 

STATE OF HAWAII
DEPARTMENT OF TRANSPORTATION
HIGHWAYS DIVISION

ONE-LINE DIAGRAM, ELECTRICAL

SERVICE EQUIPMENT

LIKELIKE HIGHWAY Inters. Improvements at Alu St.

PROJECT NO. 63A-02-96 SCALE: AS NOTED

DATE: FEB 1997 SHEET No. E-7 OF E-13 SHEETS

SHEET NO.

TOTAL SHEETS

FISCAL YEAR

STATE

HAW.

PROJ. NO.

63A-02-96