


TYPICAL SECTION SCALE: 1/2" = 1'-0"

EROSION CONTROL MATTING (ECM) NOTES:

- Remove existing vegetation, install topsoil as required, fine grade, hydromulch and grass prior to installing the erosion control matting.
- 2. The Contractor shall obtain acceptance of the prepared surface from the Engineer prior to installing the erosion control matting.
- 3. The erosion control matting shall be installed in accordance with the manufacturer's recommendations unless otherwise indicated on the plans or as directed by the Engineer.
- 4. Metal (wire) staples will not be permitted. All stakes shall be made of treated wood to the length and shape as recommended by the manufacturer of the erosion control matting and accepted by the Engineer.
- 5. As directed by the Engineer, treated wood stakes with lengths 12-inches or greater shall be used in loose soil conditions to properly secure the erosion control matting at no additional cost to the State.

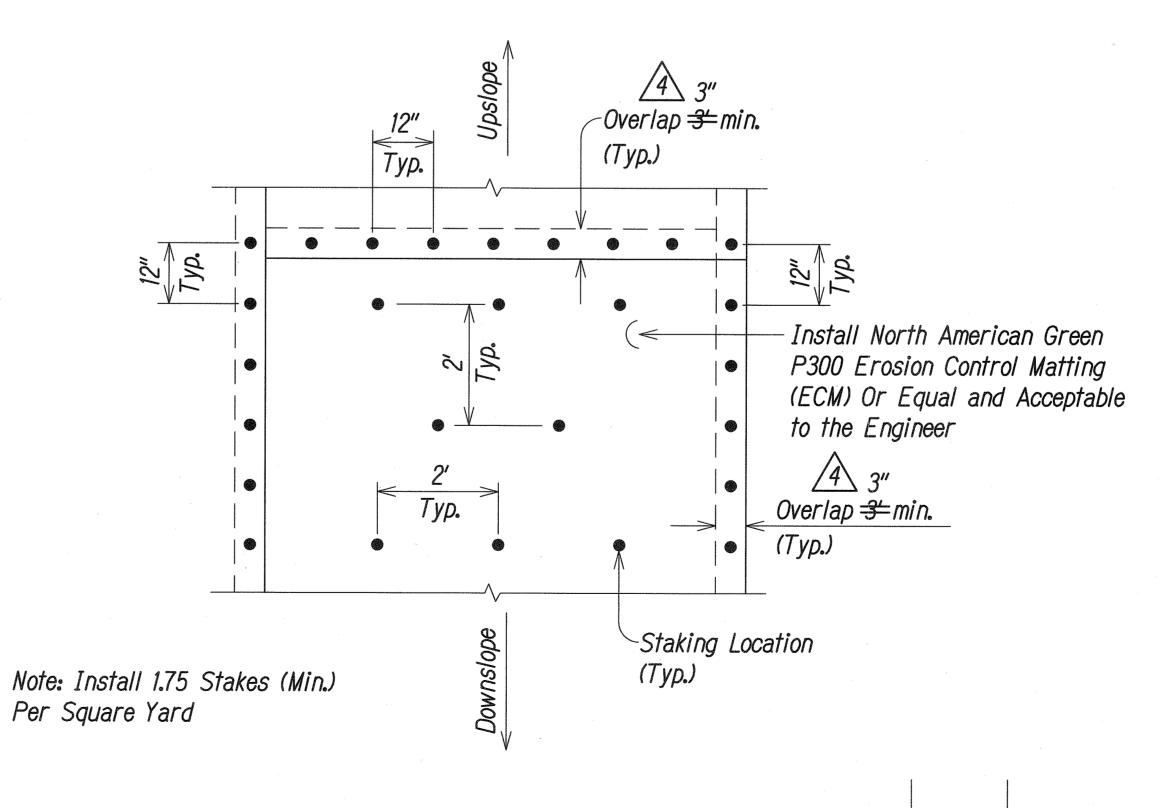

ECM STAKING PATTERN DETAIL NOT TO SCALE

10/29/12 Revised ECM Overlap Dimension. DATE

PROFESSIONAL **ENGINEER** No. 8297−C

THIS WORK WAS PREPARED BY ME OR UNDER MY SUPERVISION.

Runce Marketi APRIL 30, 2014
LIC. EXP. DATE ParEn, Inc. dba PARK ENGINEERING

STATE OF HAWAI'I DEPARTMENT OF TRANSPORTATION HIGHWAYS DIVISION

<u>DETAILS</u>

CASTLE HILLS ACCESS ROAD

Drainage Improvements, Phase 2 FEDERAL-AID PROJECT NO. STP-0300(125)

Scale: As Shown

Date: December 2011

ADD. 27

SURVEY PLOTTE
DRAWN BY_____
TRACED BY____
DESIGNED BY___
QUANTITIES BY_ ORIGINAL PLAN NOTE BOOK

> REVISION SHEET No. C8.1 OF C8.1 SHEETS