GENERAL NOTES:

1. All Work Shall be Constructed in Accordance With the Following Construction Standards and specifications:

Construction Standards of Department of Transportation, State of Hawaii, 2005.


Current Standards Specifications for Road and Bridge Construction, State of Hawaii.

- 2 It is Not the Intent of These Plans and Specifications to Indicate That All Existing Utilities are Shown on the Plans. The Information on the Existing Utilities are Based on Available Plans. The Locations are Approximate only and the Contractor Shall Verify the Location and Depth of the Facilities and Exercise Proper Care in Excavating in This Area. All Existing Utilities Whether or Not Shown on the Plans Shall be Protected at All Times by the Contractor. The Contractor Shall be Responsible for Any Damages to the Facilities Whether Shown or Not Shown on Plans. Any Repair Work Shall be Provided at No Additional Cost to This Project.
- 3. Exercise Proper Care When Excavating in Areas With Existing Underground Facilities. Damages to the Existing Facilities Shall be Immediately Reported to the Respective Utility Companies, City or State Agency. The Repair Work Shall be Provided at No Additional Cost to the Project.
- 4. All Saw Cutting Work Shall be Considered Incidental to the Various Contract Items.
- 5. For Typical Construction Details Not Shown on Plans, Refer to Applicable Standard Details of Construction and Maintenance Services, Department of Transportation, State of Hawaii.
- 6. Extra Care Shall be Taken While Excavating for the Pullboxes and Ductlines. Contractor Shall Tone for Location of Utility Lines Prior to Excavation.
- 7. Furnish and Install a Minimum Two Each TORX T-27 Tamper-Proof Screws per Pullbox Cover Section In Accordance With State DOT Highways Requirements.

ELECTRICAL SYMBOLS LIST


Pullbox/Handhole Key Note Indicator Underground Ductline


DUCT DESIGNATION

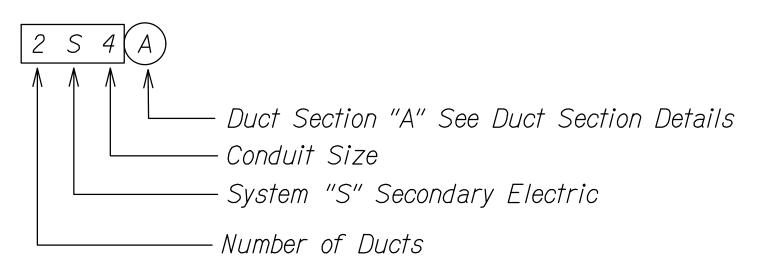

PULLBOX, HANDHOLE SCHEDULE

(105) State Highways Electrical Pullbox, Type C, See State DOT Standard Plan TE-37 and General Note 7. Provide Re-inforced Concrete Collar Ring Around the Perimeter of Pullbox, See

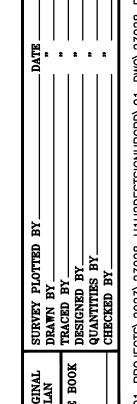

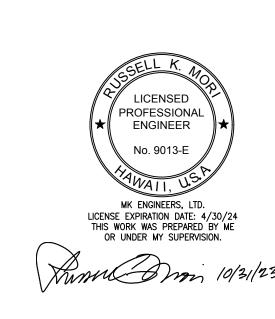

STATE OF HAWAI'I DEPARTMENT OF TRANSPORTATION ELECTRICAL SYMBOLS \$ NOTES

INTERSTATE ROUTE H-1 AND H-201 DESTINATION SIGN UPGRADE/REPLACEMENT, PHASE 3B FAP NO. NH-0300(205)

Scale: As Noted

FED. ROAD DIST. NO.

STATE


FEDERAL AID PROJ. NO.


HAWAII | HAW. | NH-0300(205) | 2024 | 190 | 197


FISCAL YEAR


SHEET TOTAL NO. SHEETS

Date: Oct. 2023 SHEET No. E0.1 OF 8 SHEETS

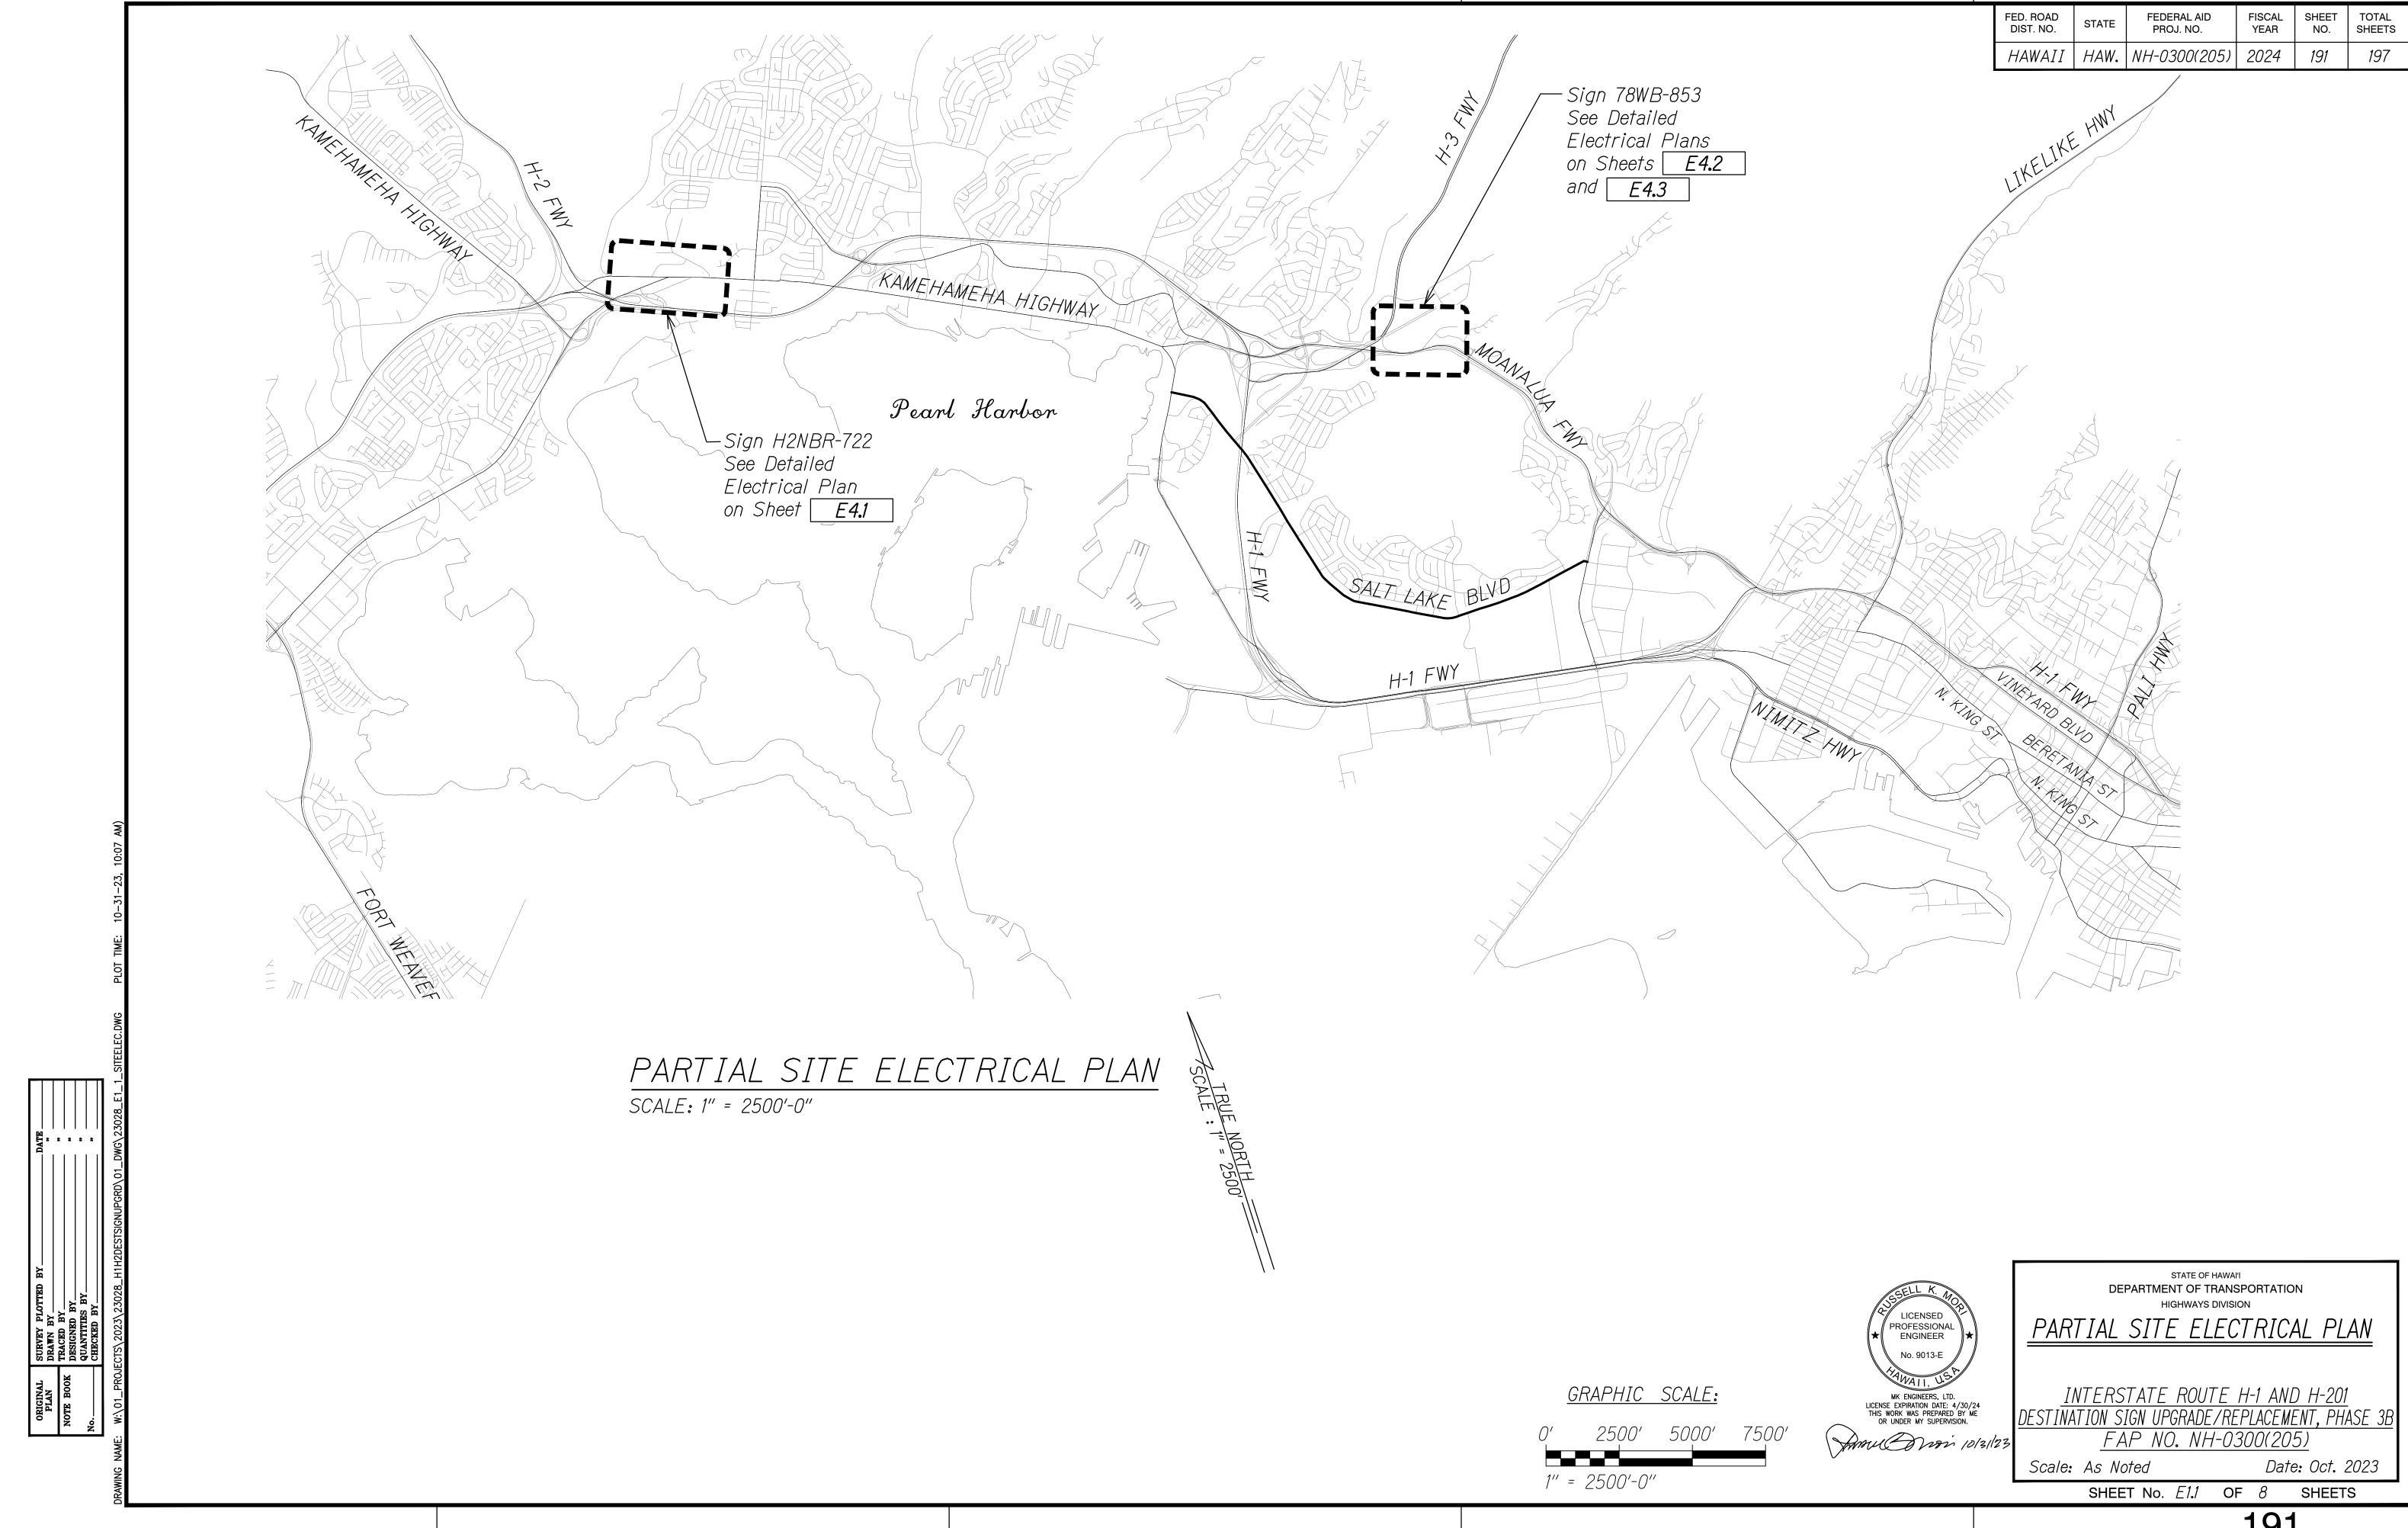


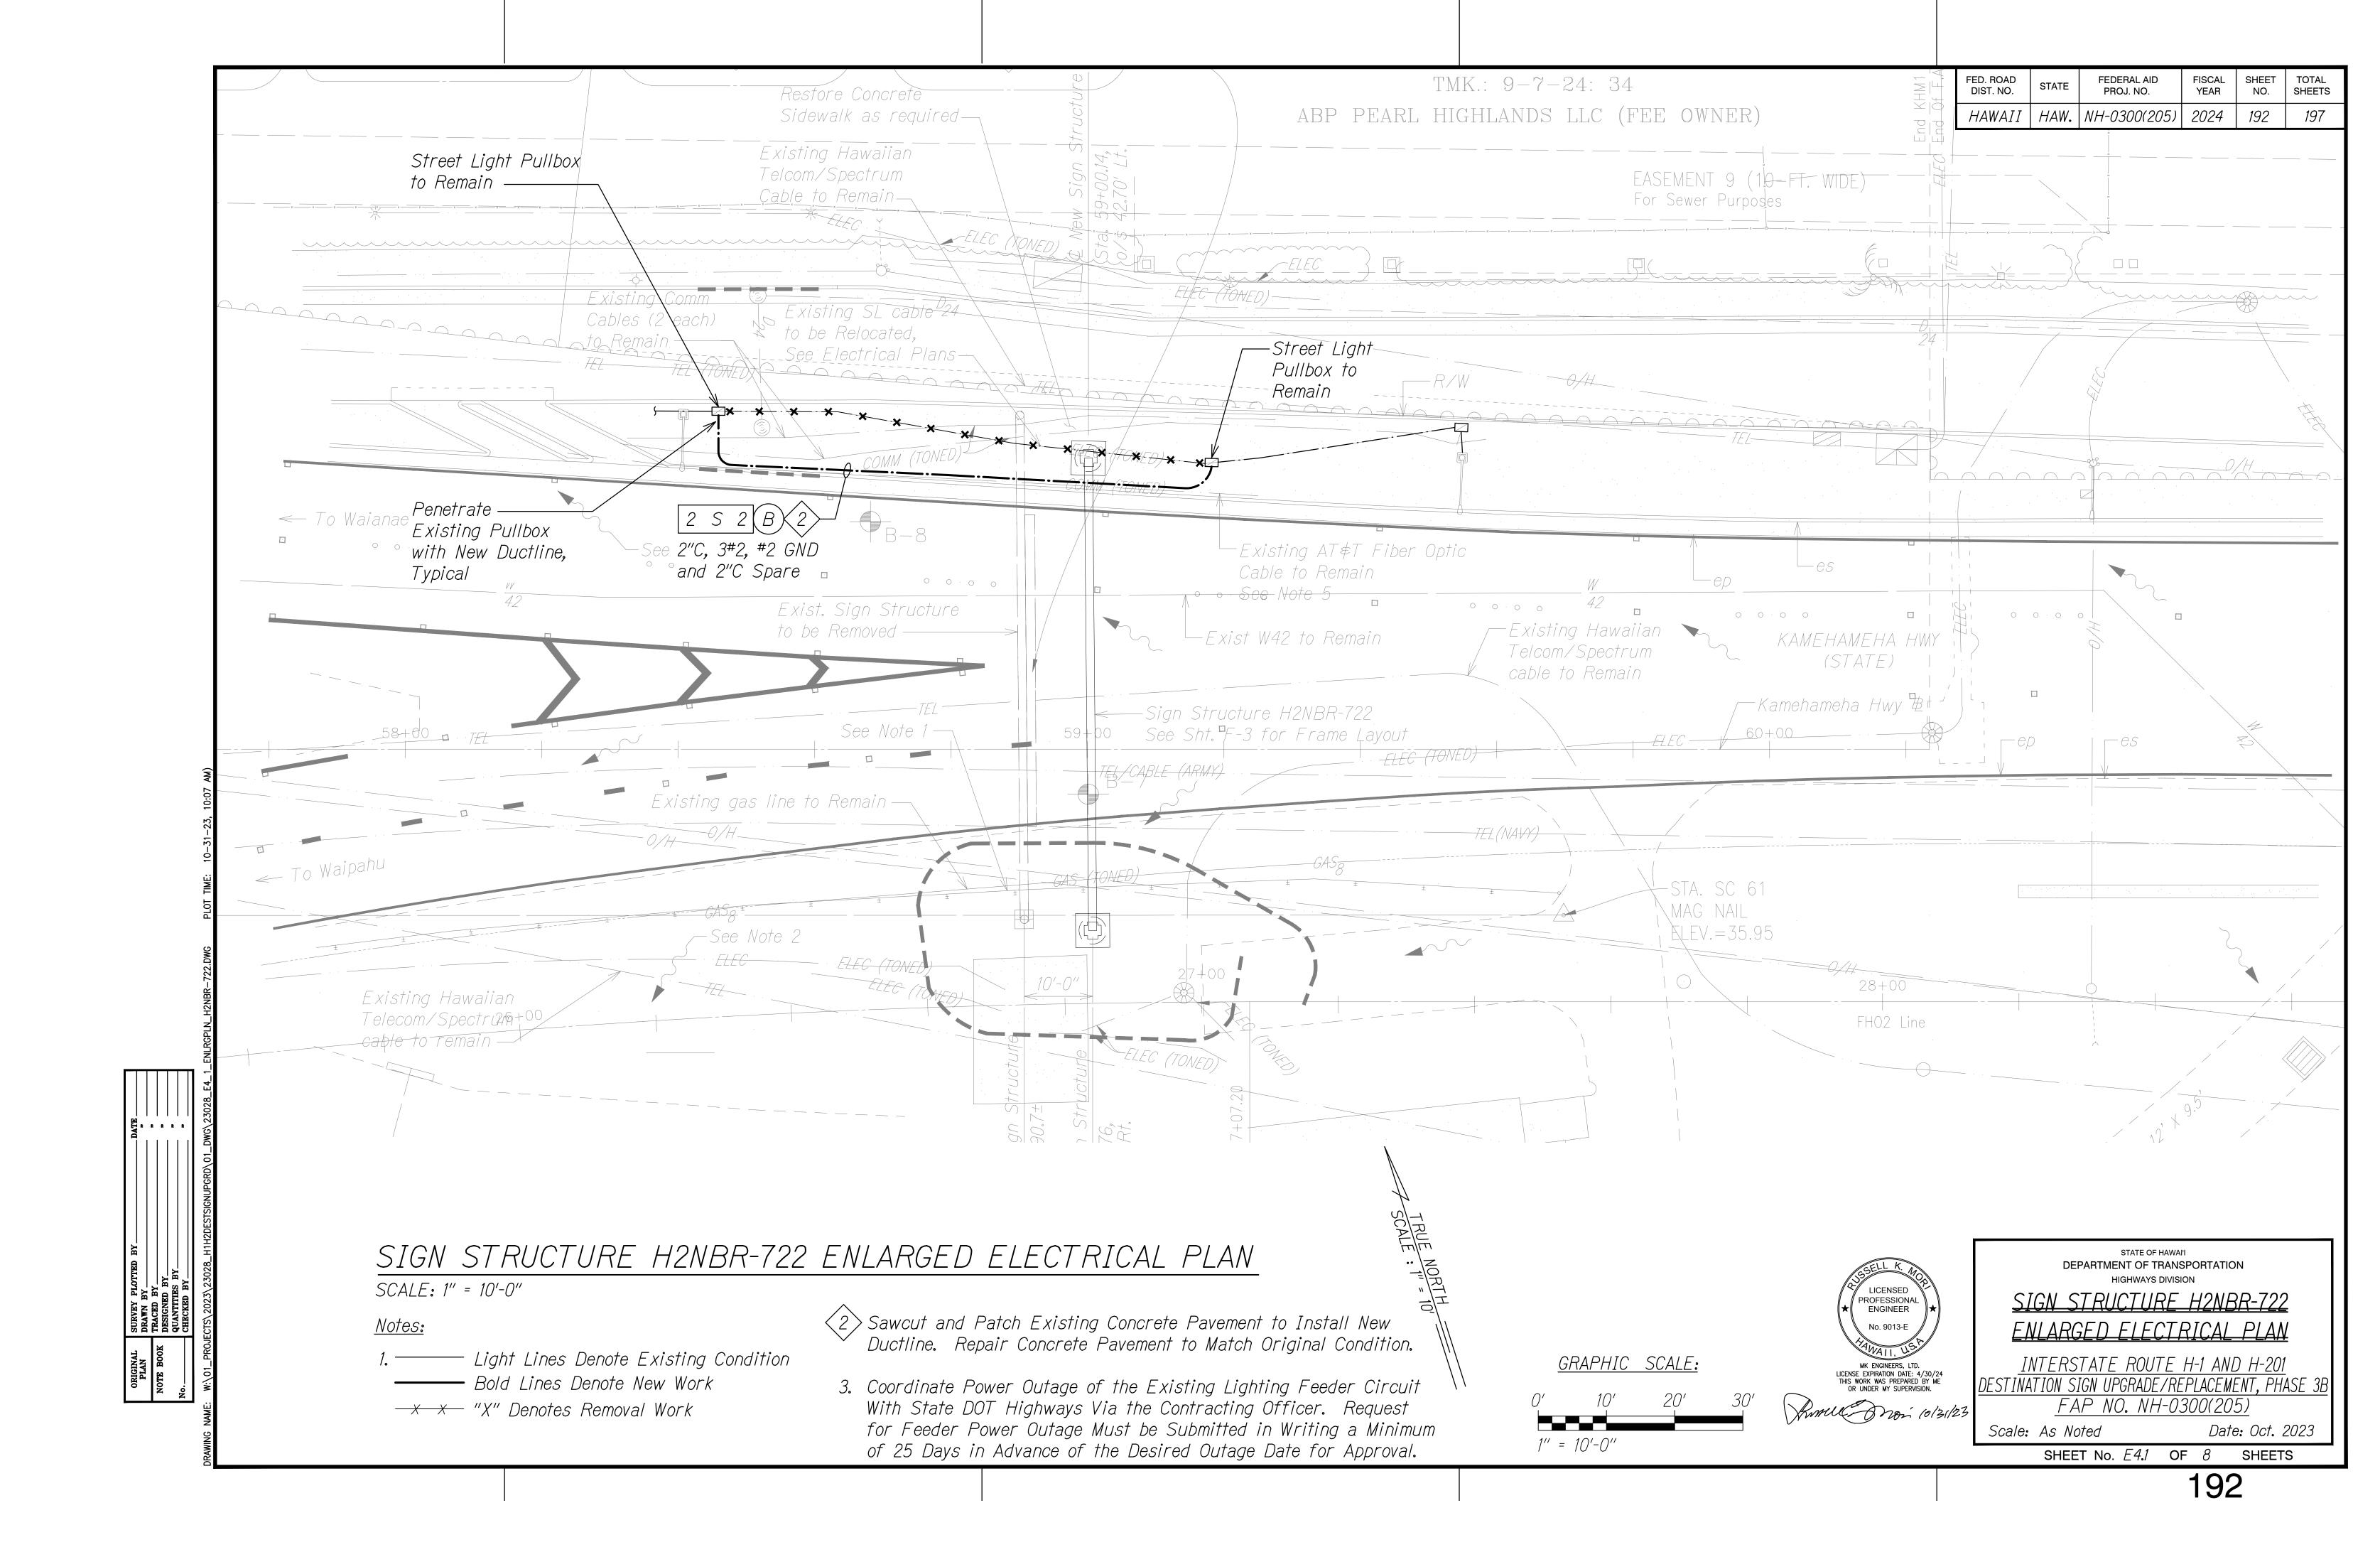

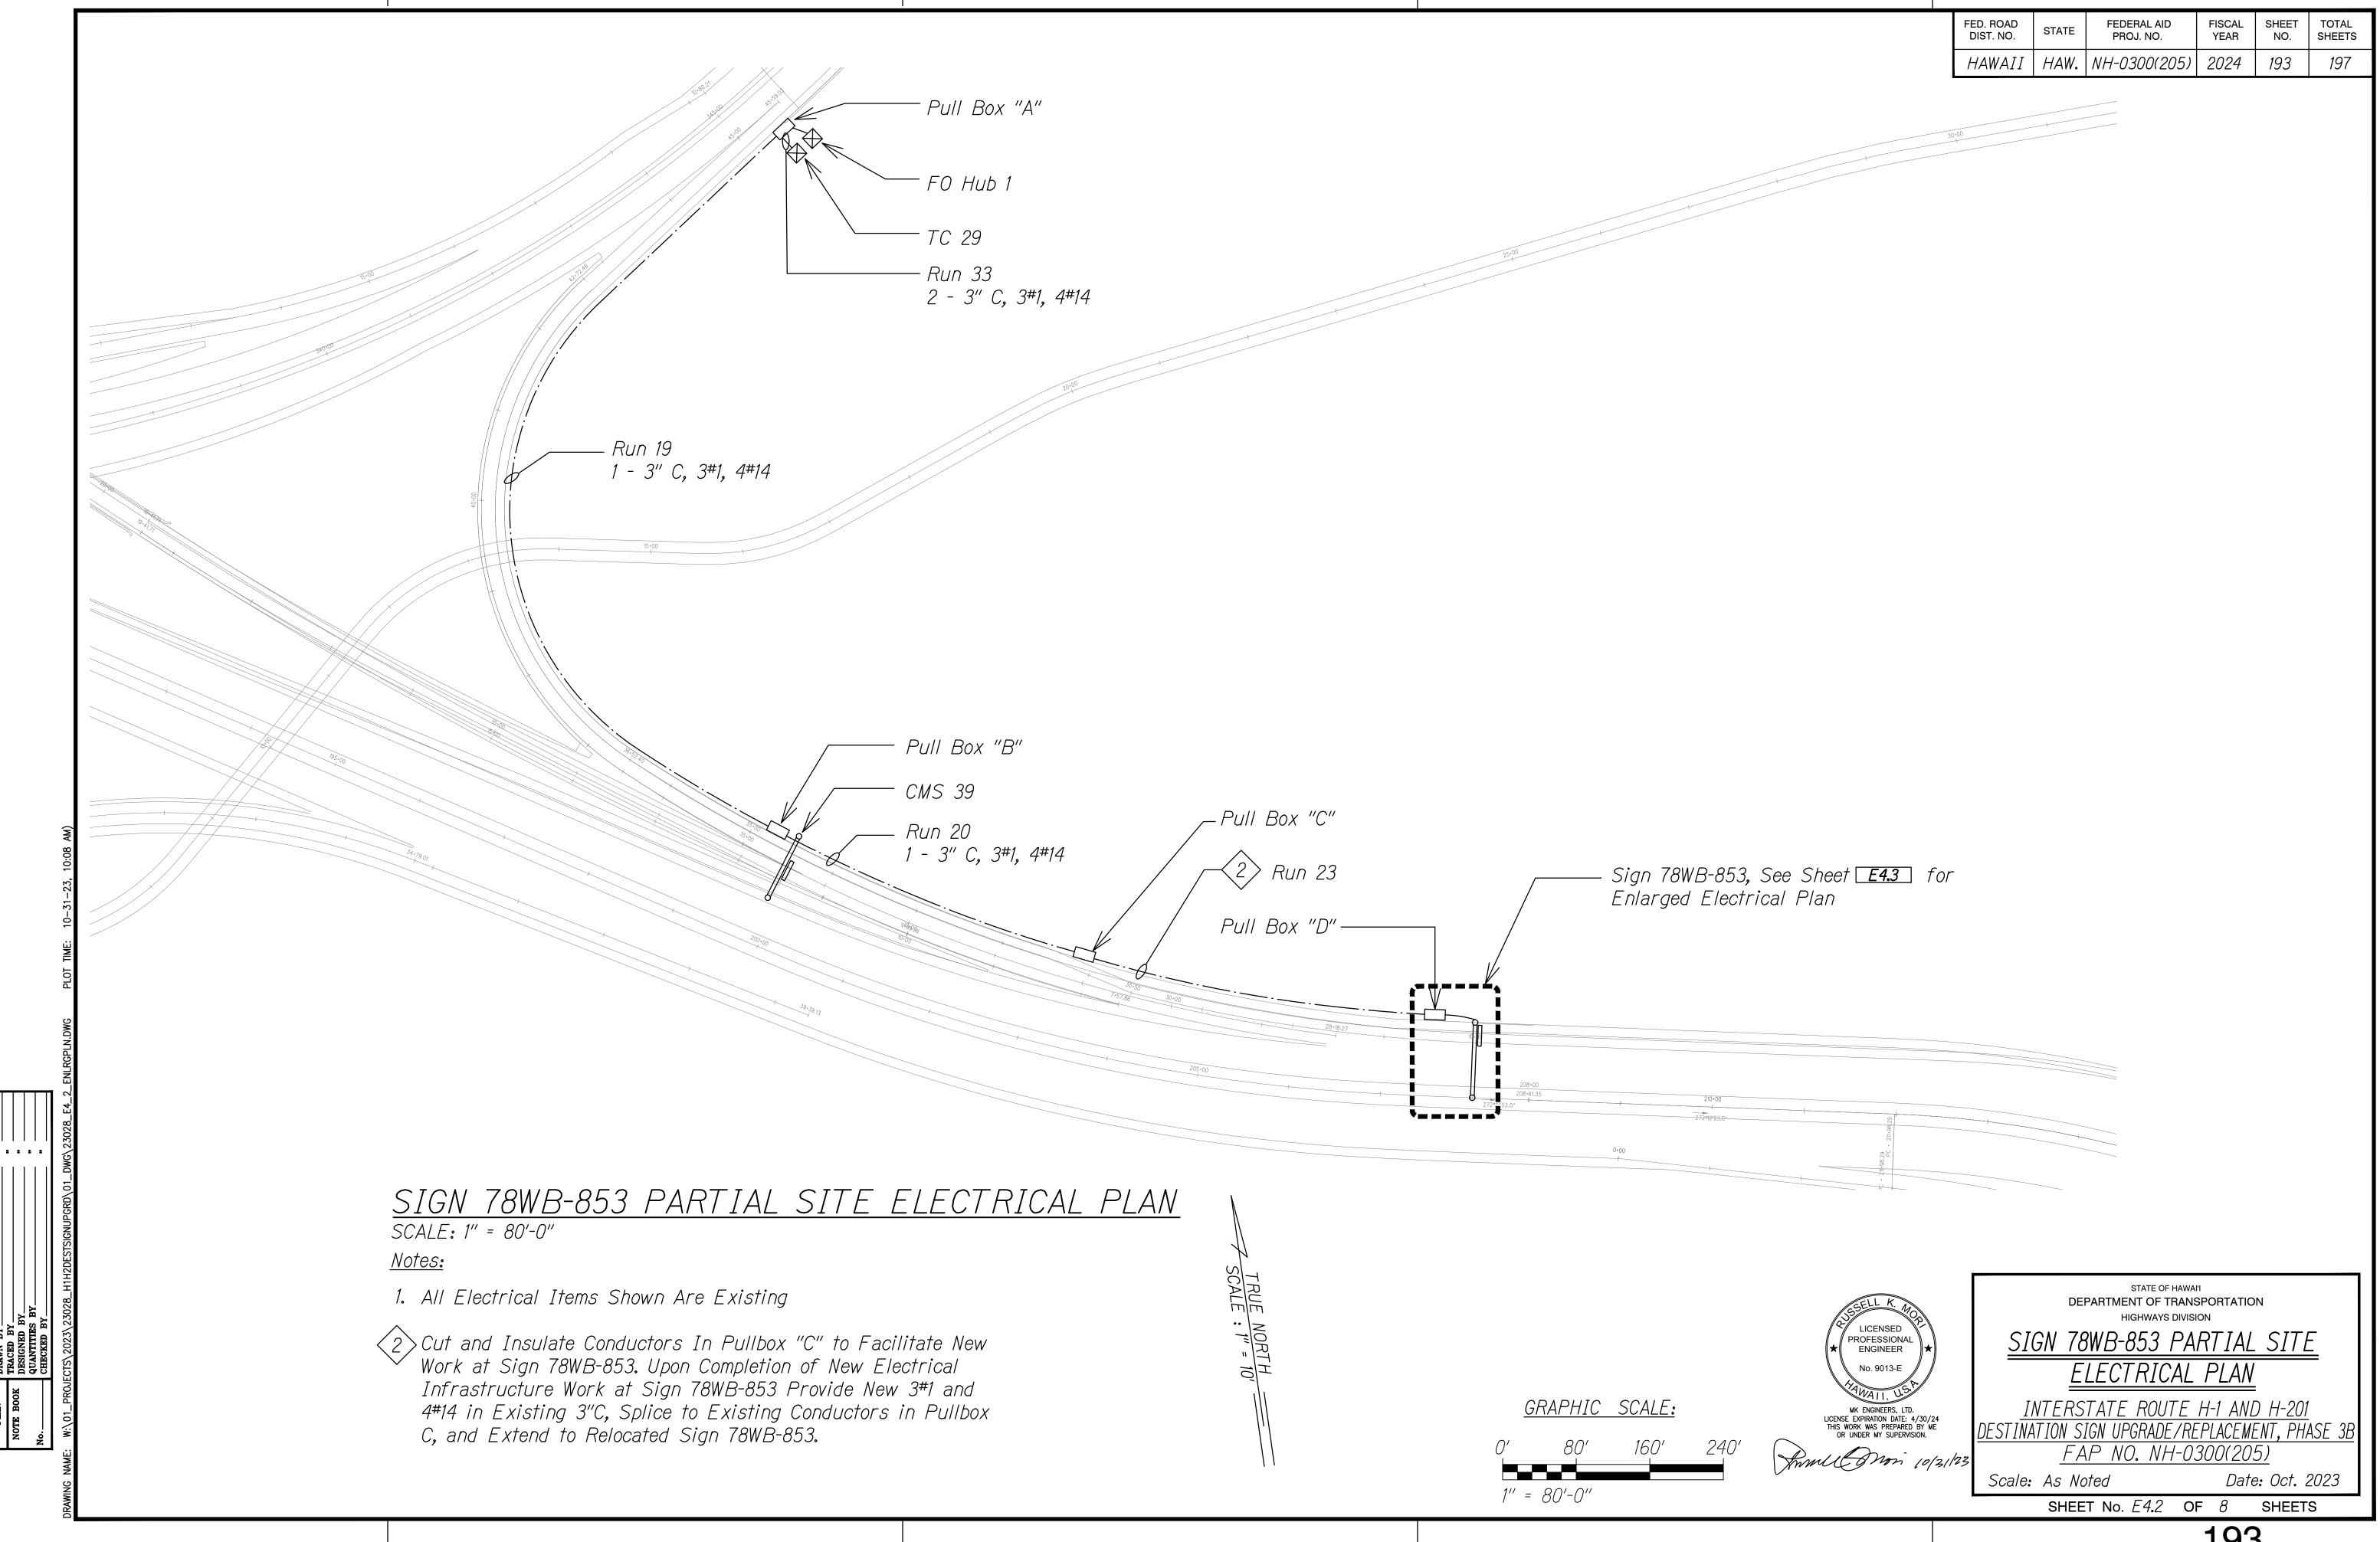

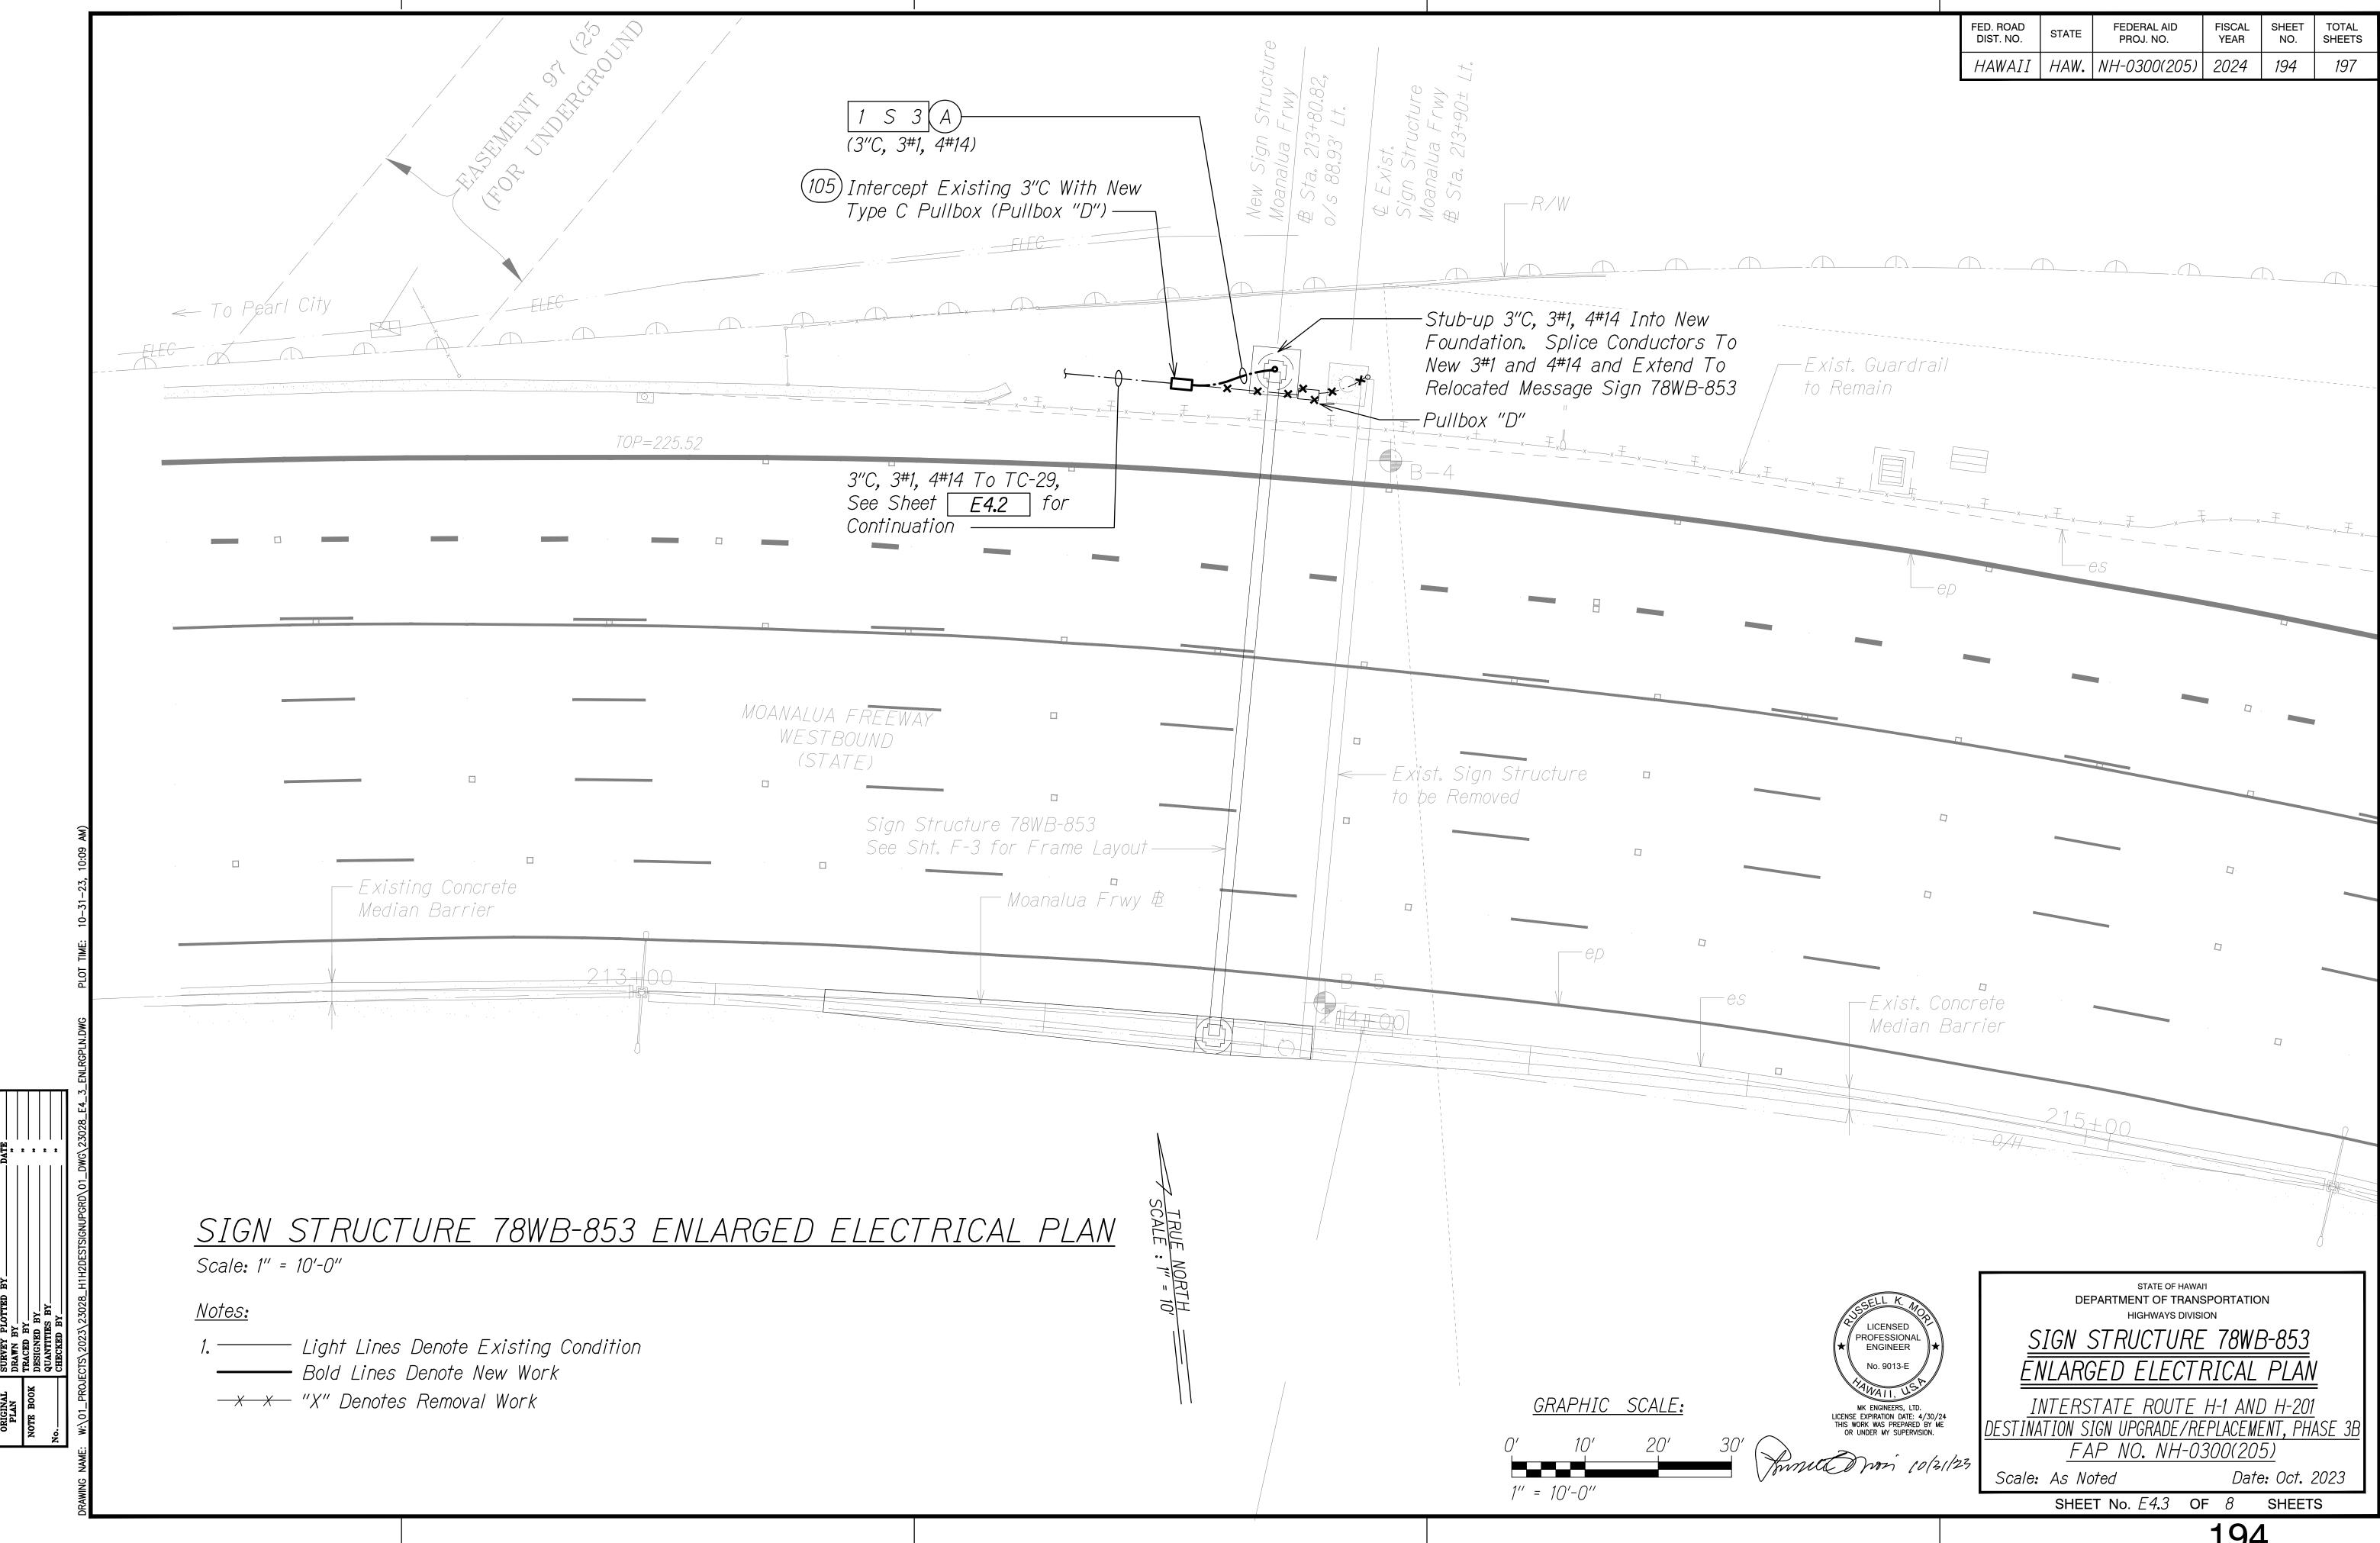

FED. ROAD	STATE	FEDERAL AID	FISCAL	SHEET	TOTAL
DIST. NO.		PROJ. NO.	YEAR	NO.	SHEETS
HAWAII	HAW.	NH-0300(205)	2024	195	197

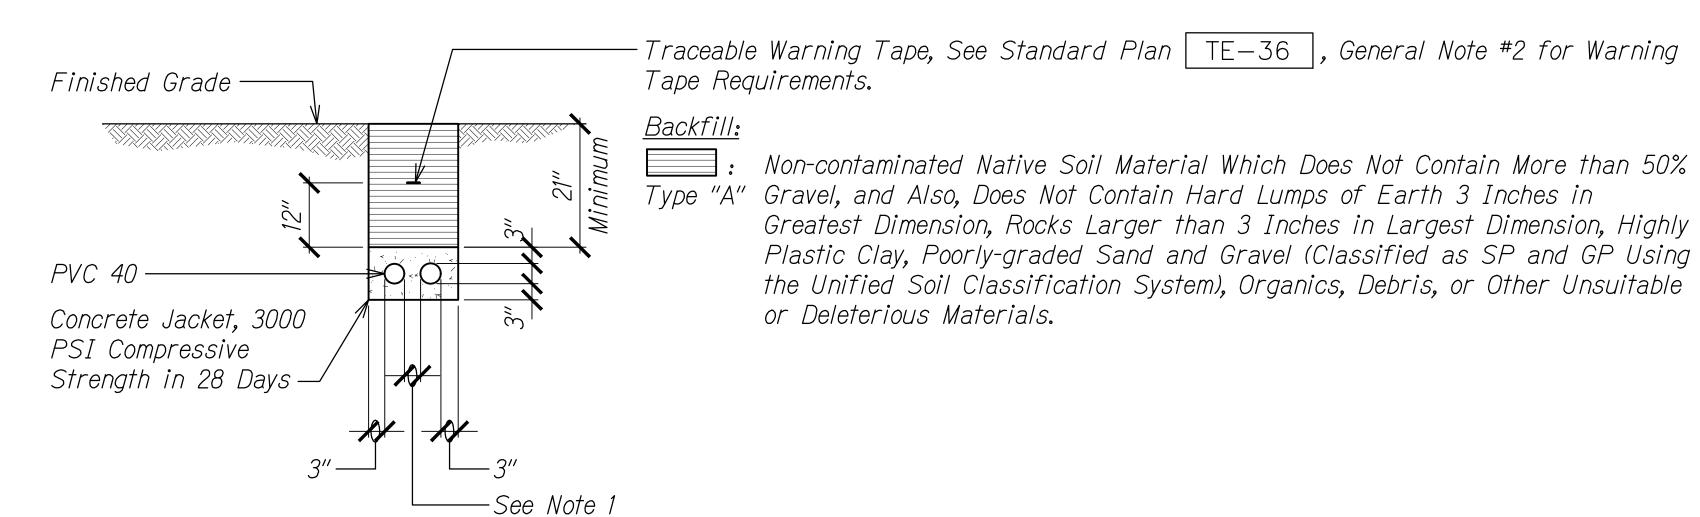


3.1 E 3.1 IV


TYPICAL DUCT SECTION (CONCRETE ENCASED) FOR UNPAVED AREAS


Not To Scale

Notes:

- 1. Provide 2" Separation between Ducts of Same System and 3" between Ducts of Different Systems.
- 2. Where Trench Encounters Grass or Landscaping, Provide 4" Top Soil After Trench is Backfilled, and Restore Landscaping to Match Existing Adjacent Area.
- 3. See Duct Section Details for Conduit Arrangement.

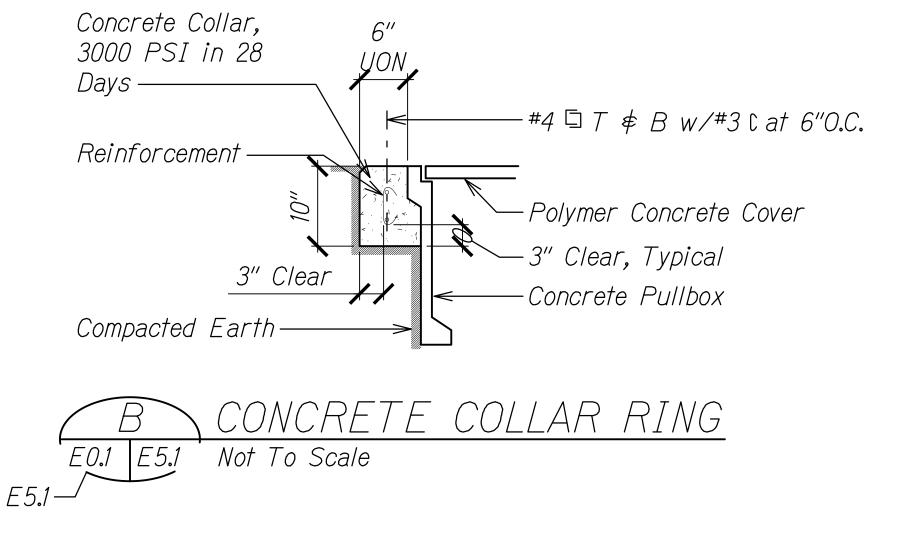

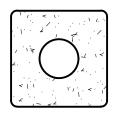

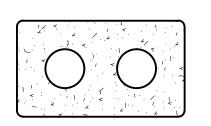


SECTION (A)

SECTION (B)

DUCT SECTION DETAILS

Not To Scale

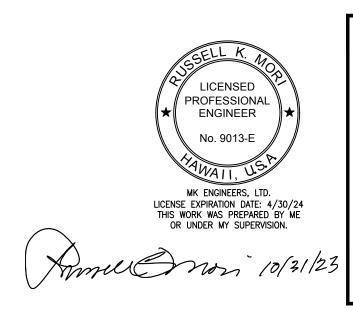

STATE OF HAWAI'I
DEPARTMENT OF TRANSPORTATION
HIGHWAYS DIVISION

<u>DUCT SECTION DETAILS</u>


<u>INTERSTATE ROUTE H-1 AND H-201</u> DESTINATION SIGN UPGRADE/REPLACEMENT, PHASE 3B FAP NO. NH-0300(205)

Scale: As Noted

Date: Oct. 2023

SHEET No. *E5.1* OF 8 SHEETS

FED. ROAD DIST. NO.	STATE	FEDERAL AID PROJ. NO.	FISCAL YEAR	SHEET NO.	TOTA SHEE
HAWAII	HAW.	NH-0300(205)	2024	196	197

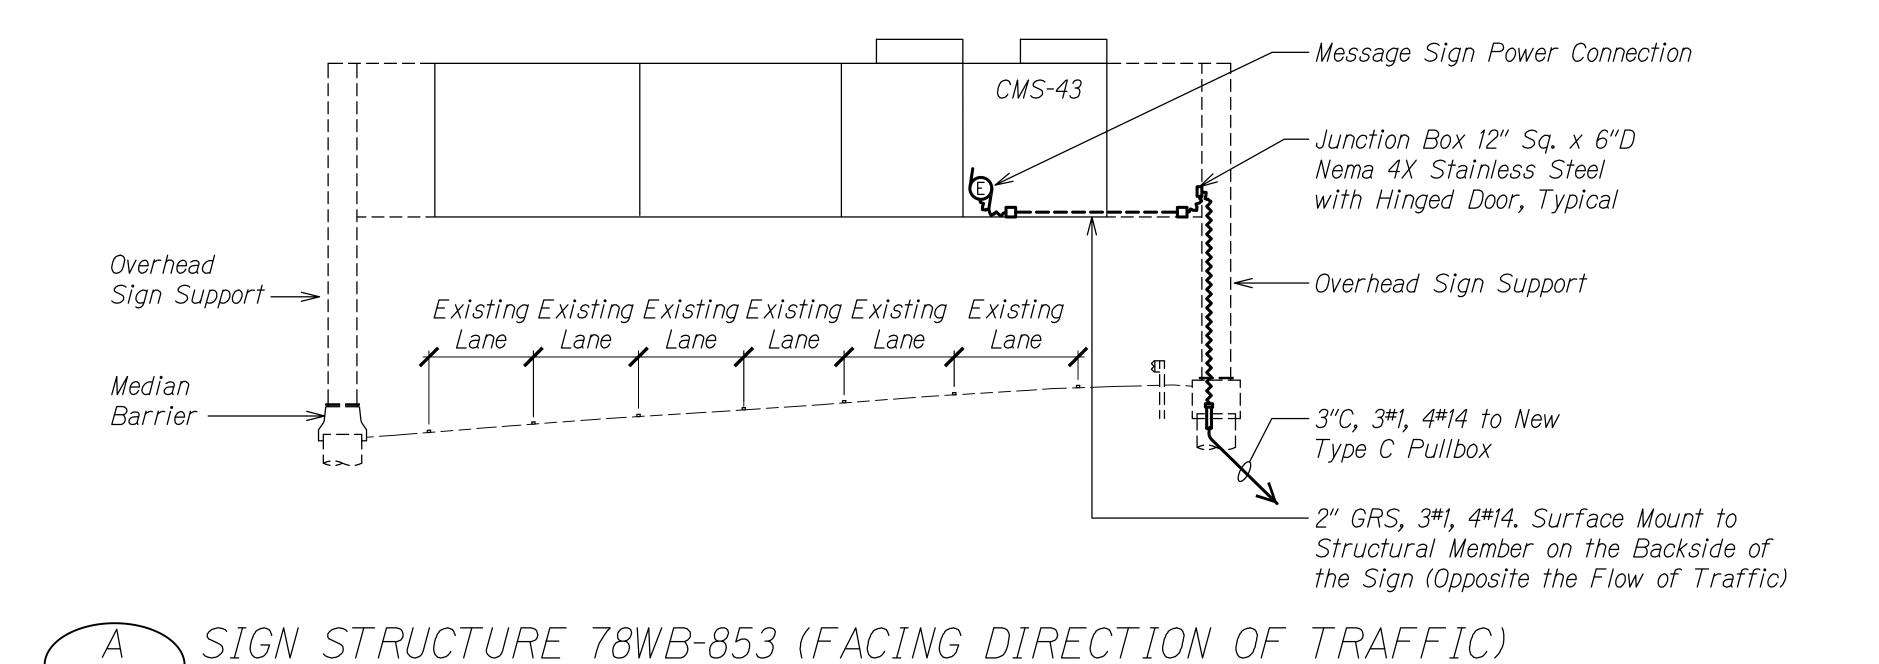

Notes:

Scale: 1" = 10'-0"

- 1. See Sht. D-6 for Sign Panel Details.
- 2. See Sht. S7.1 for Structural Plans.

PROFESSIONAL ENGINEER MK ENGINEERS, LTD.

LICENSE EXPIRATION DATE: 4/30/24
THIS WORK WAS PREPARED BY ME
OR UNDER MY SUPERVISION.

1" = 10'-0"


STATE OF HAWAI'I DEPARTMENT OF TRANSPORTATION SIGN STRUCTURE 78WB-853 ELECTRICAL DETAILS

INTERSTATE ROUTE H-1 AND H-201 FAP NO. NH-0300(205)

Date: Oct. 2023 SHEET No. E5.2 OF 8 SHEETS

FED. ROAD DIST. NO.	STATE	FEDERAL AID PROJ. NO.	FISCAL YEAR	SHEET NO.	TOTAL SHEETS	
HAWAII	HAW.	NH-0300(205)	2024	197	197	

HALAWA APPROACH

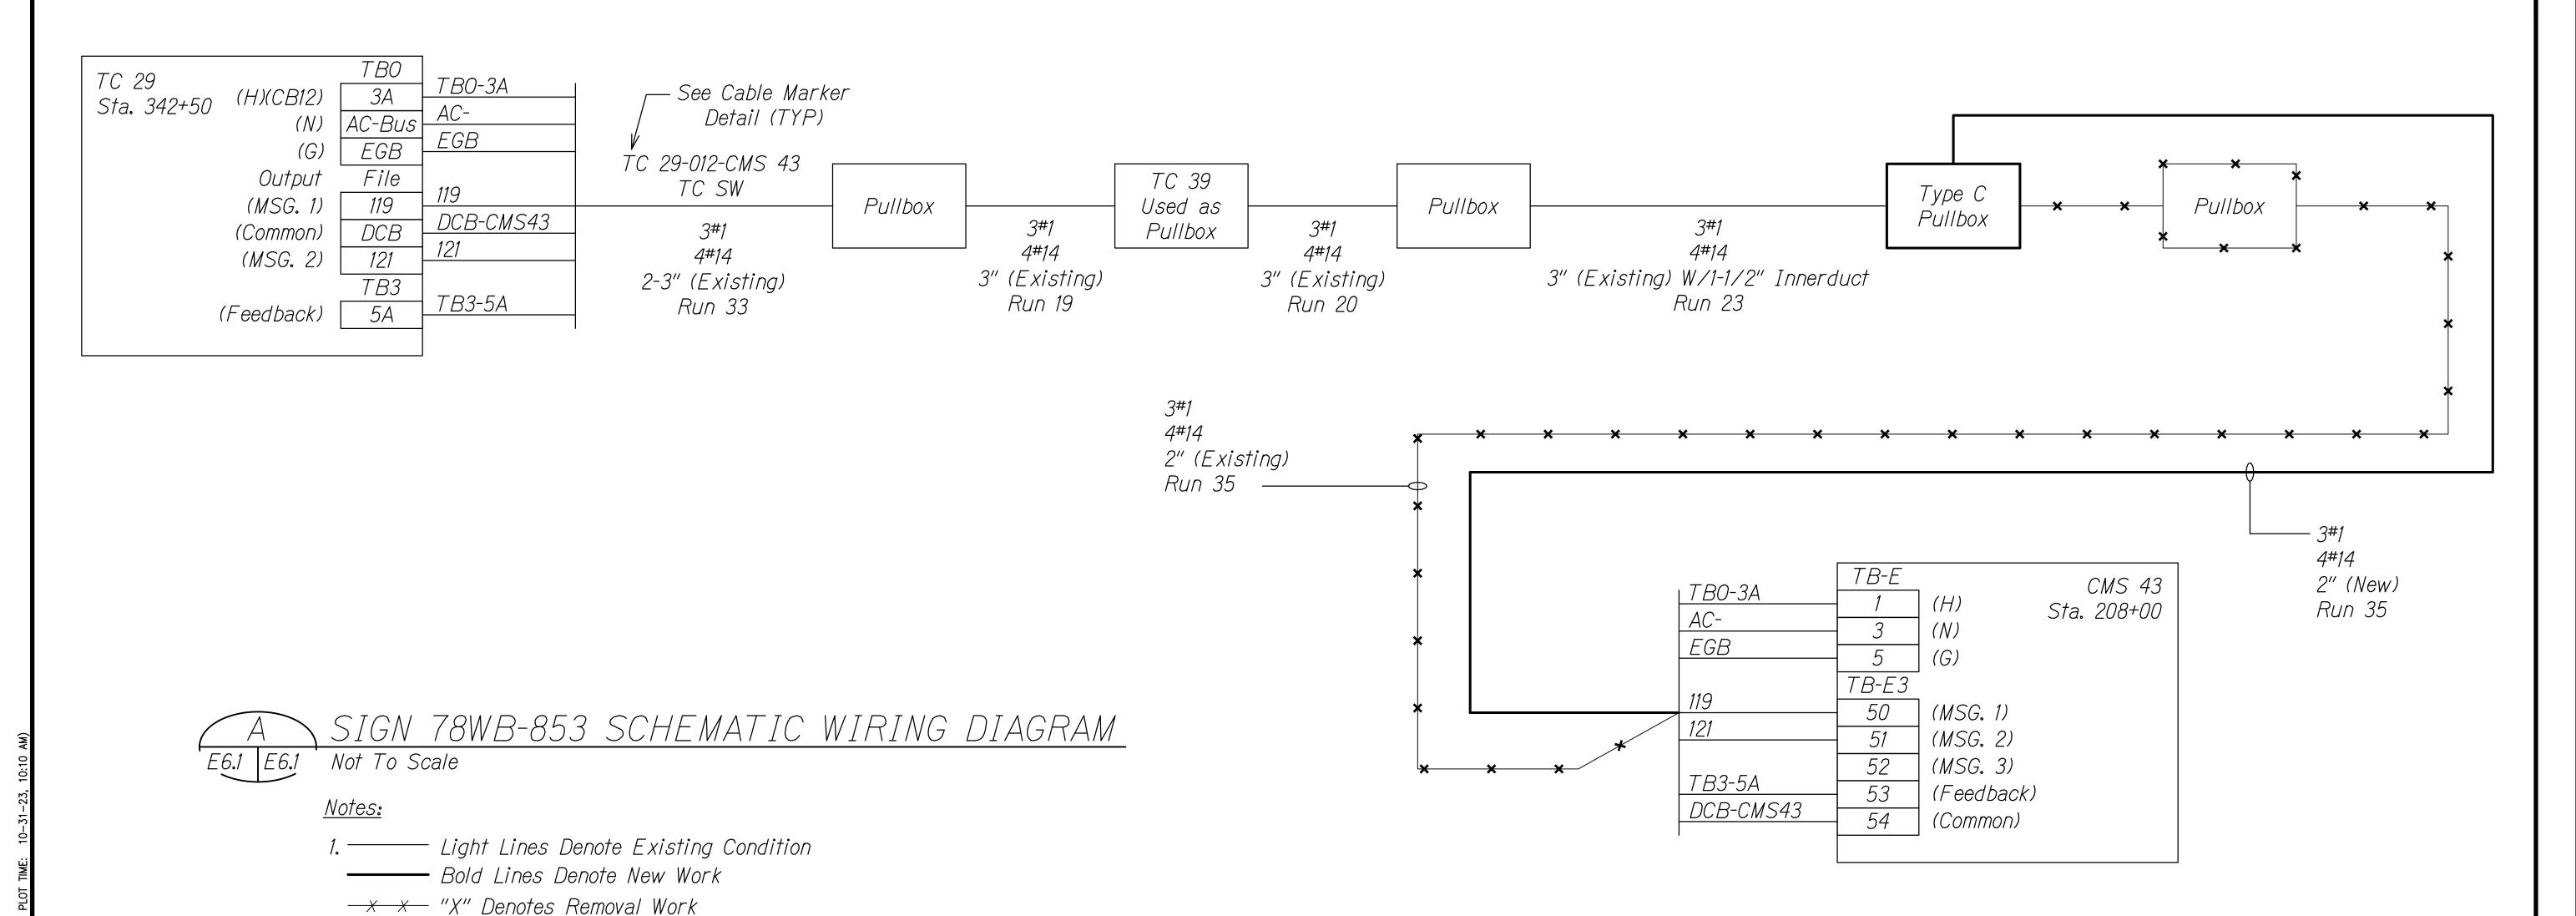

2. This Schematic Diagram is Based on Available Reference Drawings. Field Verify All Existing Conditions and Prepare an As-Built Drawing Prior to Start of Removal Work to Ensure the System is Put Back in its Operating Condition Prior to Start of Construction. Note Any Deficiencies on the As-Built Drawings.

