



SURVEY PLOT
DRAWN BY____
TRACED BY___
DESIGNED BY_
OUANTITIES I
CHECKED BY___

Trim Matting around
Obstacle (See Note 2)

Notes:

- 1. Matting shall be placed and secured in direct contact with the finish grade.
- 2. Maximum gap between edge of trimmed matting and obstacle shall be 1 inch.
- Contractor shall locate and expose exist. utility boxes prior to installing matting.
- 4. For installation of matting around existing trees, see Landscape drawings.

OBSTACLES

Scale: Not to Scale

TYPICAL SECTION AROUND EXISTING

box, etc.)

— Install Stakes @

LEGEND FOR AS-BUILT POSTINGS

Squiggly line for as-built deletion

Double line for as-built deletion

Text for as-built posting

PROFESSIONAL ENGINEER
NO. 9360-C

A/30/16

EXP. DATE

DELETED AT PID'S 445, 241, 57 & 110.

STATE OF HAWAII
DEPARTMENT OF TRANSPORTATION
HIGHWAYS DIVISION

TYPICAL DETAILS
EROSION CONTROL MATTING
CENTRAL OAHU BEST MANAGEMENT PRACTICES

CENTRAL OAHU BEST MANAGEMENT PRACTICES

ERODED SLOPE REPAIRS, PHASE 1


Project No. HWY-0-04-15M

Scale: Not to Scale Date: May 2015

SHEET No. EC-01 OF 11 SHEETS




Roadway

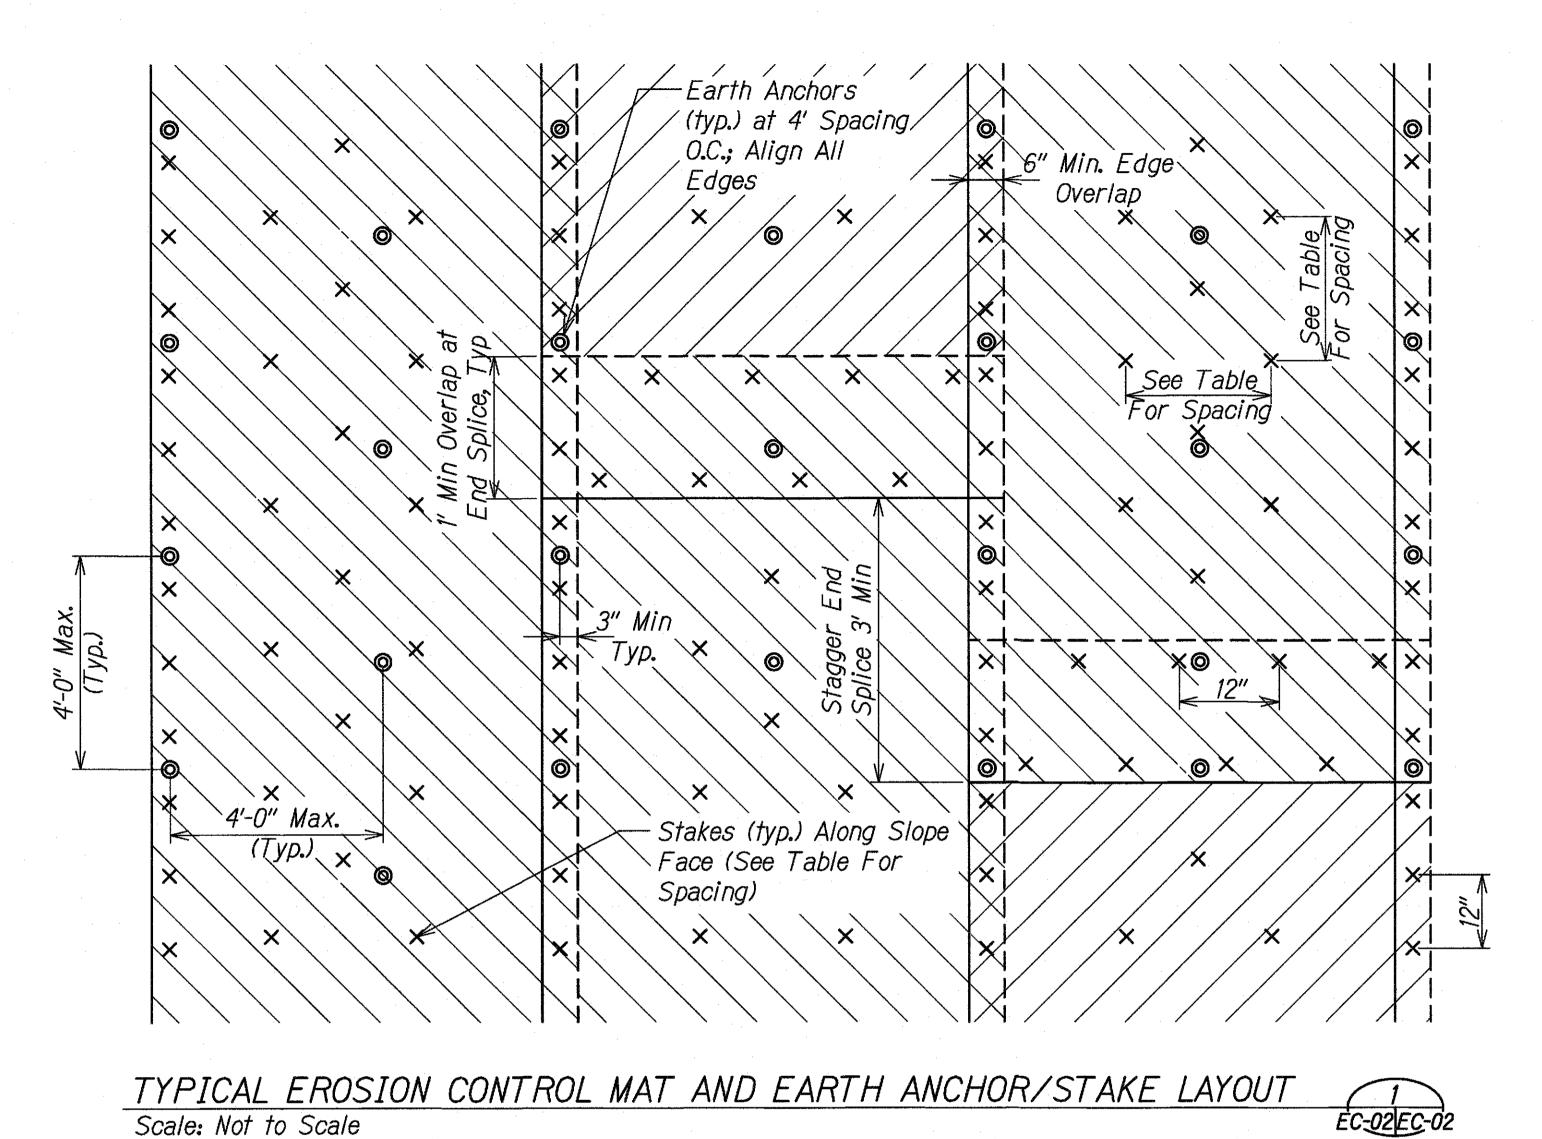

Fastener Type	Along Slope Face	Top, Bottom ¢ Edge Trenches −	
Stakes	1.5'		
Earth Anchor	4'	4'	
Pins		1'	


- Secure all erosion control mat edges with stakes, earth anchors and pins at the spacing indicated or the manufacturer's recommended spacing, whichever is more stringent.
- 2. For slopes 3H:1V or flatter, no ECM required.
- 3. Earth anchors in trenches shall extend a minimum depth of 3' from the slope face.
- 4. The upper 4 rows of earth anchors shall extend a minimum depth of 10' from the slope face.
- 4.5. The remaining earth anchors shall be installed per row to alternating depths of # and 6' respectively.
- 5. Install earth anchor at PID 907 only

FED. ROAD DIST. NO.	STATE	PROJ. NO.	FISCAL YEAR	SHEET NO.	TOTAL SHEETS
HAWAII	HAW.	HWY-0-04-15M	2015	15.	46

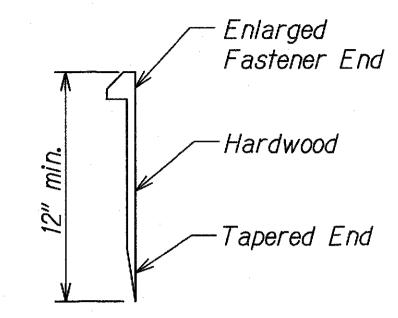

STAKE DETAIL ÈC-02EC-02 Scale: Not to Scale

1. For clayey soils, pins shall be a minimum of 12" in length.

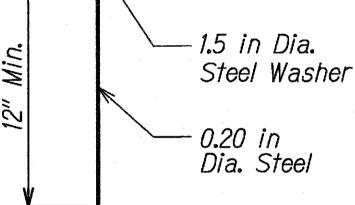

2. For sandy soils, pins shall be a minimum of 18" in length.



LEGEND FOR AS-BUILT POSTINGS


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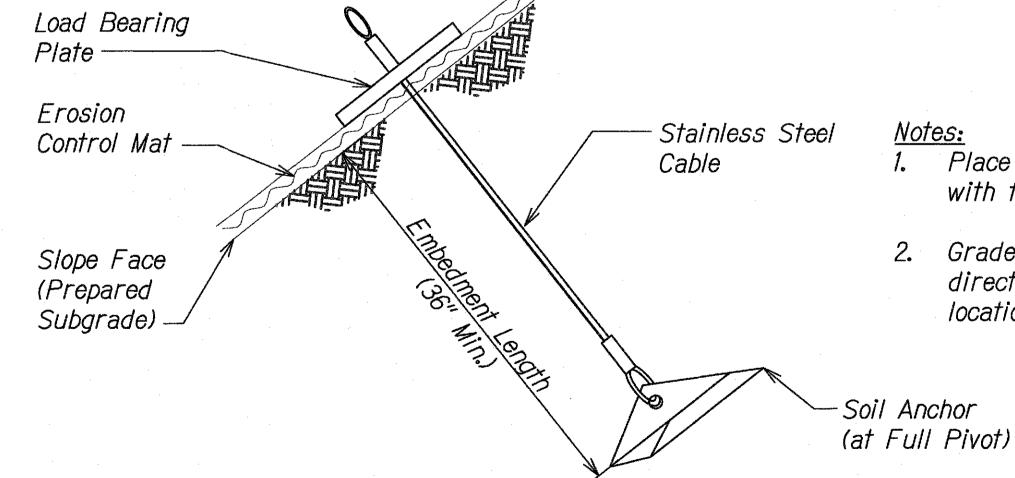
Roadway

Double line for as-built deletion Text for as-built posting



Scale: Not to Scale

OVERLAP END DETAIL EC-02 EC-02 Scale: Not to Scale

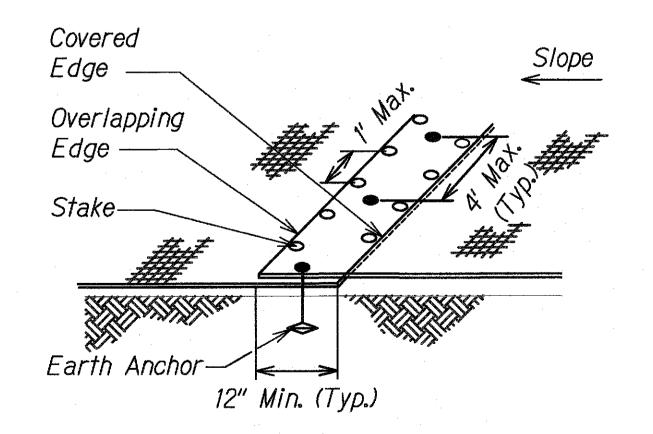


EARTH ANCHOR DETAIL

Scale: Not to Scale

EC-02EC-02

Place erosion control mat in direct contact with finish grade.

2. Grade and shave existing ground to allow direct contact of erosion control mat at all locations.

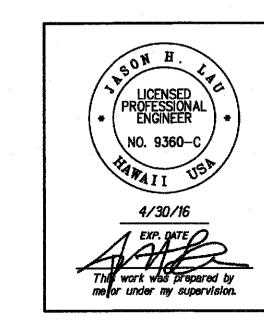

STATE OF HAWAII DEPARTMENT OF TRANSPORTATION
HIGHWAYS DIVISION


TYPICAL DETAILS EROSION CONTROL MATTING

CENTRAL OAHU BEST MANAGEMENT PRACTICES ERODED SLOPE REPAIRS, PHASE 1 Project No. HWY-0-04-15M
Scale: Not to Scale Date: N

Date: May 2015 SHEET No. *EC-02* OF 11 SHEETS

'AS-BUILT'

15

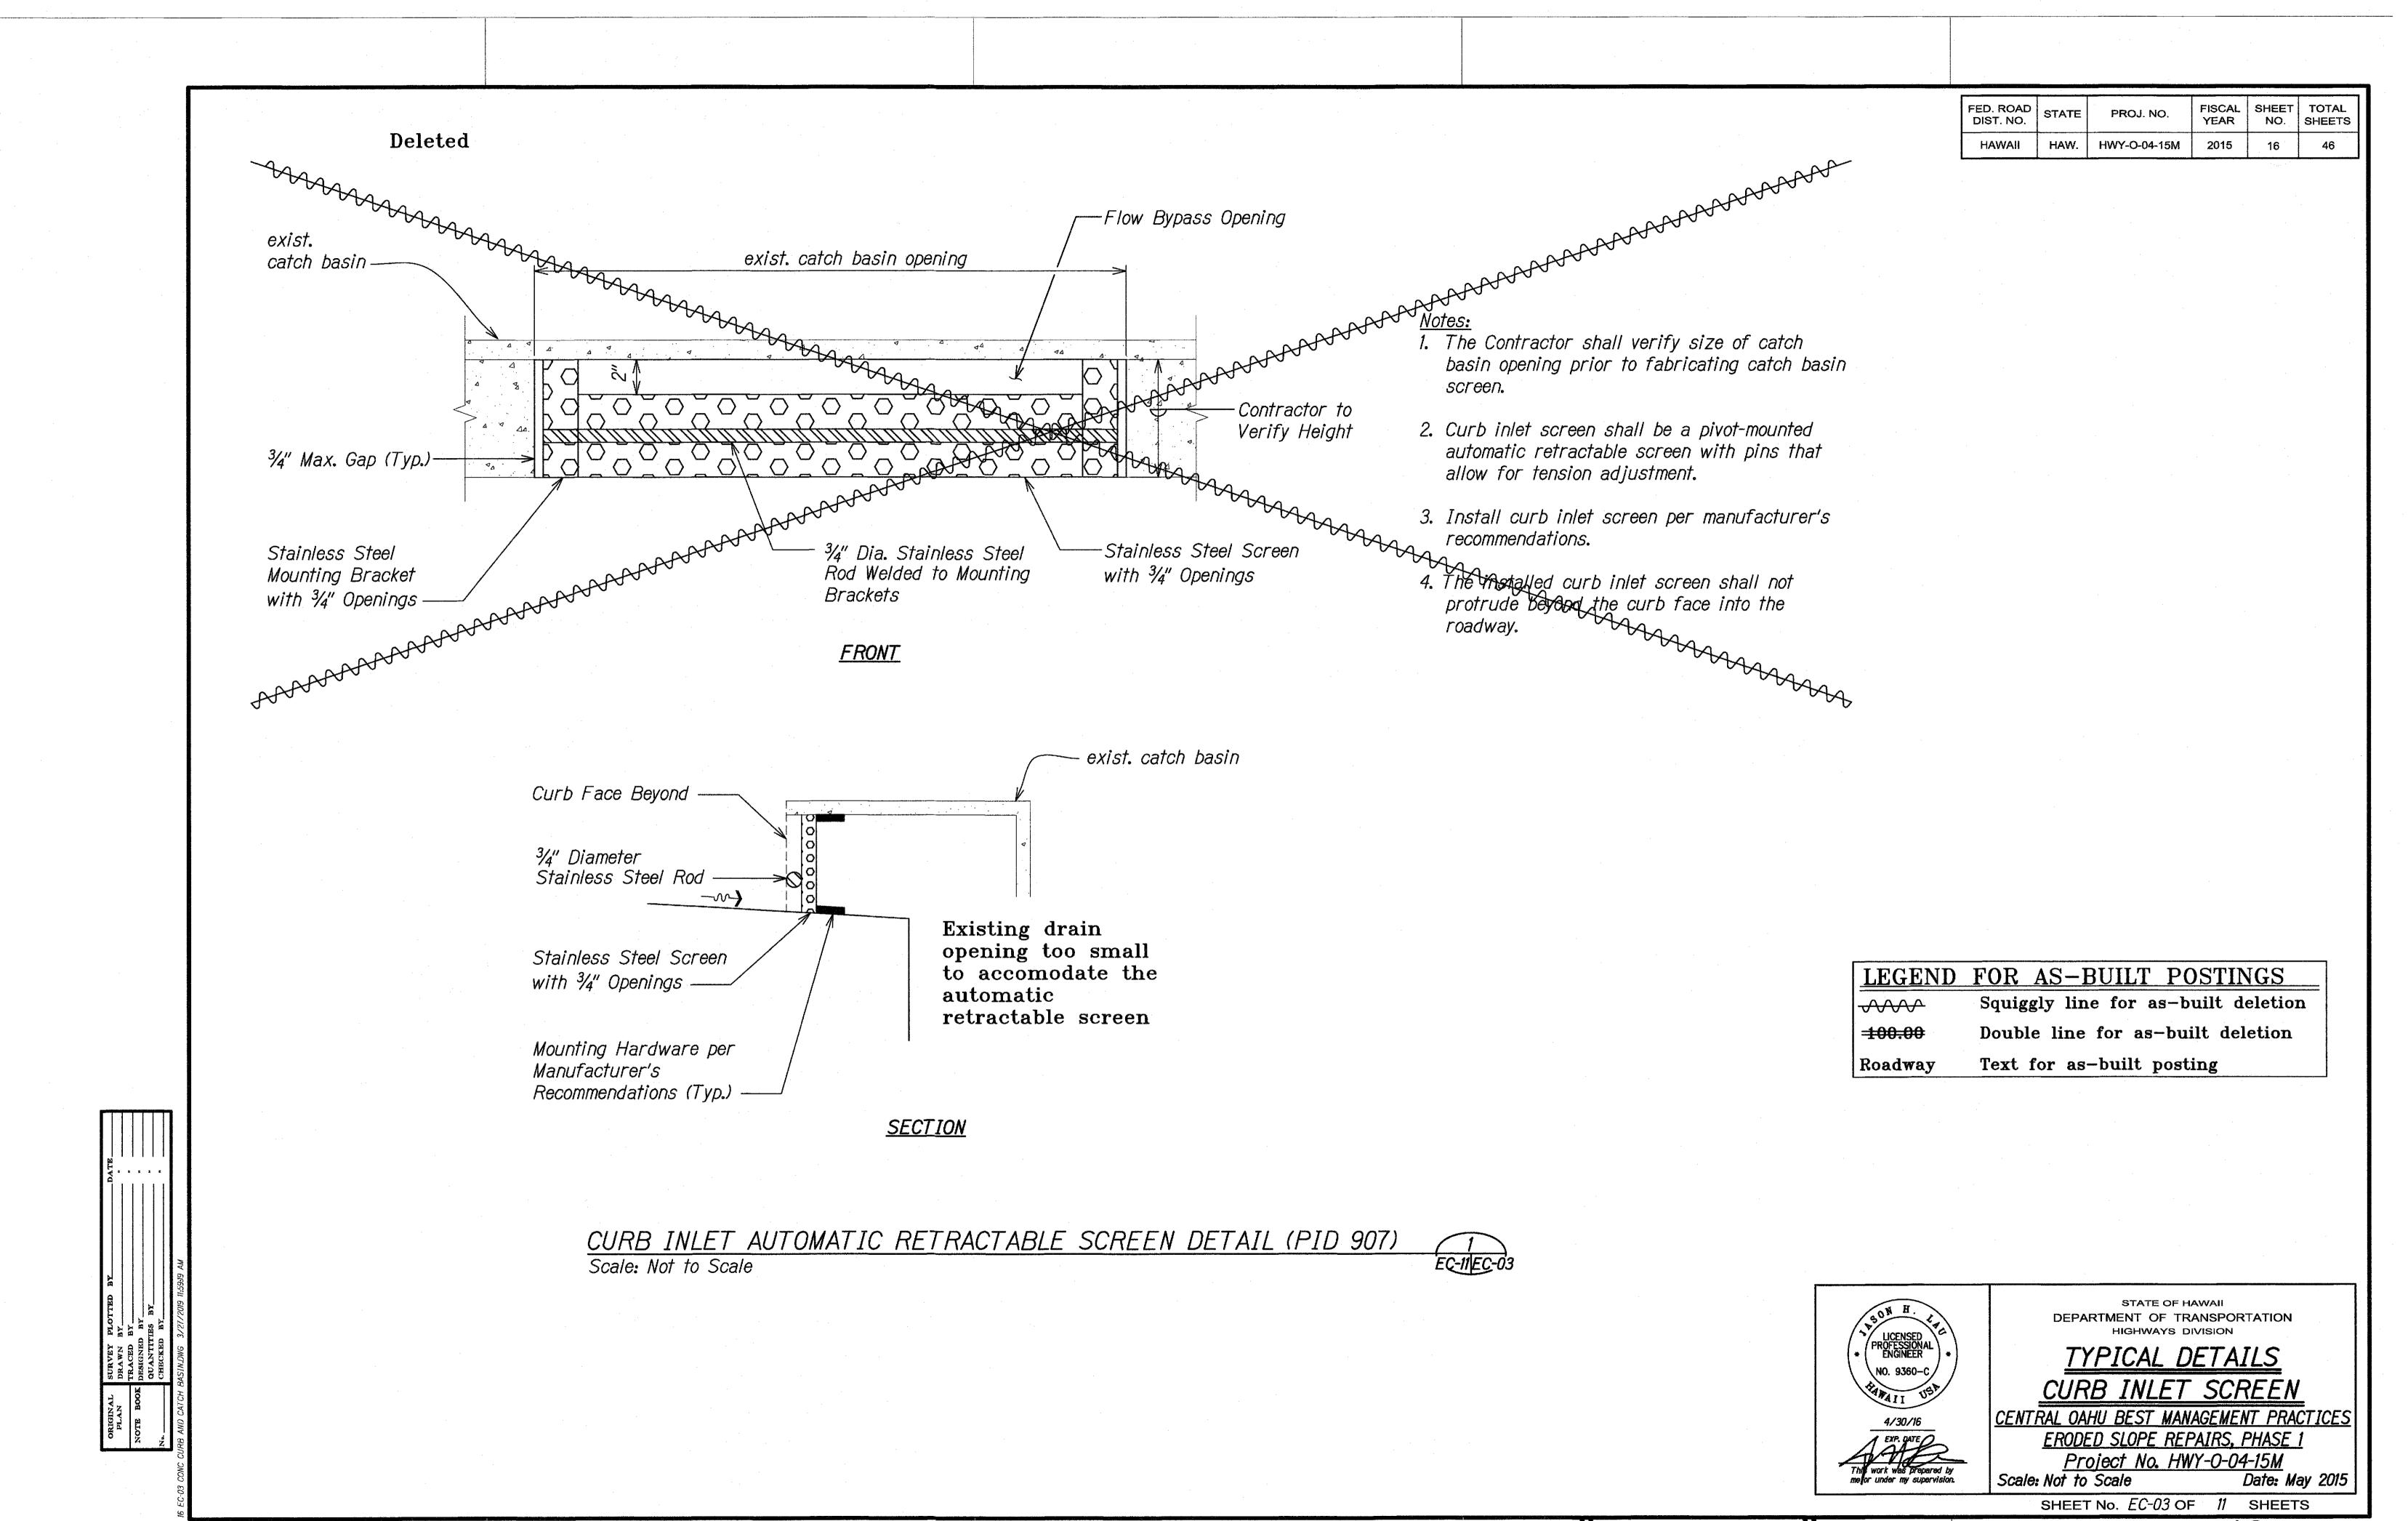

"AS-BUILT'

16