



Top Edge Treatment Erosion Control Mat -Stake/Earth Anchor-Overlap at Edge of Roll (Typ.) Bottom Anchor Trench at Toe of Slope -OVERVIEW OF PERMANENT EROSION CONTROL MATTING SYSTEM Scale: Not to Scale Compacted Backfill - Stake Min. -Erosion existing ground — Control Mat - Pin/Earth Anchor Min. LONGITUDINAL EDGE TRENCH DETAIL 4 Scale: Not to Scale

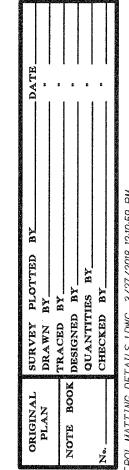

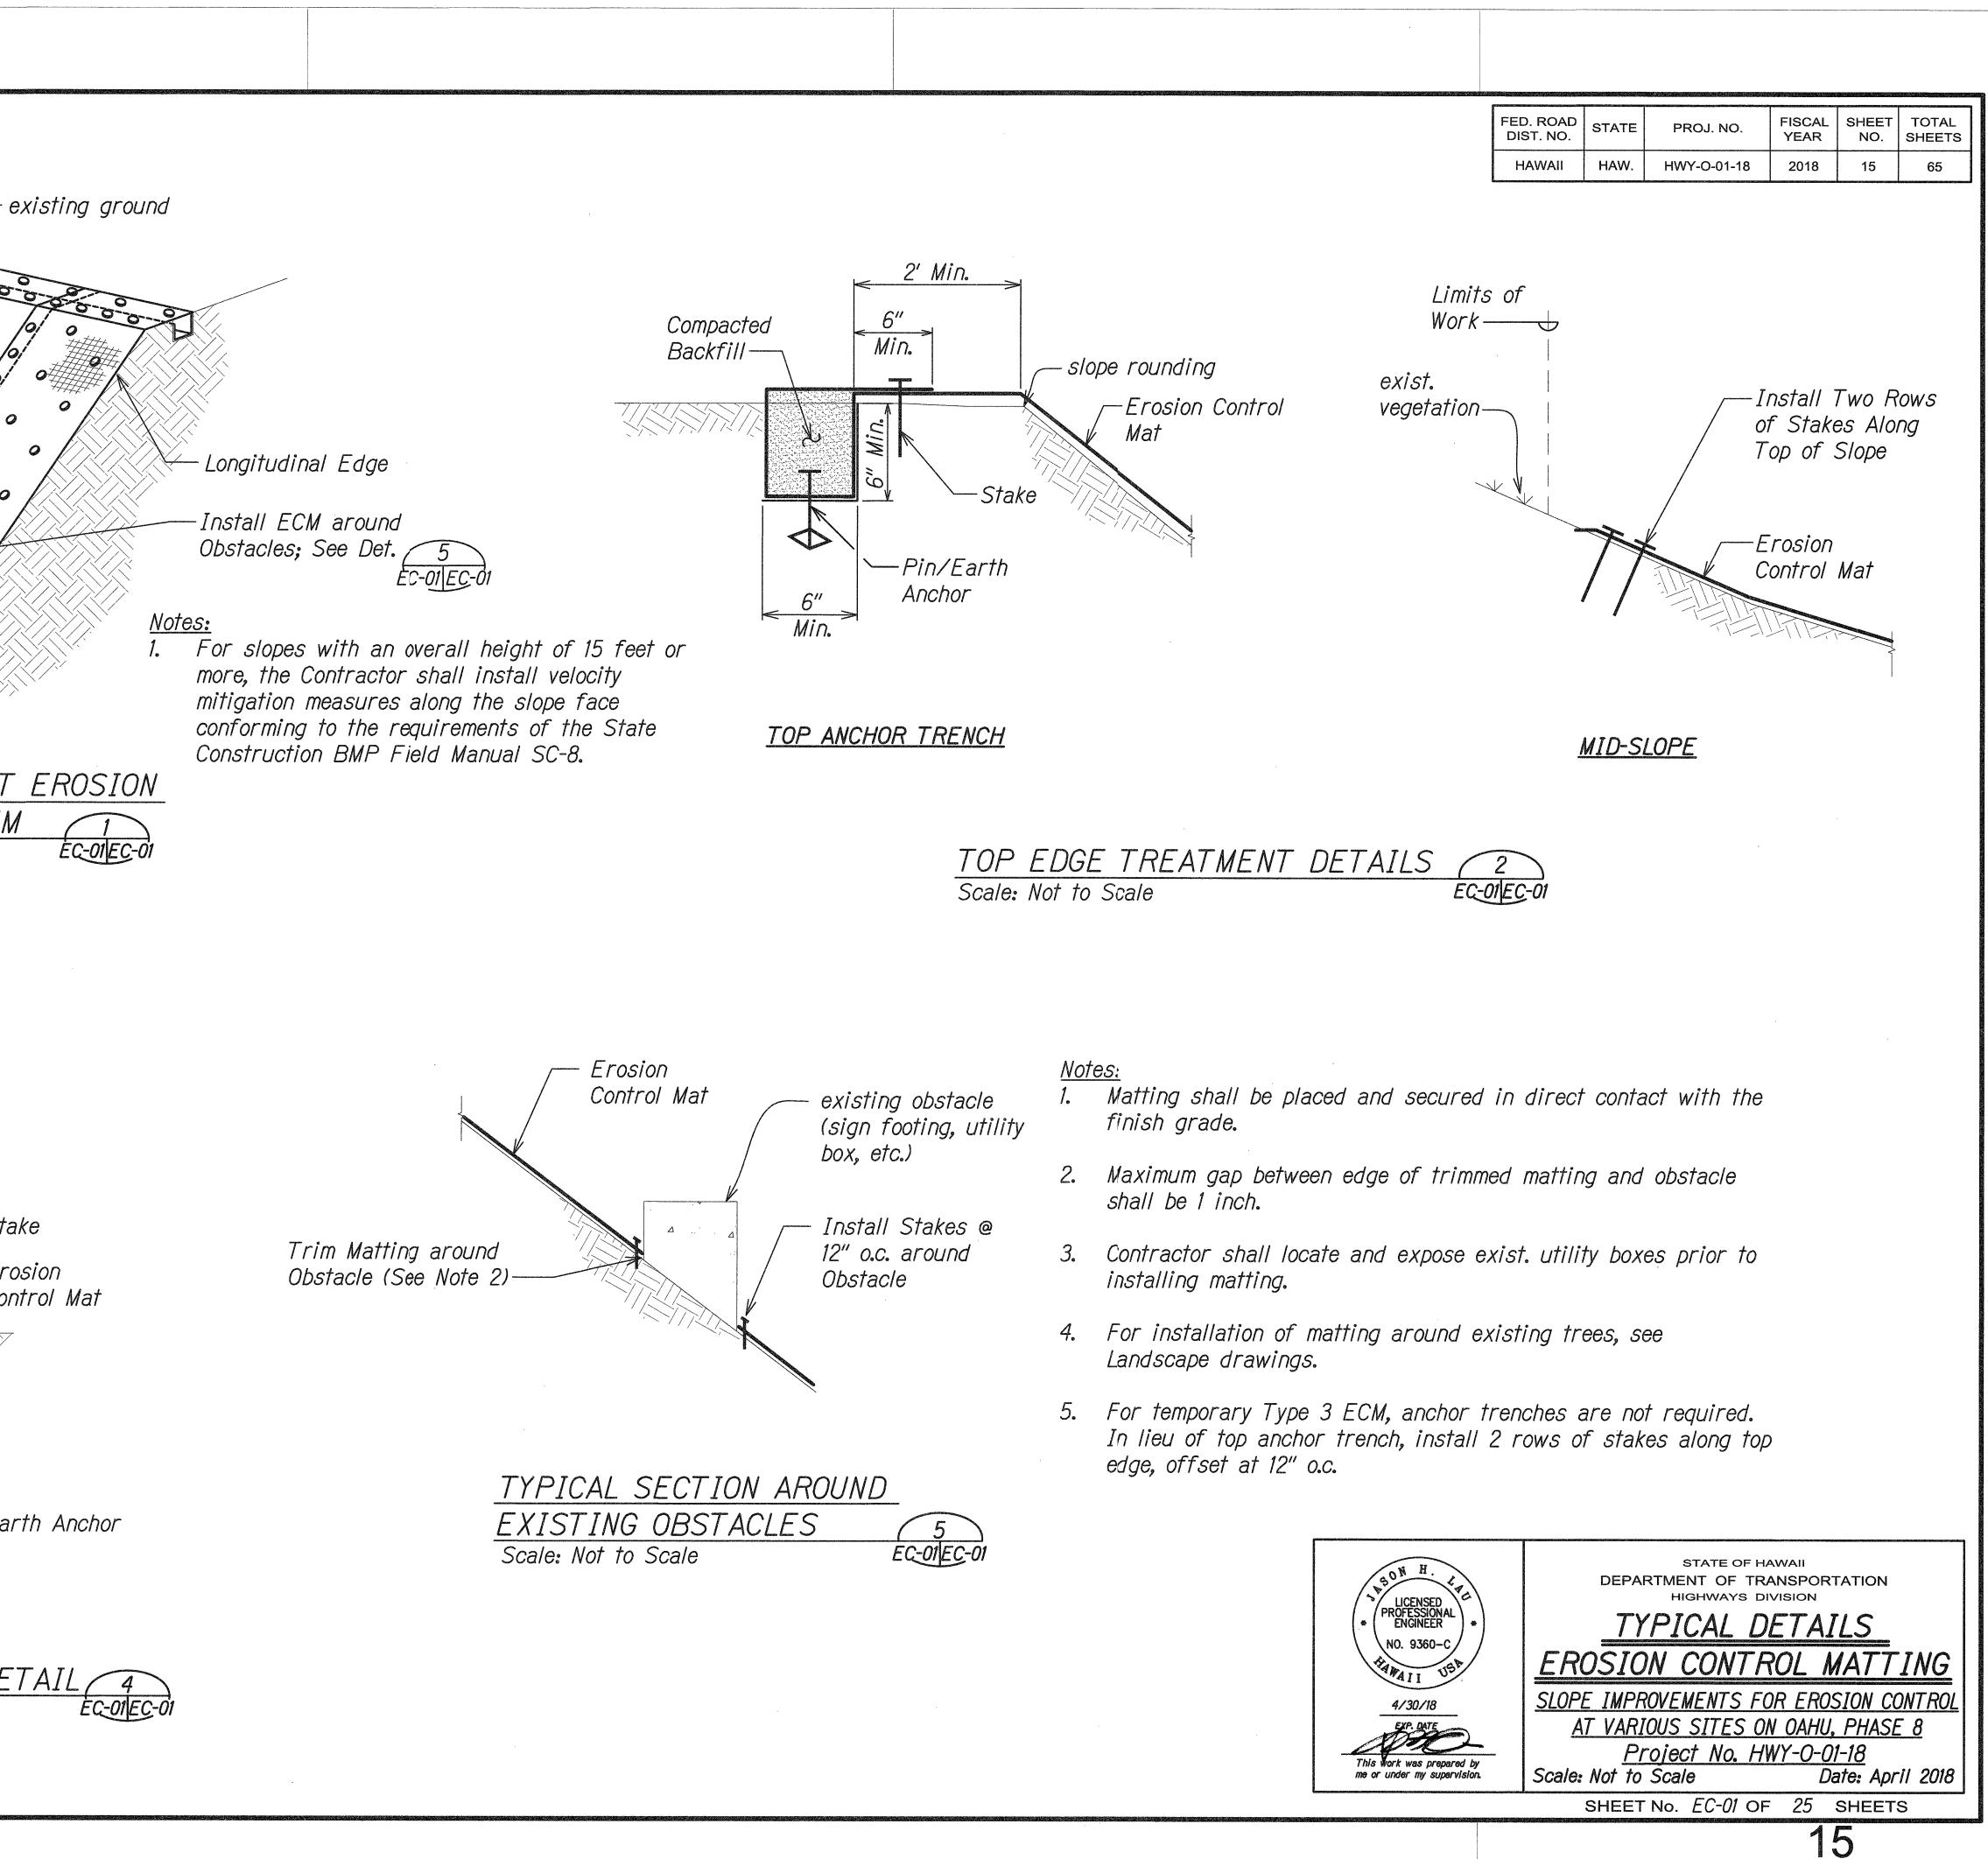

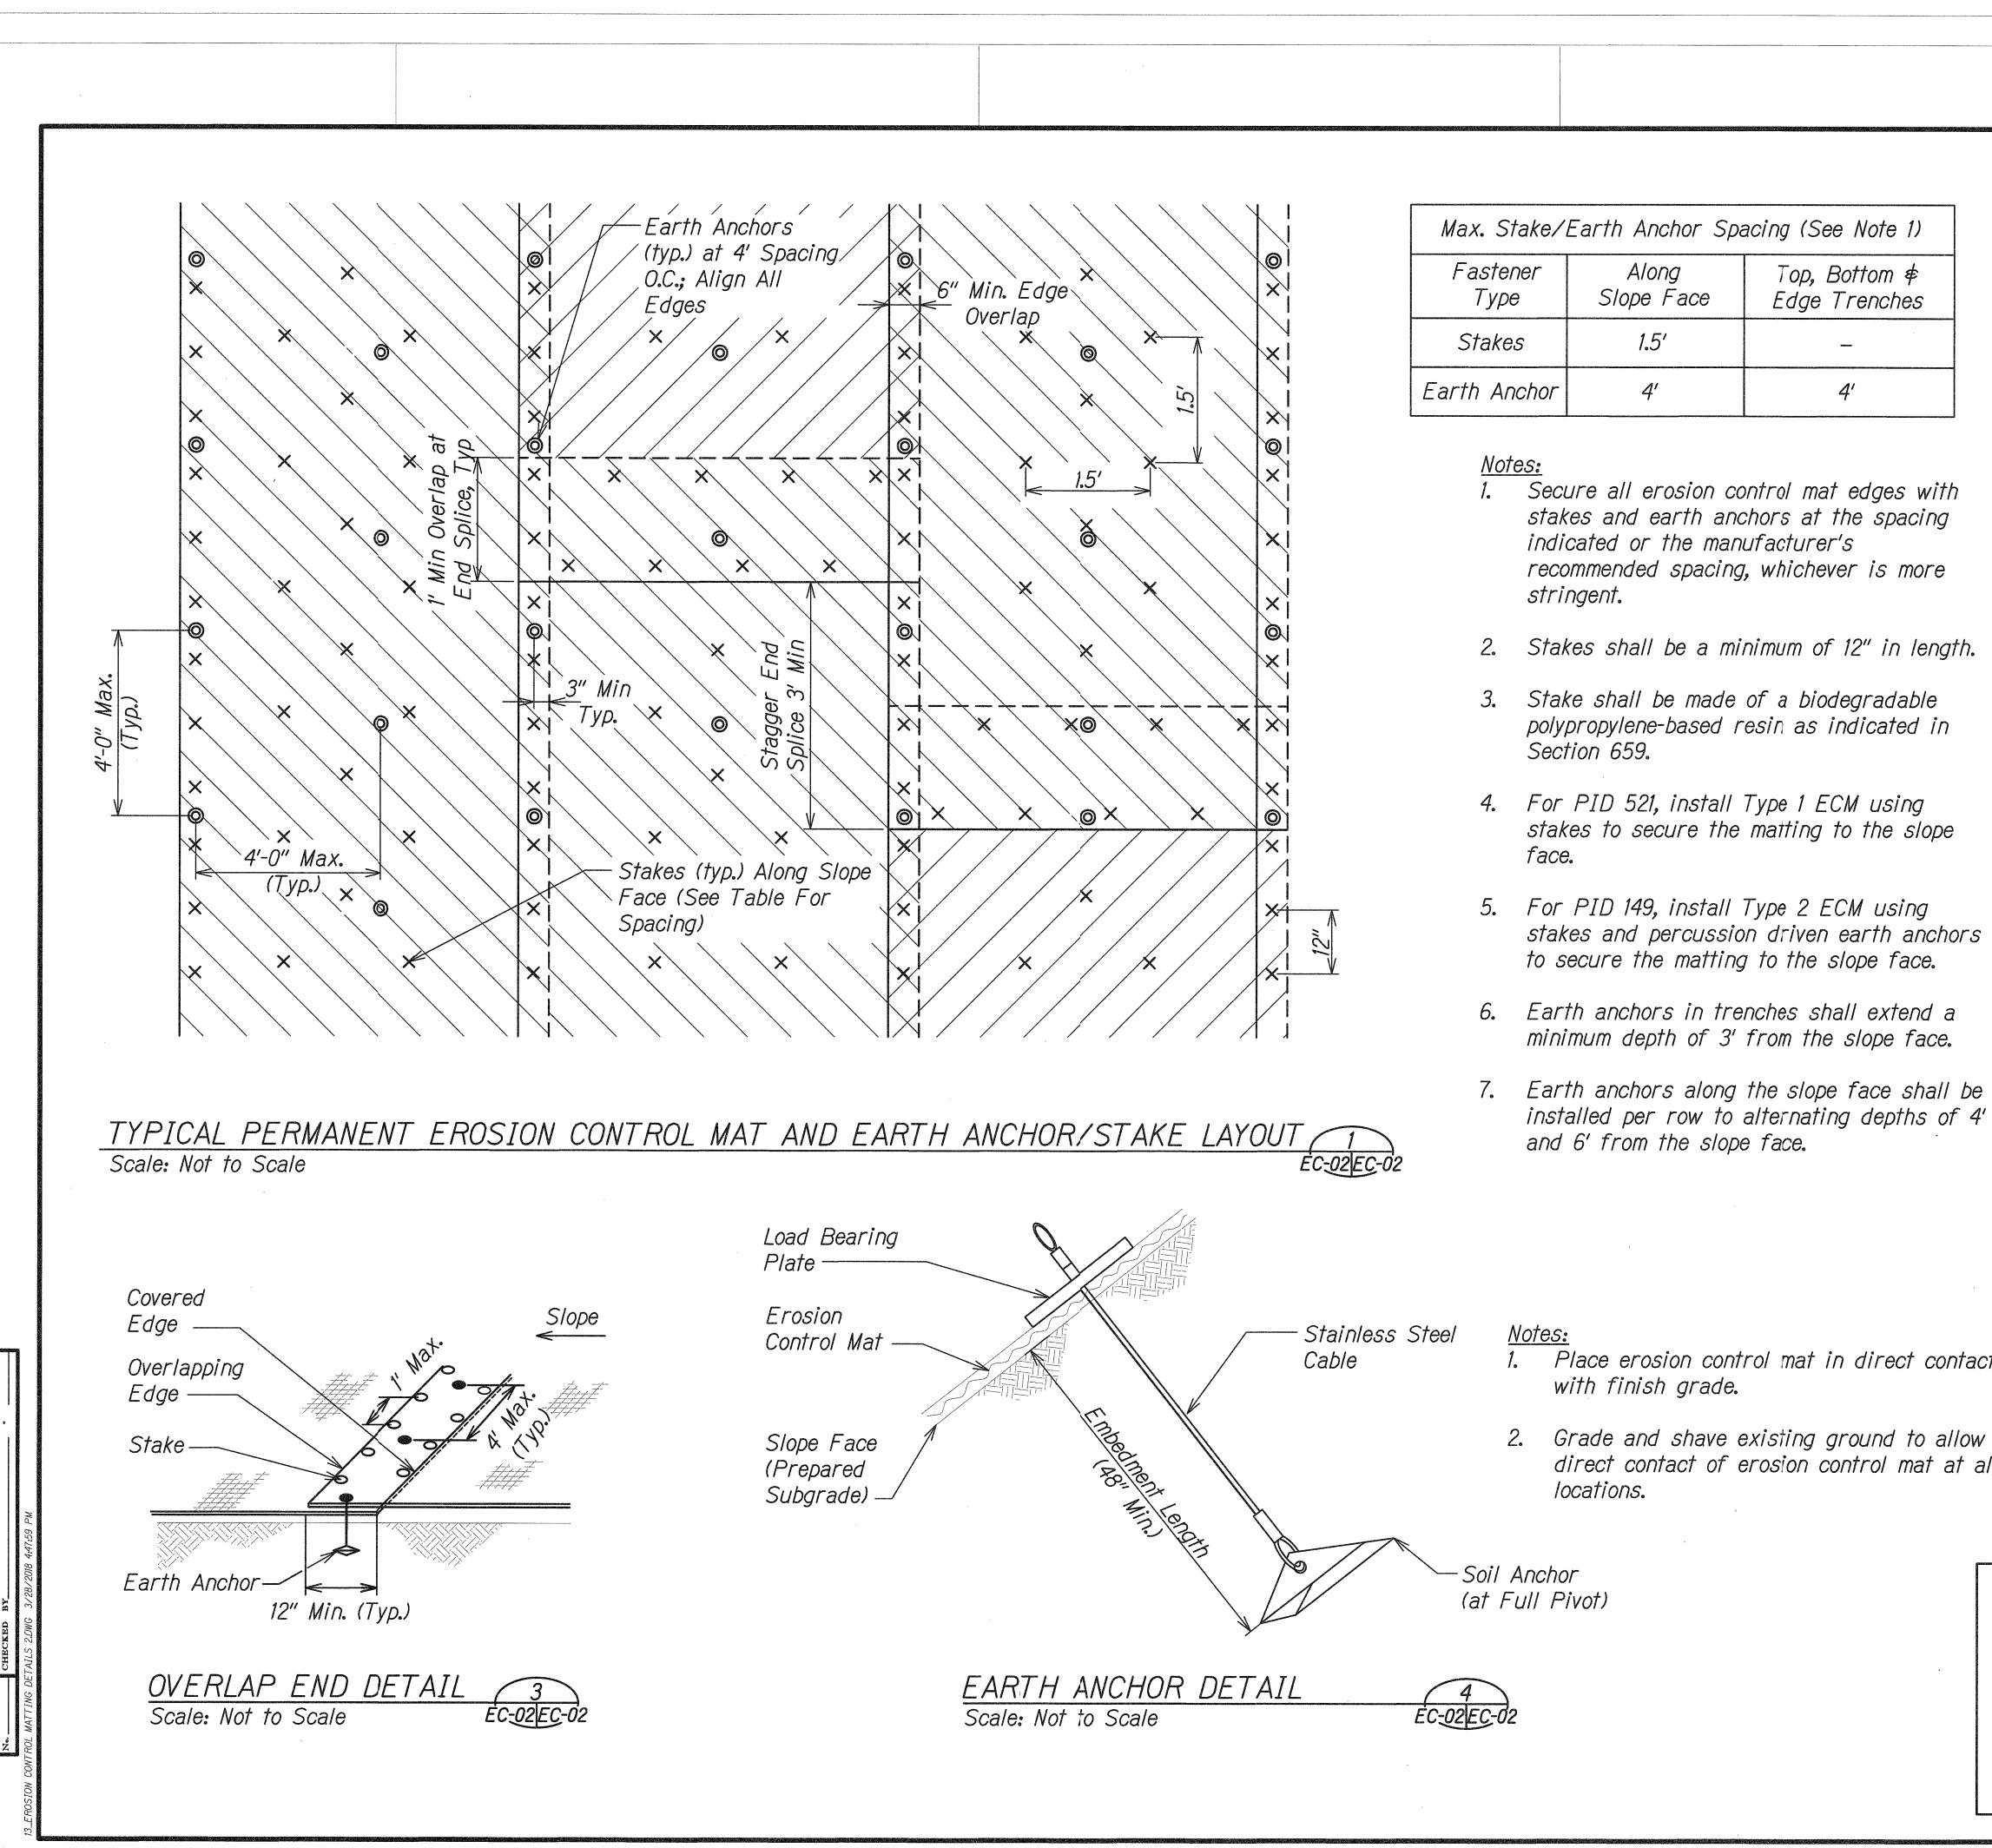

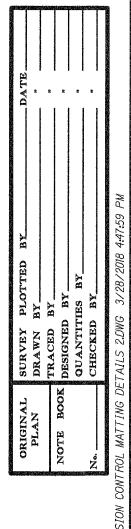


- minimum depth of 3' from the slope face.
- installed per row to alternating depths of 4' and 6' from the slope face.


FED. ROAD DIST. NO.	STATE	PROJ. NO.	FISCAL YEAR	SHEET NO.	TOTAL SHEETS
HAWAII	HAW.	HWY-O-01-18	2018	16	65

'ng (See Note 1)	
Top, Bottom ∉ Edge Trenches	
4′	

Place erosion control mat in direct contact


direct contact of erosion control mat at all

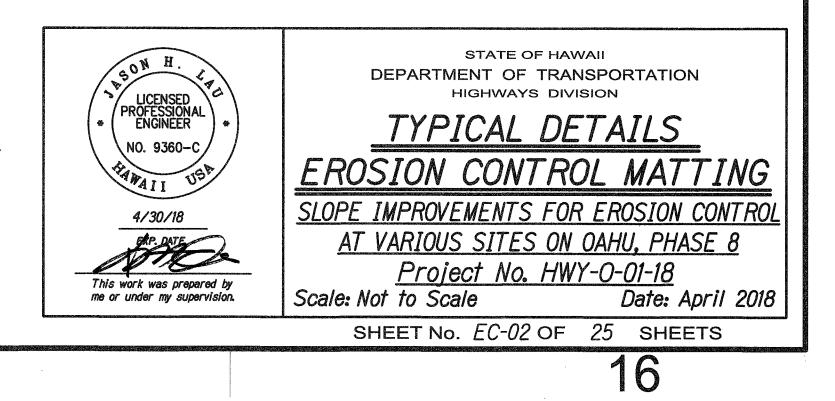


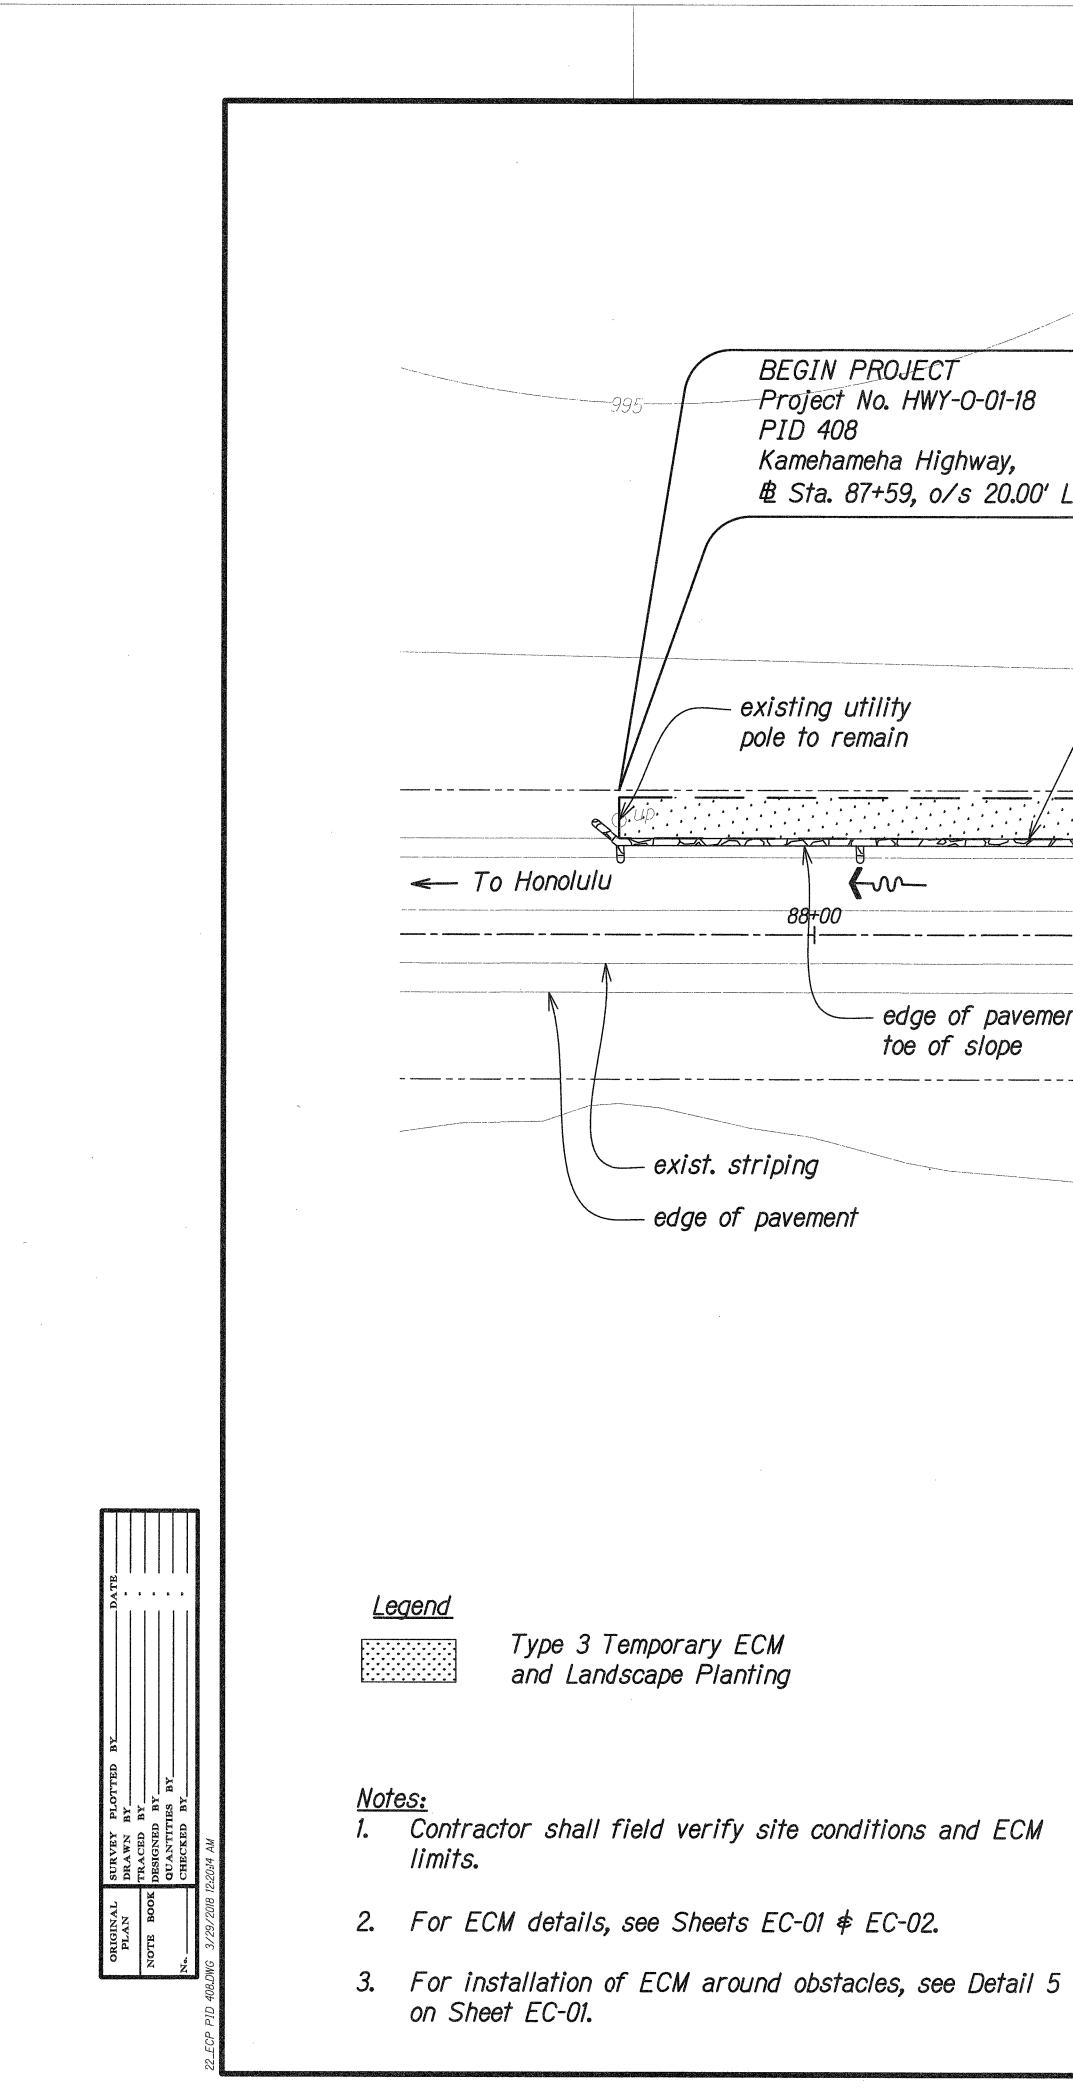


	TRUE		
	TRUE NORTH Scale: 1" = 20'-0"		
-18 / Pl	ace Temporary 9" ameter Fiber Roll at		
, / То	e of Slope		
.00' Lt.		TMK:	6-4-003:001
	 Install Type 3 Temporary ECM and Landscape 		
	Planting, per sheet LP-02		1000
	-Limits of Work		
			· · · · · · · · · · · · · · · · · · ·
	V 100 V V V V V V V V V V V V V V V V V		
89+00	KAMEHAMEHA HIGHWAY	90+00	fre
vement/	Place 4 Temporary		
e 	<i>Check Dams @ 50' o.c.</i>	-	
			Kamehar Highway
	exist. r/w		


TEMPORARY EROSION CONTROL AND PERMANENT BMP PLAN <u>PID 408</u> Scale: 1" = 20'-0"

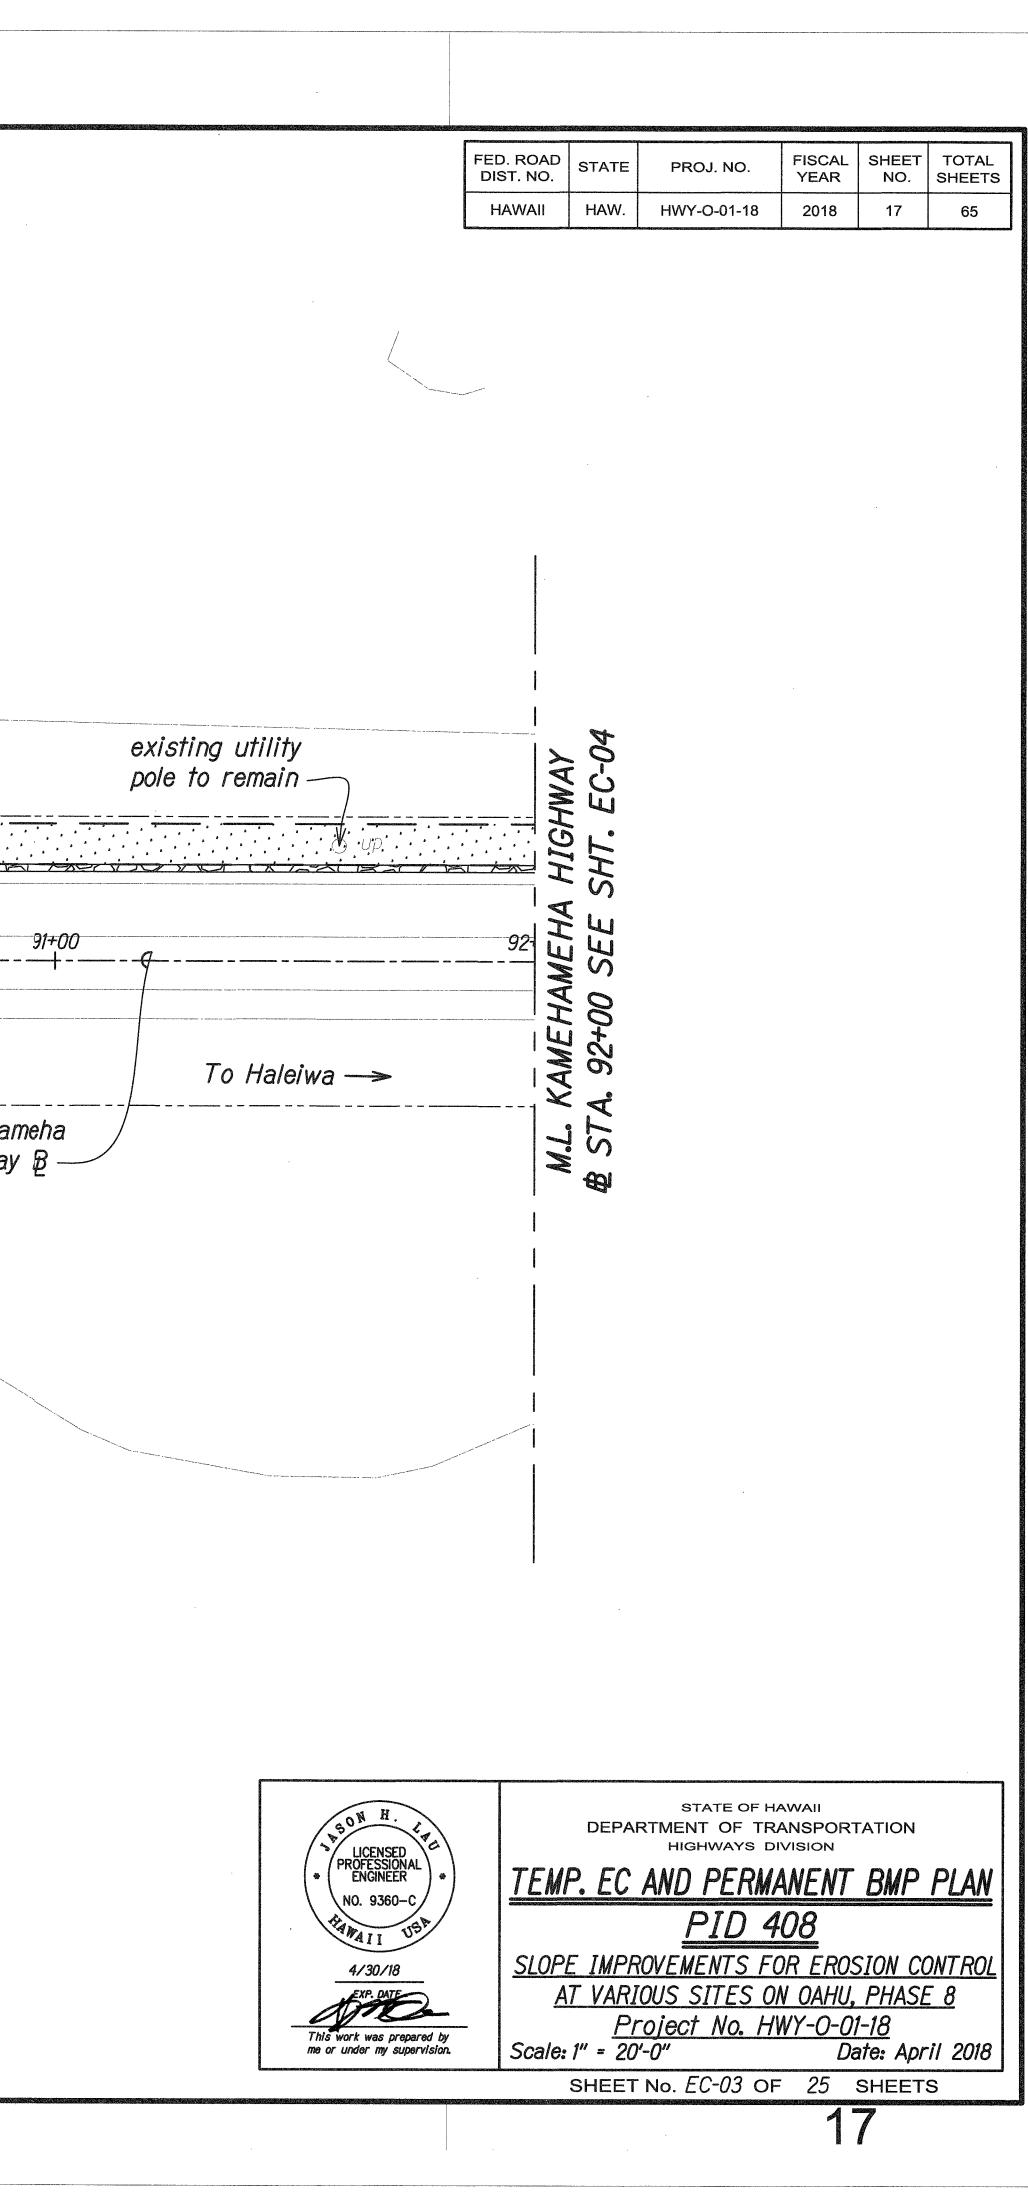

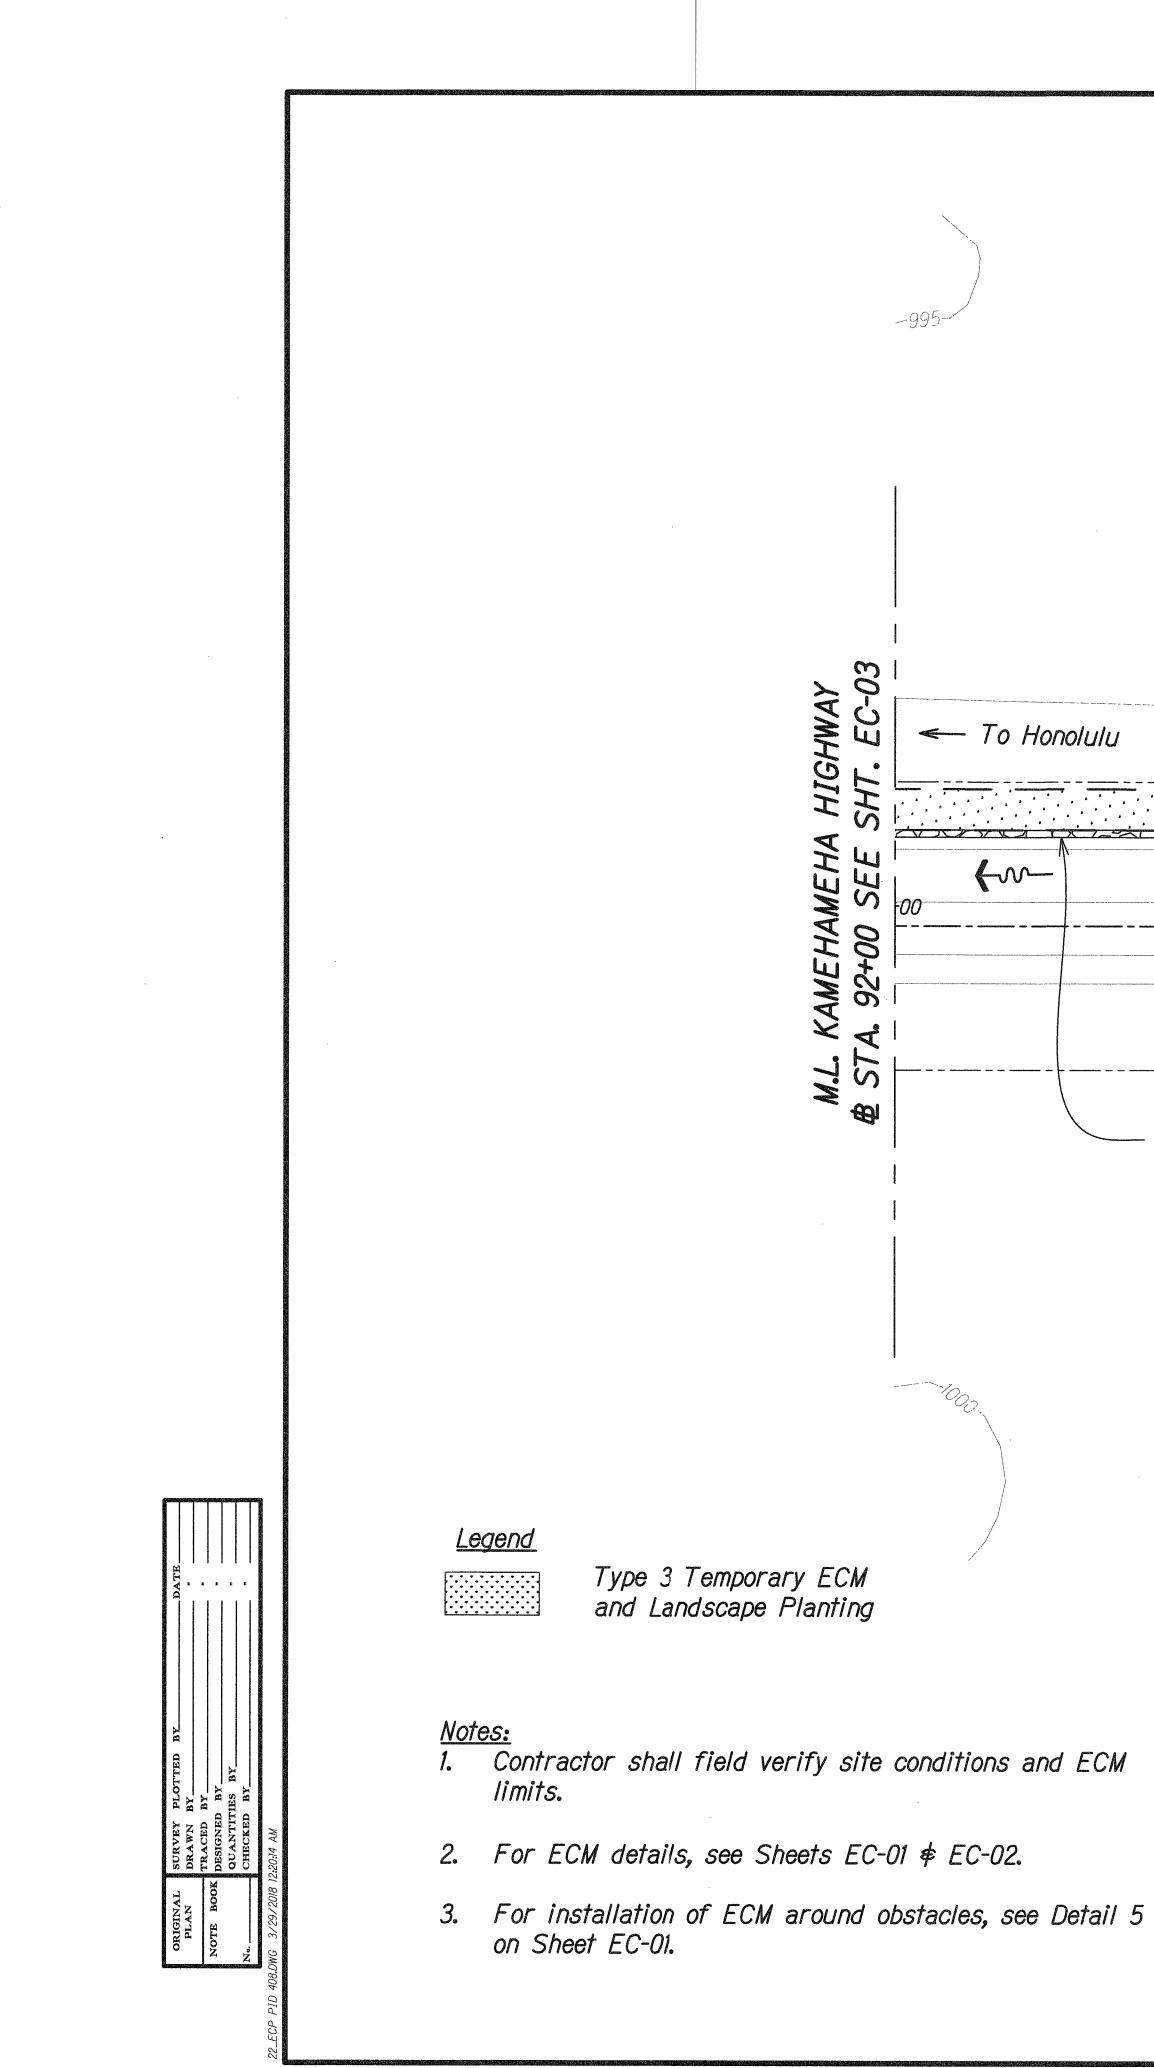



Scale: 1" = 20'-0" Place Temporary 9" Diameter Fiber Roll at Toe of Slope TMK: 6-4-003:001 - Install Type 3 Temporary ECM and Landscape Planting, per sheet LP-02 <u>— Limits of Work</u> KAMEHAMEHA HIGHWAY for 93+00 94+00 Kamehameha Highway Bg —— — exist. striping - edge of pavement/
toe of slope edge of pavement TEMPORARY EROSION CONTROL AND PERMANENT BMP PLAN <u>PID 408</u> Scale: 1" = 20'-0"

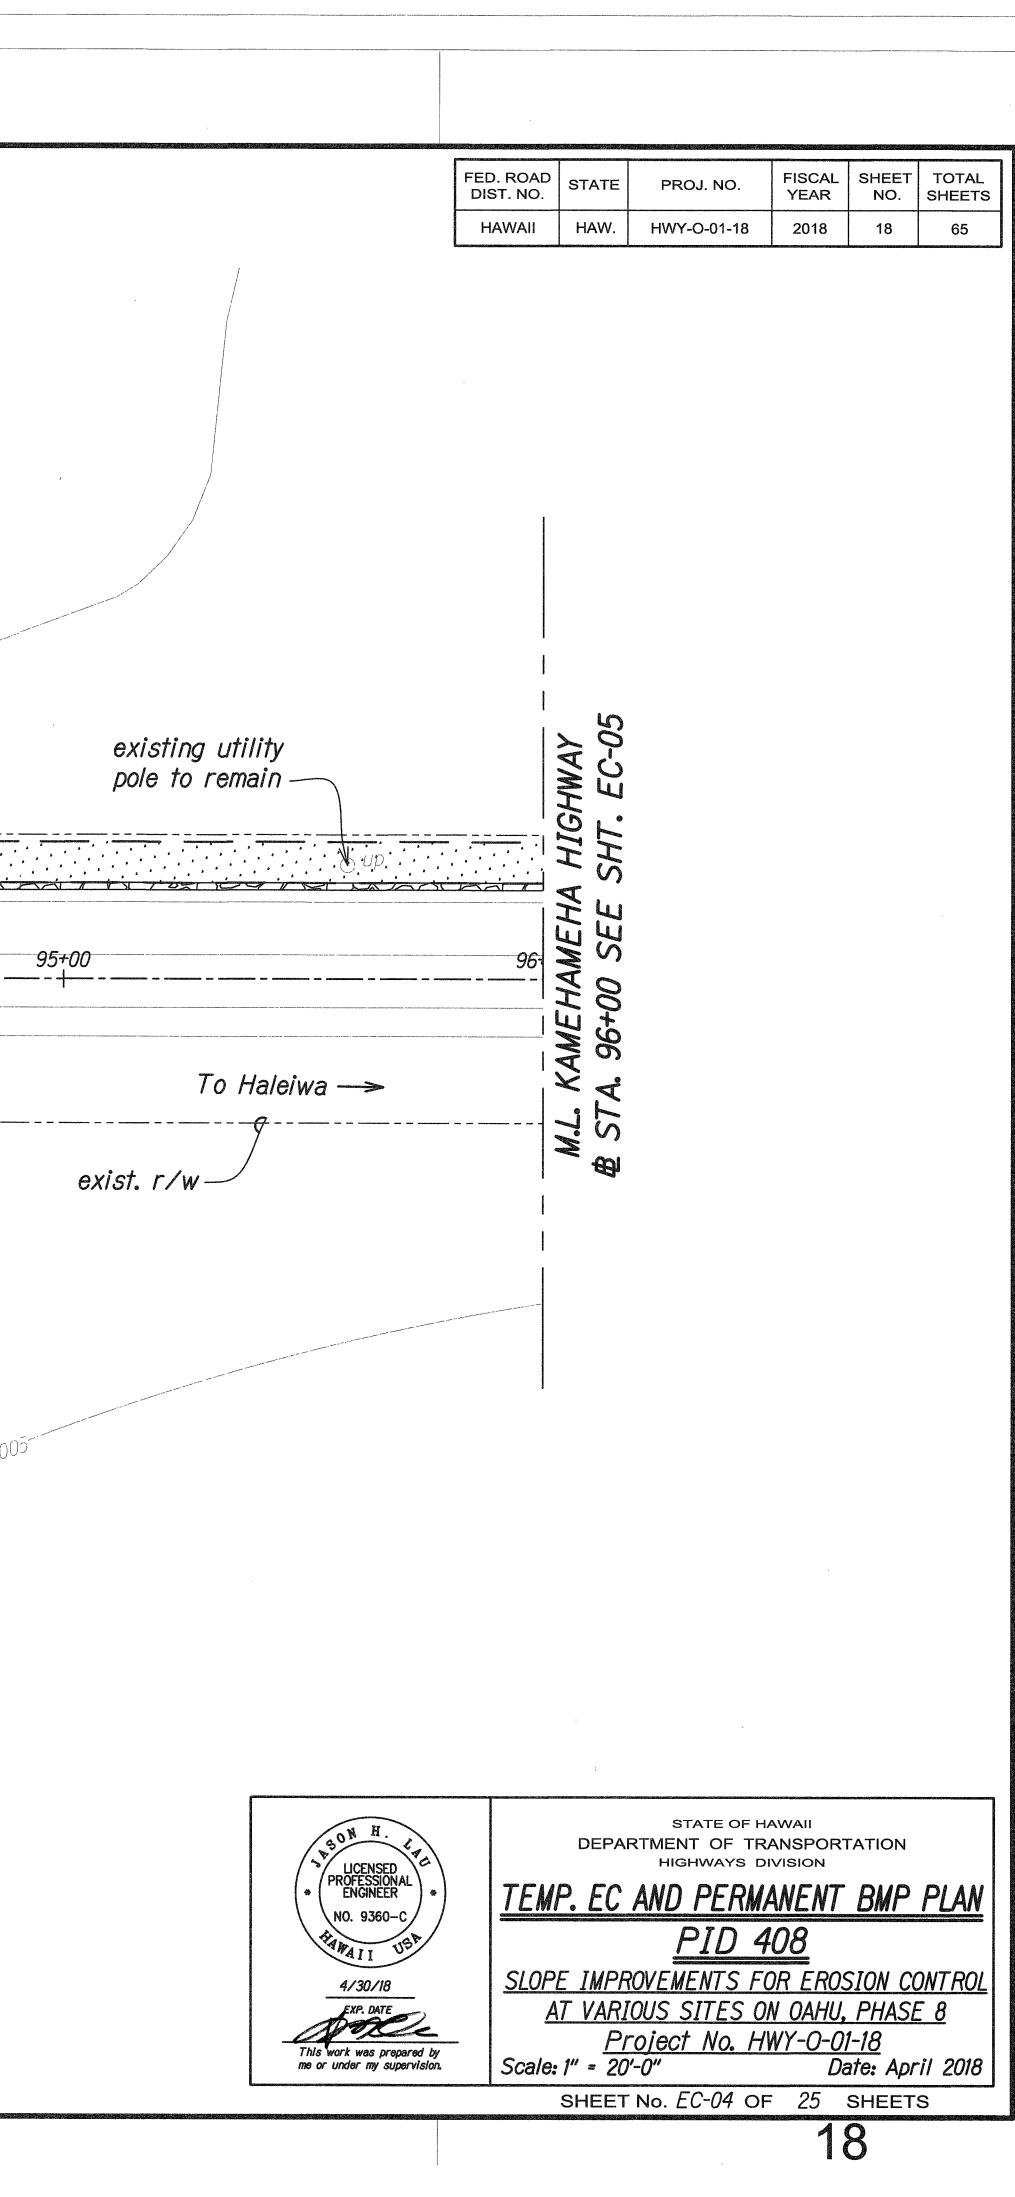

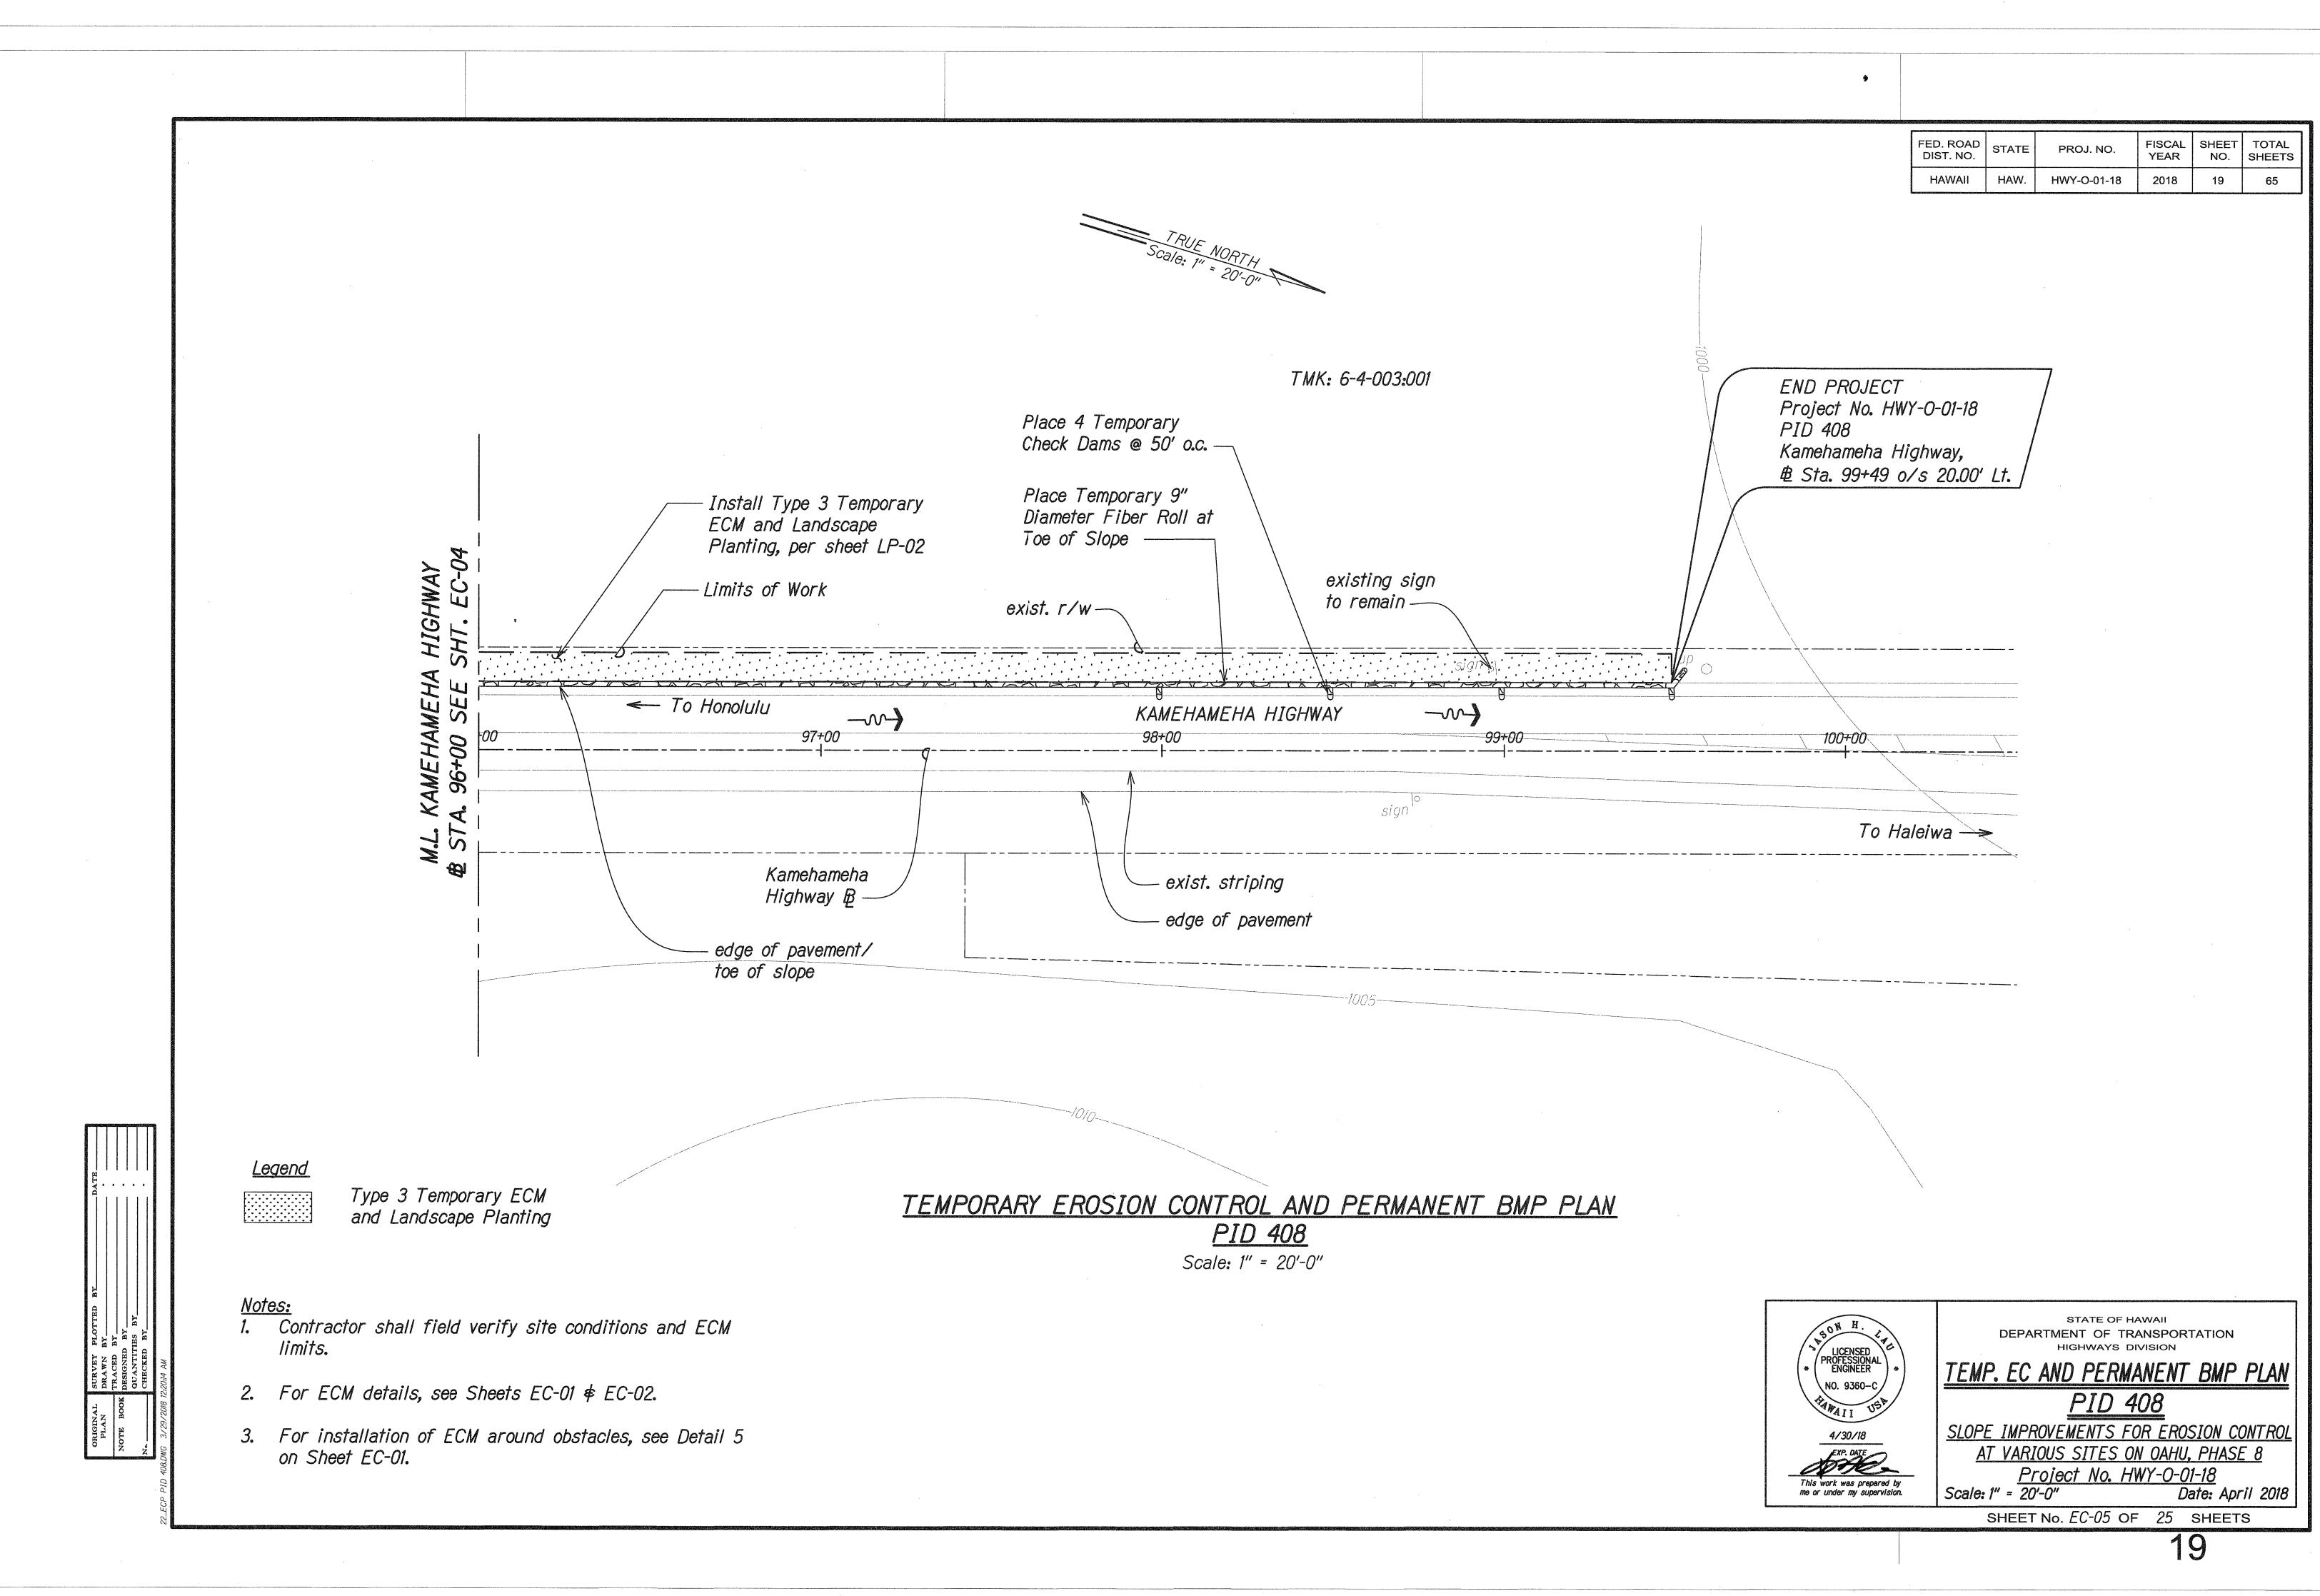


BEGIN PROJECT Project No. HWY-O-01-18 PID 502 Kamehameha Highway, ₿ Sta. 35+15, o/s 19.78' Lt. - To Honolulu / 36+00 exist. exist. crm end guardrail treatment to to remain remain -Place 4 Temporary Kamehameha Check Dams @ 50' o.c. __/ Highway 🖻 Place Temporary 9" Diameter Fiber Roll Along Edge of Pavement ------<u>Legend</u> Type 3 Temporary ECM and Landscape Planting <u>Notes:</u> 1. Contractor shall field verify site conditions and ECM limits. 2. For ECM details, see Sheets EC-01 & EC-02. 3. For installation of ECM around obstacles, see Detail 5 on Sheet EC-01.

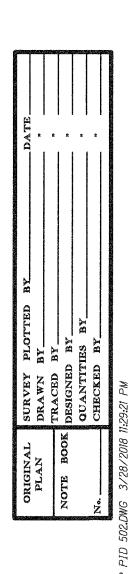


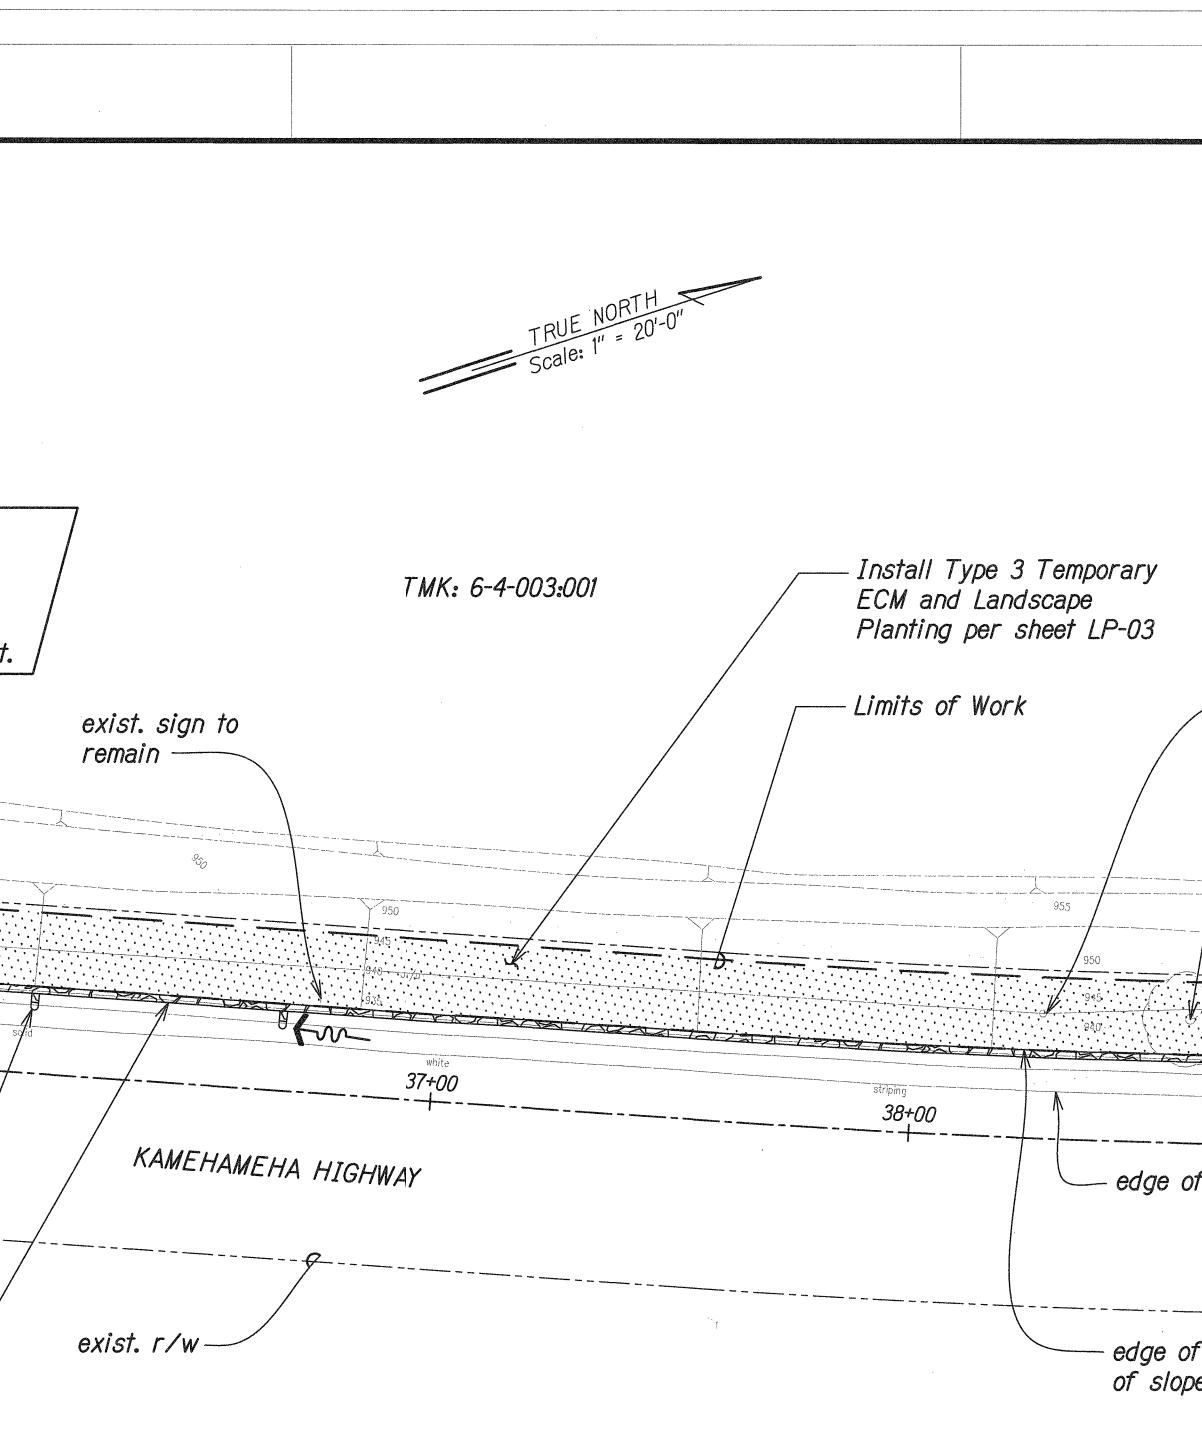


TEMPORARY EROSION CONTROL AND PERMANENT BMP PLAN <u>PID 502</u> Scale: 1" = 20'-0"

、 						
	FED. ROAD	STATE	PROJ. NO.	FISCAL	SHEET	TOTAL
	DIST. NO. HAWAII	HAW.	HWY-O-01-18	YEAR 2018	NO. 20	SHEETS 65
				NAMA GRECTARIA ANTI ANTI ANTI ANTI ANTI ANTI ANTI AN		
		r				
avict utility polo						
exist. utility pole to remain			1			
Demolish and Remove			N			
Exist. Tree; See Landscape Sheet LP-04			ST.			
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	50		AMEHAMEH. 40+00 SEE			
94	3)40					
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	-	100	40-17.			
f travel lane			EC-			-
	To Hale	eiwa —	HWAY &			
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			ł			
BON H.	Singhaman in an ann	DEPAR	STATE OF HA		ΓΑΤΙΟΝ	
LICENSED PROFESSIONAL * ENGINEER *	TEM		HIGHWAYS DI	VISION		
NO. 9360-C		• LV	PID 5		ואט	
4/30/18			OVEMENTS FO	DR EROS		
This work was prepared by		Pr	<u>OUS SITES OI</u> oject No. HV	NY-0-01	<u>1-18</u>	
nis work was prepared by me or under my supervision.		1" = 20	-0" No. <i>EC-06</i> OF	Da	ate: Apr	
				2(0	
					-	

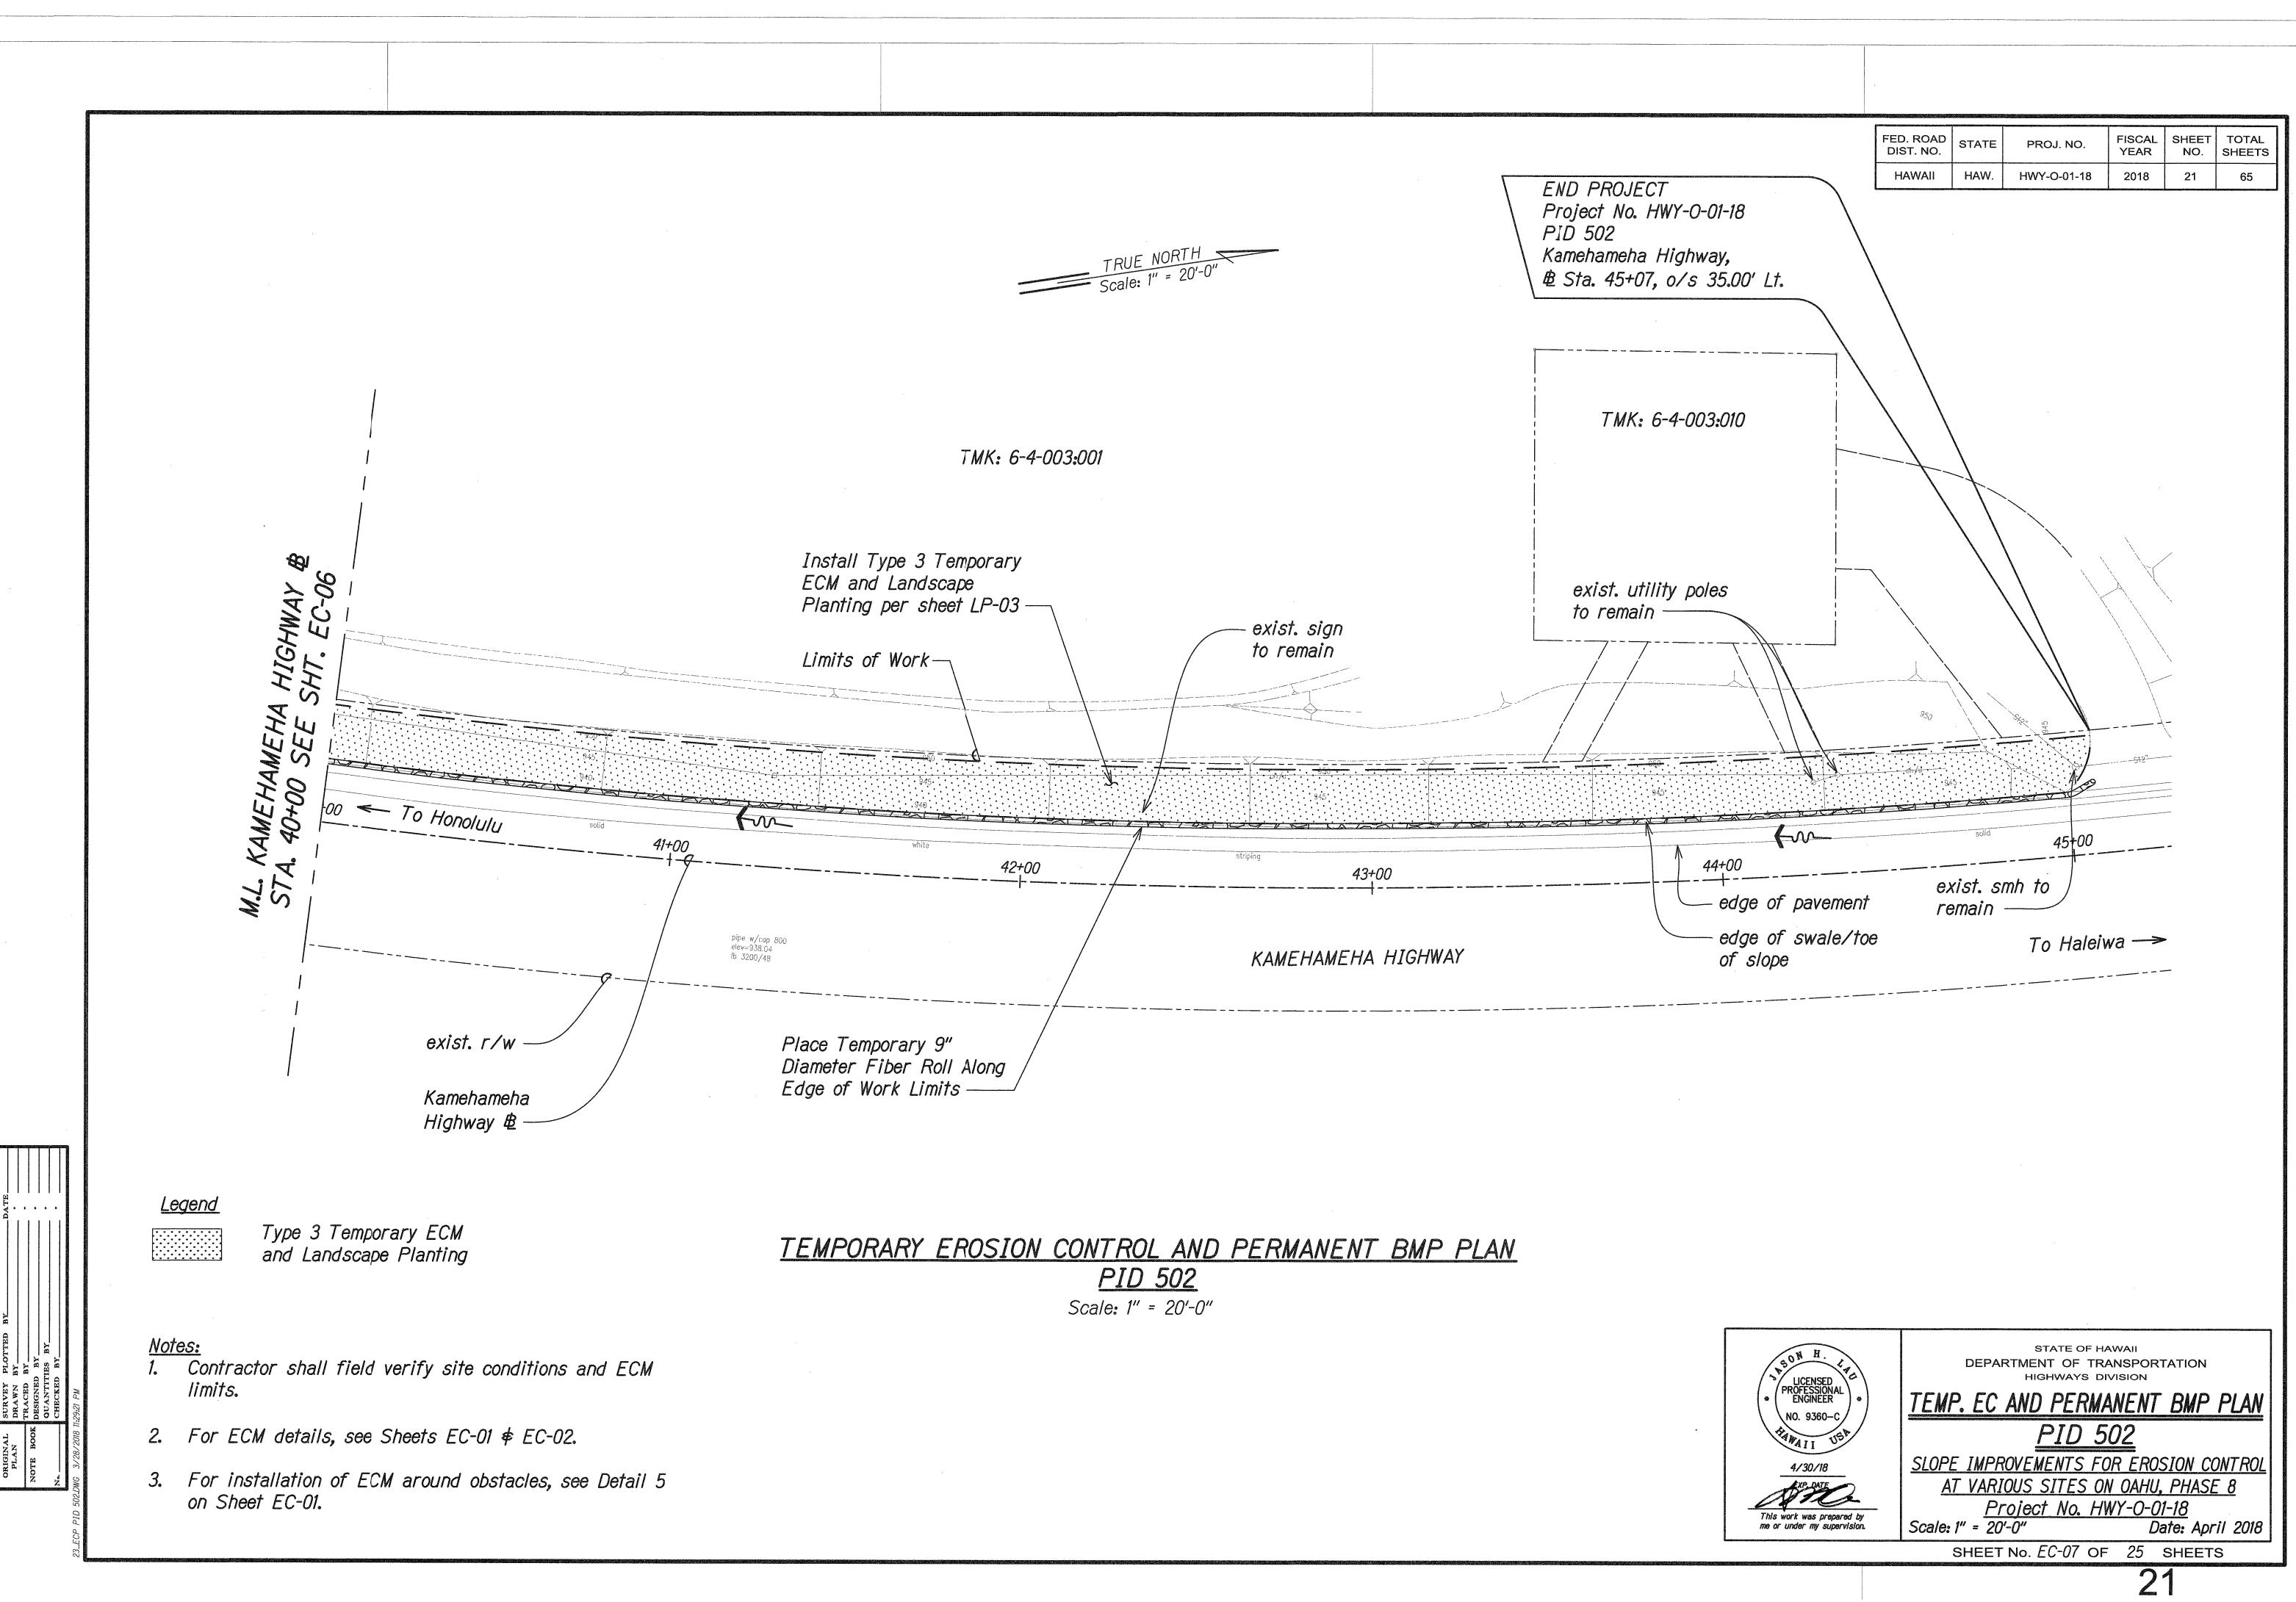

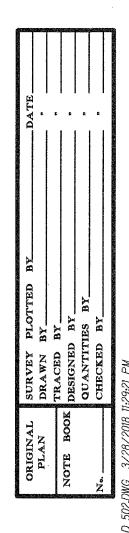

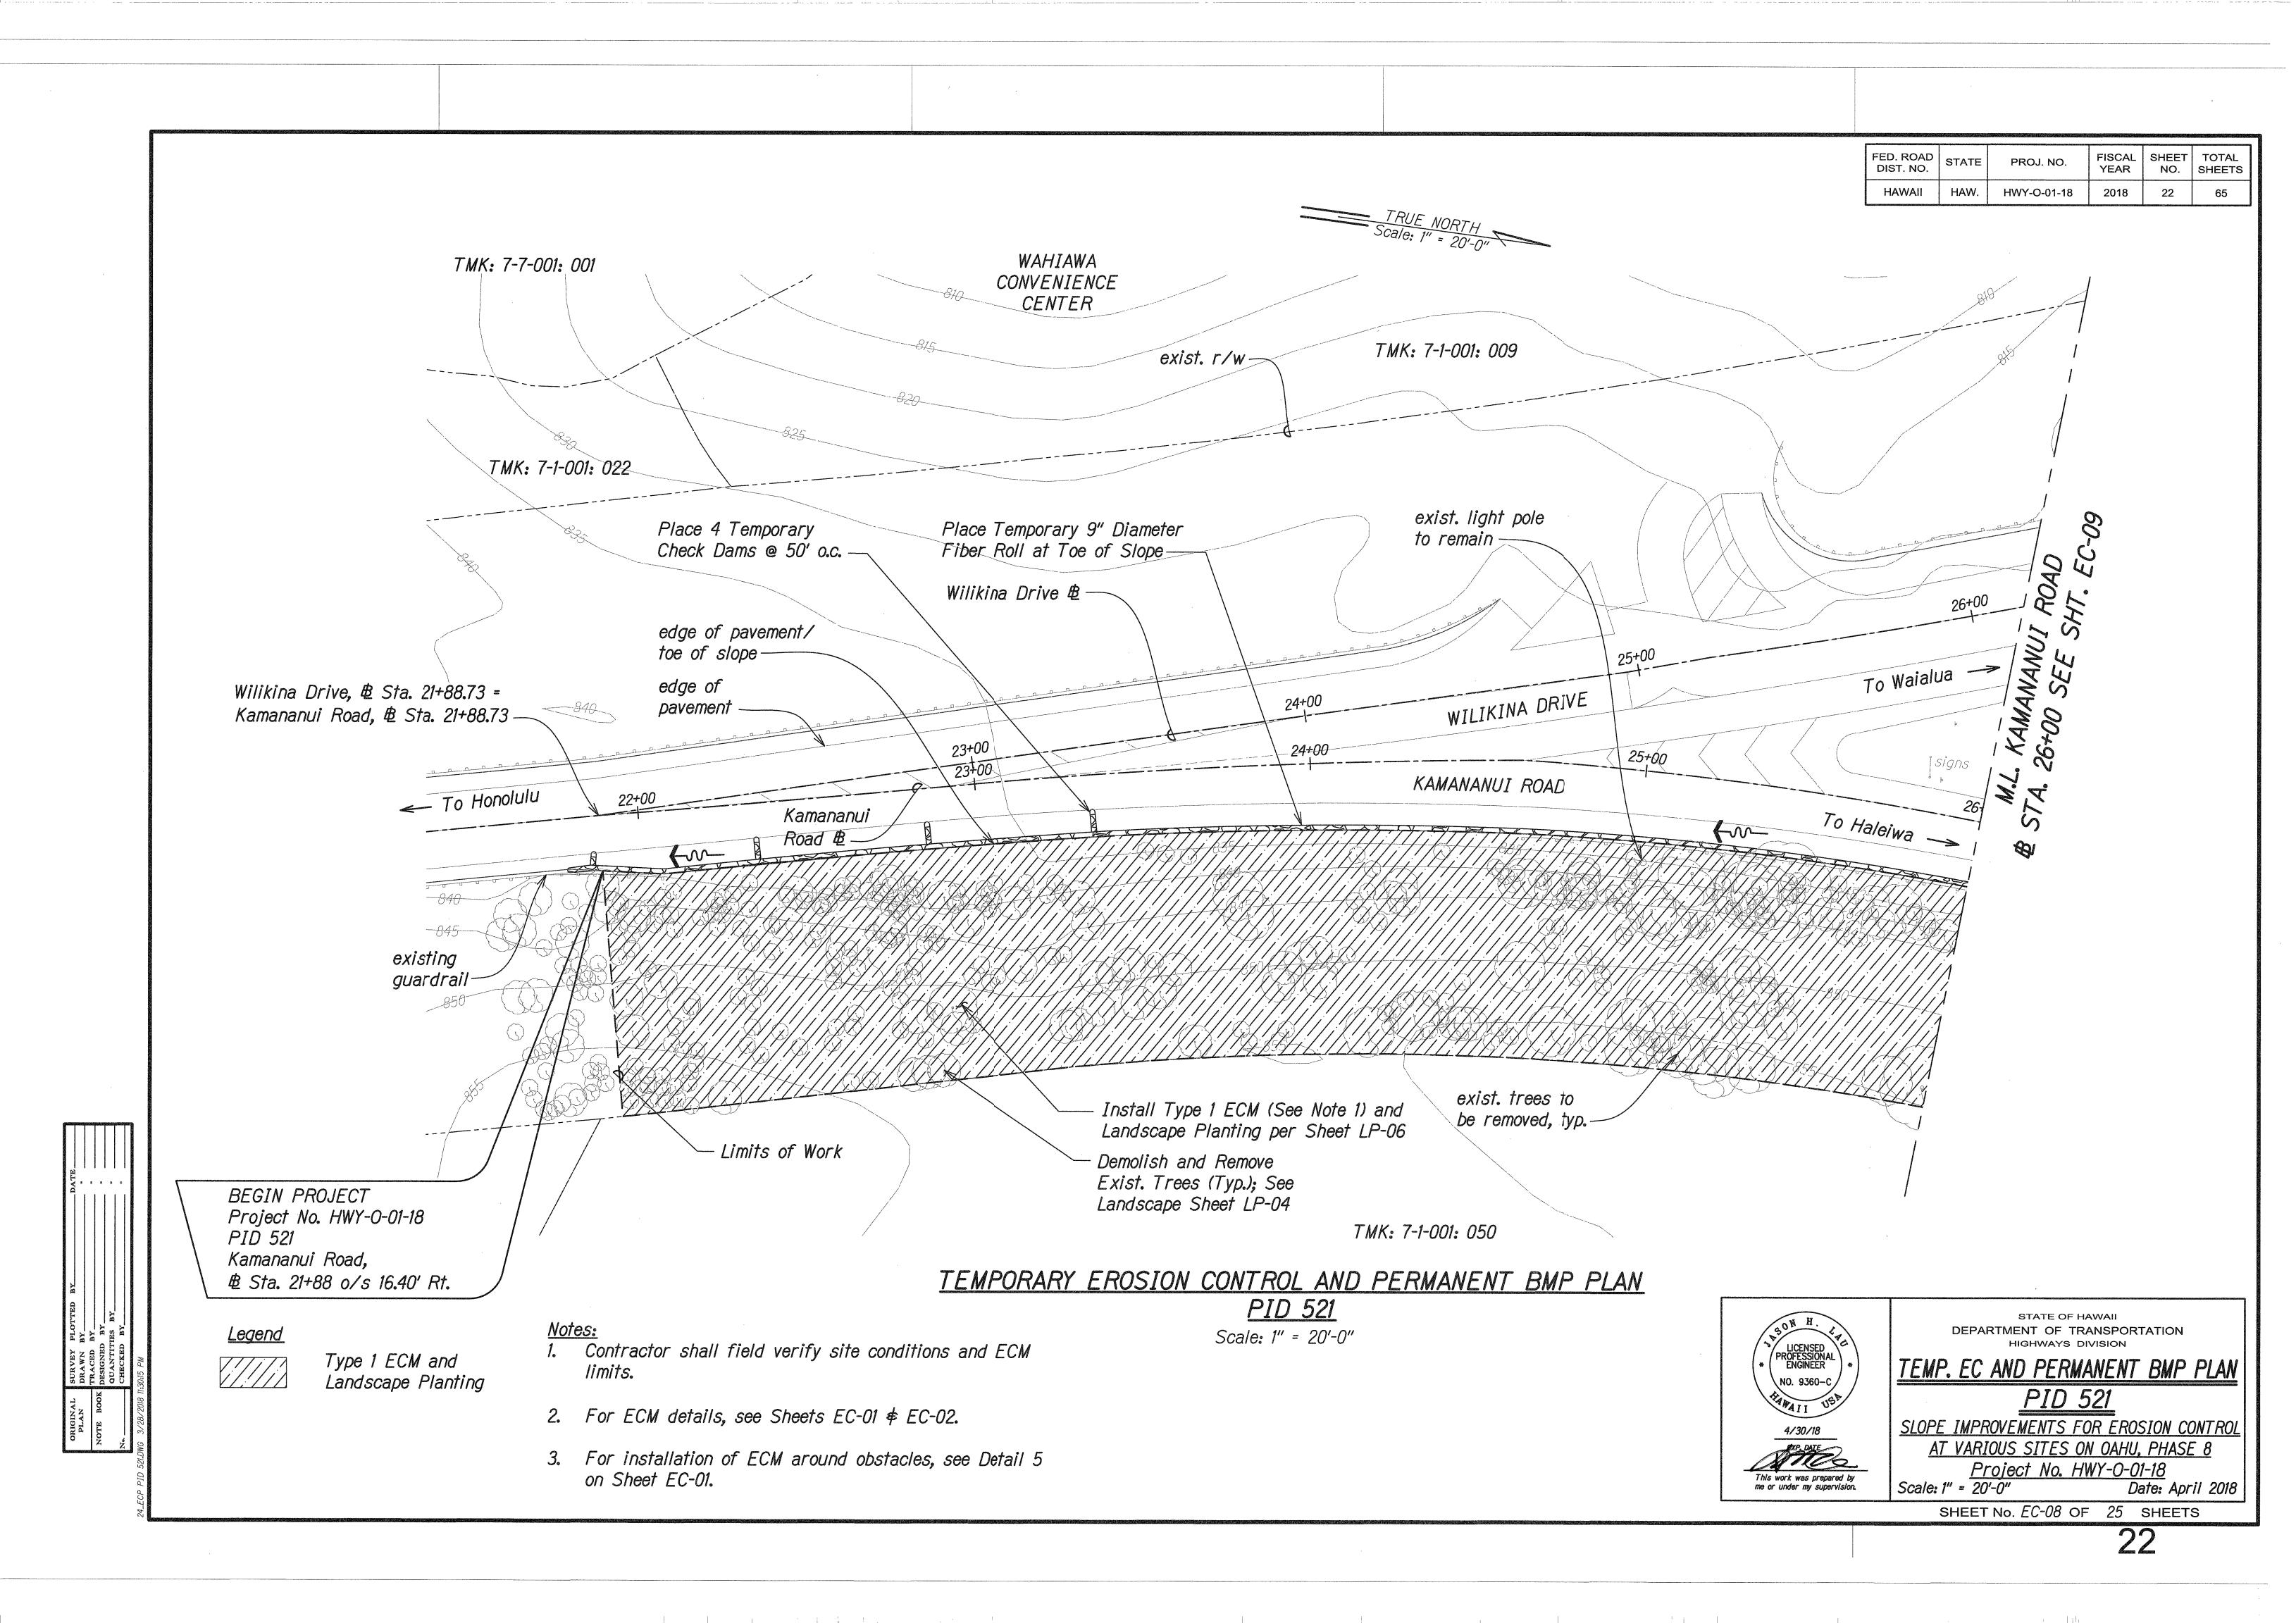

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PL(BY BY SUR DRA TRA(DESIC ORIGINAL PLAN NOTE BOOK

Legend

Type 1 ECM and Landscape Planting

<u>Notes:</u>

limits.

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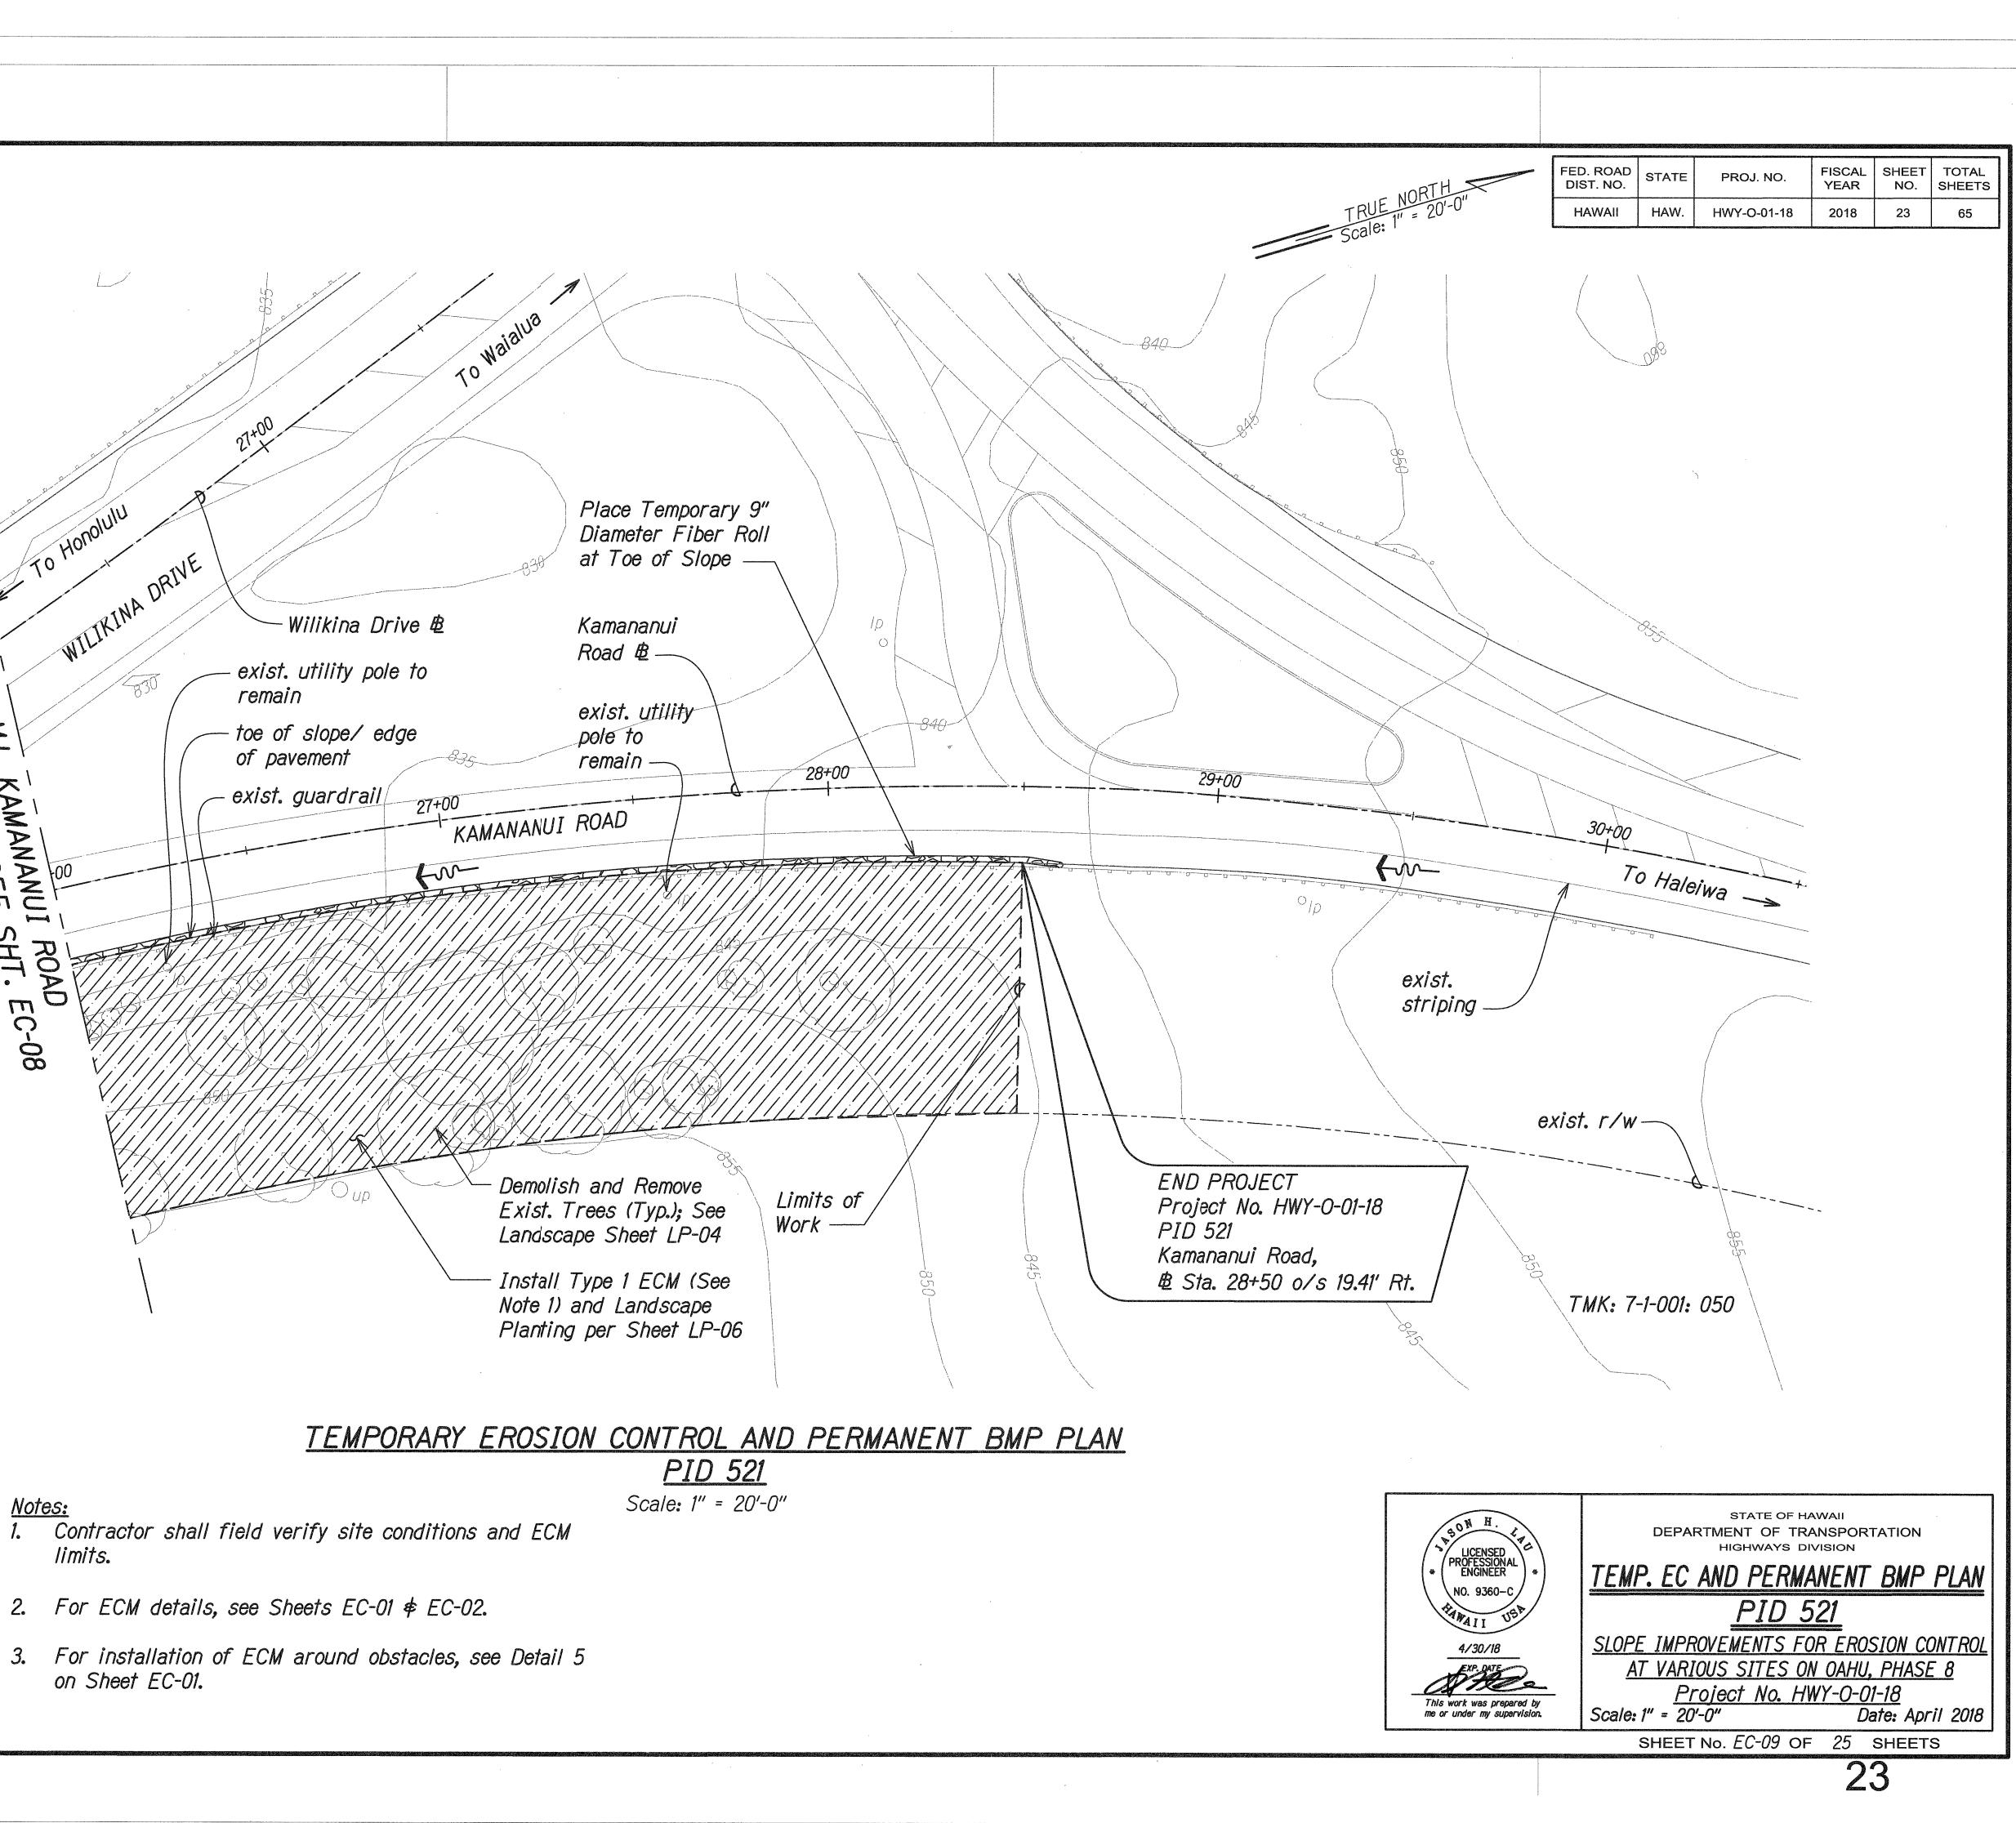
KAMANANUI 26+00 SEE

EC,

. 08 08


SHT.E


- on Sheet EC-01.





TRUE NORTH Scale: 1" = 20'-0" TMK: 9-4-005: 002 BEGIN PROJECT STATE OF HAWAII Project No. HWY-0-01-18 — Install Type 2 ECM (See PID 149 Note 1) and Landscape Planting per sheet LP-07 Kamehameha Highway, B Sta. 70+22, o/s 40.47' Rt. - Limits of Work Hydromulched Landscape Planting per sheet LP-07 exist. utility box to remain exist. guardrail to remain -Cart Ar Ar the strain m m solid white <- To Mililani toe of slope 00 68+00 69+00 70+00 edge of pavement Place 4 Temporary KAMEHAMEHA HIGHWAY Check Dams @ 50' o.c. -Share and and and and and and and a lot in the state white striping 0 exist. grp end treatment to remain Kamehameha Highway 🕏 Place Temporary 9" Diameter Fiber Roll along edge of pavement -TEMPORARY EROSION CONTROL AND PERMANENT BMP PLAN <u>PID 149</u> Scale: 1" = 20'-0" Legend <u>Notes:</u> Hydromulch Landscape 1. Contractor shall field verify site conditions and ECM PL BY BY BY BY Planting limits. SURVEY DRAWN TRACED DESIGNEI QUANTI CHECKEI Type 2 ECM and Landscape Planting 2. For ECM details, see Sheets EC-01 & EC-02. ORIGINAL PLAN NOTE BOOK 3. For installation of ECM around obstacles, see Detail 5 on Sheet EC-01.


FED. ROAD DIST. NO.	STATE	n an	FISCAL YEAR	SHEET NO.	TOTAL SHEETS

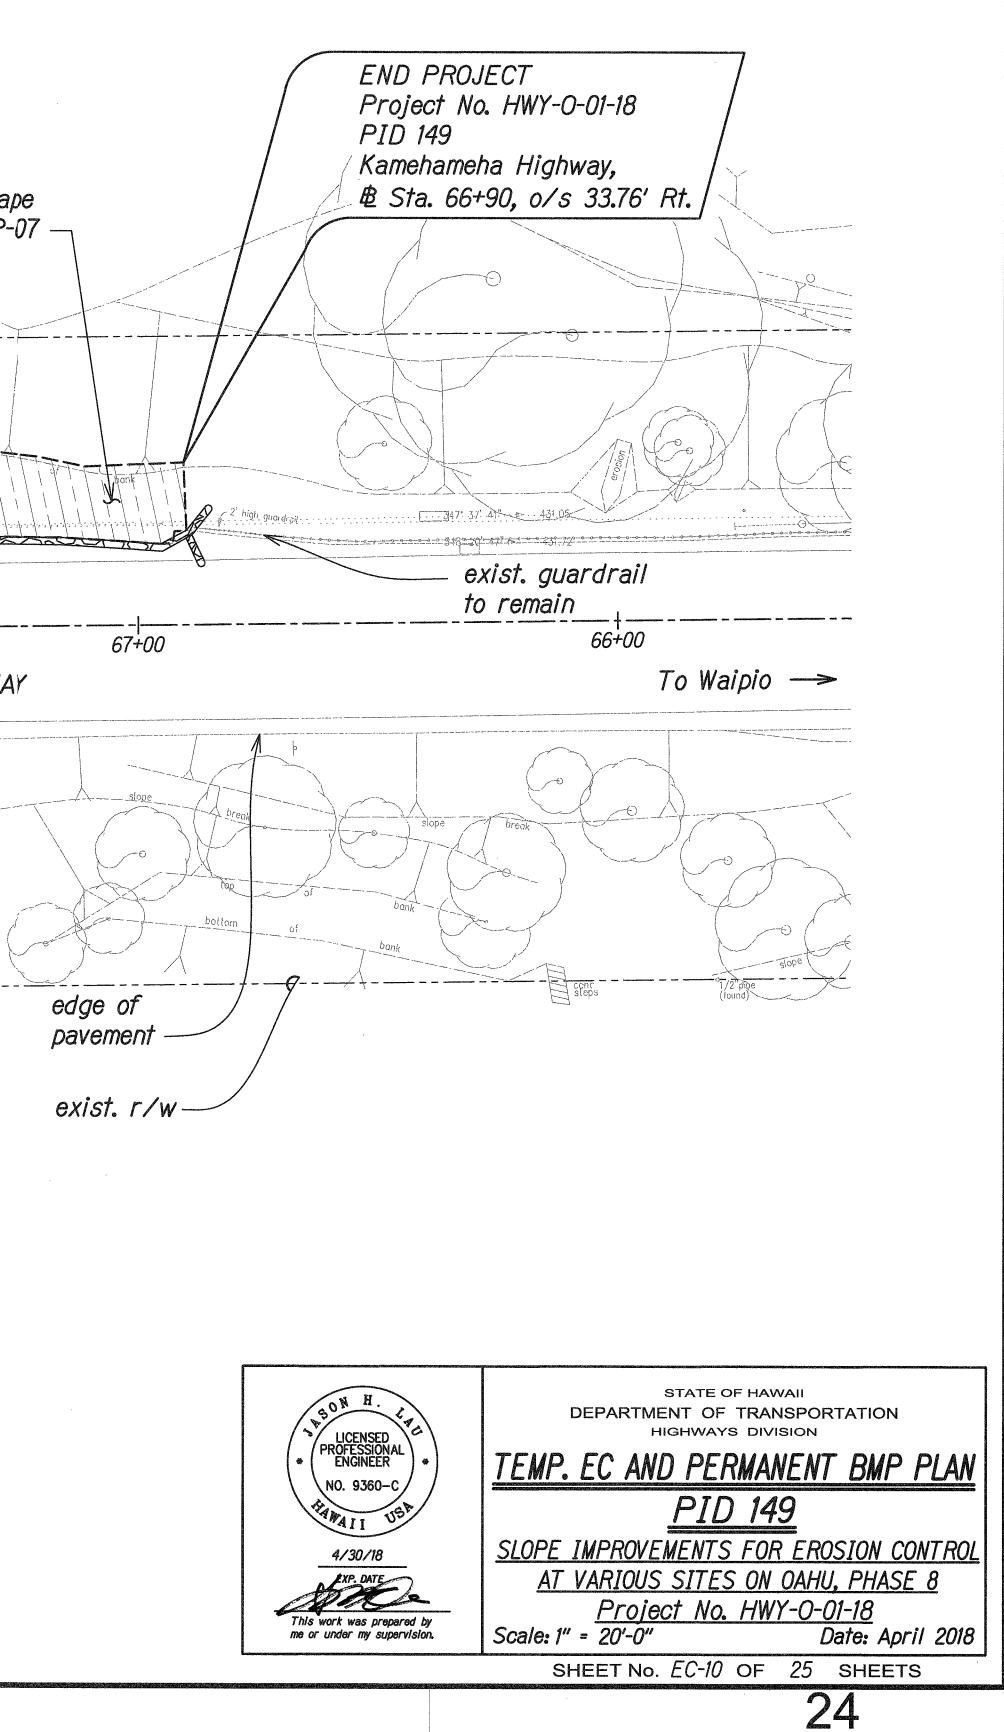


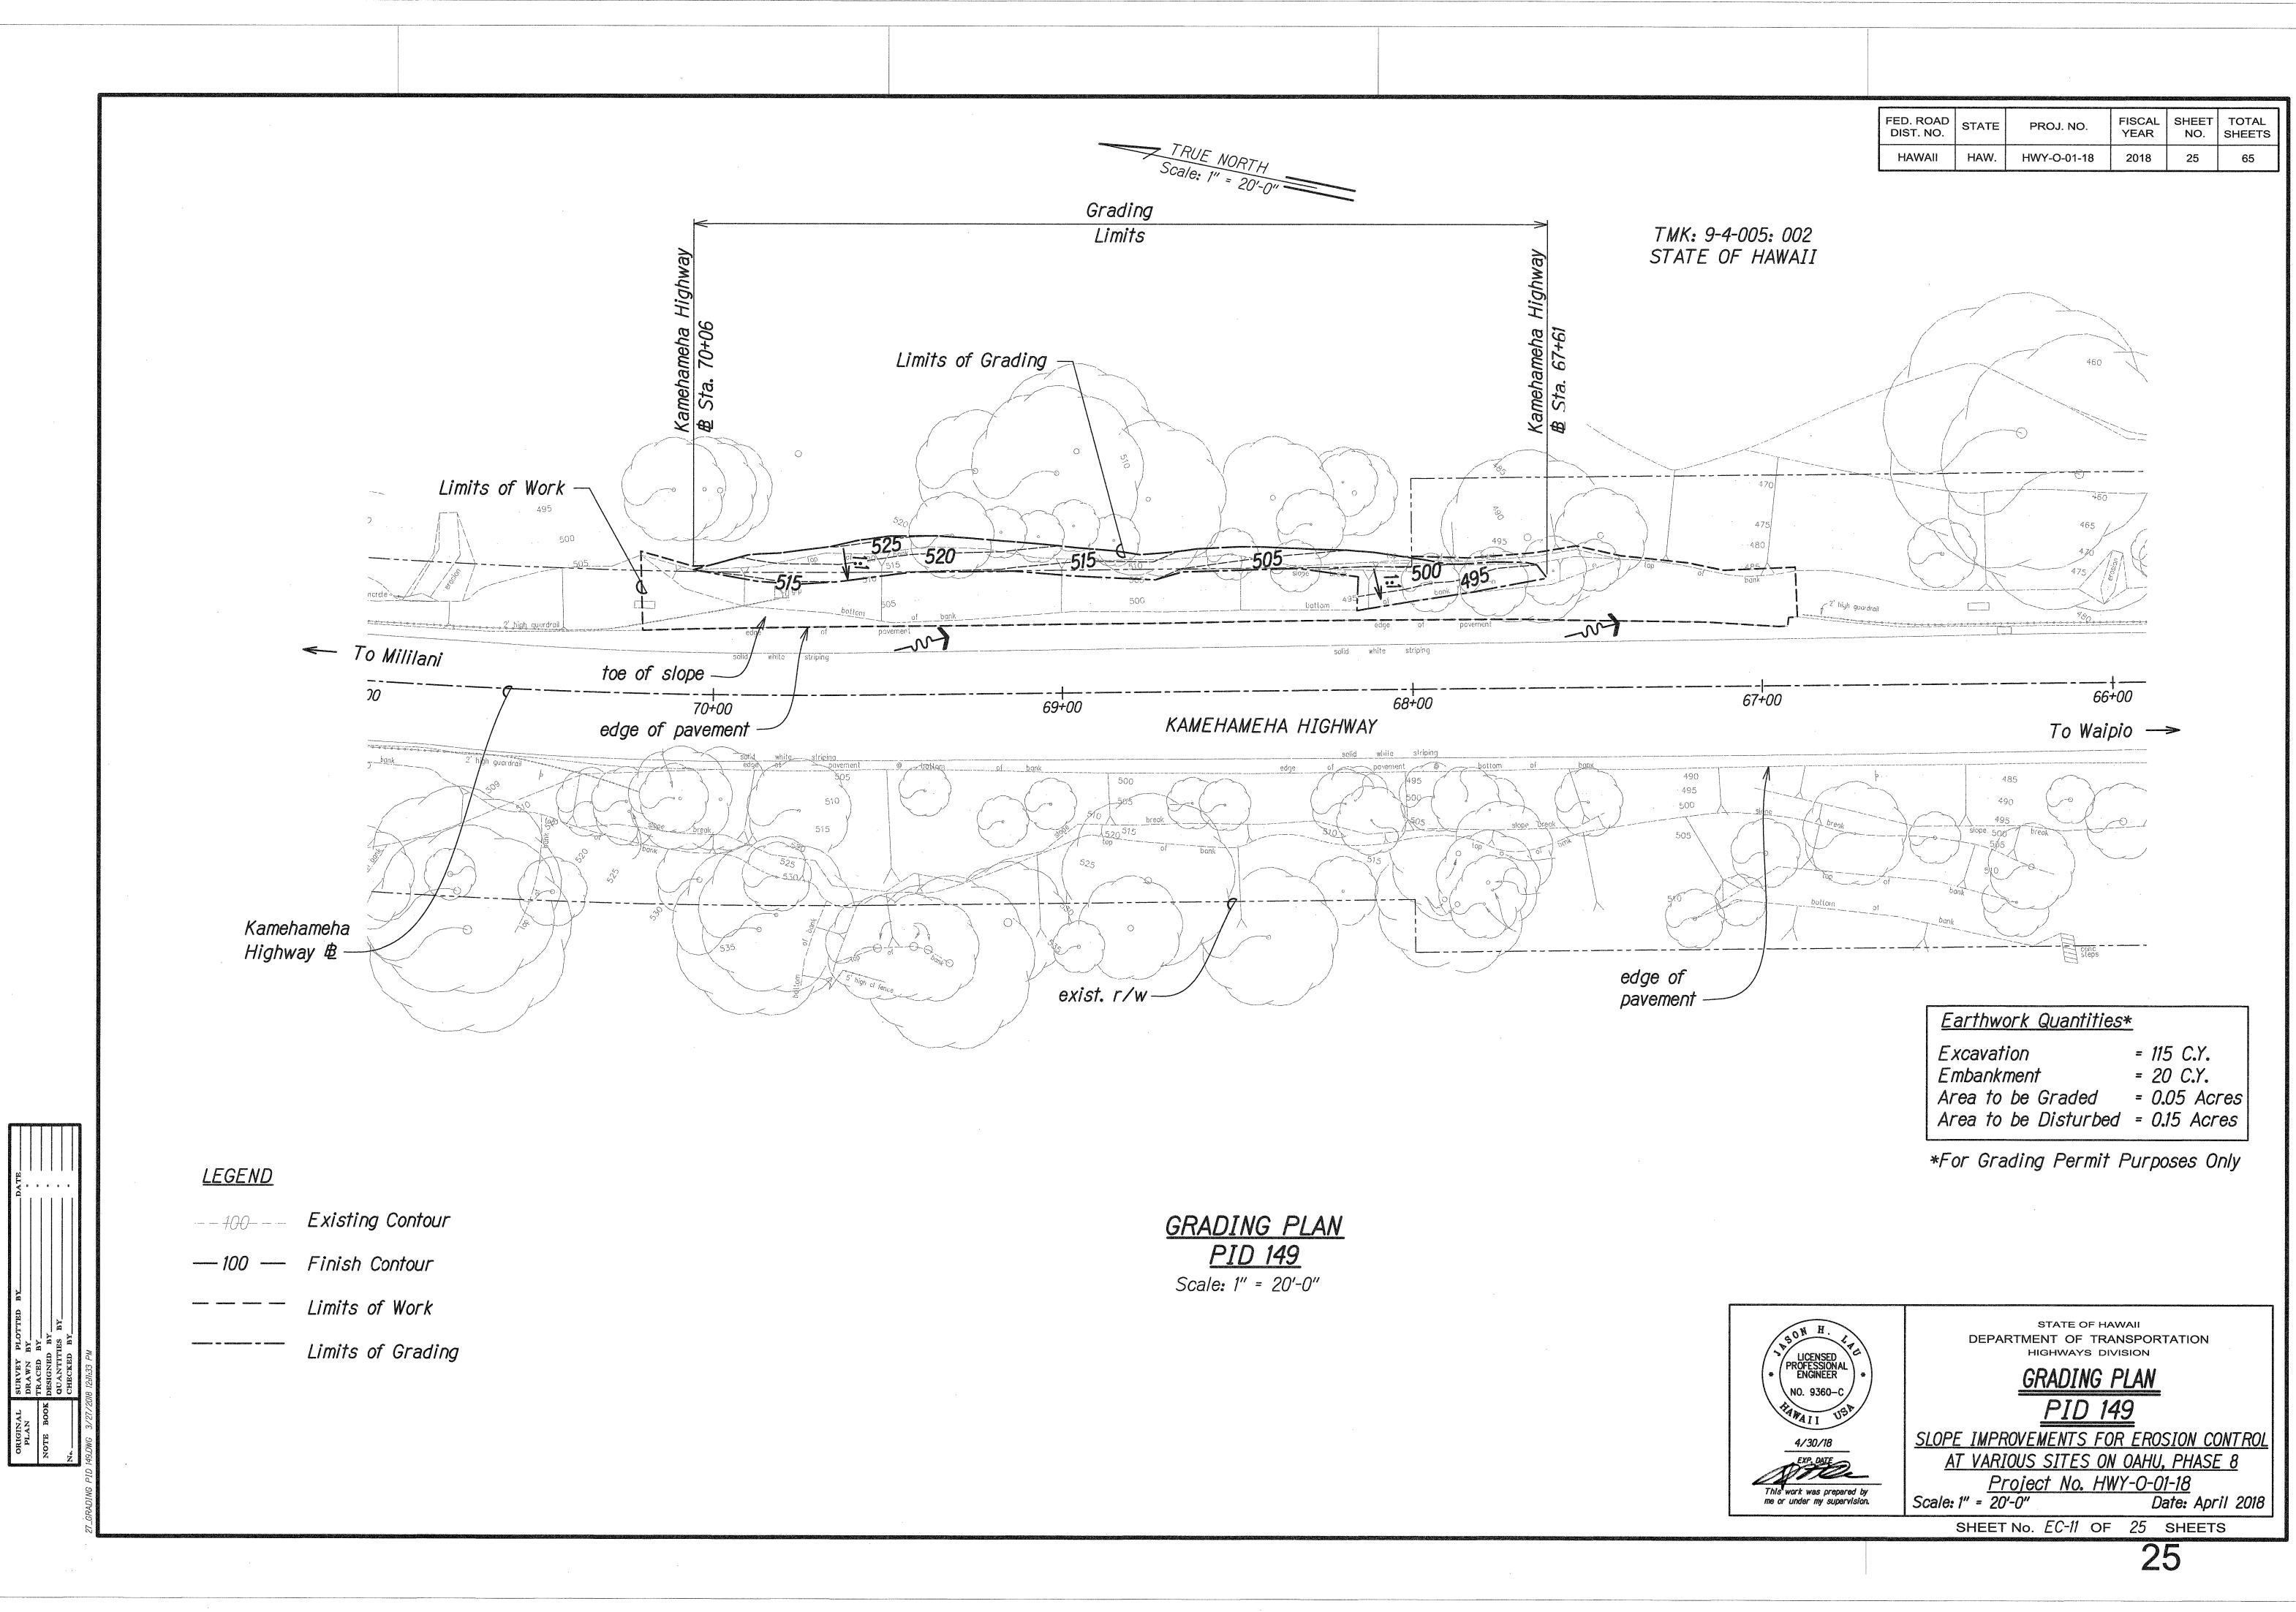


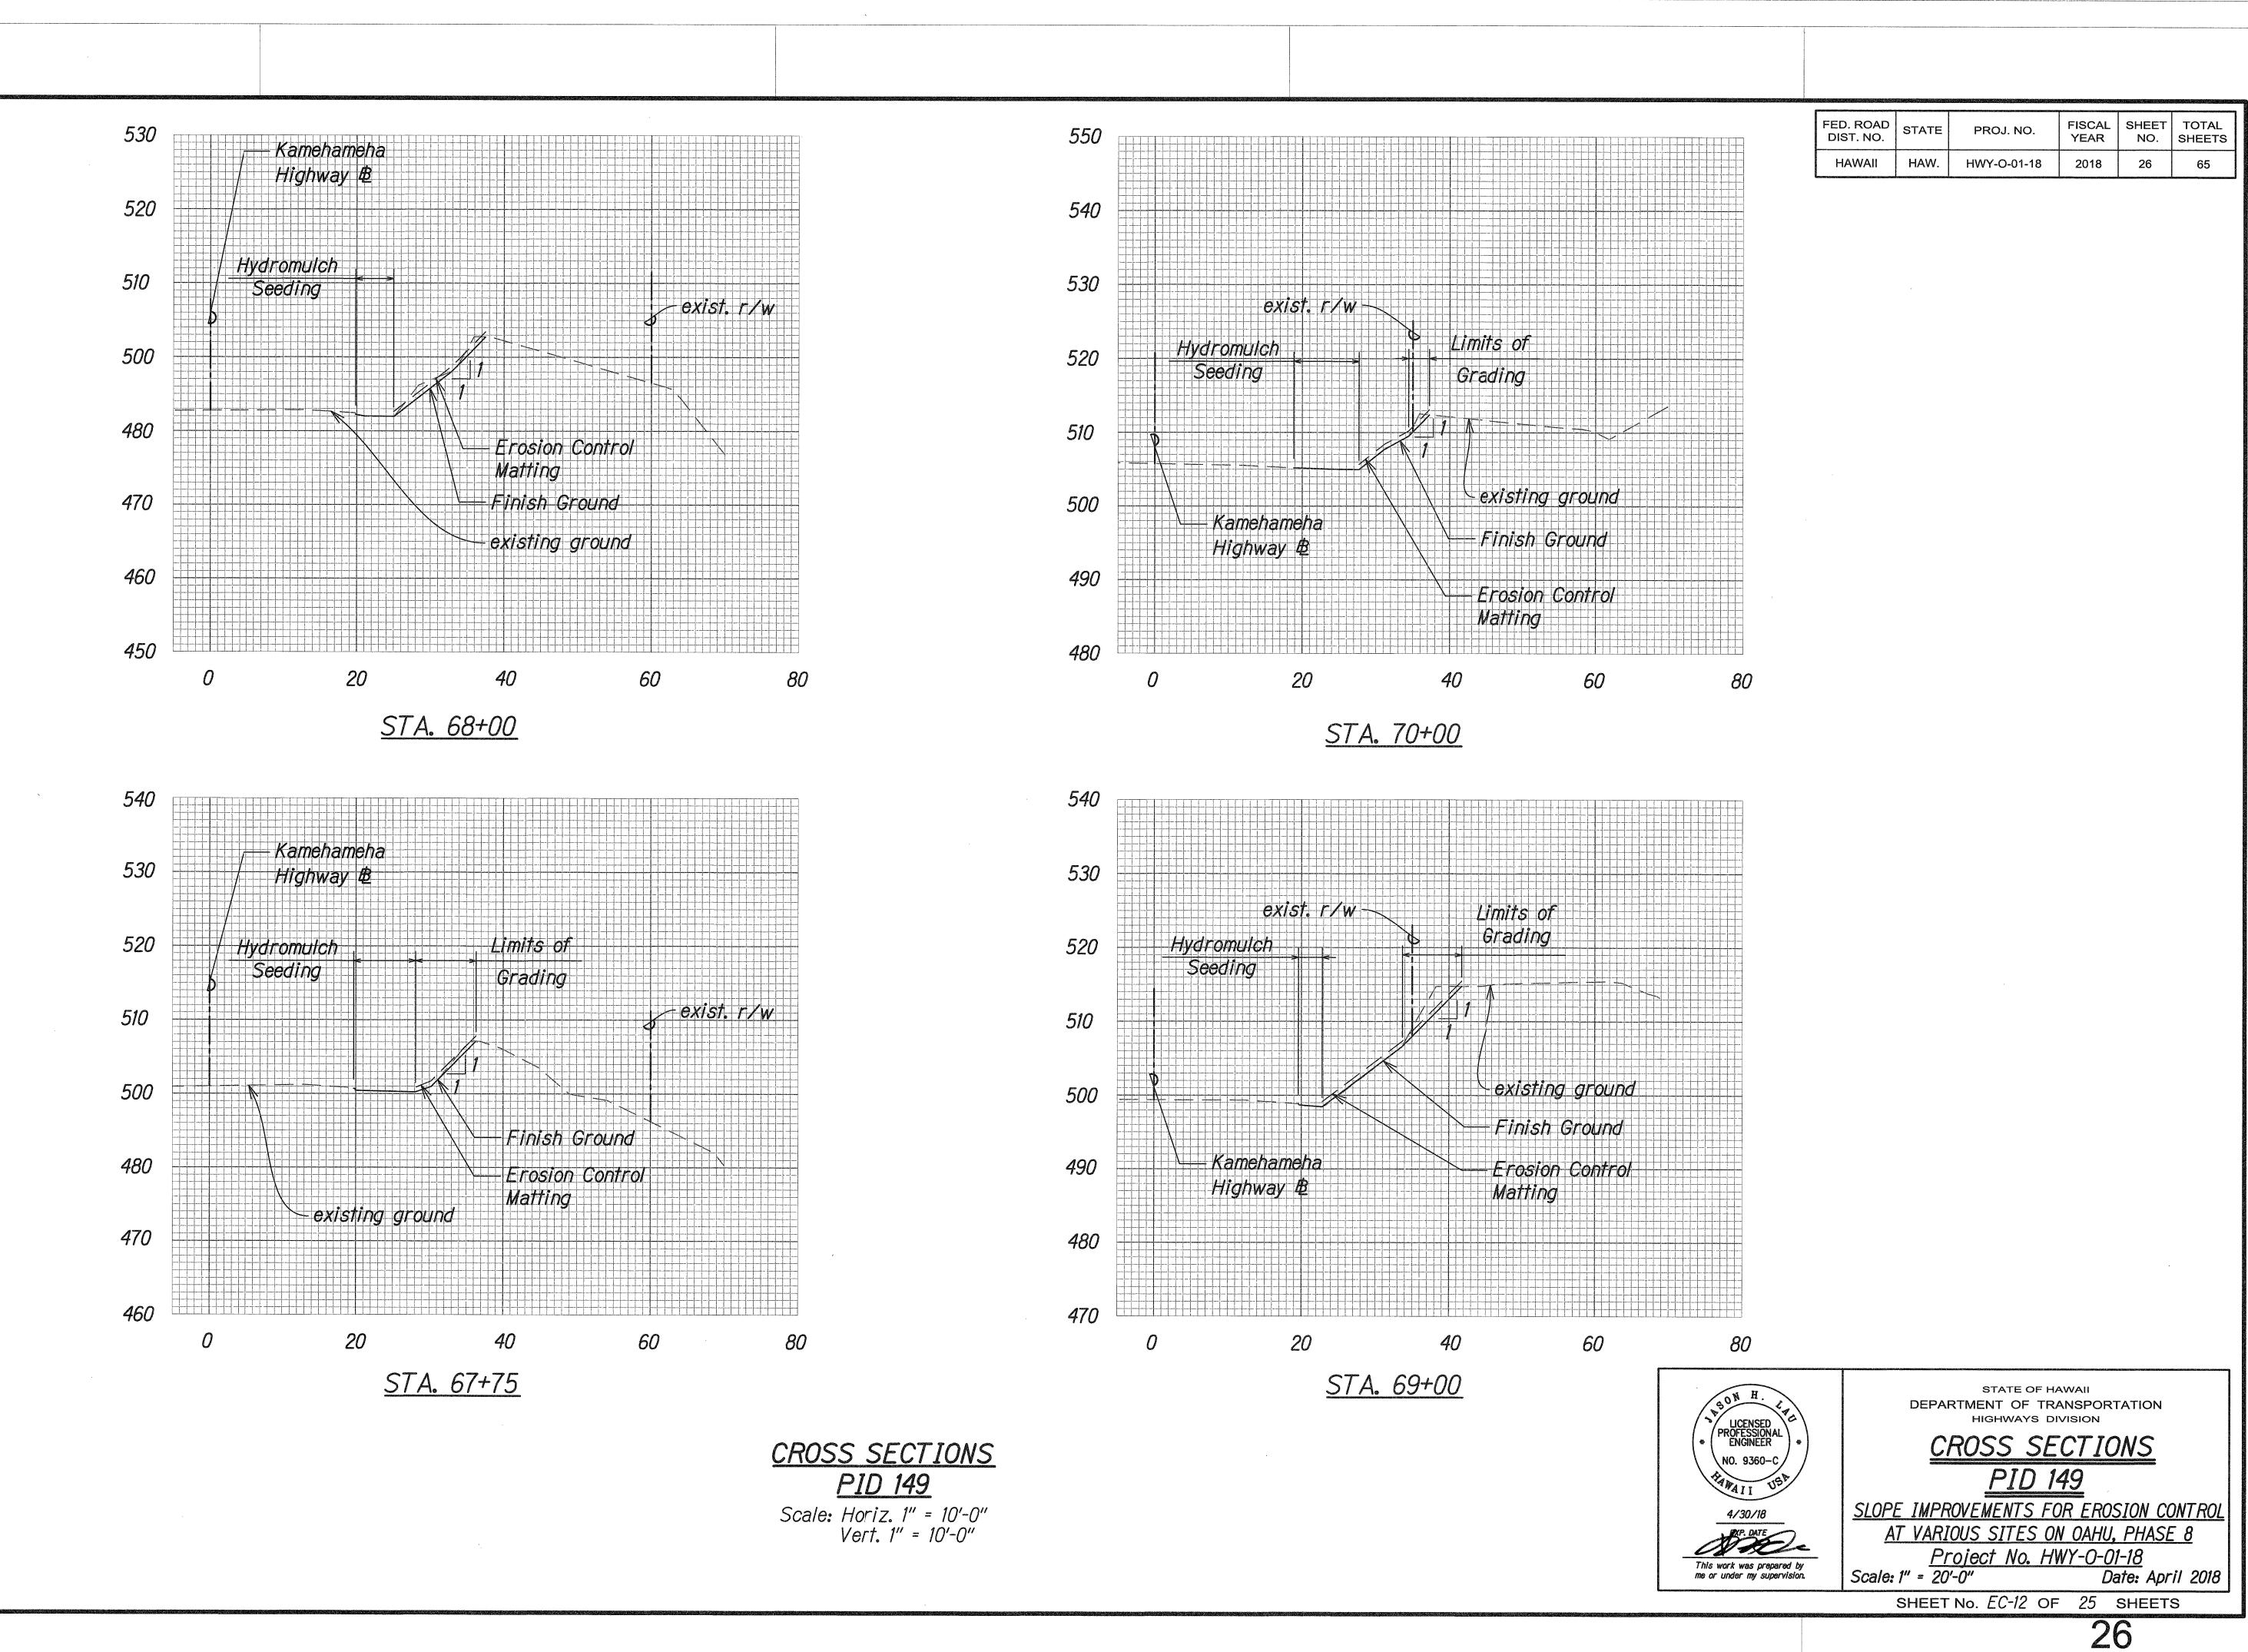

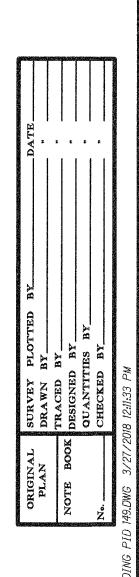

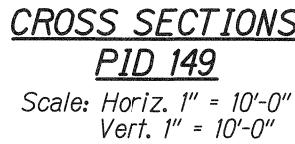


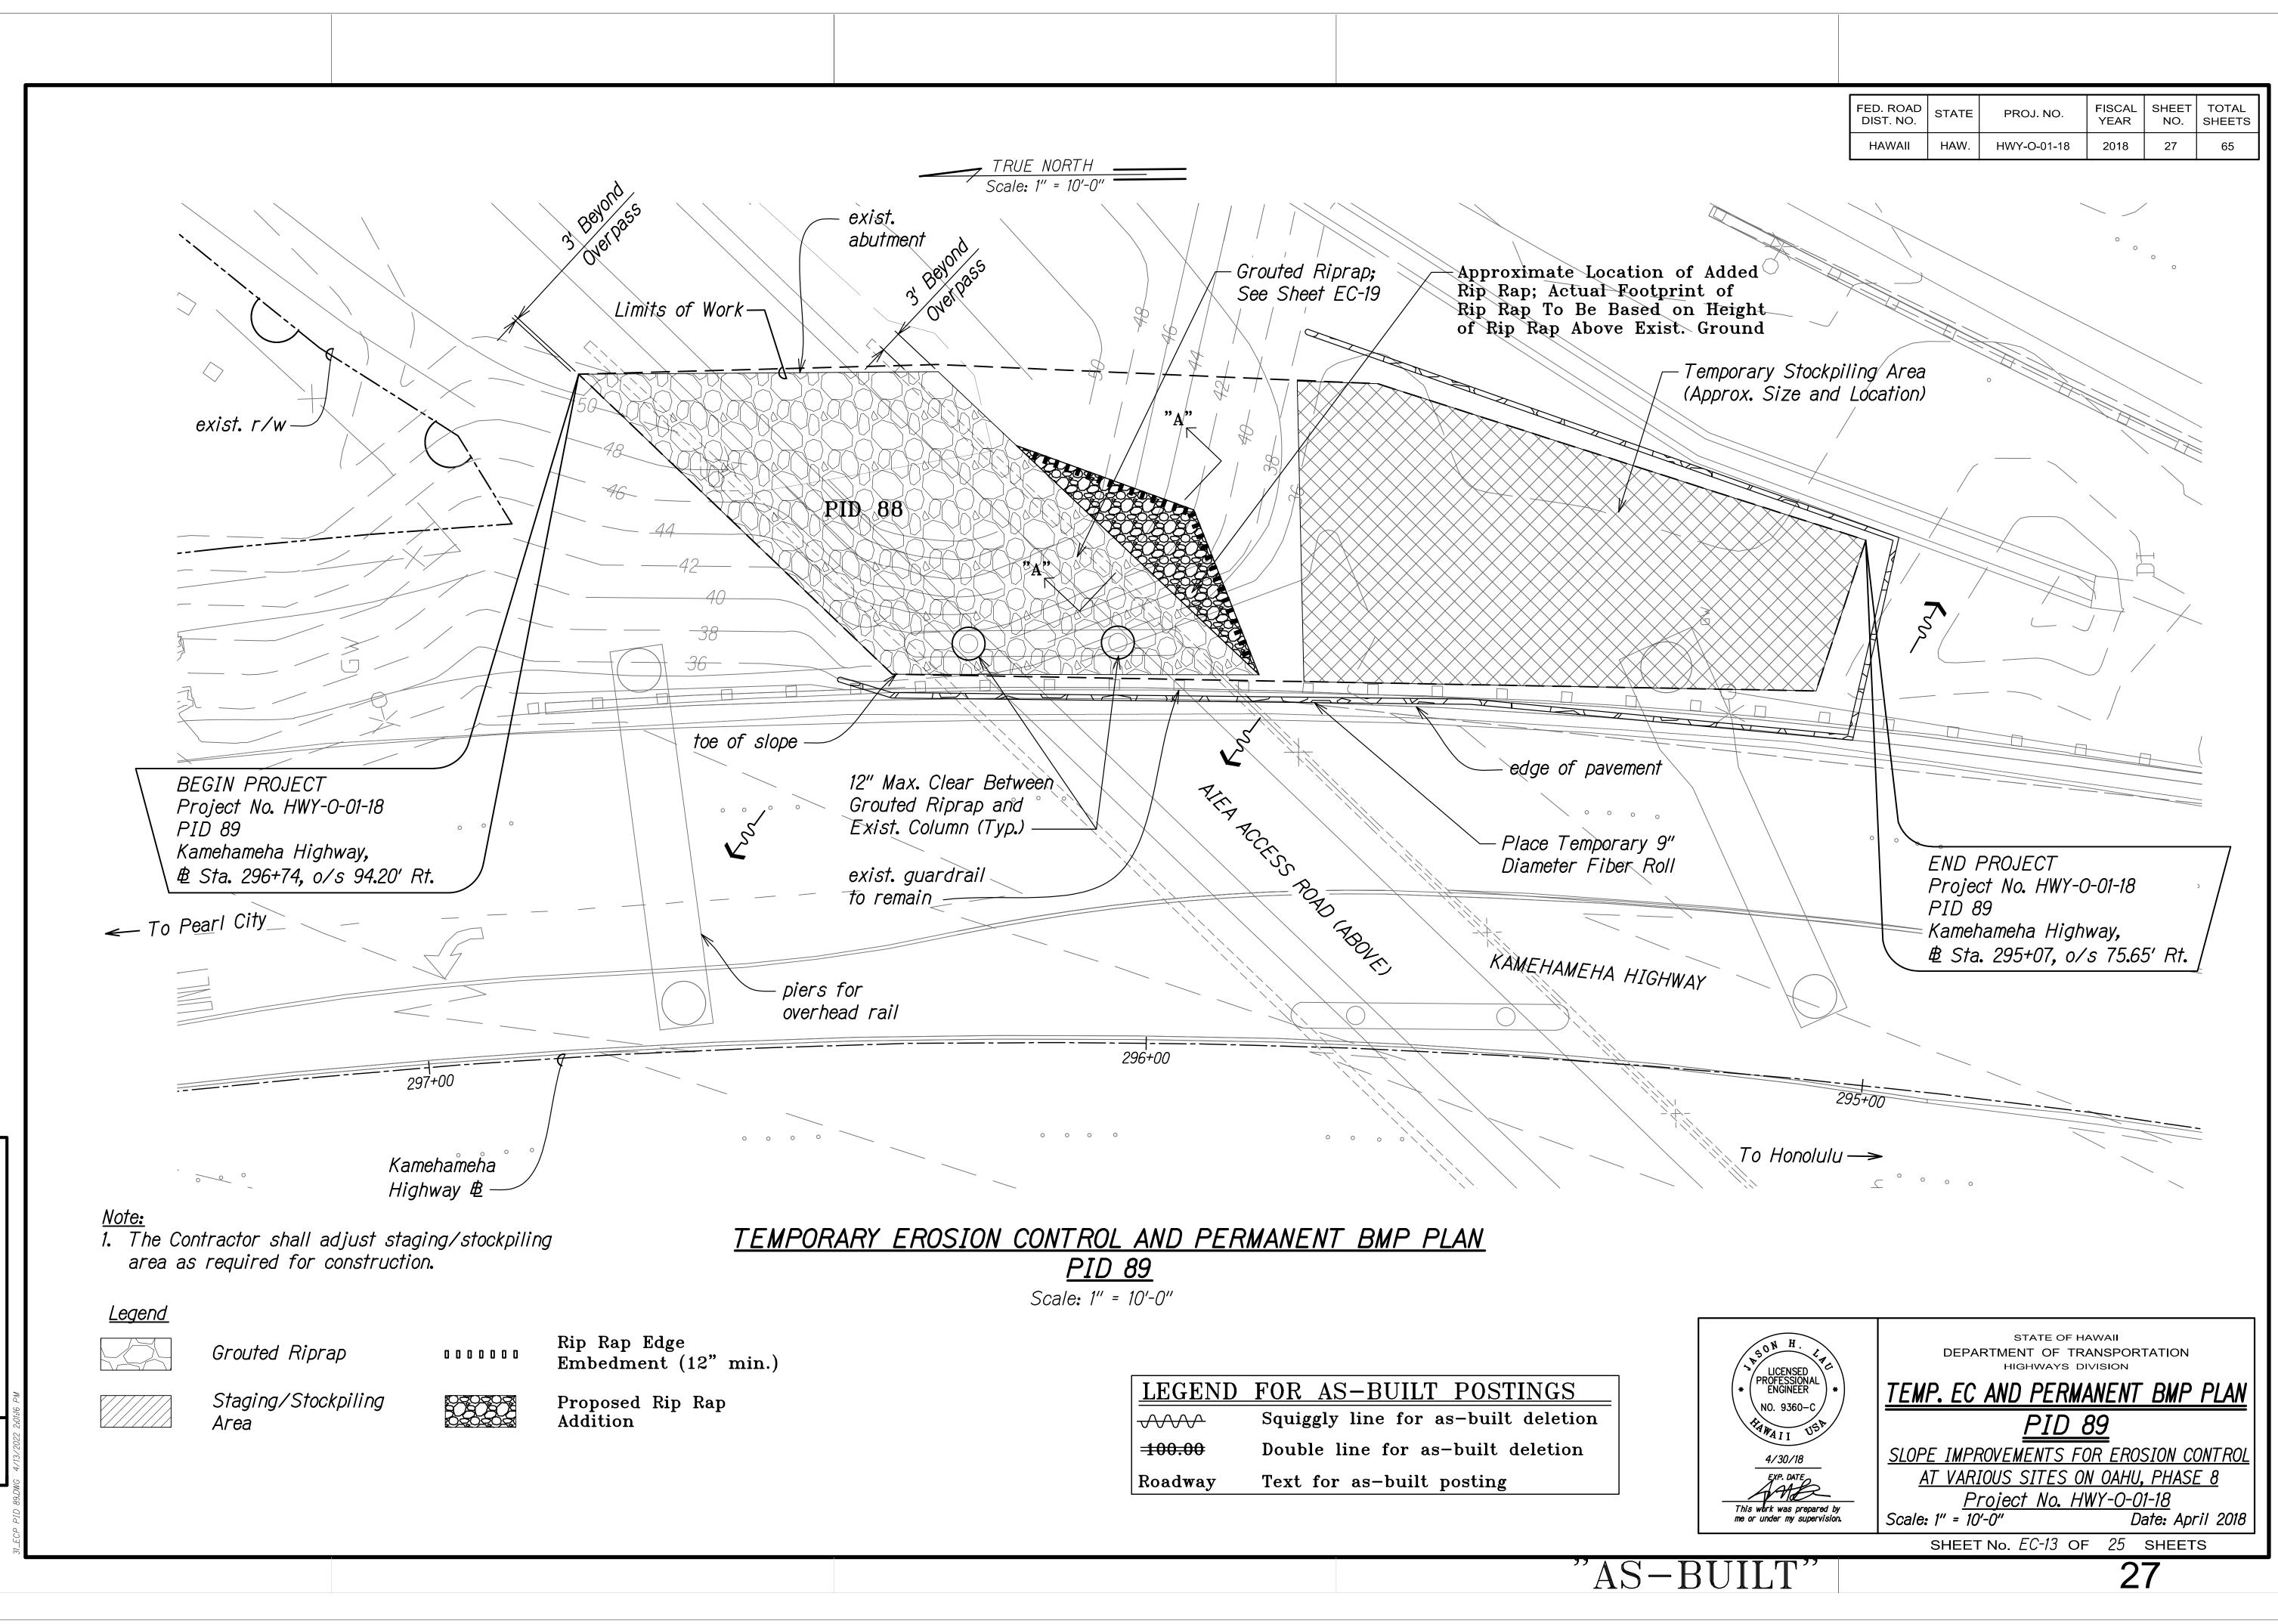


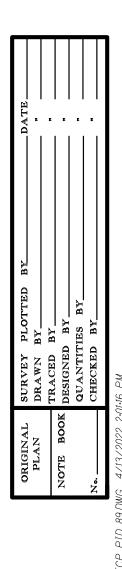



<u>LEGEND</u>	FOR AS-BUILT POSTI
	Squiggly line for as-built
-100.00	Double line for as-built de
Roadway	Text for as-built posting

	Constructed Rip Rap (Max Slope of L.SH:1V) Compared Baskfill Compared Baskfill
ORIGINAL UNEVER PLOTTED BY DATE PLAN DIAWN BY DAWN BY NOTE BOX DIAWN BY DATE Note BOX DIAWN BY DATE Note BOX DIAWN BY DATE No. DIAW DIAWN BY DATE No. DIAWN DIAWN BY DATE No. DIAWN DIAWN DIAWN No. OLANTITES BY DIAWN DIAWN DIAMN S/2/2020 BASA AA DIAWN DIAWN	PID 89 SECTION "A-A" Soale: Not to Scale

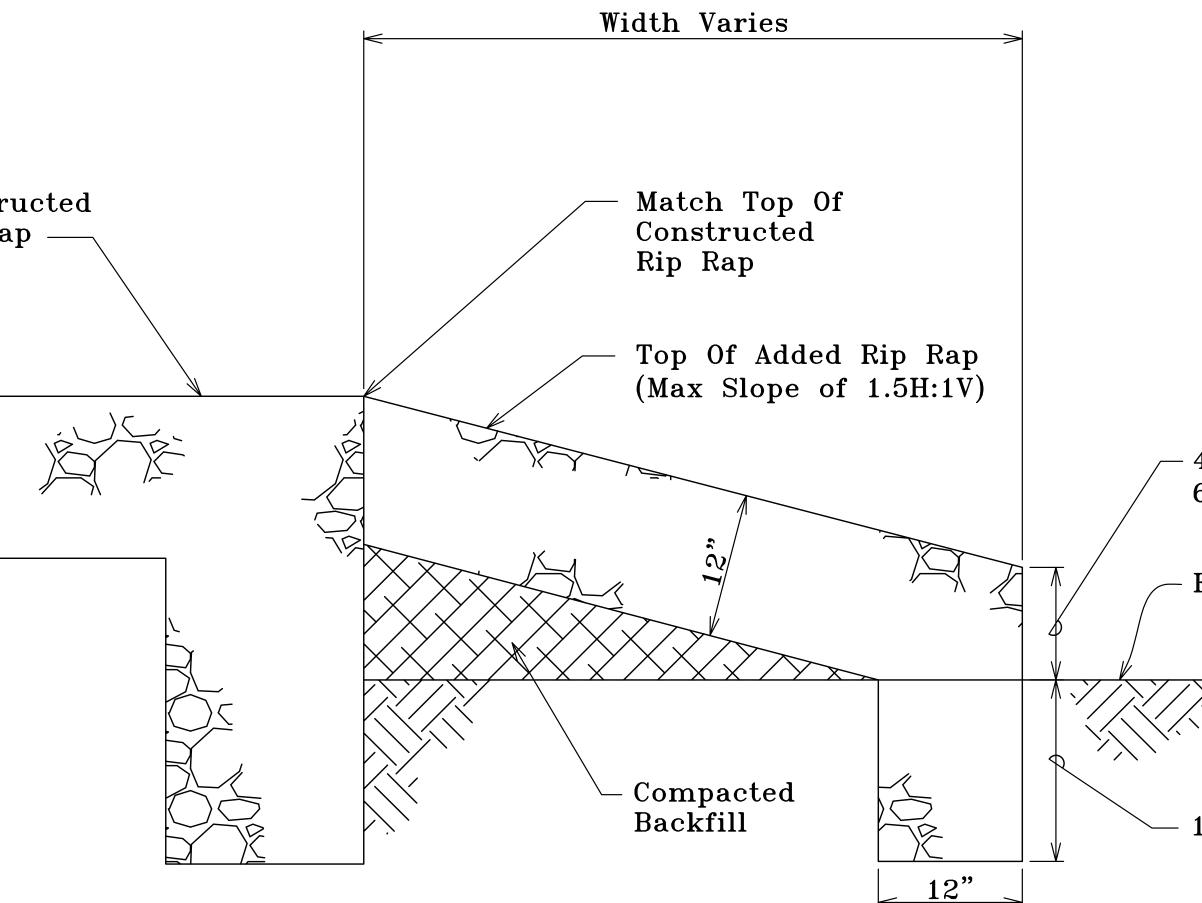

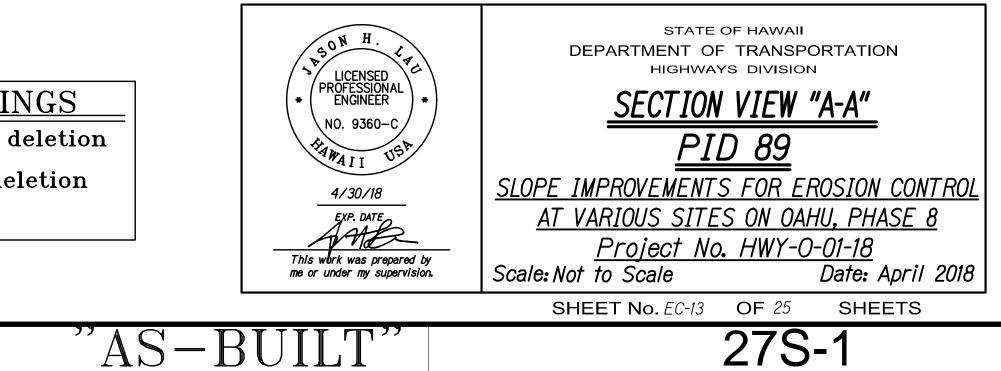


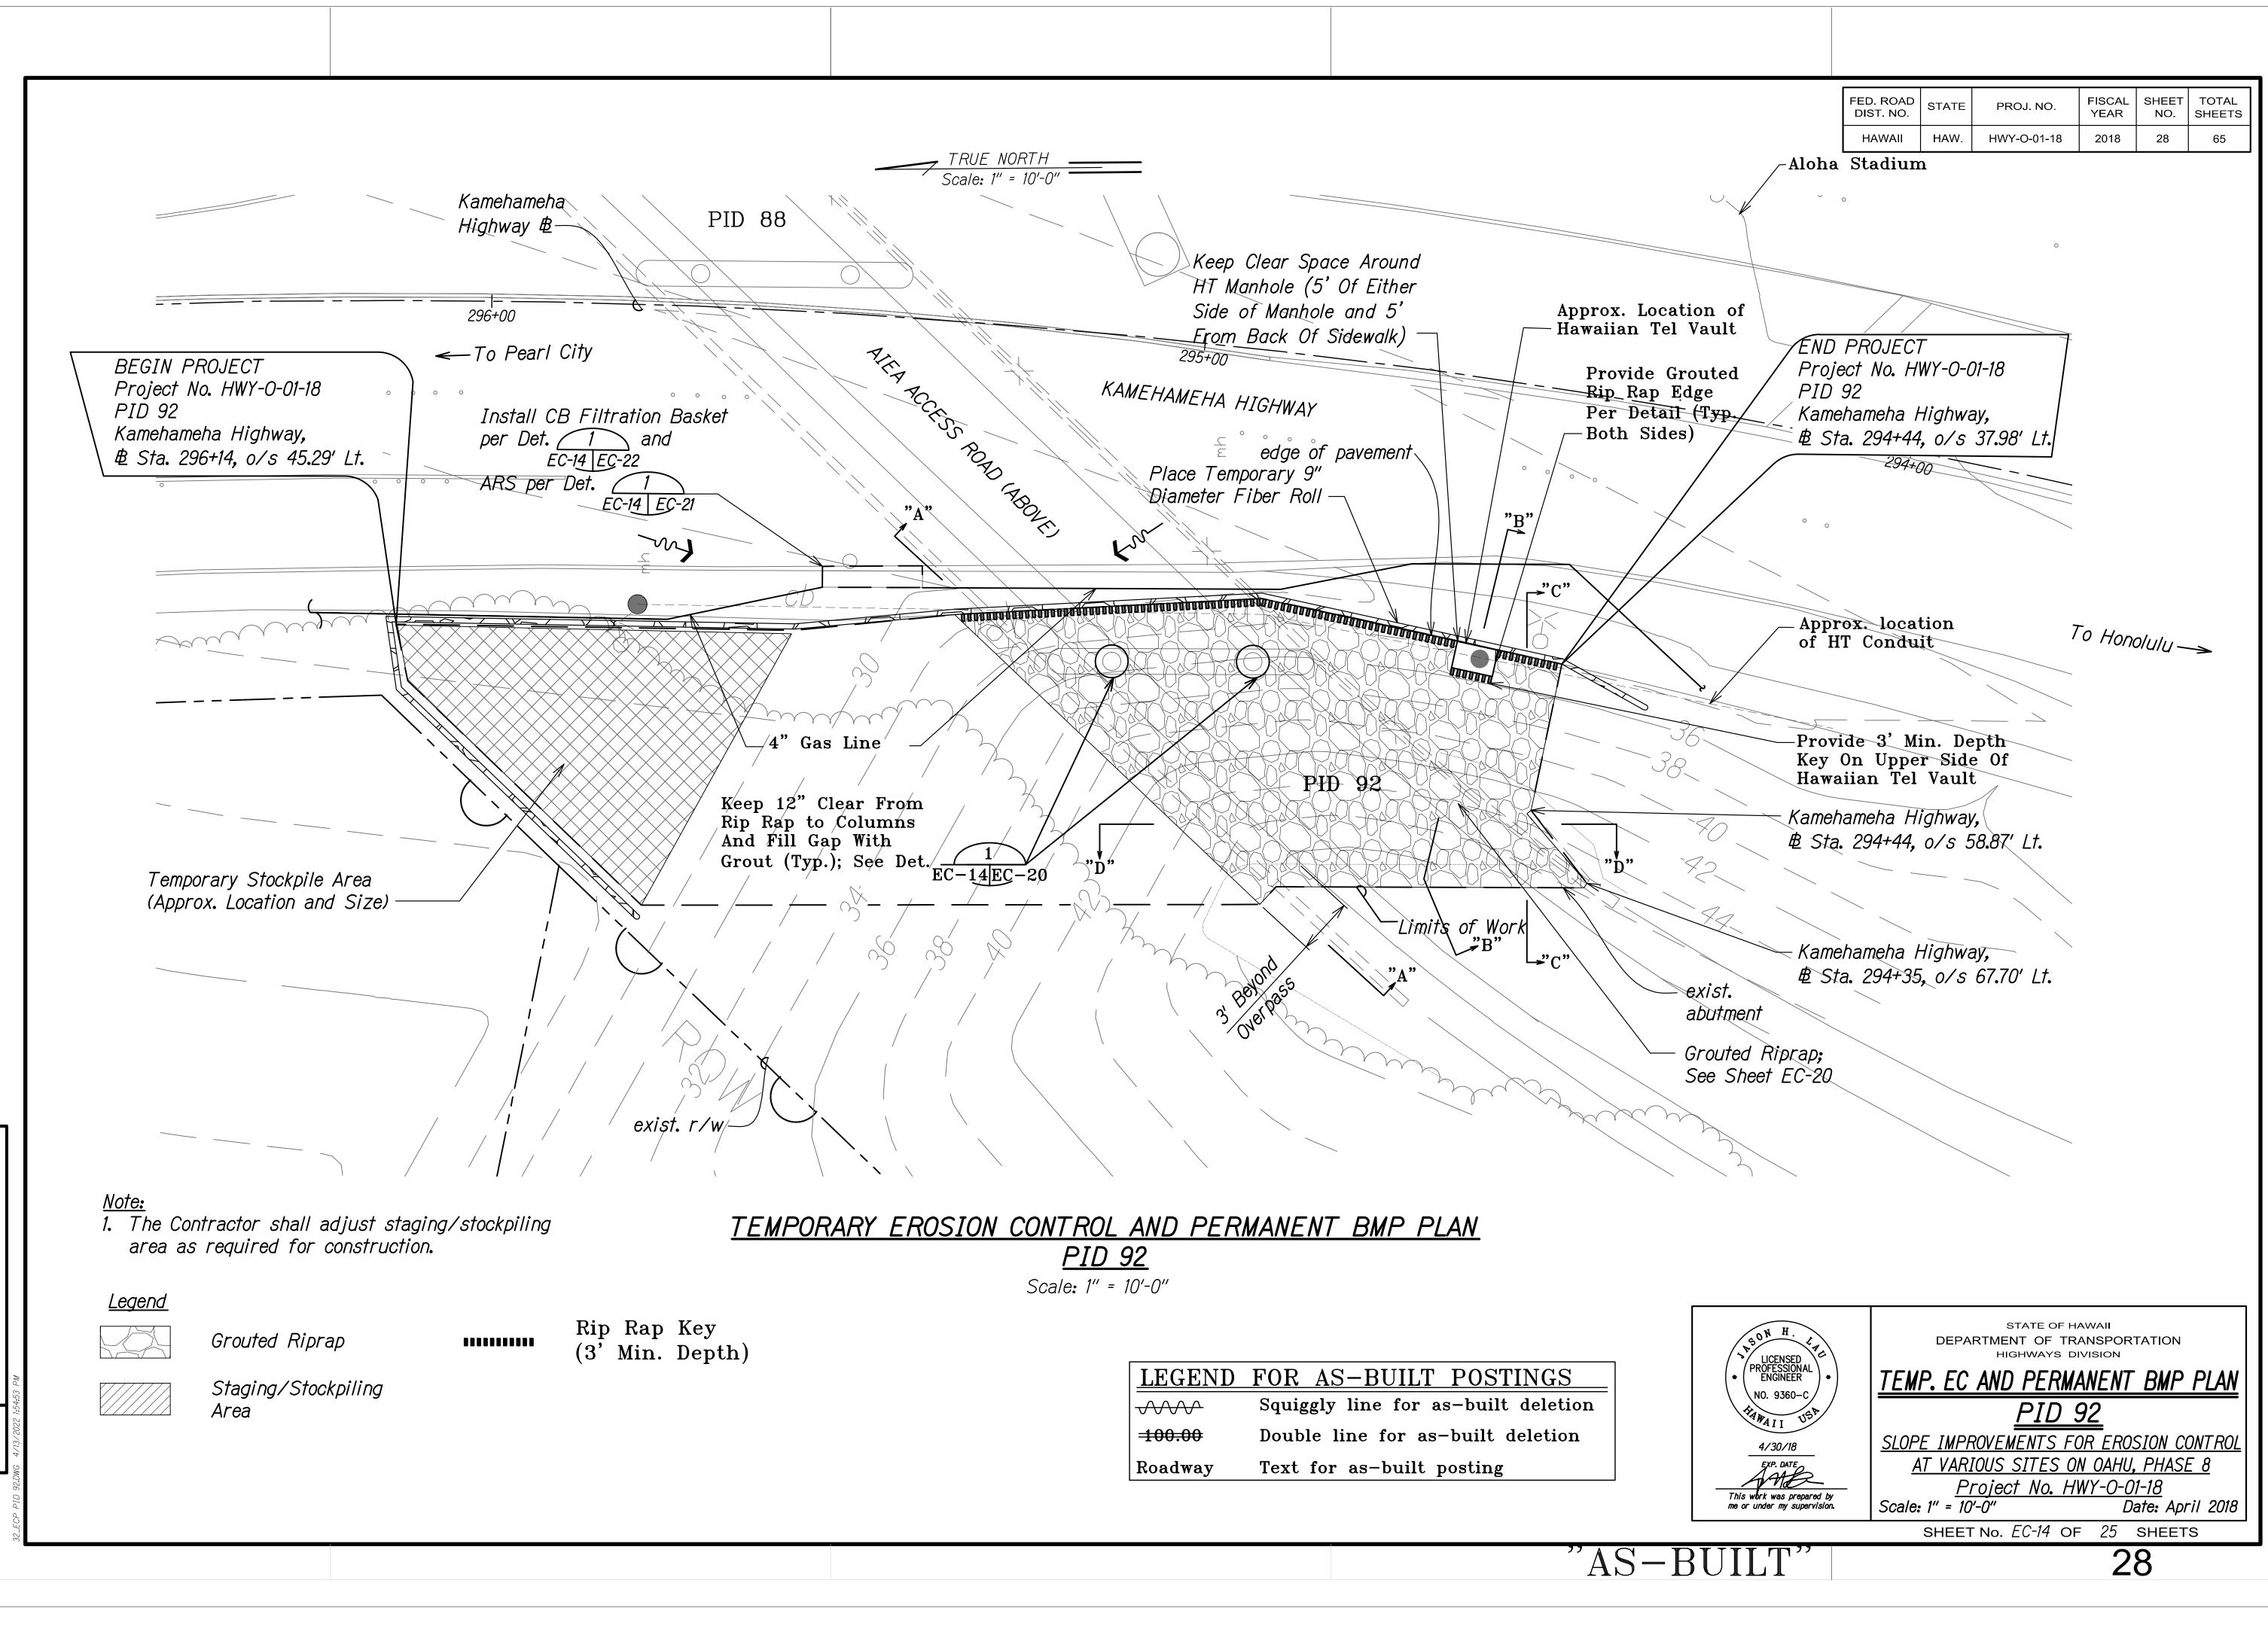


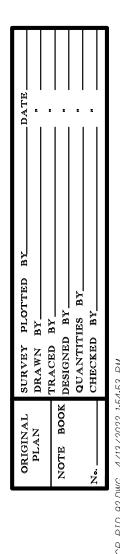



<u>TEMPORARY</u>	EROSION	CONTROL	AND	PERMANENT	BMP	PLAN
		PID S	<u>92</u>			
		Scale: 1" =	10'-0''			

LEGEND	FOR AS-BUILT POSTI
	Squiggly line for as-built
-100.00	Double line for as-built de
Roadway	Text for as-built posting

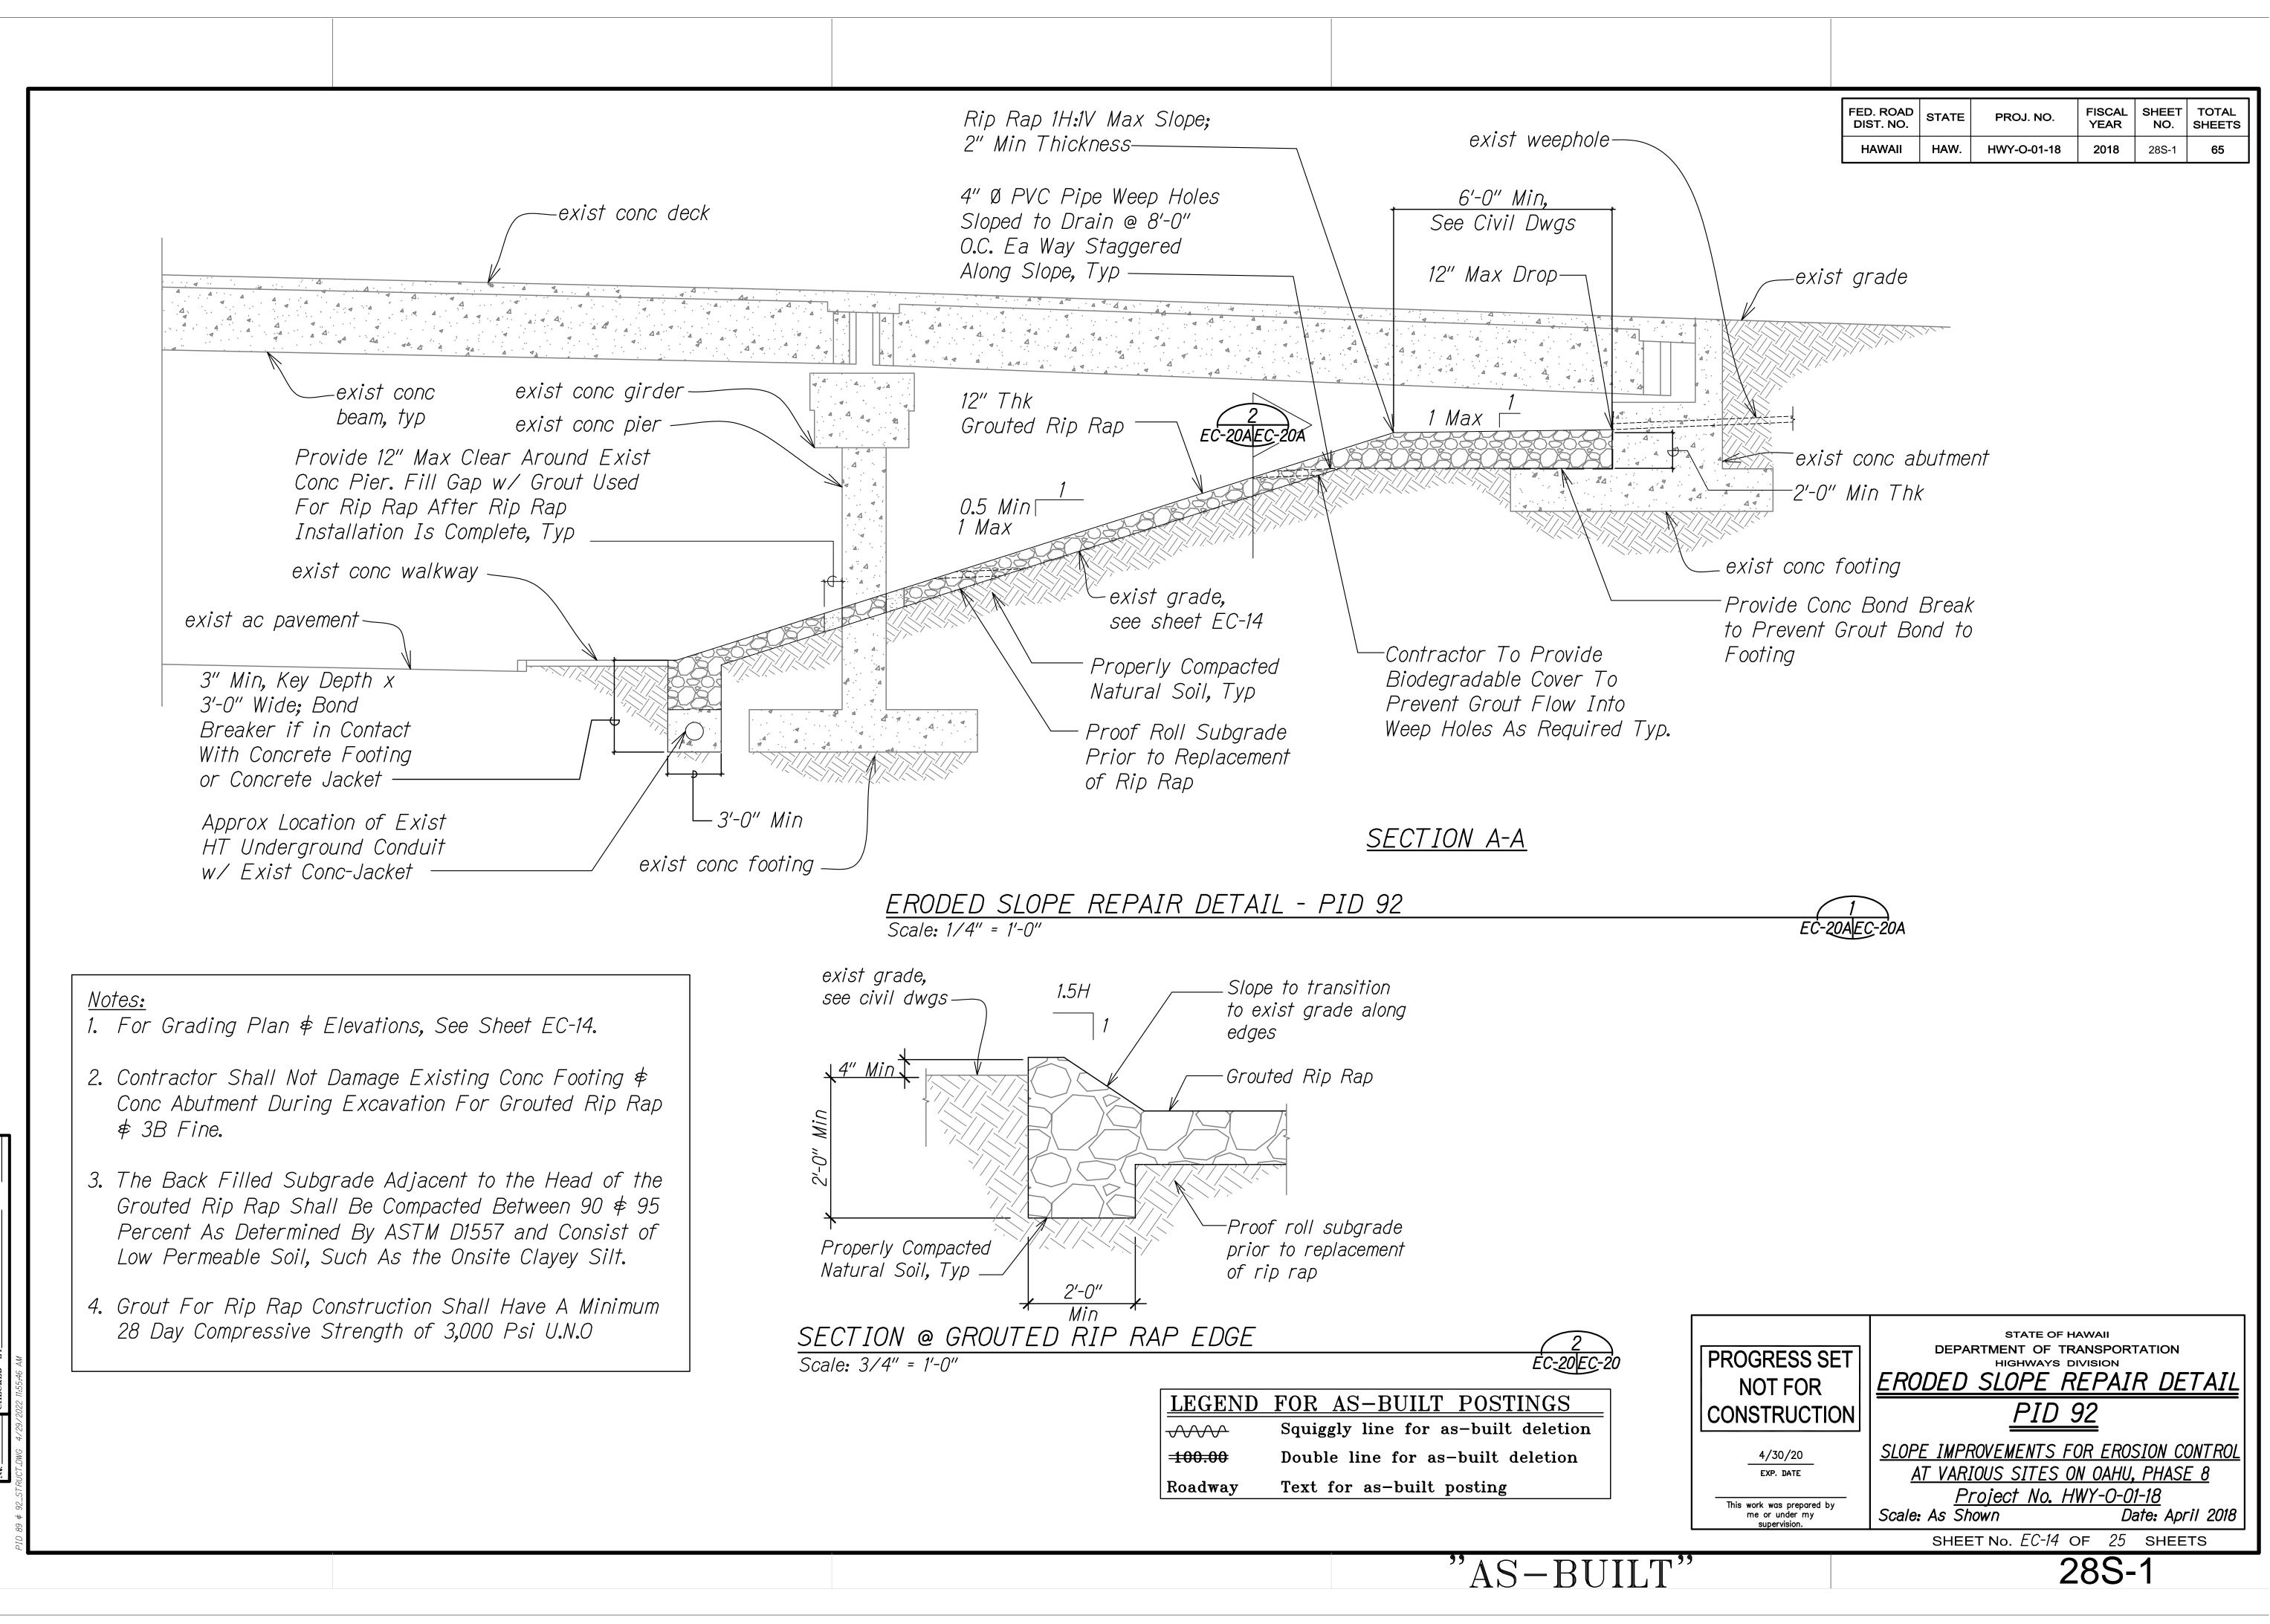


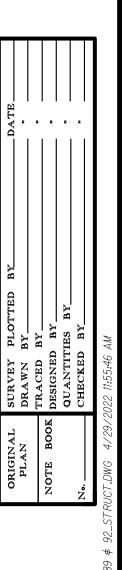


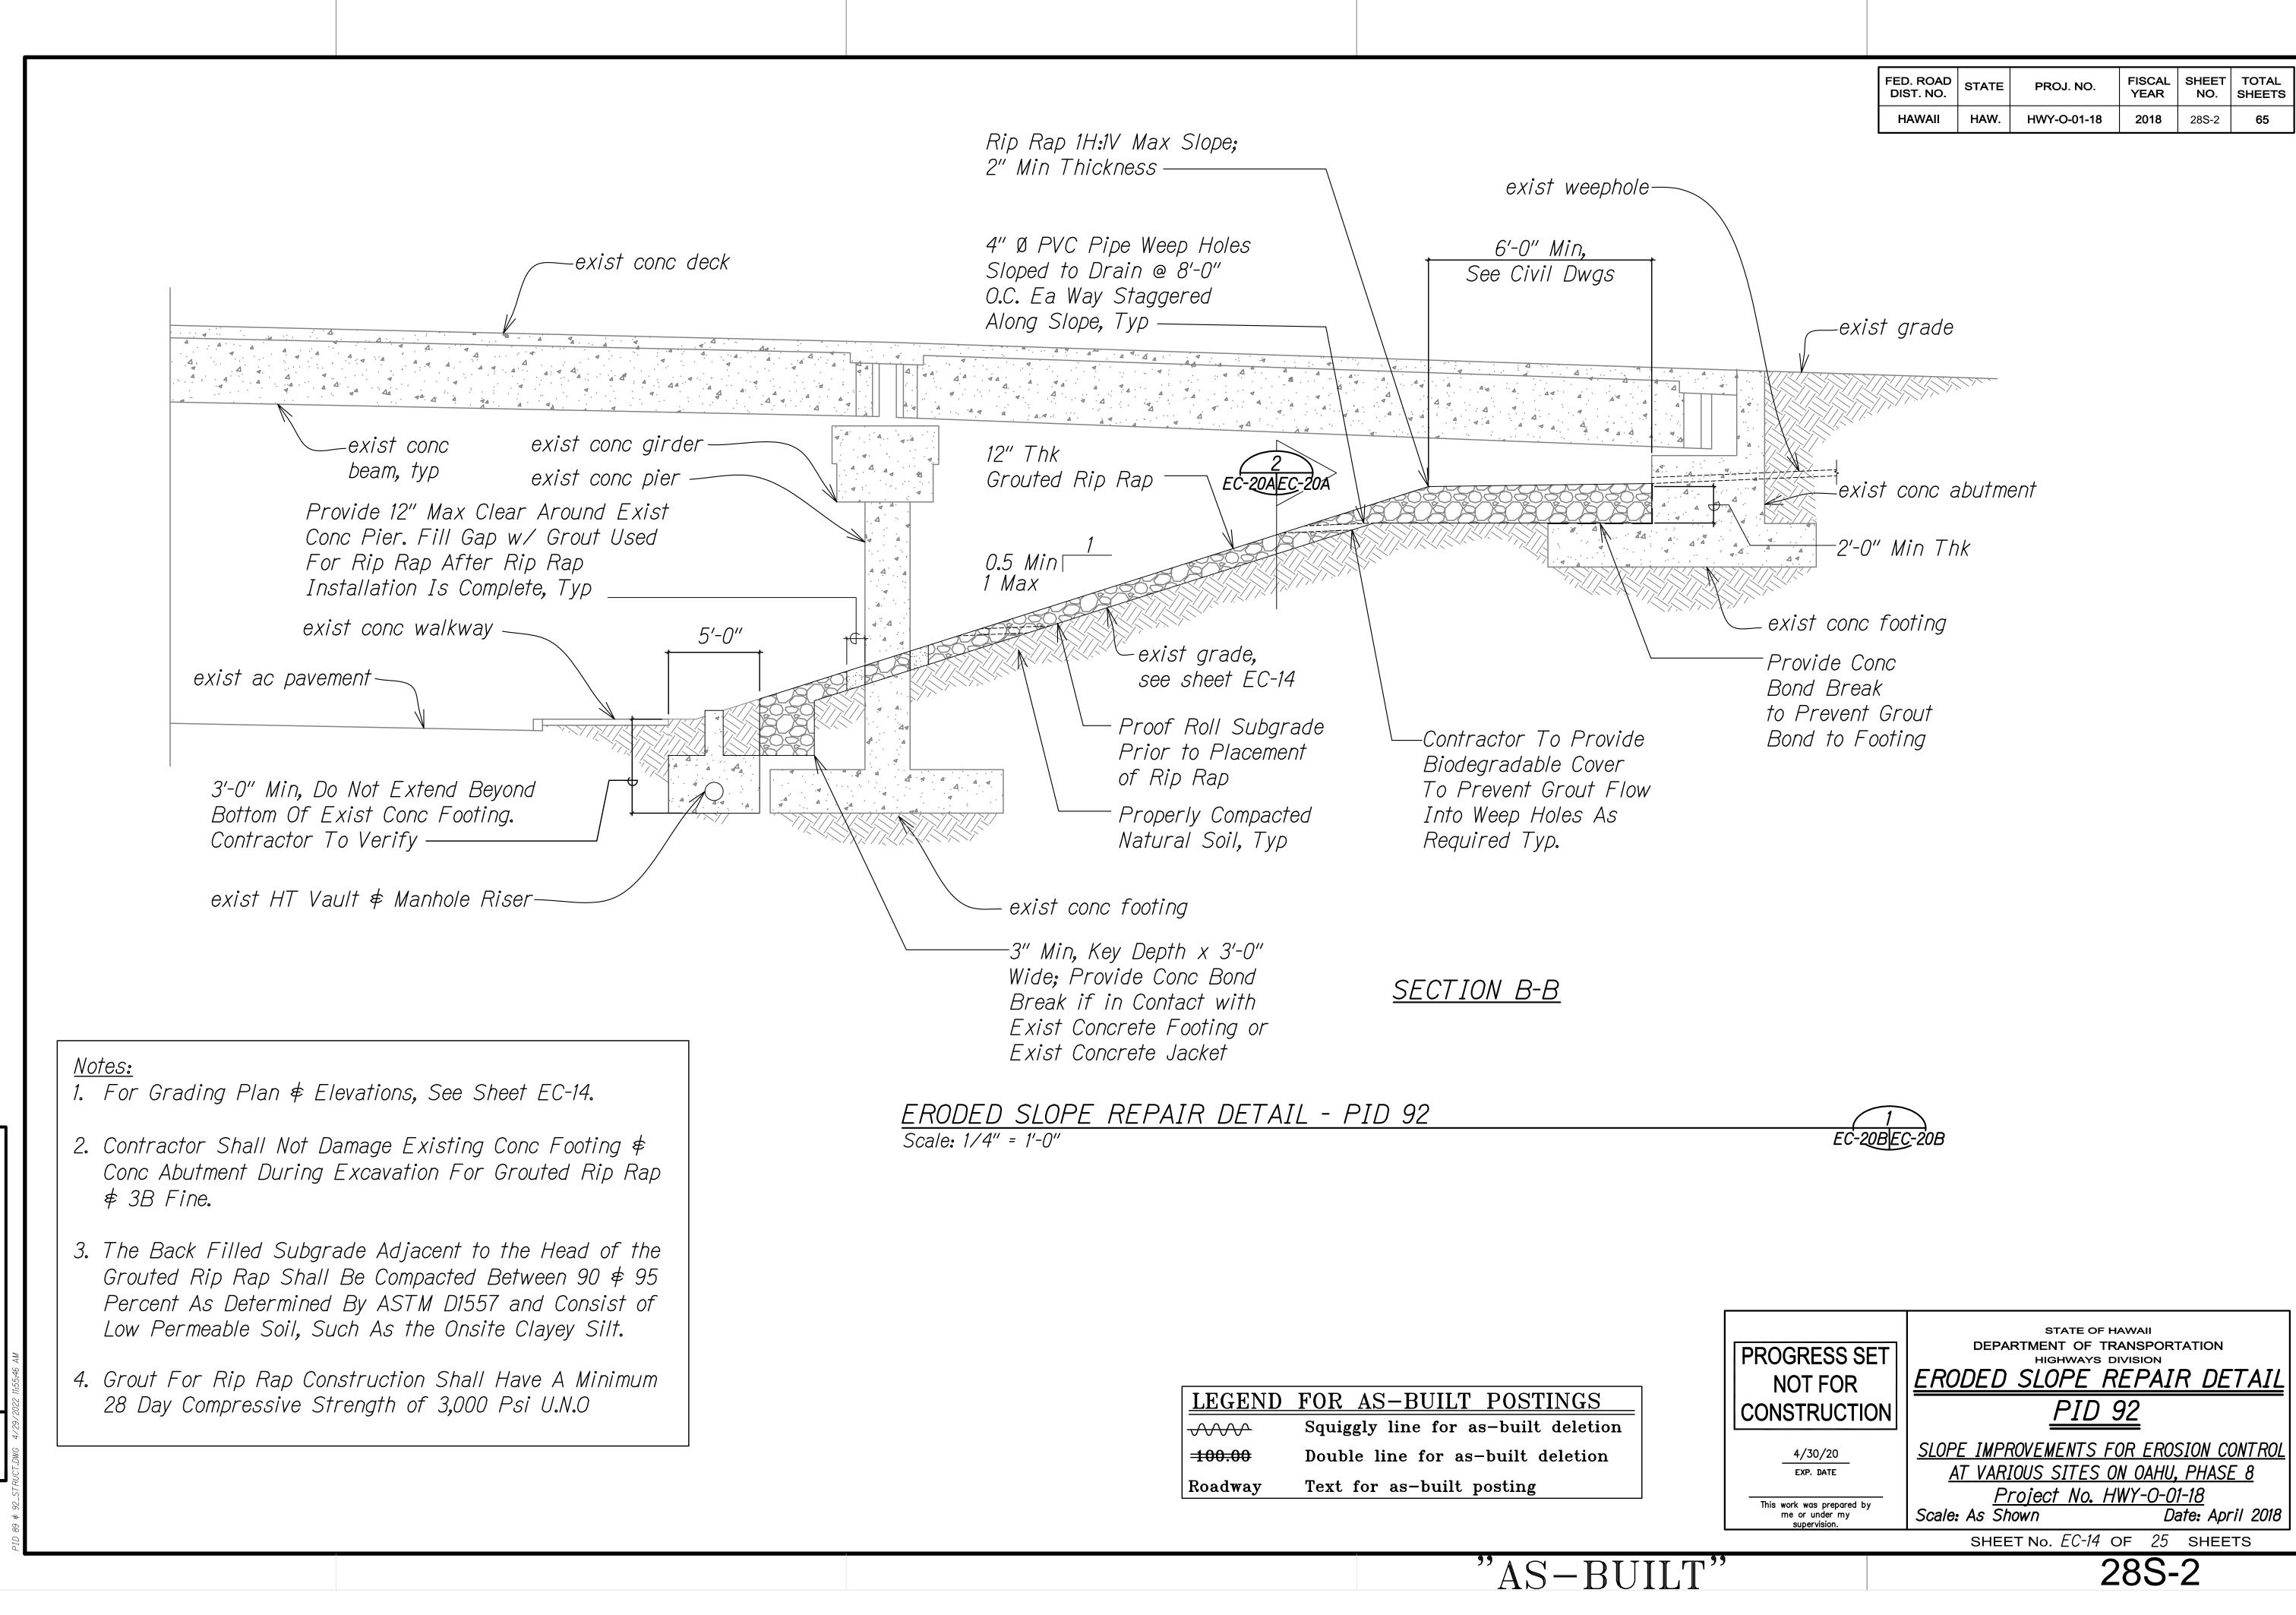

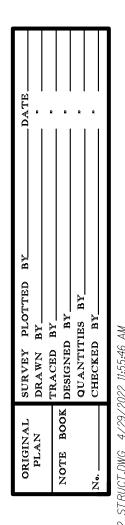


FED. ROAD DIST. NO.	STATE	PROJ. NO.	FISCAL YEAR	SHEET NO.	TOTAL SHEETS
HAWAII	HAW.	HWY-O-01-18	2018	28S-2	65

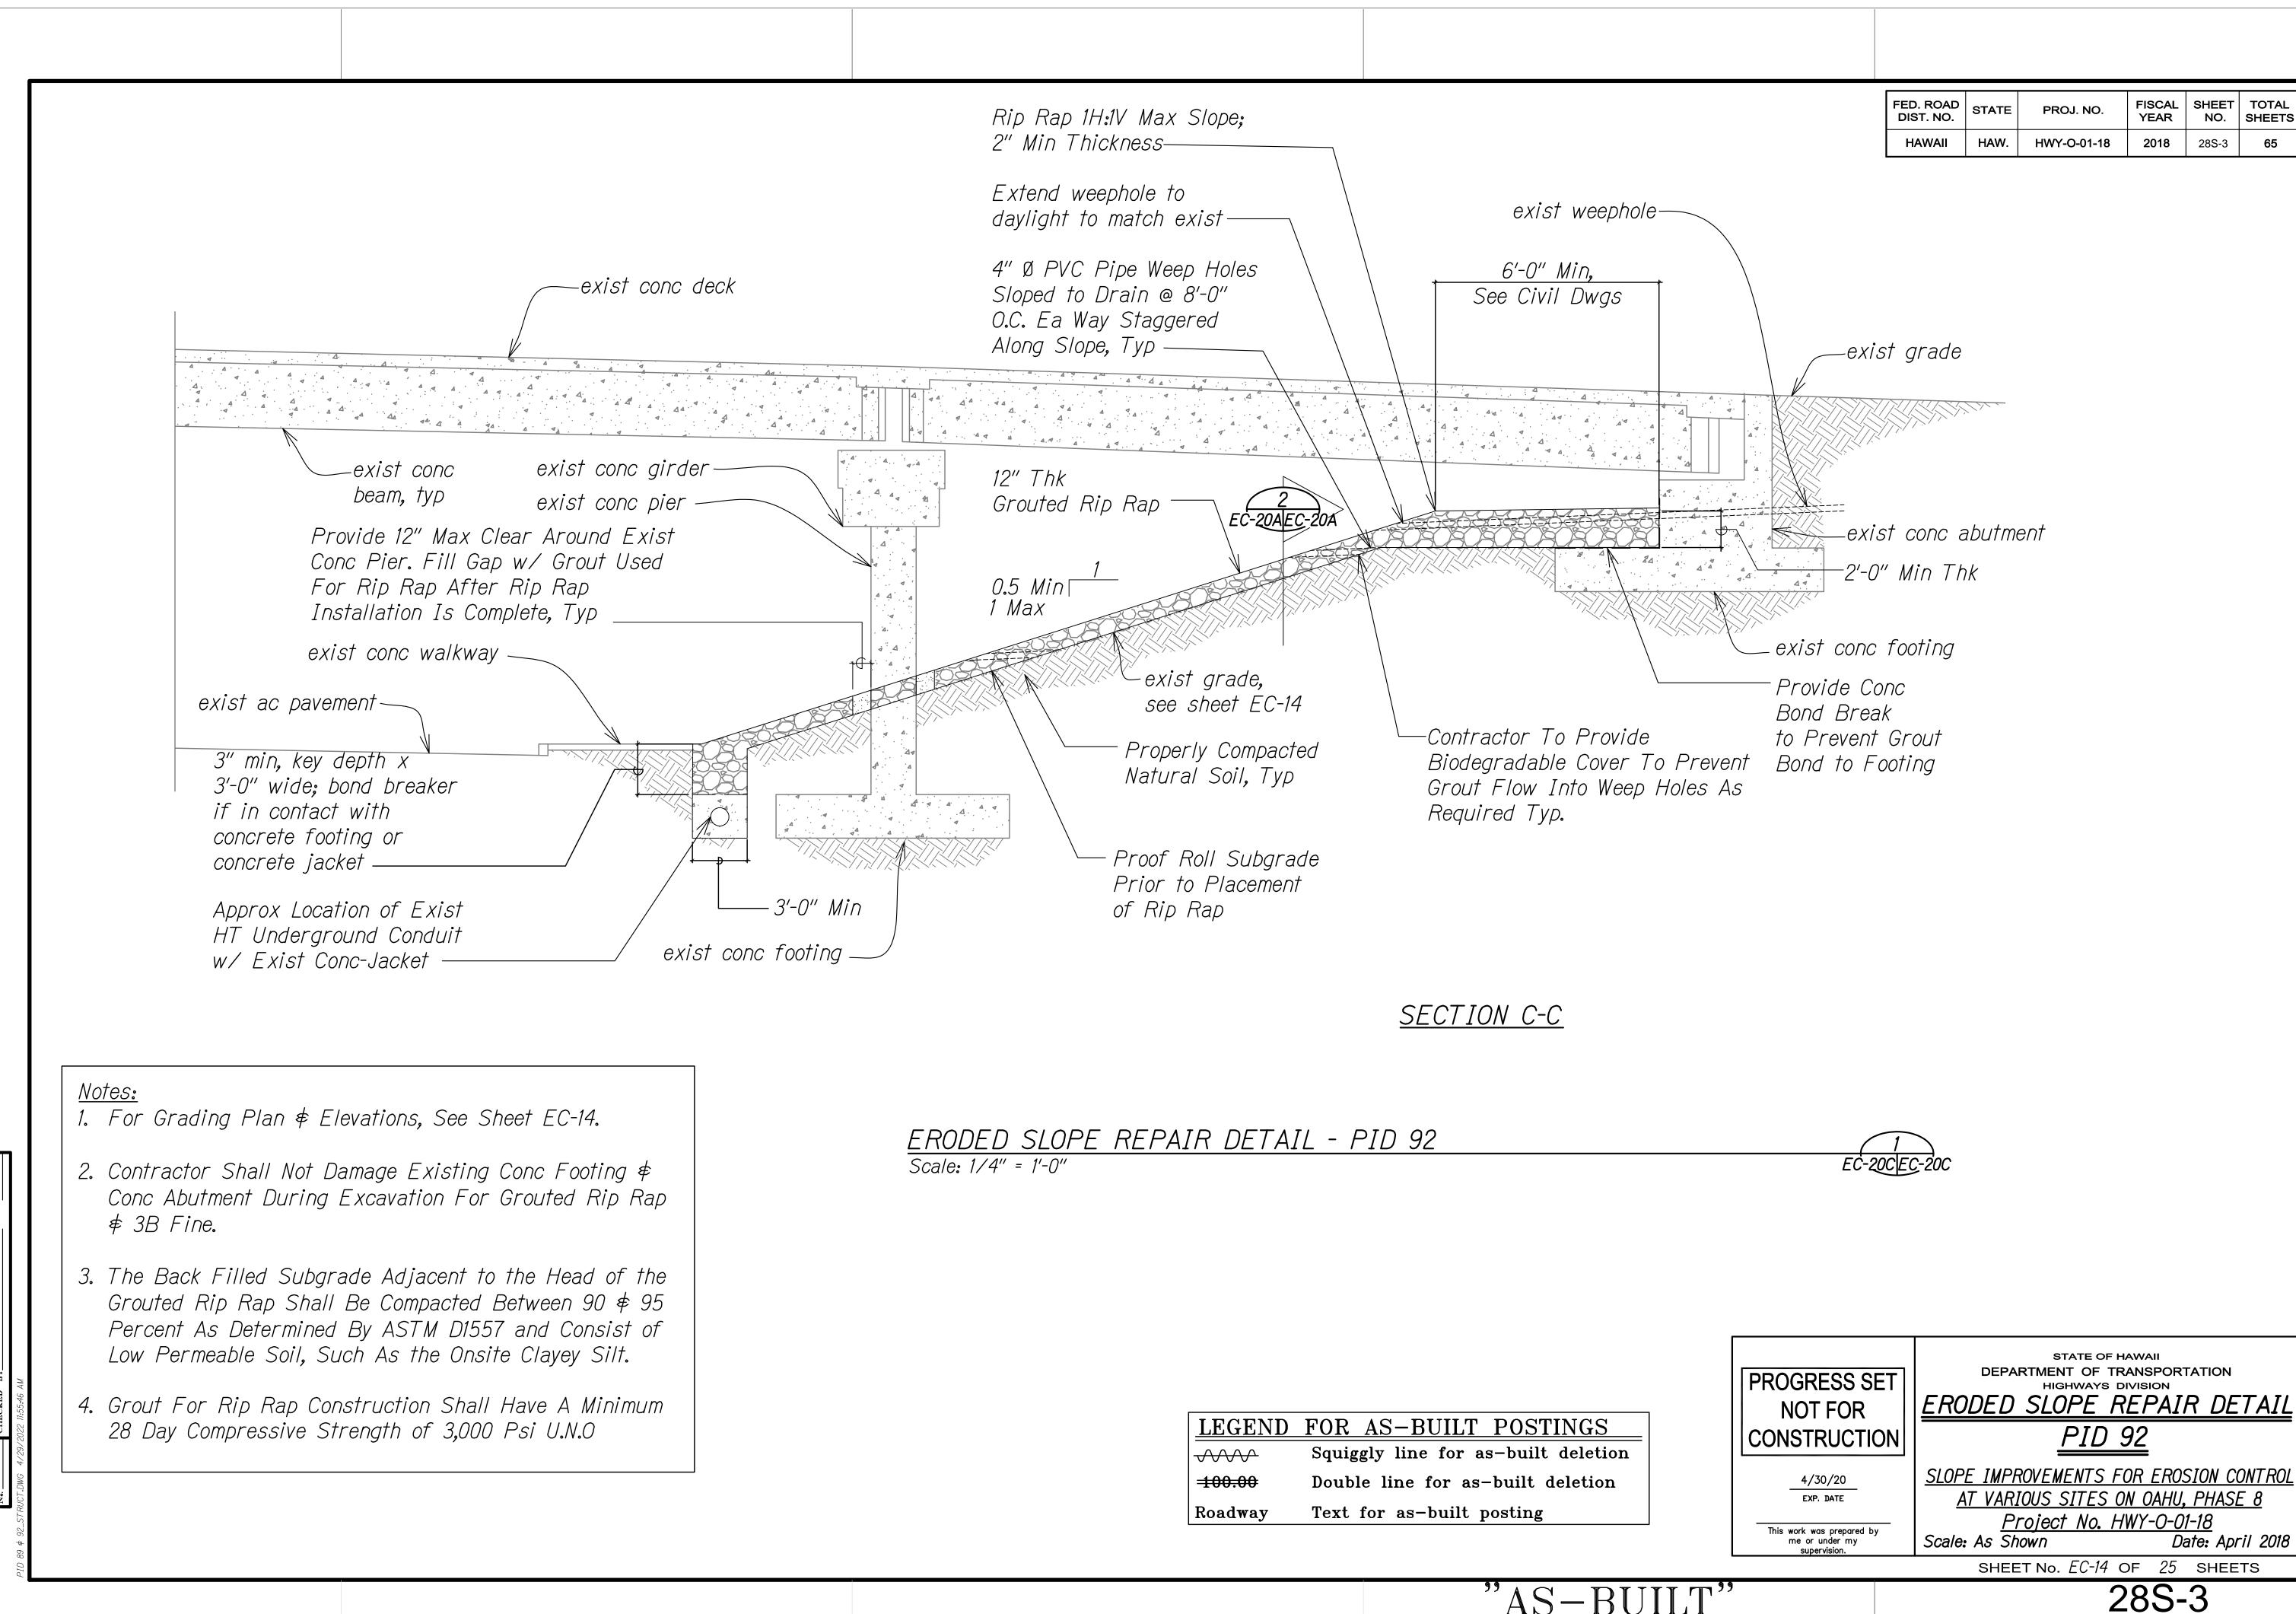

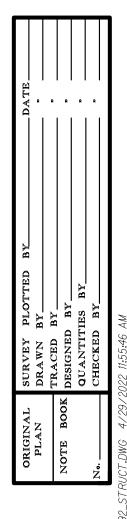


FED. ROAD DIST. NO.	STATE	PROJ. NO.	FISCAL YEAR	SHEET NO.	TOTAL SHEETS

"AS-BUILT"

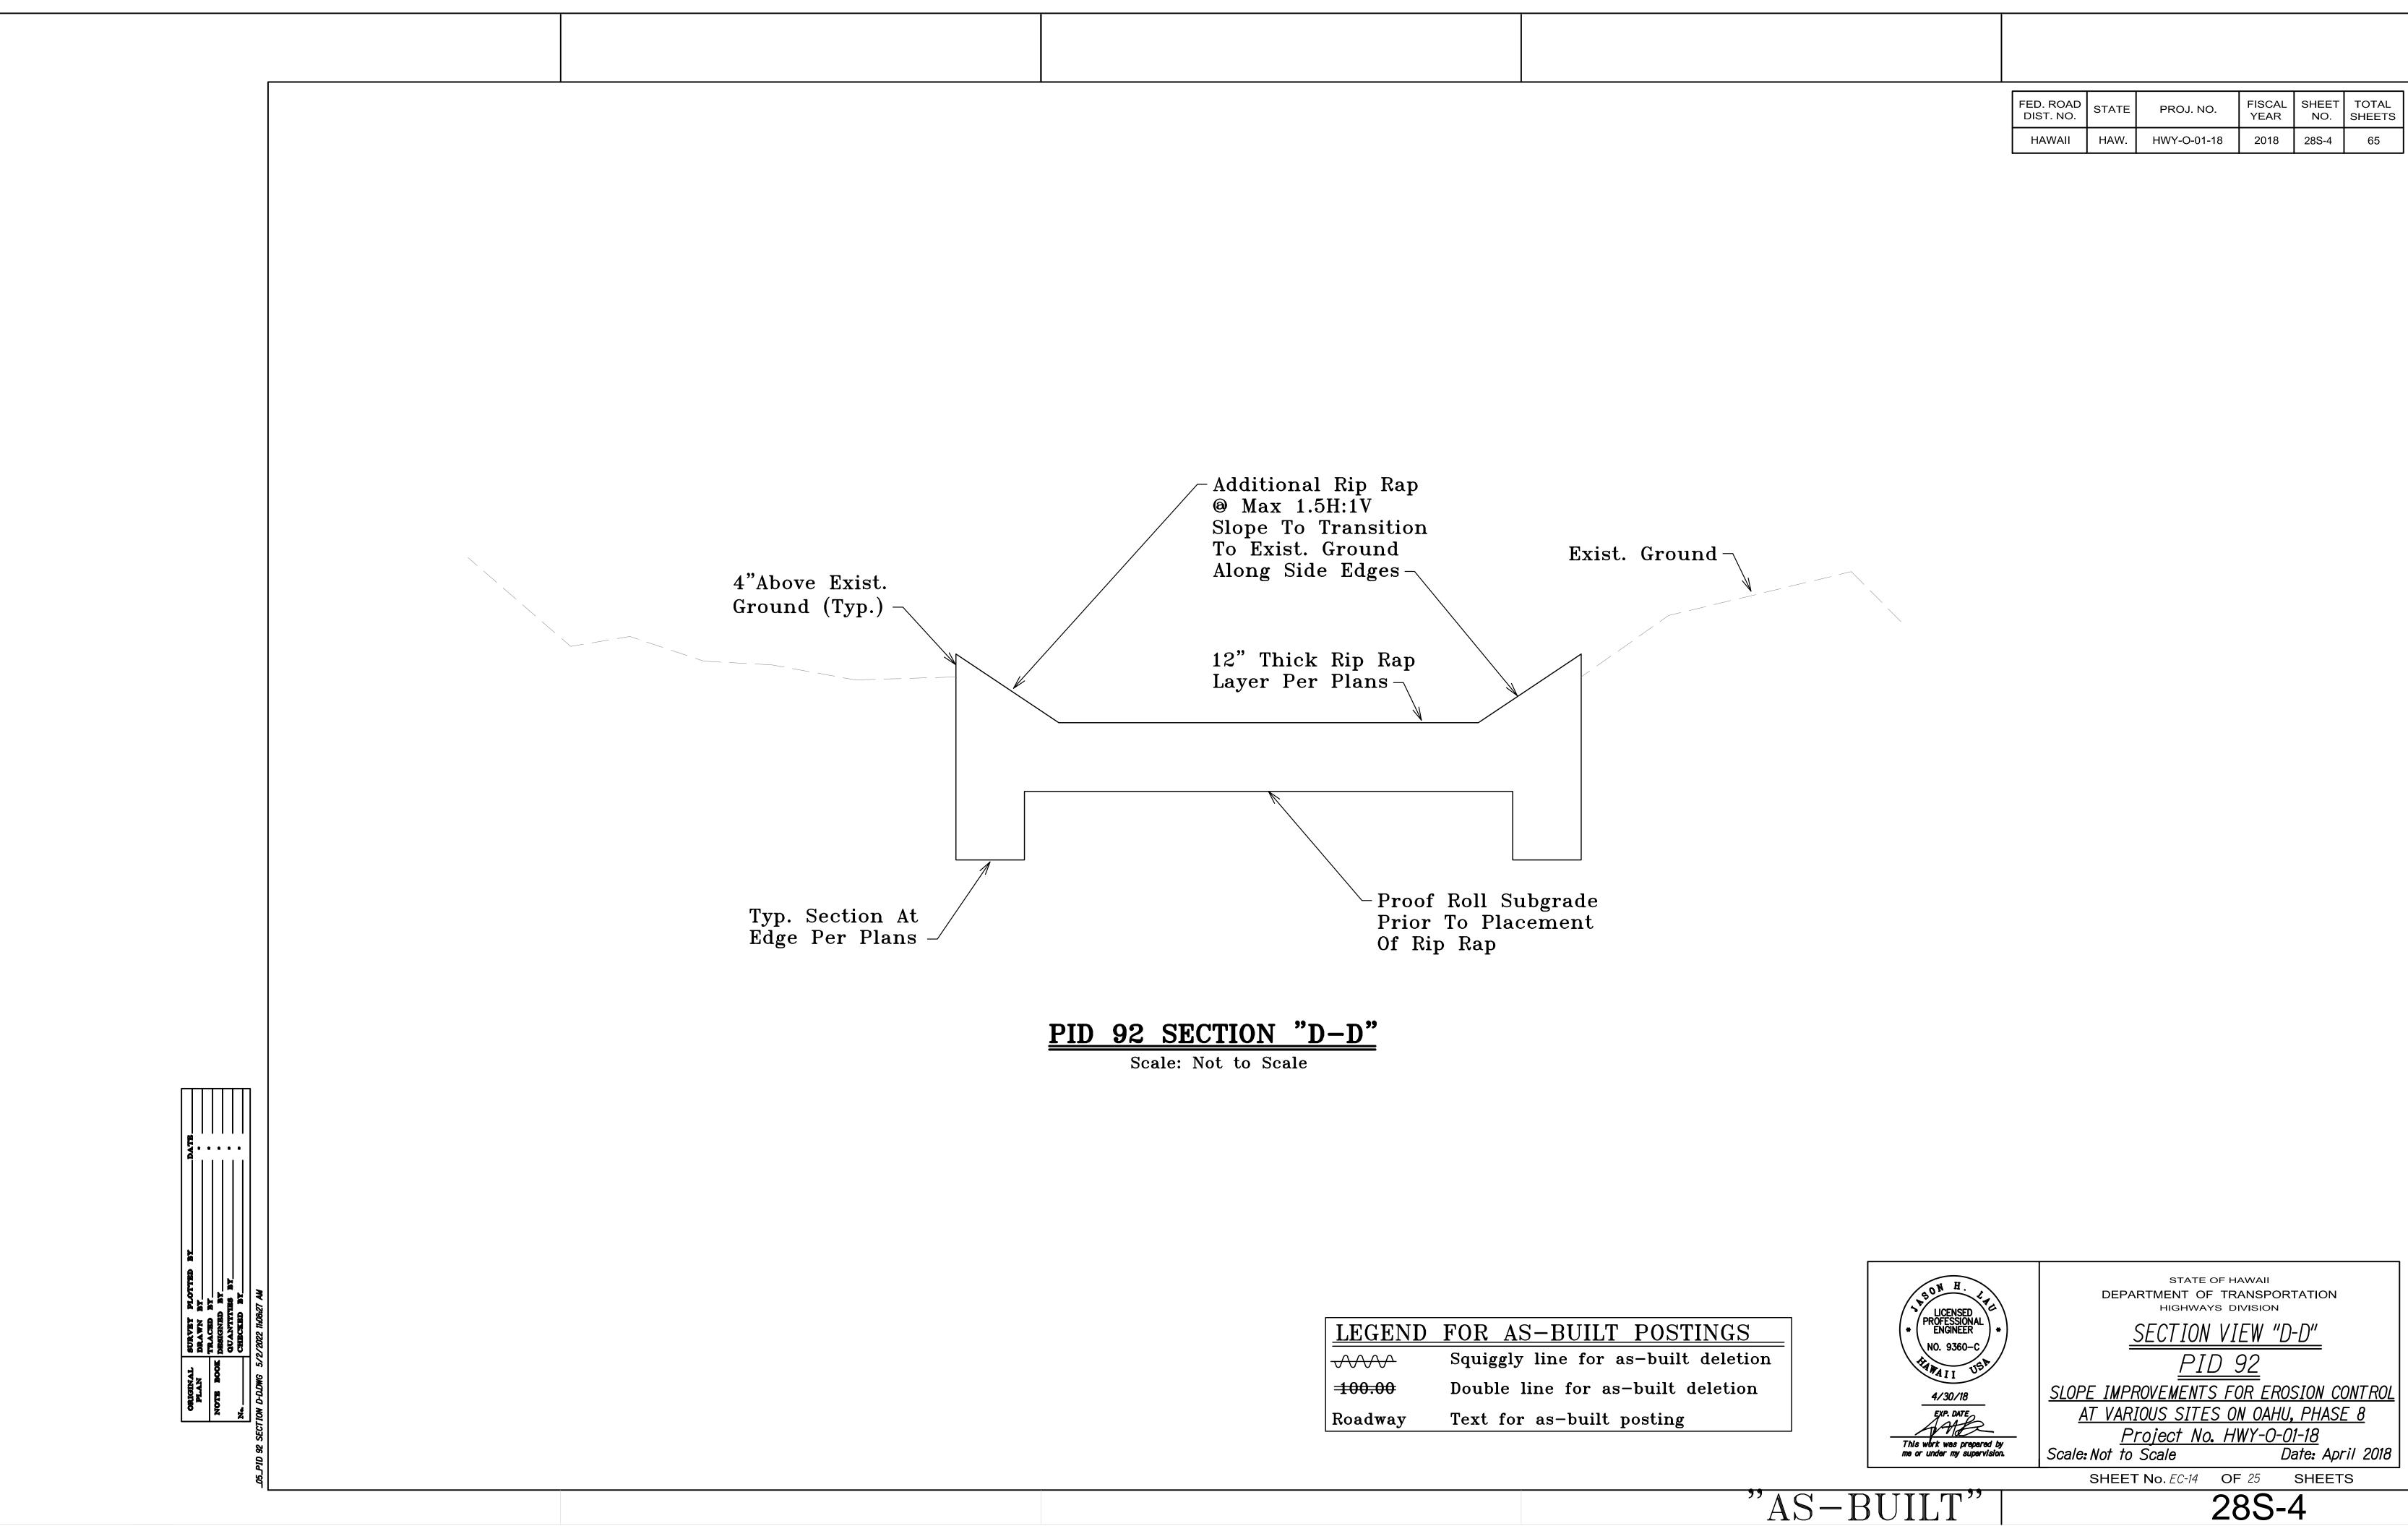



<u>LEGEND</u>	FOR AS-BUILT POST
	Squiggly line for as-built
-100.00	Double line for as-built d
Roadway	Text for as-built posting


FED. ROAD DIST. NO.	STATE	PROJ. NO.	FISCAL YEAR	SHEET NO.	TOTAL SHEETS
HAWAII	HAW.	HWY-O-01-18	2018	28S-4	65

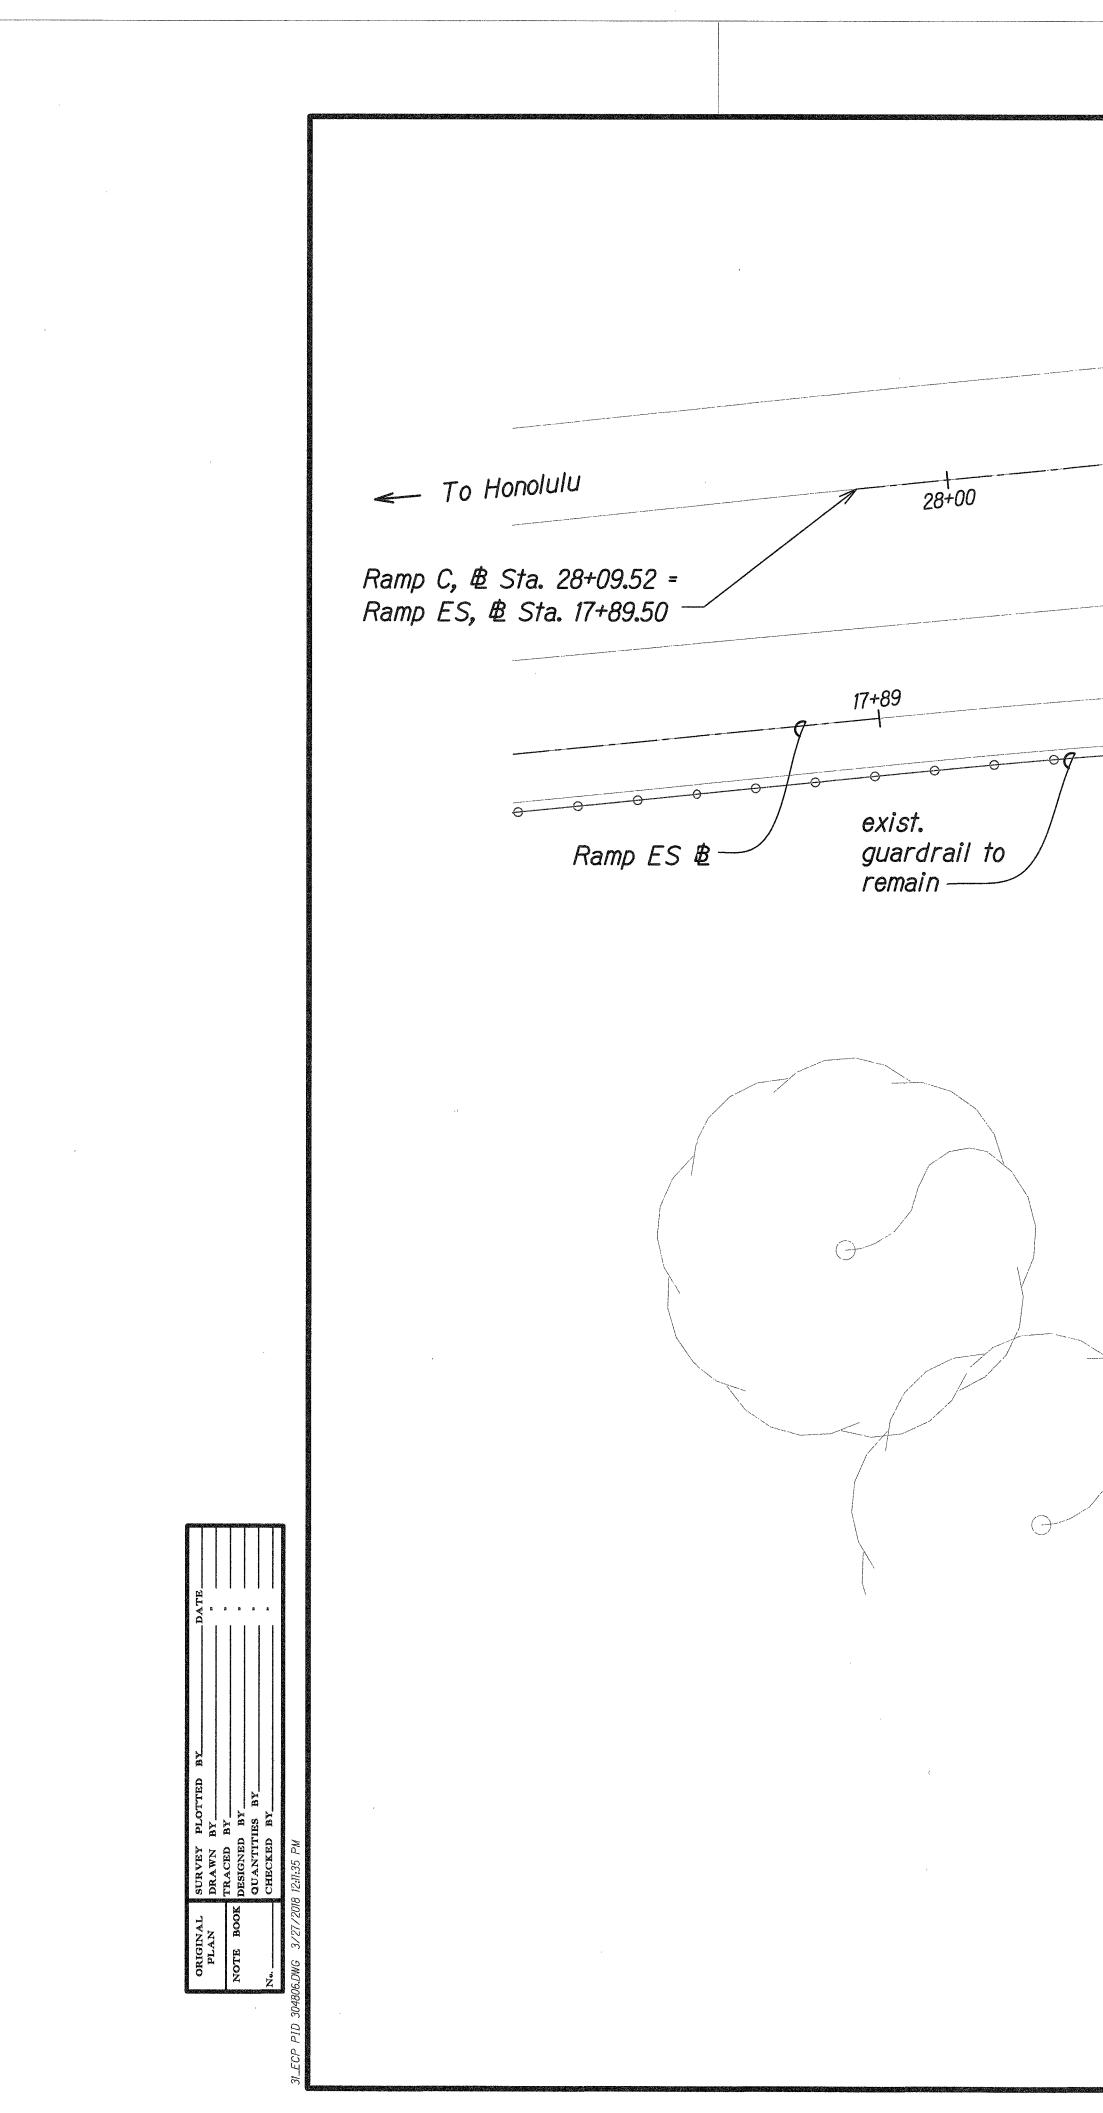


TRUE NORTH Scale: 1" = 10'-0" 27+00 RAMP C Ramp C B exist. riprap to remain exist. a.c. outfall to remain m See Det. 3 EC-15EC-22 BEGIN PROJECT Project No. HWY-O-01-18 PID 304806 Ramp C, ₿ Sta. 27+00, o/s 39.3'± Lt. END PROJECT Project No. HWY-O-01-18 PID 304806 Ramp C, m ₿ Sta. 26+92, o/s 72.8'± Lt. exist. conc. channel wall to remain -TEMPORARY EROSION CONTROL AND PERMANENT BMP PLAN <u>PID 304806</u> Scale: 1" = 10'-0"

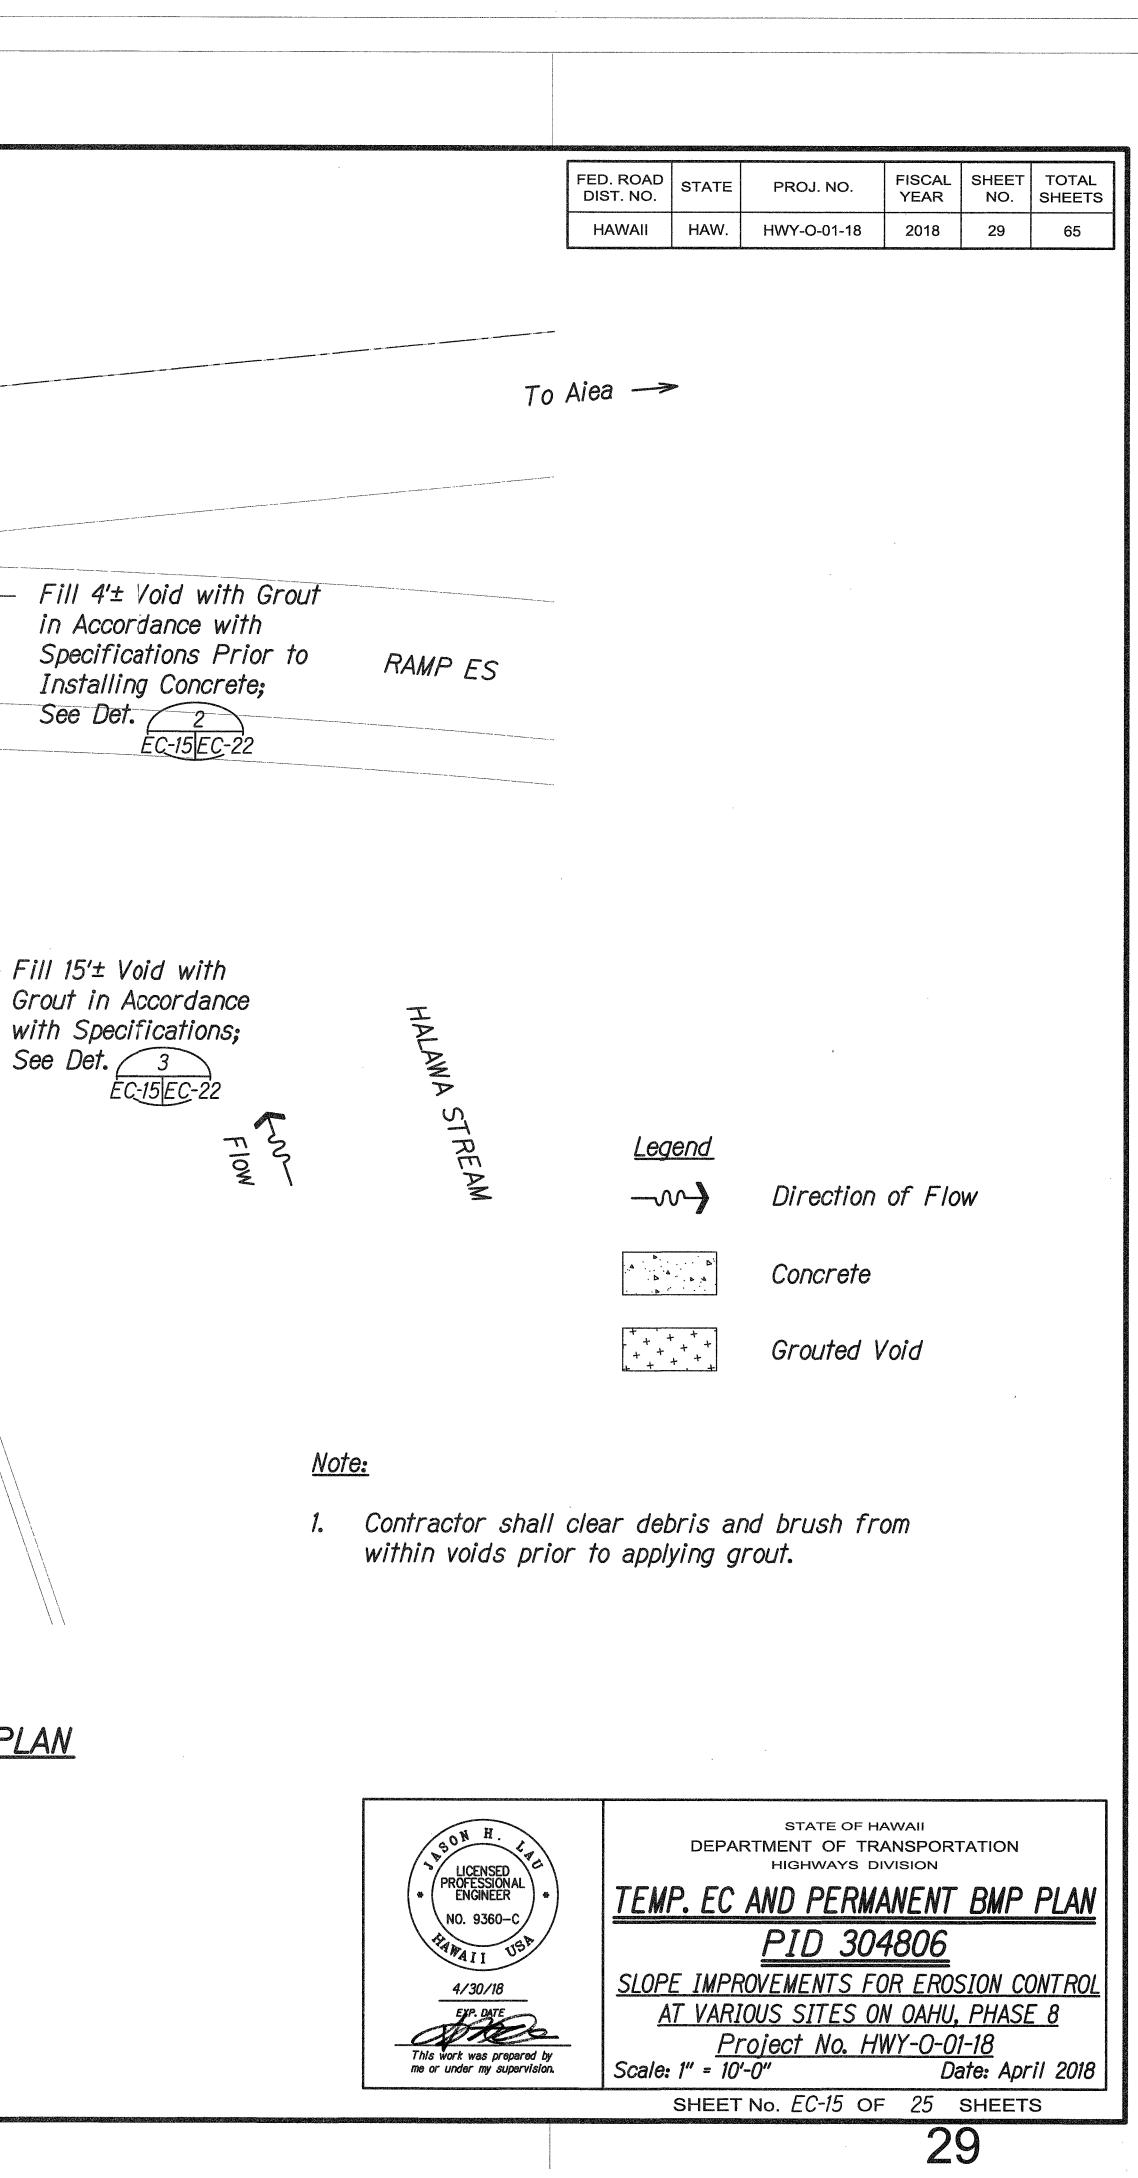


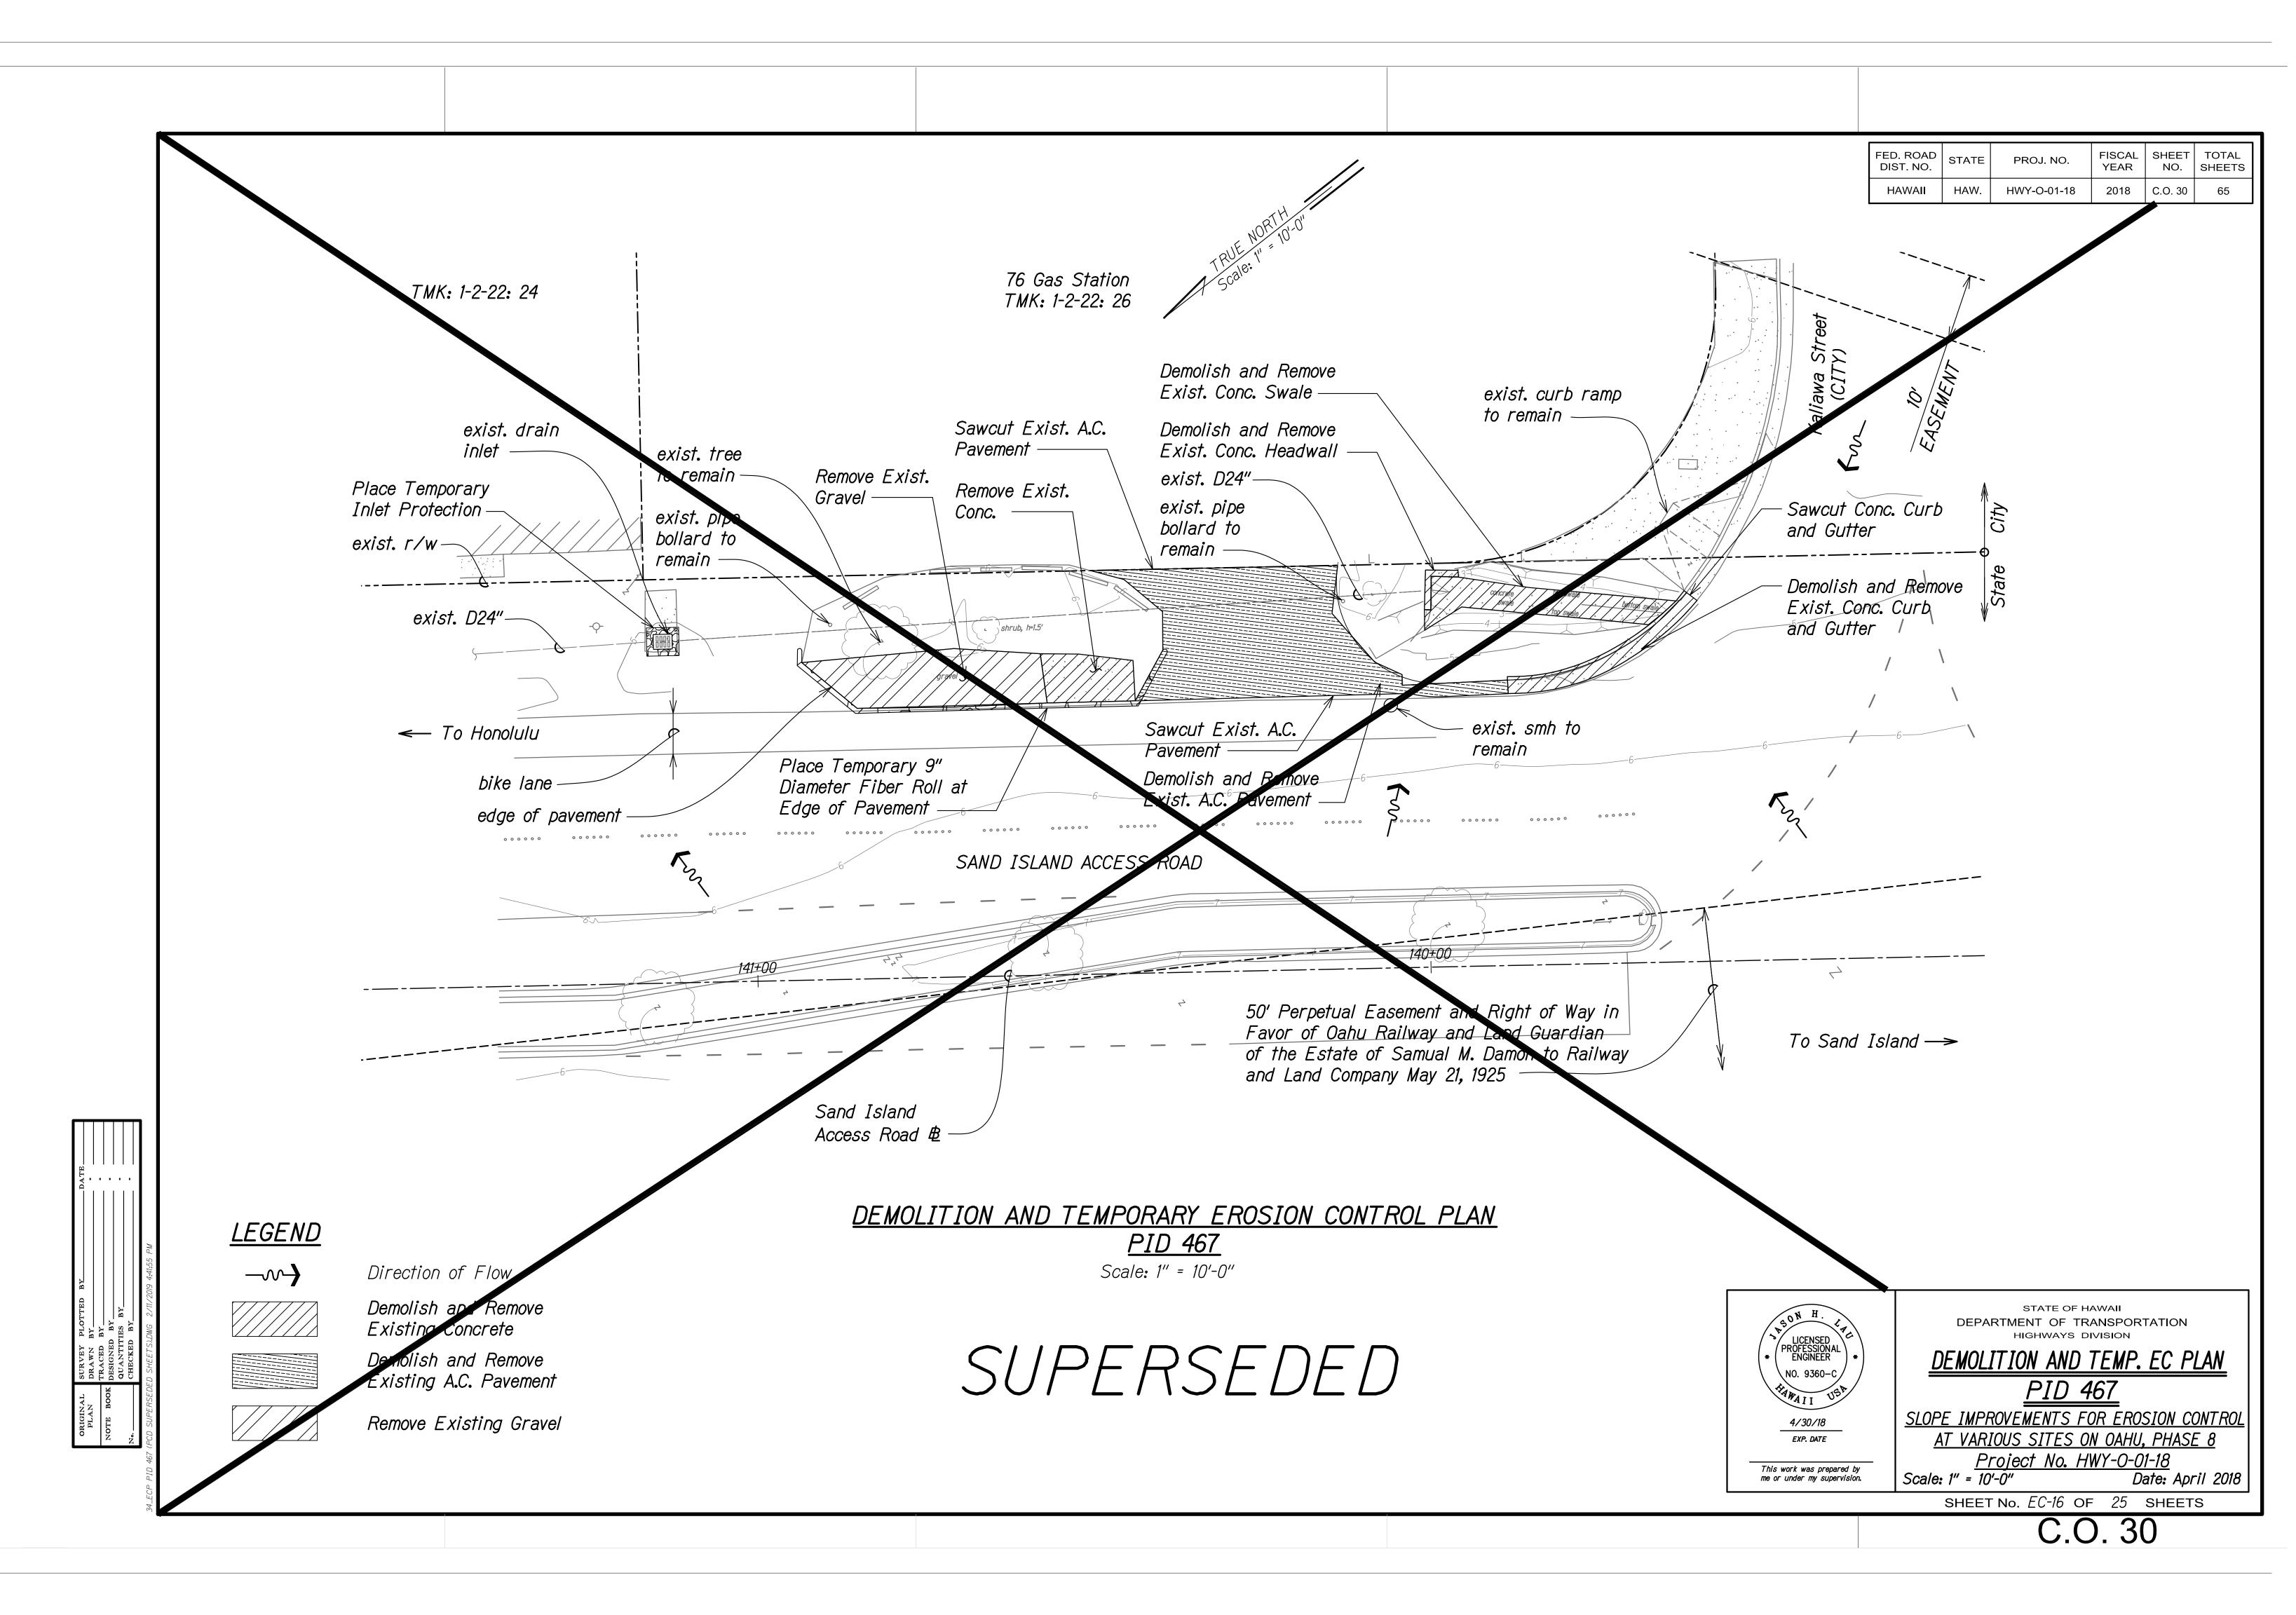


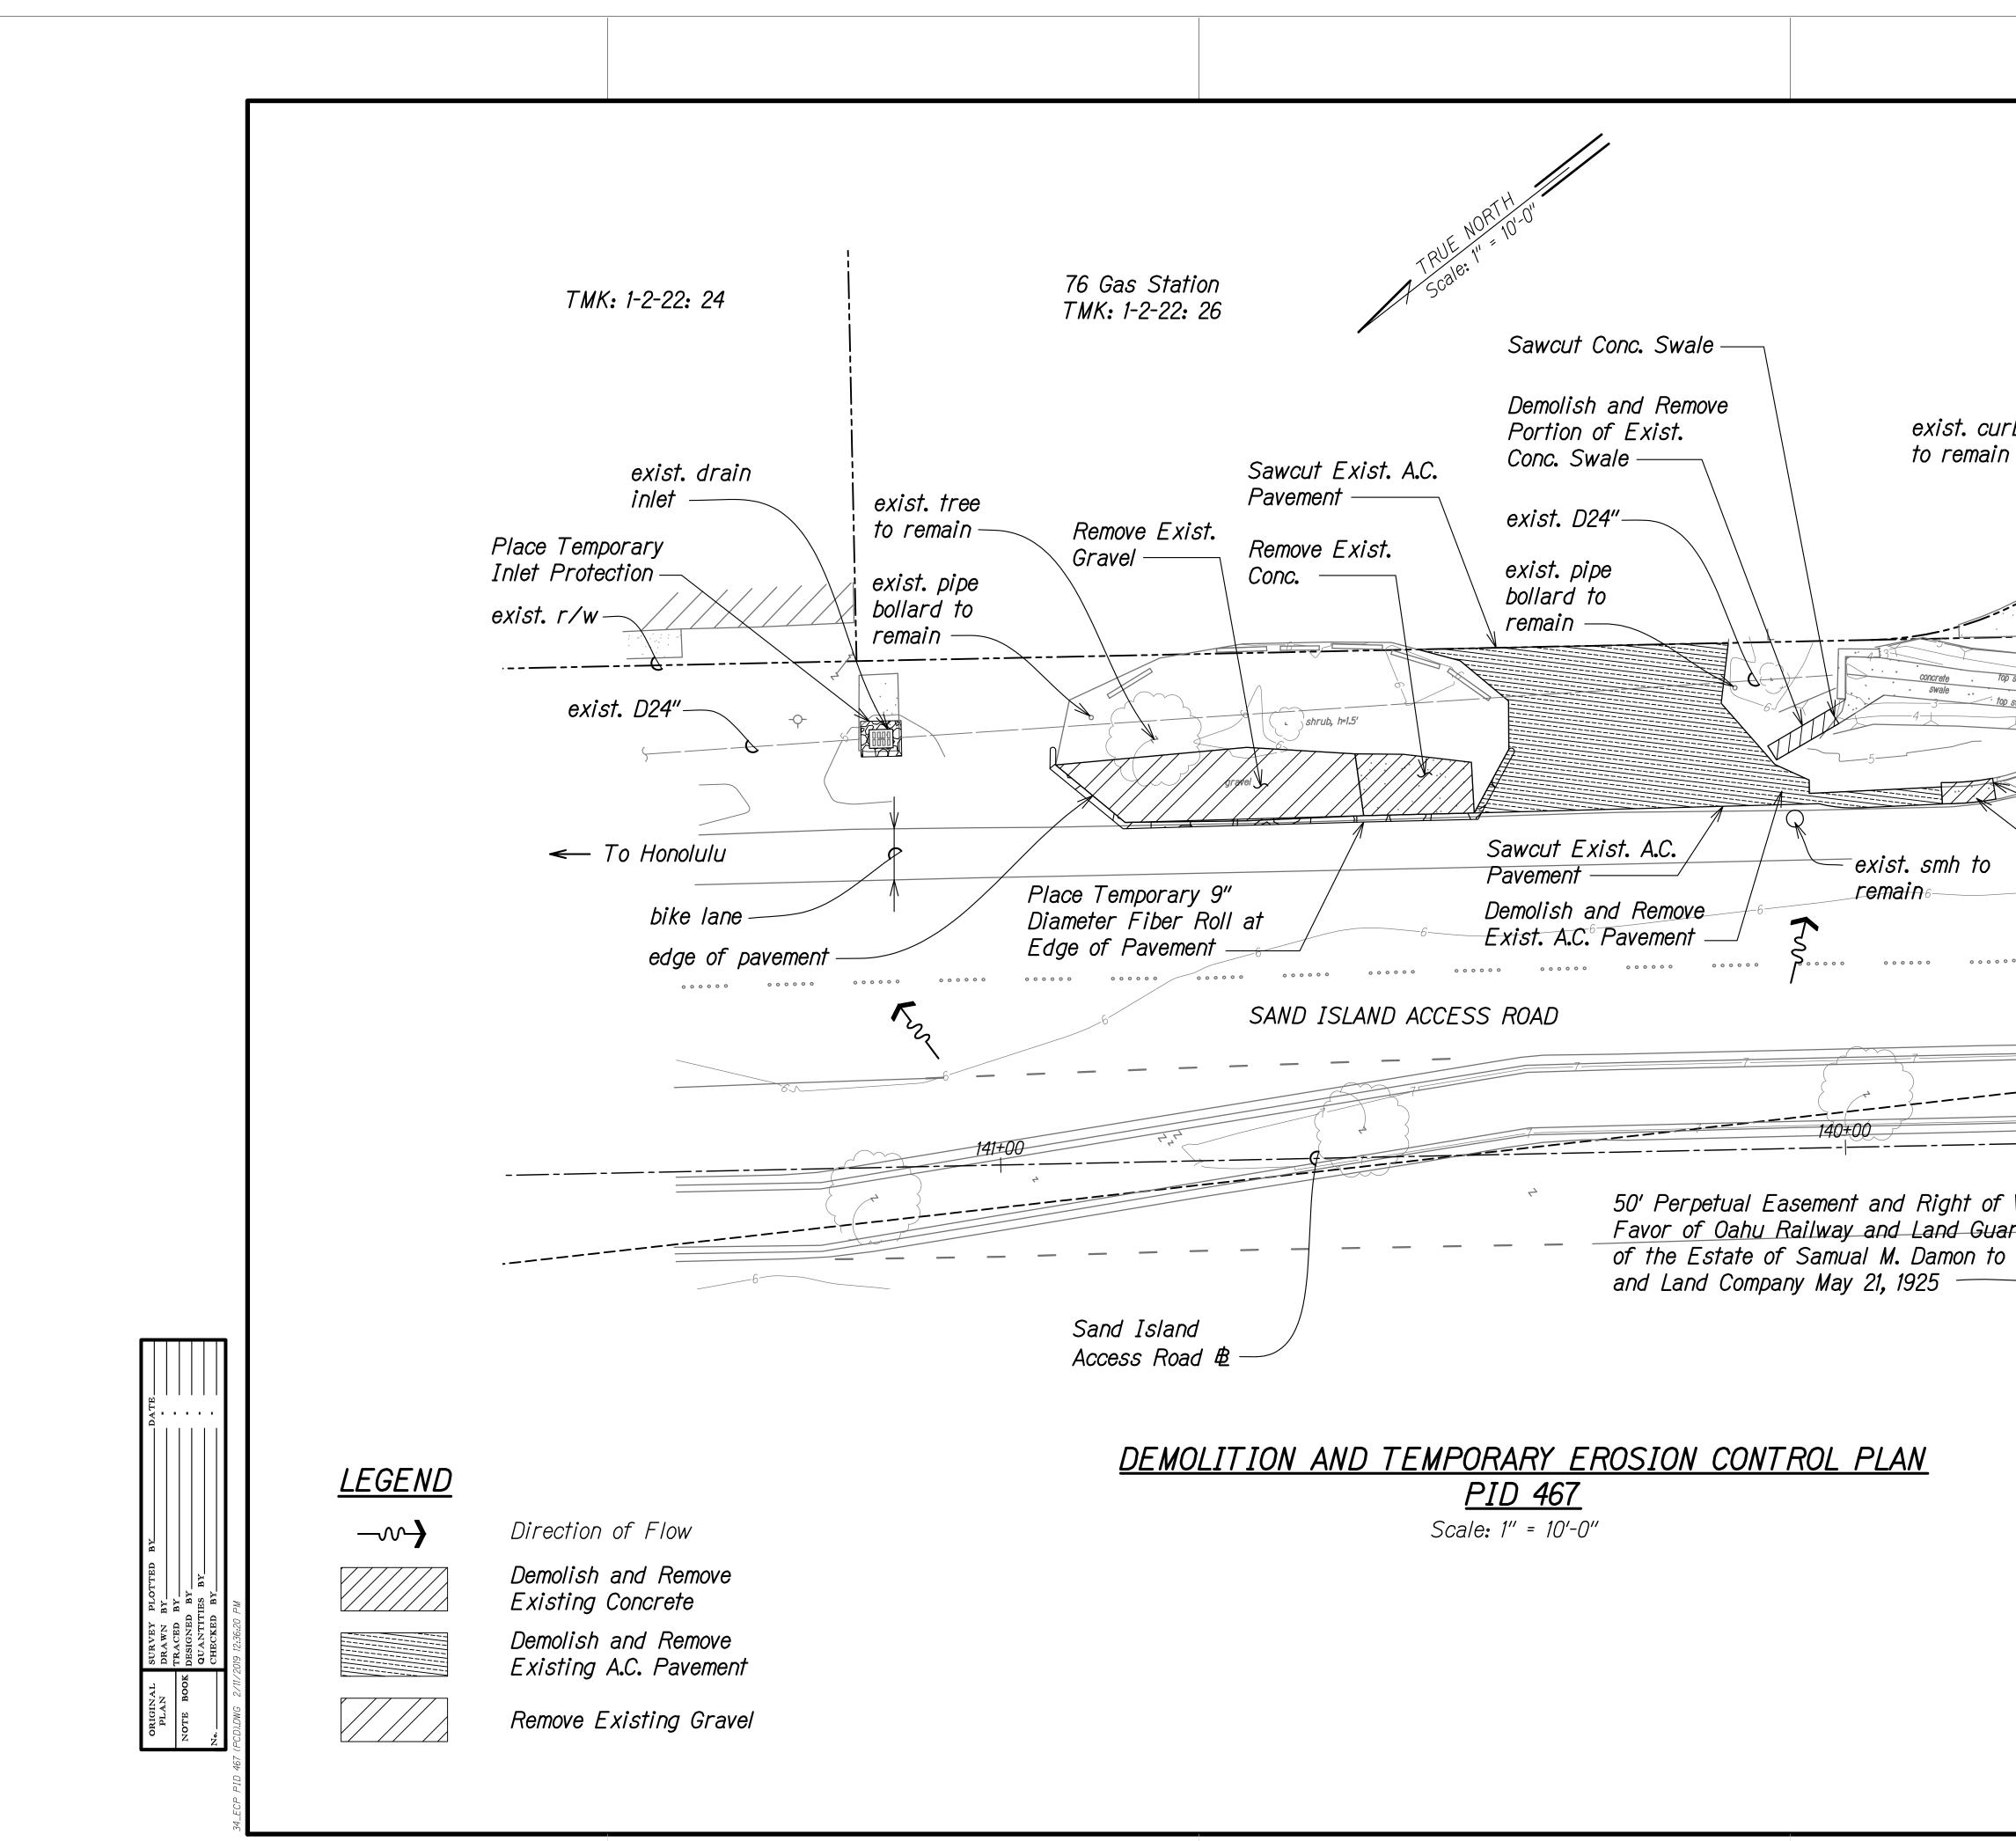



	FED. ROAD	STATE	PROJ. NO.	FISCAL	SHEET	TOTAL
	DIST. NO. HAWAII	HAW.	HWY-O-01-18	YEAR 2018	NO. C.O. 30S-1	SHEETS 65
And Concentrations of the second seco	1 1 1 1 1 1 1 1 1 1 1 1 1 1 1 1 1 1 1		State City			

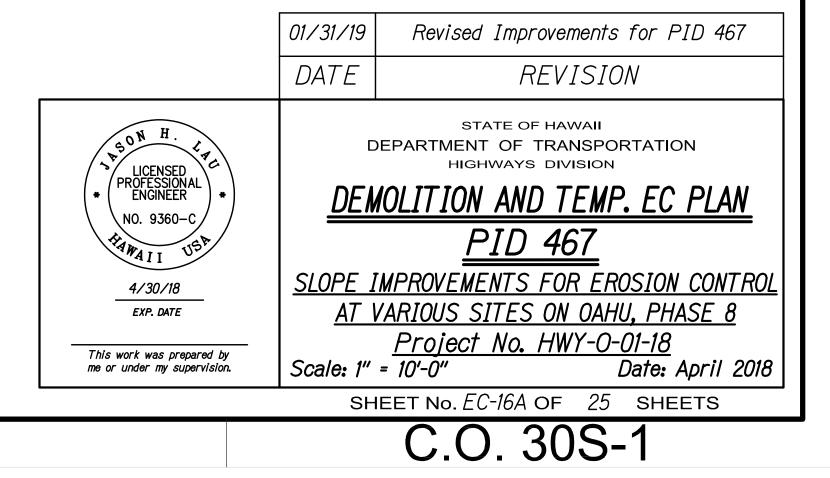


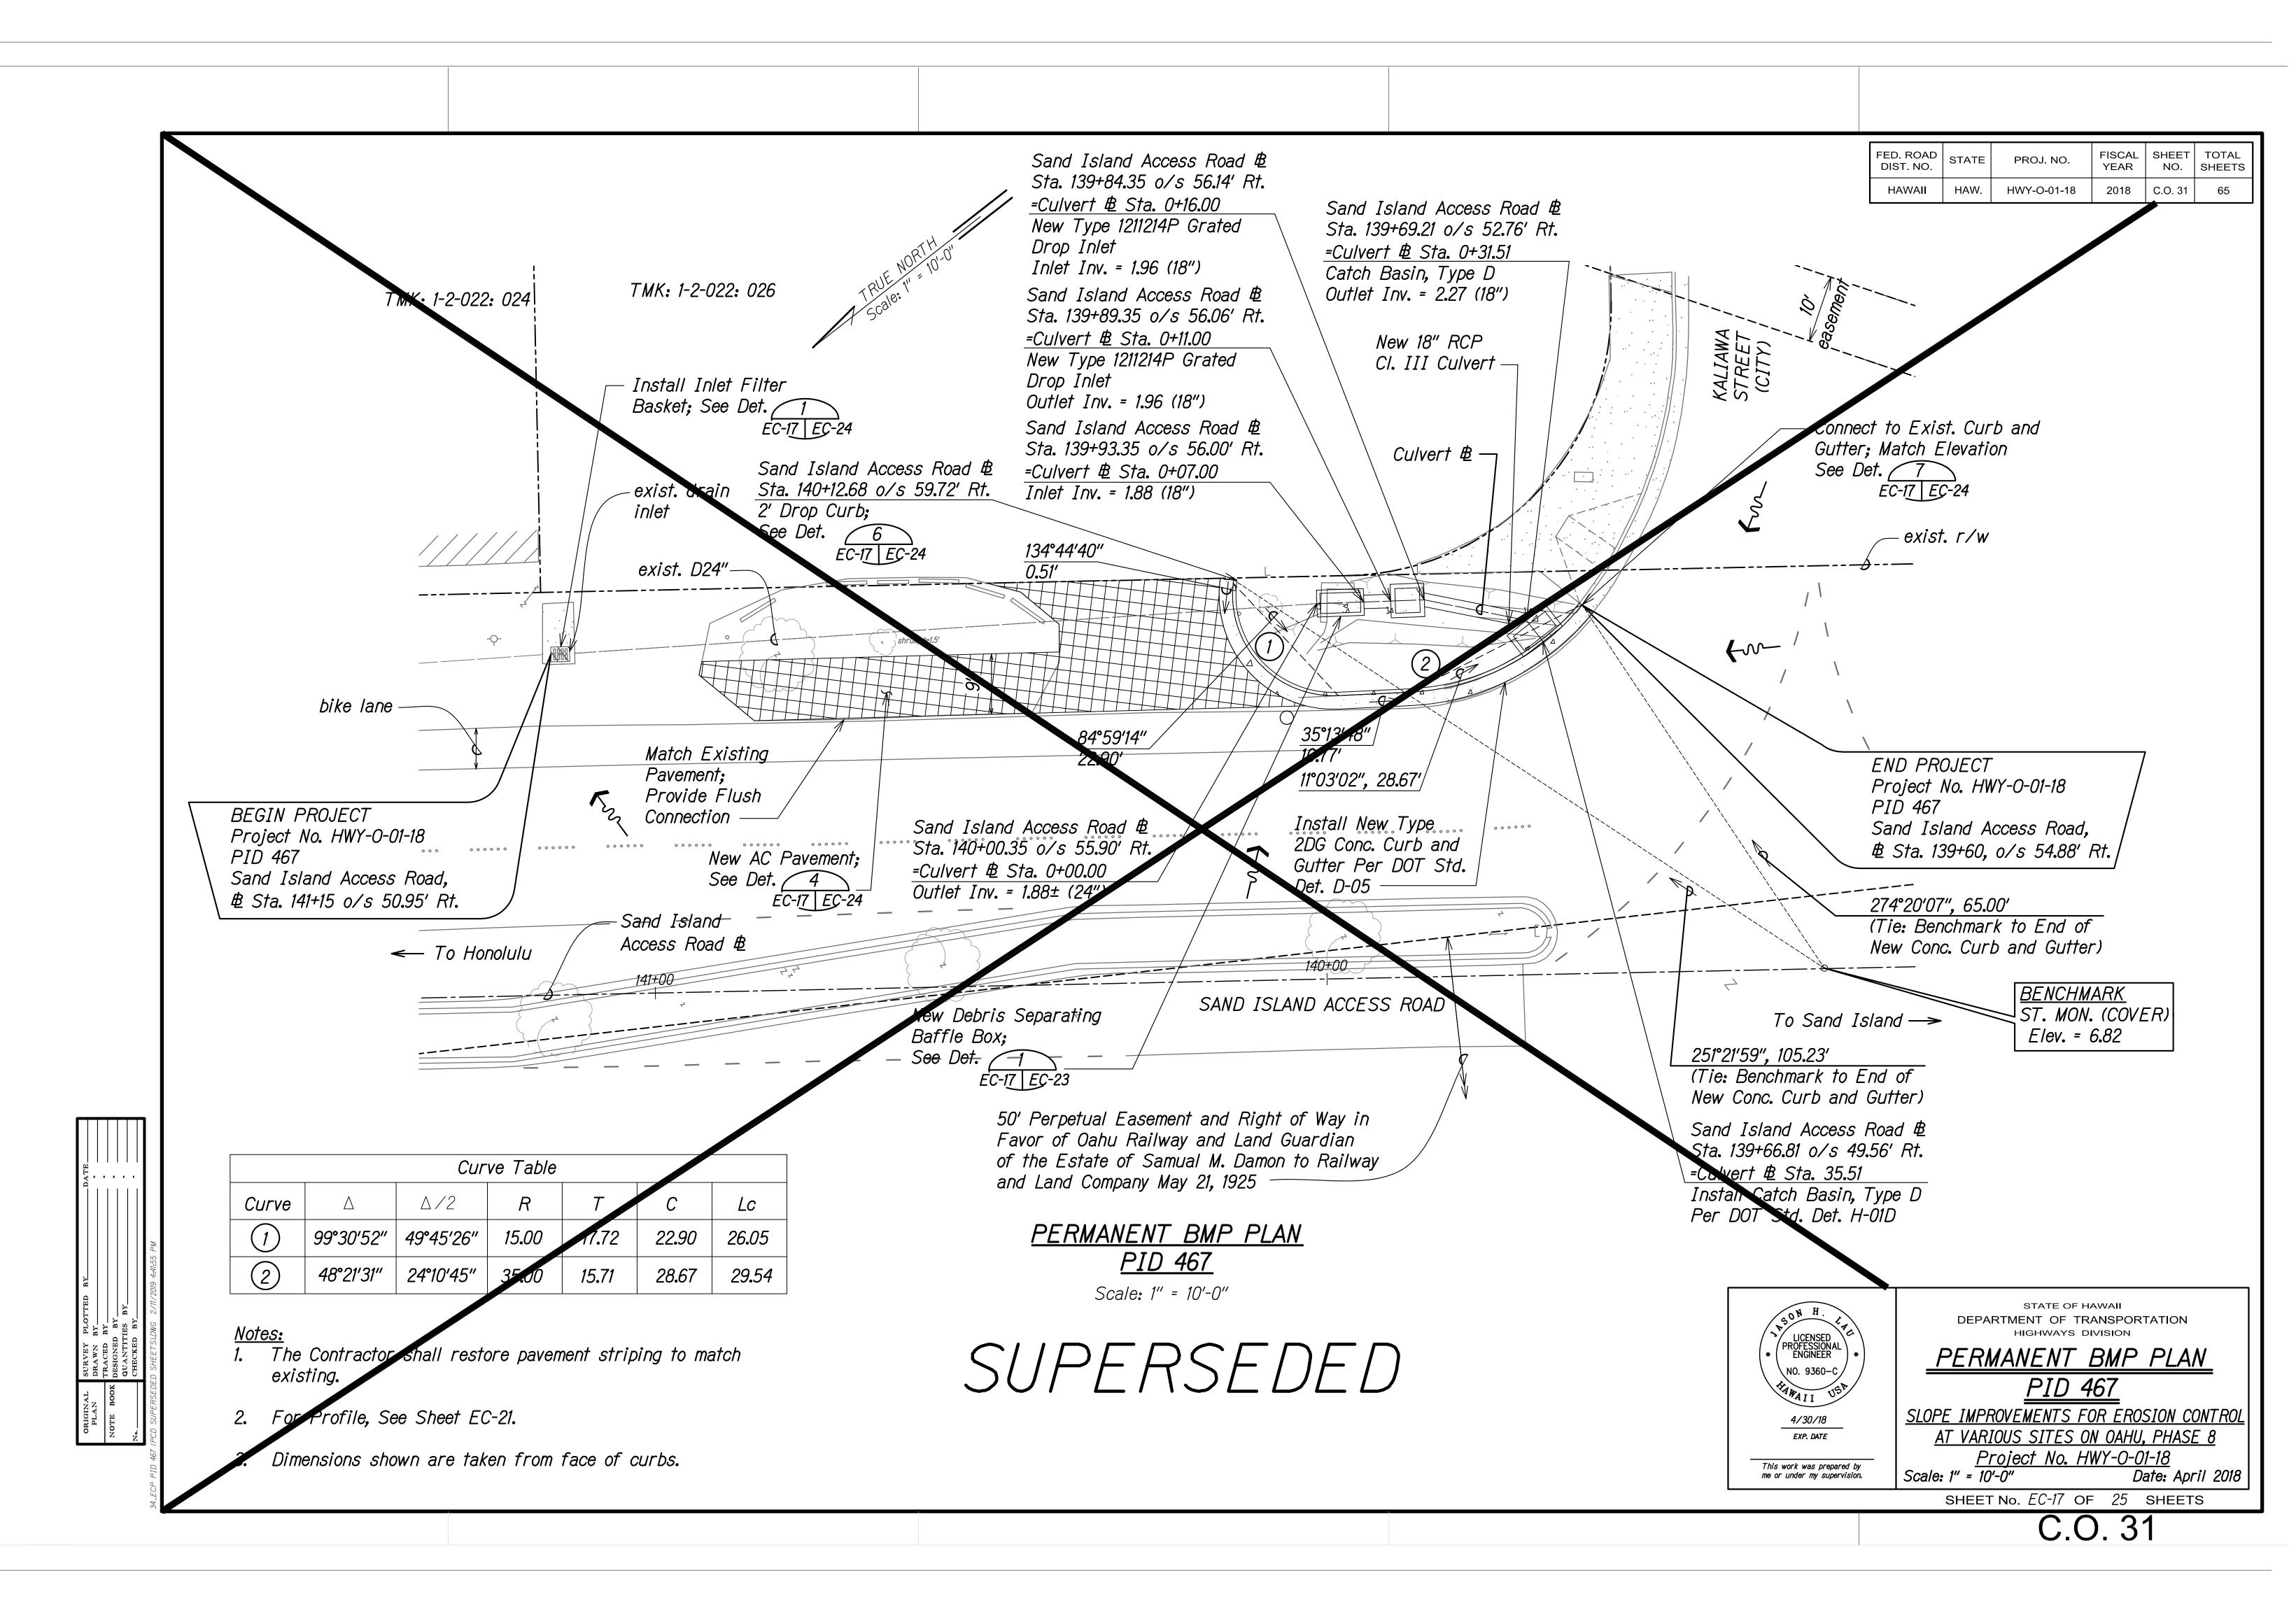

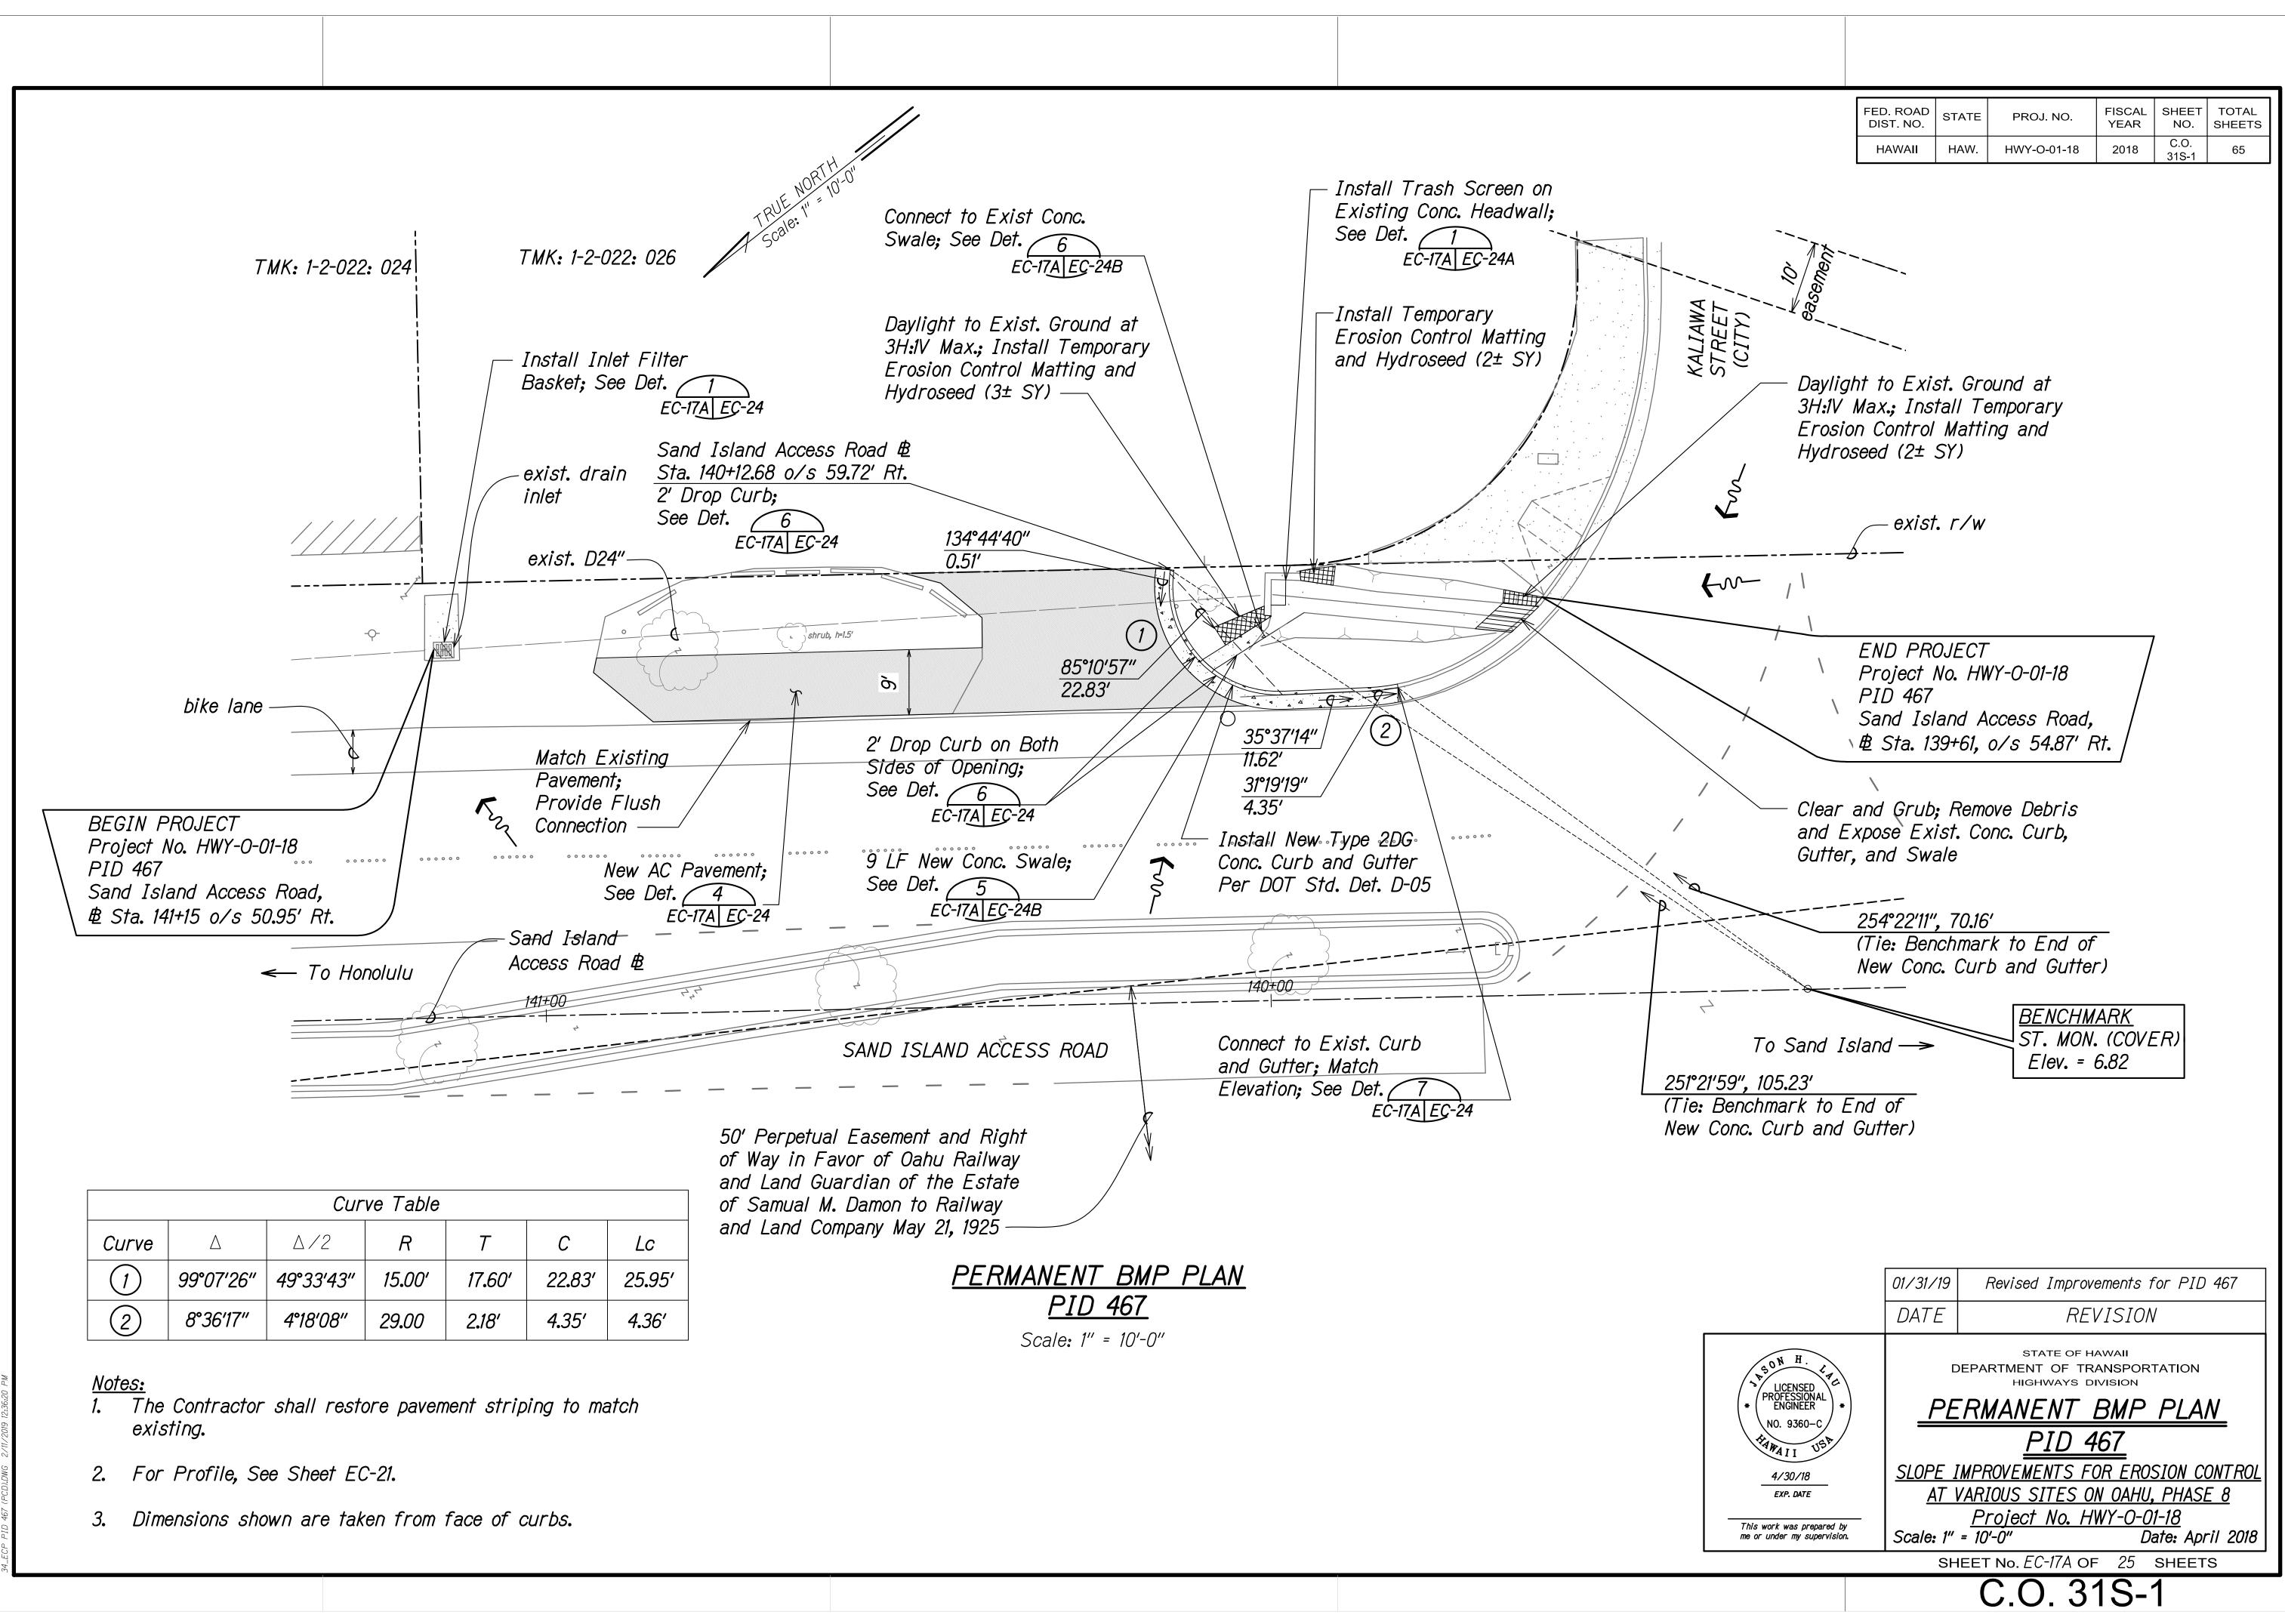

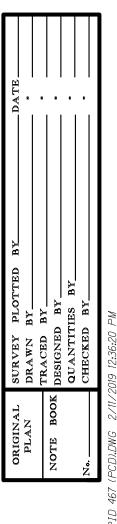


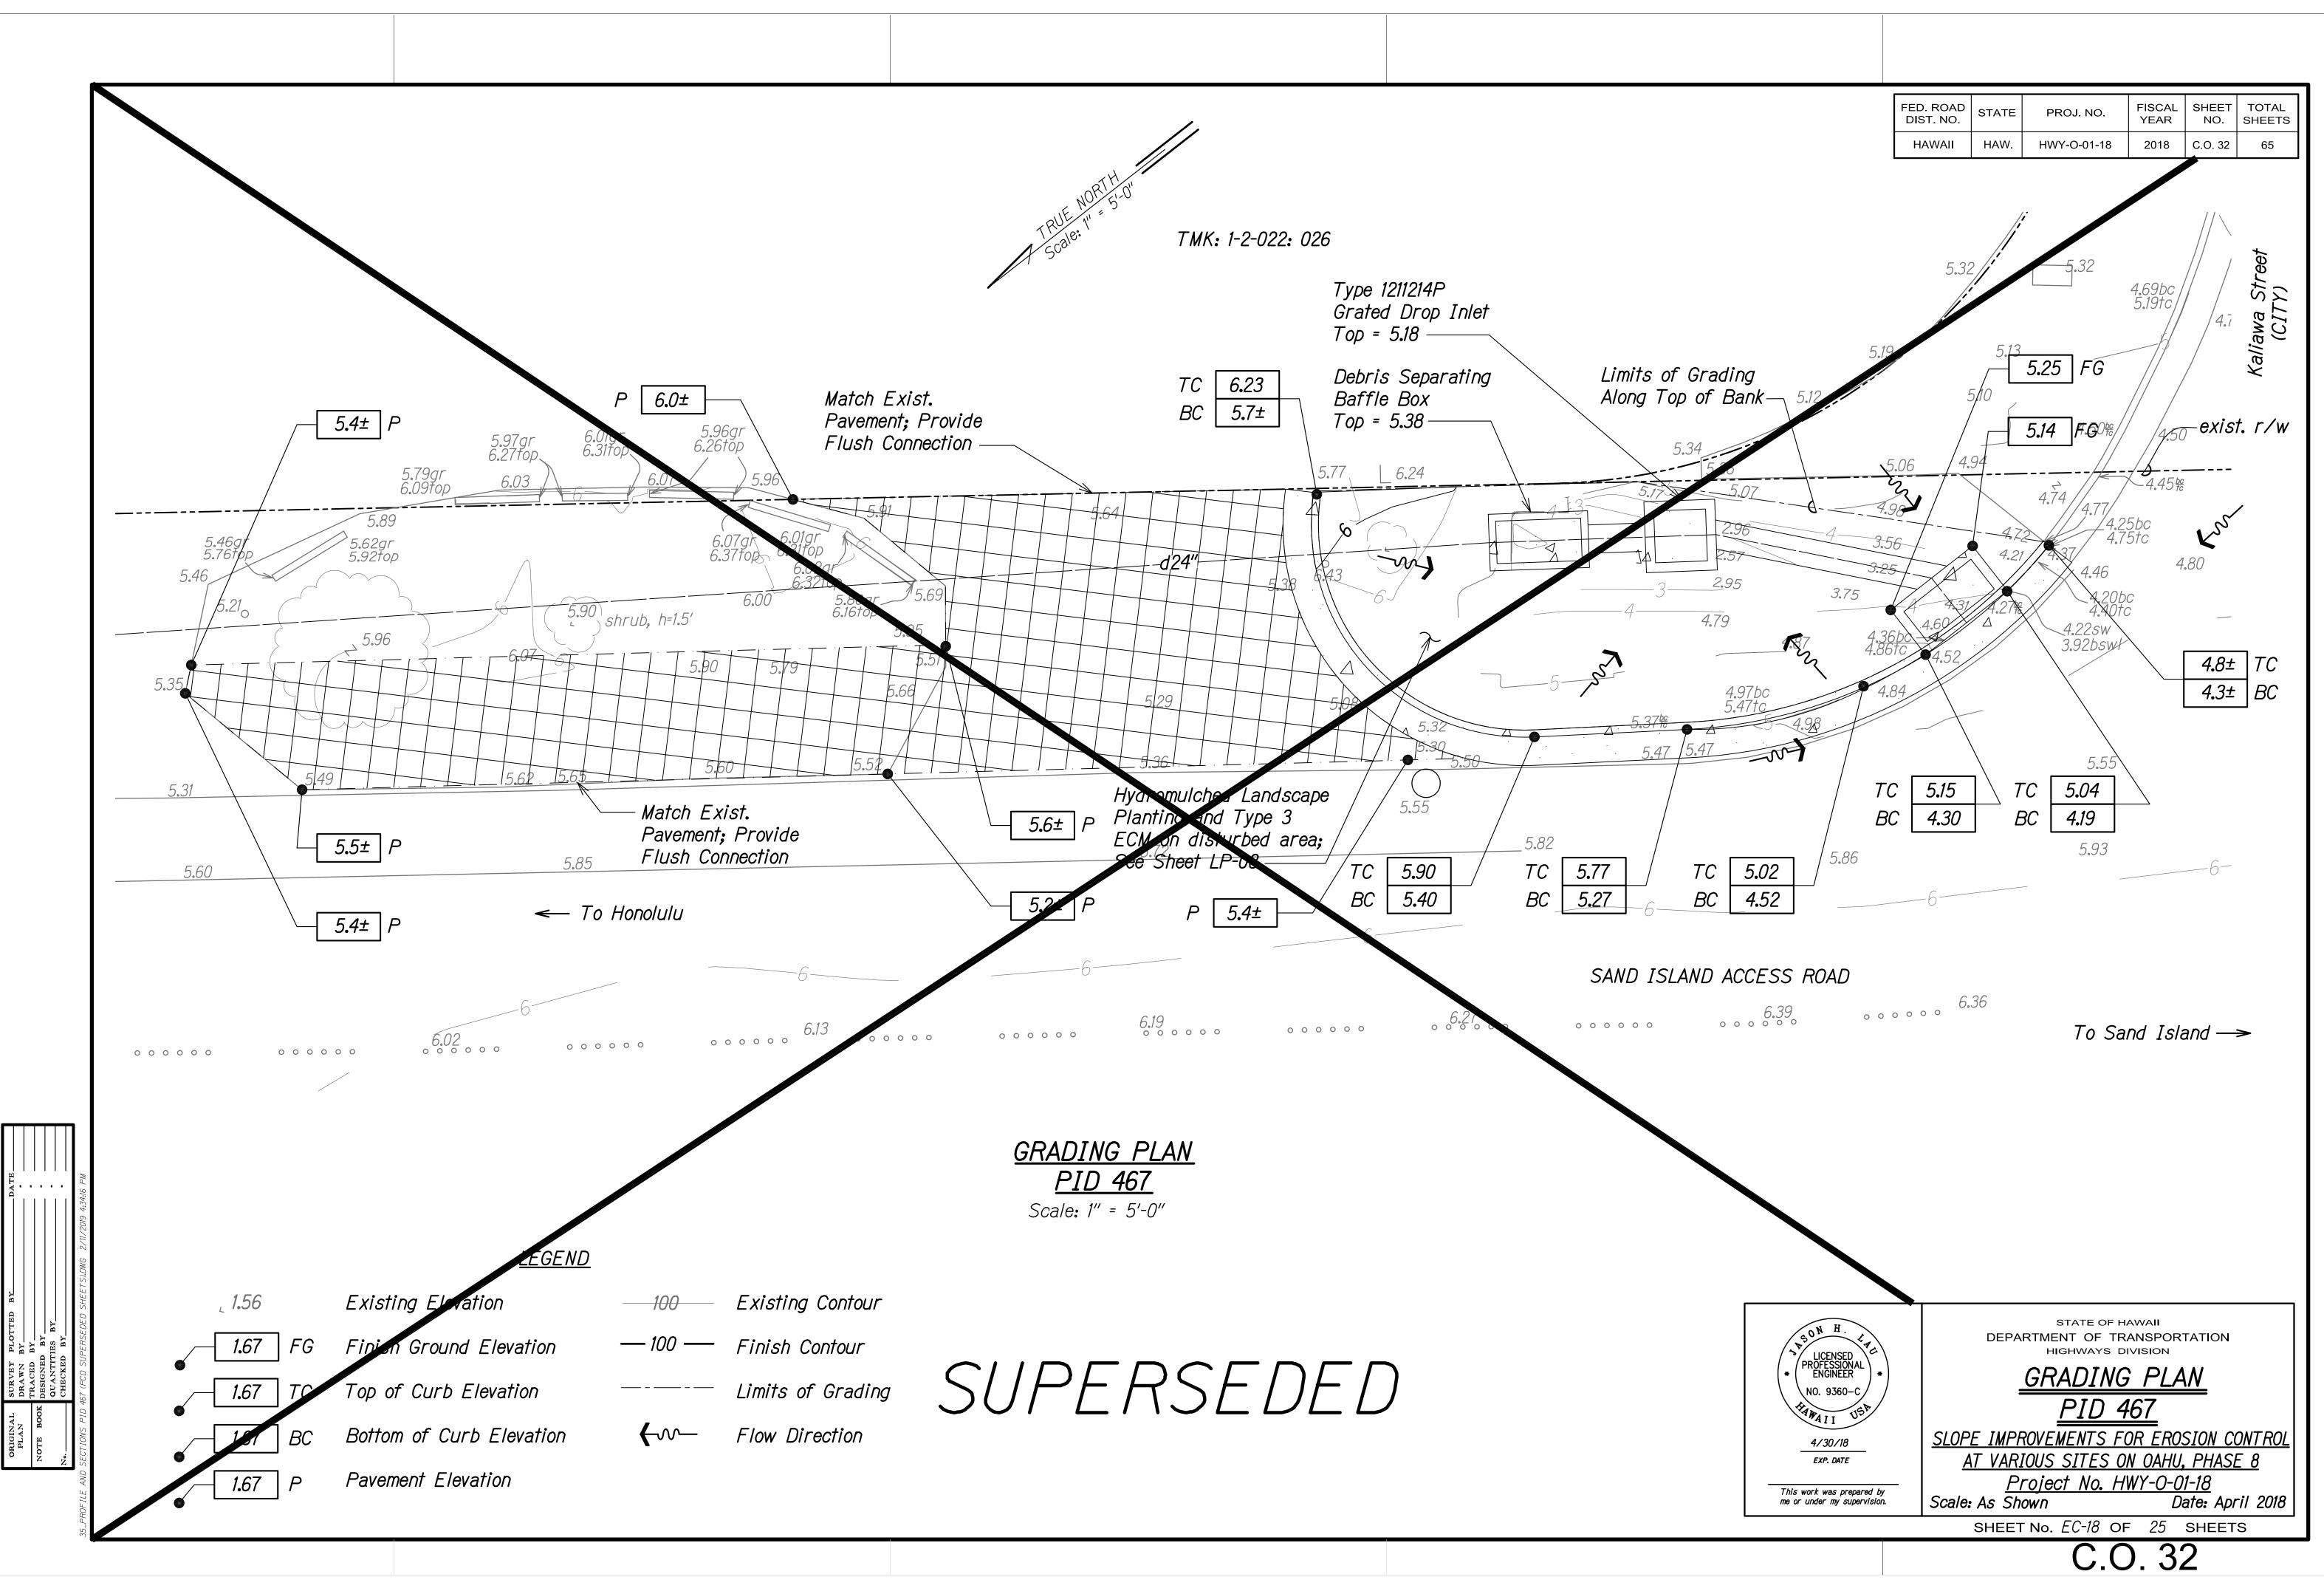


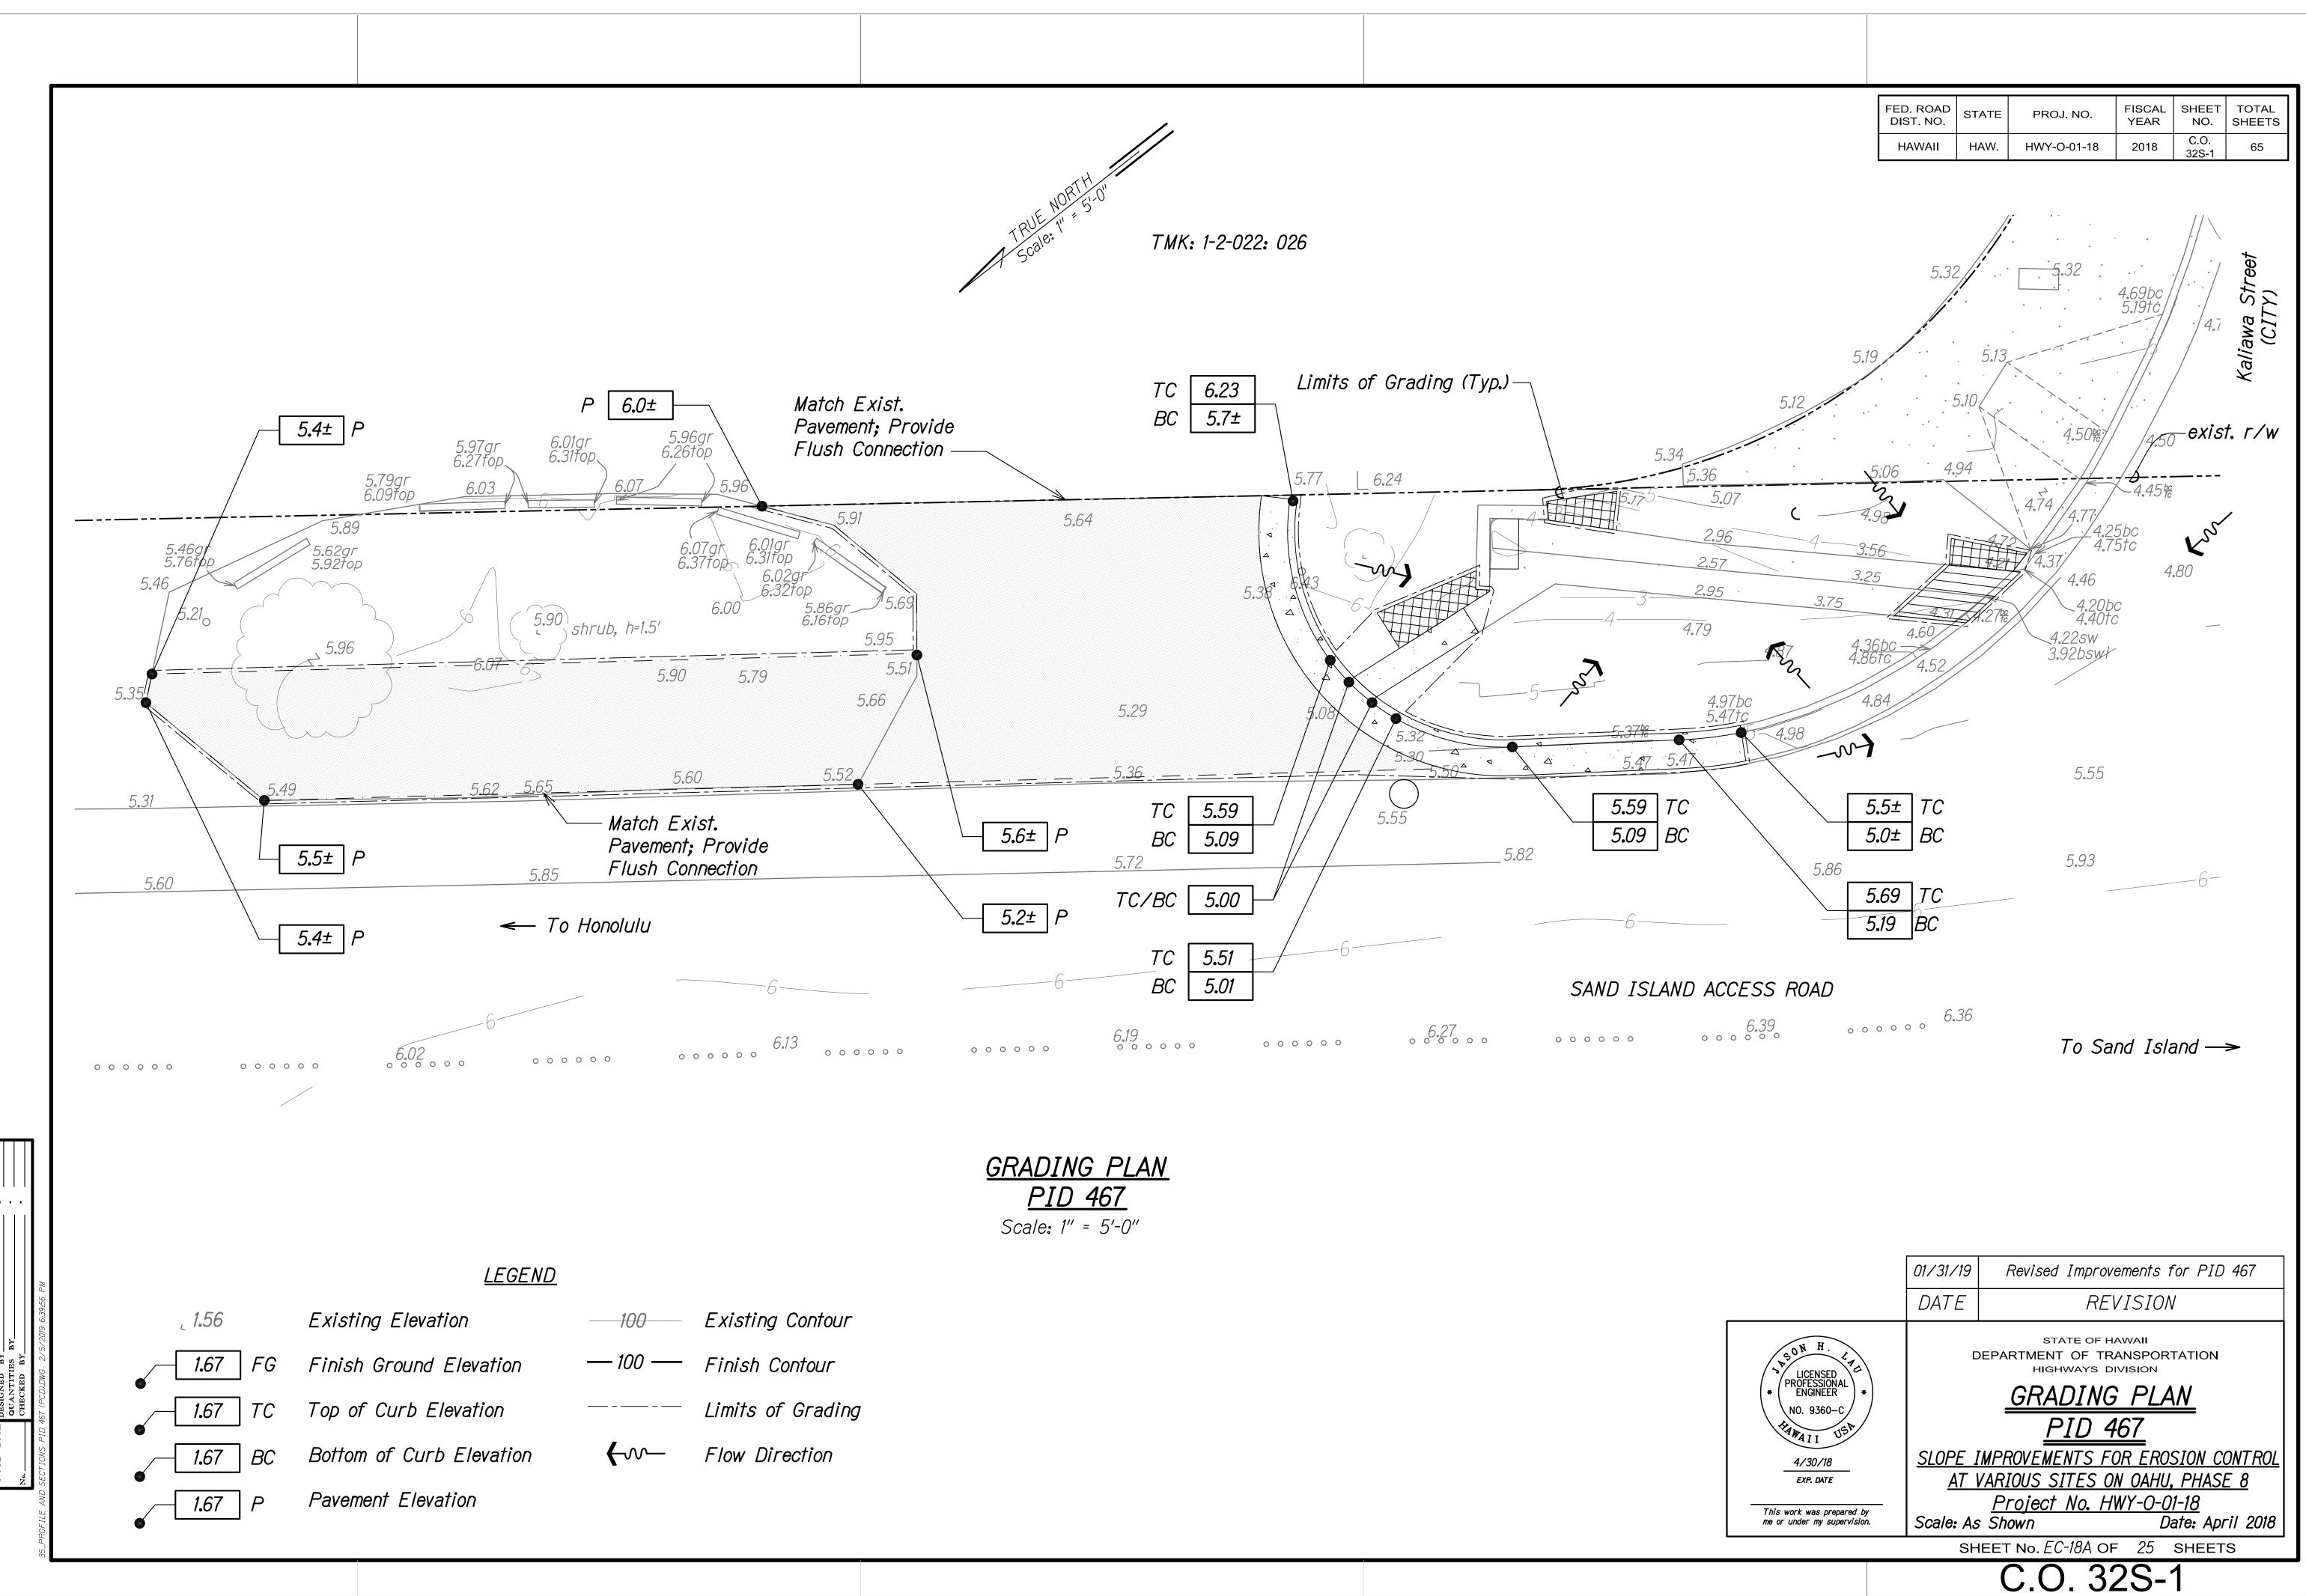



GRADING PLAN
<u>PID 467</u>
Scale: 1" = 5'-0"

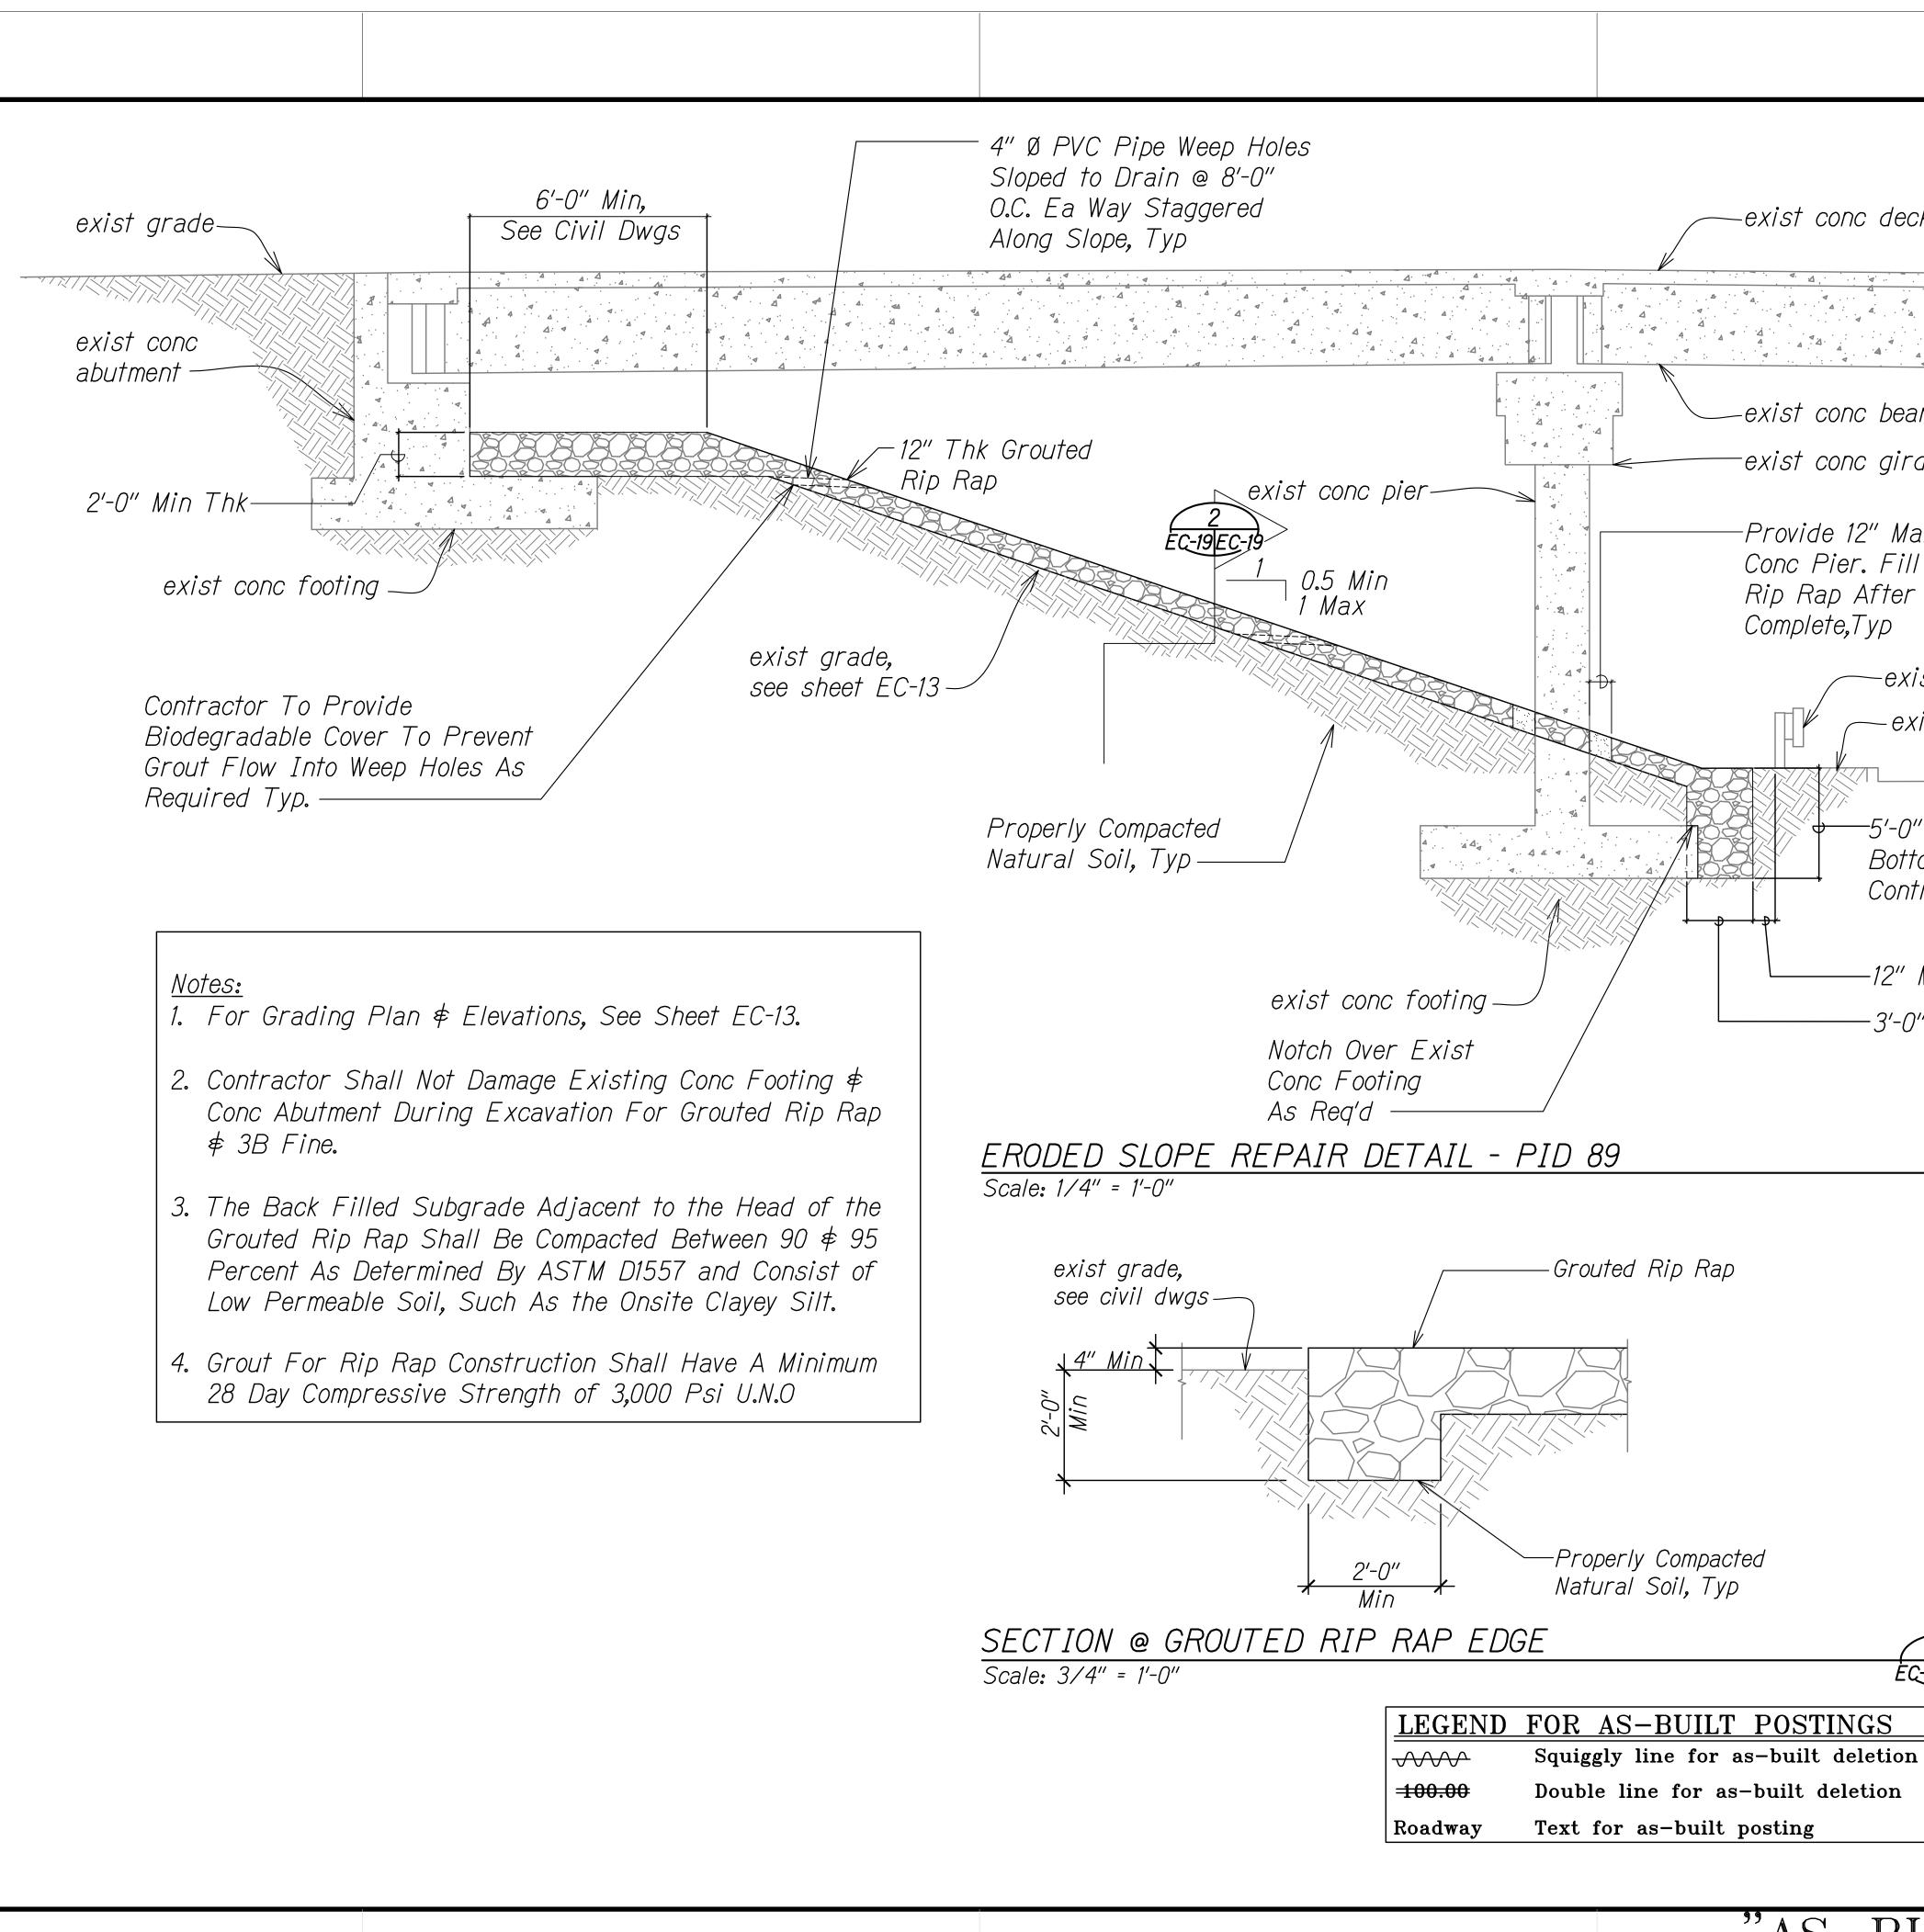

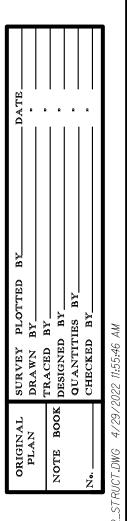



FED. ROAD	STATE	PROJ. NO.	FISCAL YEAR	SHEET NO.	TOTAL SHEETS
DIST. NO.				NO.	

-exist conc deck

-exist conc beam exist conc girder -Provide 12" Max Clear Around Exist Conc Pier. Fill Gap w/ Grout Used For Rip Rap After Rip Rap Installation Is -exist guardrail -exist grade -exist ac pavement -5'-0" Min, Do Not Extend Beyond Bottom Of Exist Conc Footing. Contractor To Verify -12" Min Clear, See Civil Dwgs -3'-0" Min ÉC-19EC-19 STATE OF HAWAII DEPARTMENT OF TRANSPORTATION PROGRESS SET EC-19EC-19 HIGHWAYS DIVISION ERODED SLOPE REPAIR DETAIL NOT FOR <u>PID 89</u> CONSTRUCTION SLOPE IMPROVEMENTS FOR EROSION CONTROL 4/30/20 AT VARIOUS SITES ON OAHU, PHASE 8 EXP. DATE Project No. HWY-0-01-18 This work was prepared by me or under my supervision. Scale: As Shown Date: April 2018 SHEET No. EC-19 OF 25 SHEETS 33 "AS-BUILT"

					exi
			· · · A.		
		Ņ	exist beam,	_	exist co exist co
			Provide 12 Conc Pier. For Rip R Installatio	Fill Gap Pap After	w∕ Grout Rip Rap
			exist conc	walkway -	
		exist ac p	pavement —		
		Bottom	n, Do Not E Of Exist Co tor To Verif	nc Footing	
					3'-0" Min
1	<u>Notes:</u> 1. For Gra	ading Plan 4	Elevations,	See Shee	et EC-14.
		ctor Shall No tment During	•	-	
	Grouted H Percent A	ack Filled Su Rip Rap Sha As Determine e Soil, Such	ll Be Compa d By ASTM	cted Betw D1557 and	een 90 ∉ : d Consist
		For Rip Rap ompressive S			
57.32 PM					
3/28/2018 5:57:32 PM		,			
STRUCT.DWG					
PID 89 \$ 92_STRUCT.DWG					

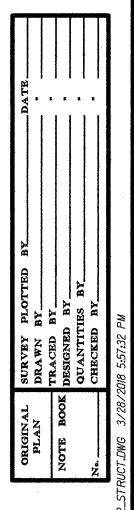


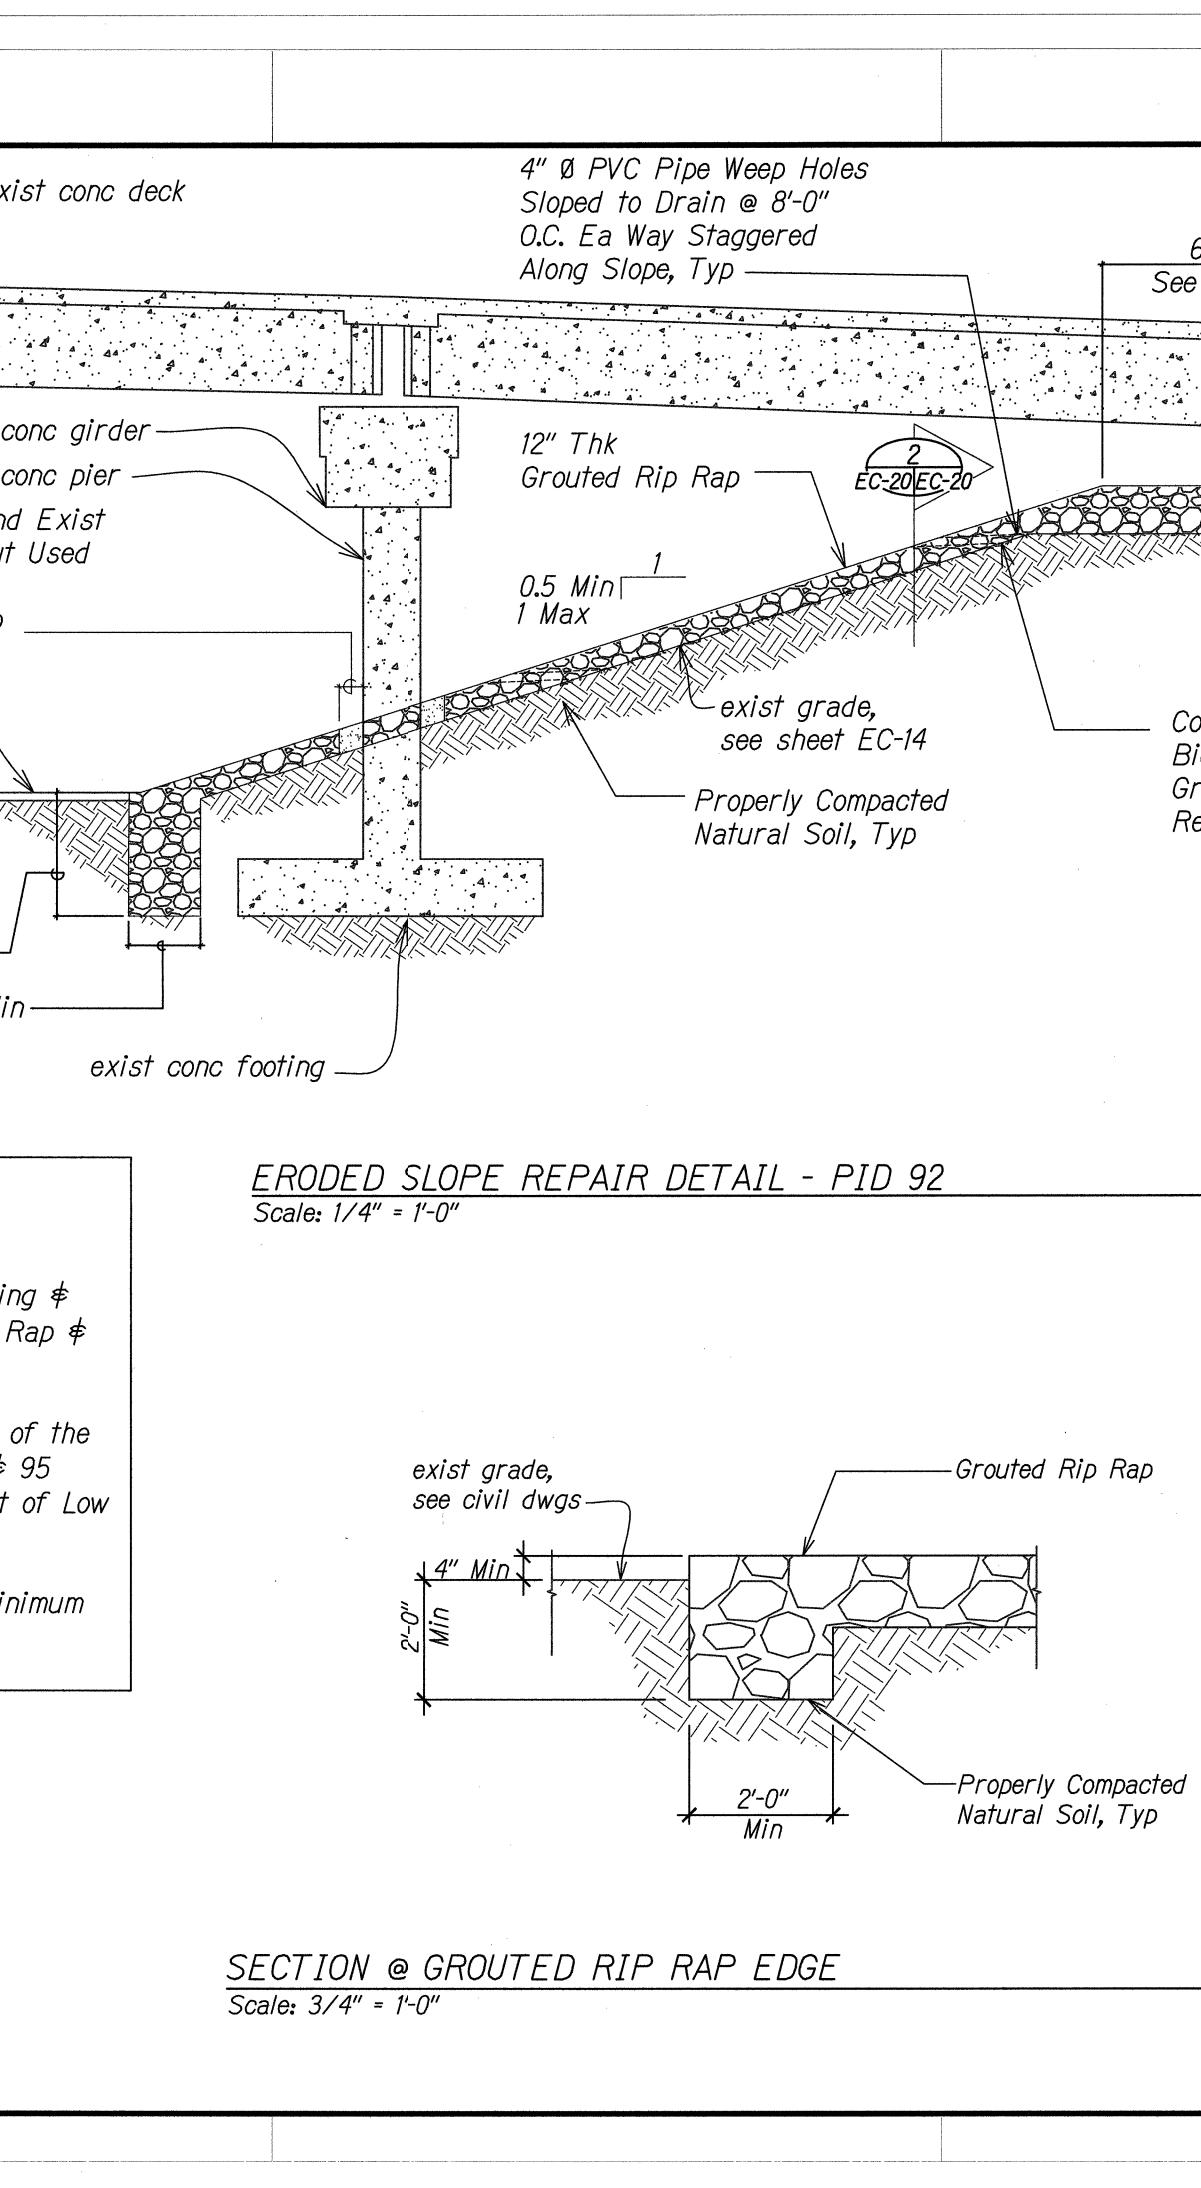


						,
	FED. ROAD DIST. NO.	STATE	PROJ. NO.	FISCAL YEAR	SHEET NO.	TOTAL SHEETS
	HAWAII	HAW.	HWY-O-01-18	2018	34	65
<u>6'-0" Min,</u> e Civil Dwgs	_exist g	rade			<u></u>	<u></u>
	exist c abutme		/ Yee			
exist conc footing						


Contractor To Provide Biodegradable Cover To Prevent Grout Flow Into Weep Holes As Required Typ.


ÉC-20EC-20

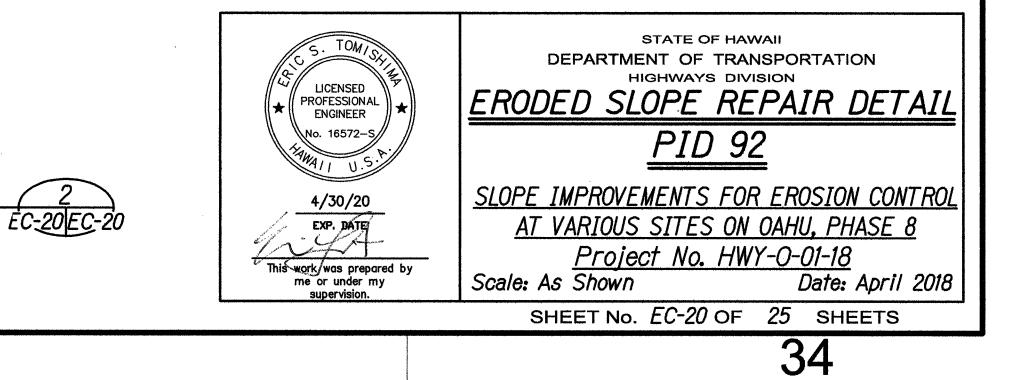

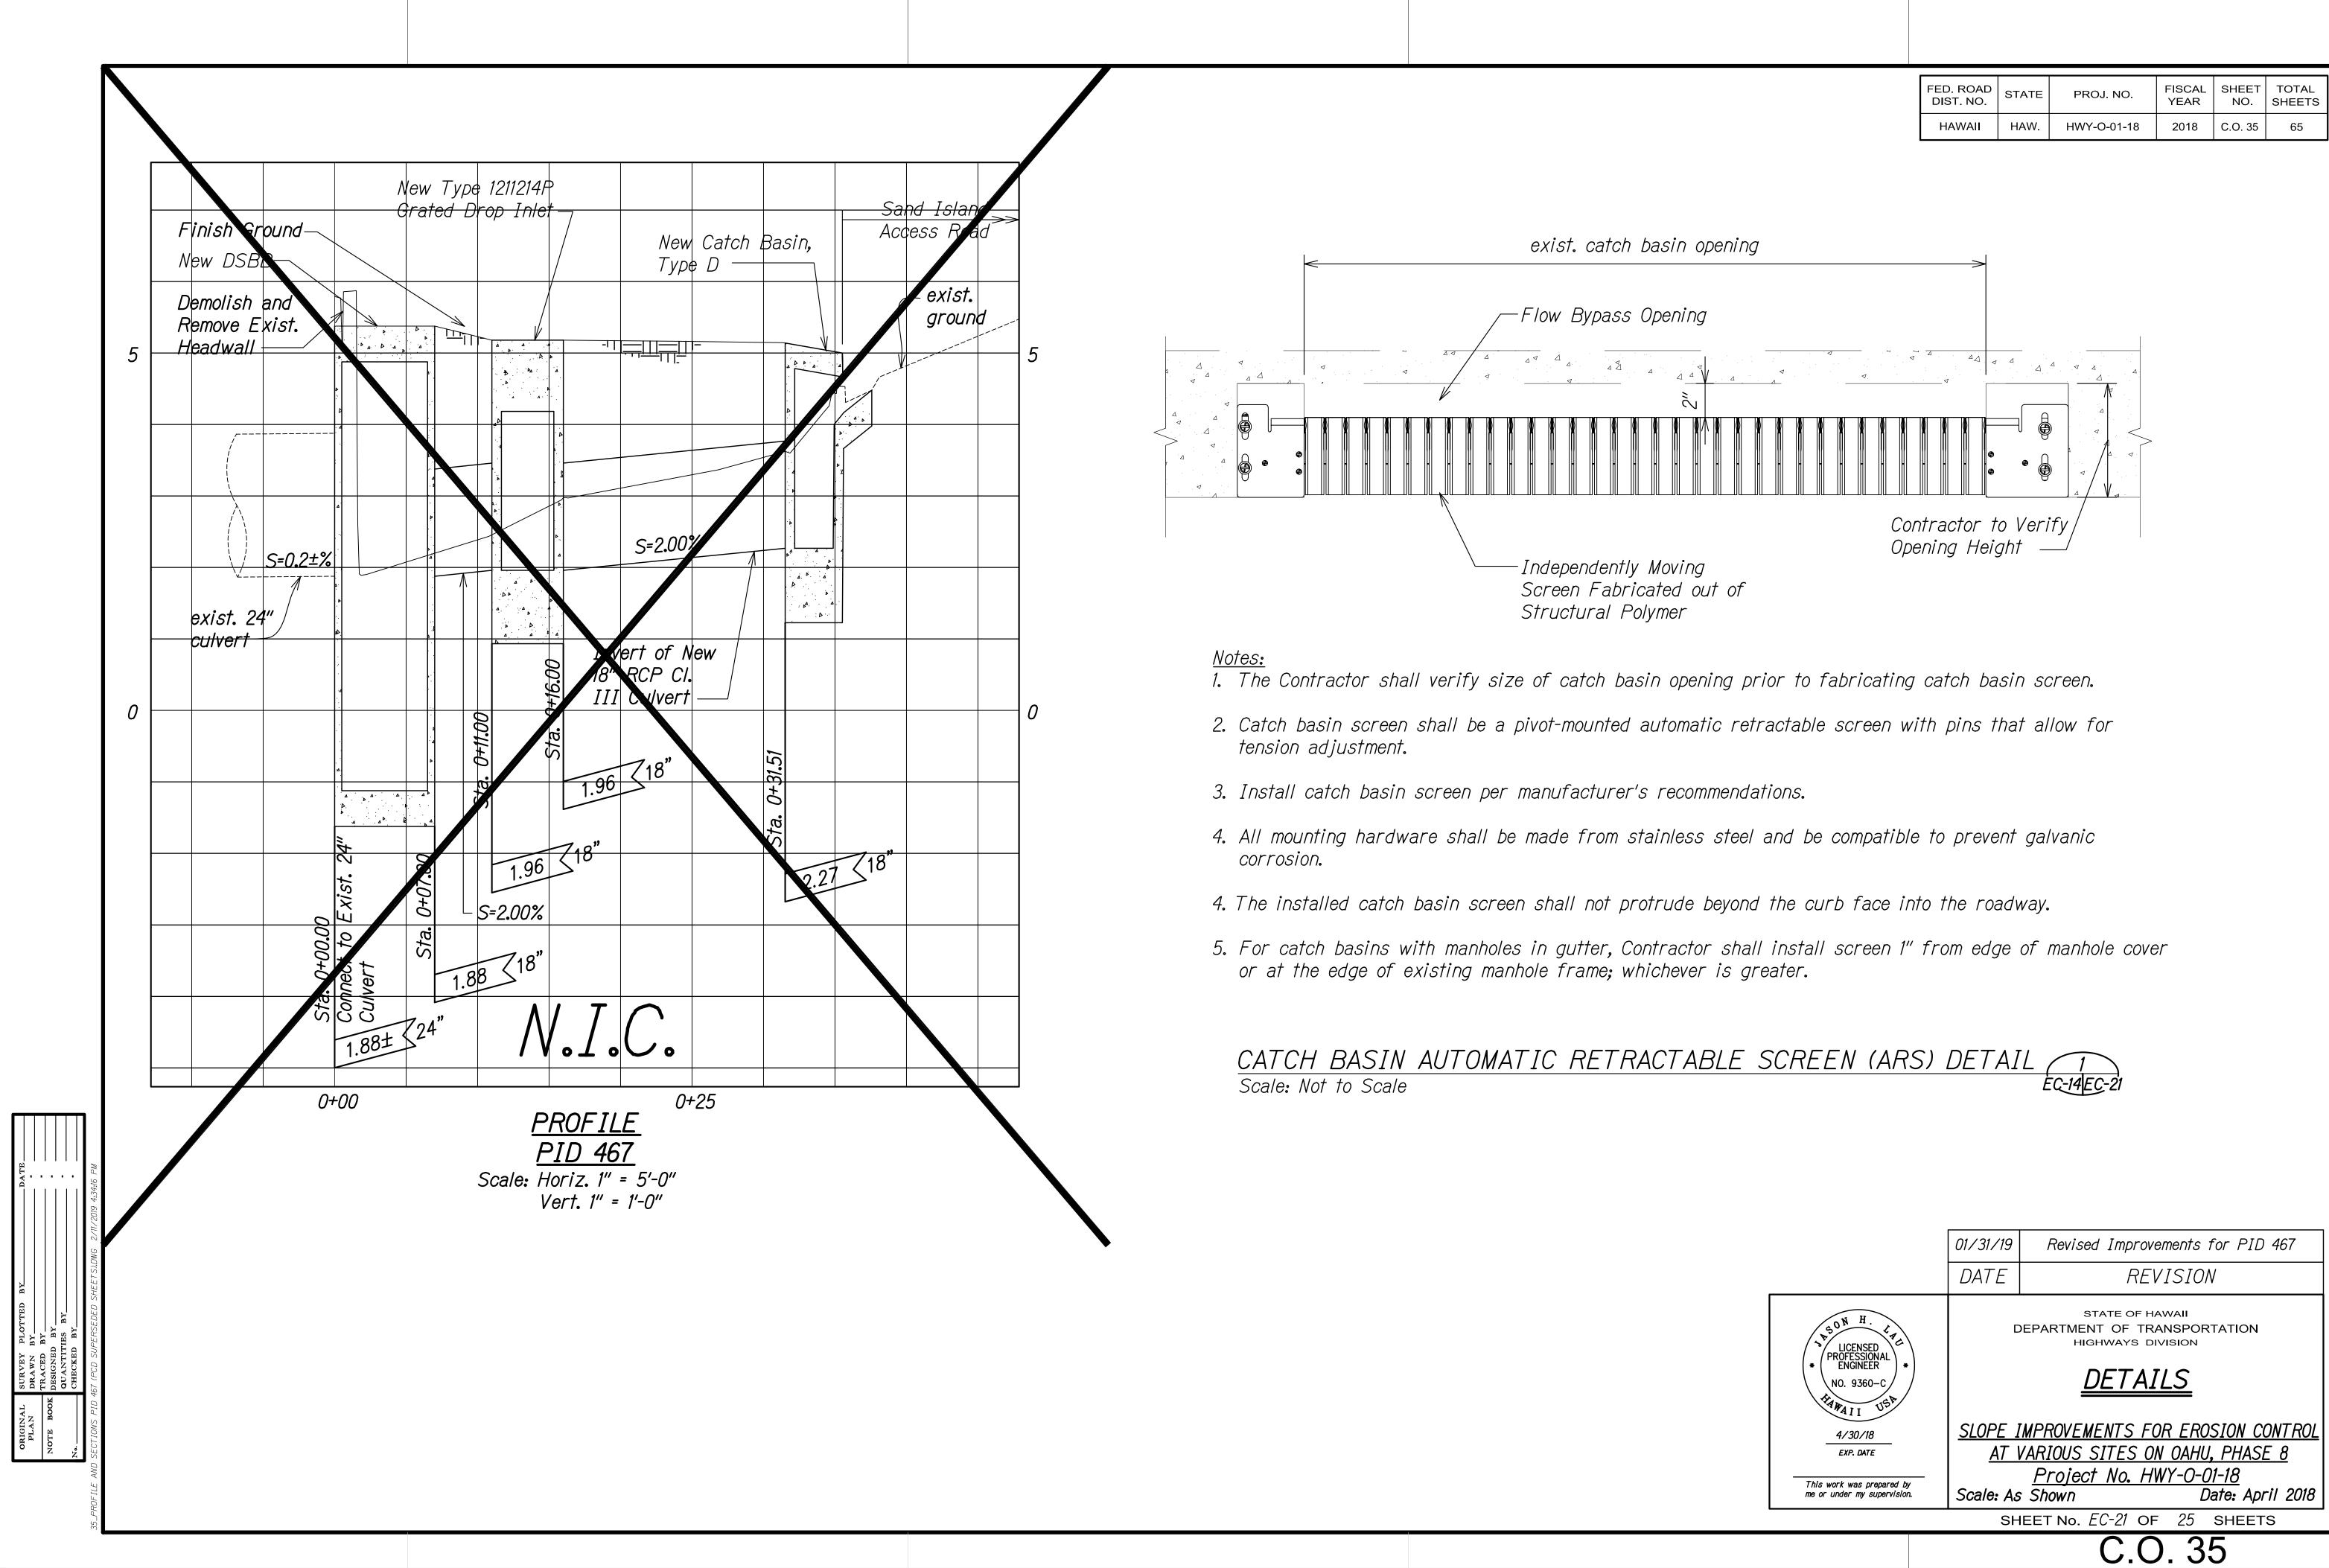



FED. ROAD DIST. NO.	STATE	PROJ. NO.	FISCAL YEAR	SHEET NO.	TOTAL SHEETS
HAWAII	HAW.	HWY-O-01-18	2018	C.O. 35	65

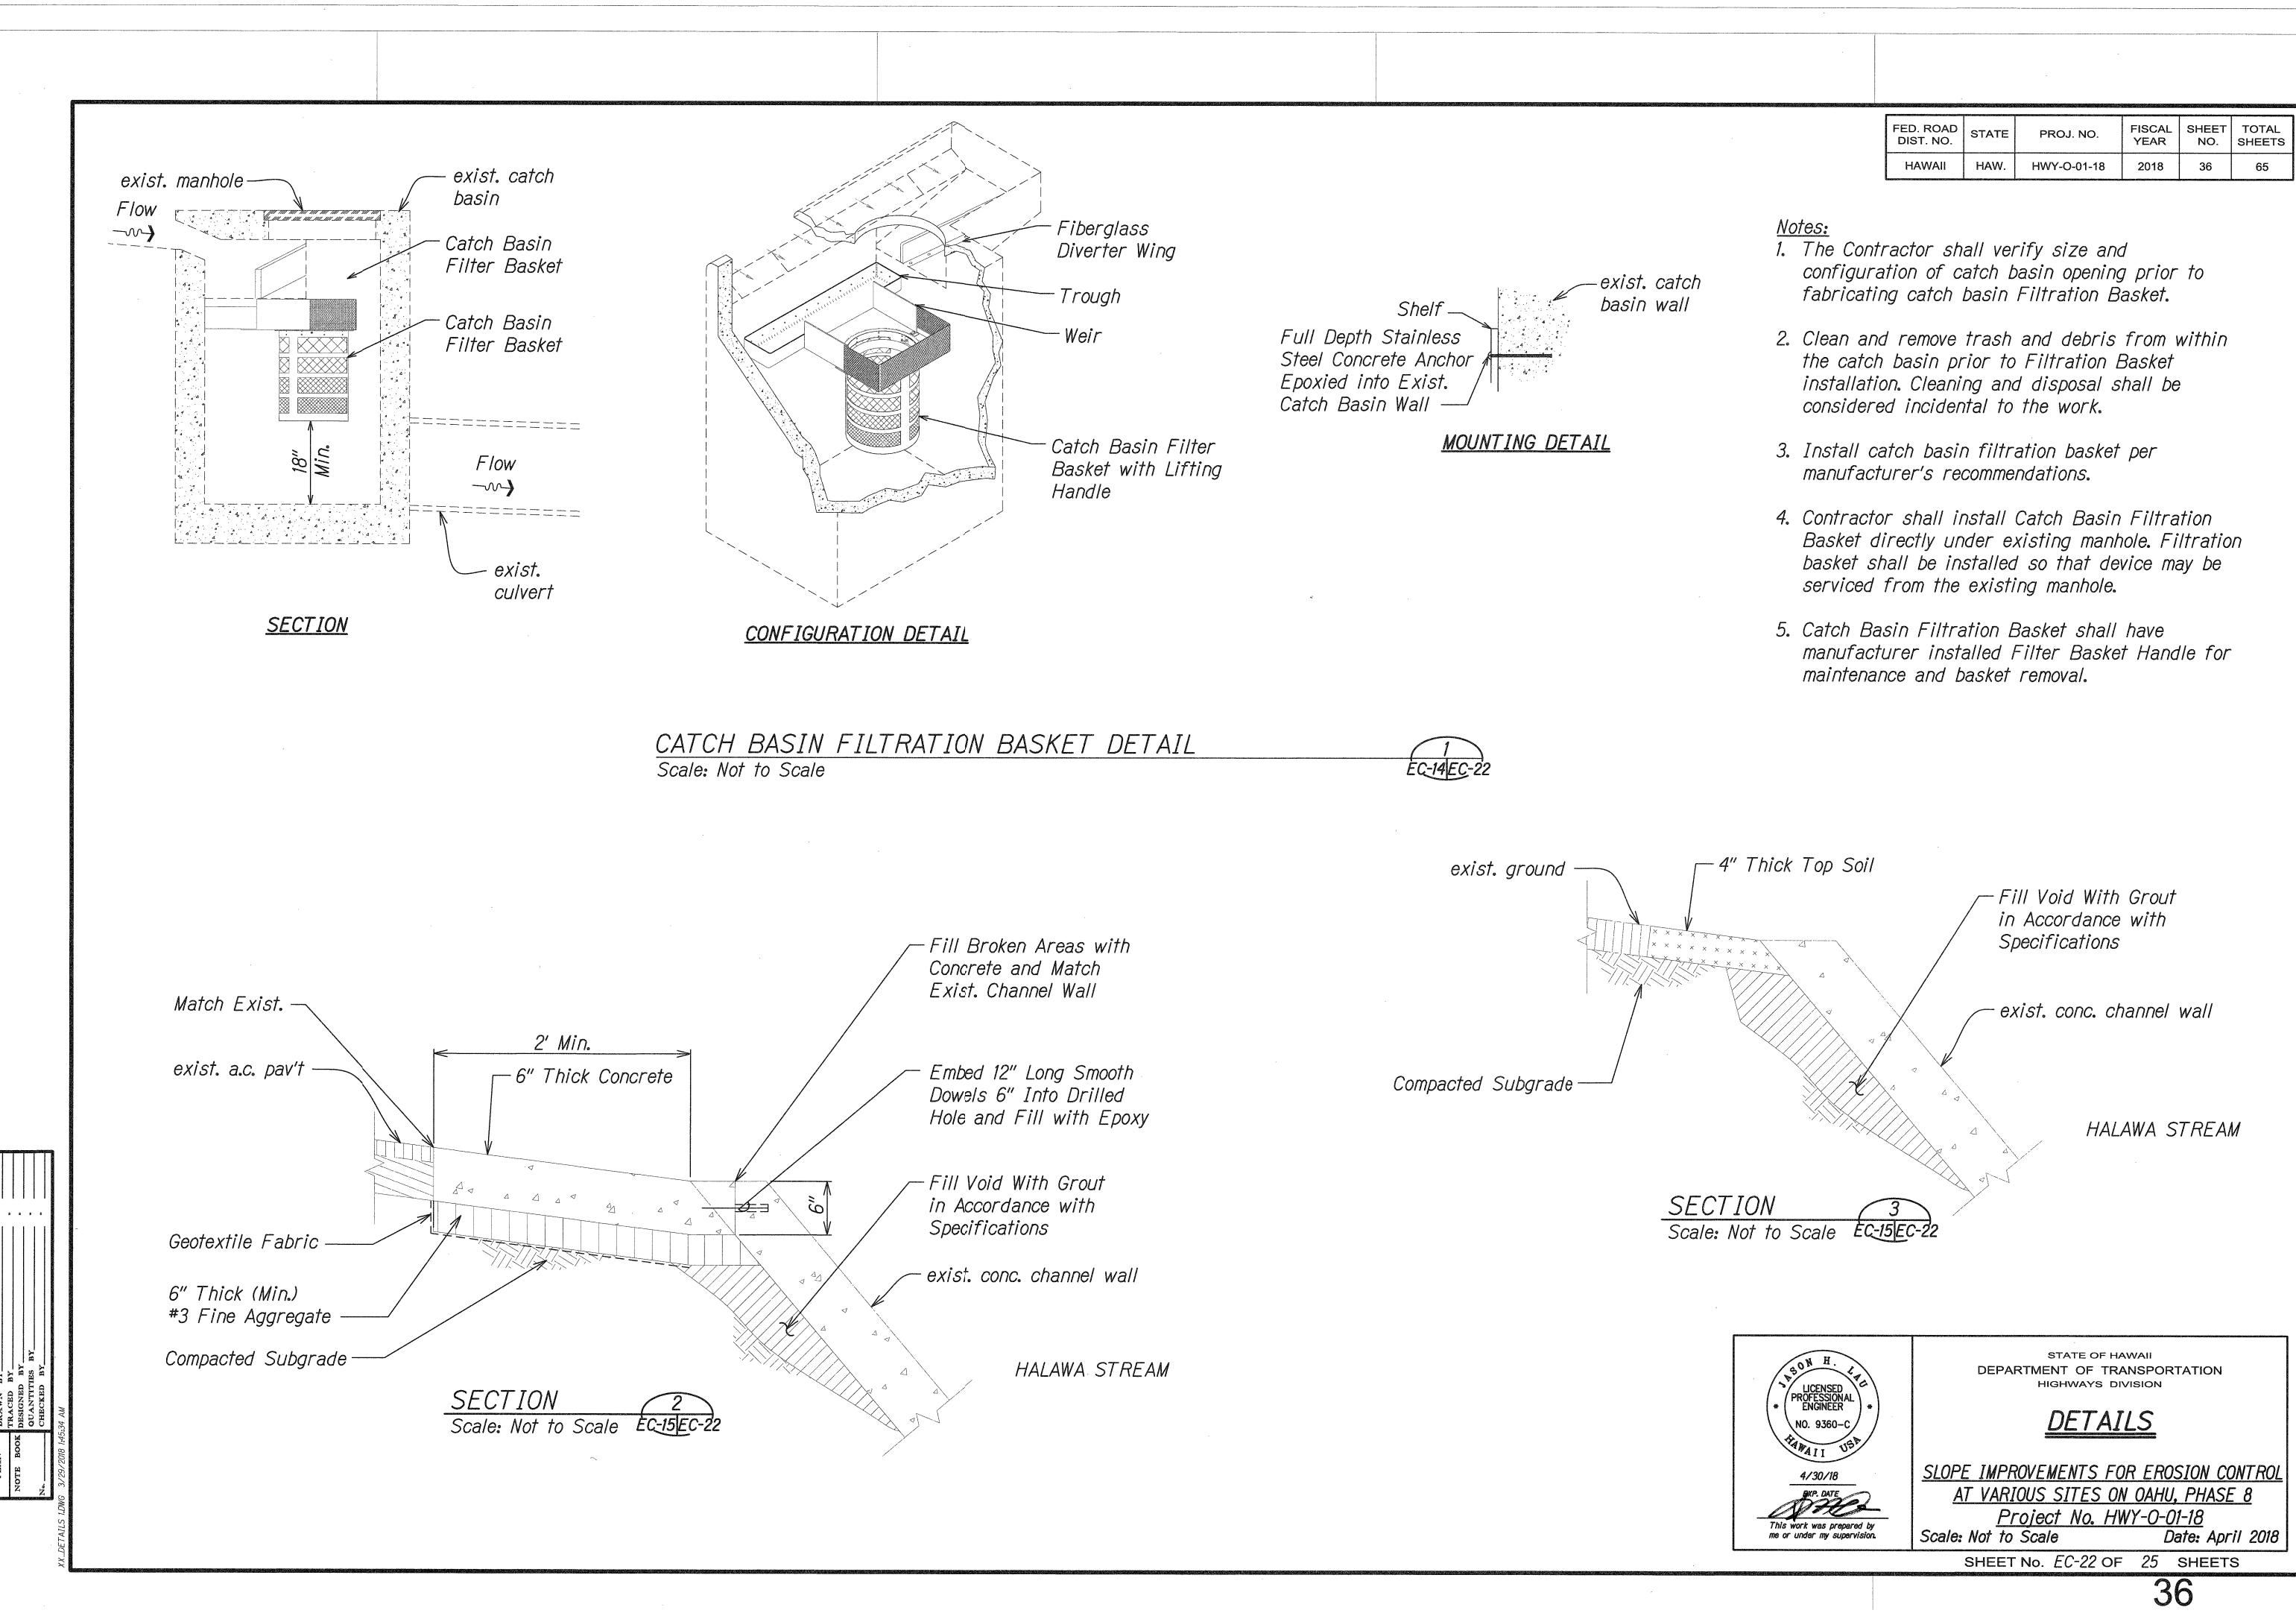


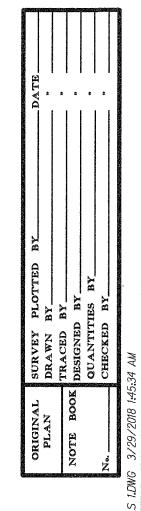

FED. ROAD DIST. NO.	STATE	PROJ. NO.	FISCAL YEAR	SHEET NO.	TOTAL SHEETS
HAWAII	HAW.	HWY-O-01-18	2018	36	65

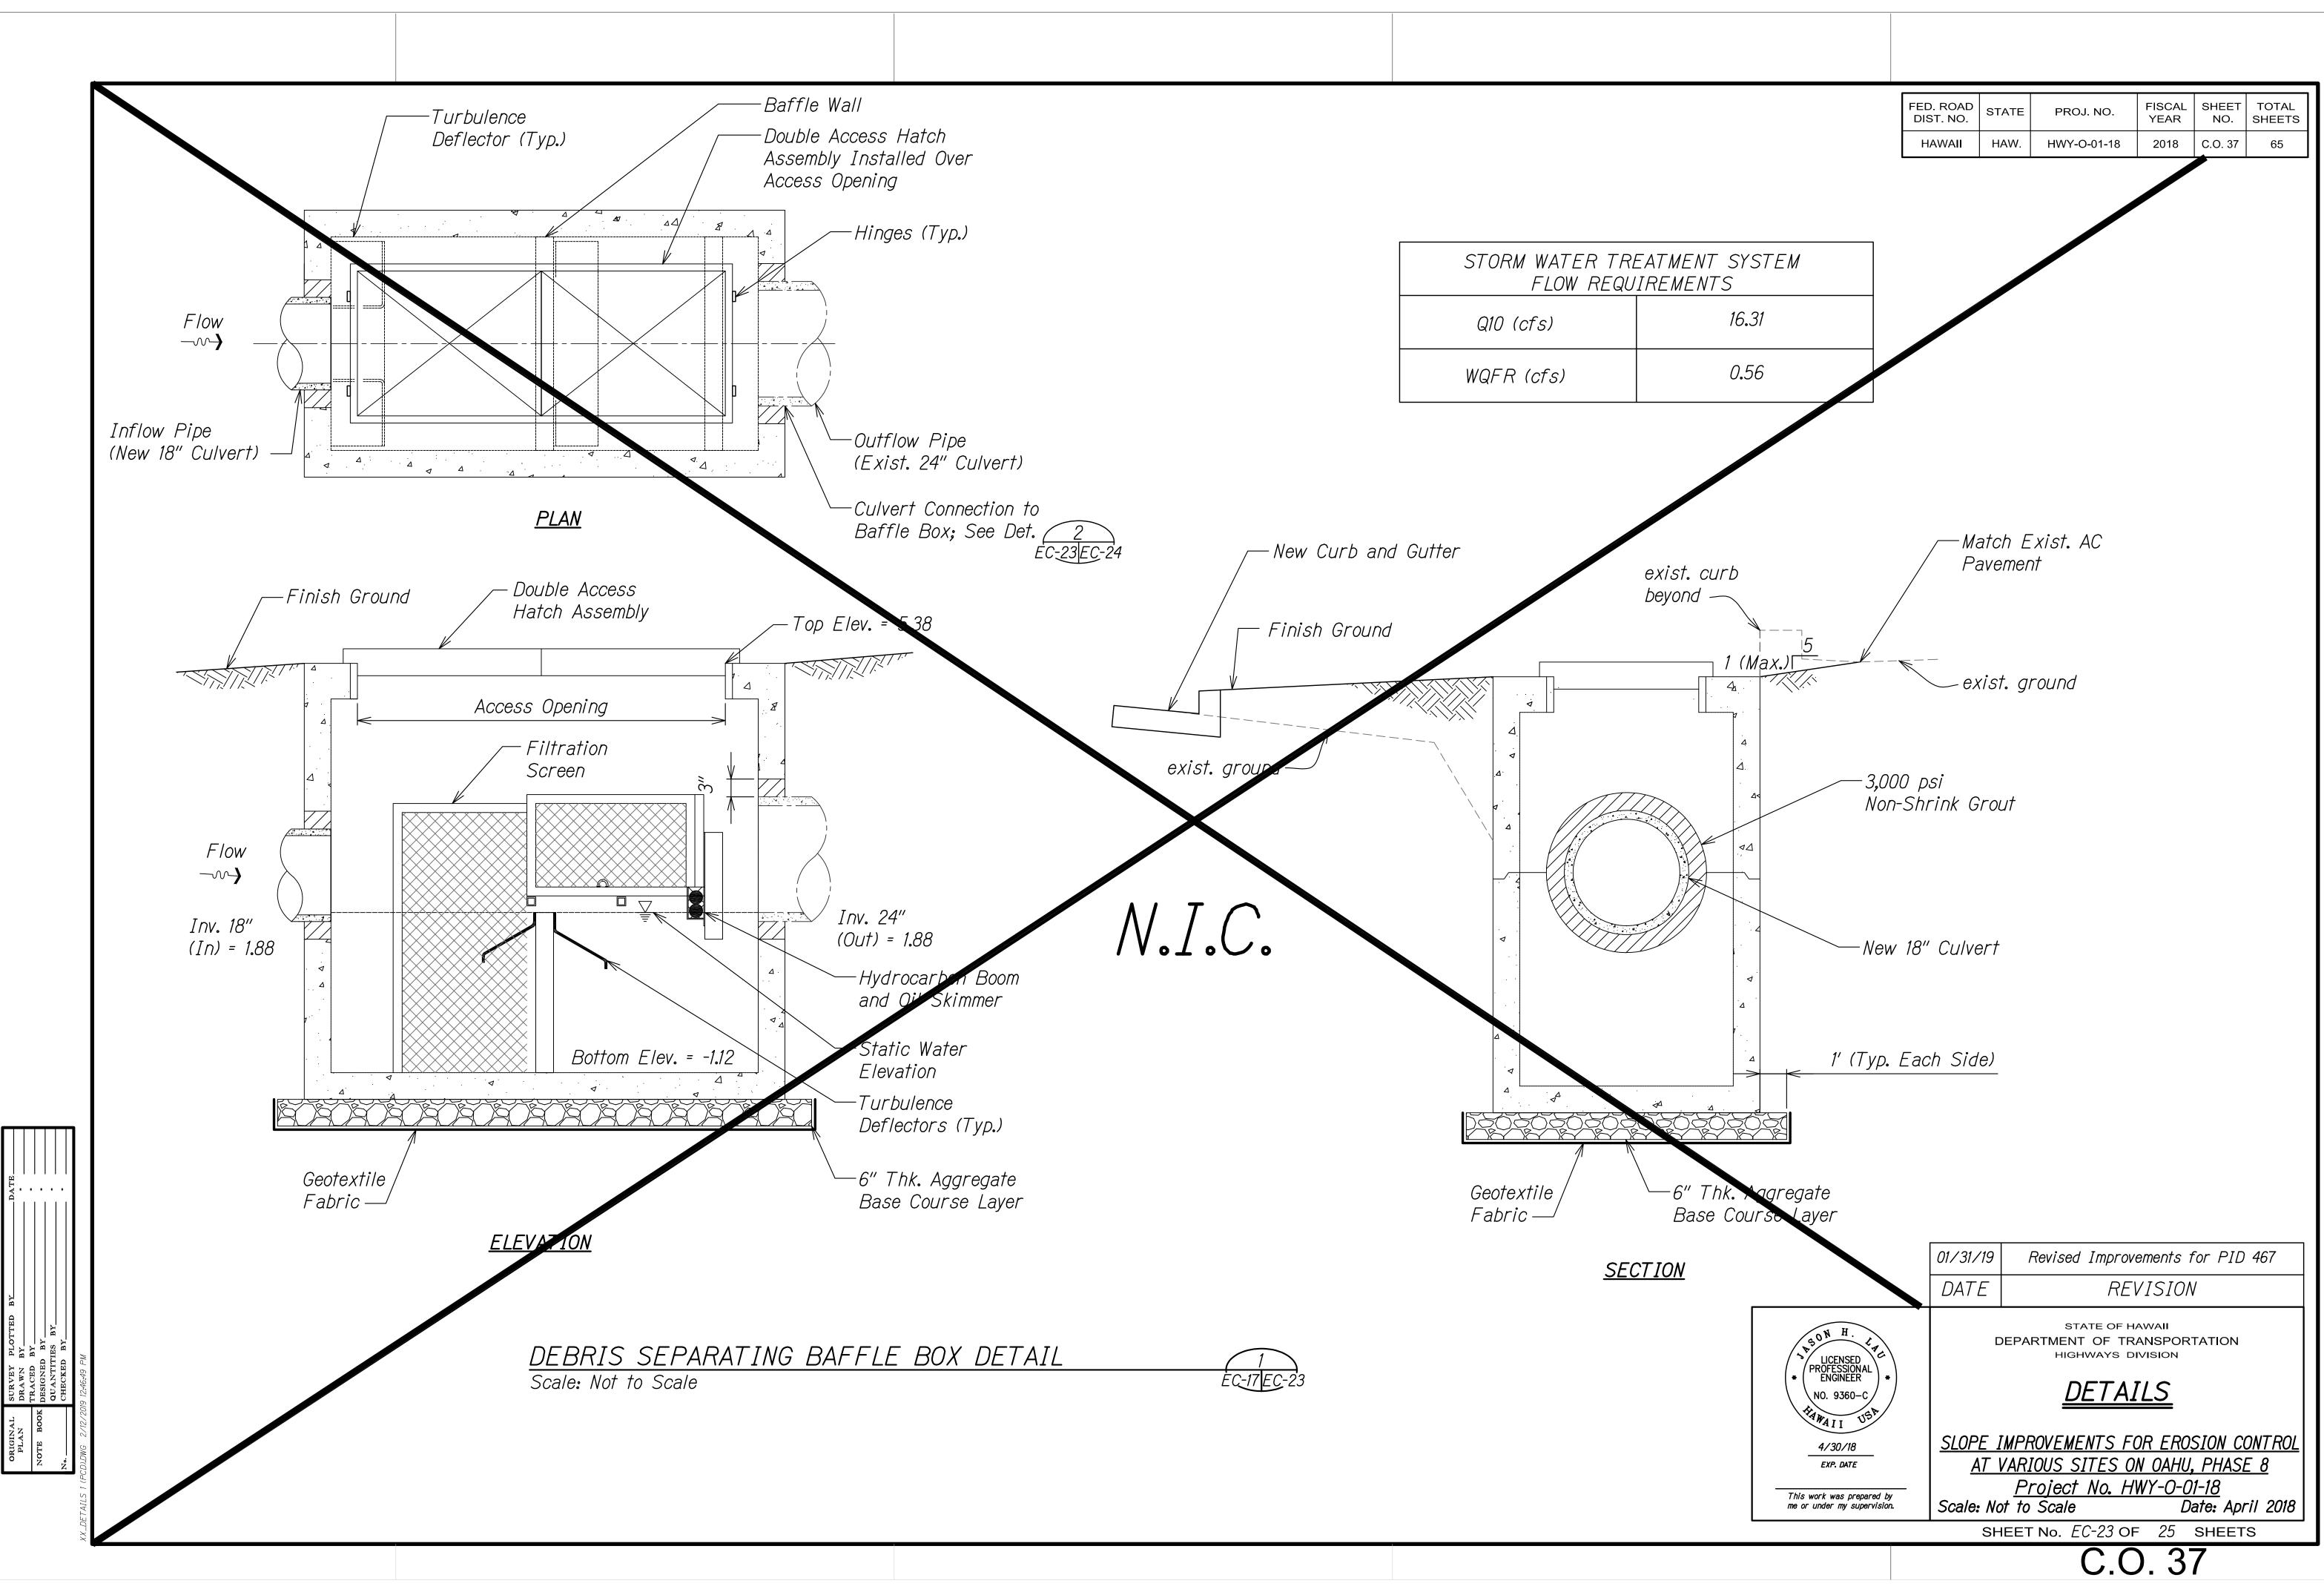

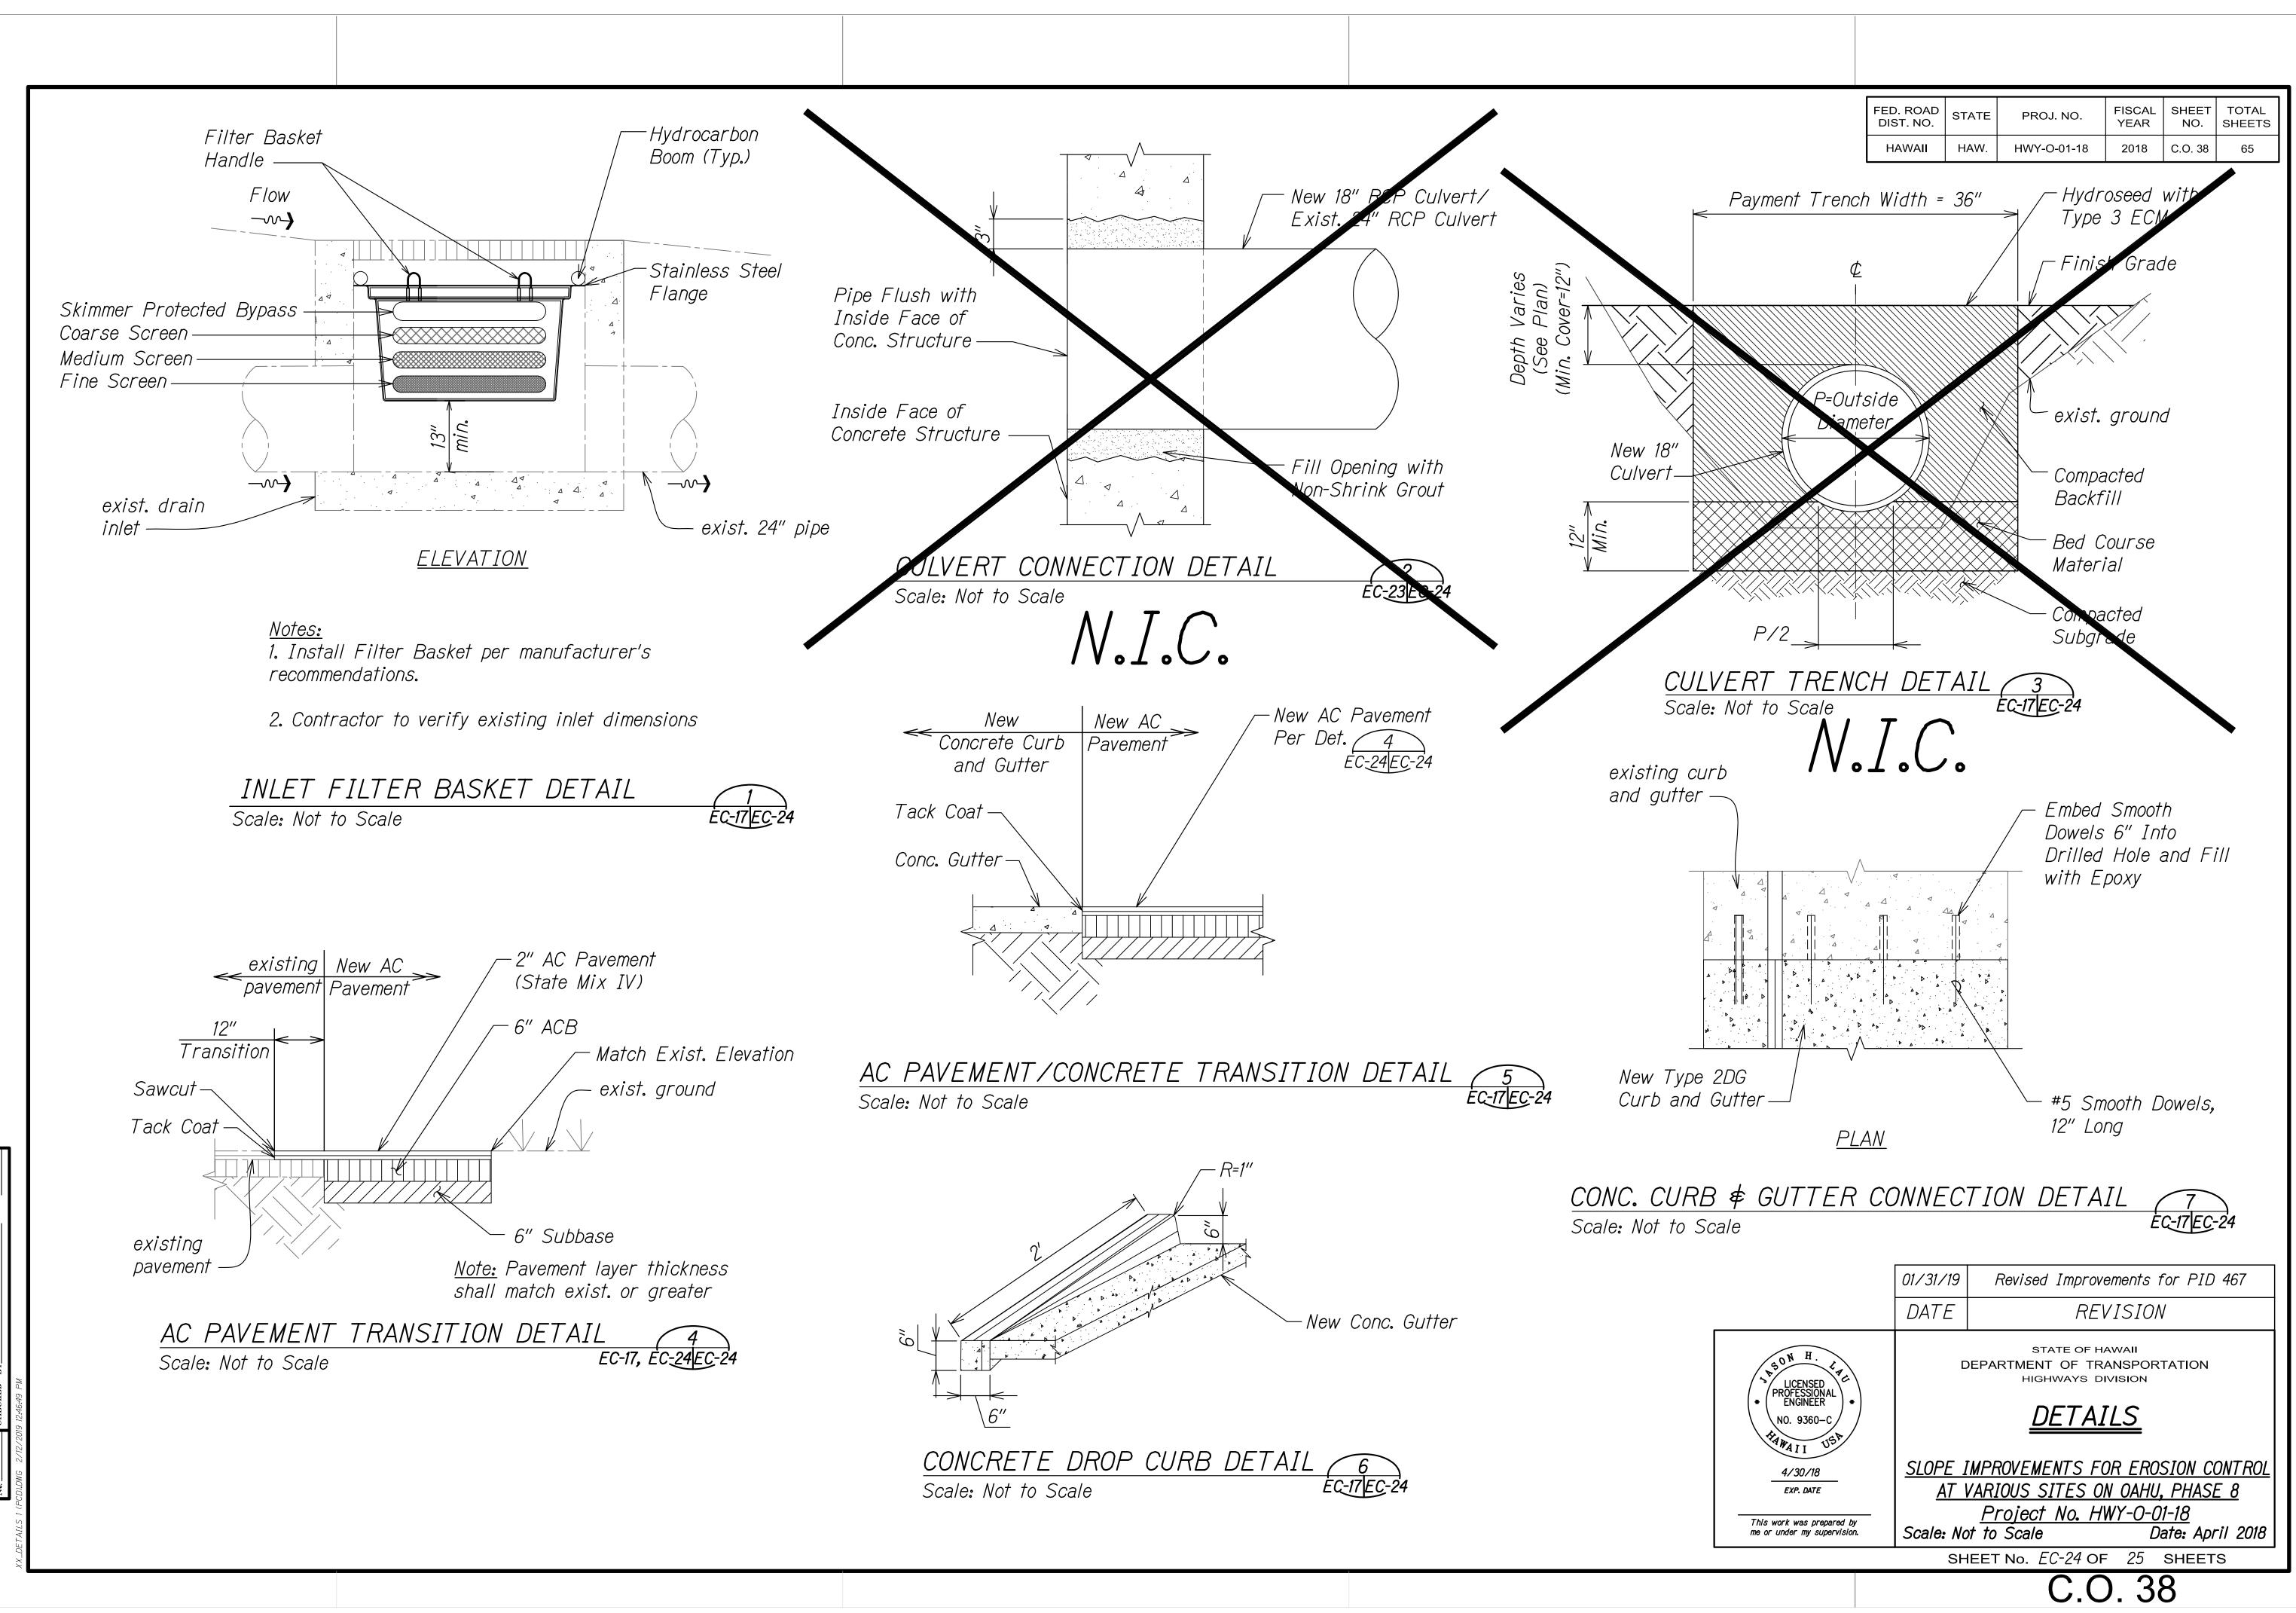


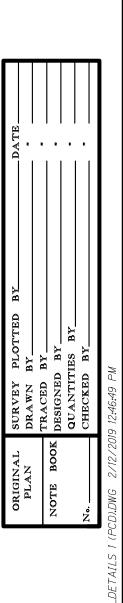



1.	Fabrication and erection of cold-formed stainless-steel sl conform to ASCE 8-02.
2.	Structural stainless steel shall conform to ASTM A276, G 316/316L unless otherwise noted.
3.	Structural stainless steel angles shall conform to ASTM Grade 316/316L.
4.	Threaded rods shall conform to ASTM A276, Grade 316/3 unless otherwise noted.
5.	Welds and welding procedures shall conform to the struc welding code AWS D1.6 of the American Welding Society.
6.	Welding shall be performed by welders pre-qualified for welding procedures to be used.
7.	Welding electrodes shall be ER308/ER308L.
8.	 The following shall be submitted to the Engineer for revia. Shop drawings detailing fabrication of structural states steel components including details of cuts; connection holes; welds; type, size and length of bolts; and other pertinent data. b. Current welder's certification of each individual performing welding work. c. Mill test reports signed by manufacturers certifying structural stainless steel, bolts, and other component comply with requirements.
EF	POXIED DOWEL ∉ THREADED ROD INSTALL
1.	Epoxy used for anchoring threaded rods and dowels into existing concrete shall be Hilti HIT-HY 200 -A or -R sys Simpson SET-XP system, or approved equal, and shall be installed per manufacturer's recommendations.
2.	Anchors shall be installed within the minimum embedment requirements as indicated on the drawings.



			D. ROAD ST. NO. STATE PROJ. NO. FISCAL SHEET TOTAL YEAR NO. SHEETS
TEEL NOTES:			ST. NO.STATEPROS. NO.YEARNO.SHEETSAWAIIHAW.HWY-O-01-182018C.O. 38S-165
shall			
, Grade	Mount Frame to Exist. Headwall (Typ. Both Ends);	TRUENORTH	
M A276,	See Det. 4 EC-24AEC-24B		===
5/316L	exist. r/w		
ructural V.		11"± thick Contractor to verify, typ.	
)r	exist. D24"	Stainless Steel L31/2x31/2x1/4 Angle EC-24AEC-24B	
review: stainless tions; ther	Flow A A A	Flow exist. conc.	
ng that	New Trash Screen	3/4" Ø Stainless Steel Bar @ 6" O.C. Max See Det. 3	
ents	exist. conc. headwall	EC-24AEC-24B Stainless Steel L31/2x31/2x1/4 Angle	
LLATIONS NOTES:		ES/2X S/2X/4 Angle	
system, be	<u>PLAN</u>		
ent	TRASH SCREEN FRAMING PLAN Scale: Not to Scale	1 EC-17AEC-24A	4
			01/31/19 Revised Improvements for PID 467 DATE REVISION
		+ UCENSED PROFESSIONAL ENGINEER +	STATE OF HAWAII DEPARTMENT OF TRANSPORTATION HIGHWAYS DIVISION
		NO. 9360-C	<u>DETAILS</u>
		<u>4/30/18</u> EXP. DATE This work was prepared by me or under my supervision.	<u>SLOPE IMPROVEMENTS FOR EROSION CONTROL</u> <u>AT VARIOUS SITES ON OAHU, PHASE 8</u> <u>Project No. HWY-O-01-18</u> Scale: Not to Scale Date: April 2018
			SHEET No. EC-24AOF 25 SHEETS
			C.O. 38S-1

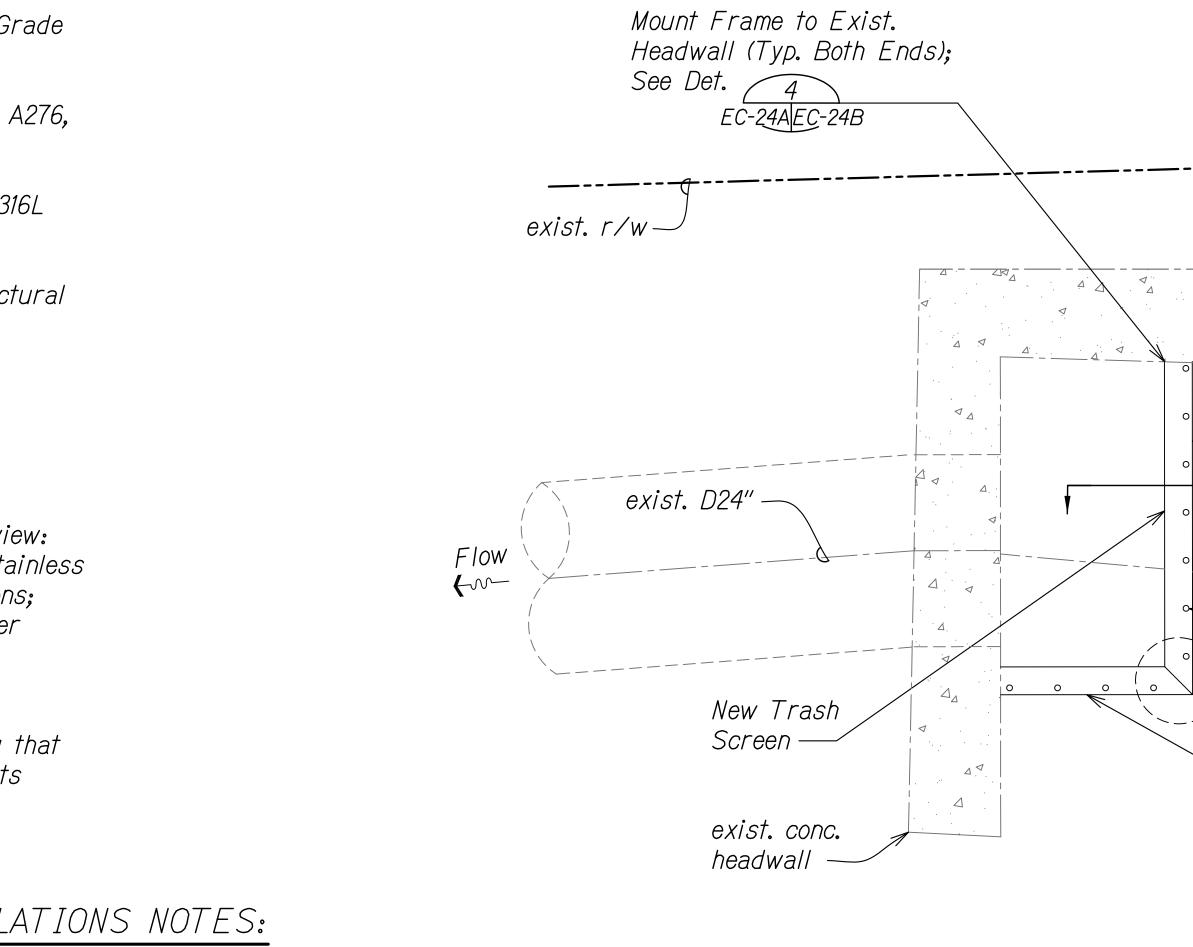

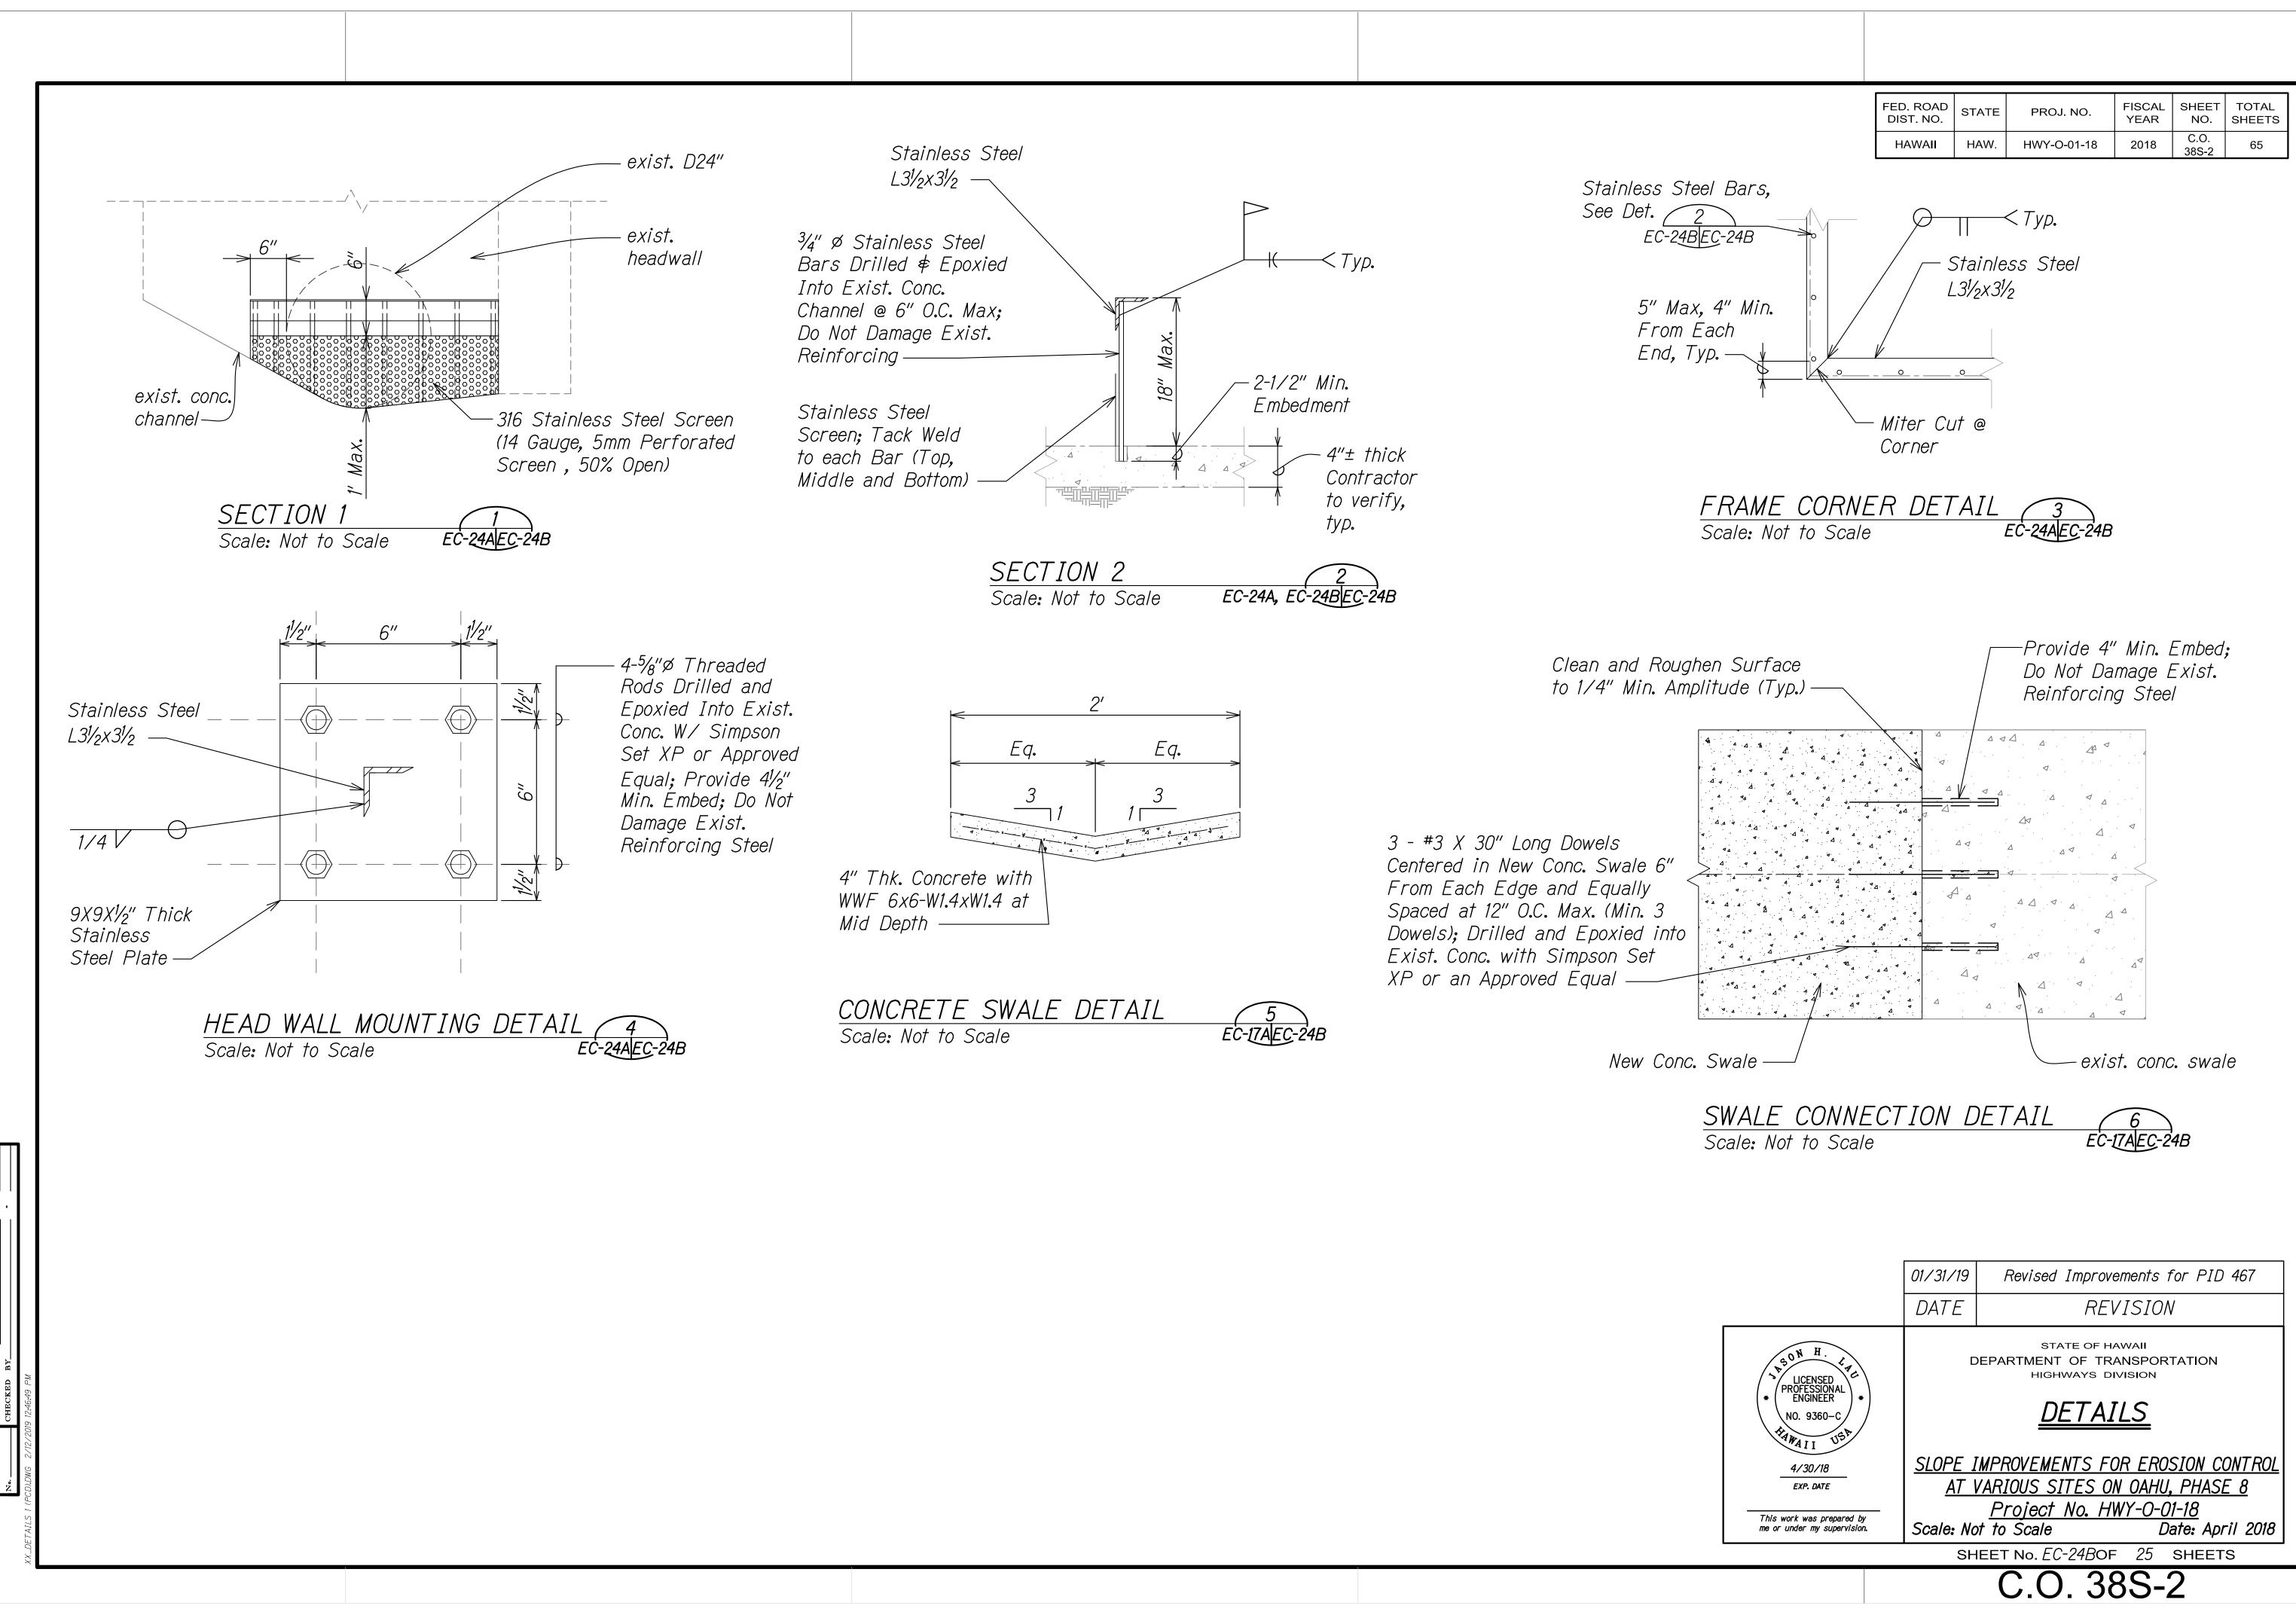

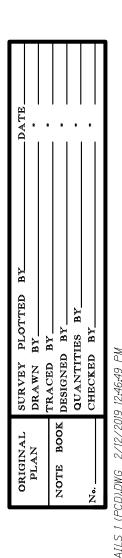

	2
EC-2	24B

CONCRETE SWALE DETAIL	5
Scale: Not to Scale	EC-17AEC-24B