



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SHEET No. LP-4 OF 6 SHEETS

Date: April 2009

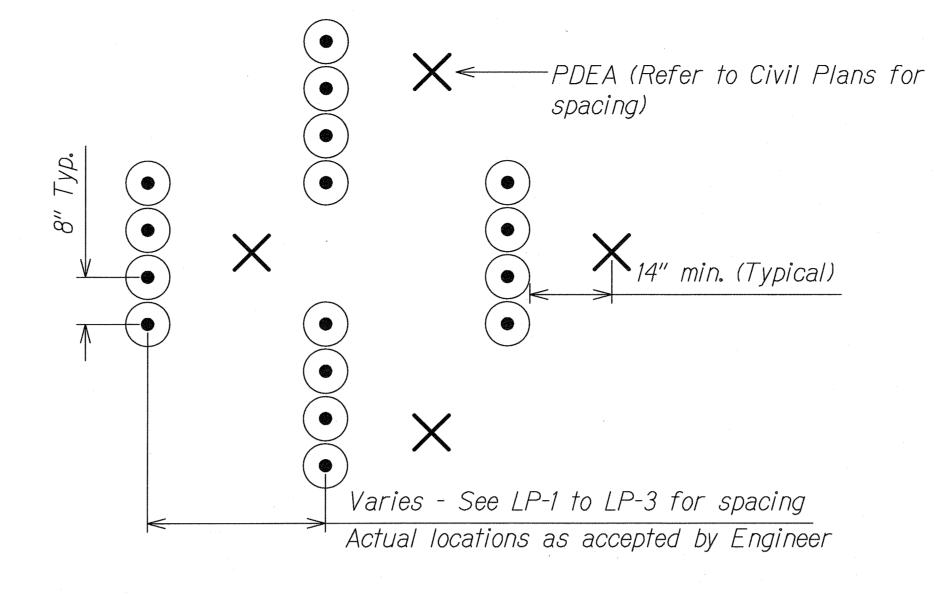

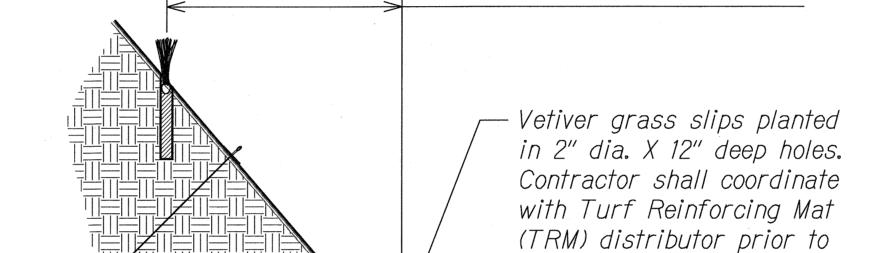

TYPICAL PLAN VIEW

— Backfill Vetiver plant holes with organic compost (typ.)

planting.

Varies - See plans for spacing

— AGS anchor (Refer to Civil Plans for spacing)

14" min. (typical)


-Finish grade of slope with TRM (See Civil Plans)

Note:
Landscape Contractor to adjust actual location of Vetiver grass planting in the field to avoid conflicts with AGS as shown.

TYPICAL SECTION

VETIVER GRASS PLANTING ON SLOPE

Scale: 3/4"=1'-0"

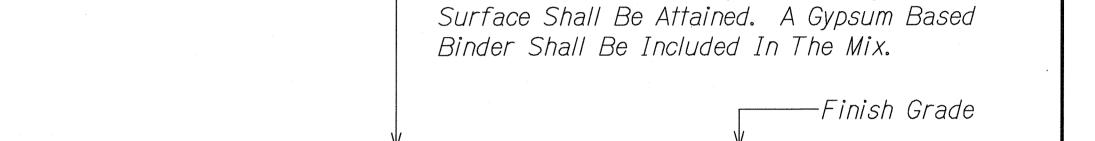

FED. ROAD DIST. NO.

Shall Be Specifically Processed Fiber

Inhibiting Factors. It Shall Be Such That

Hydraulic Equipment With Seeds/Sprigs,

Fertilizer, Water And, Other Additives Not

Detrimental To Plant Growth. The Fibers Will

Allows Infiltration. Complete Coverage Of The

Containing No Growth Or Germination

After Addition And Agitation In The

Form A Homogeneous Slurry. When

Hydraulically Sprayed On The Soil, The

Fibers Shall Form A Blotter-Like Ground

Cover Which Readily Absorbs Water And

—<u>Hydro Seed:</u>

PROJ. NO.


HAWAII HAW. HWY-0-04-09M 2009 C.O. 64 65


HYDRO-SEED DETAIL

Not to Scale

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FISCAL SHEET TOTAL YEAR NO. SHEETS



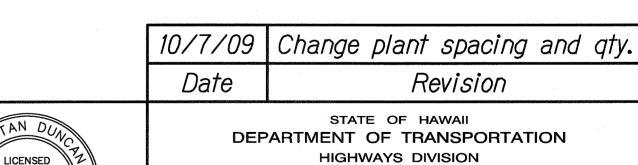

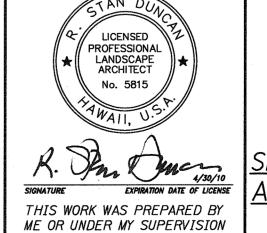PLANTING DETAILS


SLOPE MAINTENANCE FOR EROSION CONTROL

AT VARIOUS SITES ON OAHU, PHASE 3

Project No. HWY-O-04-09M

Scale: As Noted Date: April 2009

SHEET No. LP-5 OF 6 SHEETS

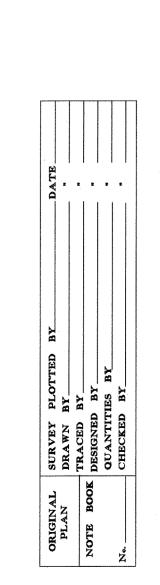

PLANT NOTES:

- Contractor shall field verify all plant quantities and dimensions prior to installation. Estimated quantities shown on plant list are for minimum quantities of shrubs and sod/seed that Contractor shall install. Actual quantities of shrubs and sod/seed installed in the field up to 10 percent in excess of the quantities shown on plans will be at no additional cost to the State.
- 2. Contractor shall be responsible for locating and protecting existing utilities.
- 3. Prior to augering shrub hole, all planting locations shall be staked out by Contractor for acceptance by Engineer. Do not plant until ground has been prepared and site is neat, orderly, and the Engineer accepts site for planting.
- 4. Notify Engineer of any discrepancies in plant locations, or plant quantities if quantities will exceed that indicated in Note 1 above.
- 5. Notify Engineer 30 days prior to planting operations for acceptance of all plant material at place of growth. All plant material not accepted by the Engineer will be subject to rejection.
- 6. The Engineer will inspect plants at the place of growth and after the delivery to the project.
- 7. Plants shall meet size indicated by minimum height and spread. Plants shall be straight and uniformly shaped, unless unique or special characteristics are specified, and shall be undamaged, sound, healthy, vigorous and free of disease and insect infestation. Plants not conforming to these requirements on delivery to the project and at the end of the plant establishment period will be rejected.
- 8. Contractor shall be solely responsible for the complete removal and damages resulting from planting any plant species listed on the Hawaii Department of Agriculture 'Noxious Weed Rules' as defined in the statute, Hawaii Administrative Rules 4:68:1 or the 'Federal Noxious Weed List' as defined in Title 7 of the Code of Federal Regulations (CFR), parts 360 and 361.
- 9. All tree work must adhere to American National Standard Institute (or ANSI) a300 Tree Care Standards and ANSI-z133 safety standards for tree work. Work shall be contracted to arborists that has been certified in good standings as an isa certified arborist for at least 5 years to assure that tree work is performed properly and trees are not damaged by practices such as topping, flush cuts, over-thinning, or climbing with spikes. Contractor shall submit a copy of the isa arborist certification of good standing of 5 years to the Engineer minimum 7 days prior to tree pruning.
- 10. For the duration of construction within the drip line of trees to remain there must be: no changes, alterations or disturbance to the grade by adding fill, excavating or scraping except as noted on plans; no storage of construction material or equipment; no stockpiling of any construction material or any excavated material no disposal of any liquids (E.G. Concrete sleuth, gas, oil, paint); no vehicular traffic, equipment or excessive pedestrian traffic no attachment of any wires, ropes, lights, or any other such attachment other than those of protective nature to any tree to be preserved; and no cleaning of equipment or material under the canopy of any tree or group of trees to remain.
- 11. Provide and incorporate a two-inch layer of organic amendments over bench area only. Representative samples of soil from project site shall be submitted to the University of Hawaii Agricultural Extention Service or laboratory acceptable to the Engineer for analysis of required soil amendments. Test results and fertilization schedule shall be presented to the Engineer for review and acceptance before placing planting soil. Uniformly distribute fertilizer and amendments over planting areas as recommended by the soil analysis report. Rototill top four-inches of soil to evenly incorporate fertilizer and amendments for bench area only.
- 12. Guy wires, flagging, stakes, windbreakers, etc. shall be maintained and replaced if necessary by the Contractor until the shrub is able to stand by itself. The Contractor shall remove and dispose of these items at the end of plant establishment period.


- FISCAL SHEET TOTAL YEAR NO. SHEETS FED. ROAD DIST. NO. HAW HWY-0-04-09M 2009 C.O. 65 65
- 13. Any planting that obstructs sight distance, signs or traffic lights shall be relocated or removed as determined by the Engineer.
- 14. Provide water for all plant material for the duration of the project, including plant establishment period. Water vetiver grass rows as well as all grassed areas. Water for planting shall not cause erosion damage to the slopes. The Contractor shall be responsible for repairing any damage caused by the watering of plants. The Contractor shall gradually decrease the amount of water being provided to the plant material 8 weeks prior to final acceptance of plantings.
- 15. Contractor shall not damage the soil stabilization material or PDEA anchor system and will be responsible for the cost of reparing any damaged areas, materials, and PDEA anchors that are caused due to planting operations.
- 16. The Contractor shall maintain a minimum 14 inch clearance around all AGS anchors. Contractor shall backfill vetiver planting holes with organic compost.

PLANT SCHEDULE SITE 1

<u>SHRUBS</u>	<u>QTY</u>	<u>BOTANICAL</u>	COMMON	<u>SPACING</u>	<u>REMARKS</u>
	7,000 EA	Chrysopogon zizanioides 'Sunshine'	Sunshine Vetiver Grass	8" O.C.	Install sprigs/slips per supplier recommendations and as shown on plans
SOD/SEED	<u>QTY</u>	<u>BOTANICAL</u>	COMMON		<u>REMARKS</u>
	36,000 SF	Axonopus affinis	Australian Carpet Grass		Hydromulch shall include a gypsum based binder

PLANT SCHEDULE SITE 2

<u>SOD/SEED</u>	<u>QTY</u>	<u>BOTANICAL</u>	<u>COMMON</u>	REMARKS
	10,500 SF	Axonopus affinis	Australian Carpet Grass	Hydromulch shall include a gypsum based binder

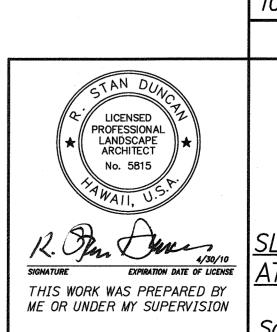

10/7/09 Change plant spacing and qty. Revision STATE OF HAWAII DEPARTMENT OF TRANSPORTATION HIGHWAYS DIVISION

> PLANT LIST AND NOTES

SLOPE MAINTENANCE FOR EROSION CONTROL AT VARIOUS SITES ON OAHU, PHASE 3 Project No. HWY-0-04-09M Scale: As Noted Date: April 2009

SHEET No. LP-6 OF 6 SHEETS