

₹728.84 STA. KAM-15 1/2PIO

113+00


Site #5-

112+00

## NOTES:

Remove overhang. See detail on this sheet.

- 1. When removing overhang, maintain 10' clearance from obstructions (i.e. utility poles, fencing, trees, etc.). Contractor shall remove overhang to the maximum horizontal distance of 5' from top of slope where possible. Where the 5' maximum conflicts with the 10' clearance, remove the overhang up to 10' clearance.
- 2. Contractor shall notify Engineer prior to overhang removal if disturbance is anticipated to jeopardize the stability of the existing trees to remain.

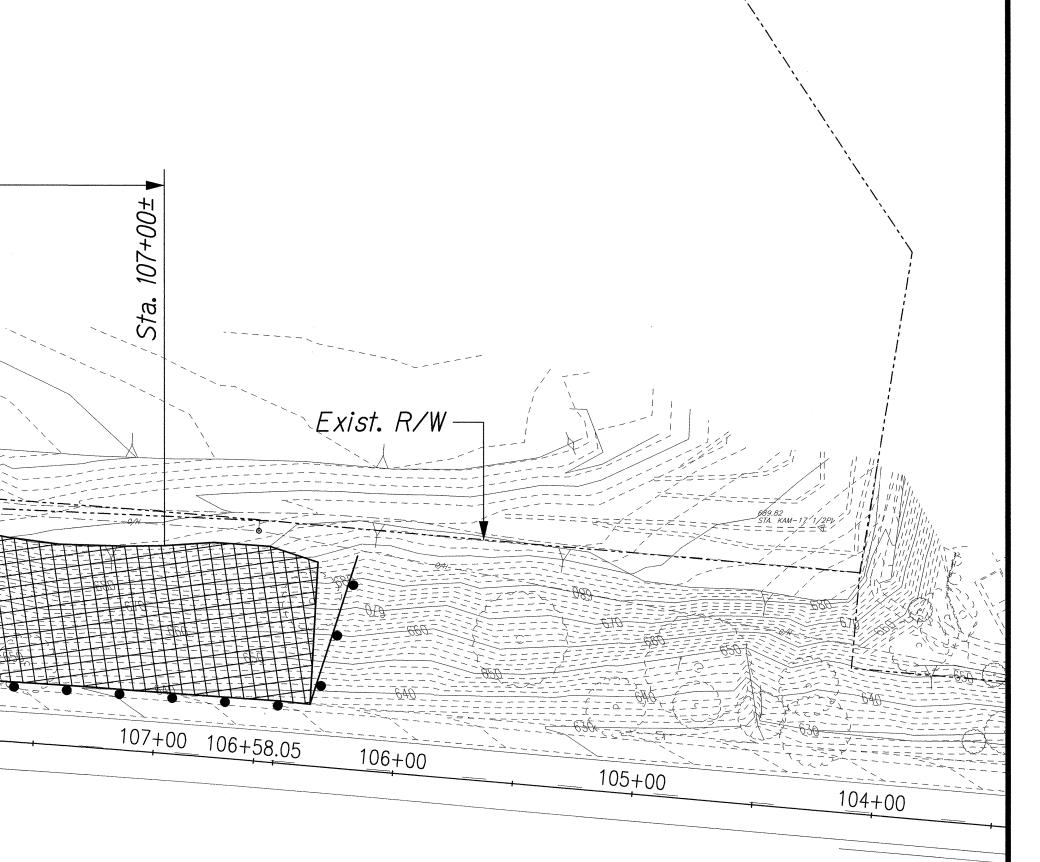

FED. ROAD DIST. NO.

FISCAL SHEET NO.

HAW. HWY-0-10-06M 2006 28



## NOTES:

115+00

**→** To Wahiawa

1. Silt fence shall be installed prior to any construction activity in the area.

114+00

- 2. Silt fence shall be removed one year after the State accepts the completed slope with hydro-mulch.
- 3. Removal of erosion control items shall be the responsibility of the Contractor and considered included in the lump sum cost of Item No. 209.1000 Installation, Maintenance, Monitoring, and Removal of BMP. Contractor shall restore disturbed area due to Silt Fence removal to equal or better condition at no cost to the State.
- 4. Maximum limits of erosion control work area shown. Existing vegetation coverage may vary at time of construction. Contractor shall install erosion control measures on areas with no vegetation or as directed by the Engineer. Existing trees and vegetation shall remain unless otherwise indicated on plan or by the Engineer for removal.

111+00


KAMEHAMEHA HIGHWAY

- 5. Remove any loose soil on the exposed slope face prior to hydro-mulch mixture application. Removal shall be paid for under Item No. 203.0300 Excess Soil Removal.
- 6. Remove overhang. See detail on this sheet. Removal shall be paid under Item No. 203.0300 Excess Soil Removal.

## LEGEND:

109+00

√1650.70 STA. POL-1 1/2

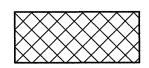


Hydro-Mulch Mixture

108+00



Silt Fence

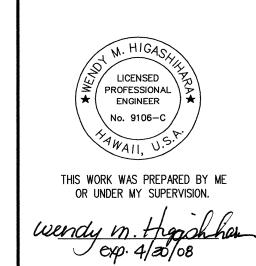

STATE OF HAWAII **DEPARTMENT OF TRANSPORTATION** 


To Honolulu ----


EROSION CONTROL KAMEHAMEHA HIGHWAY - SITE 5


SLOPE MAINTENANCE FOR EROSION CONTROL AT VARIOUS SITES ON OAHU Project No. HWY-0-10-06M

Scale: 1"=40' Date: April 2006 SHEET No. EC-4 OF

SHEETS

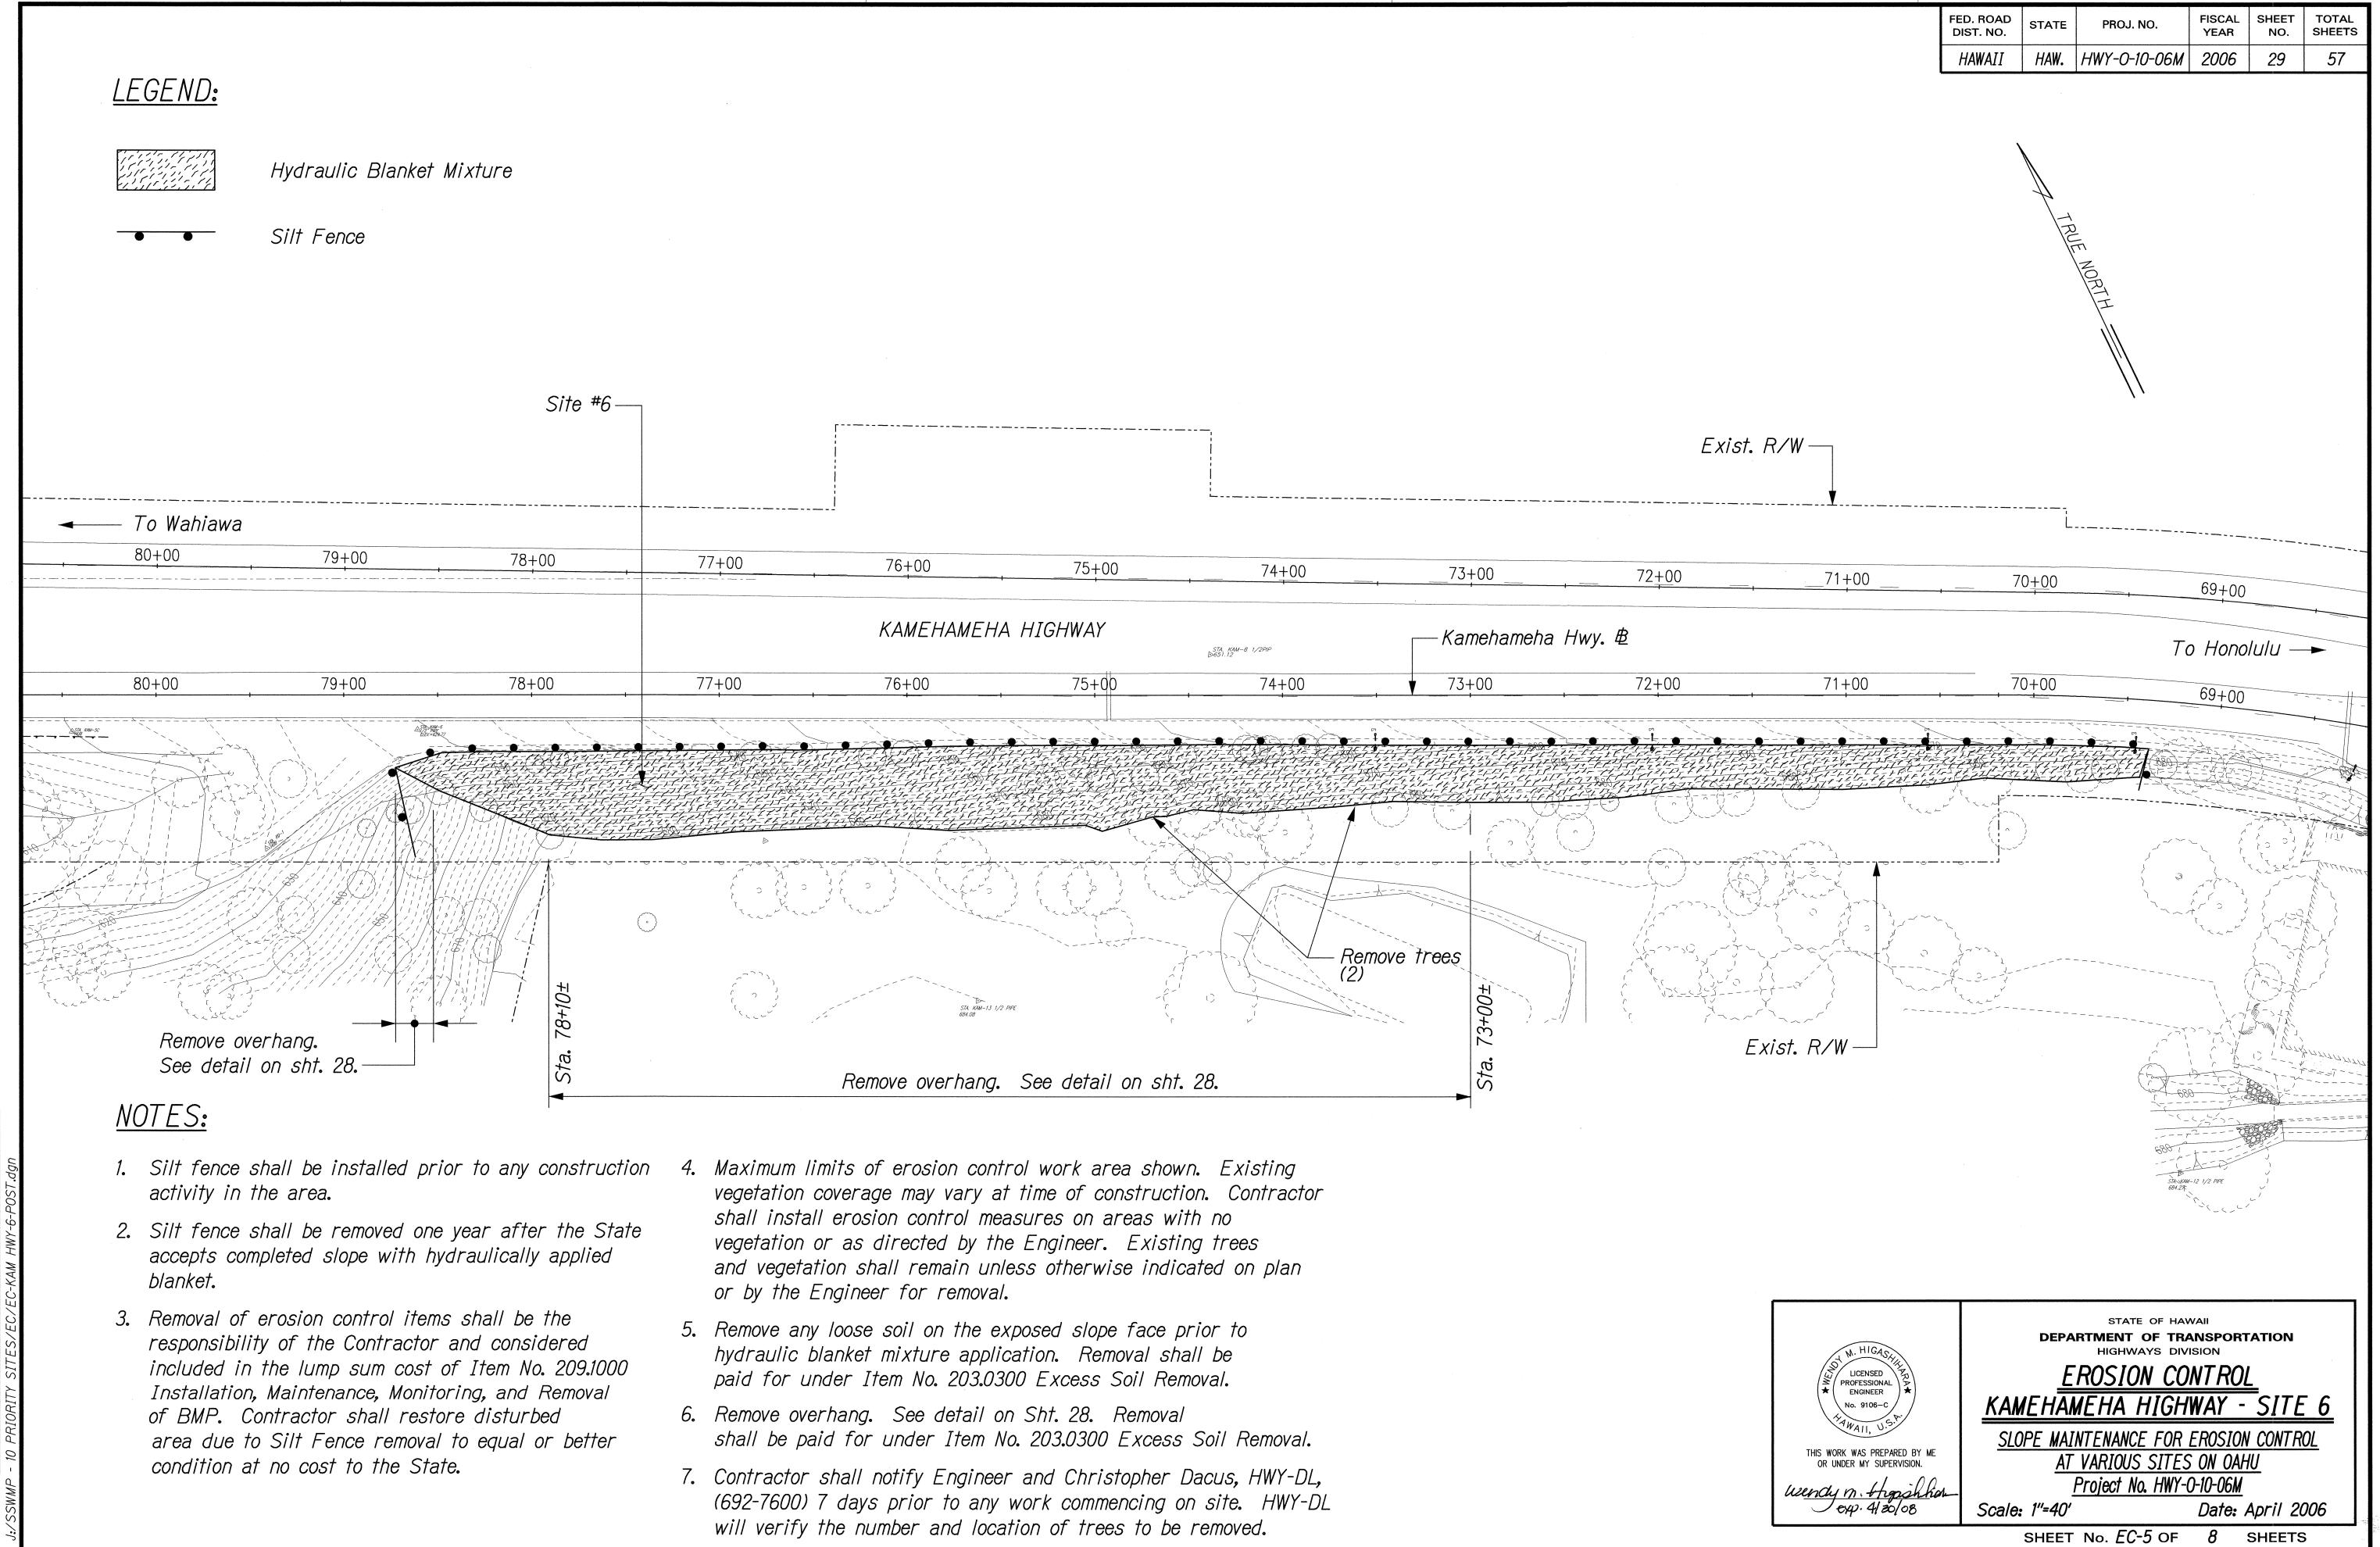


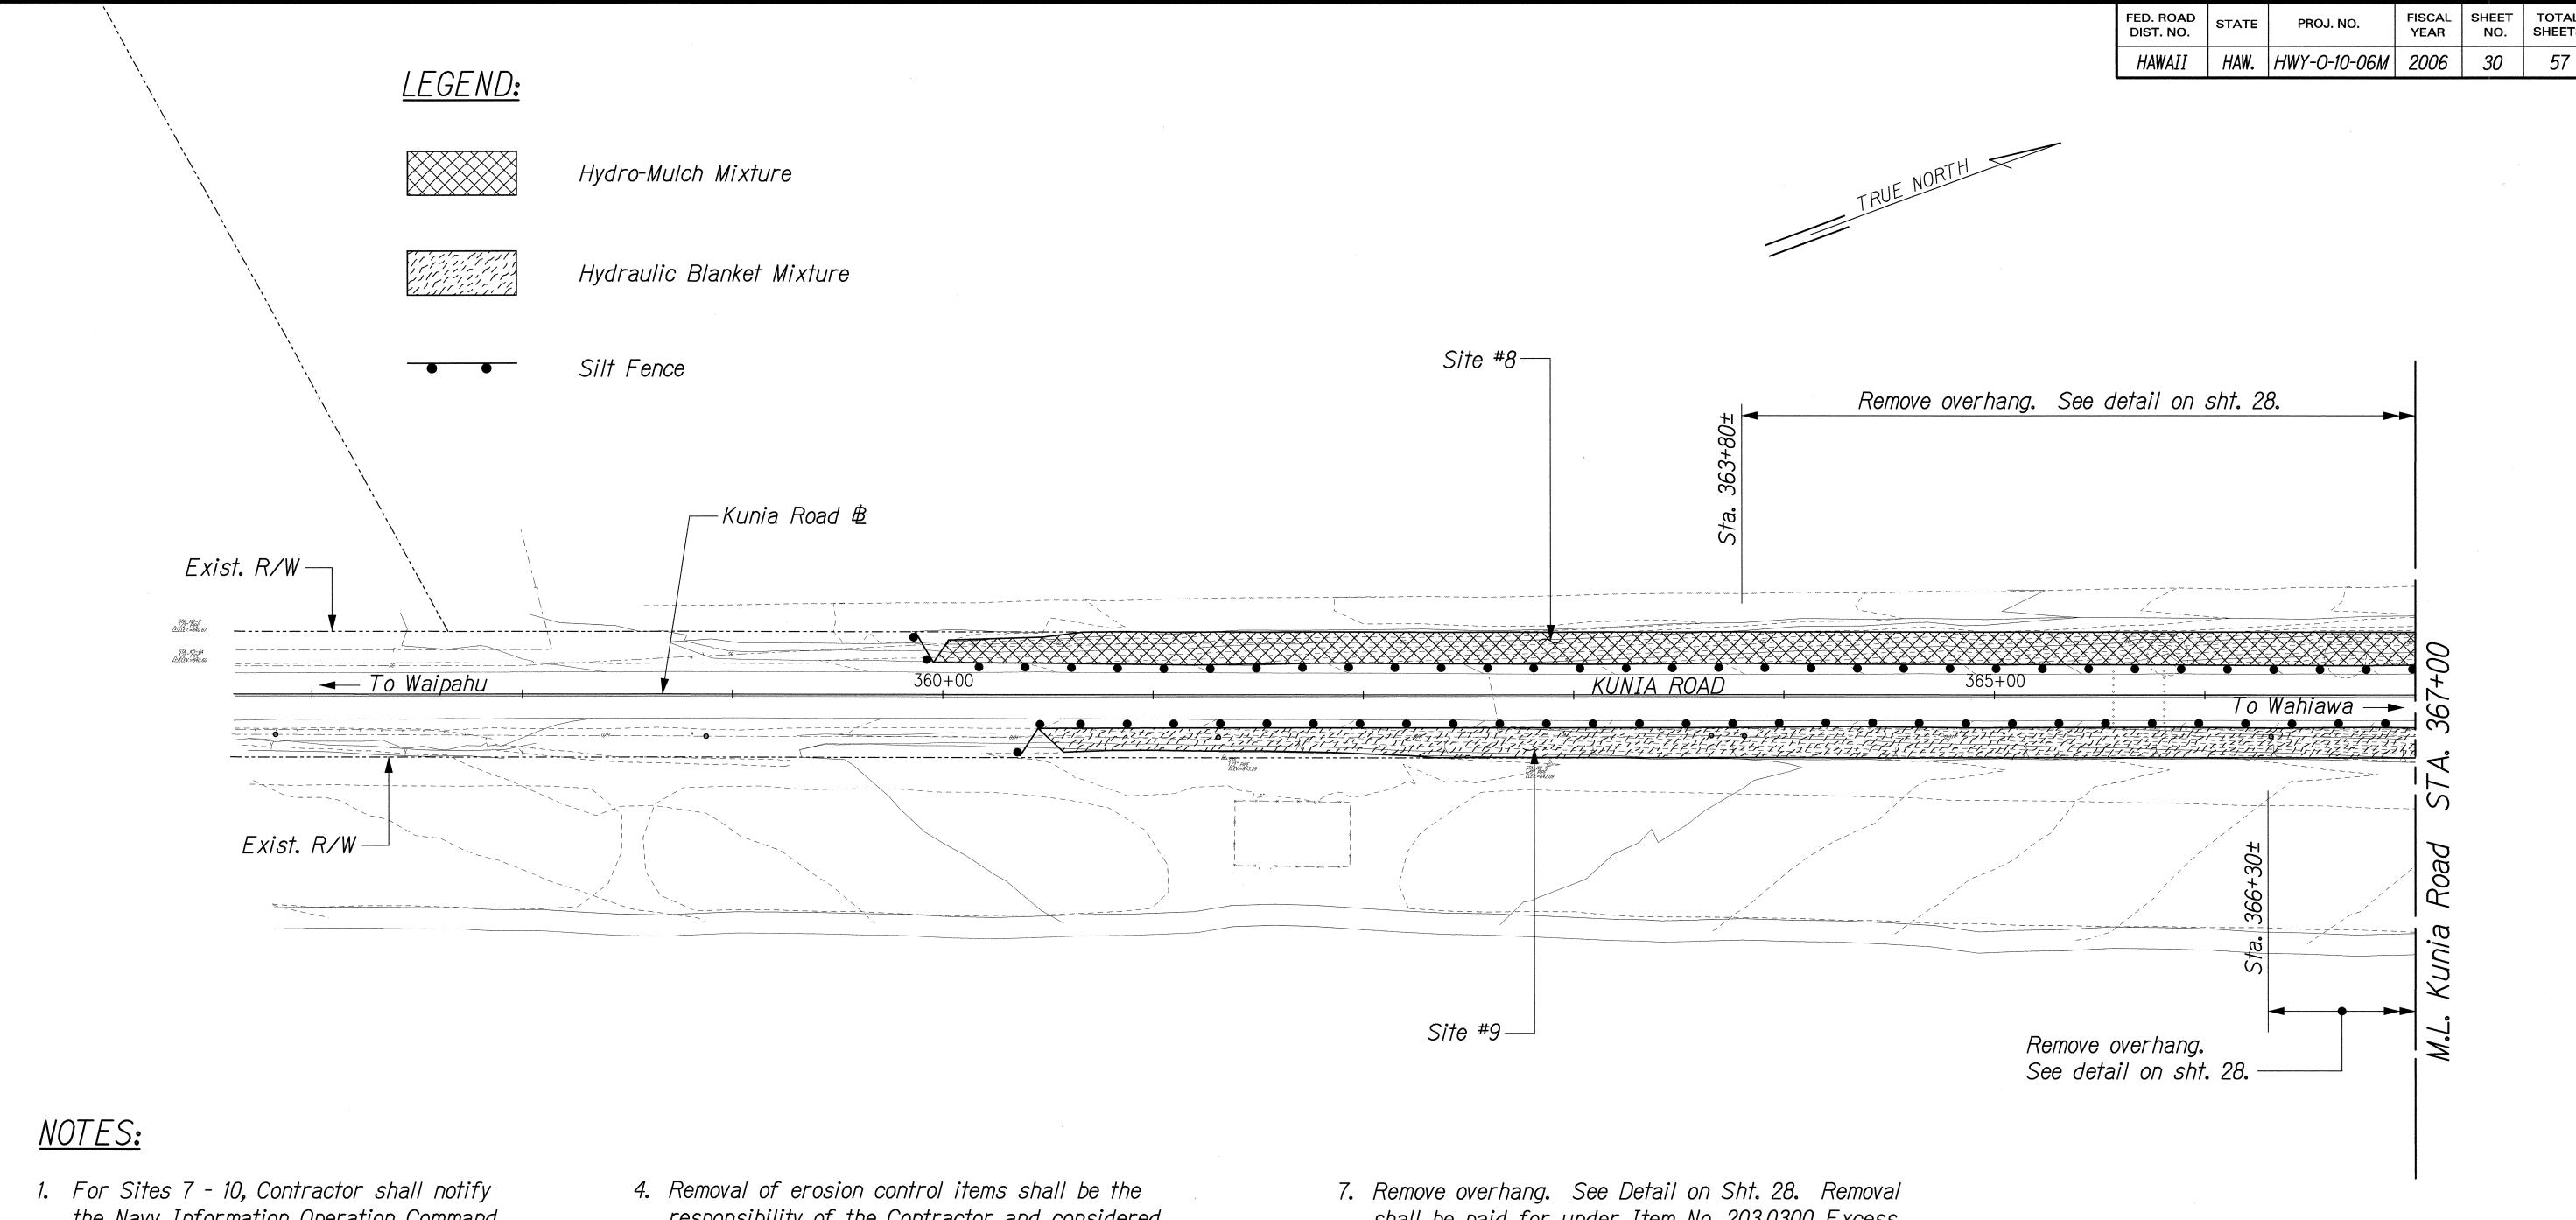

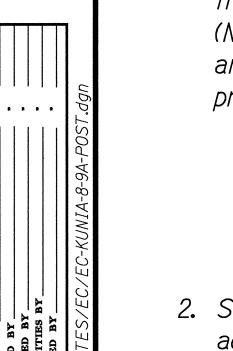

- the Navy Information Operation Command (NIOC) Facility of the schedule, location and nature of work at least seven (7) days prior to the start of construction. Facilities Department (N4) Navy Information Operations Command, Hawaii Schofield Barracks, HI 96857 Voice: (808) 655-3564/655-3266/655-3888 Fax: (808) 655-3553
- 2. Silt fence shall be installed prior to construction activity in the area.
- 3. Silt fence shall be removed one year after the State accepts completed slope with hydro-mulch or hydraulically applied erosion control blanket.
- responsibility of the Contractor and considered included in the lump sum cost of Item No. 209,1000 Installation, Maintenance, Monitoring, and Removal of BMP. Contractor shall restore disturbed area due to Silt Fence removal to equal or better condition at no cost to the State.
- 5. Maximum limits of erosion control work area shown. Existing vegetation coverage may vary at time of construction. Contractor shall install erosion control measures on areas with no vegetation or as directed by the Engineer. Existing trees and vegetation shall remain unless otherwise indicated on plan or by the Engineer for removal.
- 6. Remove any loose soil on the exposed slope face prior to hydro-mulch or hydraulic blanket mixture application. Removal shall be paid for under Item No. 203.0300 Excess Soil Removal.

shall be paid for under Item No. 203.0300 Excess Soil Removal.

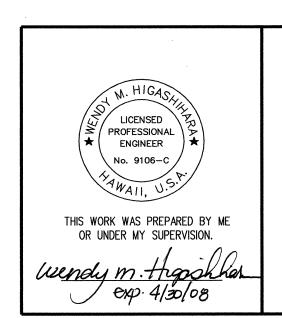


**DEPARTMENT OF TRANSPORTATION** 

EROSION CONTROL KUNIA ROAD - SITES 8 \$ 9

SLOPE MAINTENANCE FOR EROSION CONTROL AT VARIOUS SITES ON OAHU

Project No. HWY-0-10-06M Scale: 1"=40' Date: April 2006

> SHEET No. EC-6 OF 8 SHEETS

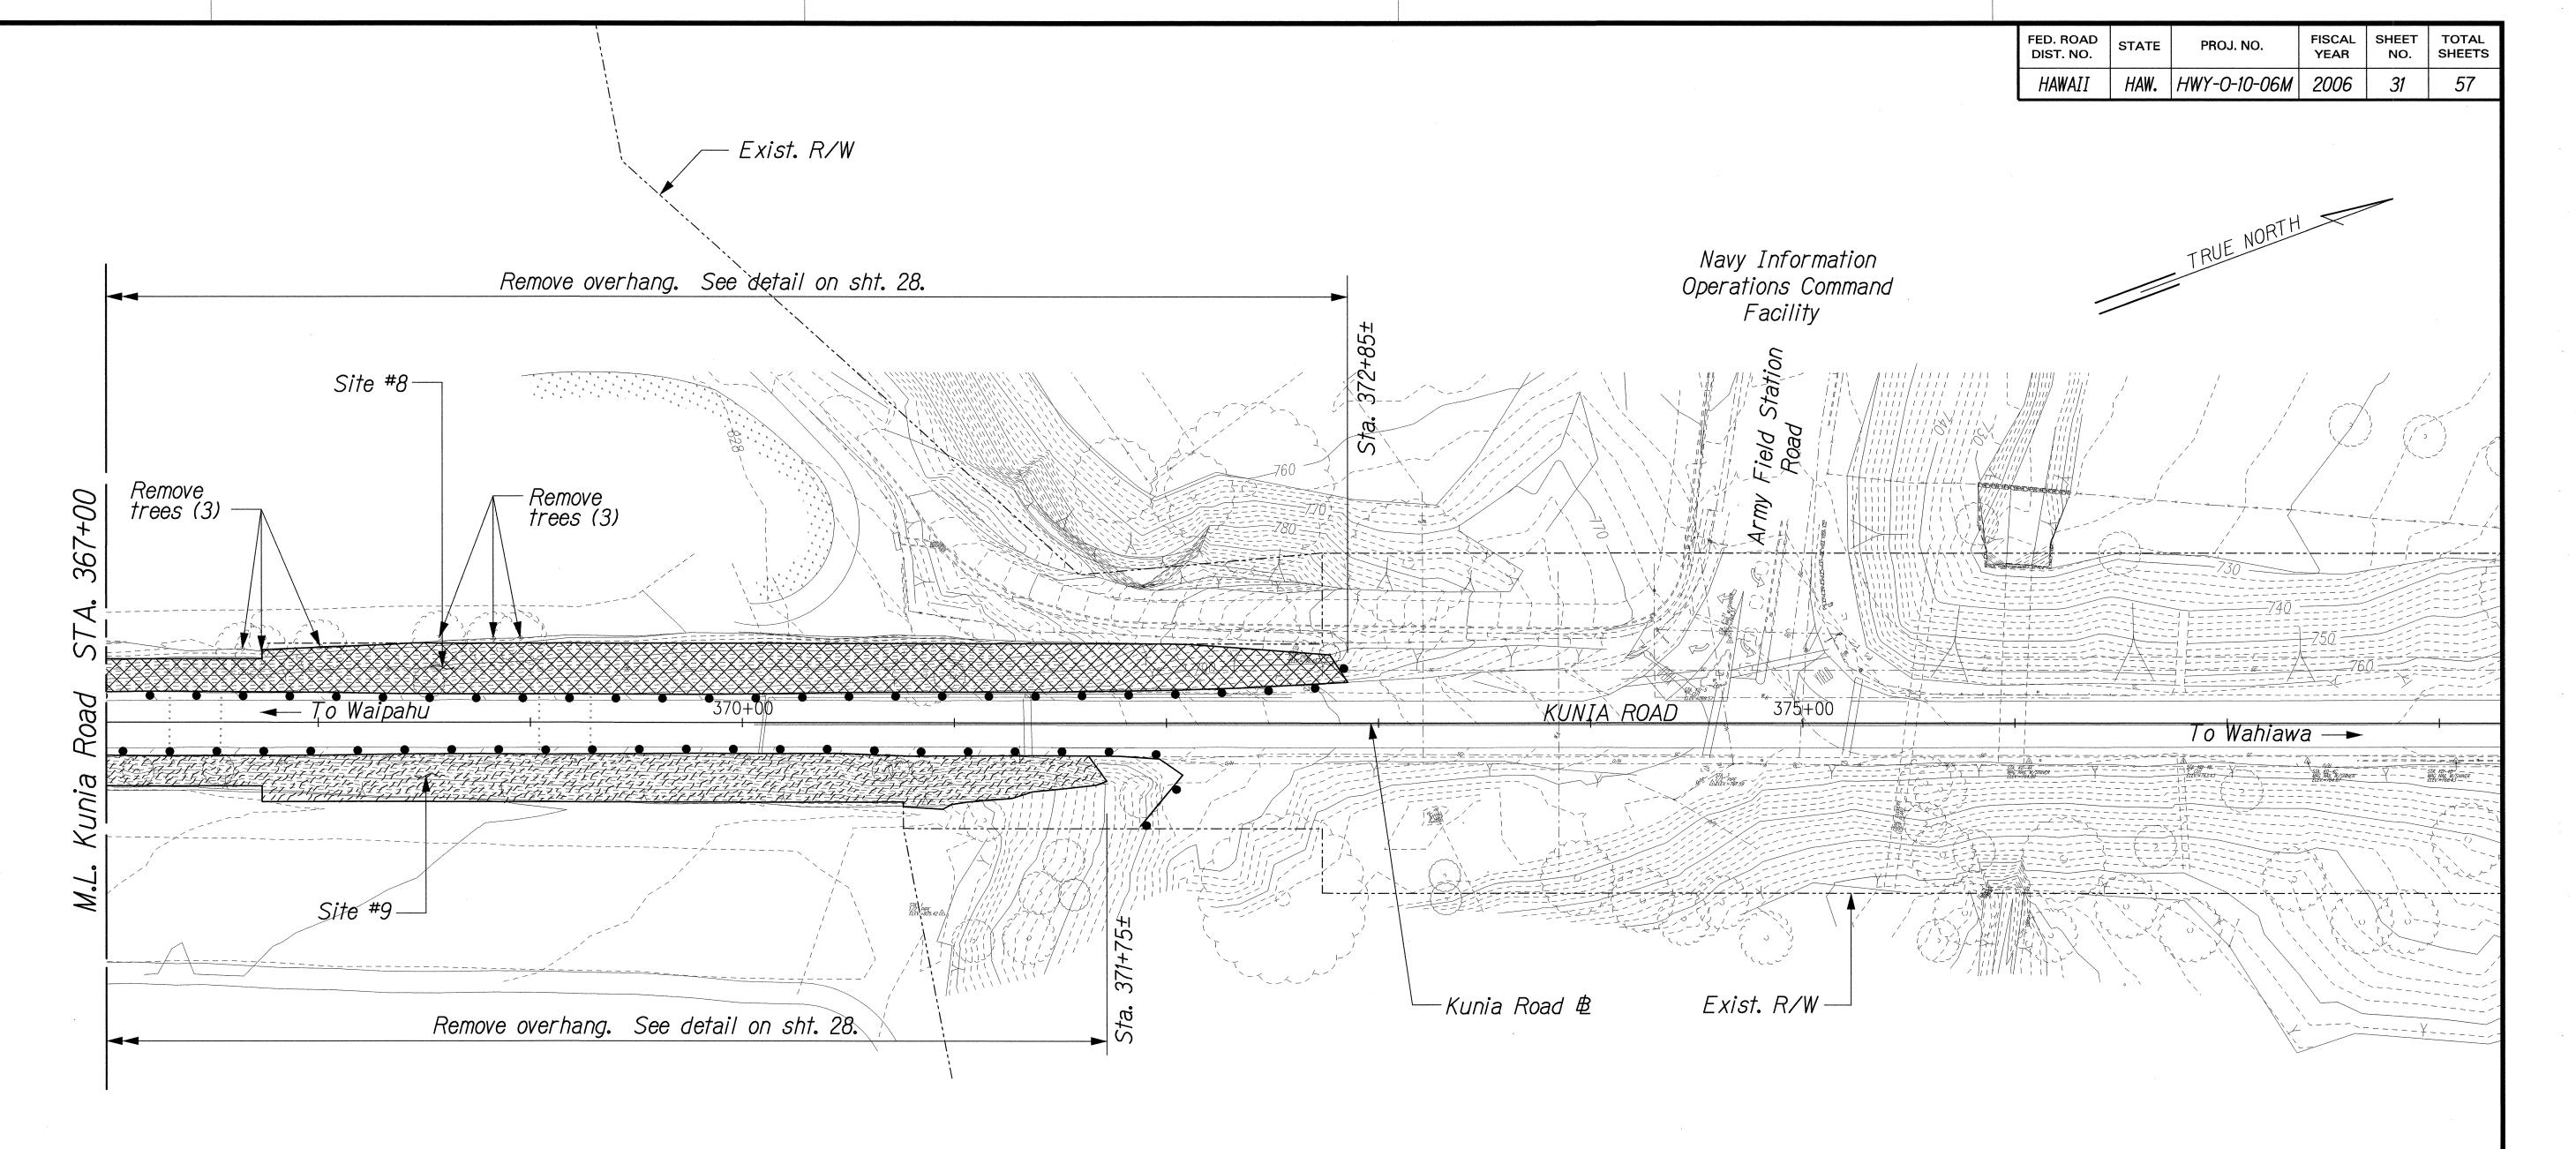

## NOTES:

- 1. For Sites 7 10, Contractor shall notify
  the Navy Information Operation Command
  (NIOC) Facility of the schedule, location
  and nature of work at least seven (7) days
  prior to the start of construction.
  Facilities Department (N4)
  Navy Information Operations Command, Hawaii
  Schofield Barracks, HI 96857
  Voice: (808) 655-3564/655-3266/655-3888
  Fax: (808) 655-3553
- 2. Silt fence shall be installed prior to construction activity in the area.
- 3. Silt fence shall be removed one year after the State accepts completed slope with hydromulch or hydraulically applied erosion control blanket.

- 4. Removal of erosion control items shall be the responsibility of the Contractor and considered included in the lump sum cost of Item No. 209.1000 Installation, Maintenance, Monitoring, and Removal of BMP. Contractor shall restore disturbed area due to Silt Fence removal to equal or better condition at no cost to the State.
- 5. Maximum limits of erosion control work area shown.

  Existing vegetation coverage may vary at time of construction. Contractor shall install erosion control measures on areas with no vegetation or as directed by the Engineer. Existing trees and vegetation shall remain unless otherwise indicated on plan or by the Engineer for removal.
- 6. Remove any loose soil on the exposed slope face prior to hydromulch or hydraulic blanket mixture application. Removal shall be paid for under Item No. 203.0300 Excess Soil Removal.

- 7. Remove overhang. See detail on Sht. 28. Removal shall be paid for under Item No. 203.0300 Excess Soil Removal.
- 8. Contractor shall notify Engineer and Christopher Dacus, HWY-DL, (692-7600) 7 days prior to any work commencing on site. HWY-DL will verify the number and location of trees to be removed.

LEGEND:




Hydro-Mulch Mixture



Hydraulic Blanket Mixture

Silt Fence

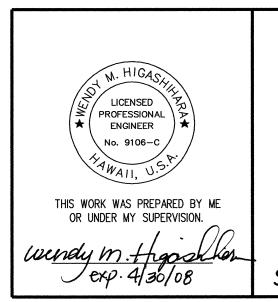

STATE OF HAWAII

DEPARTMENT OF TRANSPORTATION
HIGHWAYS DIVISION

EDOCION CONT DOI

EROSION CONTROL
KUNIA ROAD - SITES 8 \$ 9

SLOPE MAINTENANCE FOR EROSION CONTROL


AT VARIOUS SITES ON OAHU


Project No. HWY-0-10-06M

Scale: 1"=40'

Date: April 2006

SHEET No. EC-7 OF 8 SHEETS

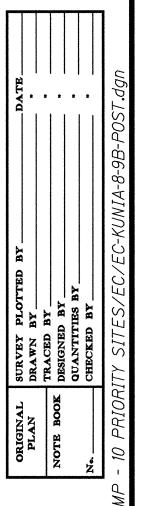

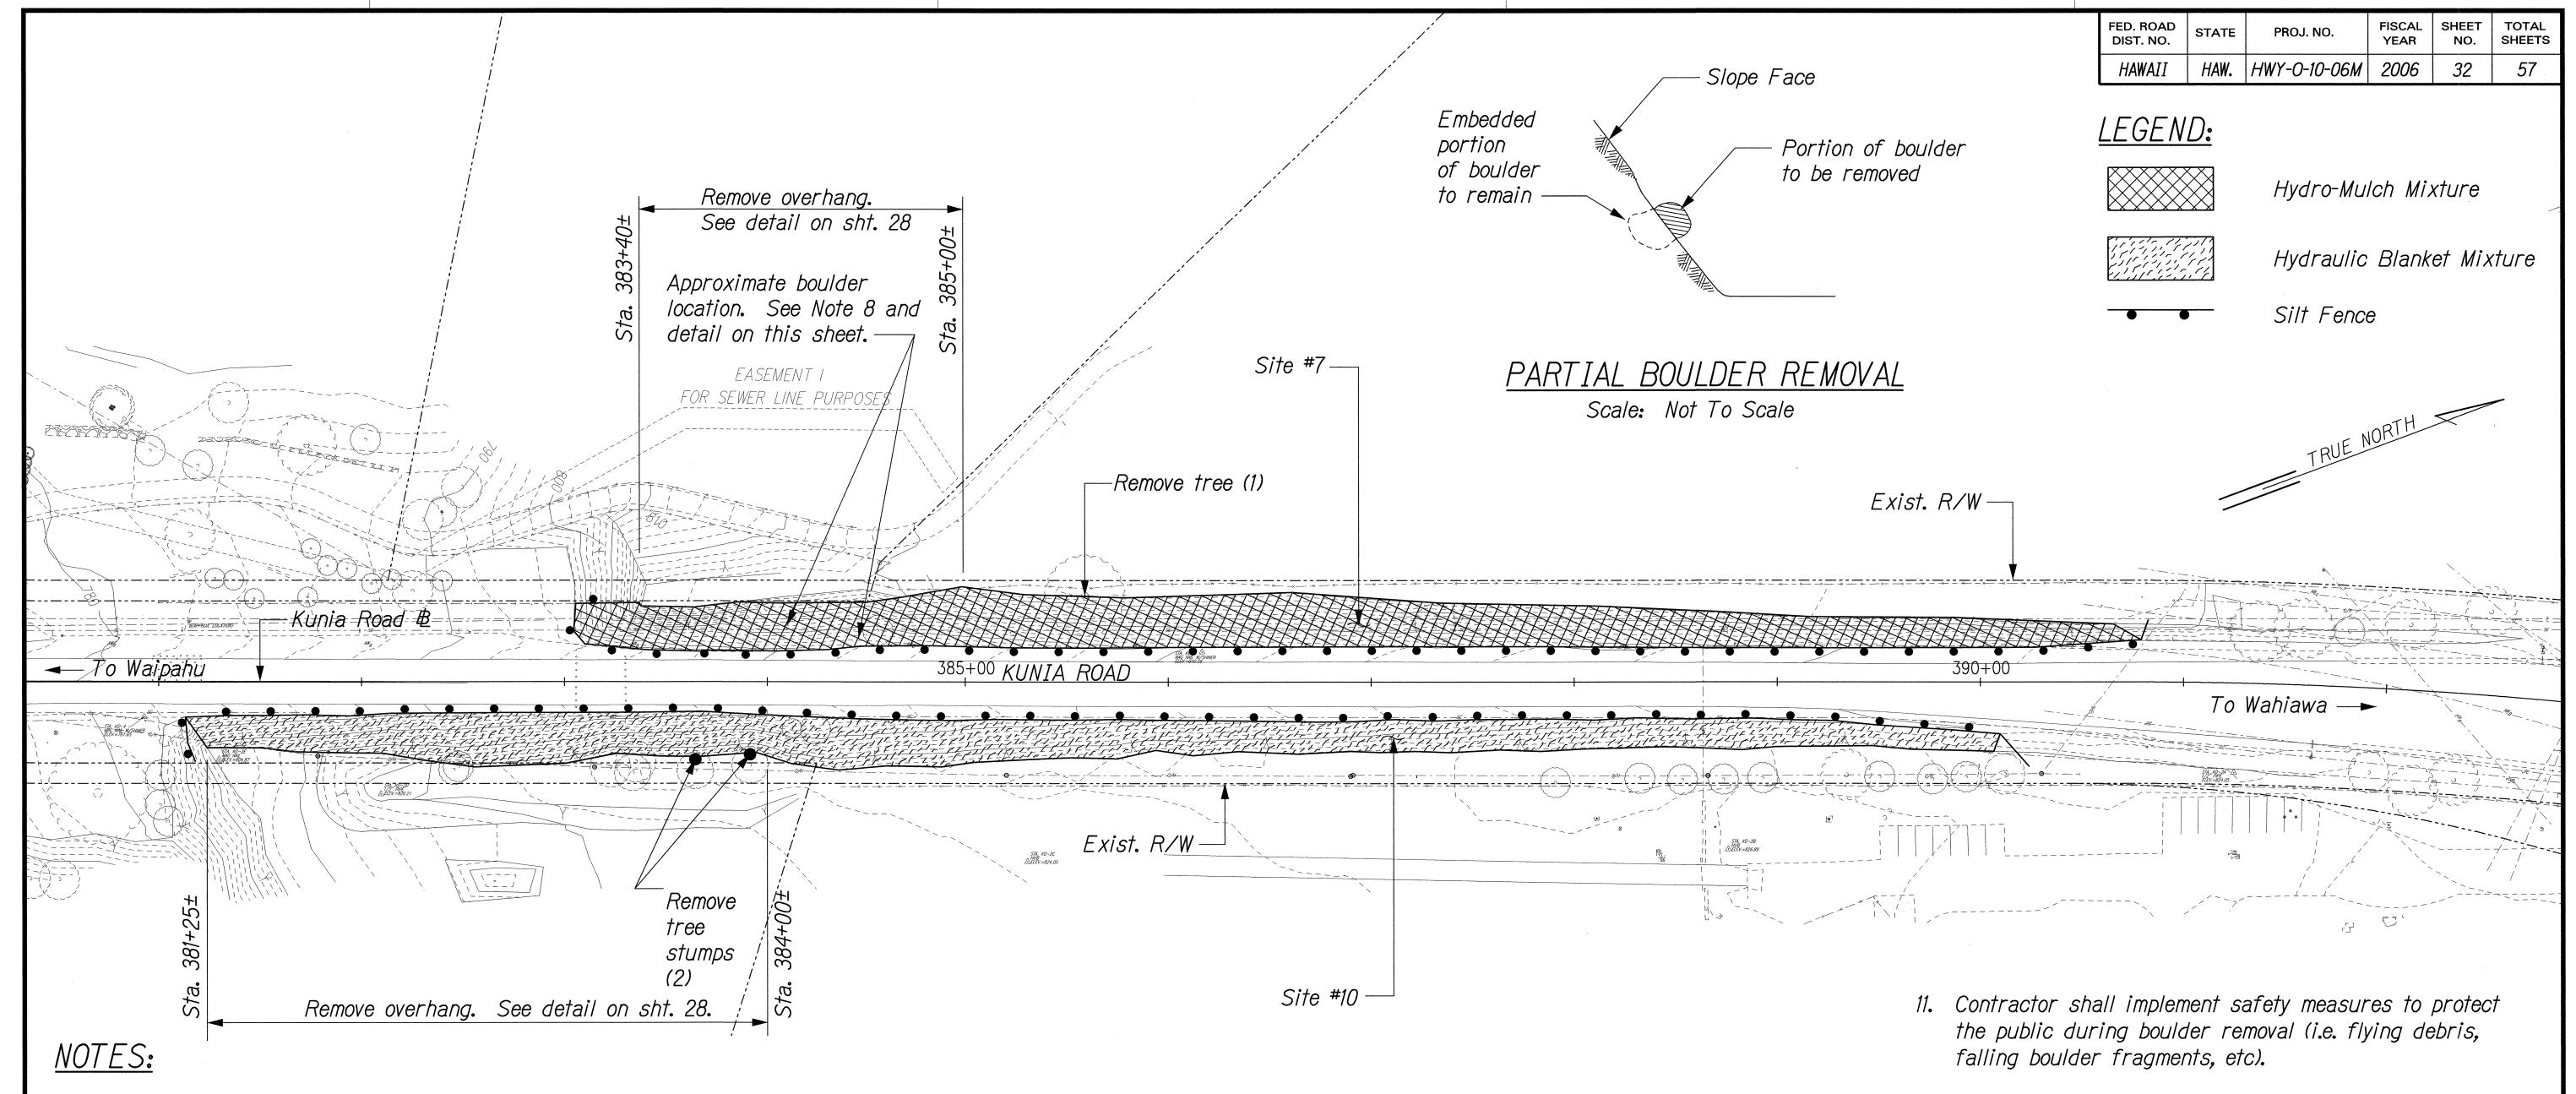


1. For Sites 7 - 10, Contractor shall notify the Navy Information Operation Command (NIOC) Facility of the schedule, location and nature of work at least seven (7) days prior to the start of construction. Facilities Department (N4) Navy Information Operations Command, Hawaii Schofield Barracks, HI 96857 Voice: (808) 655-3564/655-3266/655-3888 Fax: (808) 655-3553

- 2. For Sites 7 and 10, Contractor shall notify Master Sergeant Nambert (489-5330) of Wheeler Army Airfield of the construction work at least seven (7) days prior to the start of construction.
- Silt fence shall be installed prior to construction activity in the area.

- 4. Silt fence shall be removed one year after the State accepts completed slope with hydro-mulch or hydraulically applied erosion control blanket.
- 5. Removal of erosion control items shall be the responsibility of the Contractor and considered included in the lump sum cost of Item No. 209.1000 Installation, Maintenance, Monitoring, and Removal of BMP. Contractor shall restore disturbed area due to Silt Fence removal to equal or better condition at no cost to the State.
- 6. Maximum limits of erosion control work area shown. Existing vegetation coverage may vary at time of construction. Contractor shall install erosion control measures on areas with no vegetation or as directed by the Engineer. Existing trees and vegetation shall remain 10. Construction shall take precautions to prevent damage unless otherwise indicated on plan or by the Engineer for removal.

- 7. Remove any loose soil on the exposed slope face prior to hydromulch or hydraulic blanket mixture application. Removal shall be paid for under Item No. 203.0300 Excess Soil Removal.
- 8. Remove overhang. See detail on Sht. 28. Removal shall be paid for under Item No. 203.0300 Excess Soil Removal.
- 9. Contractor shall remove portion of boulder protruding beyond the slope face. Portion of boulder embedded in the slope to remain. Contractor is responsible to fill voids 6-inches and deeper that are due to the boulder removal at no extra cost to the State. Depth of void shall be measured from the surface immediately surrounding the boulder.
- to surrounding property during boulder removal. Damage to State facilities and surrounding property as a result of the boulder removal activity shall be restored to previous condition or better by the Contractor at no cost to the State.

- 12. Contractor shall notify Engineer and Christopher Dacus, HWL-DL, (692-7600) 7 days prior to any work commencing on site. HWY-DL will verify the number and location of trees to be removed.
- 13. Contractor shall notify Engineer prior to tree removal if disturbance is anticipated to jeopardize utility pole stability.
- 14. Removal of tree stumps shall be paid for under Item No. 202.0411 Removal of Trees.

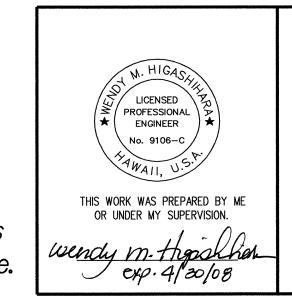

**DEPARTMENT OF TRANSPORTATION** 

EROSION CONTROL KUNIA ROAD - SITES 7 \$ 10

SLOPE MAINTENANCE FOR EROSION CONTROL AT VARIOUS SITES ON OAHU Project No. HWY-0-10-06M

Scale: 1"=40'

SHEET No. EC-8 OF SHEETS

SURVEY PLOY
DRAWN BY
TRACED BY
DESIGNED BY
QUANTITIES I
CHECKED BY

32

Date: April 2006