



FN: $96-46\96-46.11\drawings\C-16$ cabinet details.dwg

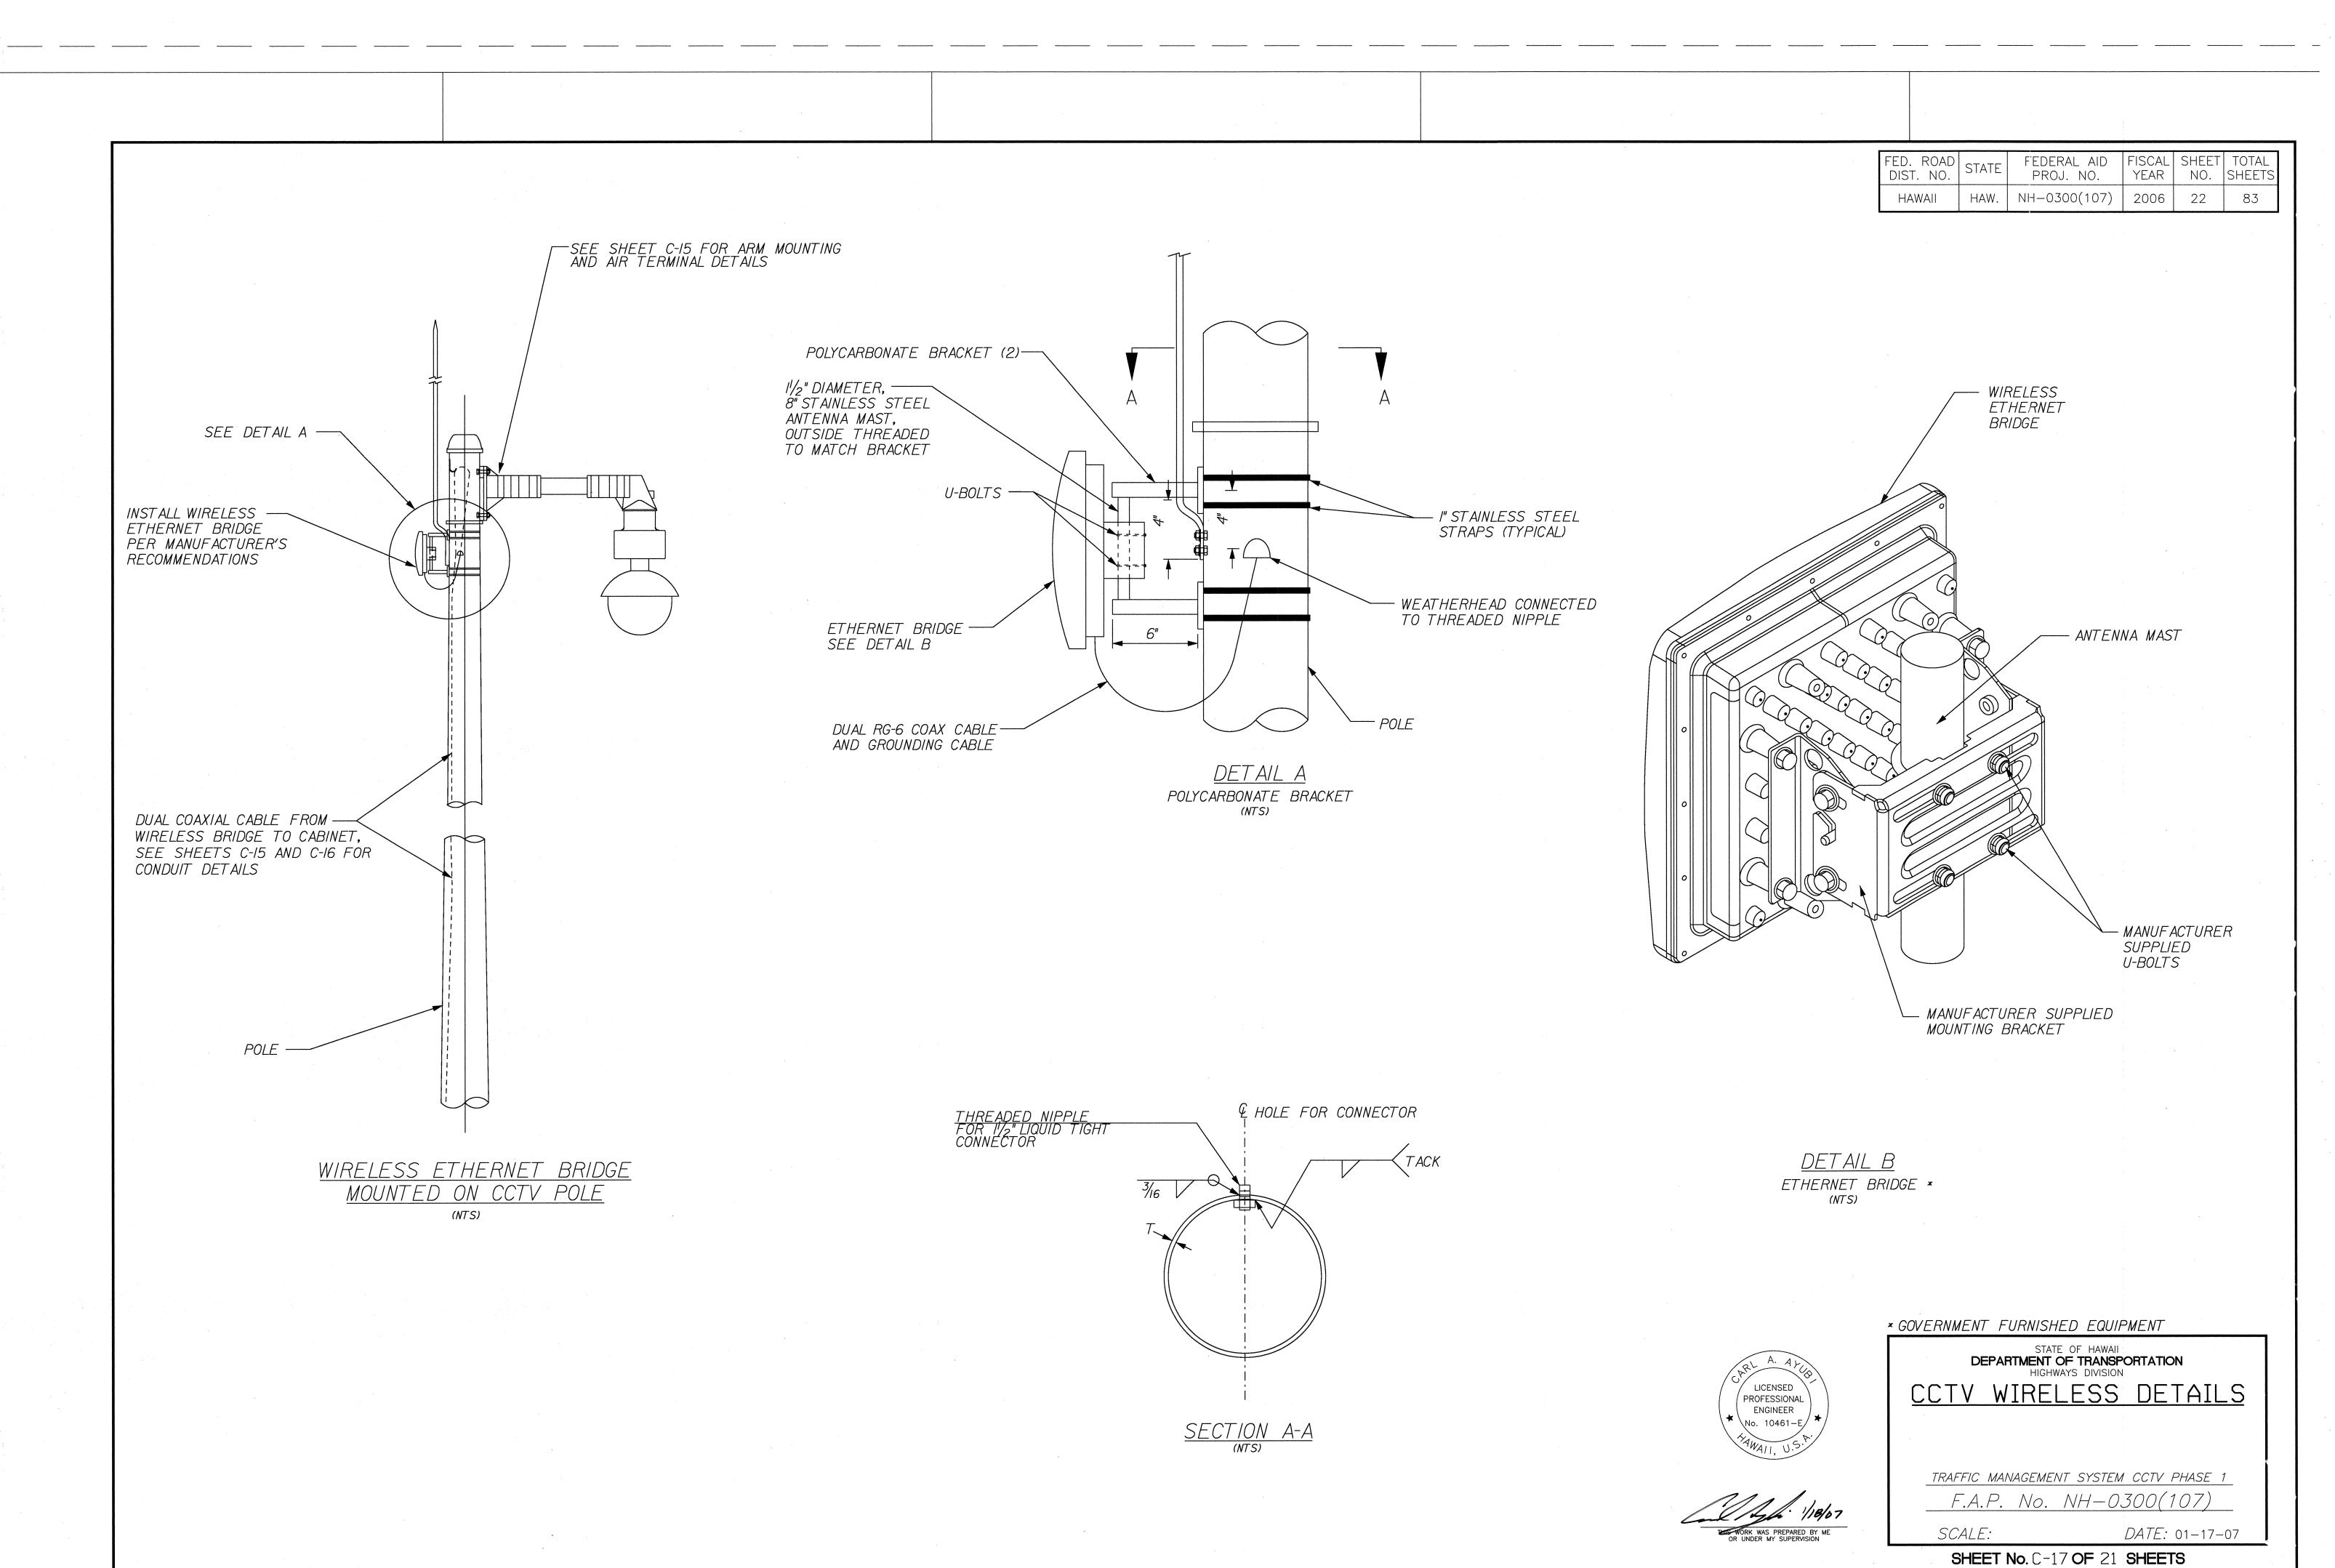


FED. ROAD DIST. NO.	STATE	FEDERAL AID PROJ. NO.	FISCAL YEAR		TOTAL SHEETS
HAWAII	HAW.	NH-0300(107)	2006	23	83

NOTES: 1. ALL DEVICES RACK MOUNTED UNLESS OTHERWISE SHOWN

2. EQUIPMENT LAYOUT AND WIRING IN RACK SHALL BE PER THE SPECIFICATIONS

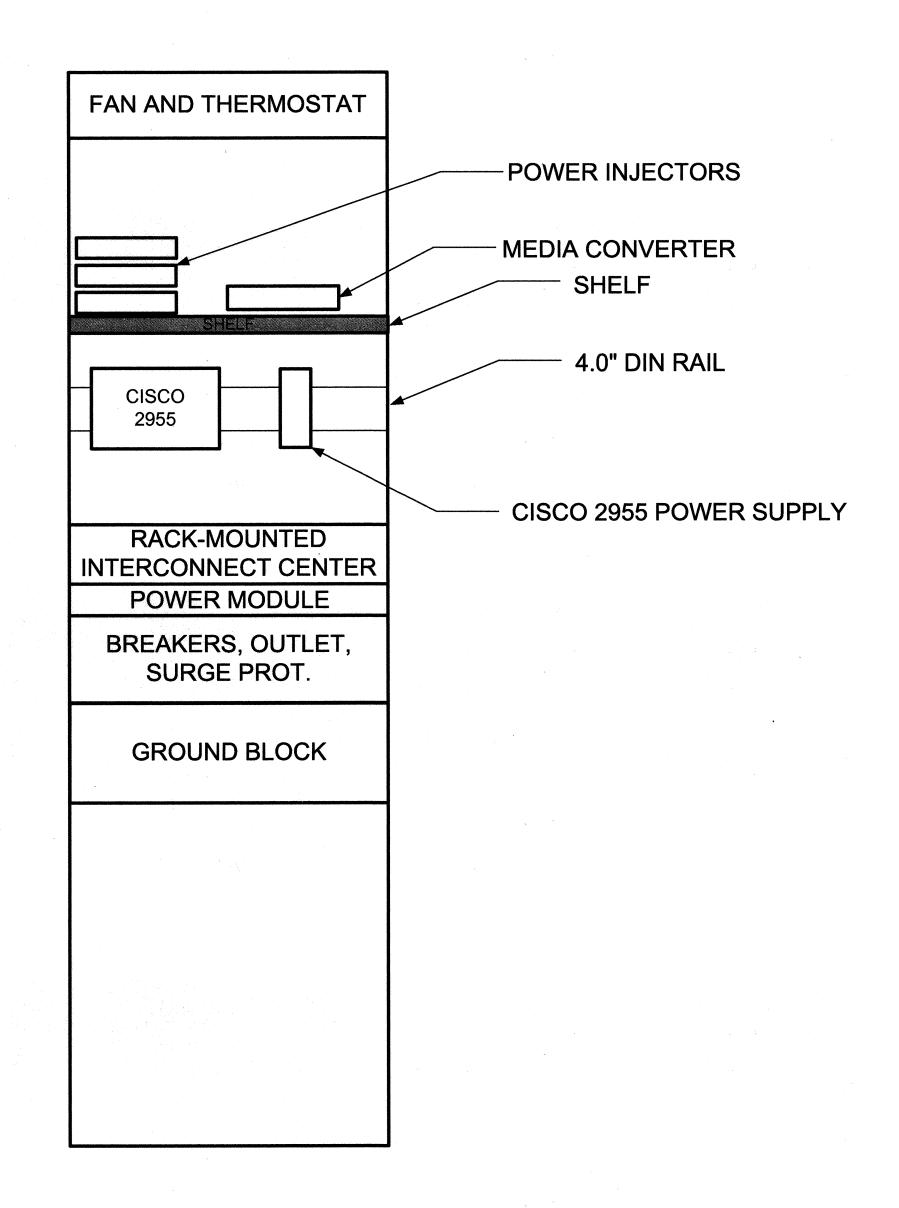

FIBER PATCH PANEL 17"W X 1.75"H X 12" D POWER INJECTOR 6.3"W x 6.4"H x 1.3"D CISCO 8.1"W x 5.0"H x 3.8"D 2955 CISCO 2955 POWER SUPPLY 1.9"W x 4.9"H x 4.1"D **MEDIA** CONVERTER 7" W X 1.5" H X 6.5" D

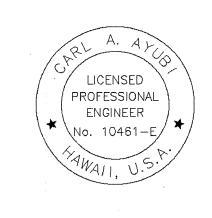

STATE OF HAWAII


DEPARTMENT OF TRANSPORTATION HIGHWAYS DIVISION CABINET DEVICE LAYOUT DETAIL

TRAFFIC MANAGEMENT SYSTEM CCTV PHASE 1 F.A. PROJ. NO. NH-0300(107)

SCALE: NTS

DATE: 01-17-07

SHEET No. C-18 OF 21 SHEETS

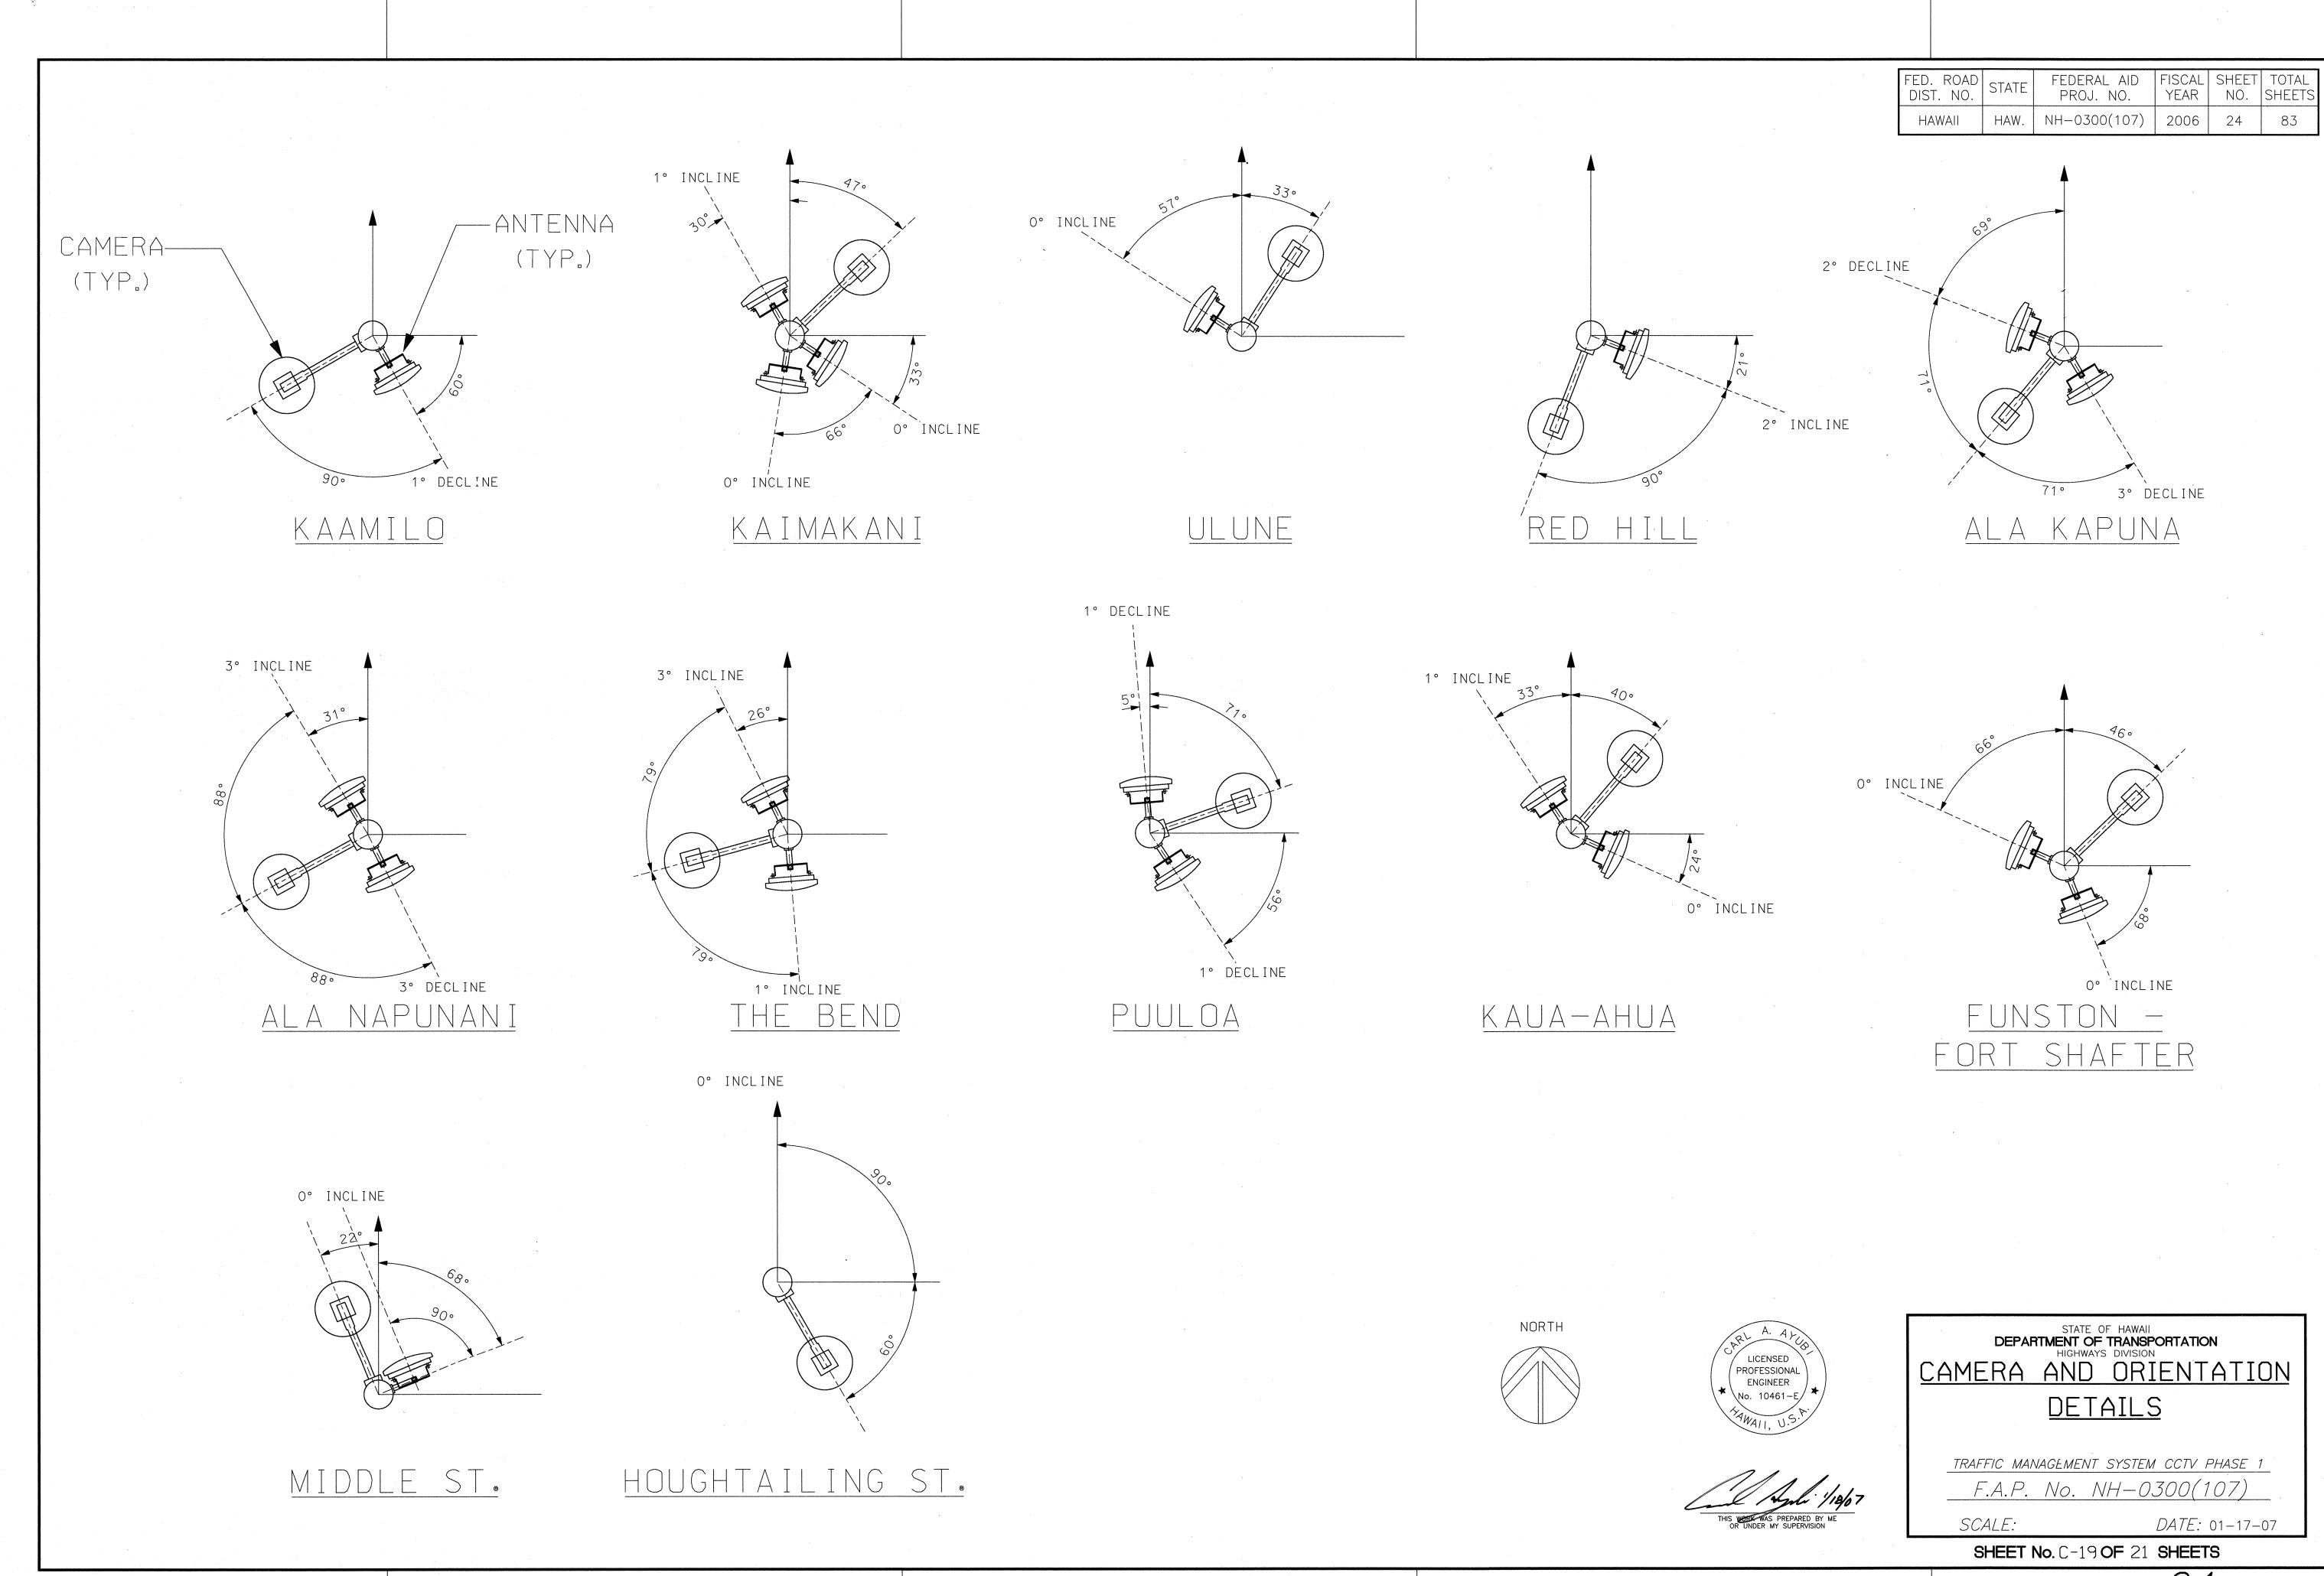

FEDERAL AID | FISCAL | SHEET | TOTAL FED. ROAD DIST. NO. PROJ. NO. YEAR NO. SHEETS HAW. NH-0300(107) 2006 25


STREAMGUARD EDGES REST ON GRATE FRAME BETWEEN GRATE AND FRAME **STREAMGUARD** GRATED DRAIN INLET

NOTES:

- 1. GRATED DRAIN INLET FILTER SHALL BE "STREAMGUARD" SEDIMENT INSERT BY BOWHEAD OR APPROVED EQUAL.
- 2. CONTRACTOR SHALL CHECK THE CONDITION OF THE FILTER AT THE BEGINNING AND ENDING OF EACH WORK DAY AND REPAIR/ CLEAN AS NECESSARY.
- 3. THE CONTRACTOR SHALL REMOVE INLET FILTERS DURING TIMES OF ABOVE NORMAL RAINFALL EVENTS AND REPLACE THEM WHEN THE EVENT HAS PASSED.

TEMPORARY SEDIMENT FILTER AT GRATED DRAIN INLET

NOT TO SCALE

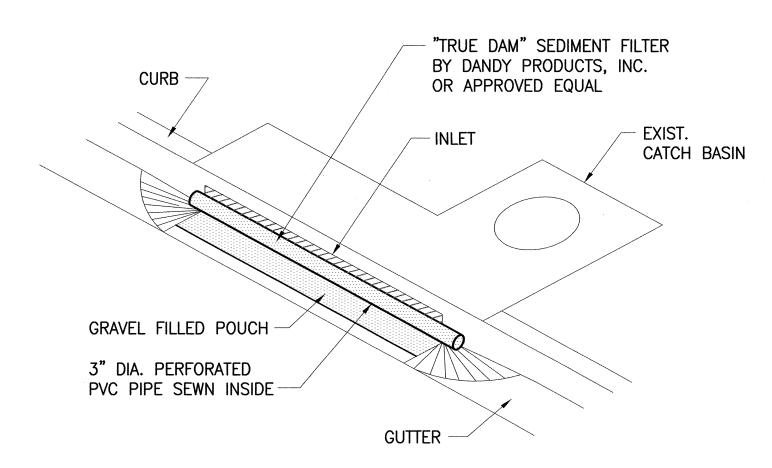

NOTES:

ENDS OF FILTER FABRIC

NOTES:

SANDWICHED BETWEEN GRATE AND FRAME

1. THE CONTRACTOR SHALL REMOVE INLET FILTERS DURING TIMES OF ABOVE NORMAL RAINFALL EVENTS AND REPLACE THEM WHEN THE EVENT HAS PASSED.

SEDIMENT CONTROL FILTER AT CATCH BASIN

← GRATE

TRENCH DRAIN

1. FILTER FABRIC SHALL BE 15 MIL (MIN.)

CORP. OR APPROVED EQUAL.

CLEAN AS NECESSARY.

HAS PASSED.

"ENVIROFENCE #10800" BY NICOLON

2. CONTRACTOR SHALL CHECK THE CONDITION

OF THE FILTER AT THE BEGINNING AND

ENDING OF EACH WORK DAY AND REPAIR/

3. THE CONTRACTOR SHALL REMOVE INLET FILTERS

DURING TIMES OF ABOVE NORMAL RAINFALL

EVENTS AND REPLACE THEM WHEN THE EVENT

NOT TO SCALE

- FILTER FABRIC

ENVIRONMENTAL PROTECTION NOTES

- 1. THE CONTRACTOR, AT HIS OWN EXPENSE, SHALL PROVIDE EFFECTIVE MEASURES FOR THE CONTROL OF FUGITIVE DUST EMISSIONS FROM THE PROJECT AND SURROUNDING AREAS CAUSED BY HIS OPERATIONS. THESE MEASURES SHALL MEET THE REQUIREMENTS OF STATE ADMINISTRATIVE RULES, DEPARTMENT OF HEALTH, AIR POLLUTION CONTROL (11-60.1).
- 2. ALL GRADING OPERATIONS SHALL BE PERFORMED IN CONFORMANCE WITH THE APPLICABLE PROVISIONS OF THE GRADING ORDINANCE TO PREVENT VIOLATION OF THE STATE ADMINISTRATIVE RULES, DEPARTMENT OF HEALTH, WATER POLLUTION CONTROL AND WATER QUALITY STANDARDS (11-54, 11-55) DUE TO EROSION AND RUN OFF TO STATE WATERS.
- 3. GRUB MATERIAL, DEMOLITION WASTES, AND CONSTRUCTION WASTES SHALL BE DISPOSED OF AT AN AUTHORIZED SITE HAVING A DEPARTMENT OF HEALTH SOLID WASTE MANAGEMENT PERMIT. OPEN BURNING IS PROHIBITED.
- 4. ALL EXCESS MATERIAL SHALL BE REMOVED FROM THE PROJECT SITE.

-2x2 DOUGLAS FIR OR

#4 WITH SAFETY CAP

EXST. GRADE

FILTER FABRIC SHALL BE A

PERVIOUS SHEET OF POLYPROPYLENE,

NYLON, POLYESTER OR ETHYLENE

YARN WITH UV INHIBITORS AND

5'-0" LONG BAR

STABILIZERS.

◎ 6'−0" 0.C.

NOTES:

TEMPORARY DUST CONTROL MEASURES

- THE GRADED OR PROJECT SITE THAT IS CLEARED OF VEGETATION SHALL BE KEPT DAMP FOR SEVEN (7) DAYS A WEEK. AT THE END OF EACH DAY, THE SITE SHALL BE SUFFICIENTLY DAMPENED SO THAT THE SITE WILL REMAIN MOSTENED DURING THE NIGHT.
- 2. THE CONTRACTOR SHALL CONDUCT HIS OPERATIONS SO THAT EXCAVATION, EMBANK-MENT, AND IMPORTED MATERIAL SHALL BE DAMPENED TO PREVENT DUST PROBLEMS.

TEMPORARY EROSION CONTROL MEASURES

- 1. TEMPORARY VEGETATIVE COVER SHALL BE PLANTED OR FIBERMULCH APPLIED AS SOON AS FINAL GRADES ARE ACHIEVED, OR IF FINAL GRADING OF THE SITE WILL BE SUSPENDED FOR MORE THAN 21 CALENDAR DAYS.
- 2. TEMPORARY VEGETATIVE COVER SHALL CONSIST OF 40 LBS, COMMON RYE GRASS SEED PER ACRE, 400 LBS, PER ACRE 10-10-10 OR EQUIVALENT FERTILIZER WORKED INTO THE SOIL CONCURRENTLY WITH ALL PLANTINGS. PLANTING AND MAINTENANCE OF GRASS SHALL CONFORM TO THE "HAWAII STANDARD SPECIFICATIONS FOR ROAD AND BRIDGE CONSTRUCTION." 2005.

PERMANENT EROSION CONTROL MEASURES

- 1. THE CONTRACTOR SHALL GRASS THE ENTIRE PROJECT SITE, EXCEPT PAVED AND CONCRETE AREAS, WITH SPECIFIED GRASSING. THE GRASS SHALL BE PLANTED, FERTILIZED, AND MAINTAINED IN ACCORDANCE WITH THE "HAWAII STANDARD SPECIFICATIONS FOR ROAD AND BRIDGE CONSTRUCTION." 2005.
- 2. THE CONTRACTOR SHALL GRASS ALL EXPOSED AREAS AS SOON AS FINAL GRADES ARE ACHIEVED.

EROSION CONTROL/BEST MANAGEMENT PRACTICES NOTES

- 1. EROSION CONTROL MEASURES TO BE INSTALLED PRIOR TO START OF CONSTRUCTION AND BE MAINTAINED UNTIL COMPLETION OF ALL CONSTRUCTION ACTIVITIES.
- 2. THE FINAL LIFT OF EACH DAY'S WORK SHALL BE COMPACTED TO PREVENT EROSION OF FILL MATERIAL.
- 3. CATCH BASIN AND DRAIN INLET FILTERS SHALL REMAIN UNTIL COMPLETION OF CONSTRUCTION WORK, CONTRACTOR SHALL PERIODICALLY INSPECT CATCH BASIN AND INLET FILTERS, ESPECIALLY DURING HEAVY RAINFALL, TO ENSURE DRAINAGE THROUGH FILTER MATERIAL IS MAINTAINED.
- 4. GOOD HOUSEKEEPING SHALL BE UTILIZED TO ENSURE PROTECTION OF ROADWAYS FROM MUD, DIRT, AND DEBRIS.
- 5. AT THE END OF GRADING OPERATIONS AND AT THE COMPLETION OF PROJECT, CONTRACTOR SHALL INSPECT ALL CATCH BASIN, DRAIN INLET AND DRAIN MANHOLE SURROUNDING THE PROJECT SITE. ANY ACCUMULATED SEDIMENT AND DEBRIS FOUND IN THE STORM DRAIN STRUCTURES SHALL BE REMOVED. PLEASE NOTE THAT FLUSHING INTO THE DRAIN STRUCTURES ARE PROHIBITED.



POLLUTION, DUST AND **EROSION CONTROL**

TRAFFIC MANAGEMENT SYSTEM CCTV PHASE 1 F.A.P. NO. NH-0300(107)

DATE: 08-15-06 SCALE: NOT TO SCALE

STATE OF HAWAII DEPARTMENT OF TRANSPORTATION

HIGHWAYS DIVISION

TEMPORARY WATER

SHEET No.C-20 OF 21 SHEETS

ENDS OF FILTER FABRIC SANDWICHED BETWEEN GRATE AND FRAME -GRATE FILTER FABRIC DRAIN INLET NOTES:

> 1. FILTER FABRIC SHALL BE 15 MIL (MIN.) "ENVIROFENCE #10800" BY NICOLON

CORP. OR APPROVED EQUAL.

- 2. CONTRACTOR SHALL CHECK THE CONDITION OF THE FILTER AT THE BEGINNING AND ENDING OF EACH WORK DAY AND REPAIR/ CLEAN AS NECESSARY.
- 3. THE CONTRACTOR SHALL REMOVE INLET FILTERS DURING TIMES OF ABOVE NORMAL RAINFALL EVENTS AND REPLACE THEM WHEN THE EVENT HAS PASSED.

TEMPORARY SEDIMENT BARRIER

AT DRAIN INLET

NOT TO SCALE

FN: $96-46\96-46.11\drawings\C-20$ erosion control .dwg

TEMPORARY SEDIMENT BARRIER

AT TRENCH DRAIN

NOT TO SCALE

SILT FENCE

SECTION

LIMITS OF GRADING -

FILTER FABRIC

STAPLED TO POST


COMPACTED BACKFILL

FLOW

SILT FENCE DETAIL

ELEVATION

NOT TO SCALE

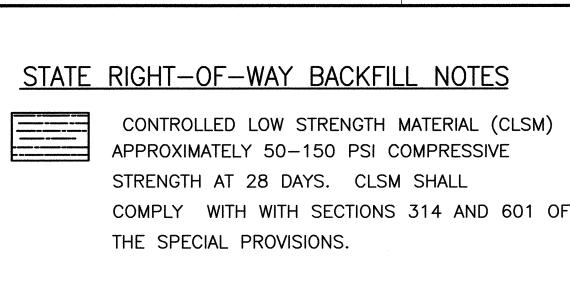

CONCRETE 3000 PSI COMPRESSIVE STRENGTH @ 28 DAYS.

NOTE: BASE COURSE & SUB-BASE COURSE PER 2005 STATE STANDARD SPECIFICATIONS FOR HIGHWAY CONSTRUCTION.

GENERAL NOTES

- 1. IF TRENCH IS LOCATED ON UNPAVED AREA, THE CONTRACTOR SHALL REPLACE 8" A.C. BASE COURSE AND 4" A.C. PAVEMENT WITH TYPE "A" TRENCH BACKFILL MATERIAL. (TRENCH BACKFILL MATERIAL "A" CONSIST OF BEACH SAND, EARTH, OR EARTH AND GRAVEL. IF EARTH AND GRAVEL IS USED, THE MAXIMUM SHALL CONTAIN NOT MORE THAN 50% BY VOLUME OF ROCK PARTICLE. MAXIMUM 8" LOOSE FILL PER LIFT OBTAIN 90% COMPACTION FOR EACH LIFT. ROCK SHALL NOT EXCEED 1" Ø.)
- 2. THE METAL DETECTABLE RED PLASTIC WARNING TAPE SHALL BE A MINIMUM 5 MILS THICK AND 4" WIDE WITH A CONTINUOUS METALLIC BACKING AND CORROSION RESISTANT 1' MIL THICK FOIL CORE. THE MESSAGE ON THE TAPE SHALL READ, "CAUTION - STATE TRAFFIC SIGNAL AND/OR HWY LIGHTING BURIED BELOW," UTILIZING 1/2 INCHES SERIES "C" BLACK LETTERING. THE MESSAGE WILL BE REPEATED WITH A 4/4" SPACING BETWEEN TOP LINE OF MESSAGE AND START OF NEXT REPEAT.
- 3. THE CONTRACTOR MAY BEGIN BACKFILLING THE CONDUIT TRENCH BEFORE THE CONCRETE REACHES 2500 PSI COMPRESSIVE STRENGTH BUT AFTER CONCRETE HAS HARDENED SUFFICIENTLY ENOUGH THAT BACKFILLING WILL NOT DAMAGE THE CONCRETE JACKET.
- 4. MAXIMUM FOUR (4) CONDUITS PER ROW FOR MULTIPLE CONDUIT DUCT SECTION. DUCTS SHALL BE INSTALLED WITH SPACERS AND ANCHORED TO THE GROUND BEFORE POURING CONCRETE. SPACERS SHALL BE A MAXIMUM OF 5' APART. JOINTS SHALL BE STAGGERED.
- 5. FOR DIRECT BURIED DUCT SECTIONS, THE CONCRETE JACKET REQUIRED AT THE CONDUIT BY-PASS FOR VARIOUS UTILITIES, SHALL BE AT THE CONTRACTOR'S EXPENSE.
- 6. AFTER INSTALLING ALL THE TRAFFIC SIGNAL CABLES, THE CONTRACTOR SHALL DUCT SEAL ALL CONDUITS IN THE PULLBOXES, TRAFFIC SIGNAL STANDARDS AND TRAFFIC SIGNAL CONTROLLER CABINET CONCRETE BASE. THE DUCT SEAL MATERIAL SHALL BE APPROVED BY THE TRAFFIC SIGNAL INSPECTOR/ENGINEER.


CAUTION-STATE TRAFFIC SIGNAL AND/OR

HWY LIGHTING BURIED BELOW


11/4" SERIES "C"

BLACK LETTERS

FN: 96-46\96-46.11\drawings\C-21 TRENCH DETAILS.dwg

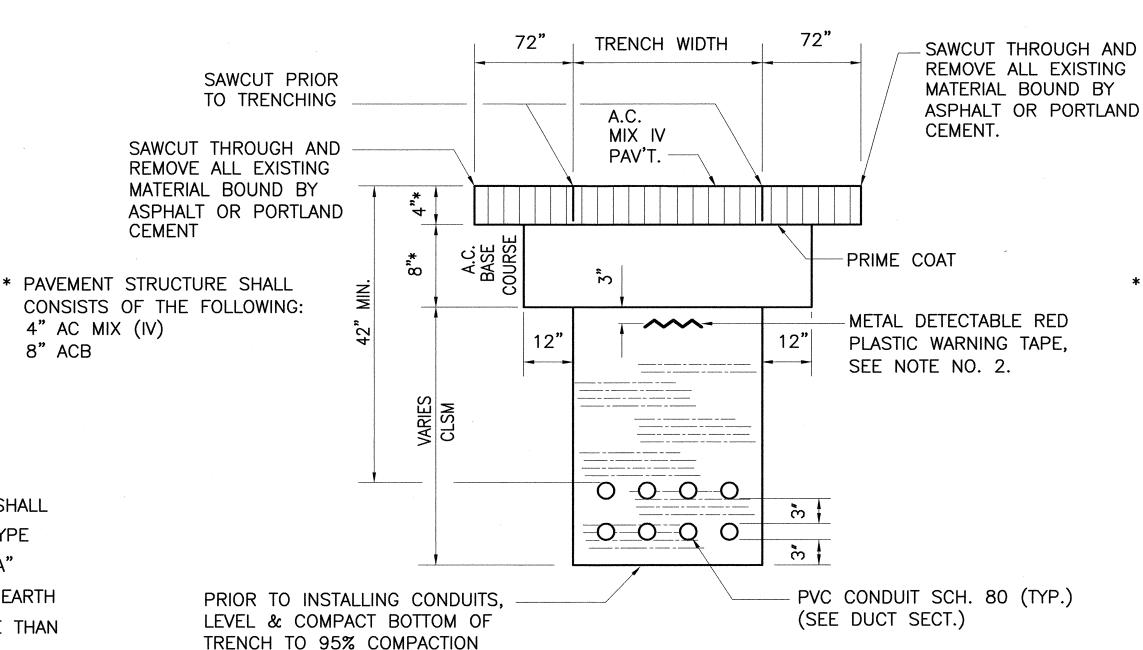

(2) TYPICAL BACKFILL SECTION DIRECT BURIED DUCTS

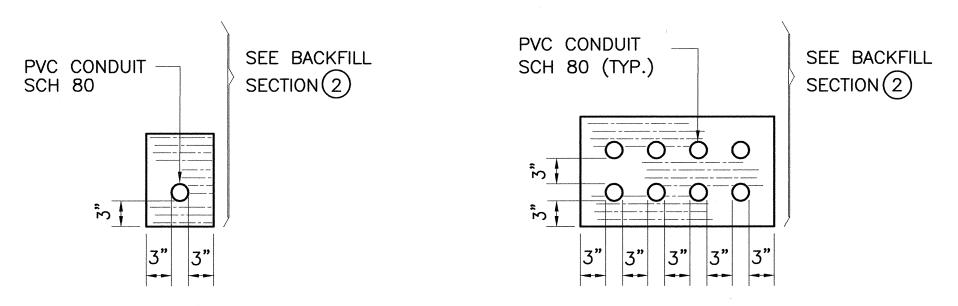

SINGLE CONDUIT


MULTIPLE CONDUIT

DUCT SECTIONS - DIRECT BURIED

HAW. NH-0300(107) 2006 26 TRENCH WIDTH SAWCUT THROUGH AND REMOVE ALL EXISTING SAWCUT PRIOR MATERIAL BOUND BY TO TRENCHING ASPHALT OR PORTLAND MIX IV CEMENT. SAWCUT THROUGH AND PAV'T. REMOVE ALL EXISTING MATERIAL BOUND BY **4**** ASPHALT OR PORTLAND CEMENT PRIME COAT * PAVEMENT STRUCTURE SHALL METAL DETECTABLE RED CONSISTS OF THE FOLLOWING: 12" 4" AC MIX (IV) PLASTIC WARNING TAPE, 8" ACB SEE NOTE NO. 2. CONCRETE ENCASEMENT — · O * O * O _ PVC CONDUITS SCH. 40 (TYP.) PRIOR TO INSTALLING CONDUITS, LEVEL & COMPACT BOTTOM OF (See DUCT SECT.) TRENCH TO 95% COMPACTION

DIST. NO.

(1) TYPICAL BACKFILL SECTION WITH CONCRETE ENCASED DUCTS

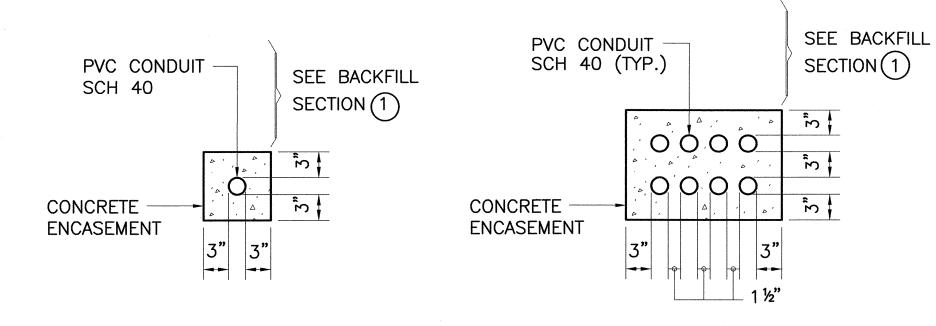

SINGLE CONDUIT


MULTIPLE CONDUIT

FEDERAL AID | FISCAL | SHEET | TOTAL

YEAR NO. SHEETS

PROJ. NO.

<u>DUCT SECTIONS - CONC. ENCASED</u>

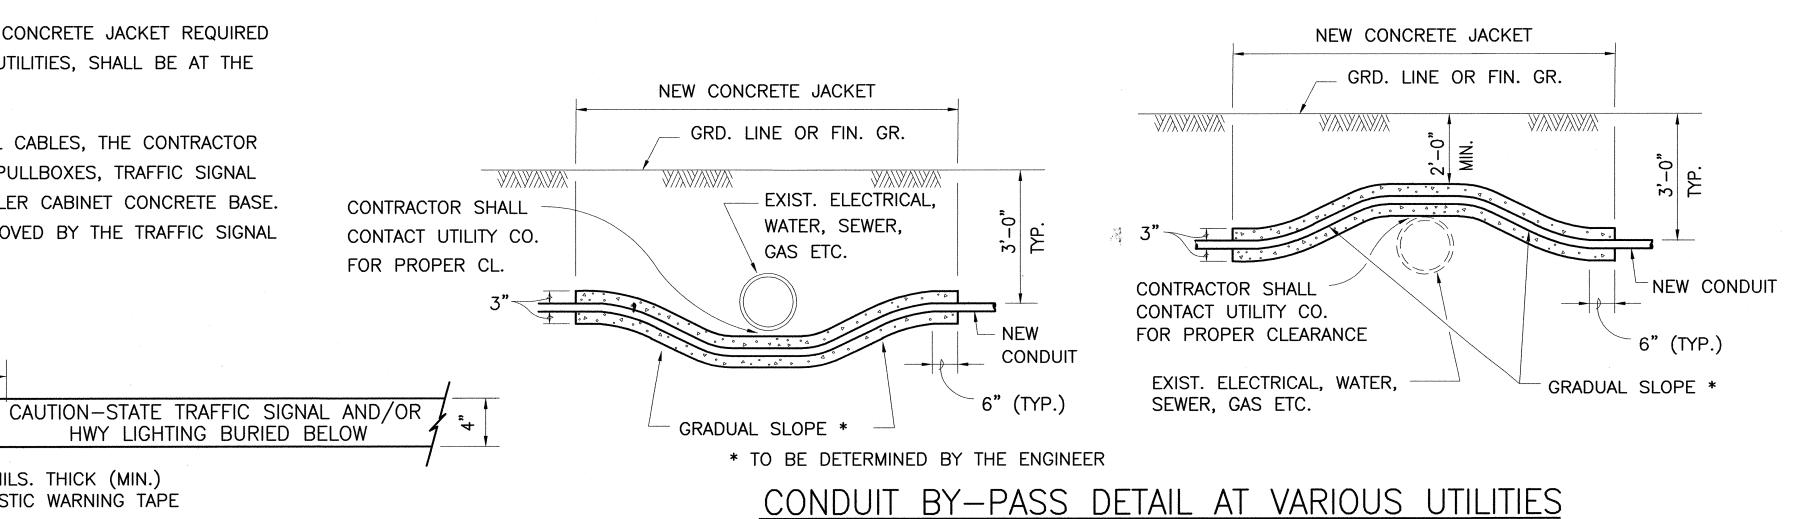

NOT TO SCALE

FOR ADDITIONAL INFORMATION SEE NOTE NO.2.

METAL DETECTABLE RED PLASTIC WARNING TAPE

5 MILS. THICK (MIN.)

PLASTIC WARNING TAPE

TRENCH DETAILS

STATE OF HAWAII
DEPARTMENT OF TRANSPORTATION
HIGHWAYS DIVISION

TRAFFIC MANAGEMENT SYSTEM CCTV PHASE 1

F.A.P. NO. NH-0300(107)

SCALE: AS SHOWN DATE: 08-15-06

SHEET No. C-21 OF 21 SHEETS

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