
## CURB RAMP AND SIDEWALK NOTES:

- 1. These typical details are intended as curb ramp guidelines for design and construction. These guidelines shall not replace site specific curb ramp plans.
- 2. A 2% maximum cross slope shall be maintained in the direction of pedestrian traffic.
- 3. Subject to field conditions, the Engineer shall determine the final location of curb ramps.
- 4. All pullboxes shall be installed away from the curb ramp and within the sidewalk/unpaved area to the maximum extent feasible.
- 5. Where necessary, existing pullboxes, handholes, manholes, etc. shall be adjusted to match curb ramp grade. Adjustments shall not be paid for separately but shall be considered incidental to the various curb ramp items unless indicated otherwise.
- 6. Transitions from ramps to gutters and roadways shall be flush.
- 7. Curb ramps and sidewalks shall be constructed to eliminate ponding to the maximum extent feasible.
- 8. The pedestrian push button shall meet operational and reach requirements of the American with Disabilities Act Accessibility Guidelines (ADAAG):

  a) Forward Reach. The maximum height for forward reach shall be 48".
- b) Side Reach. The maximum height for side reach shall be 48".
- c) Operation. Controls and operating mechanisms shall be operable with one hand and shall not require tight grasping, pinching, or twisting of the wrist. The force required to activate controls shall be no greater than 5 lbf.

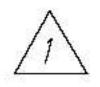

- 9. The maximum slopes of adjoining gutters or road surface immediately fronting the curb ramp shall not exceed 5%.
- 10. There shall be a 30"x48" level ground surface (2% max. cross slope, both directions) for a forward or side approach, as appropriate, to a pedestrian push button.
- 11. Construction joints are required to join curb ramps with sidewalks.
- 12. Unless otherwise noted, new gutters are required as shown.
- 13. All curb ramps shall be reinforced with 6x6 W1.4/W1.4 welded wire fabric.
- 14. Surface of sidewalks and curb ramps shall be firm, stable, and slipresistant. This includes the surfaces of pullboxes, valve covers, manhole covers, etc.
- 15. Bed course material is required for curb ramps, sidewalks, and gutters.
- 16. All sidewalks shall provide a minimum clear width of 3'-0" (excluding curb) for pedestrian circulation. If this cannot be met, a minimum 32-inch clear width is allowed for a distance of 24-inches.
- 17. Passing spaces along new sidewalks with 5' clear width or less shall be provided at maximum 200' intervals as required by ADA guidelines. The passing area shall be a minimum 5' wide by 5' long as feasible.
- 18. If possible, install utility poles, fire hydrants, light poles, sign posts, pullboxes, etc. off of sidewalk but within the right-of-way.

FED. ROAD DIST. NO.	STATE	PROJ. NO.	FISCAL YEAR	SHEET NO.	TOTAL SHEETS
HAWAII	HAW.				

- 19. Objects protruding from utility poles and walls adjacent to the sidewalks (i.e. wall mounted fire hydrants, telephones, meters on poles, etc.) shall be mounted to meet the current American with Disabilities Act Accessibility Guidelines (ADAAG) and will be subject to Engineer's approval.
- 20. If a curb ramp is not constructed according to the plans, the Contractor shall reconstruct the curb ramp at no cost to the State. Construction tolerance for Portland Cement Concrete shall be based on ½ inch per 10 ft. (±0.2%). Remedial measures will not be accepted.

## CURBLESS CROSSWALK NOTES:

1. If conditions are encountered on site at crosswalks that do not have curb ramps and sidewalks, the Contractor shall inform the Engineer of these specific conditions and their locations. HDOT will submit construction plans for these specific conditions to the Disability and Communications Access Board (DCAB), indicating paved clear floor spaces with maximum 2% slopes or a Technical Infeasiblity Statement pending DCAB approval.

Figure 5.1

7/8/22

7/8/22 Revised Note No. 9.

DATE

REVISION

STATE OF HAWAII
DEPARTMENT OF TRANSPORTATION
HIGHWAYS DIVISION

CURB RAMP AND SIDEWALK NOTES

SIDEWALK, CURB & GUTTER REPAIR


AT VARIOUS LOCATIONS

ISLAND OF OAHU


PROJECT NO. HWY-OM-2022-38


Date: June, 2022


SHEET No. 1 OF 9 SHEETS

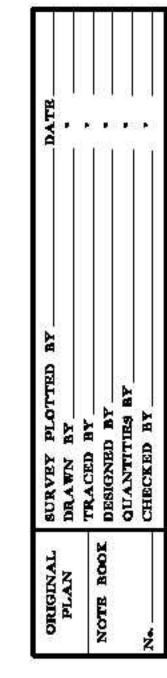


Addendum No. 2 r7/8/22

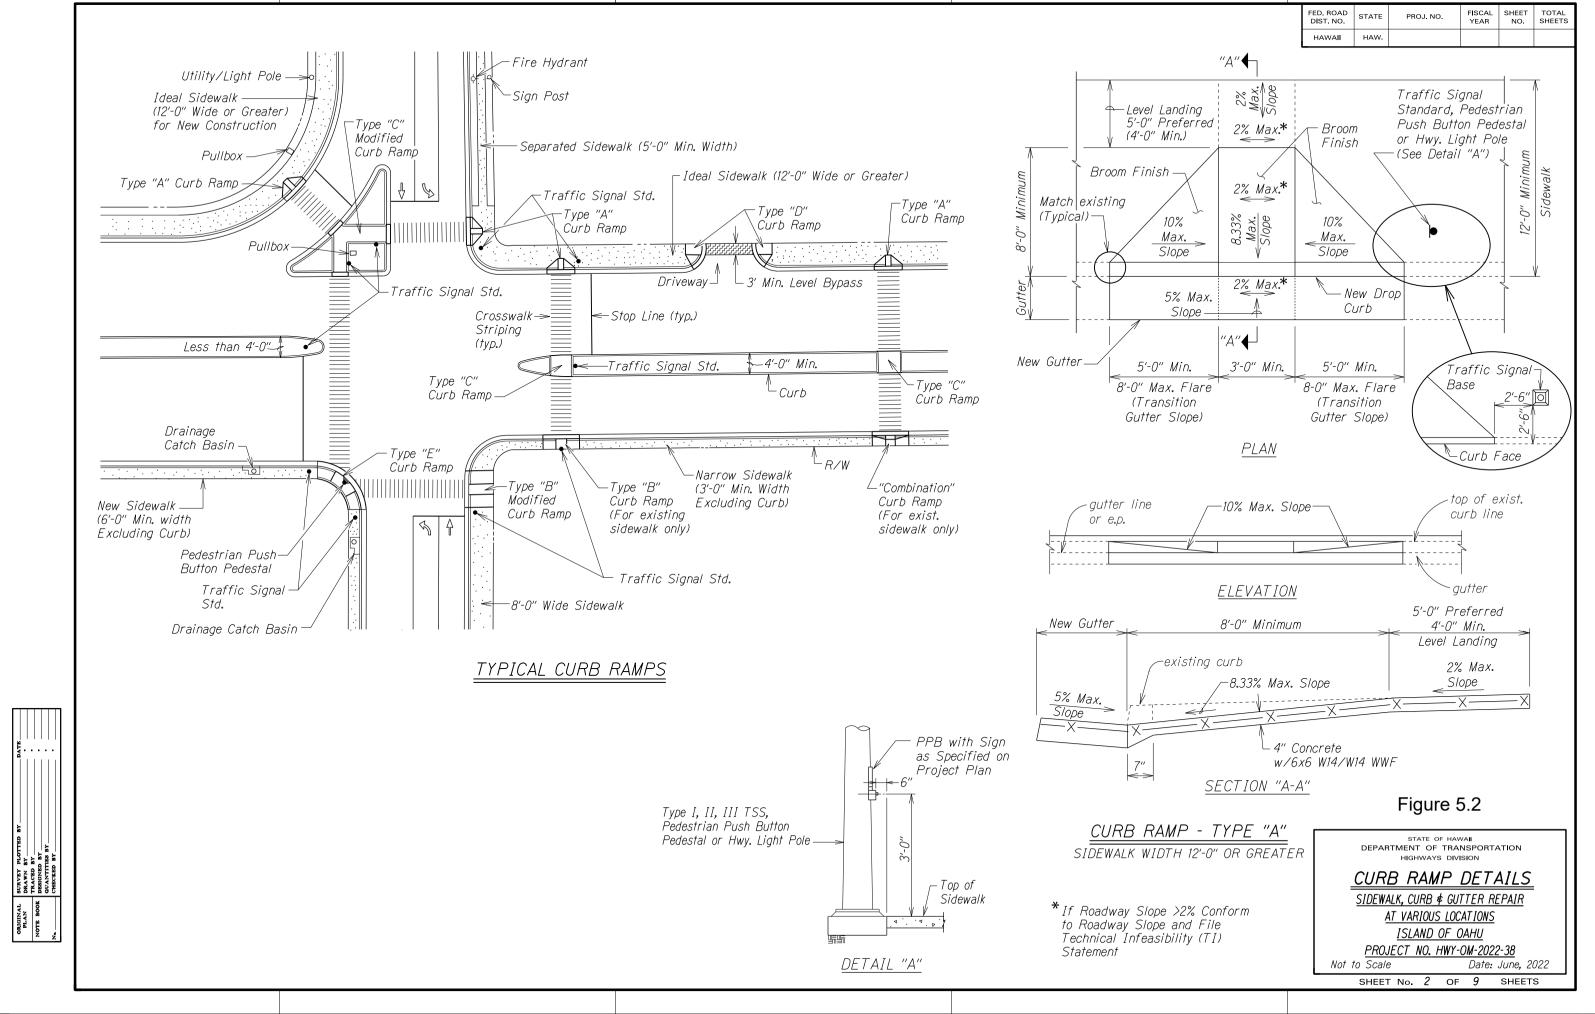

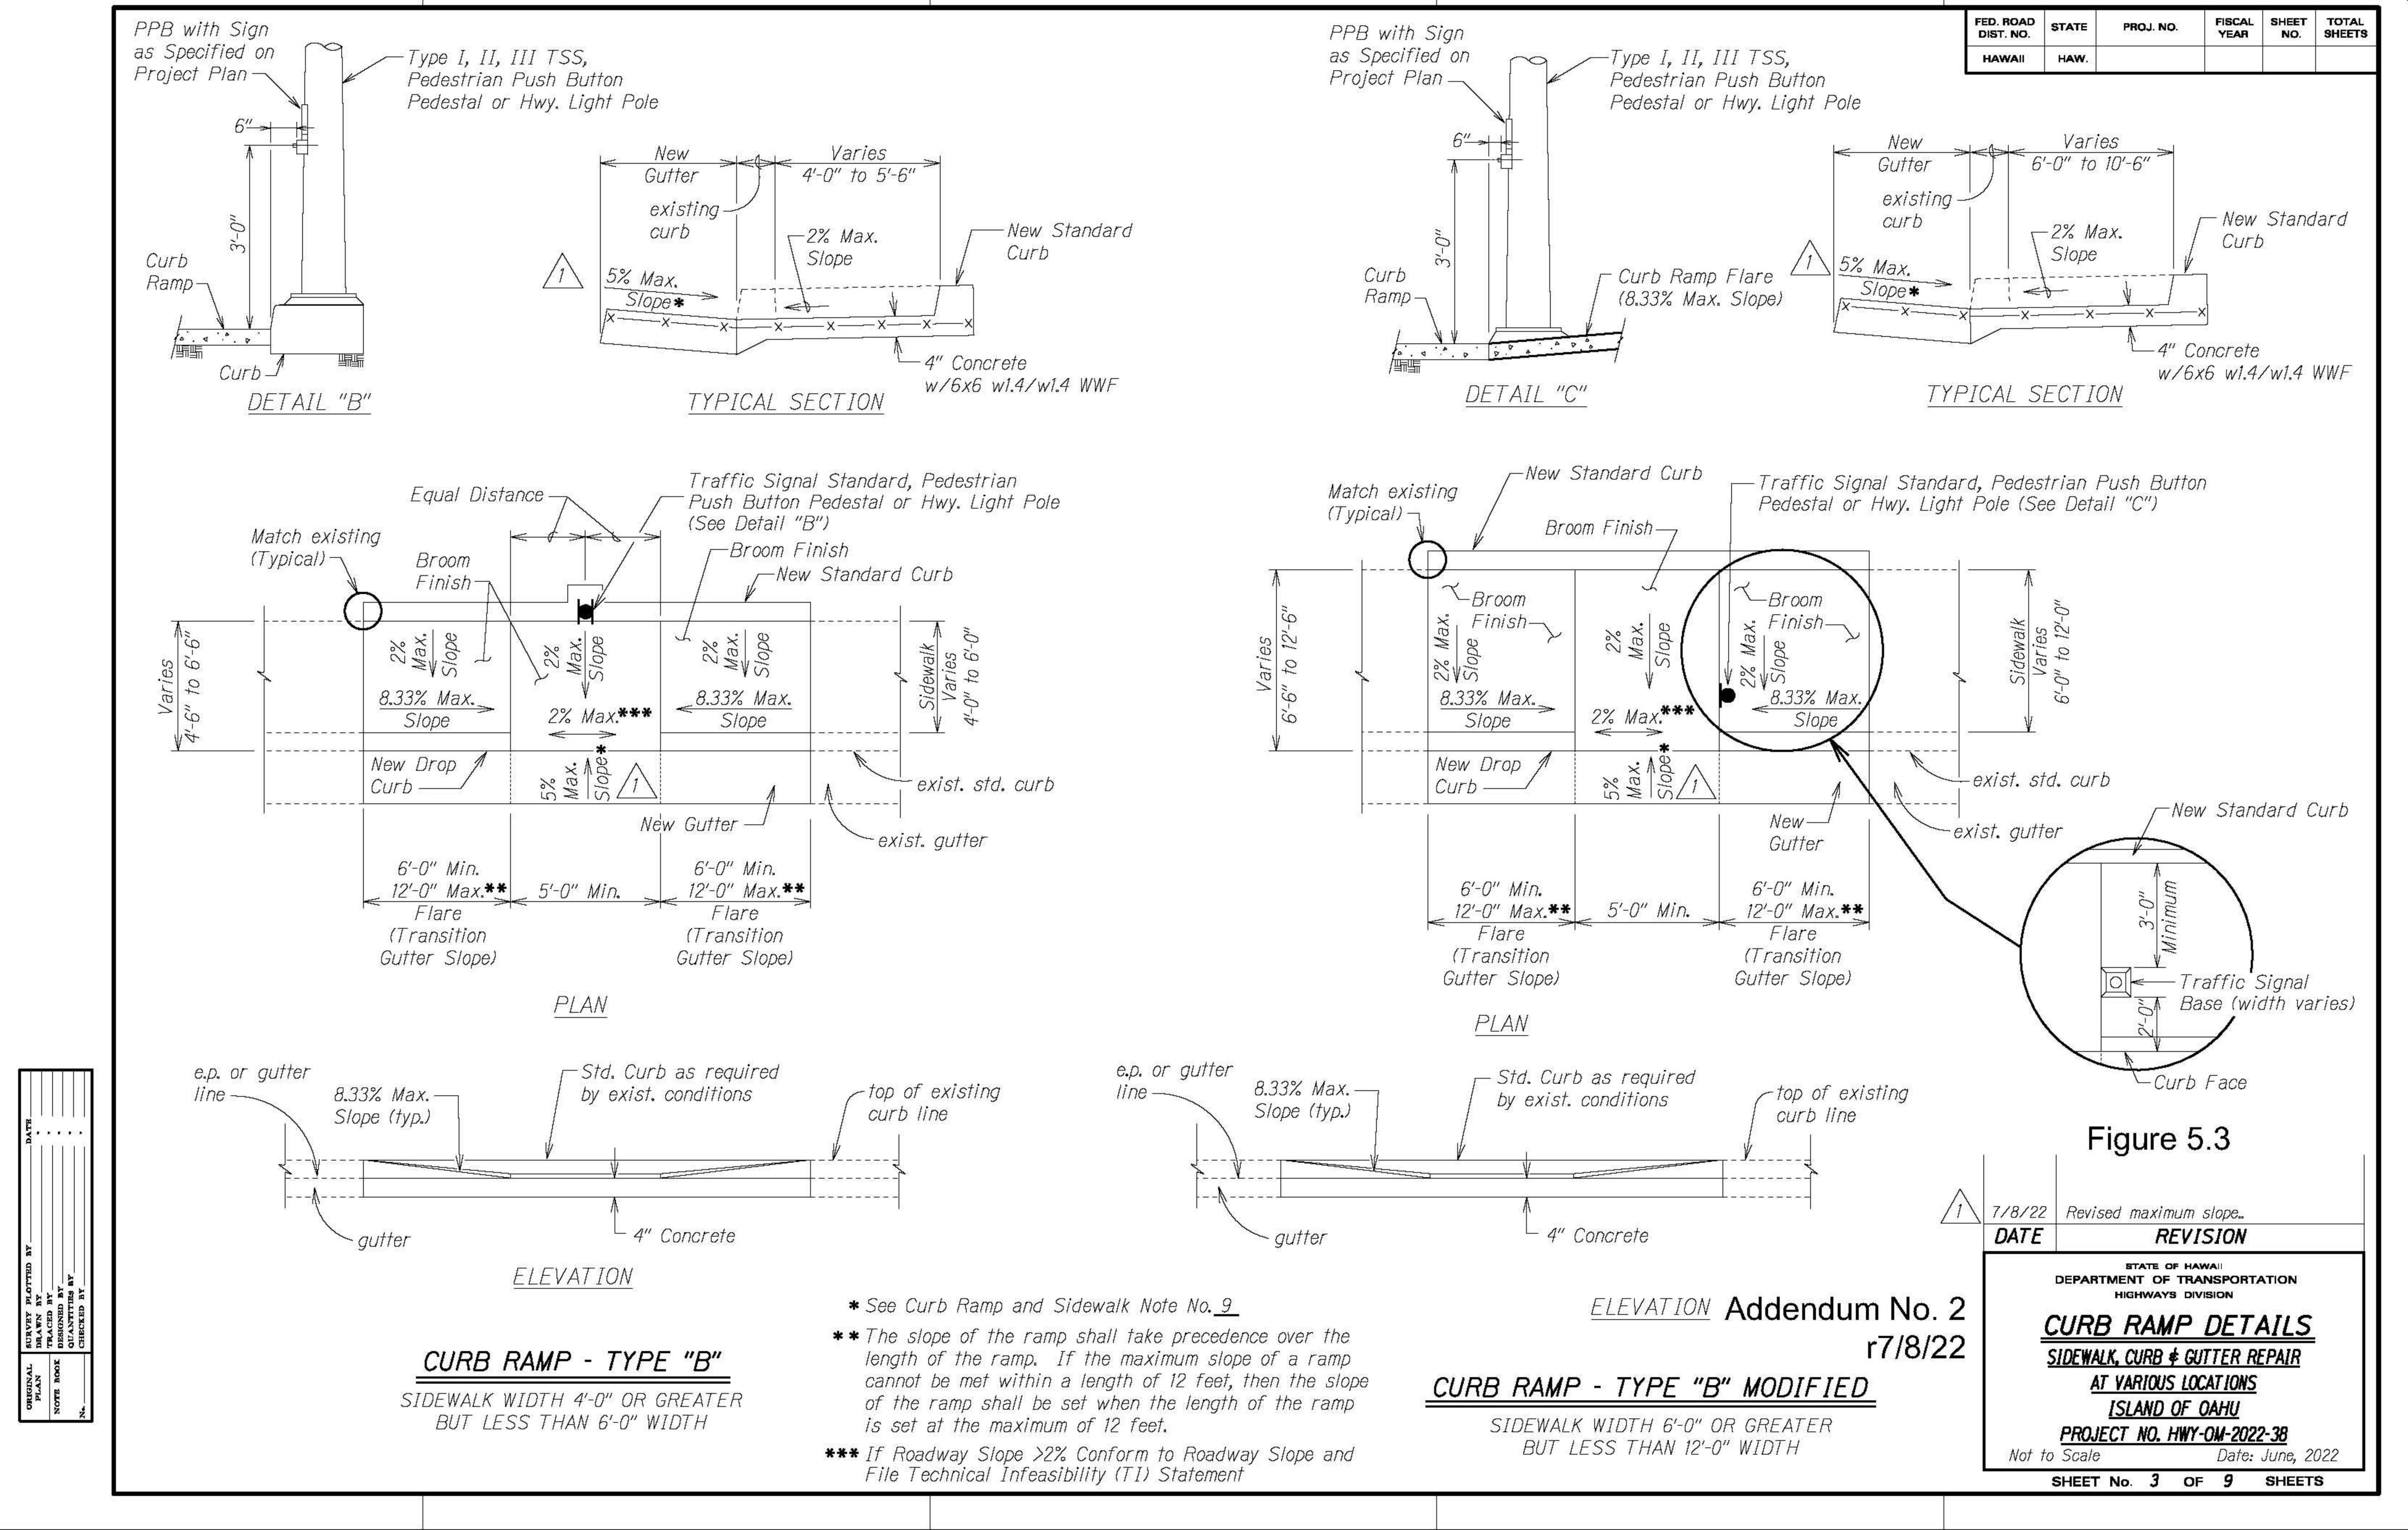


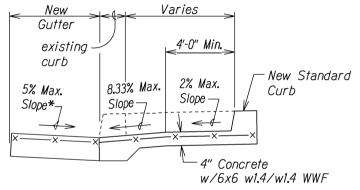

#### TYPICAL SECTION

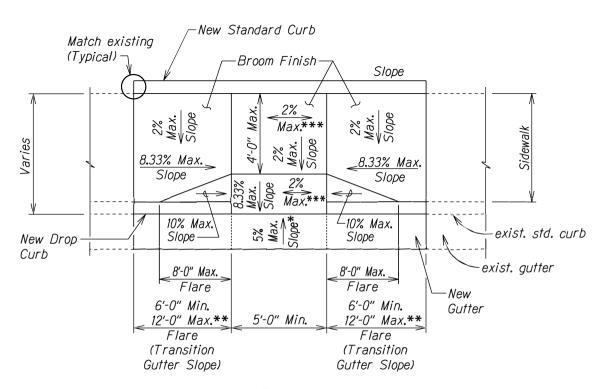

#### PLAN

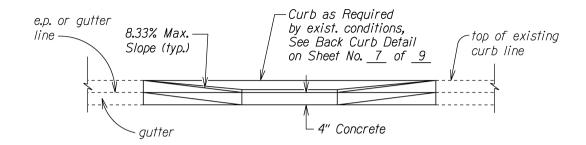

#### ELEVATION

#### CURB RAMP - COMBINATION

- \* See Curb Ramp and Sidewalk Note No. 9.
- \*\* The slope of the ramp shall take precedence over the length of the ramp. If the maximum slope of a ramp cannot be met within a length of 12 feet, then the slope of the ramp shall be set when the length of the ramp is set at the maximum of 12 feet.
- \*\*\* If Roadway Slope >2% Conform to Roadway Slope and File a Technical Infeasibility (TI) Statement

Figure 5.4

STATE OF HAWAII
DEPARTMENT OF TRANSPORTATION
HIGHWAYS DIVISION

### CURB RAMP DETAILS SIDEWALK, CURB & GUTTER REPAIR


AT VARIOUS LOCATIONS


ISLAND OF OAHU


PROJECT NO. HWY-OM-2022-38

Not to Scale Date: June, 2022

SHEET No. 4 OF 9 SHEETS

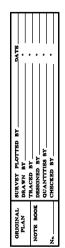

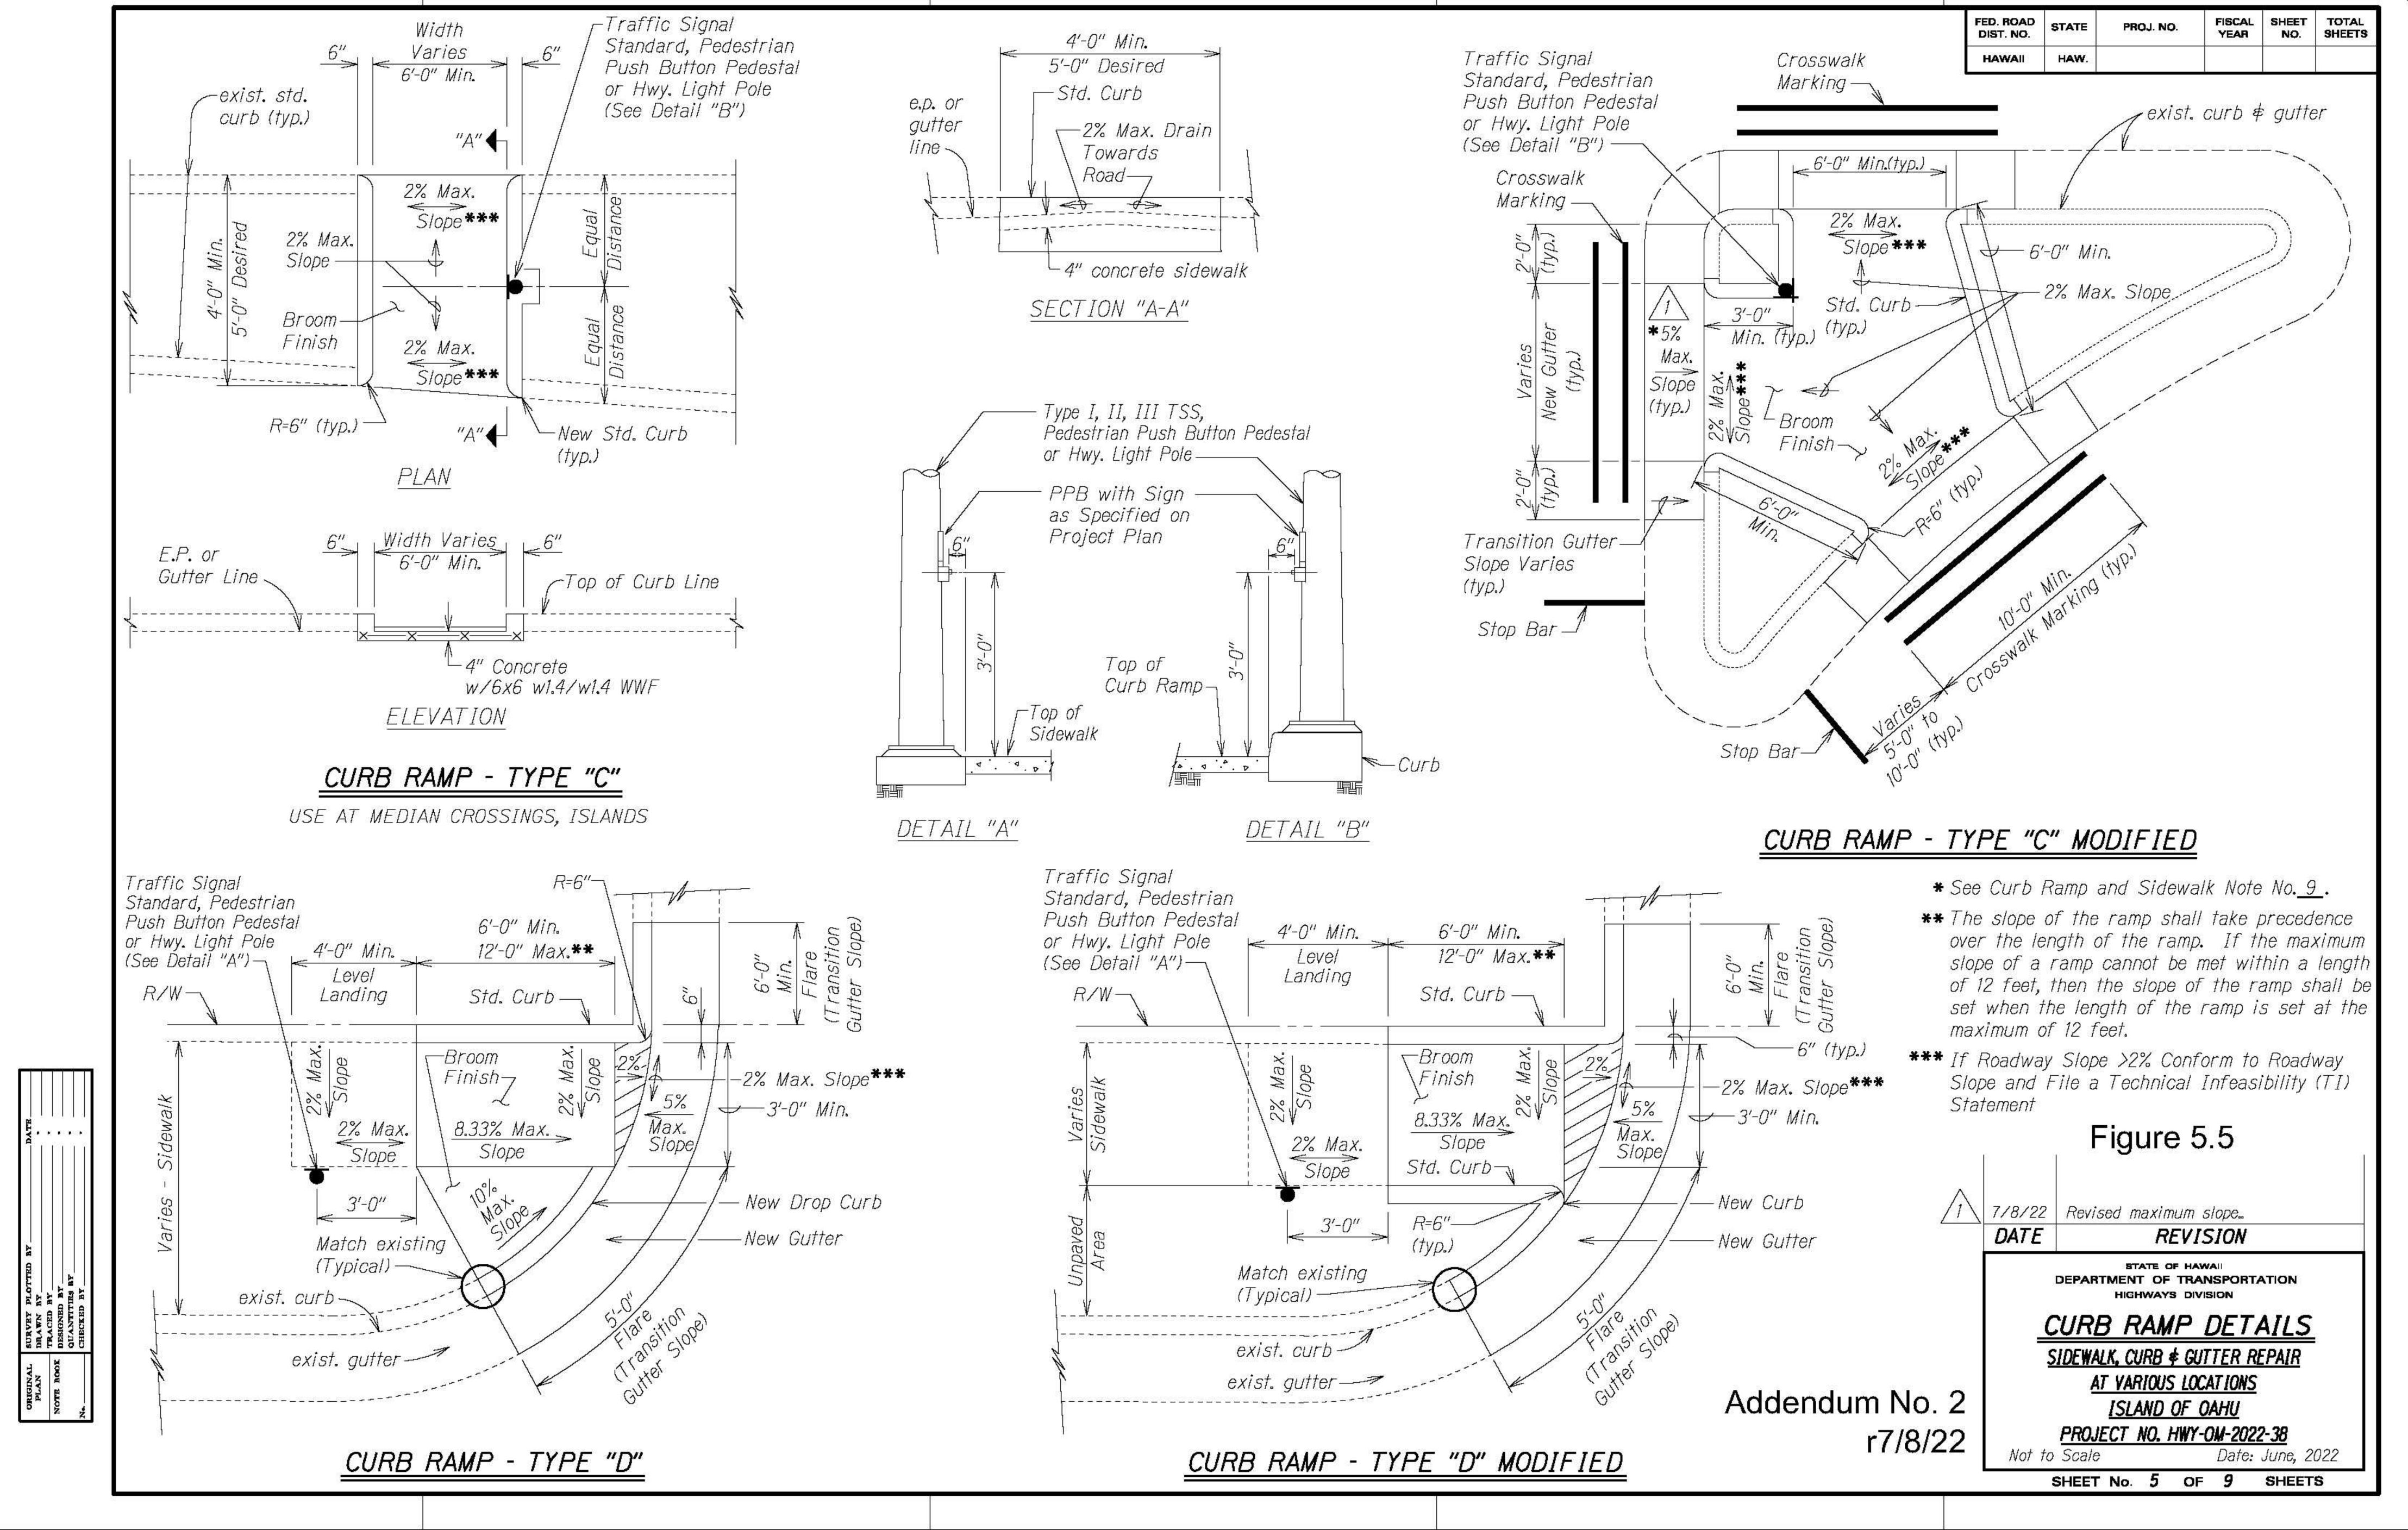

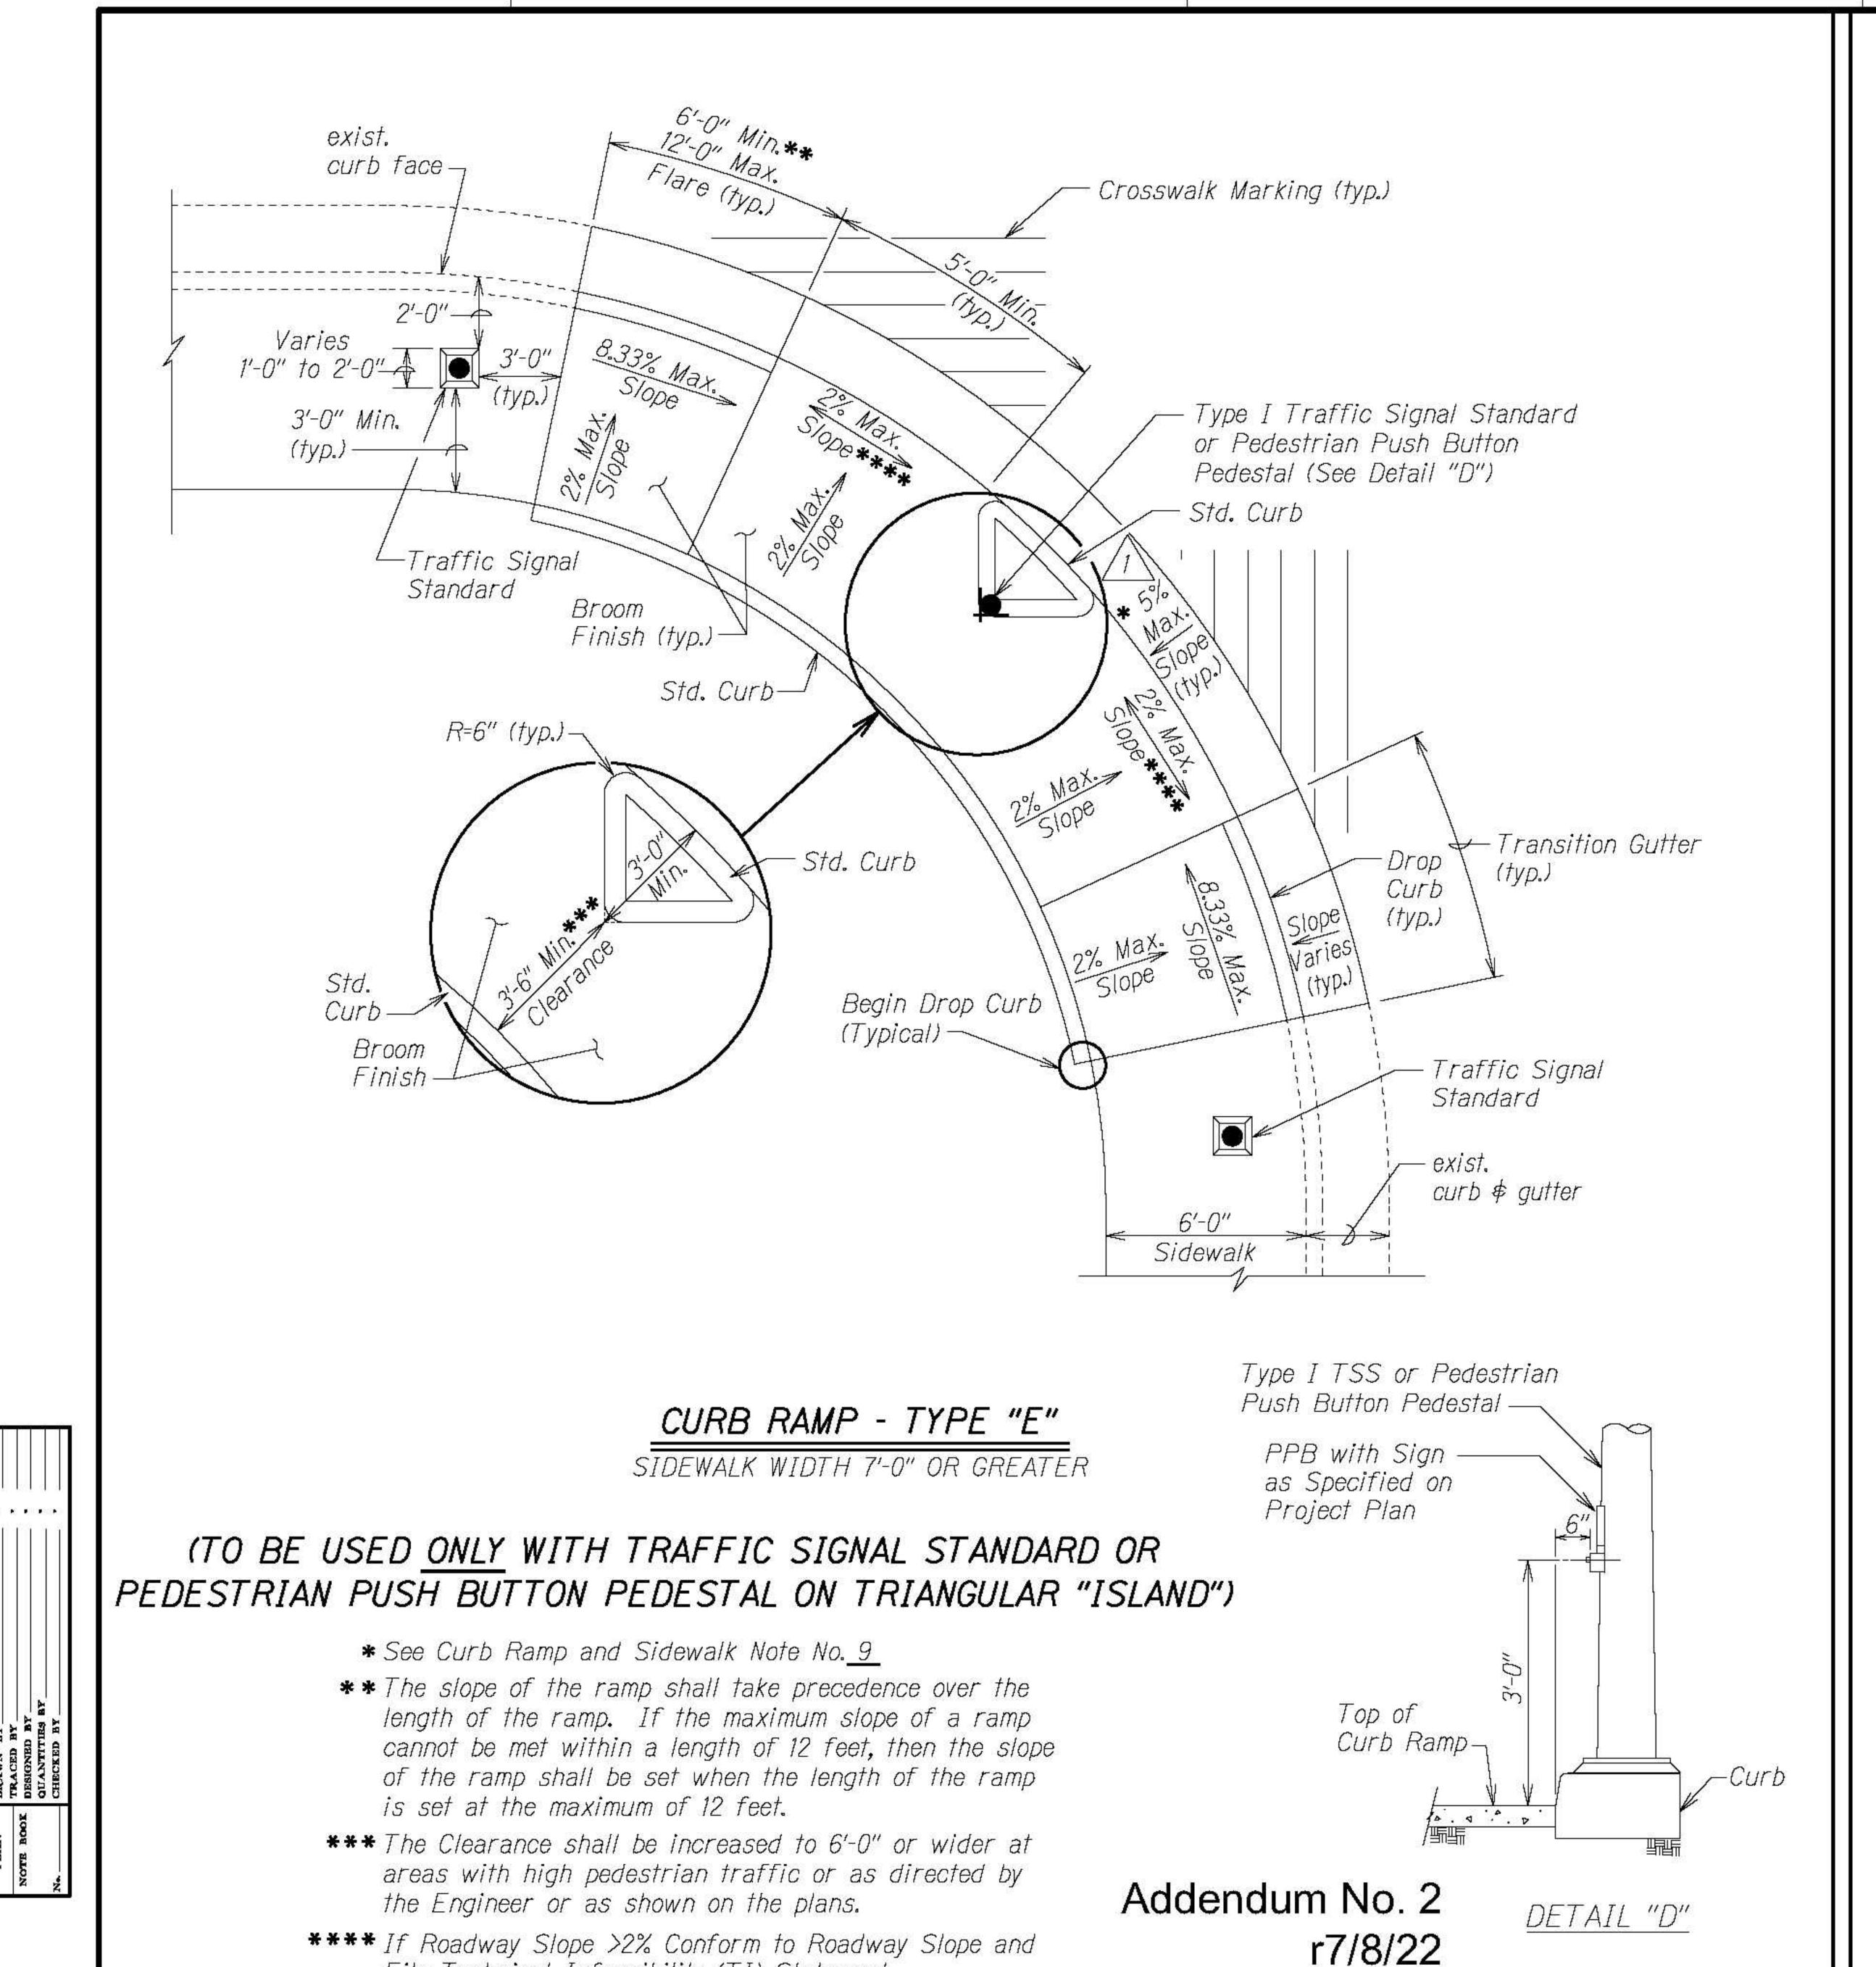

File Technical Infeasibility (TI) Statement

FISCAL YEAR HAW. HAWAII Curb return type driveway may be Provide keyed joints both sides. (See Detail "A" for permitted for parking areas exceeding 100 spaces, fire stations and hospitals. new construction). Warp lines -(No scoring) A--Scare lines for monalithic Score lines to be construction of curb and Standard conc. Standard conc. Standard conc. spaced equally driveway apron. drop curb driveway curb drop curb maximum spacing 4'-0" Limits of reinforcement. 4" thick concrete reinforced PLAN with 6"x6"-W2.9XW2.9 galv. welded wire fabric for residential districts. 6" thick for all other districts. NOT TO SCALE Surface shall be broom finished. Variable Standard conc. Standard conc. Property Standard conc. Line grade driveway curb drop curb drop curb **ELEVATION** NOT TO SCALE \* Match width of existing sidewalk whenever possible. \*\* Breakover and departure angles should not exceed 10 degrees or 17%. Length Varies 3'-0" Min.\* Accessible Route Std. conc. DETAIL "A" driveway 2% Max. NOT TO SCALE slab — (NEW CONSTRUCTION) See Sect. A-A 4" conc. slab with 6"x6"-W2.9XW2.9 galv. mesh for residential districts. See Alternate Detail -6" conc. slab with 6"x6"-W2.9XW2.9 for monolithic construction mesh for all other districts. of curb and driveway apron

FED. ROAD

STATE

PROJ. NO.

SHEETS

SECTION A-A

NOT TO SCALE

ALTERNATE DETAIL NOT TO SCALE

# DRIVEWAY APRON

Figure 5.6

1. For extension to existing driveway, scoring and finish shall match existing scoring and finish. For driveway constructed in built up areas, scoring conforming to scoring at adjacent driveways may be authorized.

REVISION

2. This detail is only one method for providing ADA access. Other methods can be used. These methods are shown in references listed in Curb Ramp and Sidewalk Note No. 21.

> 7/8/22 Revised maximum slope. DATE

CURB RAMP DETAILS SIDEWALK, CURB # GUTTER REPAIR AT VARIOUS LOCATIONS


STATE OF HAWAII DEPARTMENT OF TRANSPORTATION


HIGHWAYS DIVISION

ISLAND OF OAHU PROJECT NO. HWY-OM-2022-38

Not to Scale

Date: June, 2022 SHEET No. 6 OF 9 SHEETS

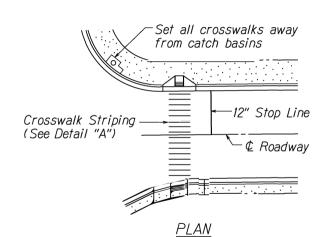


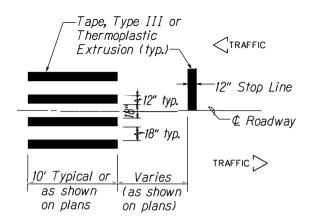


<u>DETAIL "A"</u>


CROSSWALK STRIPING DETAIL

<u>NOTE:</u> Longitudinal lines shall be parallel to traffic flow.

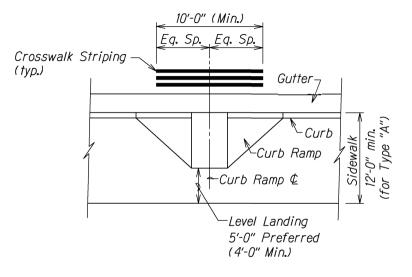


## TYPICAL CROSSWALK STRIPING \_AT CURB RAMP

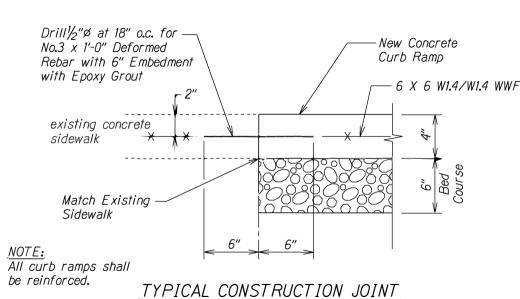

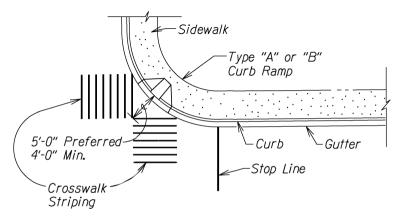

AT EXISTING SIDEWALK

TYPICAL CROSSWALK STRIPING
AT DIAGONAL CURB RAMP

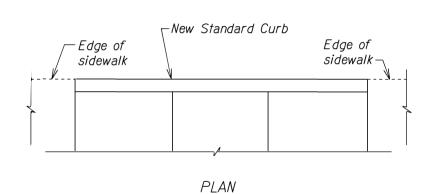

FED. ROAD DIST. NO.


STATE

HAW.

PROJ. NO.

FISCAL YEAR

SHEET NO.

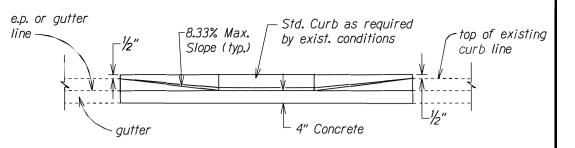

#### ELEVATION

#### DETAIL - BACK CURB

#### *NOTE*:

This detail can be used in situations where the edge of sidewalk cannot be flush with the face of (back) curb due to right of way restrictions.

### Figure 5.7



DEPARTMENT OF TRANSPORTATION
HIGHWAYS DIVISION

MISCELLANEOUS DETAILS


STATE OF HAWAII


SIDEWALK, CURB & GUTTER REPAIR
AT VARIOUS LOCATIONS


<u>ISLAND OF OAHU</u> PROJECT NO. HWY-OM-2022-38


Not to Scale Date: June, 2022

SHEET No. 7 OF 9 SHEETS

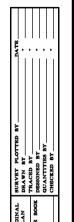

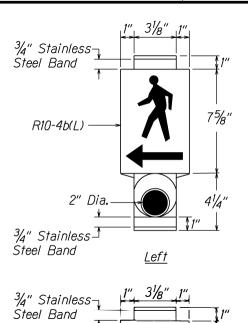


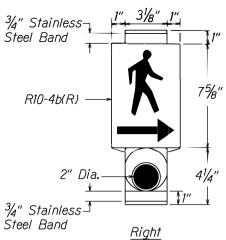

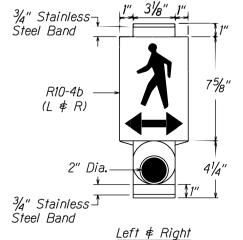

#### PEDESTRIAN PUSH BUTTON WITH SIGN

Background - Black

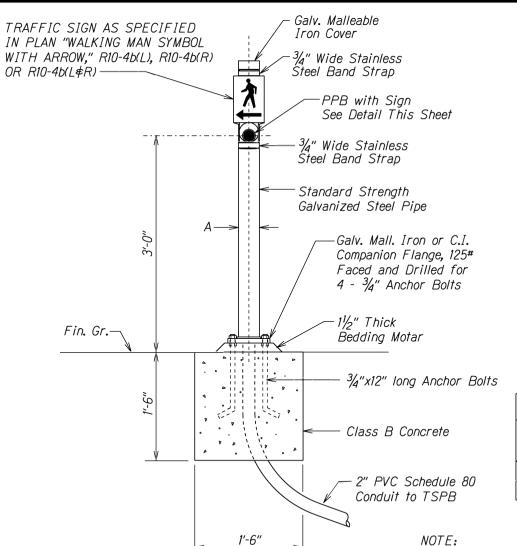

DATA TABLE FOR PPB POST					
AMOUNT OF PPR	DIMENSIONS				
AMOONTOTTIB	Α	В			
1	3½"	8"			
2→3	4½"	9"			

PPB POST AND FOOTING DETAIL


Sauare


- 1. Conduits shall protrude 2" max. above finished surface
- 2. Conduits shall slope away from post foundation.

Max.

#### GENERAL NOTES:

- 1. There shall be a 30" x 48" level ground surface (2% max. cross slope, both directions) for a forward or side approach, as appropriate, to a pedestrian push button. Location of pedestrian push button shall be shown on Civil Plans in addition to Electrical Plans.
- 2. At intersection corners where two pedestrian push buttons are provided, the push buttons should be separated by a distance of at least 10 ft. and located as follows:
  - A. adjacent to a level all-weather surface to provide access from a wheelchair and, where there is an all-weather surface, wheelchair accessible route to the ramp
  - B. within 5 ft. of the crosswalk extended
  - C. within 10 ft. of the edge of the curb, shoulder or pavement
  - D. parallel to the crosswalk to be used

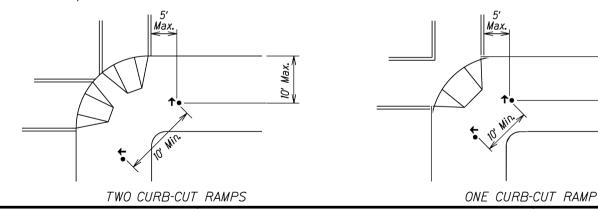

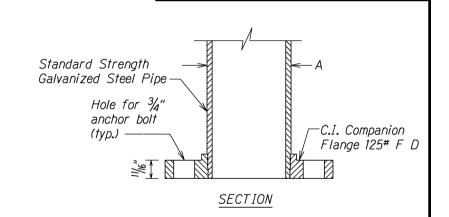


STATE

PROJ. NO.

FISCAL SHEET YEAR NO.

FED. ROAD DIST. NO.

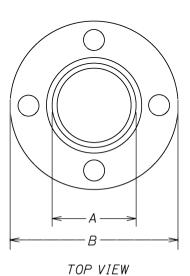

FLANGE DETAIL

Figure 5.8

DEPARTMENT OF TRANSPORTATION


#### PEDESTRIAN PUSH BUTTON DETAILS

SIDEWALK, CURB & GUTTER REPAIR AT VARIOUS LOCATIONS ISLAND OF OAHU PROJECT NO. HWY-OM-2022-38


Date: June, 2022 Scale: Not to scale

> SHEET No. 8 OF 9 SHEETS




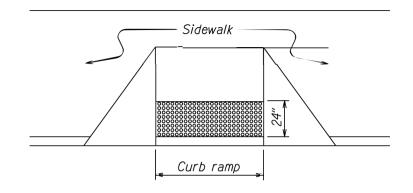

#### DETECTABLE WARNING AT CURB RAMP

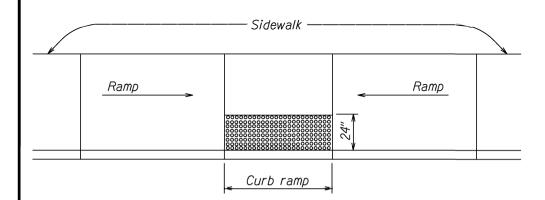

TRANSITION RAMP WITH DETECTABLE WARNING

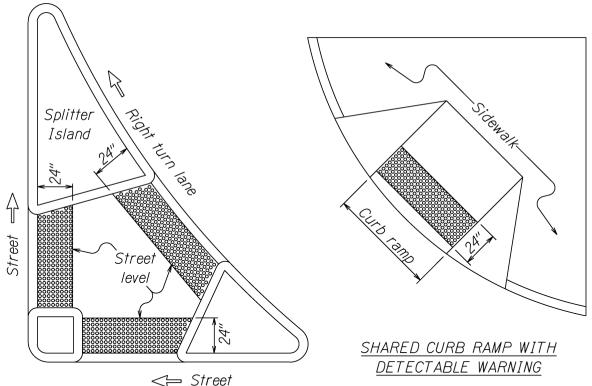

Sidewalk Level Landing

SHEET NO.

FED. ROAD DIST. NO.

STATE

PROJ. NO.

END OF SIDEWALK CURB RAMP WITH DETECTABLE WARNING

(Street level)

#### TYPICAL INSTALLATION OF DETECTABLE WARNINGS


REFUGE ISLAND WITH

DETECTABLE WARNING

Not to Scale

#### NOTES:


- 1. Detectable warnings shall be 24 inches in the direction of travel and extend the full width of the curb ramp or flush surface (does not include flares).
- 2. Truncated domes shall have a diameter of 0.9 to 1.4 inch at the bottom, a diameter of 50%-65% of the base diameter at the top, a height of 0.2 inch and a center-to-center spacing of 1.6 to 2.4 inches measured along one side of a square arrangement.
- 3. Domes shall be aligned on a square grid in the predominant direction of travel to permit wheels to roll between the domes.
- 4. There shall be a minimum of 70 percent contrast in light reflectance between the detectable warning and an adjoining surface, or the detectable warning shall be "safety yellow".
- 5. The material used to provide visual contrast shall be an integral part of the detectable warning surface.
- 6. The detectable warning shall be located so that the edge nearest the curb line or other potential hazard is 6 to 8 inches from the curb line.

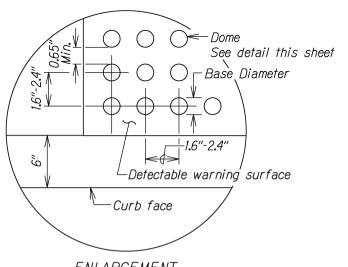

ENLARGEMENT

DETECTABLE WARNING DETAIL

Not to Scale

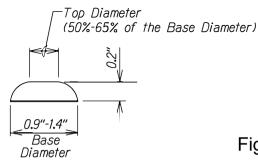

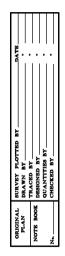


Figure 5.9 DOME SECTION STATE OF HAWAII
DEPARTMENT OF TRANSPORTATION DETECTABLE WARNING DETAILS SIDEWALK, CURB & GUTTER REPAIR AT VARIOUS LOCATIONS ISLAND OF OAHU PROJECT NO. HWY-OM-2022-38 Scale: XX Date: June, 2022 SHEET No. 9 OF 9 SHEETS