
GENERAL MECHANICAL NOTES:

- 1. CONTRACTOR SHALL VISIT THE JOB SITE TO VERIFY ALL EXISTING FIELD CONDITIONS, DIMENSIONS AND OBSTRUCTIONS.
- 2. THE CONTRACTOR SHALL COORDINATE ALL WORK WITH ALL OTHER TRADES. THE CONTRACTOR SHALL NOTIFY THE ENGINEER OF ANY DISCREPANCIES IN THE DRAWINGS (MECHANICAL, STRUCTURAL, ELECTRICAL, OR ARCHITECTURAL) IMMEDIATELY BEFORE PROCEEDING WITH ANY FURTHER WORK, OTHERWISE THE CONTRACTOR SHALL BE HELD RESPONSIBLE FOR ALL COST INVOLVED IN THE CORRECTION OF THE CONSTRUCTION INSTALLATION.
- 3. THE CONTRACTOR SHALL VERIFY THAT THERE ARE NO UTILITIES PRESENT BEFORE DEMOLITION OF ANY SORT SHOULD ANY UTILITIES BE DAMAGED IN THE PROCESS OF DEMOLITION, THE CONTRACTOR SHALL REPAIR THE UTILITIES AT NO COST TO THE STATE. ANY CLAIMS FILED DUE TO THE DISRUPTION OF THE UTILITY SERVICE SHALL BE THE SOLE RESPONSIBILITY OF THE CONTRACTOR.
- 4. ALL WORK SHALL BE NEW UNLESS OTHERWISE NOTED AS EXISTING.
- 5. PROVIDE SEALANT AND FIRE STOPS FOR ALL PIPE, DUCT, CONDUIT, ETC. PENETRATIONS THROUGH FLOORS, WALLS, STRUCTURAL MEMBERS, ETC. THE SEALS SHALL HAVE A FIRE RATING GREATER THAN OR EQUAL TO THE FIRE RATING OF THE WALL, FLOOR AND ENCLOSURE.
- 6. ALL PLUMBING FIXTURES SHALL CONFORM TO UPC SECTION 402 WATER CONSERVATION AND UPC CHAPTER 6.
- PROVIDE 1/4" MESH SS SCREENS AND SS DRAWBANDS FOR VTR'S.
- PROVIDE ACCESS PANELS FOR ALL CLEANOUTS, SHUTOFF VALVES LOCATED IN THE WALLS AND CEILINGS.
- 9. ADJUST FIXTURE HEIGHTS AND ROUGH—INS AS REQUIRED TO MAINTAIN FIXTURE CLEARANCES, ETC. CONFORMING TO ADAAG STANDARDS.
- 10. INSULATE ALL WASTE AND VENT PIPING CARRYING CONDENSATE WITH VAPOR BARRIER AND 1" THICK FIBERGLASS INSULATION. THE PIPING SHALL BE INSULATED UP TO THE NEXT FIXTURE CONNECTION.
- 11. PROVIDE 1/4" STAINLESS STEEL SCREENS FOR ALL FLOORS DRAINS AND CONNECTIONS WHICH ACCEPT PROCESS/WASHDOWN WASTEWATER
- 12. ALL HOLES IN CONCRETE SHALL BE SAW CUT OR CORE DRILLED.

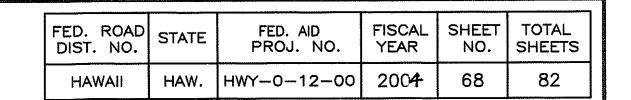

LEGEND & ABBREVIATIONS

SYMBOL	ABBREV	DESCRIPTION	SYMBOL	ABBREV	DESCRIPTION
	ACCU	AIR COOLED COND UNIT		SS	STAINLESS STEEL
	FCU	FAN COIL UNIT		STRUCT	STRUCTURAL
	ARCH	ARCHITECT		TYP	TYPICAL
	CFM	CUBIC FEET PER MINUTE		UR	URINAL
	CLG	CEILING	<i>VD</i> ∟	VD	VOLUME DAMPER
	CONN	CONNECT		VTR	VENT THRU ROOF
	COTG	CLEAN OUT TO GRADE		WC	WATER CLOSET
	DWG	DRAWING	T	T'STAT	THERMOSTAT
	ELEC	ELECTRICAL		NC	NORMALLY CLOSED
	EXIST	EXISTING			
	EXT	EXTERIOR		RL	REFRIGERANT LIQUID PIPE
	FCO	FLOOR CLEANOUT		RS	REFRIGERANT SUCTION PIPE
	FD	FLOOR DRAIN		CW	COLD WATER PIPING
	FLR	FLOOR		HW	HOT WATER PIPING
	FS	FLOOR SINK		S	SANITARY PIPING
	HB	HOSE BIBB		V	VENT PIPING
	LAV	LAVATORY		CW	EXISTING COLD WATER
	MECH	MECHANICAL			PIPING TO REMAIN
	SHT	SHEET			EXISTING SANITARY PIPING
	S/S	SERVICE SINK			TO REMAIN

REVISED ORDINANCES OF HONOLULU COUNTY CHAPTER 32 BUILDING ENERGY EFFICIENT STANDARDS

THE BUILDING ENERGY EFFICIENT STANDARDS HAVE BEEN REVIEWED AND TO THE BEST OF MY KNOWLEDGE THIS DESIGN SUBSTANTIALLY CONFORMS TO THESE STANDARDS.



KEVIN K. KATAYAMA

NAME (PRINT)

MECHANICAL ENGINEER TITLE (ARCHITECT, ME, EE) 7913-M

ARCH. OR PE LICENSE NO.





THIS WORK WAS PREPARED BY ME OR UNDER MY SUPERVISION


STATE OF HAWAII DEPARTMENT OF TRANSPORTATION HIGHWAYS DIVISION


GENERAL MECHANICAL NOTES LEGEND & ABBREVIATIONS

WAHIAWA BASEYARD **IMPROVEMENTS** Project No. HWY-0-12-00


Scale: AS SHOWN

Date: *JAN. 2003* SHEET No. M1.00 OF 82 SHEETS

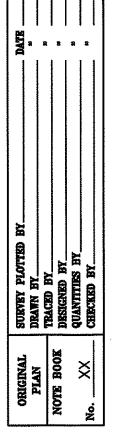

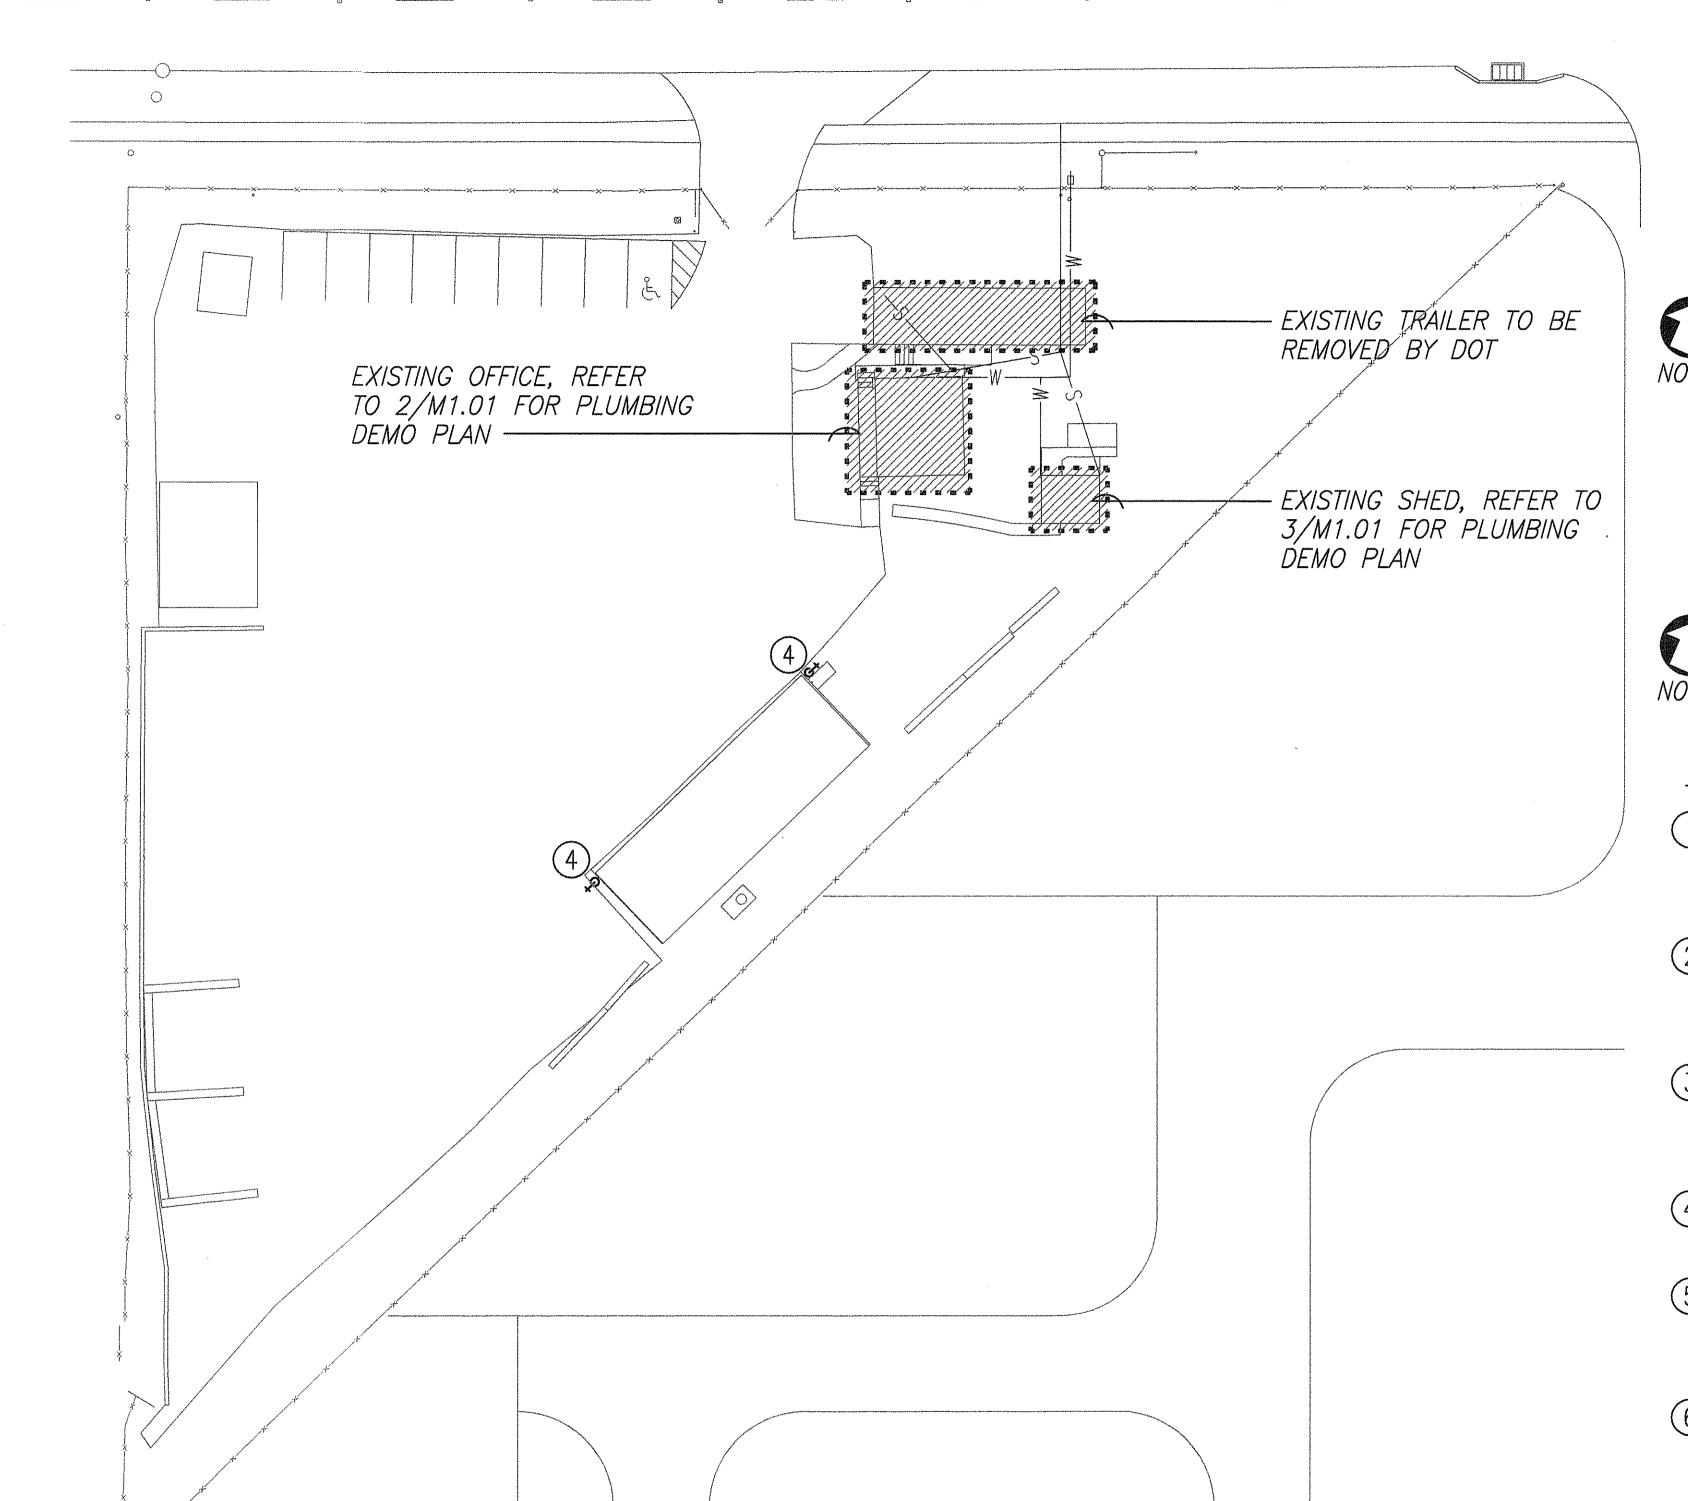

MECHANICAL EX-SITE DEMOLITION PLAN (1)

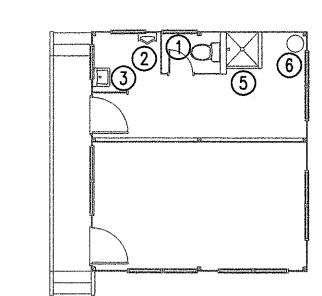


FISCAL SHEET TOTAL YEAR NO. SHEETS FED. AID PROJ. NO. HAW. HWY-0-12-00 2004

Scale: 1/8"=1'-0"

M1.01 M1.01

NORTH

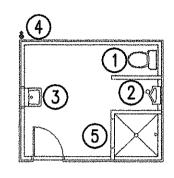

Scale: 1/8"=1'-0"

DEMOLITION NOTES:

- (1) REMOVE COMPLETE WATER CLOSET, CW SUPPLY STOP AND ALL CW, VENT AND SEWER PIPING ABOVE GRADE. CUT, CAP AND ABANDON EXISTING CW SEWER AND VENT PIPING BELOW GRADE.
- (2) REMOVE COMPLETE URINAL, CW SUPPLY STOP AND ALL CW, VENT AND SEWER PIPING ABOVE GRADE. CUT, CAP AND ABANDON EXISTING CW SEWER AND VENT PIPING BELOW GRADE.
- (3) REMOVE COMPLETE LAVATORY, DRAIN ASSEMBLY, CW SUPPLY STOP AND ALL CW, SEWER AND VENT PIPING ABOVE GRADE. CUT, CAP AND ABANDON EXISTING CW, SEWER AND VENT PIPING BELOW GRADE.
- (4) REMOVE COMPLETE HOSE BIBB, AND ALL CW PIPING ABOVE GRADE. CUT, CAP AND ABANDON ALL PIPING BELOW GRADE.
- (5) REMOVE COMPLETE SHOWER DRAIN, CAP AND ABANDON EXISTING SEWER AND VENT PIPING BELOW GRADE. REMOVE COMPLETE SHOWER TRIM INCLUDING ALL EXPOSED CW AND HW PIPING. CUT, CAP AND ABANDON PIPING BELOW GRADE.
- (6) REMOVE COMPLETE ELECTRIC WATER HEATER IN REUSABLE CONDITION AND RETURN TO DEPARTMENT OF TRANSPORTATION. REMOVE ALL PIPING AND VALVES COMPLETELY. CUT, CAP AND ABANDON ALL PIPING BELOW GRADE.
- (7) REMOVE ALL ABANDONED PIPING THAT WILL INTERFERE WITH THE INSTALLATION OF NEW PIPING.



HIGHWAYS DIVISION DEMOLITION PLANS DEMOLITION NOTES


DEPARTMENT OF TRANSPORTATION

WAHIAWA BASEYARD <u>IMPROVEMENTS</u> Project No. HWY-0-12-00


Scale: AS SHOWN Date: JAN. 2003

SHEET No. M1.01 OF 82 SHEETS

69

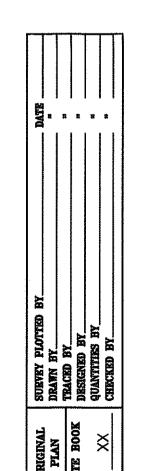

FED. ROAD	STATE	FED. AID	FISCAL	SHEET	TOTAL
DIST. NO.		PROJ. NO.	YEAR	NO.	SHEETS
HAWAII	HAW.	HWY-0-12-00	2004	70	82

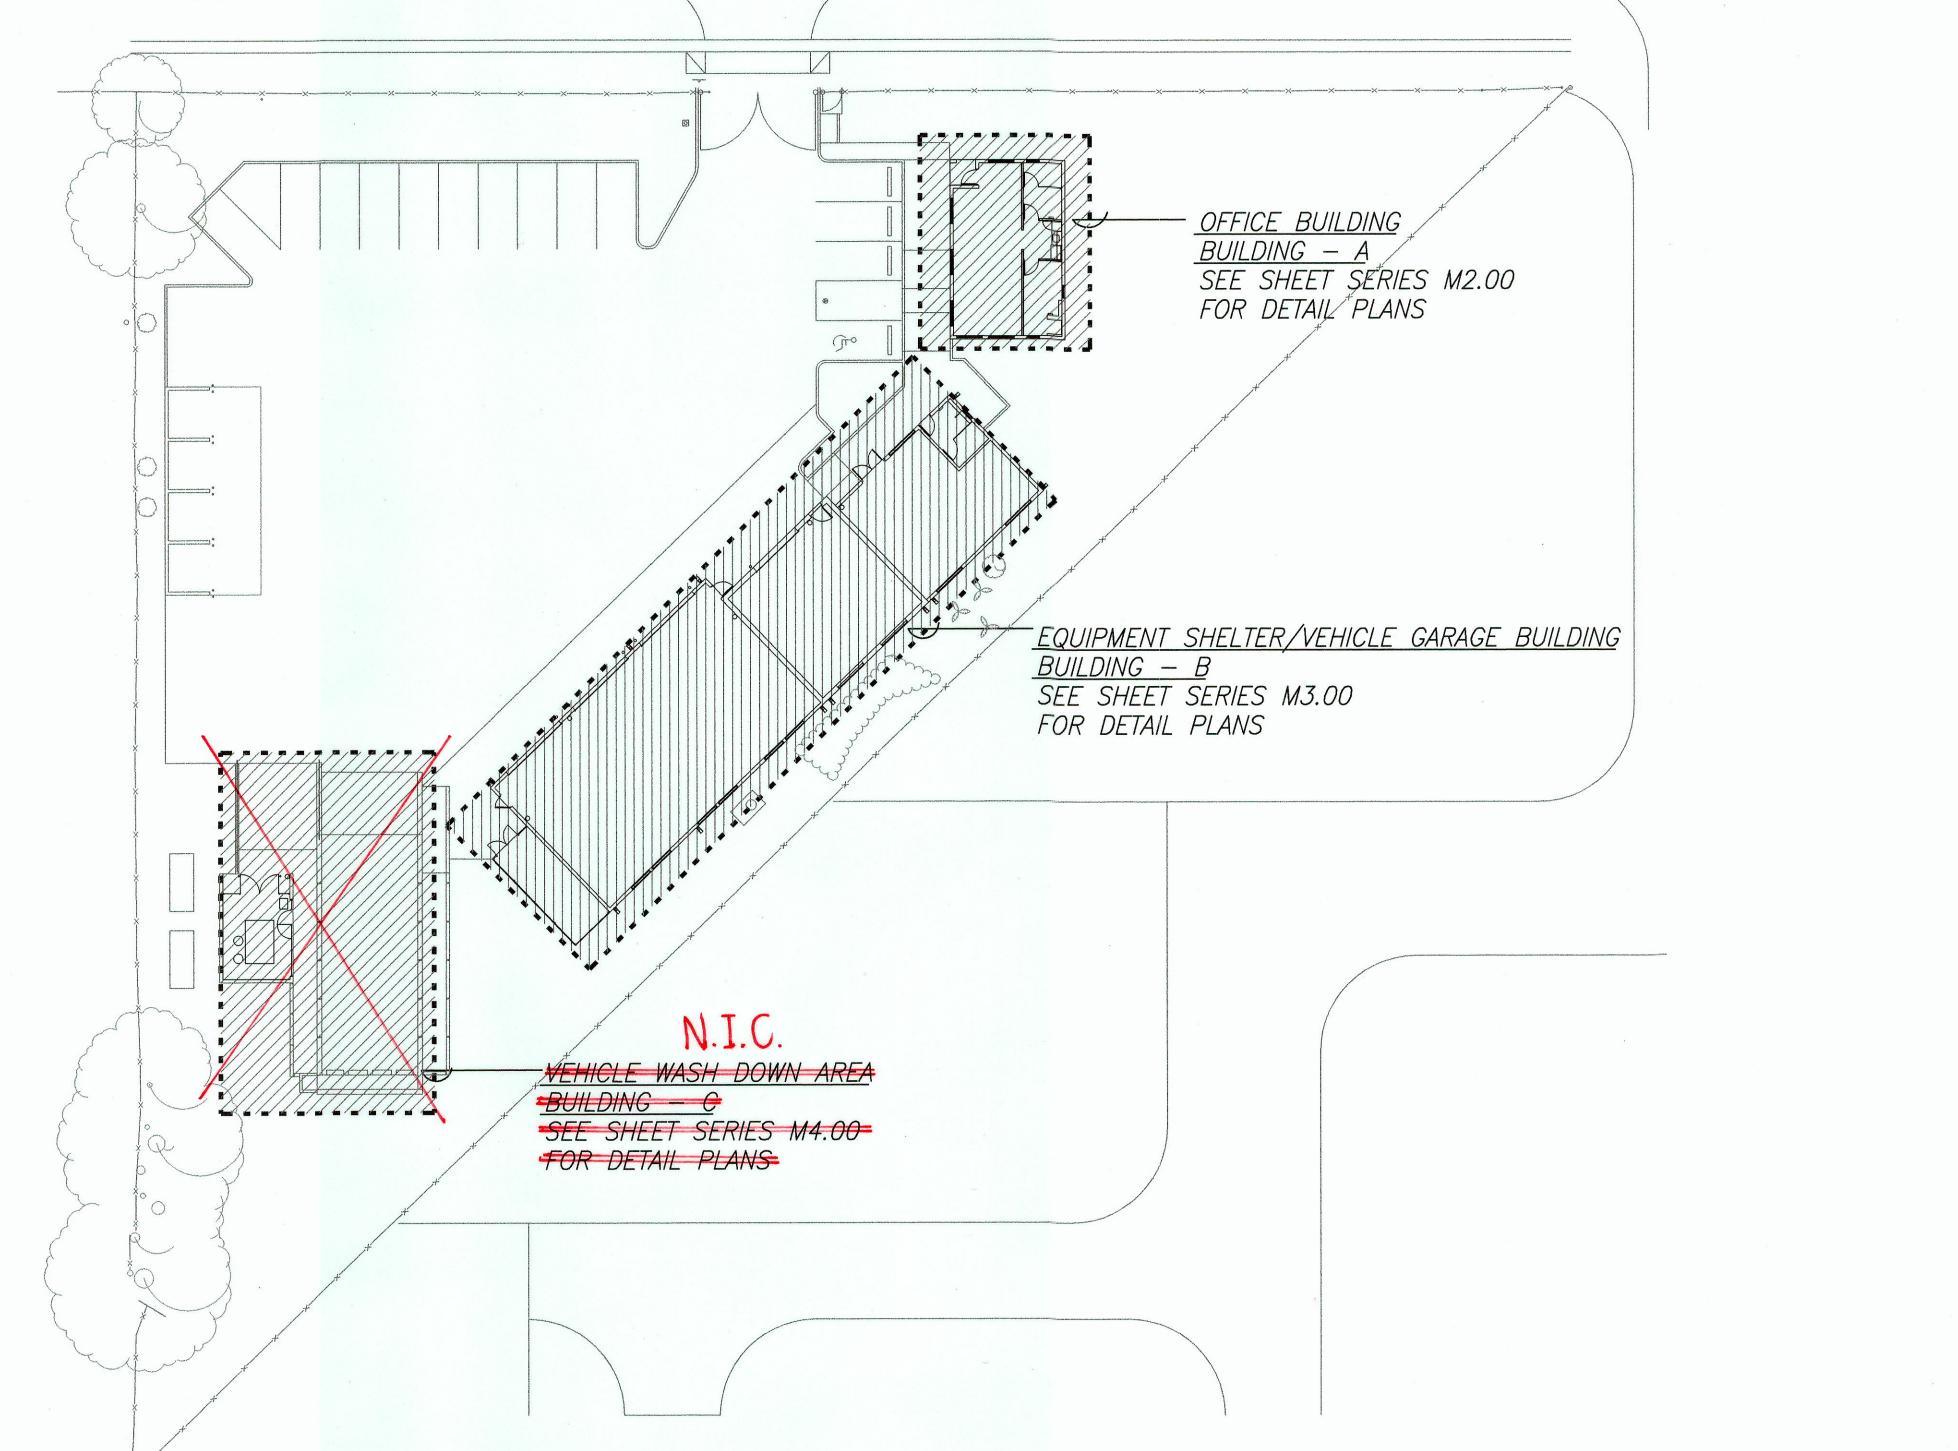

MECHANICAL SITE PLAN 1
Scale: 1"=20'-0" M1.02 M1.02
NORTH

FIXTURE CALCULATION							
FIXTURE TYPE	NO. OF FIXTURES	FIXTURE UNITS PER	TOTAL FIXTURE UNITS				
<u>DEMOLITION</u>							
SHOWER	2	2.0	4.0				
WATER CLOSET	2	3.0	6.0				
URINAL	2	3.0	6.0				
LAV	2	1.0	2.0				
HOSE BIBB (LAST)	1	2.5	2.5				
HOSE BIBB	2	1.0	2.0				
TOTAL			22.5 F.U.				
			37.0 GPM				
<u>NEW</u>			F				
SHOWER	1	1.6	1.6				
WATER CLOSET	2	1.7	3.4				
URINAL	2	1.7	3.4				
LAV	3	.6	1.8				
HOSE BIBB (FIRST)	1	2.5	2.5				
HOSE BIBB	11	1.0	12.0				
SINK	3	1.6	3.2				
EMERG. EYEWASH	2	3.0	6.0				
ICE MAKER	1	1.0	1.0				
TOTAL			34.9 F.U.				
		·	44.0 GPM				



STATE OF HAWAII DEPARTMENT OF TRANSPORTATION HIGHWAYS DIVISION MECHANICAL SITE PLAN FIXTURE CALCULATIONS

<u>WAHIAWA BASEYARD</u>


<u>IMPROVEMENTS</u>


<u>Project No. HWY-0-12-00</u>

Scale: AS SHOWN Date: *JAN. 2003*



SHEET No. M1.02 OF 82 SHEETS

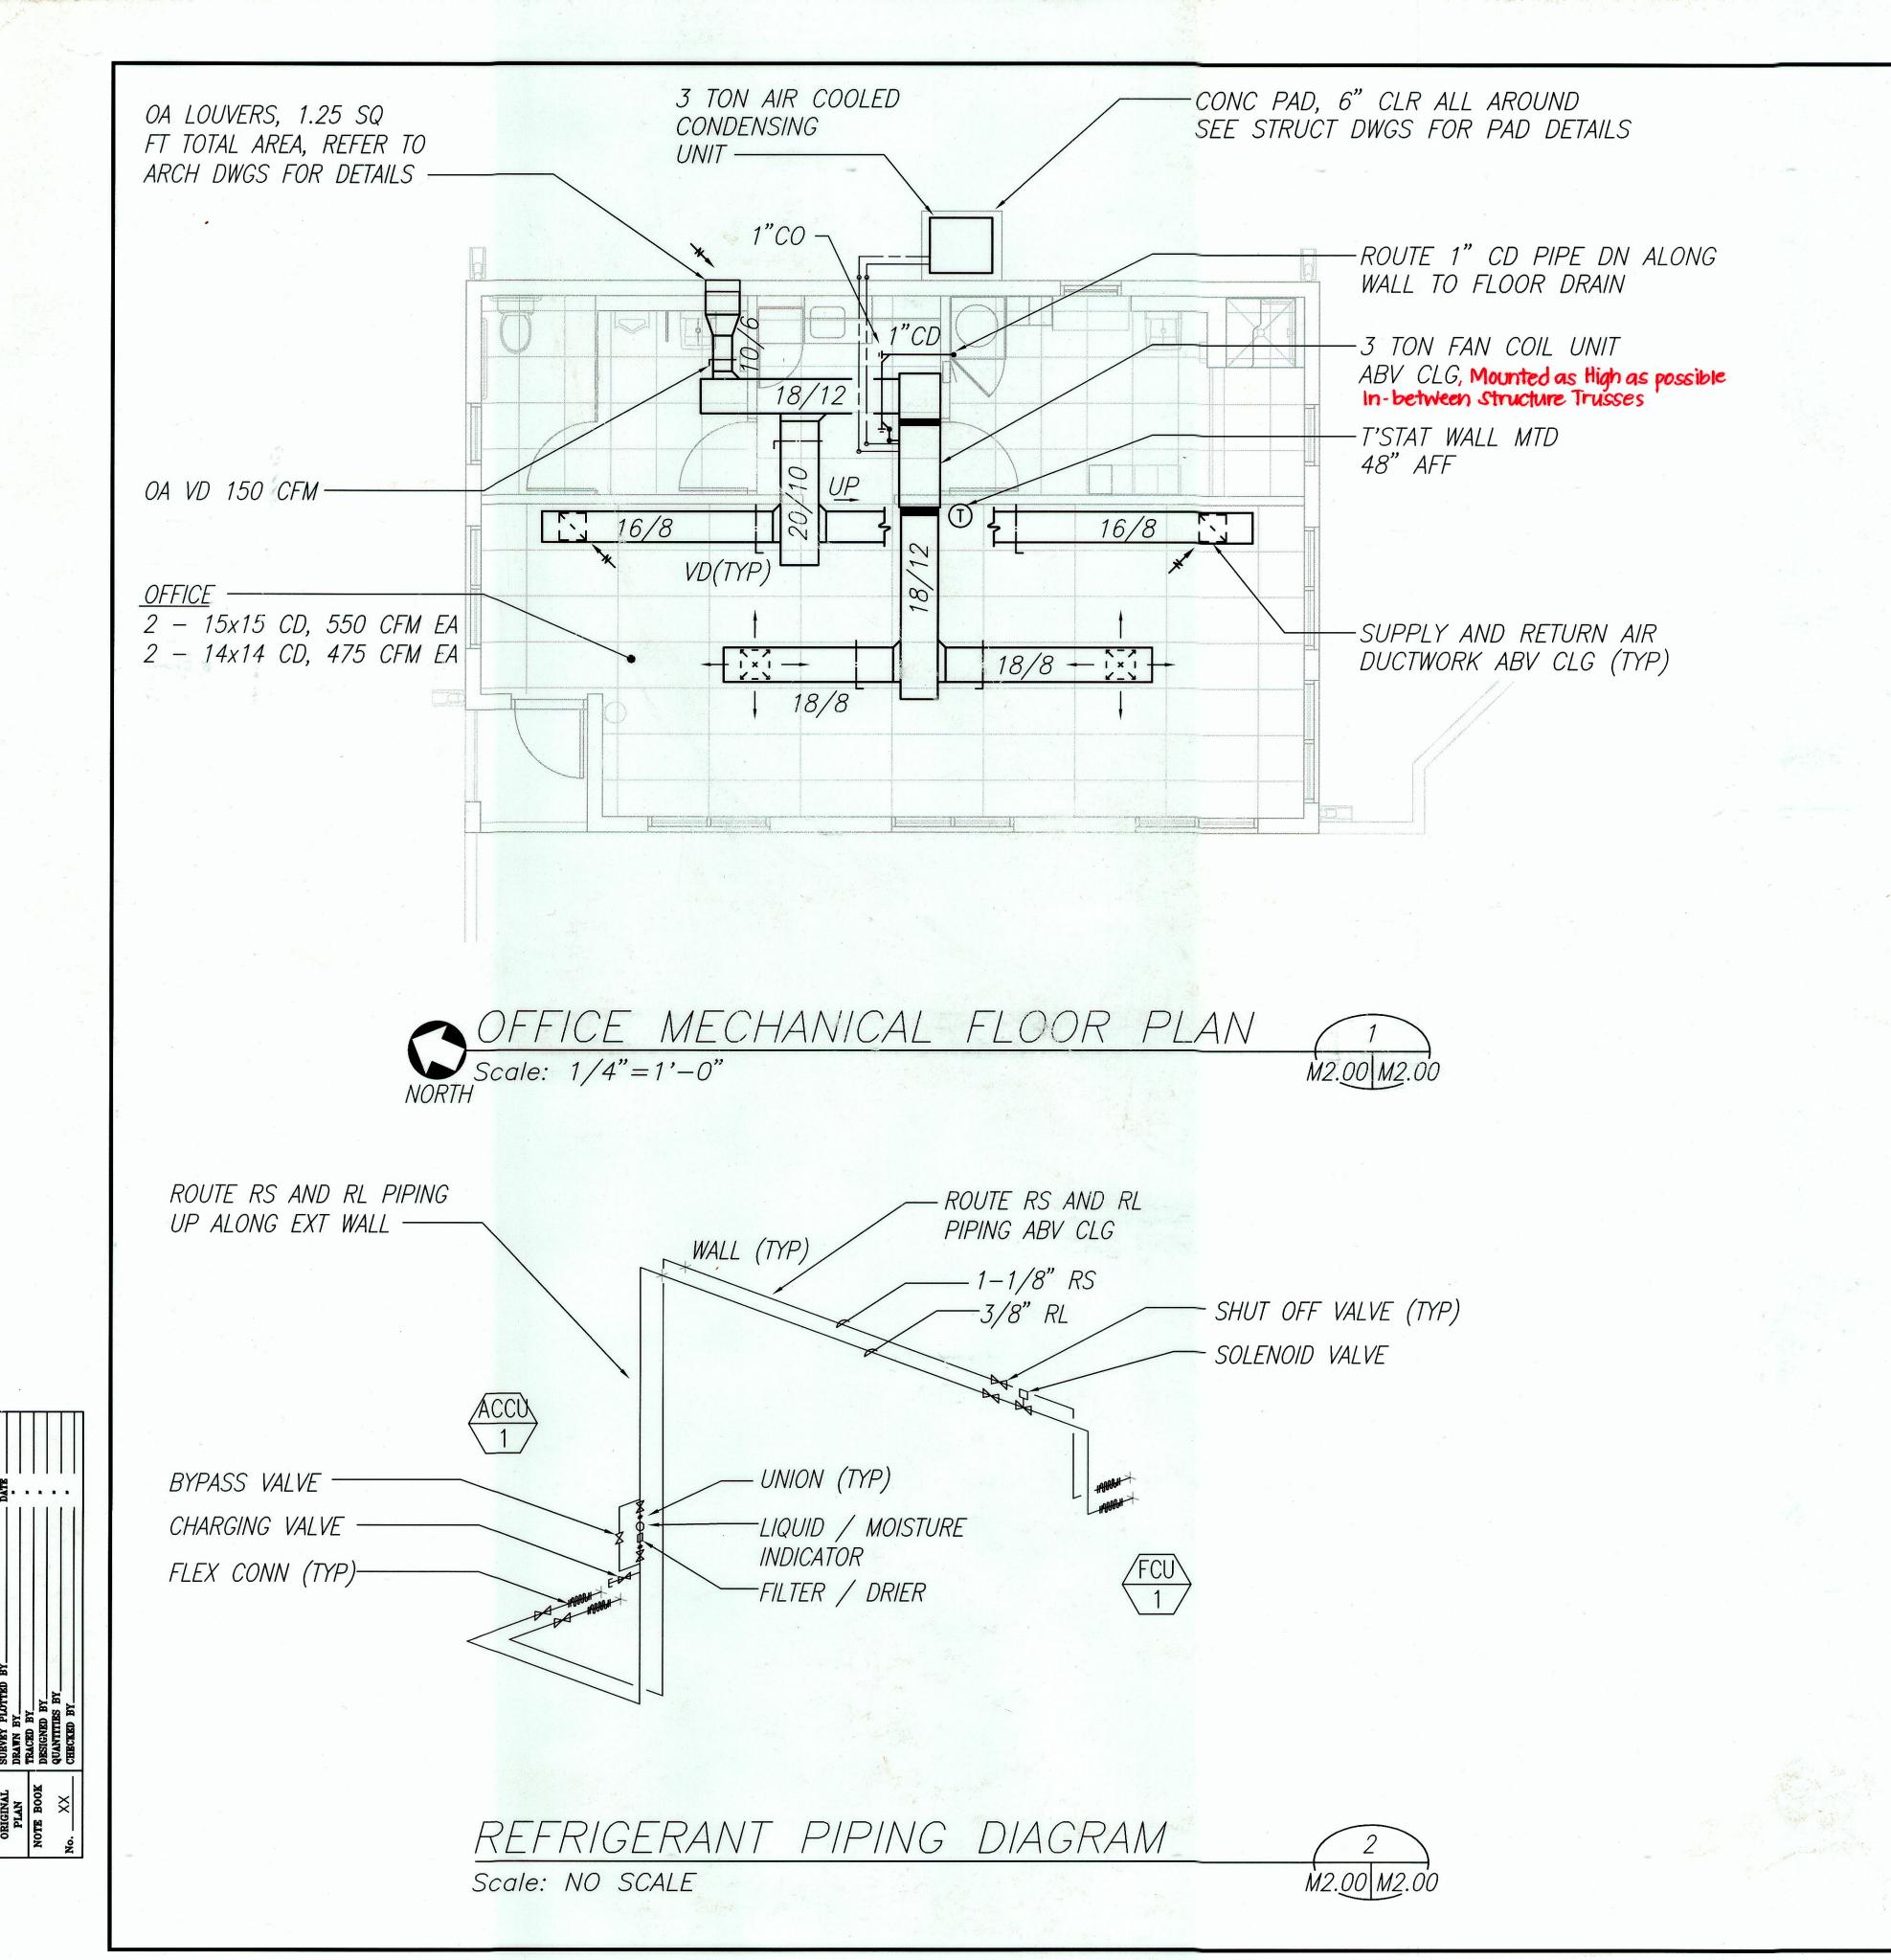

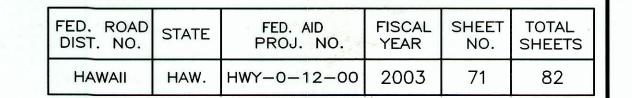

EQUIPMENT SCHEDULE



HORIZONTAL DRAW THRU UNIT, DX COOLING COIL, FORWARD CURVED, BELT DRIVEN FAN. SINGLE CIRCUIT COOLING COIL. GALVANIZED STEEL CASING, INTERNAL MOTOR. PROVIDE 1" THICK THROWAWAY FILTER, With Filter Access from Bottom of Unit.

36,600 TOTAL BTUH, 28,700 SENSIBLE BTUH 78.0°FDB / 64.0°FWB ENT. AIR 1,100 CFM @ 0.6 E.S.P., 750 RPM APPROX. 3.9 SQ. FT. COIL AREA, 290 FPM FACE VELOCITY. 150 CFM OA, 1/2 HP, 208V/10/60HZ. TRANE TWE 036C



VERTICAL DISCHARGE, R-22, DIRECT DRIVE PROPELLER FAN MOTOR. PAINTED GALVANIZED STEEL CABINET, CORROSION PROTECTION ON CABINET. PROVIDE HOT GAS BYPASS KIT. COIL EER 9.0

36,600 TOTAL BTUH, 28,700 SENSIBLE BTUH 45°F SUCTION, 95°F EAT COMPRESSORS (1 EA.) - 208V/1ø/60 HZ., 16.0 RLA, 91.0 LRA CONDENSER FAN (1 EA) - 1/4 HP, 208V/10/60 HZ., 1.9 FLA TRANE TTP 036C



THIS WORK WAS PREPARED BY ME OR UNDER MY SUPERVISION

This sheet replaces the original sheet A DPP/DLU Comments dated 2/22/08 DATE **REVISION**

STATE OF HAWAII
DEPARTMENT OF TRANSPORTATION HIGHWAYS DIVISION


OFFICE BUILDING MECHANICAL FLOOR PLAN

WAHIAWA BASEYARD **IMPROVEMENTS** Project No. HWY-0-12-00


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Date: *JAN. 2003*

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C.O.72

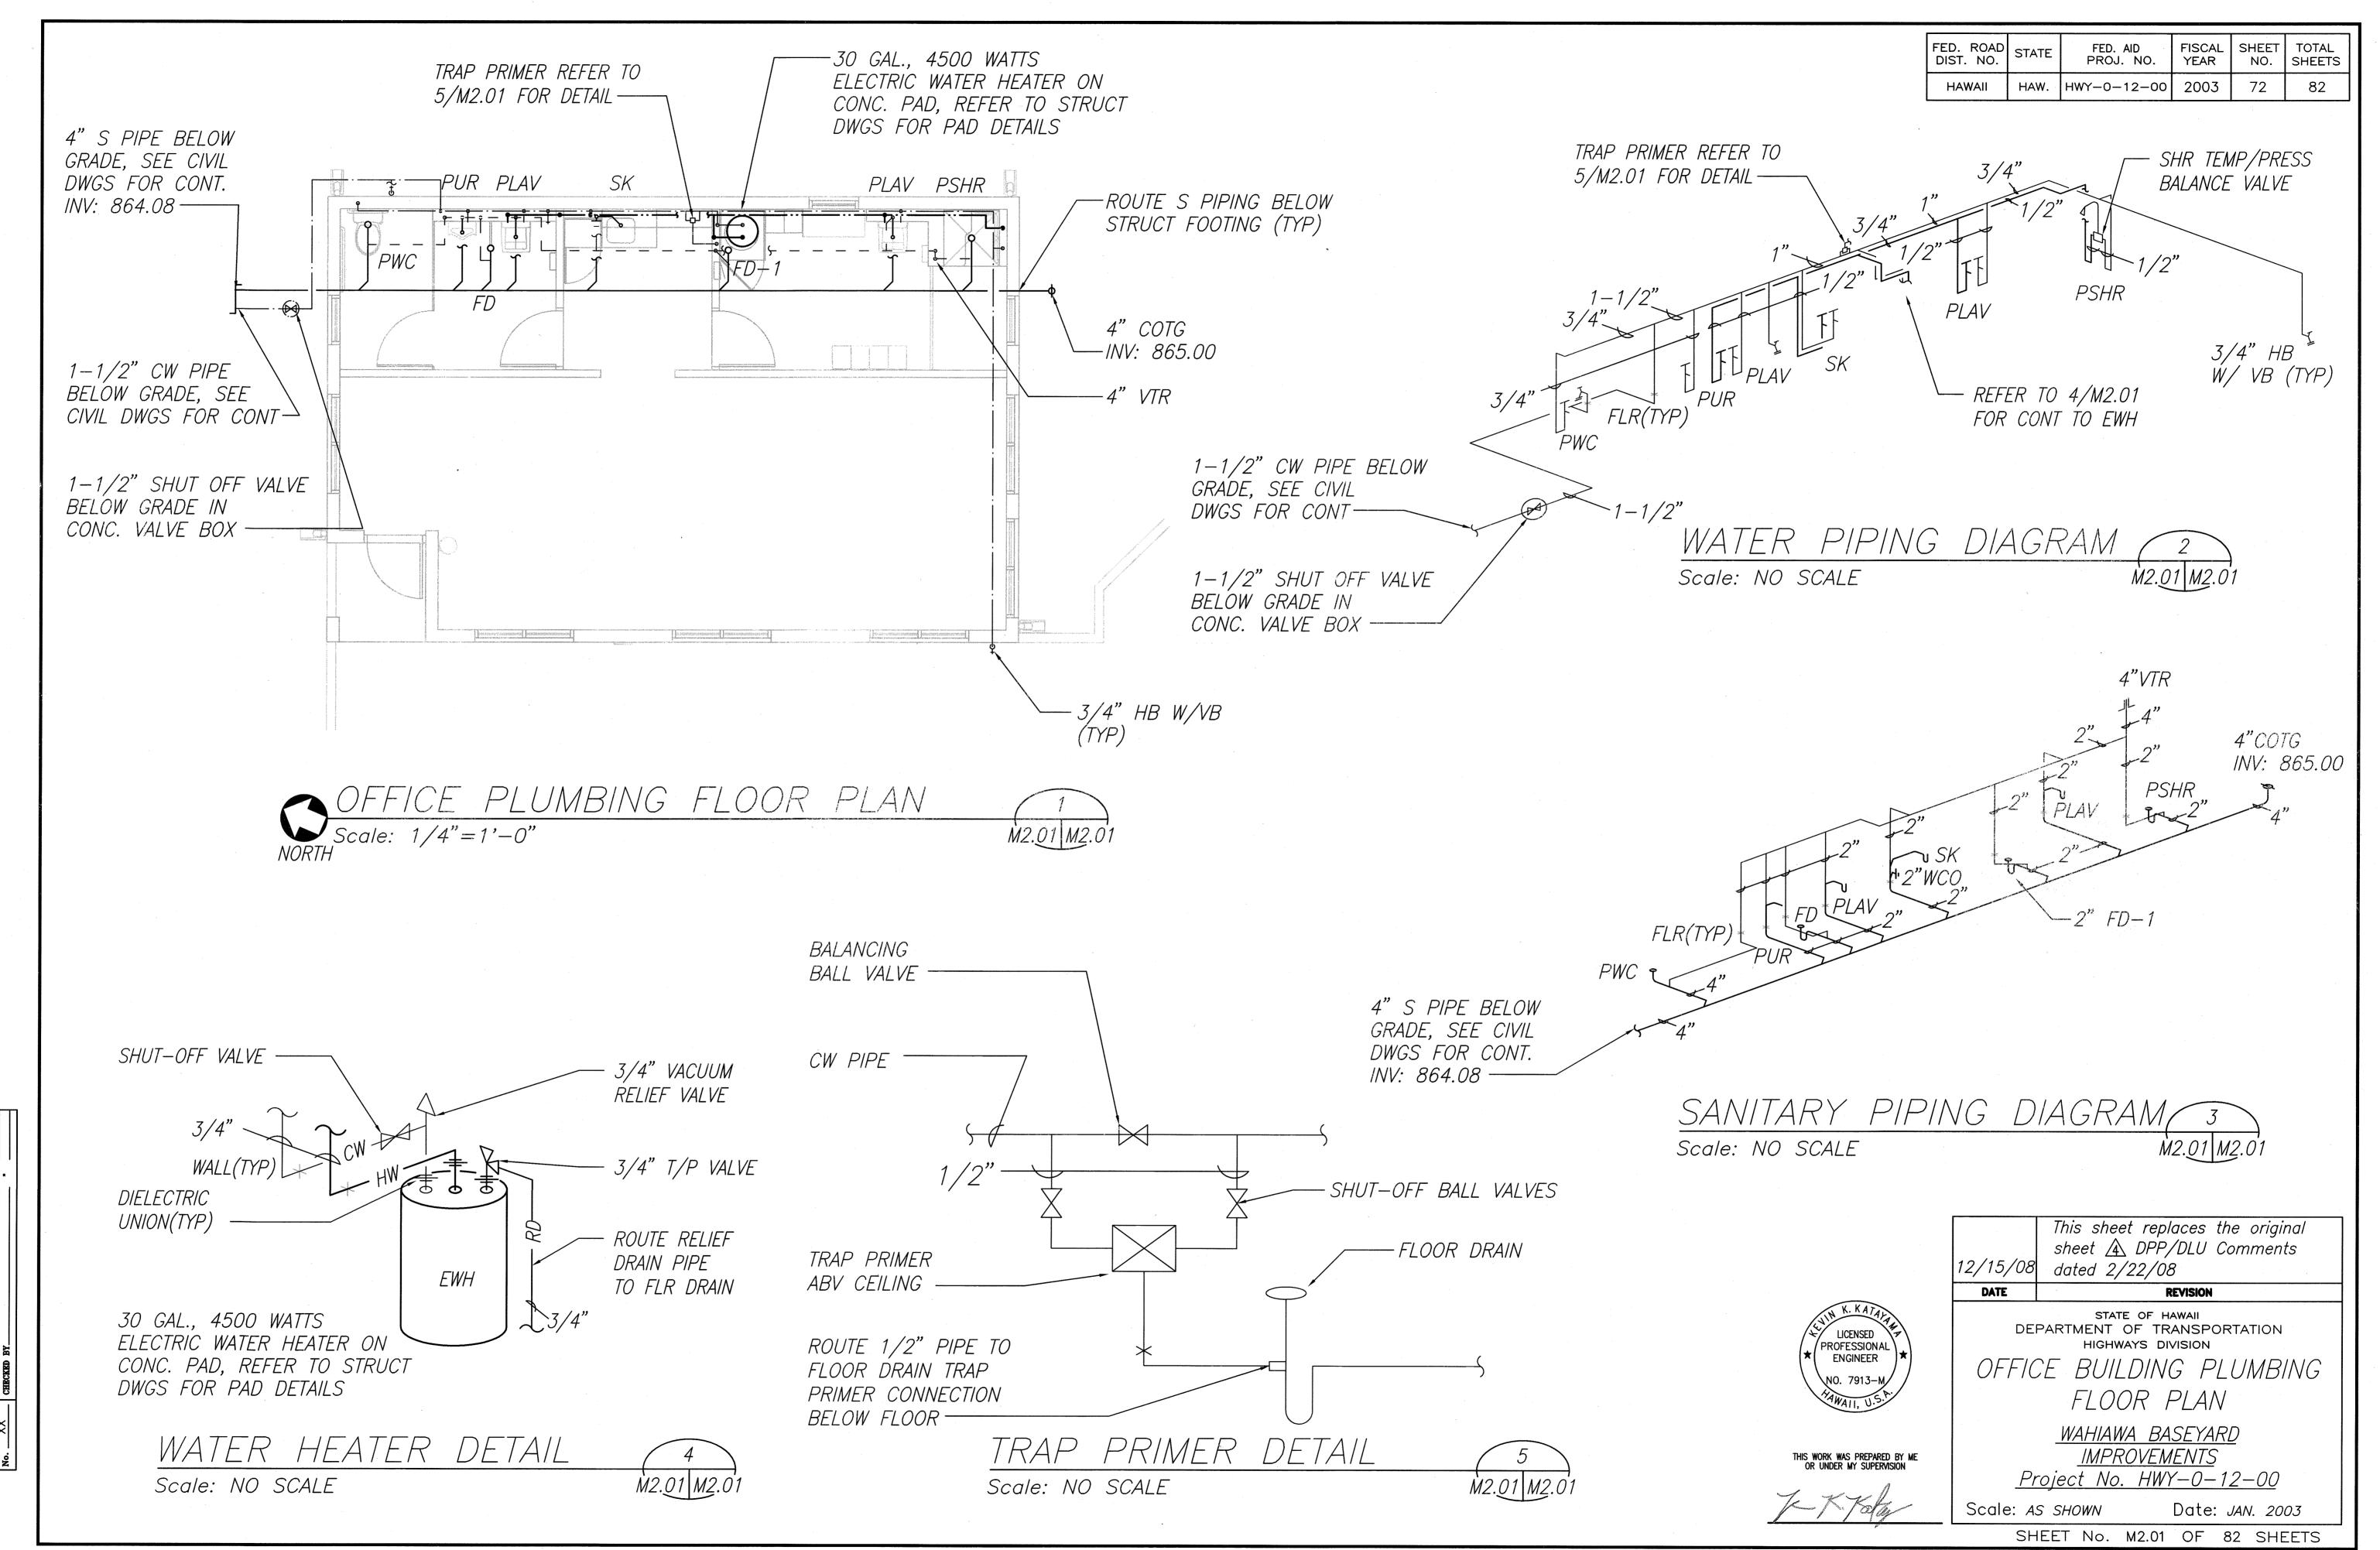



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Scale: AS SHOWN Date: JAN. 2003


SHEET No. M3.00 OF 82 SHEETS

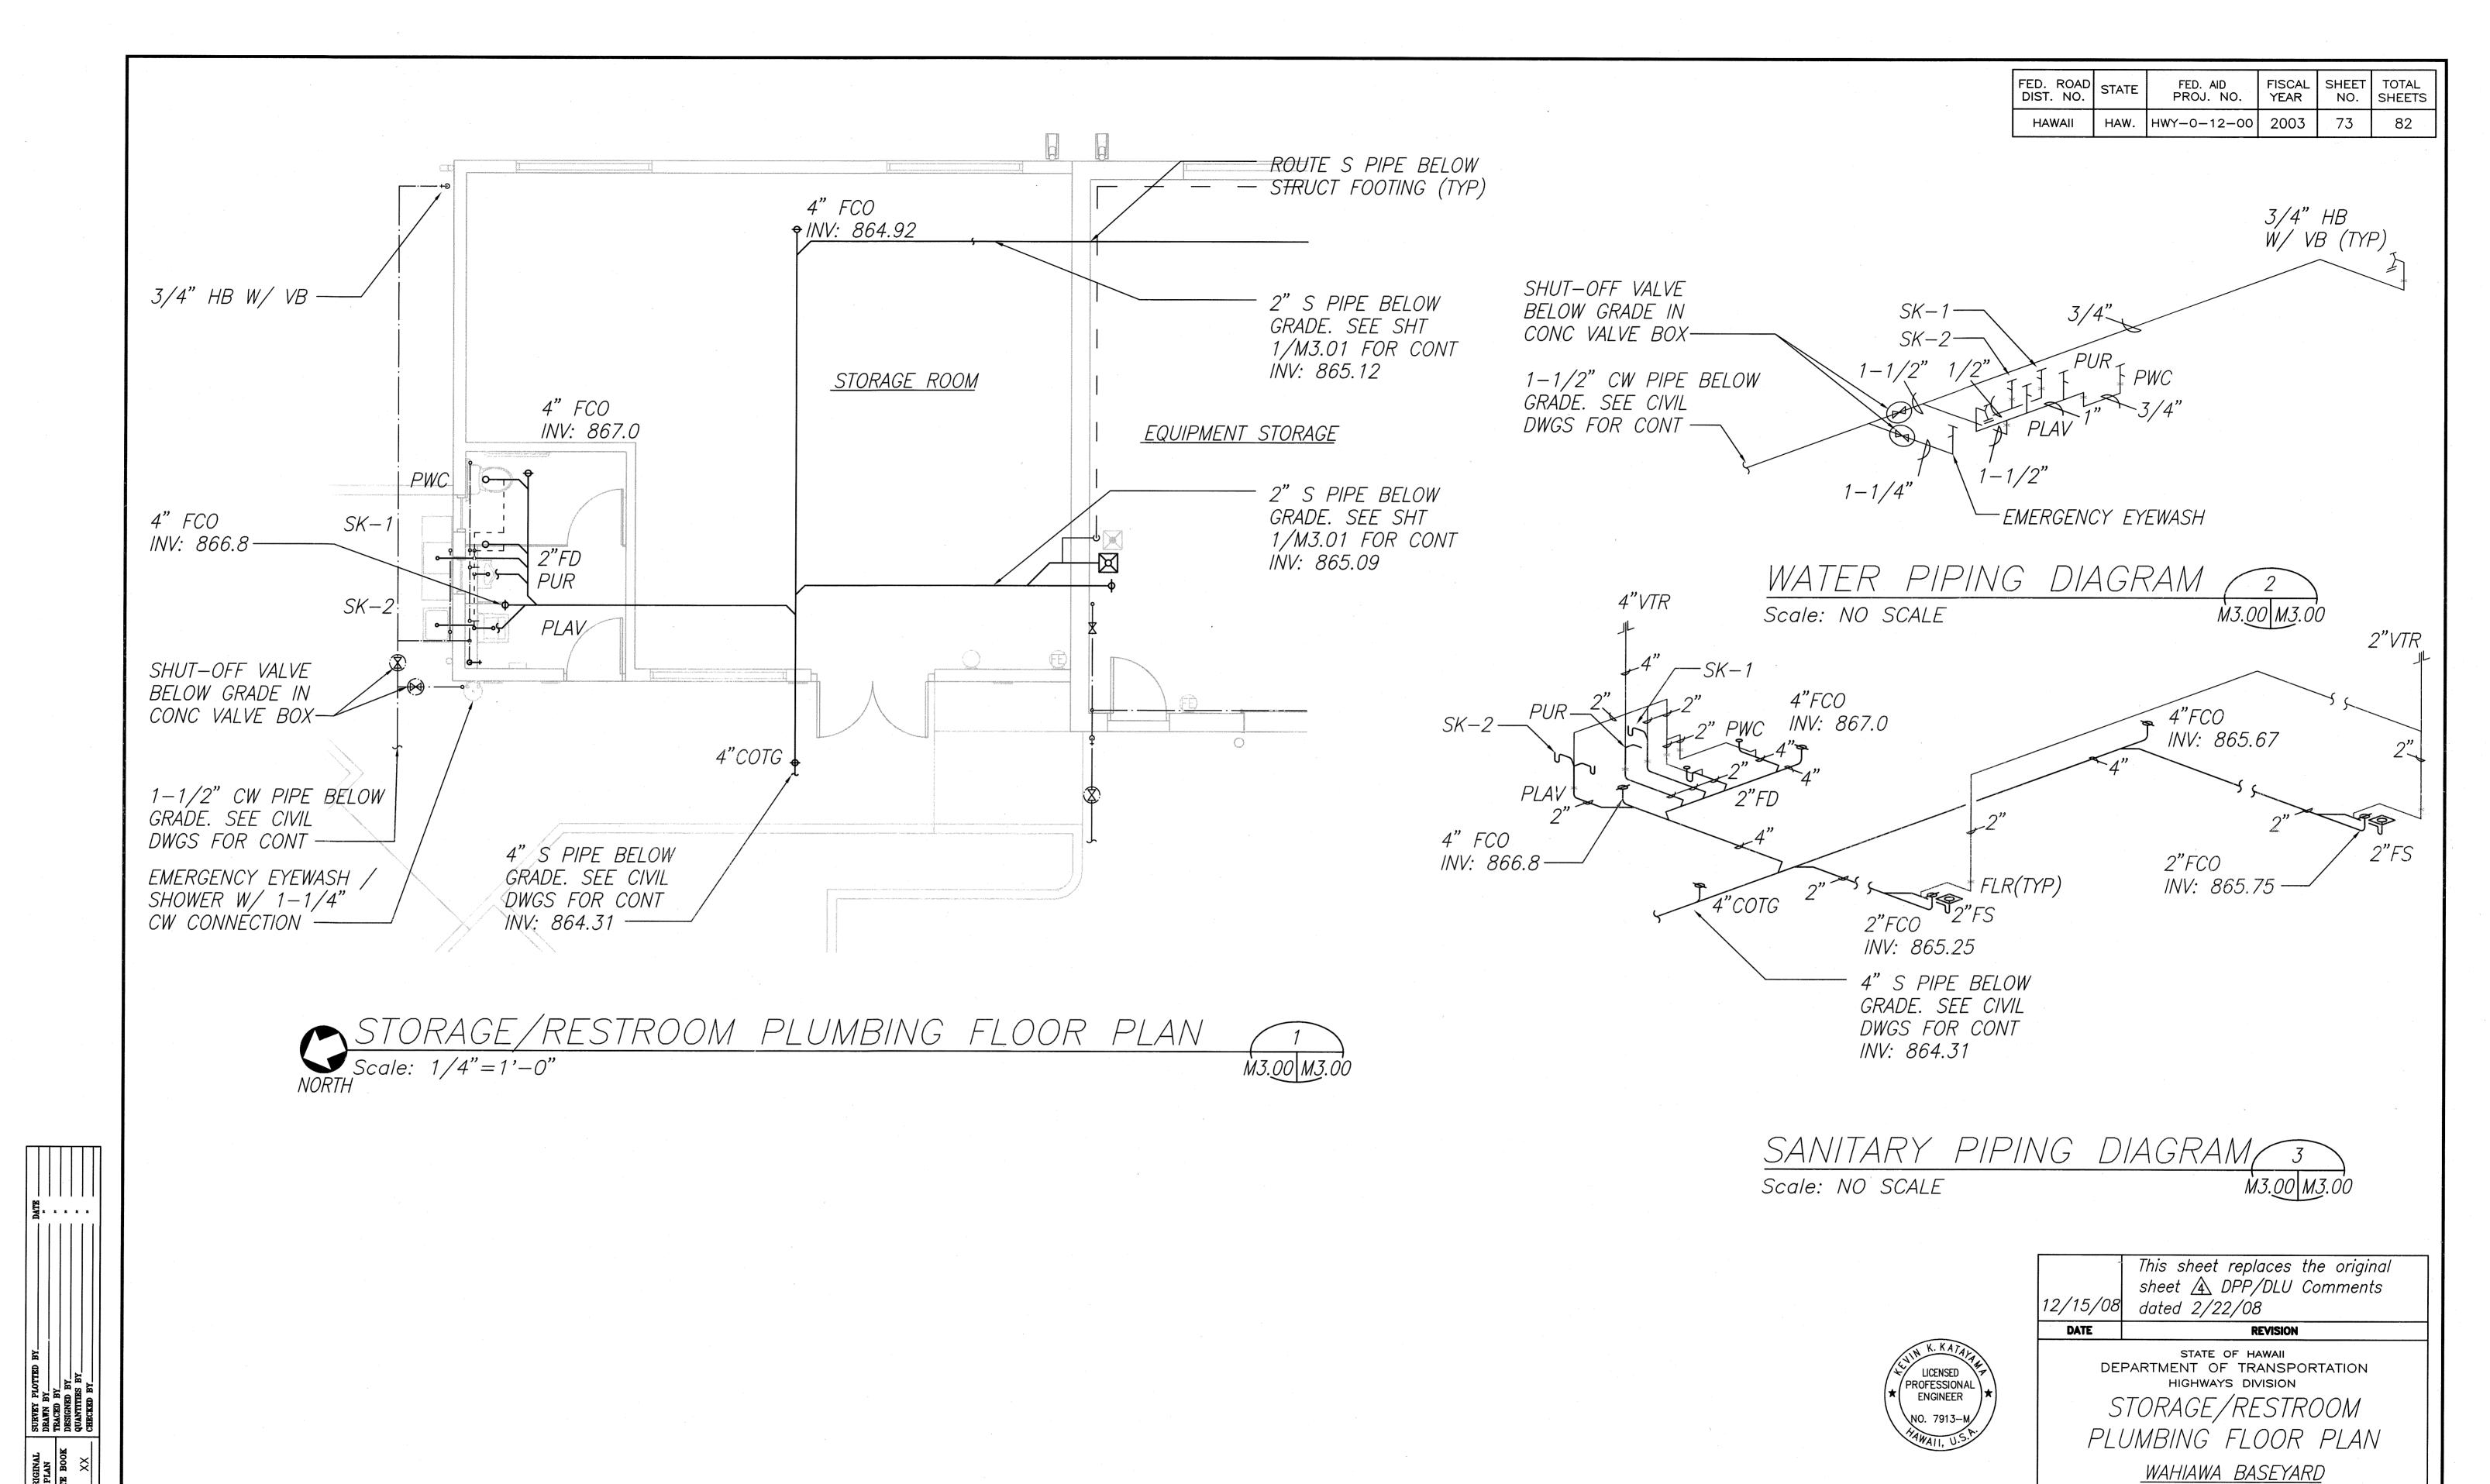IMPROVEMENTS



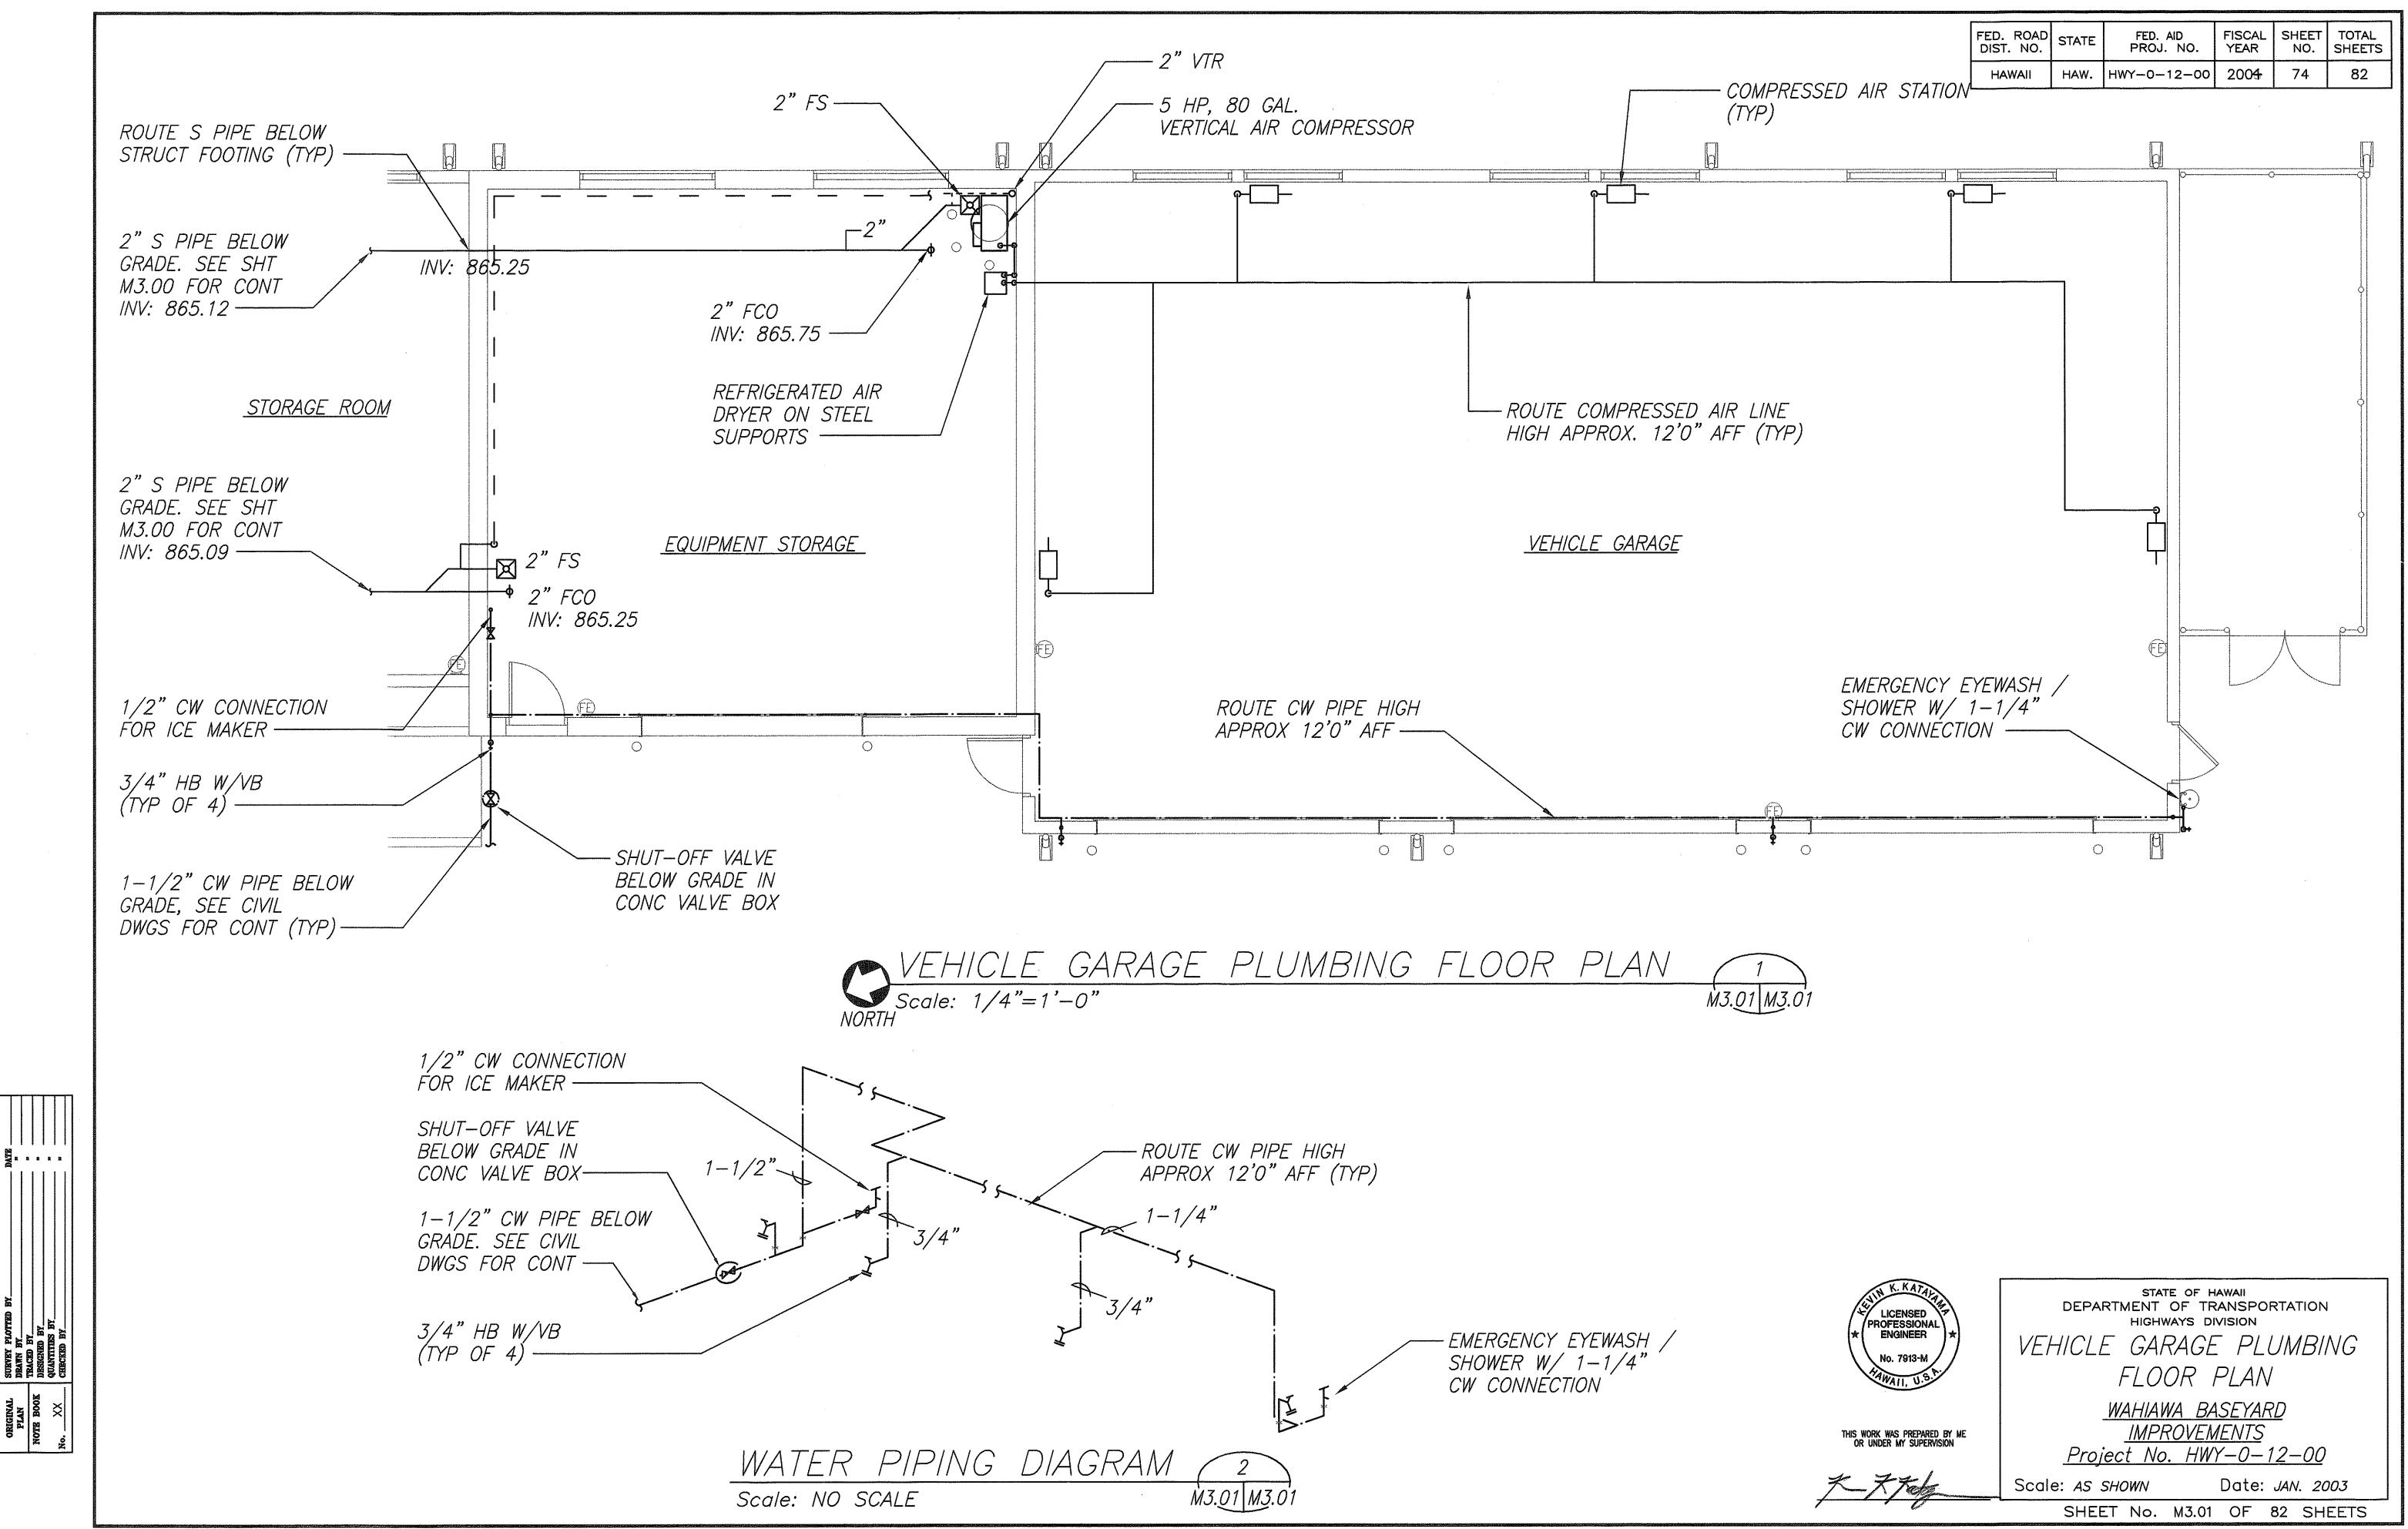


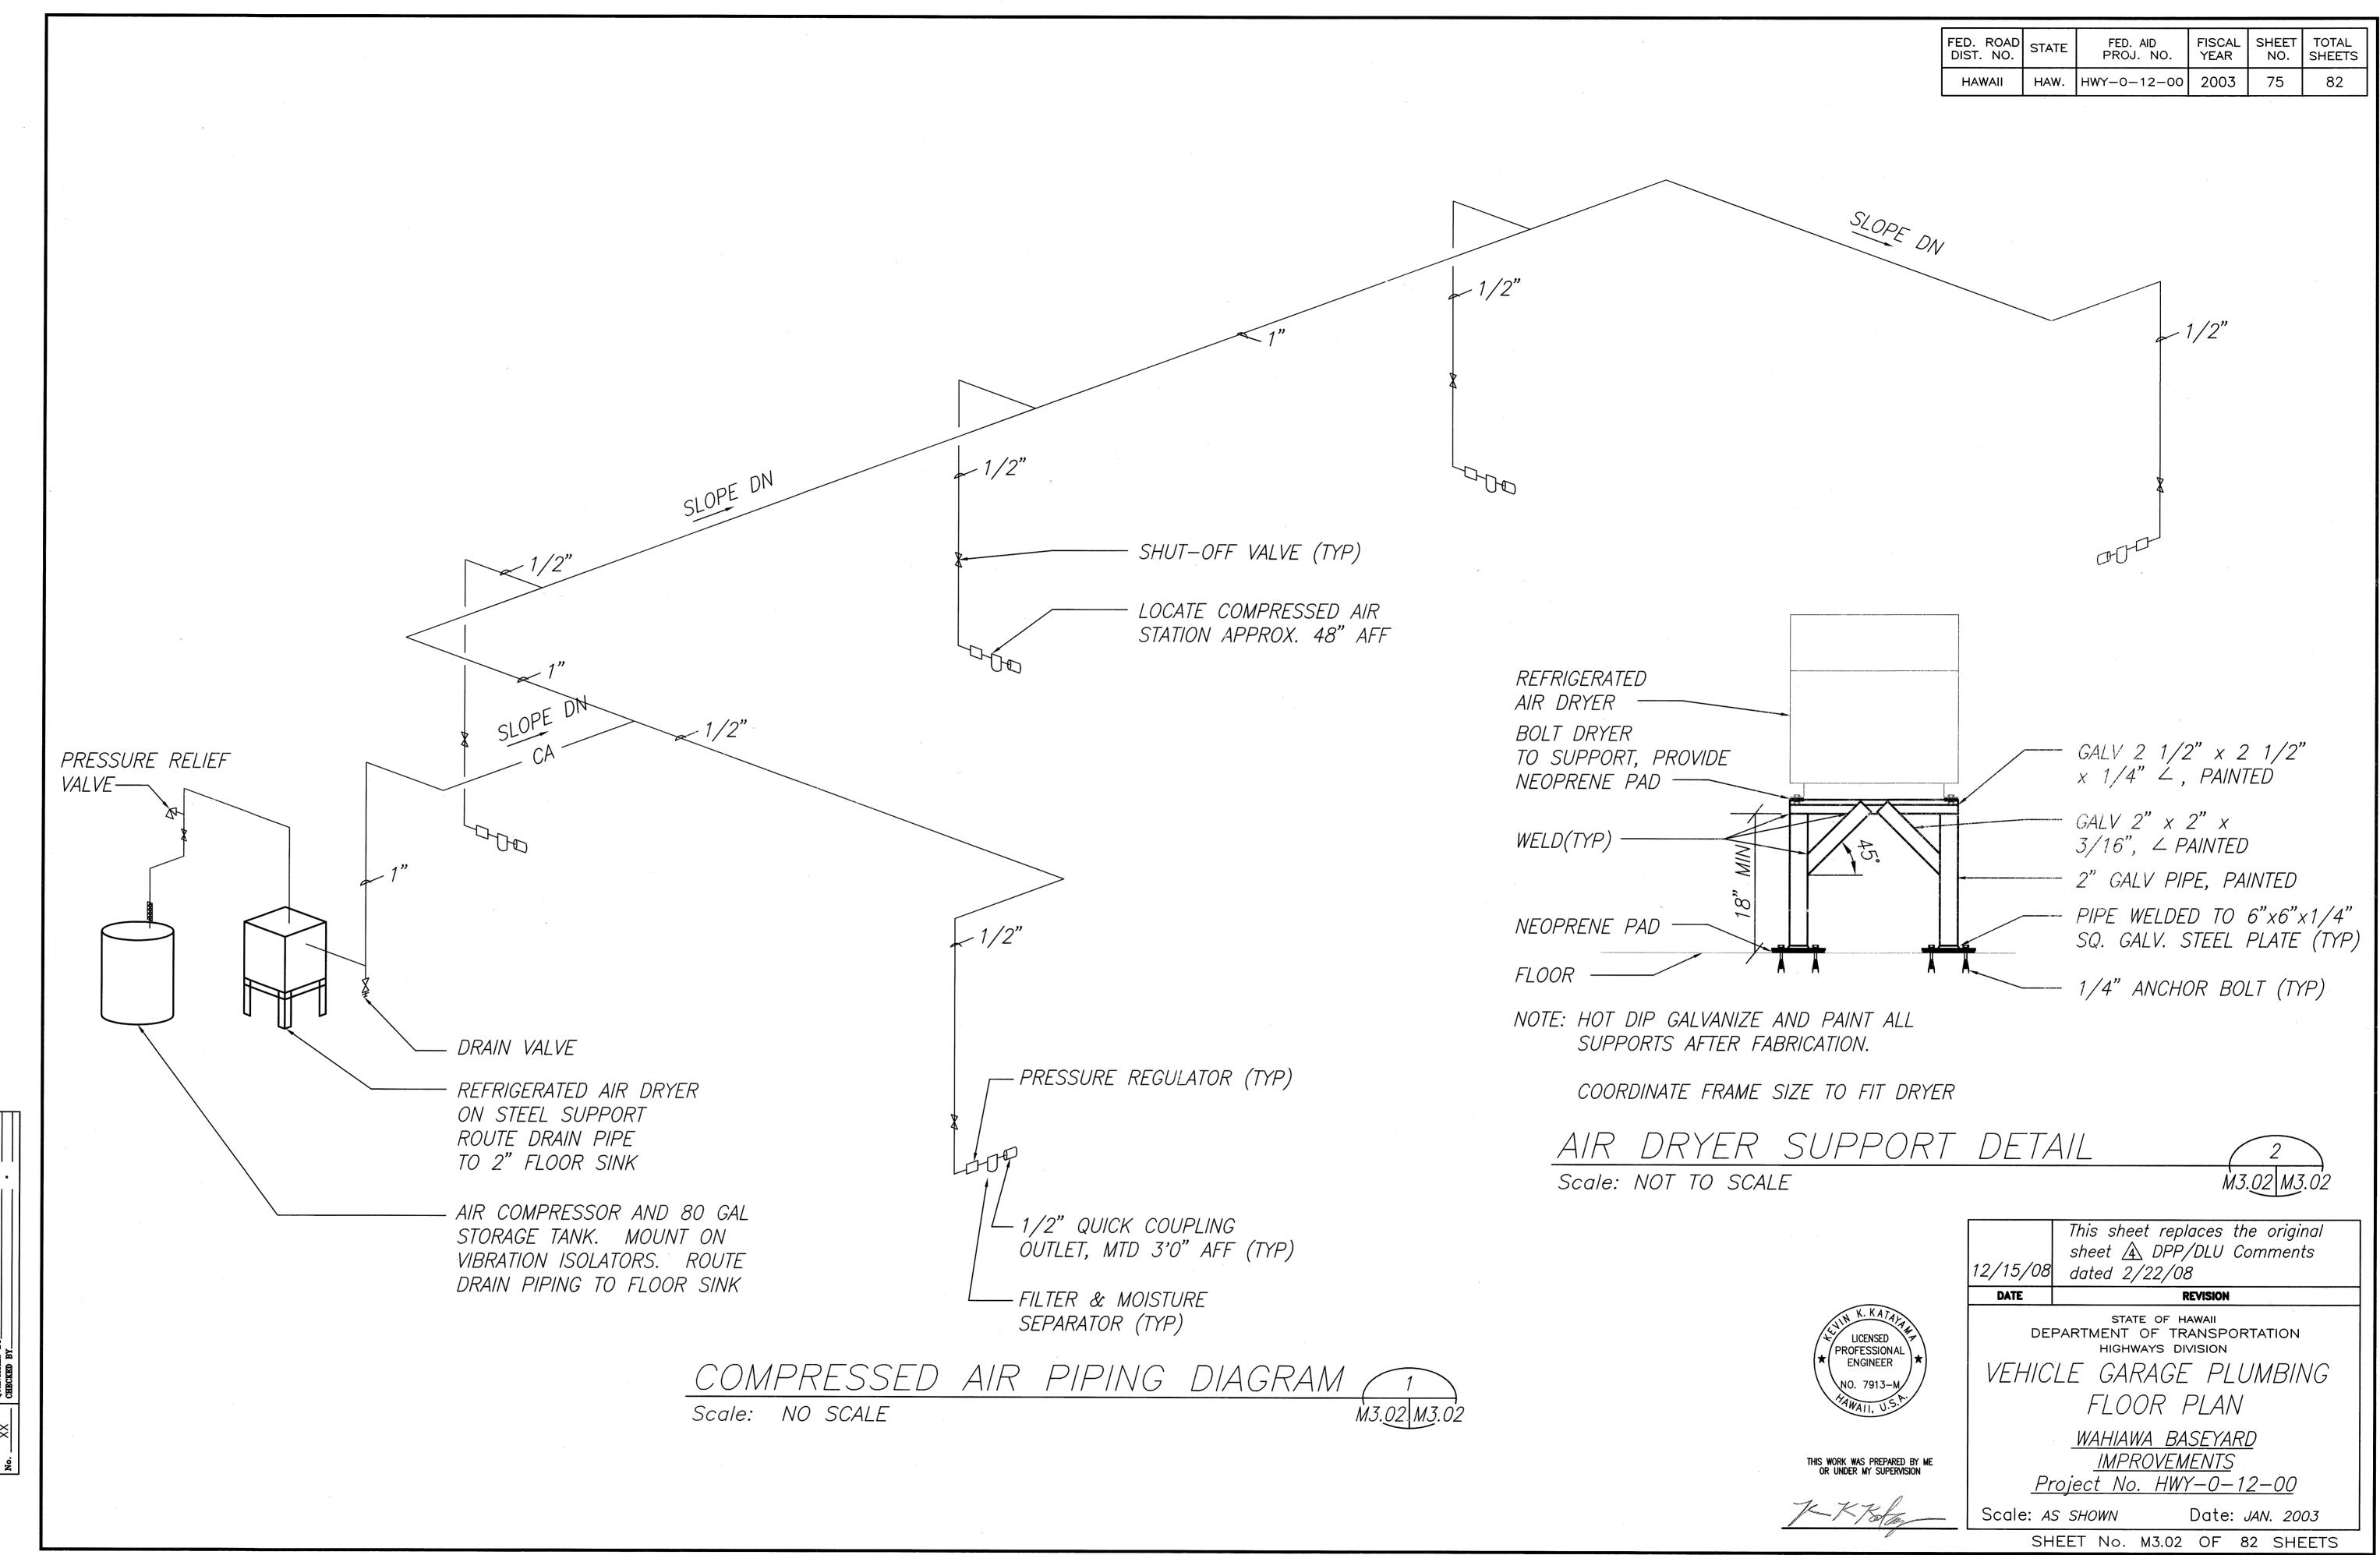C.O.75

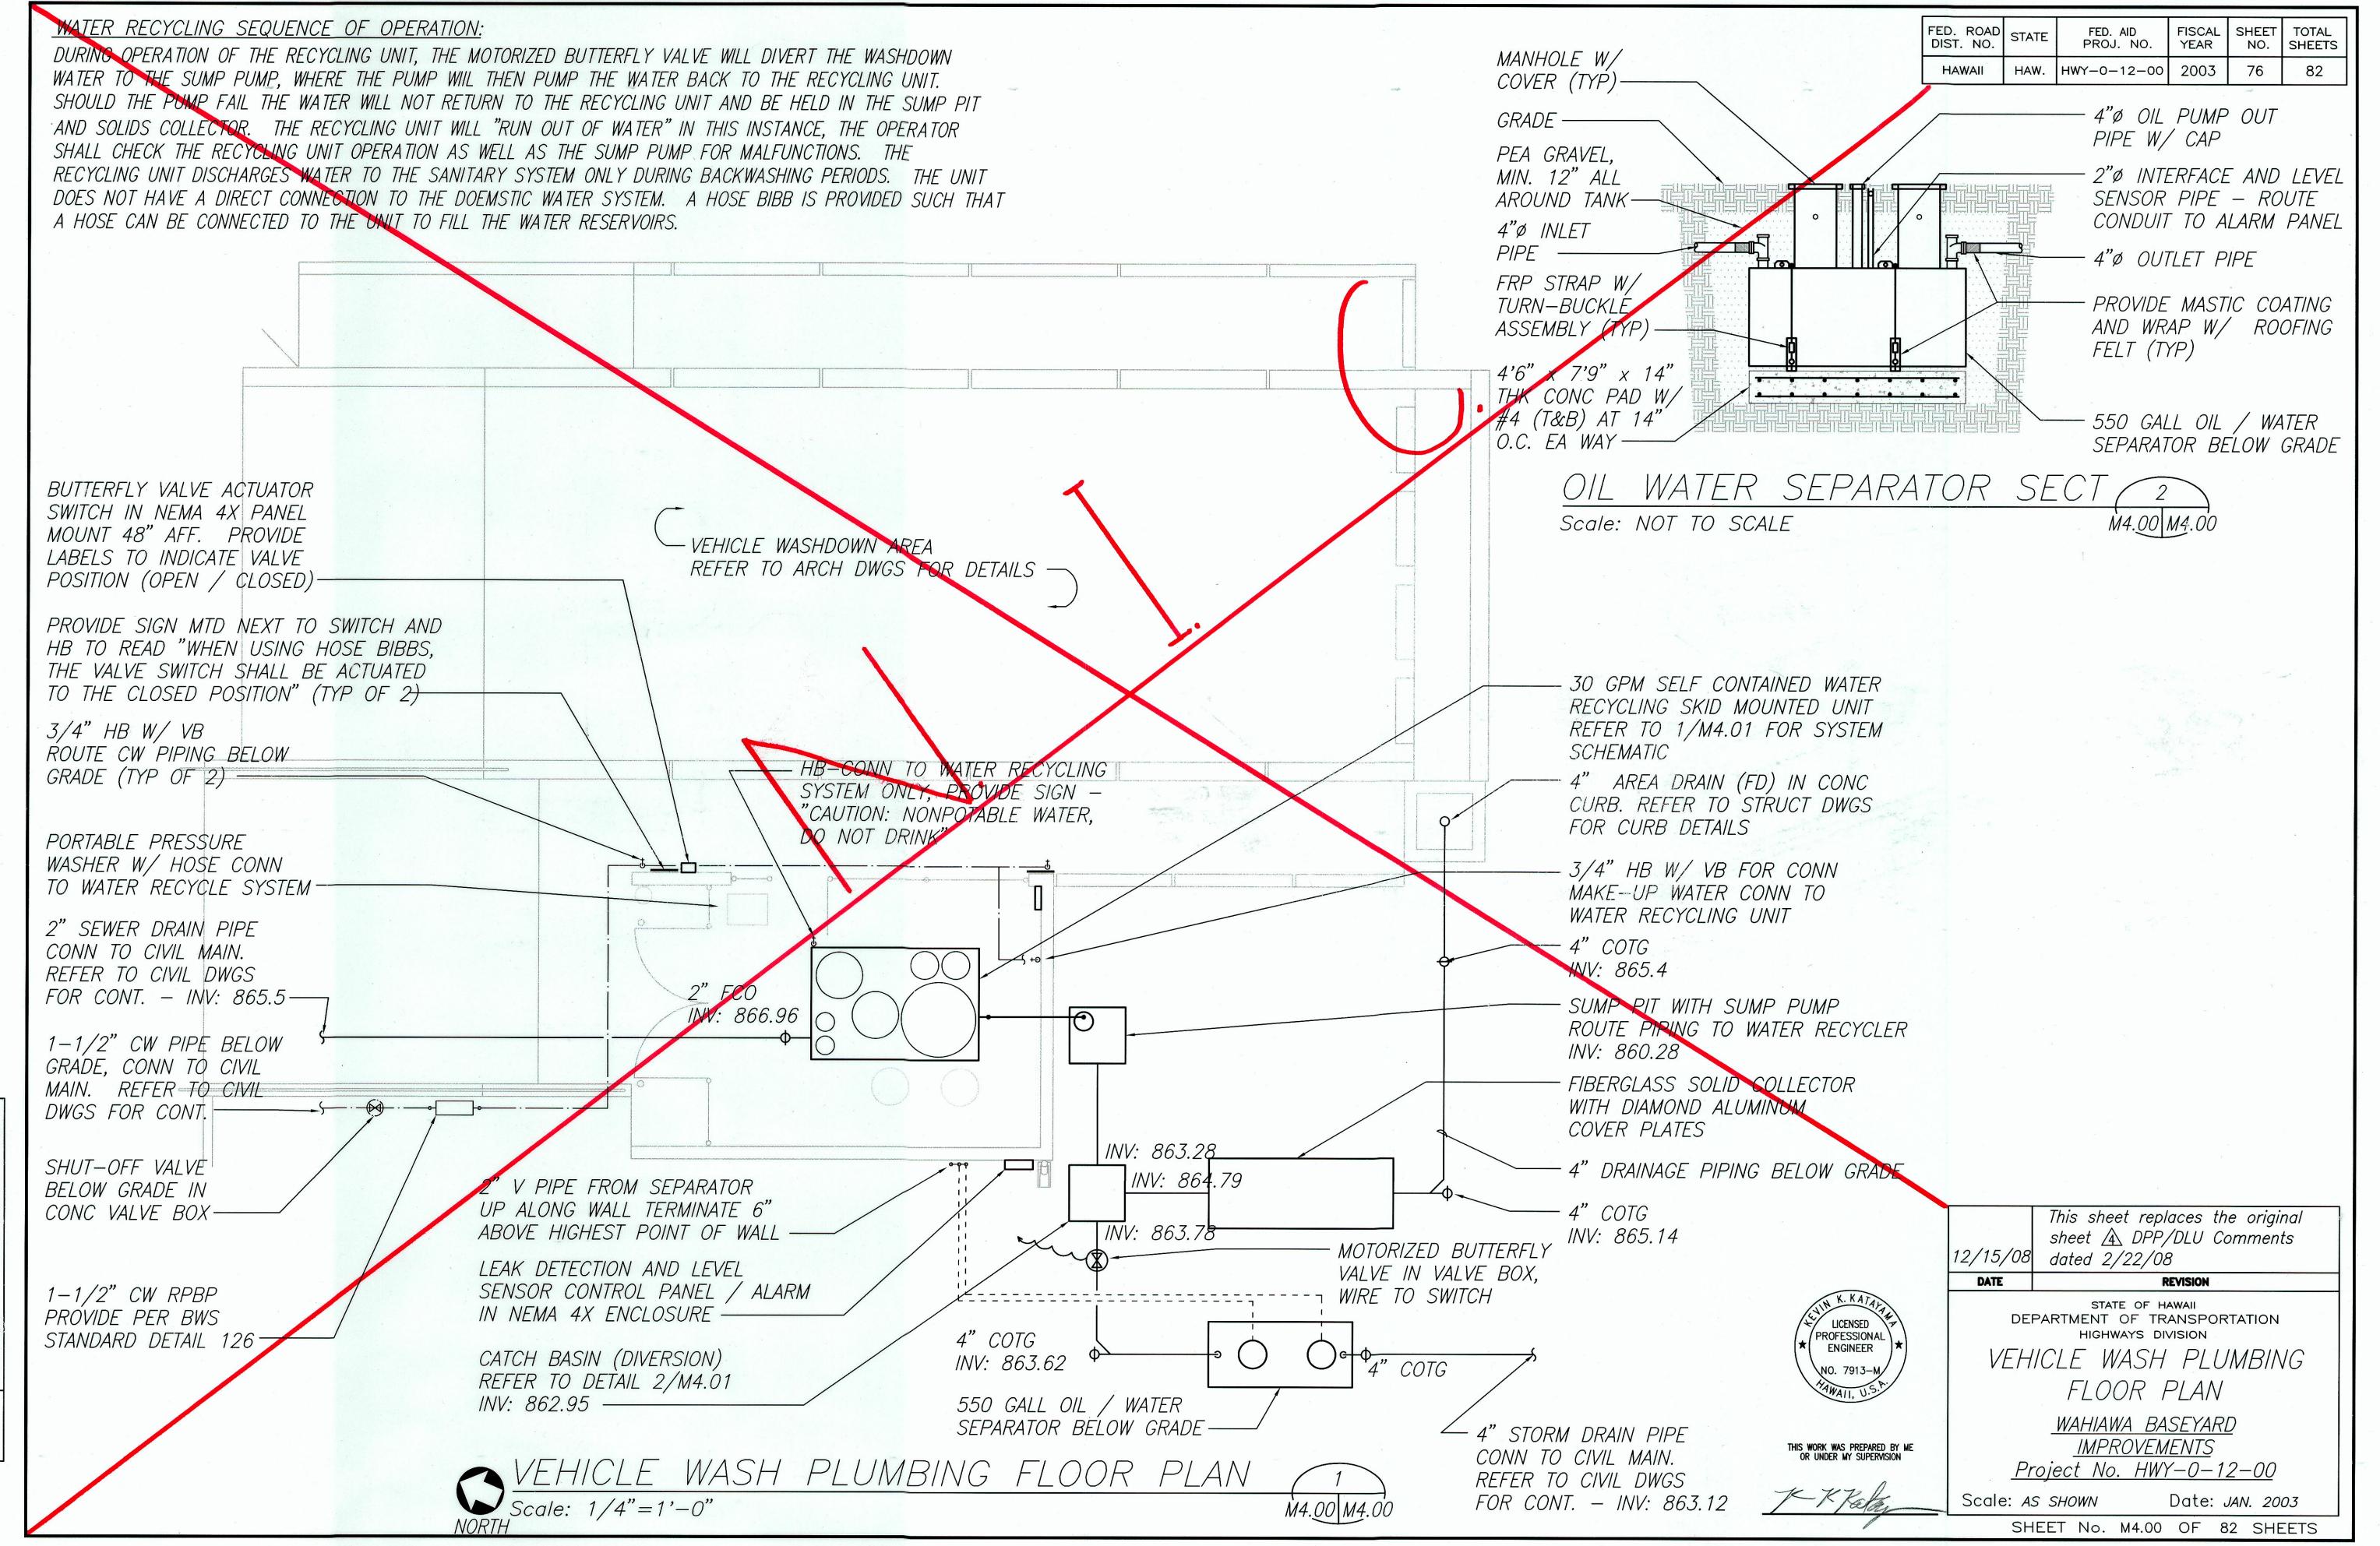

SURVEY PLOTTED
DRAWN BY
TRACED BY
DESIGNED BY
QUANTITIES BY
CHECKED BY

C.0.76

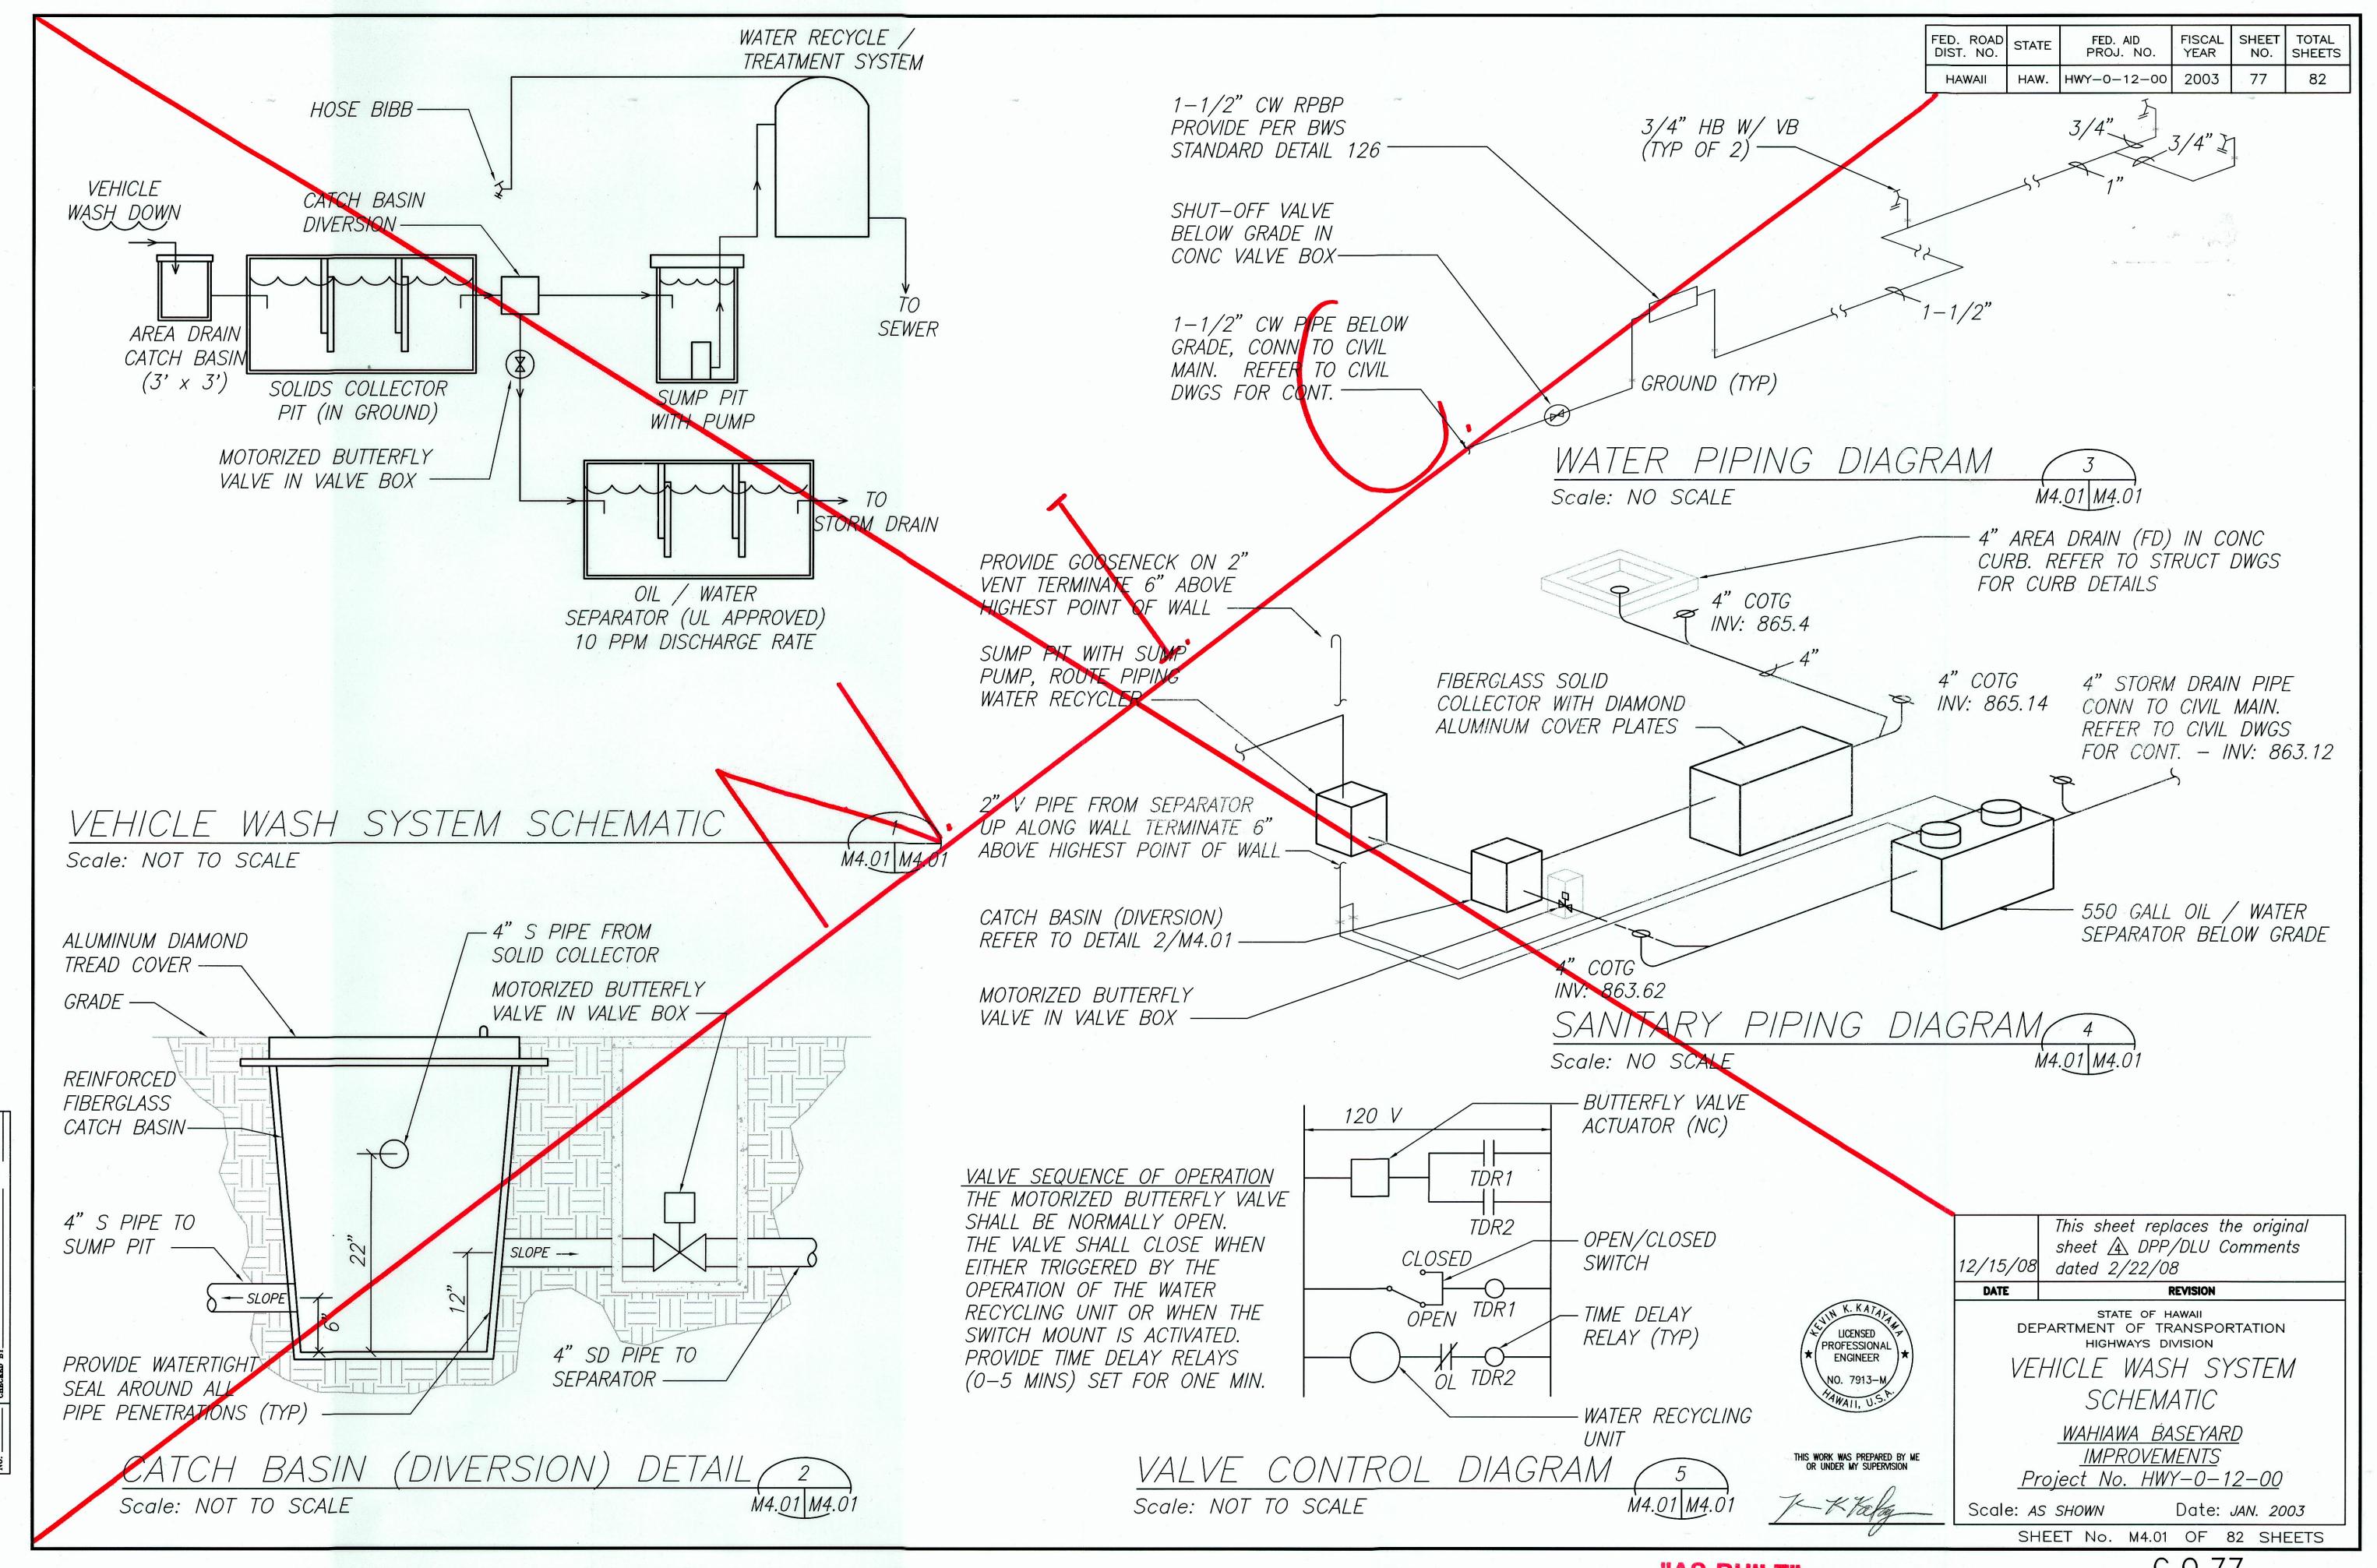

C.O.77