FED. ROAD DIST. NO.	STATE	PROJ. NO.	FISCAL YEAR	SHEET NO.	TOTAL SHEETS
HAWAII	HAW.	HWY-0-09-06	2008	ADD.33	46

CKT		de Cabinet, Industrial—Bolted, NEMA 4X S		KVA	
NO.	BKR	L O A D	L1	L2	WIRE
1,3	2P100A	existing panel "A"	2.4	2.4	#2
2,4	2P200A	New Panel "W"	19.2	19.2	#3/0
5,7	2P	P F B			
6,8	2P	PFB			
9,11	2P	P F B			
10,12	2P	PFB			•
13,15	2P	P F B			
14,16	2P	PFB		,,,,,,,,,,,,,,,,,,,,,,,,,,,,,,,,,,,,,,,	
17,19	2P	P F B			
18,20	2P	PFB			
21,23	2P	P F B			
22,24	2P	PFB			

	anel "W"	120/240 Volts		1ø, 3	
	lain Lugs (•			0 Am
Surface	e, 20" Wid	de Cabinet, Industrial—Bolted, NEMA 4X			1
CKT	BKR	L O A D		KVA	
NO.			<u>L1</u>	L2	WIF
1,3	2P40A	PW-1	3.4	3.4	8
2,4	2P40A	PW-1	3.4	3.4	8
5,7	2P40A	PW-1	3.4	3.4	8
6,8	2P40A	PW-1	3.4	3.4	8
9,11	2P40A	WTS-2	3.6	3.6	8
10	1P20A	Light-NL	1.0		10
12	1P20A	Light-NL		1.0	10
13	1P20A	SP-1	1.0	7.0	12
14	1P20A	Timeswitch	0.1		12
15	1P	P F B	0.1		12
16					
17					
18					
19					
20					
21				***	
22					
23					
24					
		·			
T	0 T A		20.2	19.2	

ELECTRICAL SYMBOLS

- → Post Light Luminaire
- Duplex Convenience Outlet, 3W2OA, Ground Fault Grounding Type +16" Unless Otherwise Noted
- Special Outlet, +16", Size And Rating As Indicated Or As Required
- Main Service Equipment
- **H** Wall Junction box, 4−11/16" Square Minimum
- Large Junction Box
- Panelboard
- existing panelboard
- **WP** Weatherproof
- © Equipment Connection
- →
 Safety Switch

A-2/48 Luminaire Designation, Type "A-2/48" Indicated


-x-eoh-x − existing overhead lines to be removed

--- wiring in existing raceway

----- Wiring In Raceway Concealed In Floor Or Below Grade

---- Wiring In Exposed Raceway

- 1. Any Circuit With No Further Designation Indicates A Two Wire Circuit. Circuits With Additional Wires Are Indicates As Follows: ----, 3 Wires: -----, 4 Wires, Etc.
- 2. Ground Wire Per National Electrical Code Indicated As Follows: ——
- 3. All Exposed Conduit And Boxes Shall Be Painted To Match Adjacent Wall Or Ceiling Surrounding

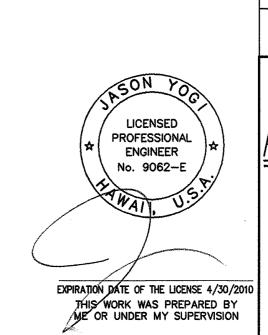

Revised Panel Schedule ∖ And Electrical Symbols REVISION


STATE OF HAWAII
DEPARTMENT OF TRANSPORTATION

P. SCHEDULES, ELECT'L SYMBOLS (PEARL CITY BASEYARD)


KANEOHE, PEARL CITY AND WAIANAE BASEYARD WASHDOWN RACKS Project No. HWY-0-09-06

Date: MAY 2008 Scale:


SHEET No. E-200 OF 46 SHEETS

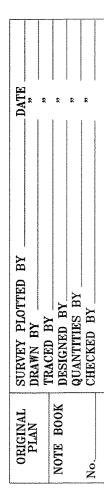


ADD.33

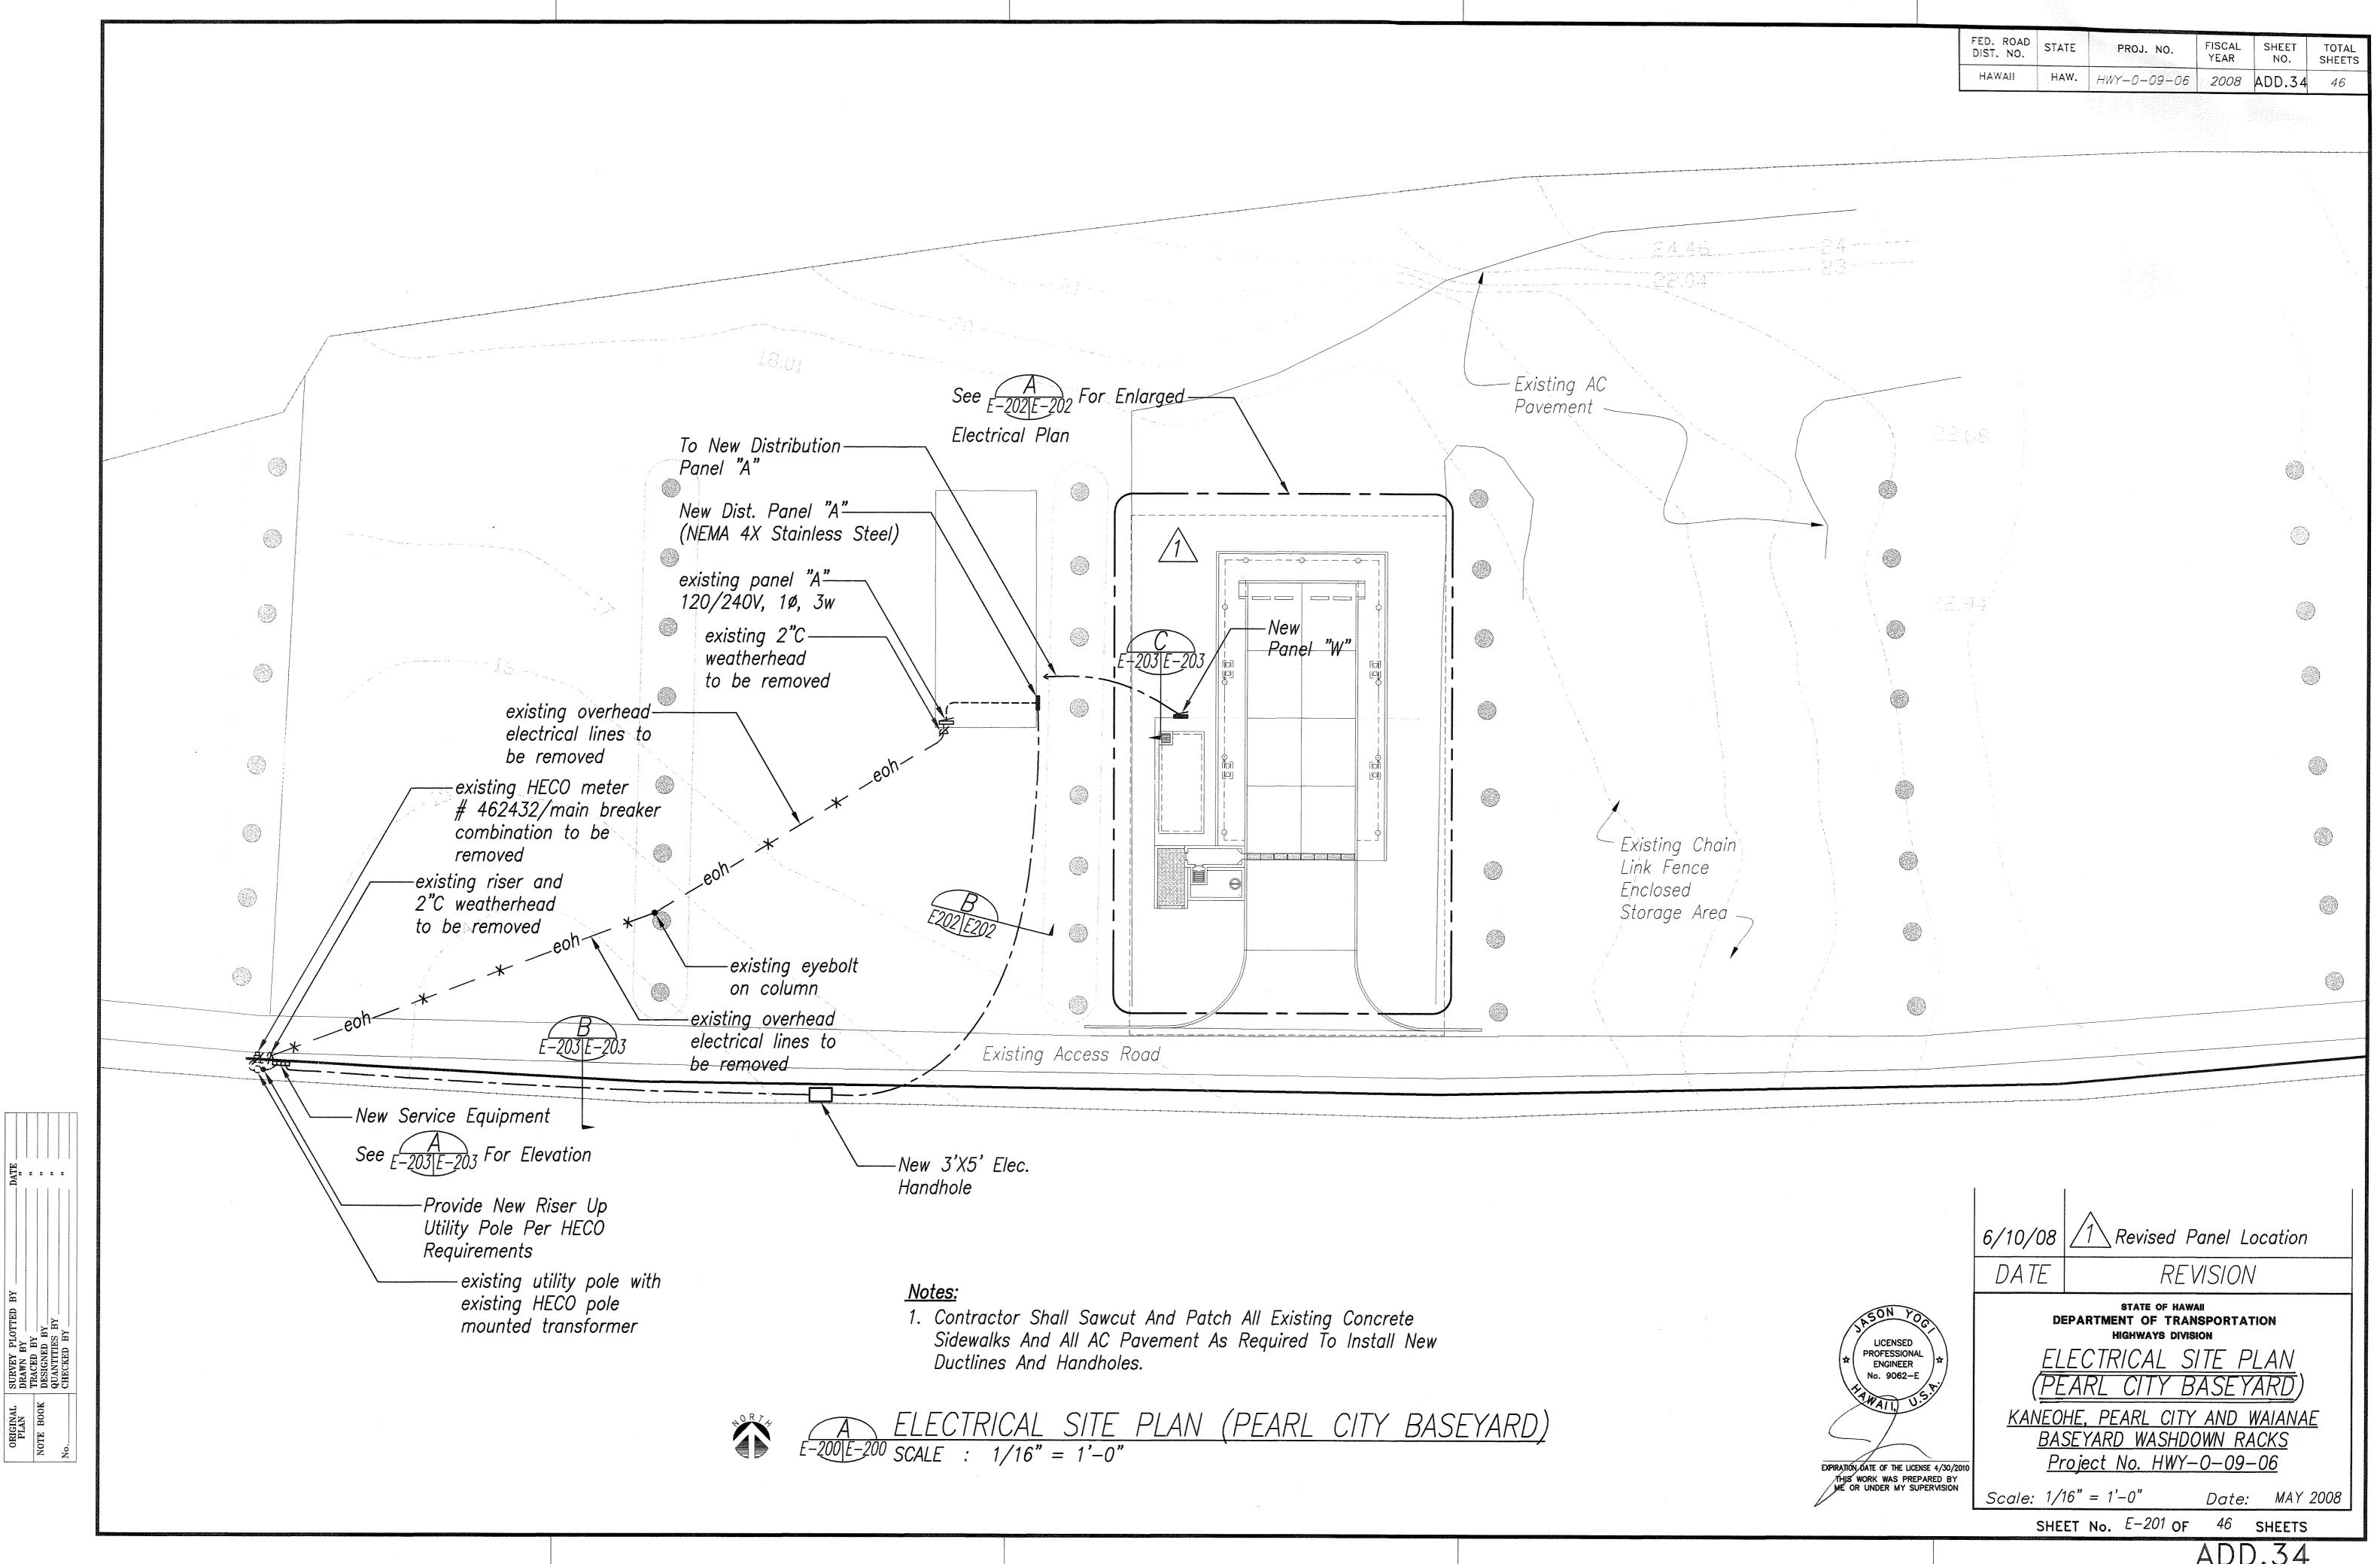


ADD.34

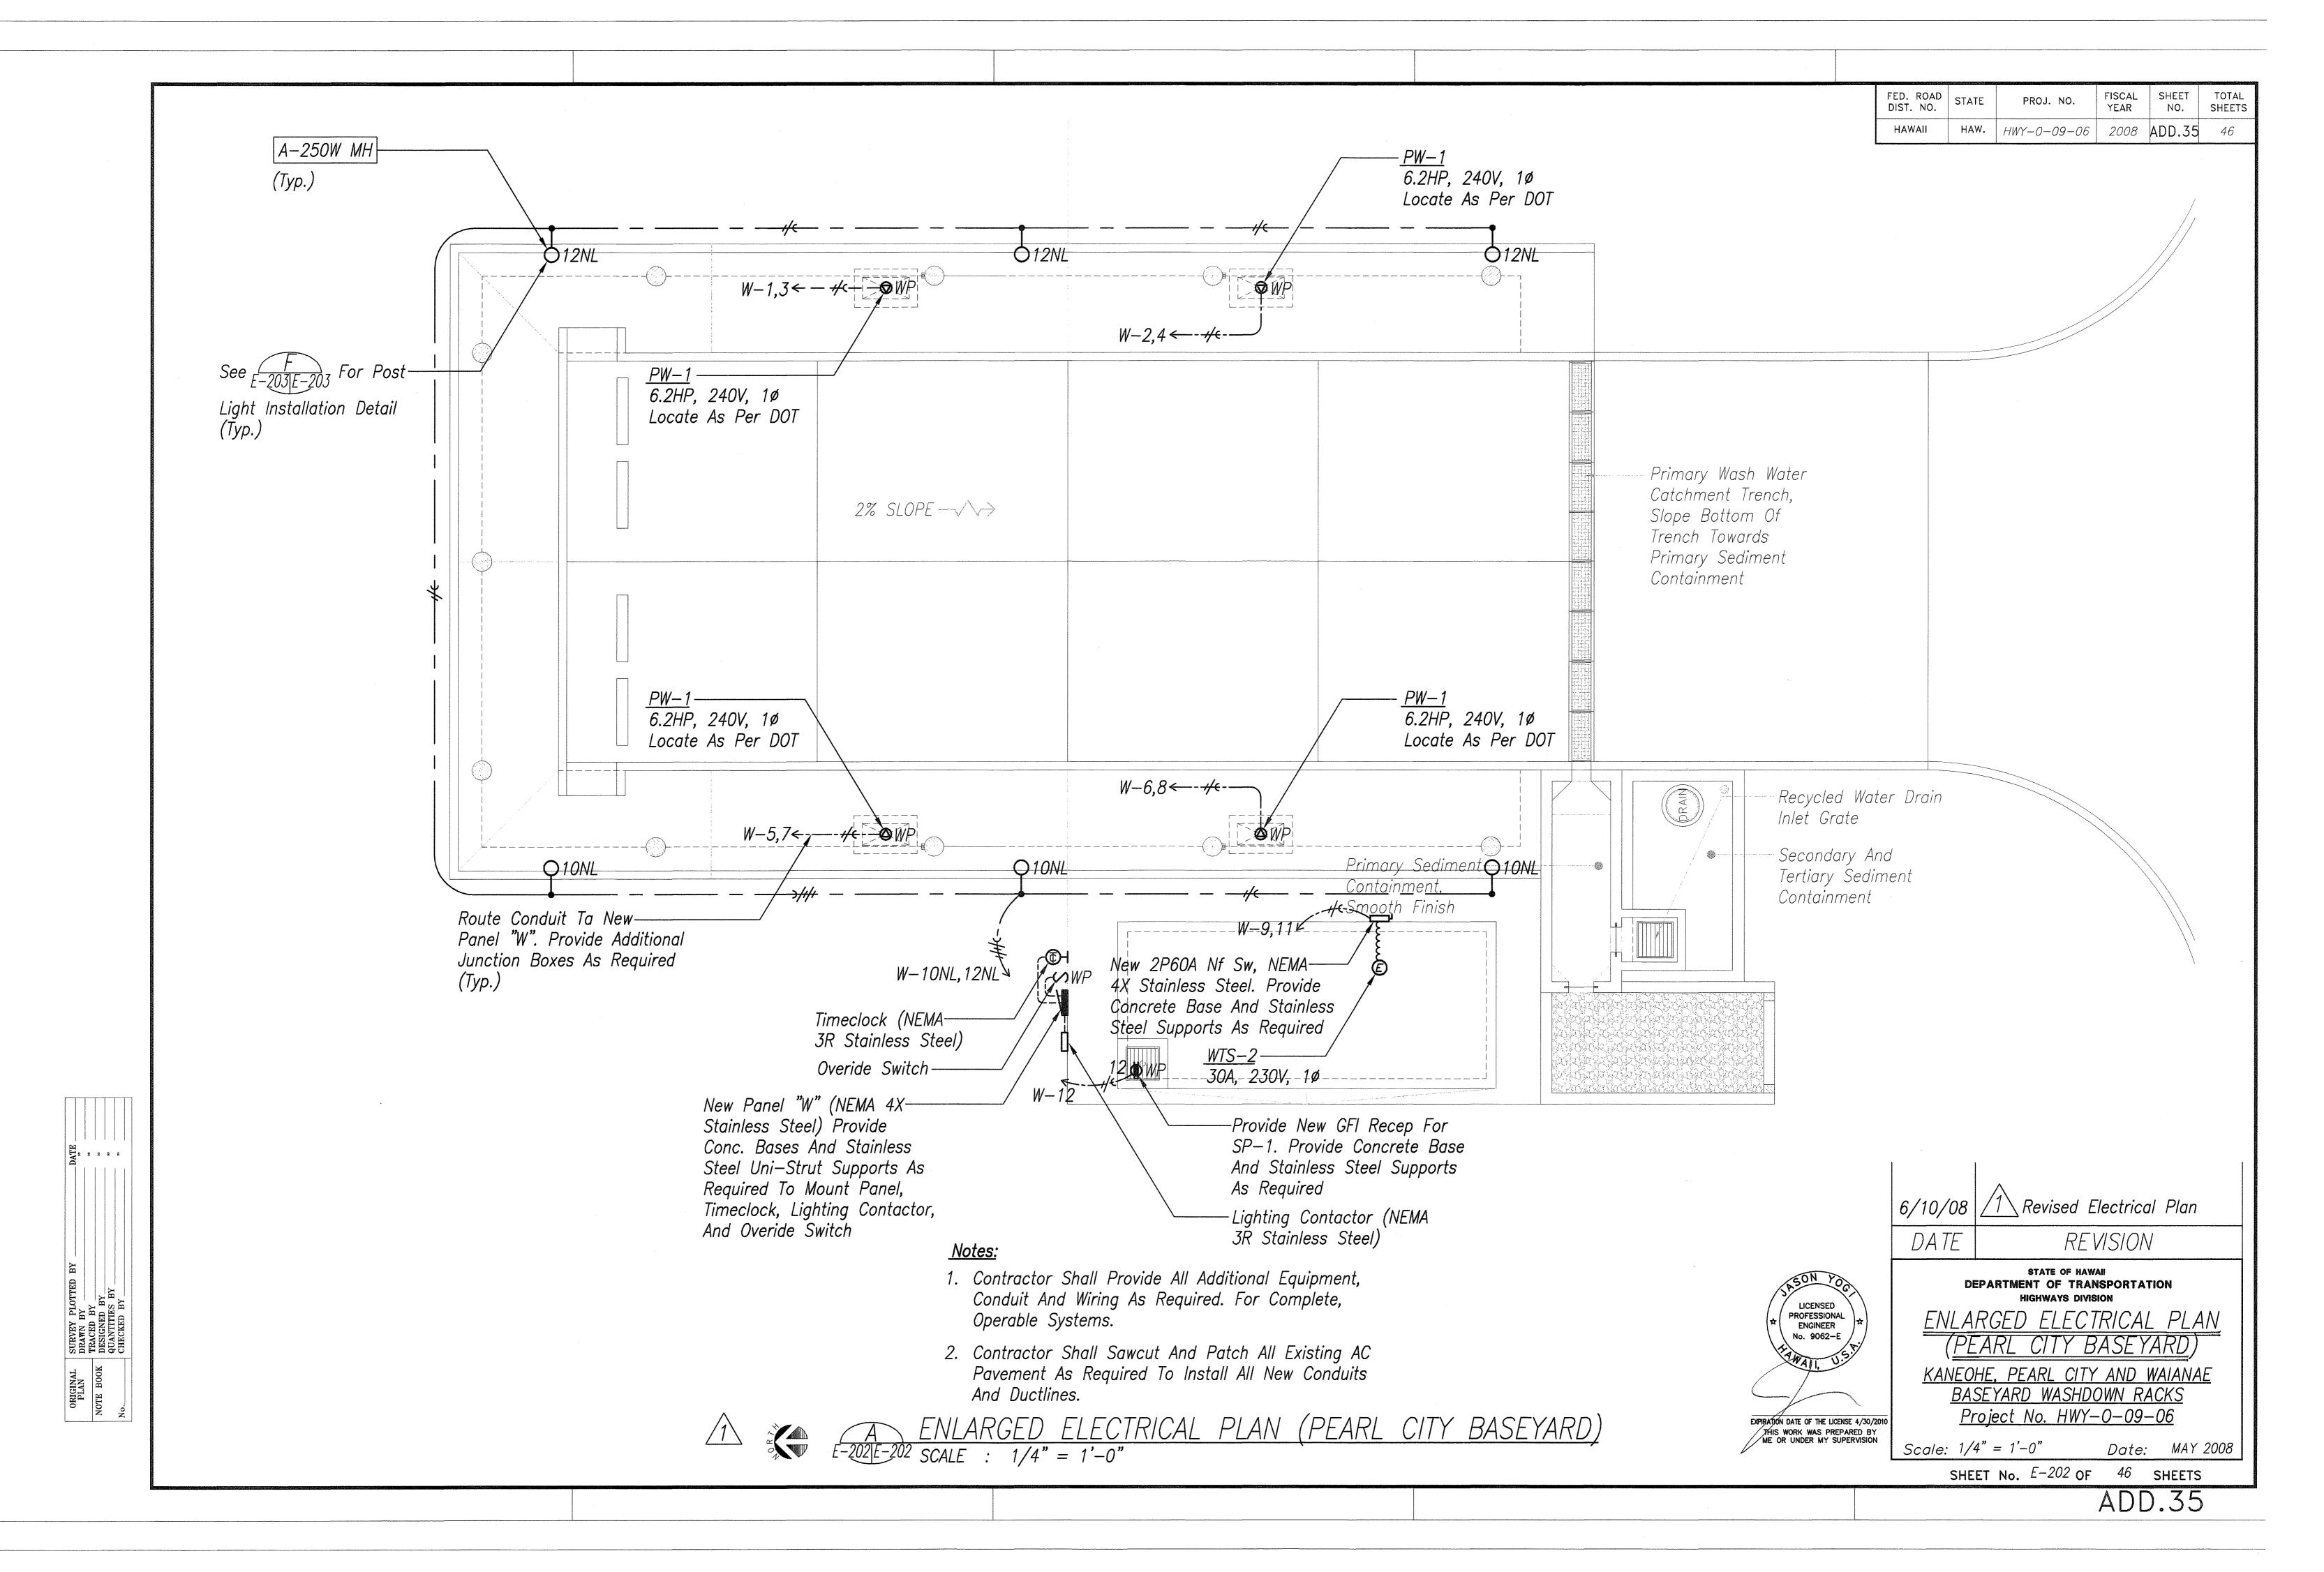

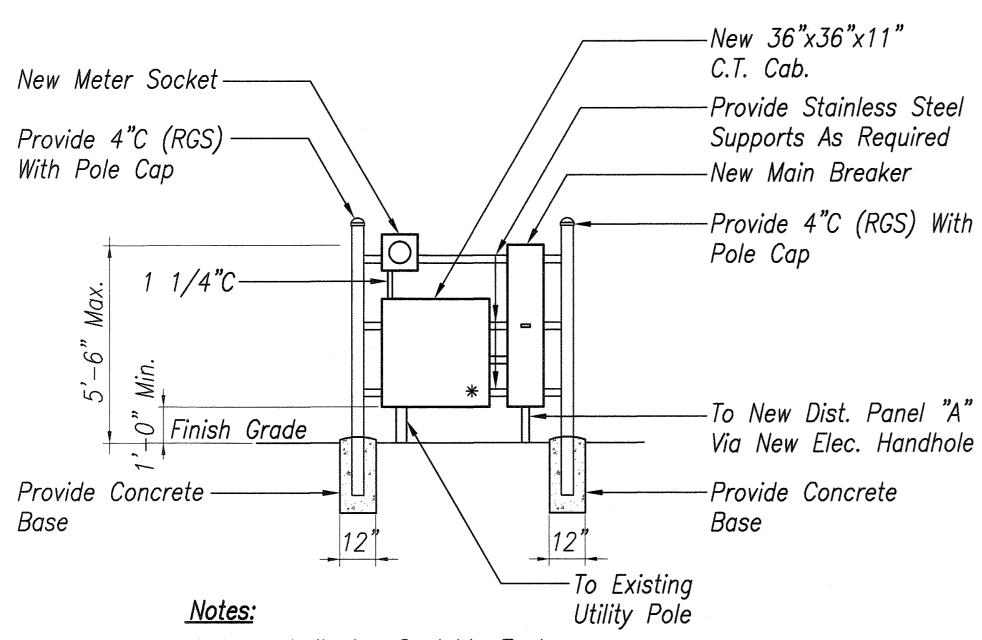

- 1. * Indicates Sealable Enclosure.
- 2. All Equipment And Enclosures Shall Be Rated NEMA 4X Stainless Steel, Weatherproof.
- 3. Provide Concrete Bollards If Required By HECO.
- 4. Coordinate All Work With HECO.

MAIN SERVICE EQUIPMENT ELEVATION E-203 E-203 SCALE : 3/8" = 1'-0"

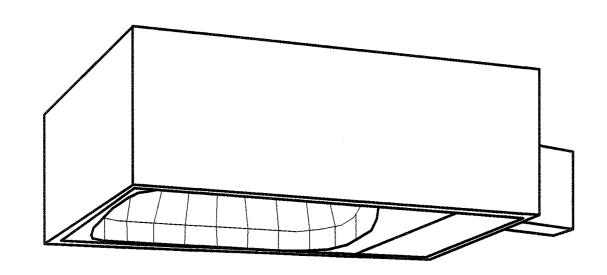

Housing: Heavy Gauge Extruded Aluminum, Mitered Corners, Minimum 10" Deep x 28-9/16" Long, Internally Welded And Sealed Corners For Weather-Tightness.

Lens Frame: Envelope-Type, One Piece Gasket That Seals Inside And Outside Of Lens, To Be 3/16" Thick Impact Resistant, Clear Tempered Glass. Door Can be Removed And Replace Without The Use Of Tools.

Ballast Assembly: Self Contained Pre-Wired Ballast Module, With Primary And Secondary Quick Dsiconnect Wiring Feature.

Reflector: One Piece Hydroformed With Specular Finish.


Optimal Cahmber: Sealed and Gasketed At Door Frame, Socket And Wire Entry.

Finish: Architectural Class | Dark Bronze Anodize Coating.


Provide Type III Distribution

120V


LUMINAIRE TYPE "A"-250W METAL HALIDE LAMP

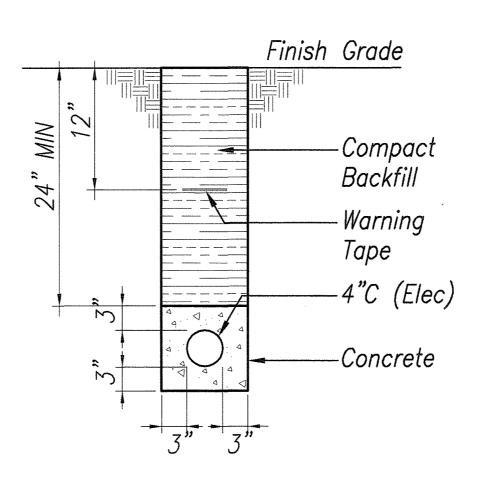



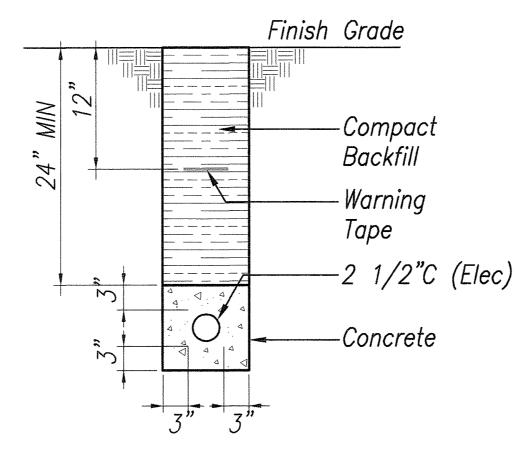




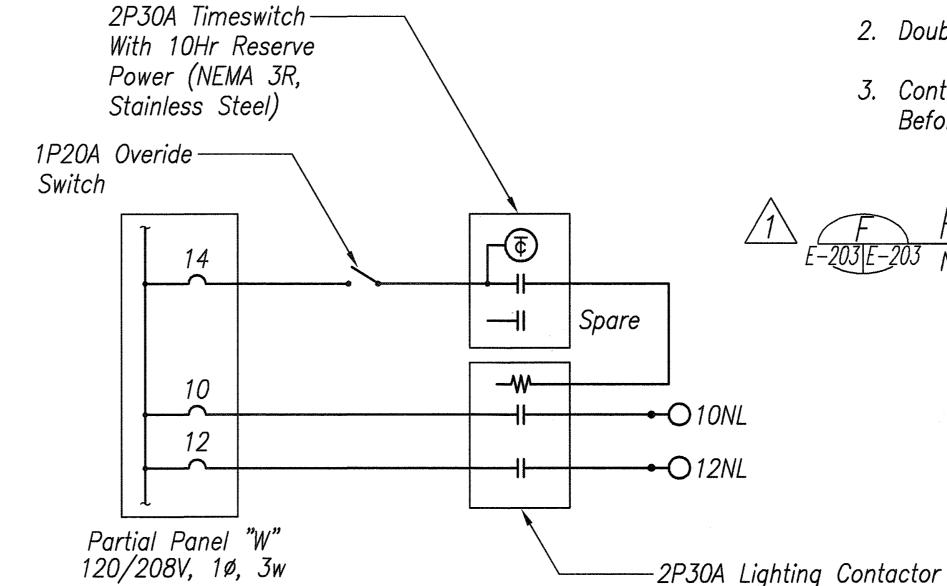

NIGHT LIGHT CONTROL WIRING DIAGRAM

(NEMA 3R, Stainless Steel)

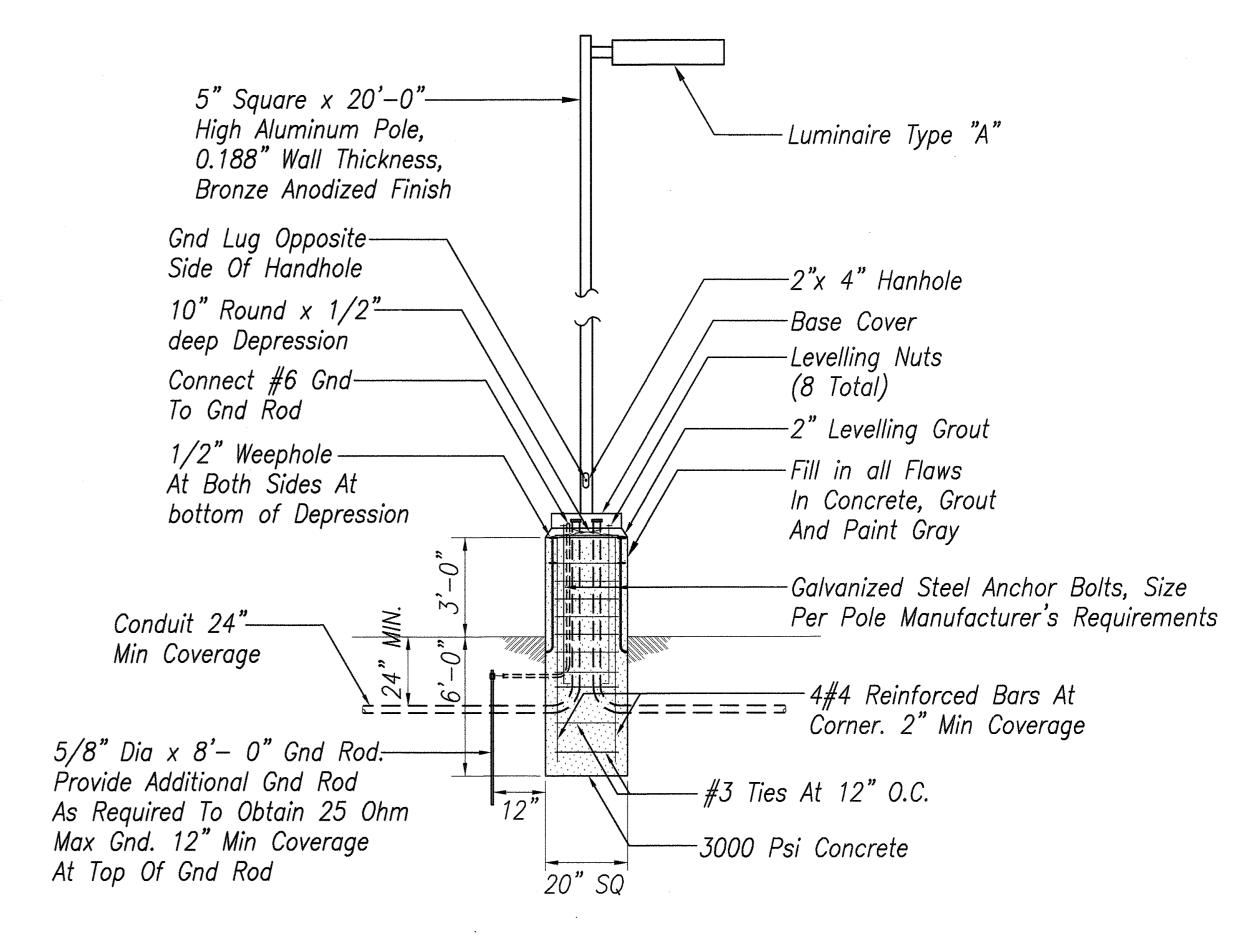

FED. ROAD DIST. NO.

1. All Bases Shall Be 2'-0" Away From Concrete Curbing And Walkways.

2. Double Nut Anchor Bolts And Coat With Bitumous Paint.

3. Contractor To Verify Exact Location Of Light Pole Bases Before Any Excavation.

POST LIGHT INSTALLATION DETAIL E-203 E-203 Not To Scale

> 1 \ Added Details And Diagram REVISION STATE OF HAWAII
> DEPARTMENT OF TRANSPORTATION LICENSED PROFESSIONAL ENGINEER DETAILS, DIAGRAM, LUM. DET. No. 9062-E AWAII, U.S.T.

(PEARL CITY BASEYARD) KANEOHE, PEARL CITY AND WAIANAE BASEYARD WASHDOWN RACKS

Project No. HWY-0-09-06 EXPIRATION DATE OF THE LICENSE 4/30/2010 THIS WORK WAS PREPARED BY ME OR UNDER MY SUPERVISION Scale: 3/8" = 1'-0"Date: MAY 2008

SHEET No. E-203 OF 46 SHEETS

ADD.36


FISCAL SHEET TOTAL YEAR NO. SHEETS

PROJ. NO.


HAW. HWY-0-09-06 2008 ADD.36



¢	FED. ROAD DIST. NO.	STATE	PROJ. NO.	FISCAL YEAR	SHEET NO.	TOTAL SHEETS
	HAWAII	HAW.	HWY-0-09-06	2008	37	46

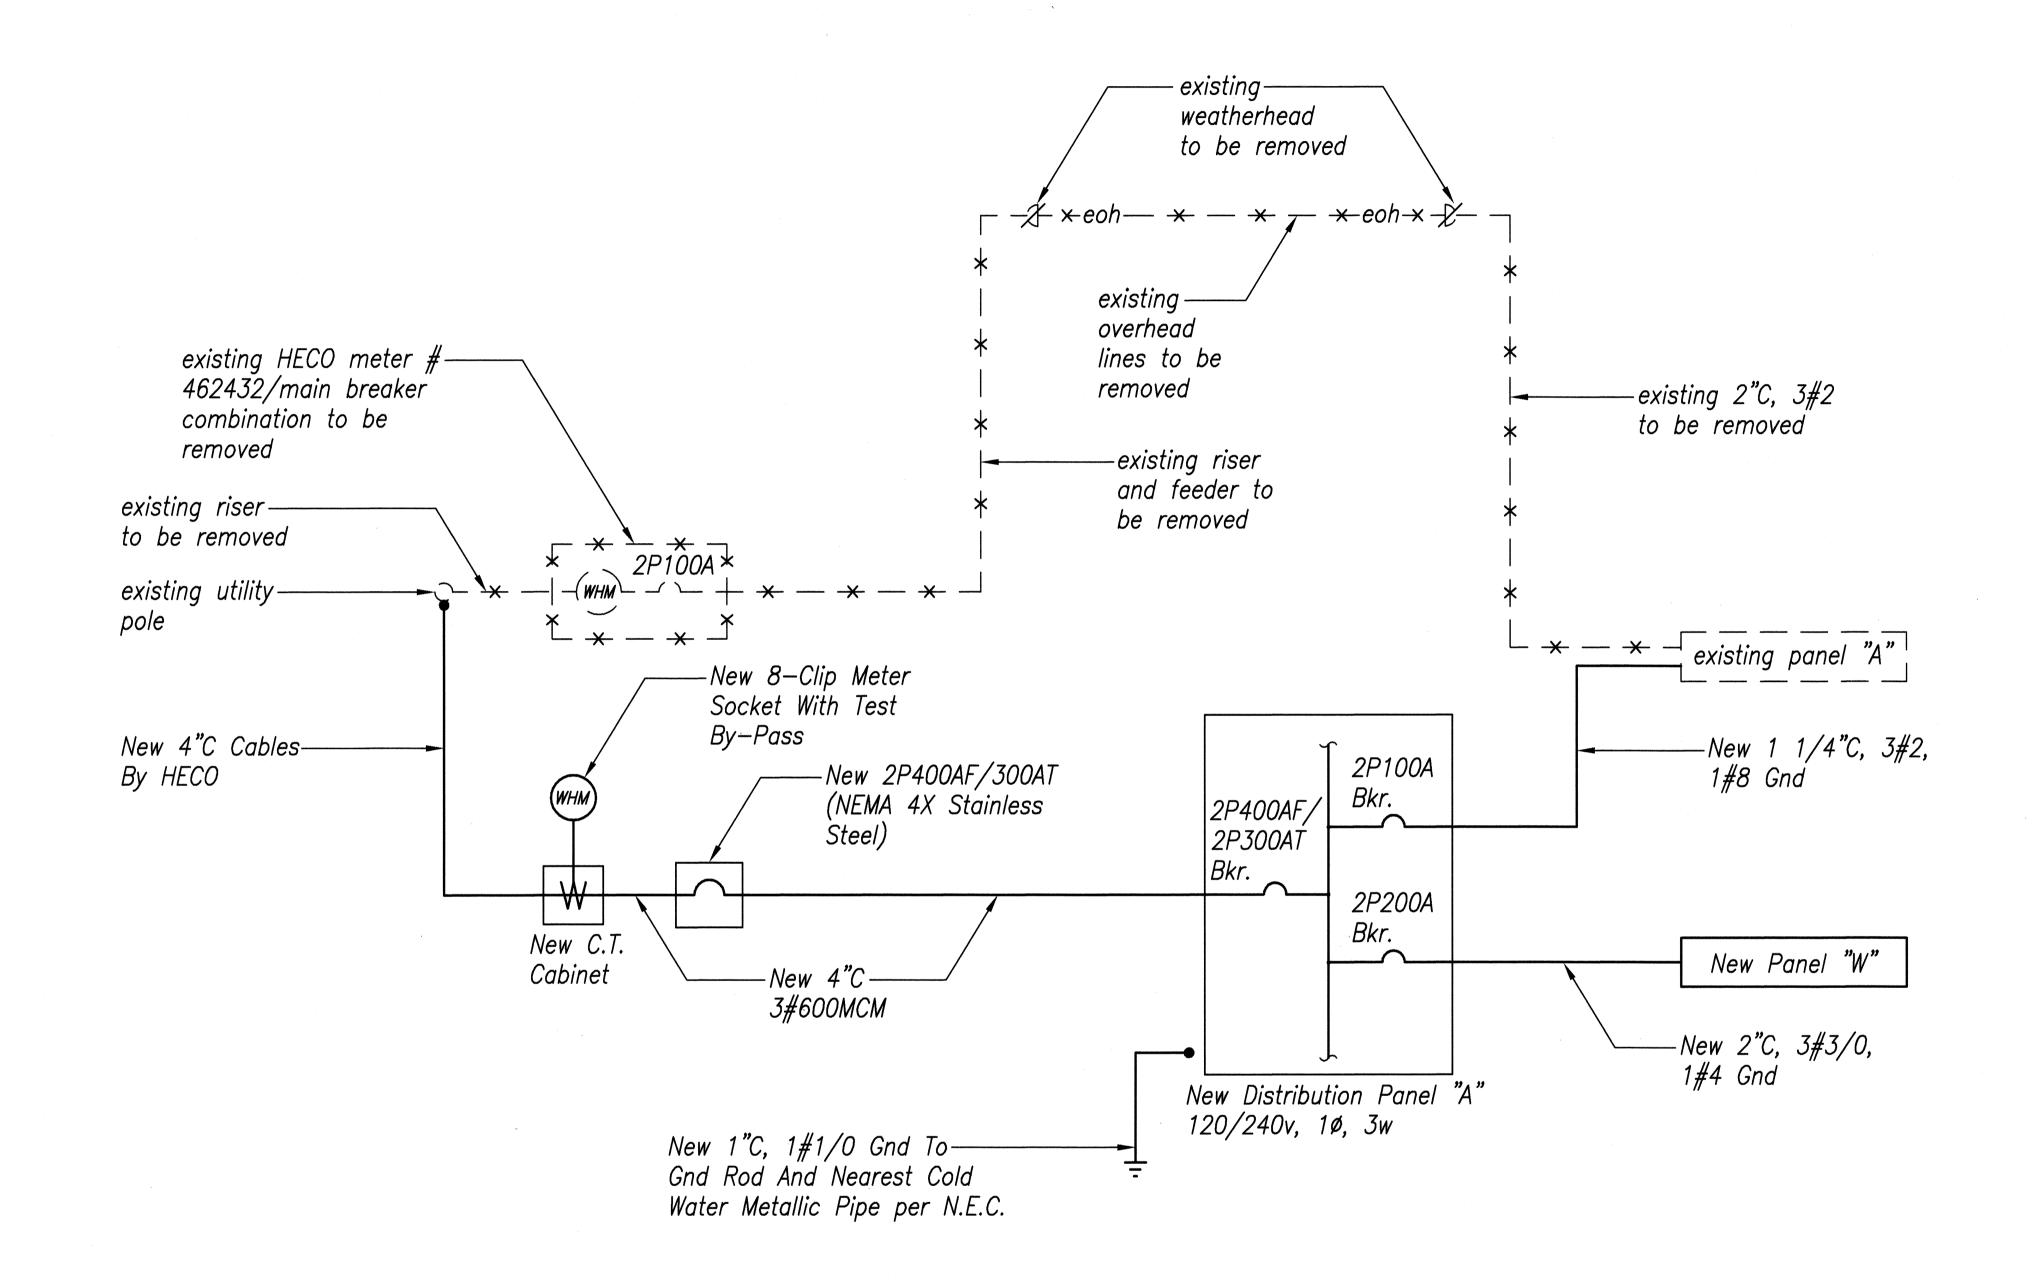

SINGLE LINE DIAGRAM (PEARL CITY BASEYARD)

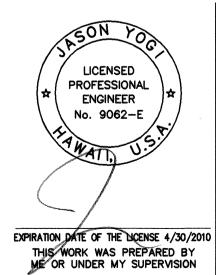

STATE OF HAWAII
DEPARTMENT OF TRANSPORTATION
HIGHWAYS DIVISION <u>SINGLE LINE DIAGRAM</u> (<u>PEARL CITY BASEYARD</u>) KANEOHE, PEARL CITY AND WAIANAE BASEYARD WASHDOWN RACKS Project No. HWY-0-09-06 Date: MAY 2008

SHEET No. E-204 OF 46 SHEETS

37

DATE "