



FED. ROAD DIST. NO.	STATE	FED. AID PROJ. NO.	FISCAL YEAR	SHEET NO.	TOTAL SHEETS
HAWAII	HAW.	RS-0378(1)	1980	10	18

GENERAL NOTES


- Signs 48" and wider or larger than 10 sq. ft. in area shall be mounted on two sign posts.
- All signs larger than 10 sq. ft. in area or 48" inches and wider, and mounted on other than two posts supports (i.e., on highway lighting poles) shall have at least two sets of band brackets and back braces.
- All signs 28 sq. ft. in area or larger and mounted on other than two posts supports (i.e., on highway lighting poles) shall have at least three sets of band brackets and back braces.
- All parking restriction signs with arrows shall be mounted 45° to the line of traffic flow.
- Sign posts shall extend 3 1/2" above sign where required for City and County street name signs.
- (R) or (L) indicates right or left and shall be as shown on the plans.
- See plans for special details.
- When clear roadside recovery areas are provided, Signs shall be placed as far from the edge of traveled way as possible up to a maximum of 30 feet. When possible they shall be placed in protected locations.
- Signs in medians shall be placed at midpoint of median up to a maximum distance of 30 feet from the edge of traveled way. When appropriate, signs for opposing directions shall be placed back to back.

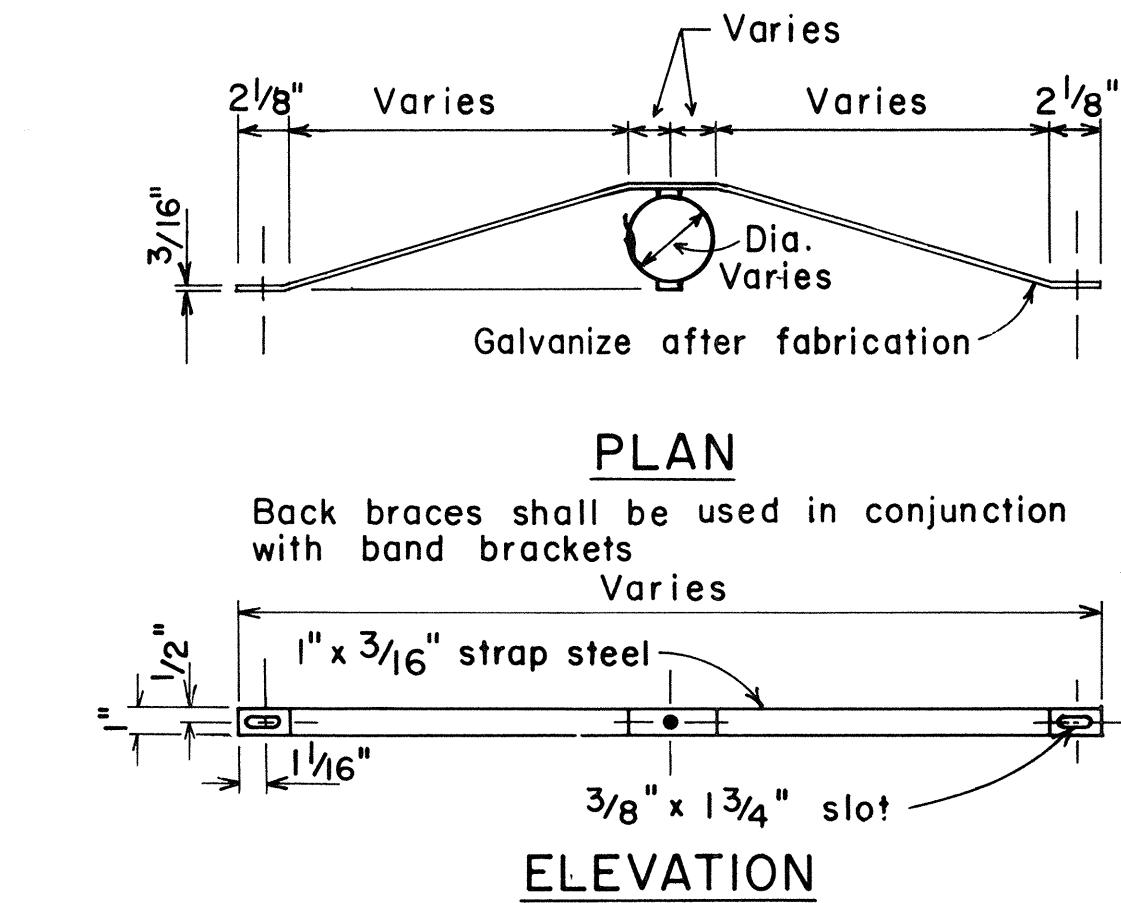

BACK BRACE DETAILS FOR BALANCED SIGN INSTALLATION

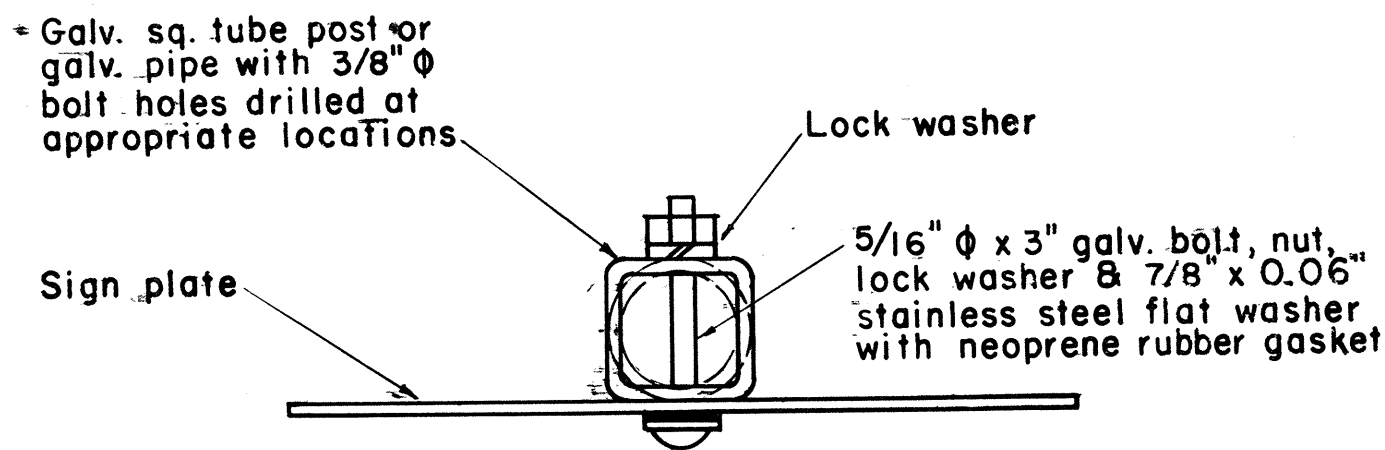

GALVANIZED SQUARE TUBE POST (OR GALVANIZED PIPE)

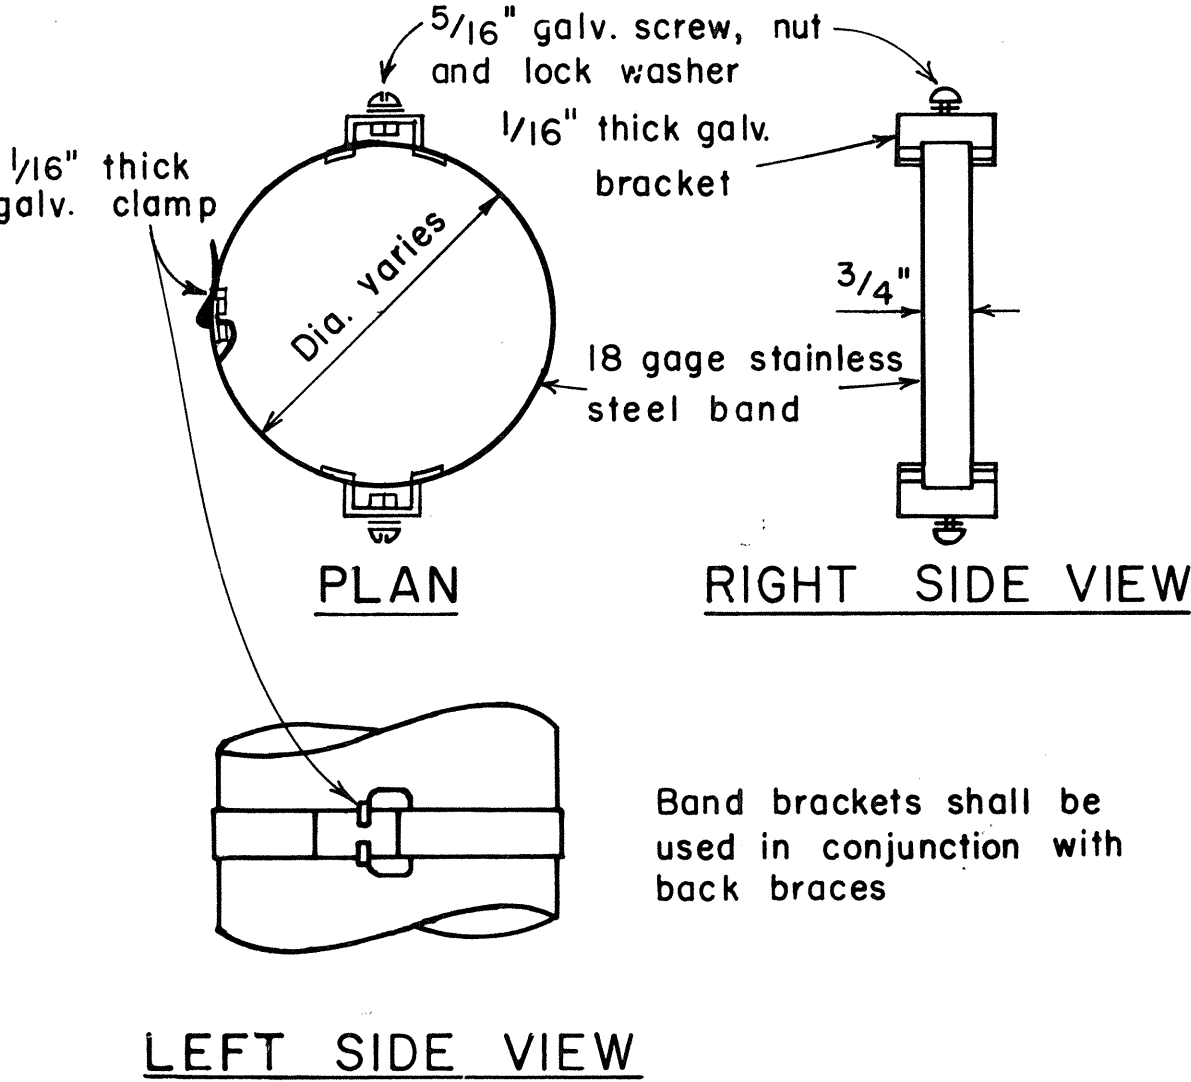

BAND BRACKET

TYPICAL MOUNTING DETAILS



NOT TO SCALE

NO.	REVISION	APPROVED BY	DATE
1	Supercedes Sht. DT-100 approved 12/30/69	H.T.	11/15/77
2	Revised depth of signpost	H.T.	5/23/79
3	Added Notes No. 8 & No. 9	H.T.	5/18/79
4	Revised Gen. Note #4 & Mounting Details	H.T.	4/23/80

APPROVAL RECOMMENDED:
Ernie Tanaka 11/15/77
 TRAFFIC ENGINEER DATE

APPROVED:
Harbert B. Delaich 11/15/77
 ASSISTANT CHIEF, ENGINEERING DATE


STATE OF HAWAII DEPARTMENT OF TRANSPORTATION HIGHWAYS DIVISION
STANDARD DETAILS
MISCELLANEOUS SIGN DETAILS
Not to scale June, 1977
SHEET NO. 1 OF 9 SHEETS DT 100

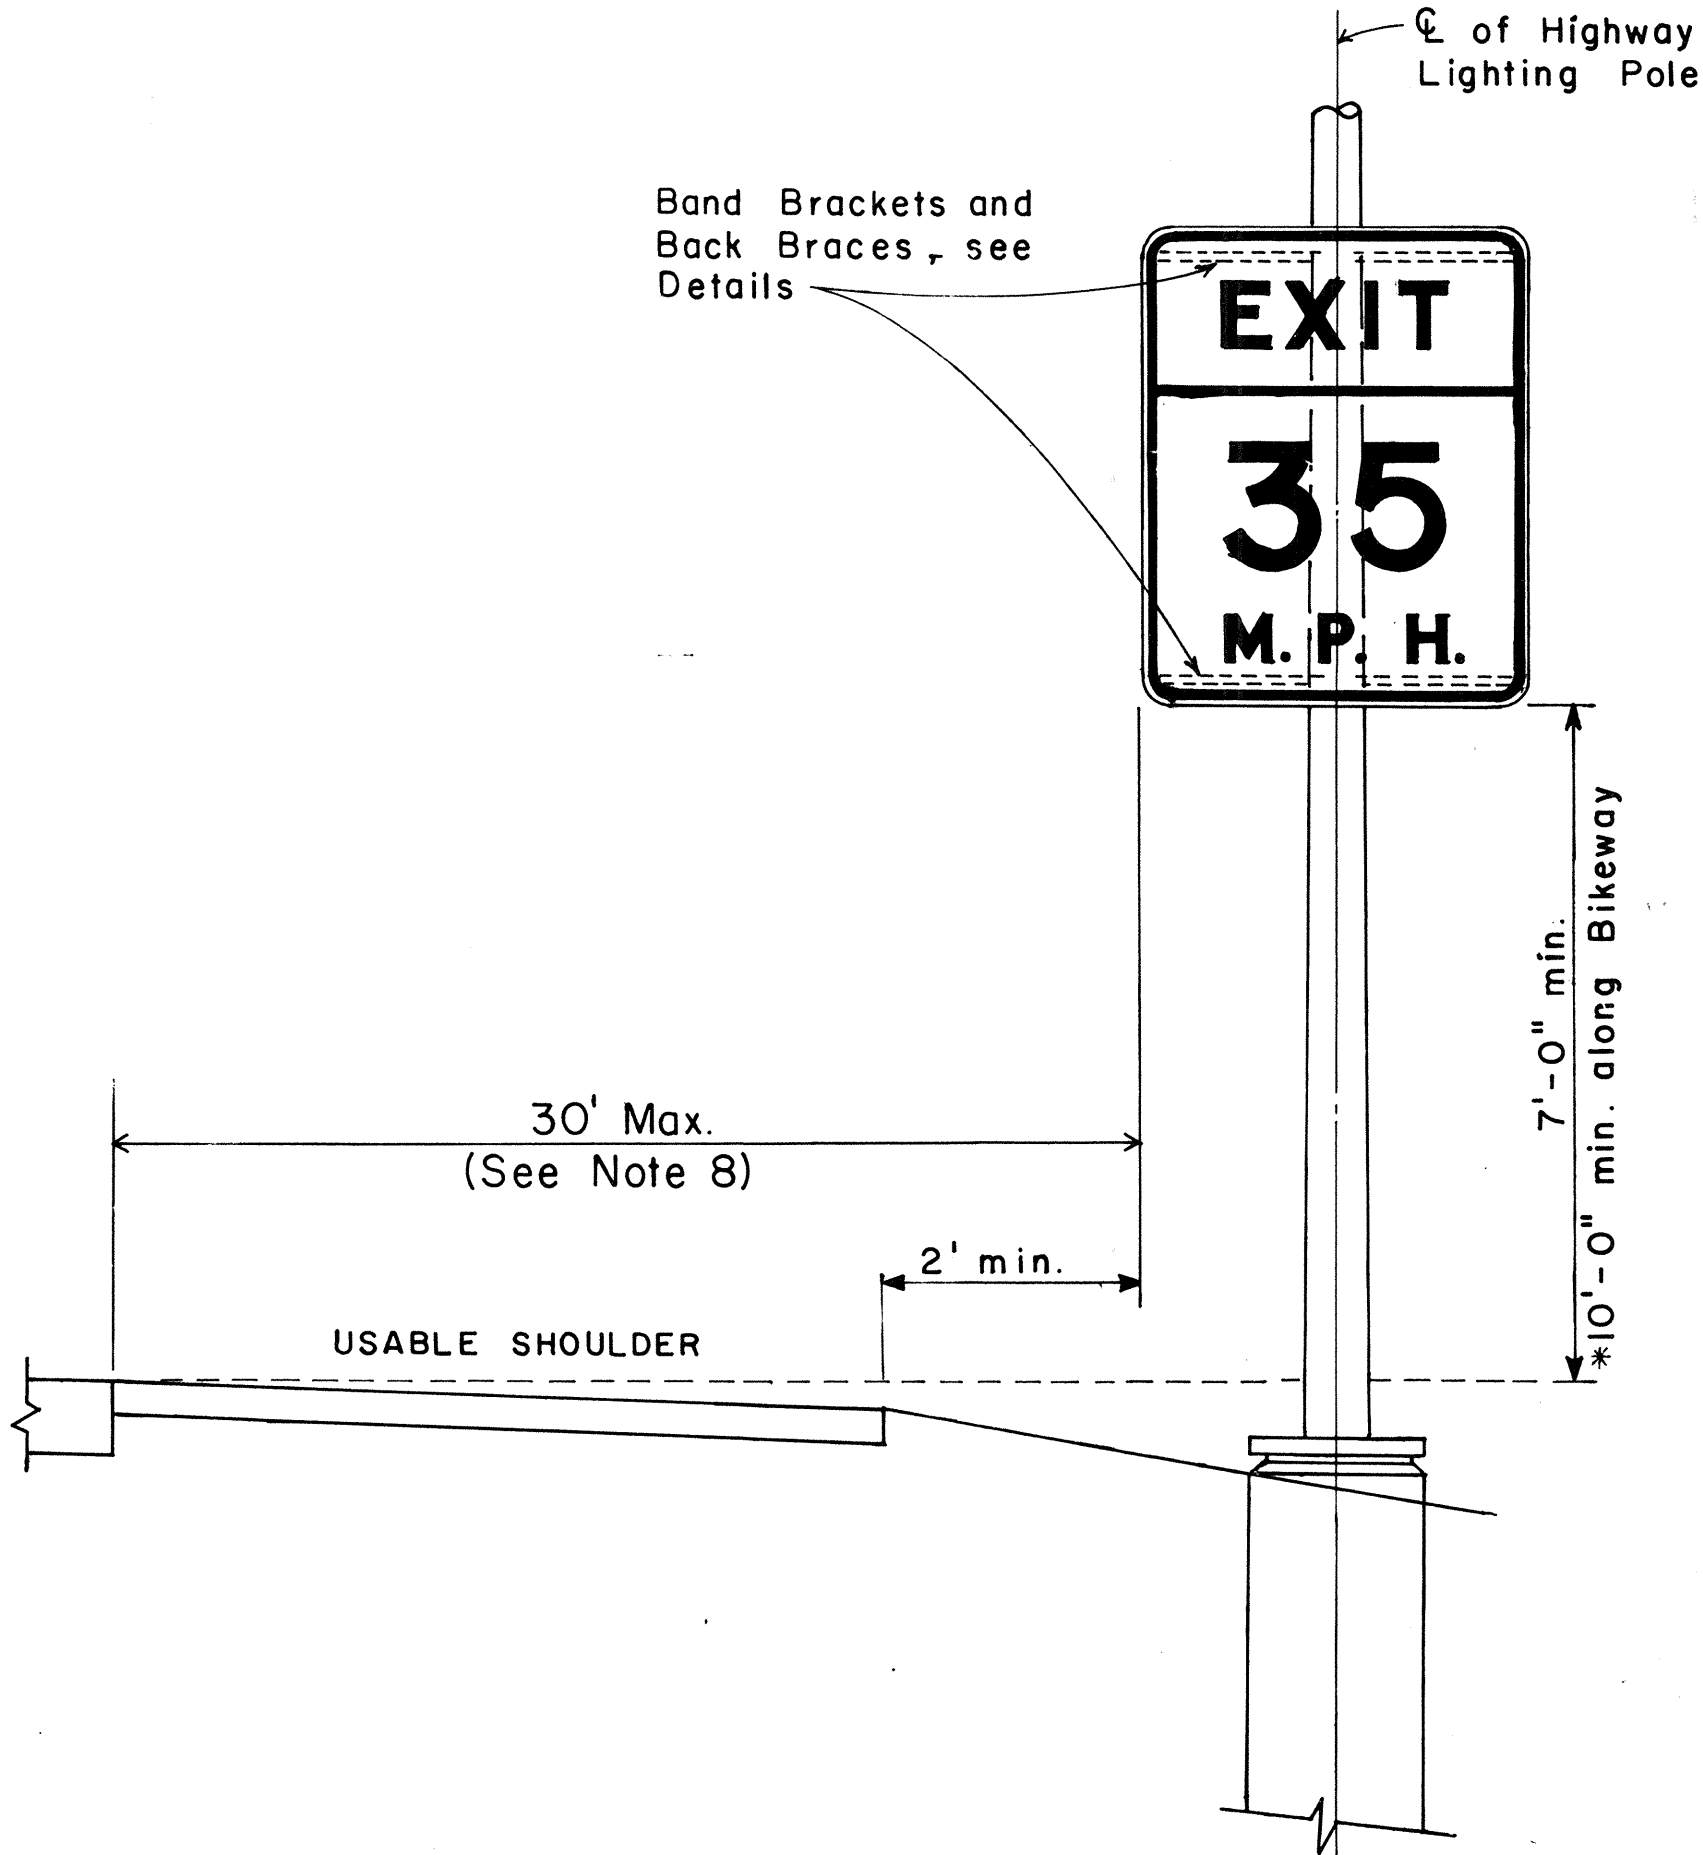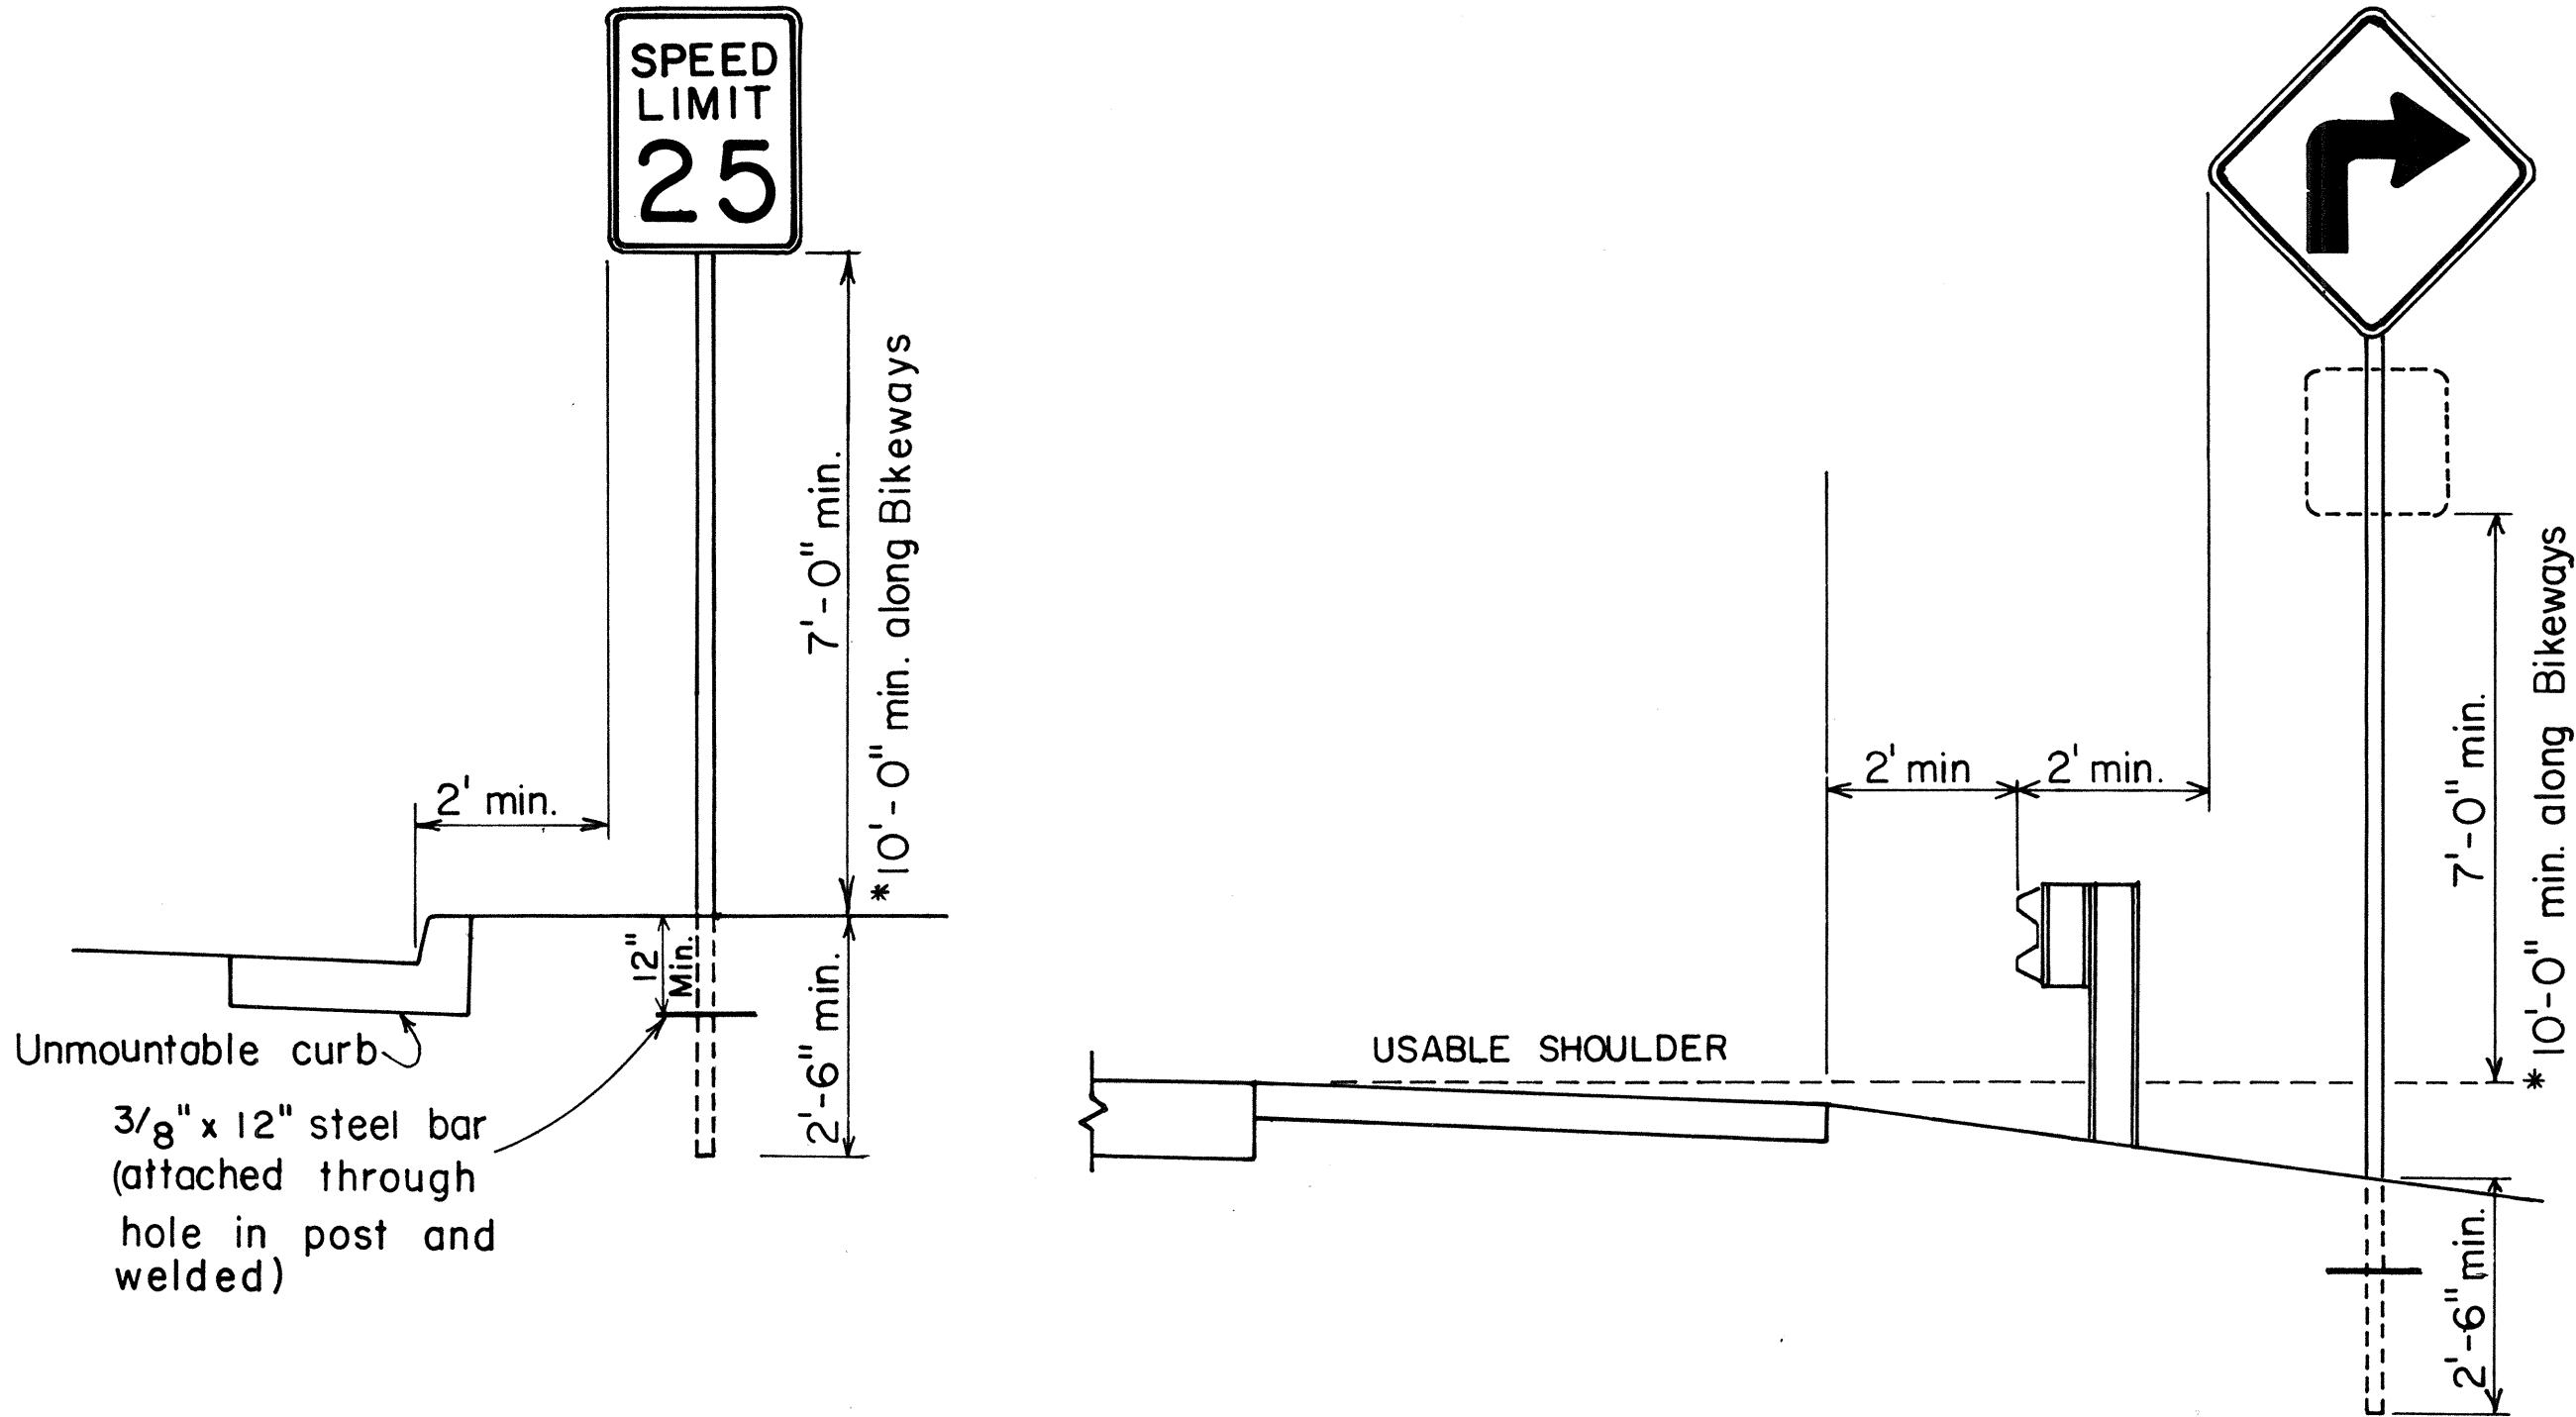

HEIGHT AND LATERAL LOCATION OF SIGNS TYPICAL INSTALLATION

SURVEY PLOTTED BY	DATE
DRAWN BY	
DESIGNED BY	
CHECKED BY	
NO.	


FED. ROAD DIST. NO.	STATE	FED. AID PROJ. NO.	FISCAL YEAR	SHEET NO.	TOTAL SHEETS
HAWAII	HAW.	RS-0378(1)	1980	11	18

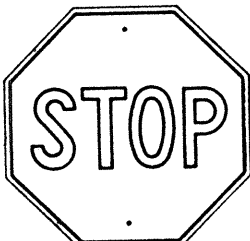


R1-1 30"x 30"
R1-1-A 36"x 36"

4-WAY


R1-3 12"x 6"
R1-3-A 18"x 9"

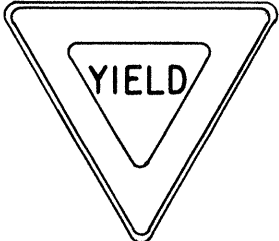


R1-2 36"x 36"x 36"
R1-2-A 48"x 48"x 48"

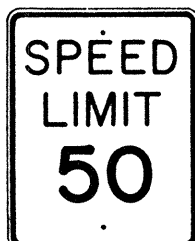


R2-1(50) 24"x 30"
R2-1(50)-A 48"x 60"




R2-2(40) 24"x 24"
R2-2(40)-A 48"x 48"

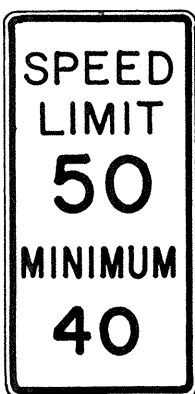


R2-4a(50/40) 24"x 48"
R2-4a(50/40)-A 48"x 96"

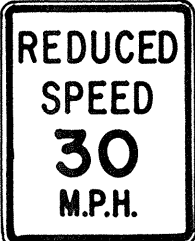


R2-5b(30) 24"x 30"
R2-5b(30)-A 48"x 60"




R3-1 24"x 24"
24"x 18"
R3-1-A 48"x 48"
48"x 36"




R3-2 24"x 24"
24"x 18"
R3-2-A 48"x 48"
48"x 36"




R3-3 24"x 24"
R3-3-A 48"x 48"

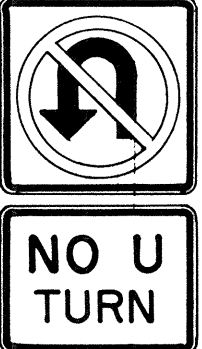


R3-4 24"x 24"
24"x 18"
R3-4-A 48"x 48"
48"x 36"

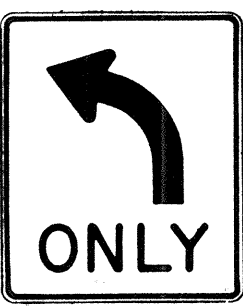


R3-5(L) 30"x 36"
R3-5(L)-A 48"x 60"

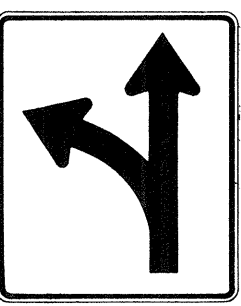


R3-6(L) 30"x 36"
R3-6(L)-A 48"x 60"




R3-7(R) 30"x 30"
R3-7(R)-A 48"x 48"

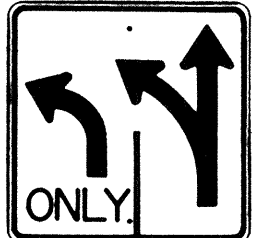


R3-8(L) 30"x 30"
R3-8(L)-A 36"x 36"
R3-8(L)-B 48"x 48"

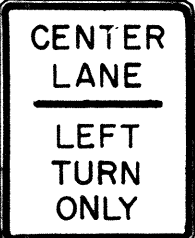


R3-9 24"x 30"




R4-1 24"x 30"




R4-2 24"x 30"

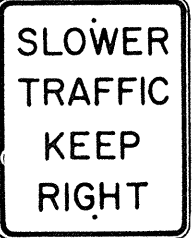


R4-3 24"x 30"
R4-3-A 48"x 60"

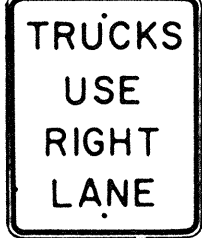


R4-5 24"x 30"

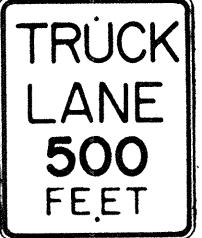


R4-6(500) 24"x 30"




R4-7 24"x 30"
24"x 18"




R4-8 24"x 30"
24"x 18"

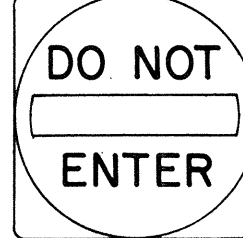


R5-1 30"x 30"
R5-1-A 48"x 48"

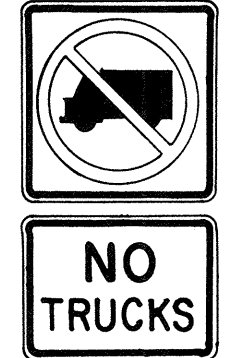


R5-2 24"x 24"
24"x 18"

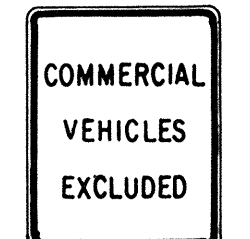


R5-4 24"x 30"




R5-6 24"x 24"
24"x 18"




R5-9 36"x 24"




R6-1 (R) 36"x 12"




R6-2(R) 18"x 24"




R7-1 12"x 18"
R7-1-A 24"x 30"

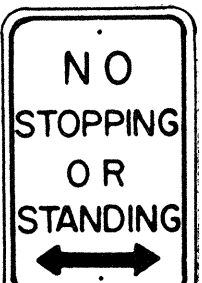


R7-4 12"x 18"
R7-4-A 24"x 30"

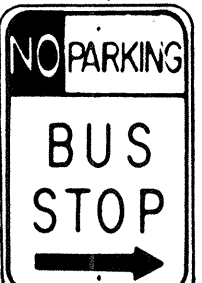


R7-1, 7(R) 12"x 18"

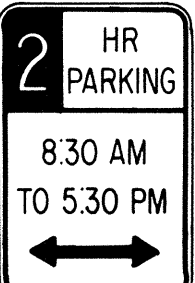


R7-108 12"x 18"




R7-201 12"x 6"
R7-201-A 24"x 12"




R8-1 24"x 30"




R8-2 24"x 30"




R8-3 24"x 30"




R8-4 30"x 24"
R8-4-A 48"x 36"




R8-5 24"x 30"

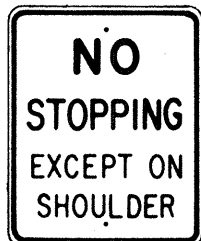


R8-6 24"x 30"

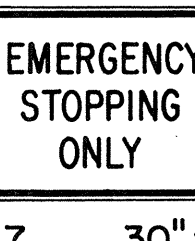


R8-7 30"x 24"
R8 7-A 48"x 36"

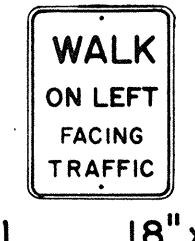


R9-1 18"x 24"

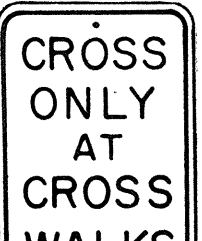


R9-2 12"x 18"




R9-3 12"x 18"




R9-4 18"x 24"

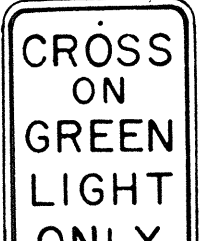


R10-1 12"x 18"




R10-2 12"x 18"




R10-3 9"x 12"




R10-4 9"x 12"




R10-5 24"x 30"




R10-6 24"x 36"

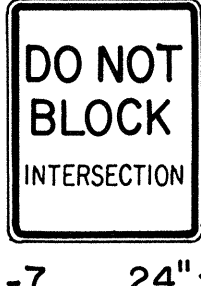


R10-7 24"x 30"

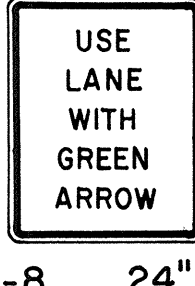


R10-8 24"x 30"

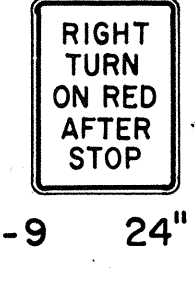


R10-9 24"x 30"

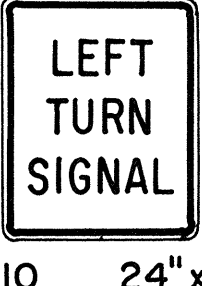


R10-10 24"x 30"




R11-1 24"x 30"




R11-2 48"x 30"

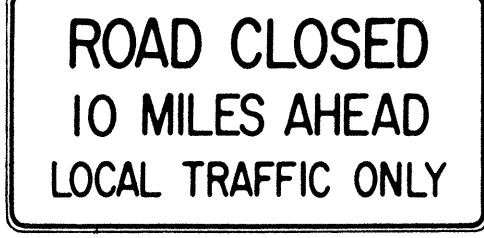

R11-3(10) 60"x 30"

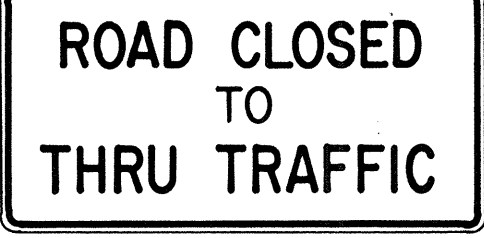

R11-4 60"x 30"

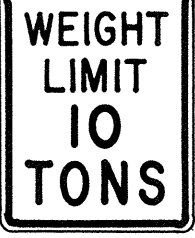

R12-1(10) 24"x 30"

GENERAL NOTES

- Sign details shall conform to the FHWA publications "Manual on Uniform Traffic Control Devices for Streets and Highways," 1971, and "Standard Highway Signs," 1972, and as amended.
- All regulatory signs shall be reflectorized unless otherwise specified.
- All regulatory signs shall have 3/8" bolt holes drilled at appropriate locations.
- Numerals in () indicates numerals to be inserted for sign message. (R) or (L) indicates right or left.
- All signs shall be erected without educational plaques unless called for in the plans.

APPROVAL RECOMMENDED:
Enishi Tanaka 3/17/72
 TRAFFIC ENGINEER DATE

APPROVED:
Robert J. Davis 3-20-72
 ASSISTANT CHIEF, ENGINEERING DATE

NO.	REVISION	APPROVED BY	DATE
1	Supersedes Sht. DT 101 Approved 12-30-69	H.T.	3/20/72
2	Revised General Note 1.	H.T.	10/14/74
3	Added General Note 5	H.T.	6/9/79

STATE OF HAWAII

DEPARTMENT OF TRANSPORTATION

HIGHWAYS DIVISION

STANDARD DETAILS


REGULATORY SIGNS

NOT TO SCALE

SHEET No. 2 OF 9 SHEETS DT 101

SURVEY PLOTTED BY	DATE
DRAWN BY	
CHECKED BY	
DESIGNED BY	
QUANTITIES BY	
CHECKED BY	
ORIGINAL PLAN	
NOTE BOOK	
No.	


FED. ROAD DIST. NO.	STATE	FED. AID PROJ. NO.	FISCAL YEAR	SHEET NO.	TOTAL SHEETS
HAWAII *	HAW.	RS0378(1)	1980	12	18

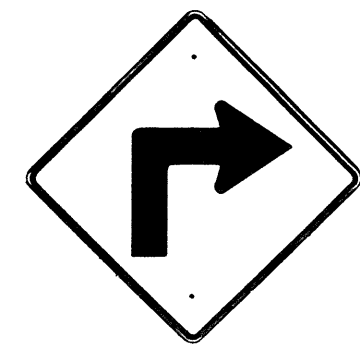

W1-1(R) 30"x30"
W1-1(R)-A 48"x48"



W1-2(R) 30"x30"
W1-2(R)-A 48"x48"

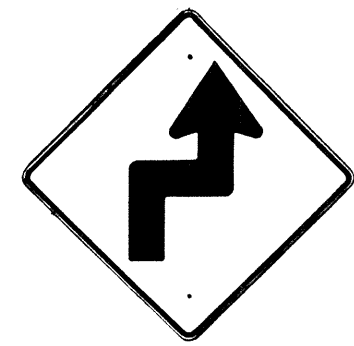


W1-3(R) 30"x30"
W1-3(R)-A 48"x48"




W1-4(R) 30"x30"
W1-4(R)-A 48"x48"




W1-5(R) 30"x30"
W1-5(R)-A 48"x48"

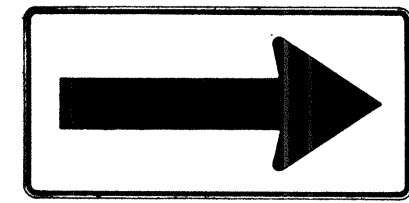


W1-6 48"x24"

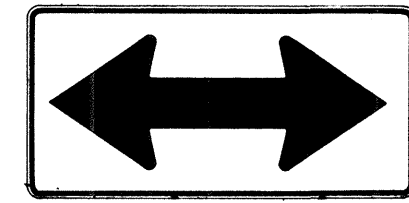


W1-7 48"x24"

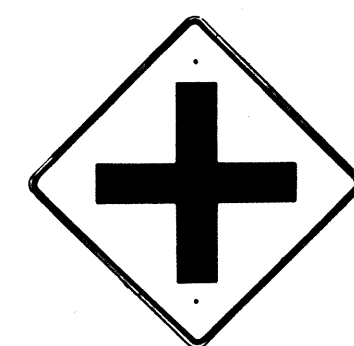


W2-1 30"x30"
W2-1-A 48"x48"

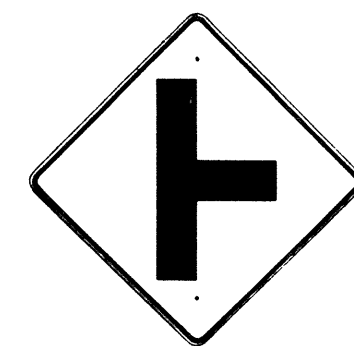


W2-2 30"x30"
W2-2-A 48"x48"

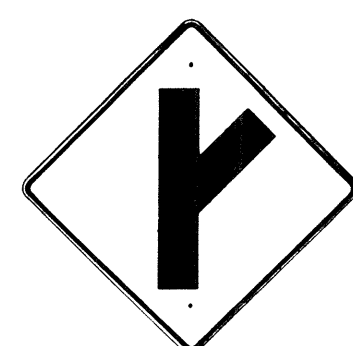

W2-3(R) 30"x30"
W2-3(R)-A 48"x48"

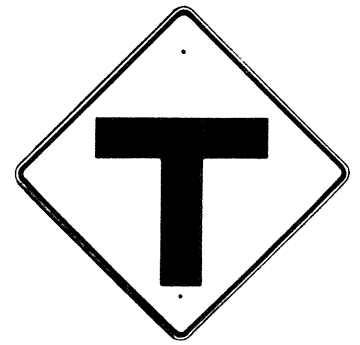

W2-4 30"x30"
W2-4-A 48"x48"

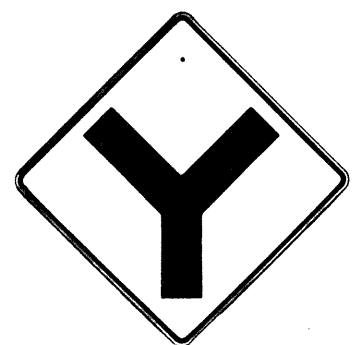


W2-5 30"x30"
W2-5-A 48"x48"




W3-1 30"x30"
W3-1-A 36"x36"




W3-2 30"x30"
W3-2-A 36"x36"

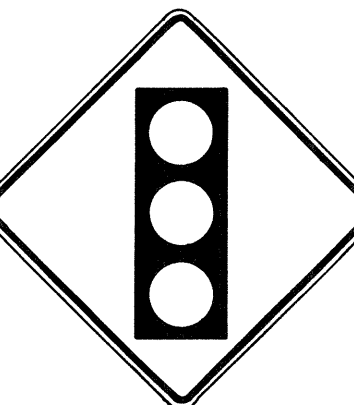

W3-3 36"x36"
24"x18"

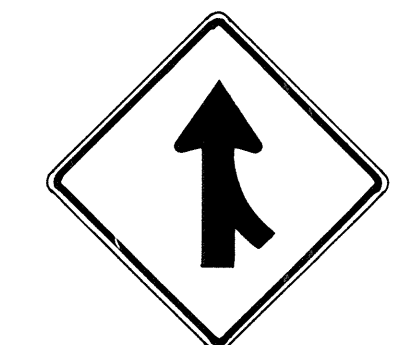

W4-1(R) 30"x30"
24"x18"
W4-1(R)-A 48"x48"
24"x18"

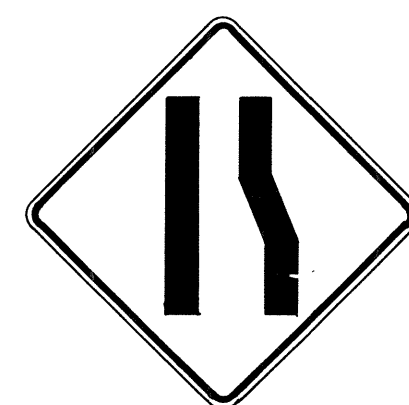

W4-2(R) 36"x36"
W4-2(R)-A 48"x48"



W5-1 36"x36"



W5-2 30"x30"
W5-2-A 36"x36"




W5-3 36"x36"



W6-1 36"x36"
24"x18"



W6-2 36"x36"
24"x18"

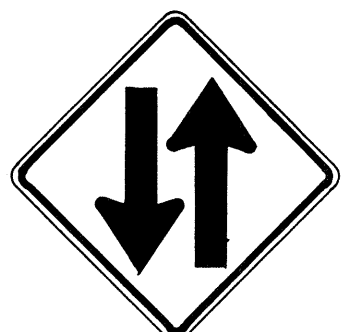

W6-3 30"x30"
24"x18"
W6-3-A 36"x36"
24"x18"
W6-3-B 48"x48"
24"x18"



W7-1 30"x30"
24"x18"
W7-1-A 36"x36"
24"x18"



W7-2 24"x18"



W8-1 30"x30"
W8-1-A 36"x36"



W8-2 30"x30"
W8-2-A 36"x36"



W8-3 30"x30"
W8-3-A 36"x36"



W8-4 30"x30"
W8-4-A 36"x36"



W8-5 30"x30"
24"x18"
W8-5-A 36"x36"
24"x18"



W9-1(R) 30"x30"
W9-1(R)-A 36"x36"
W9-1(R)-B 48"x48"



W9-2(L) 36"x36"
W9-2(L)-A 48"x48"



W10-1 36" Diameter



W11-1 30"x30"
24"x18"
W11-1-A 36"x36"
24"x18"




W11-2 30"x30"
24"x18"
W11-2-A 36"x36"
24"x18"



W11-4 30"x30"
24"x18"
W11-4-A 36"x36"
24"x18"



W11-5 30"x30"
24"x18"
W11-5-A 36"x36"
24"x18"

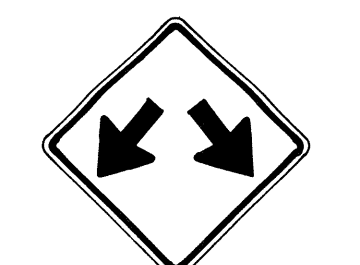


W12-1 24"x24"
W12-1-A 36"x36"
W12-1-B 48"x48"




W12-2(12'-6") 36"x36"
24"x18"



W13-1(25) 18"x18"
W13-1(25)-A 24"x24"

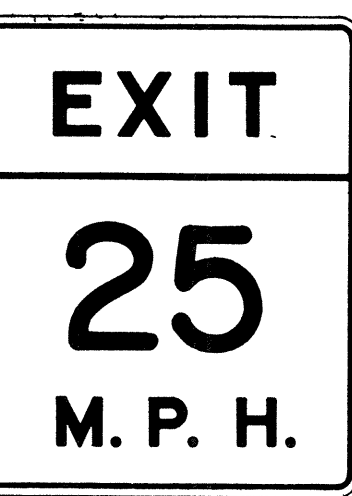

W13-2(25) 48"x60"

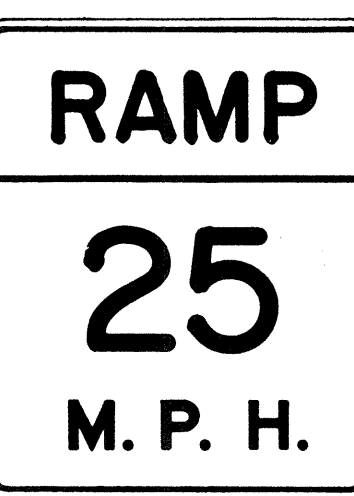

W13-3(25) 48"x60"



W14-1 30"x30"



W14-3 36"x48"x48"

GENERAL NOTES

- Sign details shall conform to the FHWA publications "Manual on Uniform Traffic Control Devices for Streets and Highways," 1971, and "Standard Highway Signs," 1972, and as amended.
- All warning signs shall be reflectorized unless otherwise specified.
- All warning signs shall have 3/8" bolt holes drilled at appropriate locations.
- Numerals in () indicates numerals to be inserted for sign message. (R) or (L) indicates right or left.
- Signs prefixed with "CW" on the plans shall indicate orange and black construction signs, and shall be reflectorized.

APPROVAL RECOMMENDED:
Ernie Tanaka
TRAFFIC ENGINEER

3/17/72
DATE

APPROVED:
Shirley S. Sisk
ASSISTANT CHIEF, ENGINEERING

3-20-72
DATE

NO.	REVISION	APPROVED BY	DATE
1	Supersedes Sht. DT 102 Approved 12-30-69	H.C.	3/20/72
2	Revised General Note 1	H.C.	10/16/74
3	Revised General Note 5	MT	9-16-75
4	Revised General Note 5	H.C.	9-14-76
5	Added Note 1	H.C.	11-9-79

STATE OF HAWAII DEPARTMENT OF TRANSPORTATION HIGHWAYS DIVISION
STANDARD DETAILS WARNING SIGNS
NOT TO SCALE
SHEET No. 3 OF 3 SHEETS DT 102

NOTE

- All signs shall be erected without educational plaques unless called for in the plans.

SURVEY PLOTTED BY	DATE
DESIGNED BY	
NOTED BY	
CHECKED BY	
NO.	

FED. ROAD DIST. NO.	STATE	FED. AID PROJ. NO.	FISCAL YEAR	SHEET NO.	TOTAL SHEETS
HAWAII	HAW.	RS-0378(1)	1980	13	18



CW20-1a 48" x 48"



CW20-2d 48" x 48"



CW20-3b 48" x 48"



CW20-4d 48" x 48"



CW20-5d(L) 48" x 48"



CW20-7c 48" x 48"



CW21-1 30" x 30"



CW21-2 30" x 30"



CW21-3 36" x 36"



CW21-4 36" x 36"



CW21-5 30" x 30"




CW21-6 30" x 30"



CW22-1b 48" x 48"




CW22-2 42" x 36"

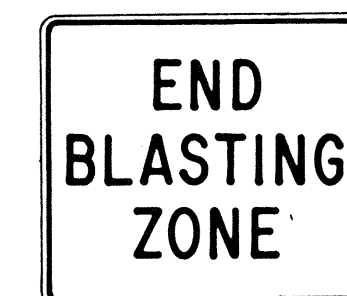

CW22-3 42" x 36"



CG20-1(5) 60" x 36"

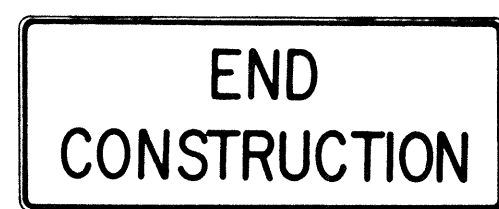


CG20-2 60" x 24"



CM4-9(R) 30" x 24"




CM4-10(R) 48" x 18"

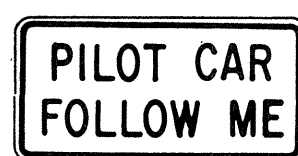

CG20-4 36" x 18"



CW23-1 36" x 36"

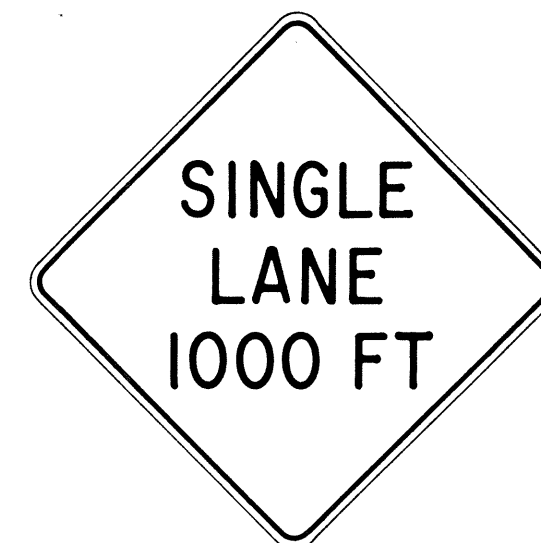

CW23-2b 48" x 48"



CW23-3(R) 48" x 48"

GENERAL NOTES

- Sign details shall conform to the FHWA publications "Manual on Uniform Traffic Control Devices for Streets and Highways," 1971, and "Standard Highway Signs," 1972, and as amended.
- All construction signs shall be reflectorized.
- All construction signs shall have $\frac{3}{8}$ " bolt holes drilled at appropriate locations.
- Numerals in () indicates numerals to be inserted for sign message. (R) or (L) indicates right or left.
- For "CW" series signs, suffixes a, b, c and d are as follows:
a-1500 FT, b-1000 FT, c-500 FT and d-AHEAD.

APPROVAL RECOMMENDED:
Erich Tanaka 3/21/72
TRAFFIC ENGINEER DATE

APPROVED:
Walter S. Smith 3/23/72
ASSISTANT CHIEF, ENGINEERING DATE

NO.	REVISION	APPROVED BY	DATE
1	Supersedes Sht. DT 104 Approved 12-30-69	H.T.	3/23/72
2	Revised General Note 1	H.T.	10/16/74
3	Revised General Note 2	M.H.	9-16-75
4	Revised General Note 2 and sign CG20-1(5)	H.T.	9-14-76

STATE OF HAWAII
DEPARTMENT OF TRANSPORTATION
LAND TRANSPORTATION FACILITIES DIVISION


STANDARD DETAILS CONSTRUCTION SIGNS

NOT TO SCALE

SHEET No. 4 OF 9 SHEETS DT 104


ORIGINAL PLAN	SURVEY PLOTTED BY	DATE
NOTE BOOK	DESIGNED BY	
No.	CHECKED BY	

FED. ROAD DIST. NO.	STATE	FED. AID PROJ. NO.	FISCAL YEAR	SHEET NO.	TOTAL SHEETS
HAWAII	HAW.	RS-0378(1)	1980	15	18

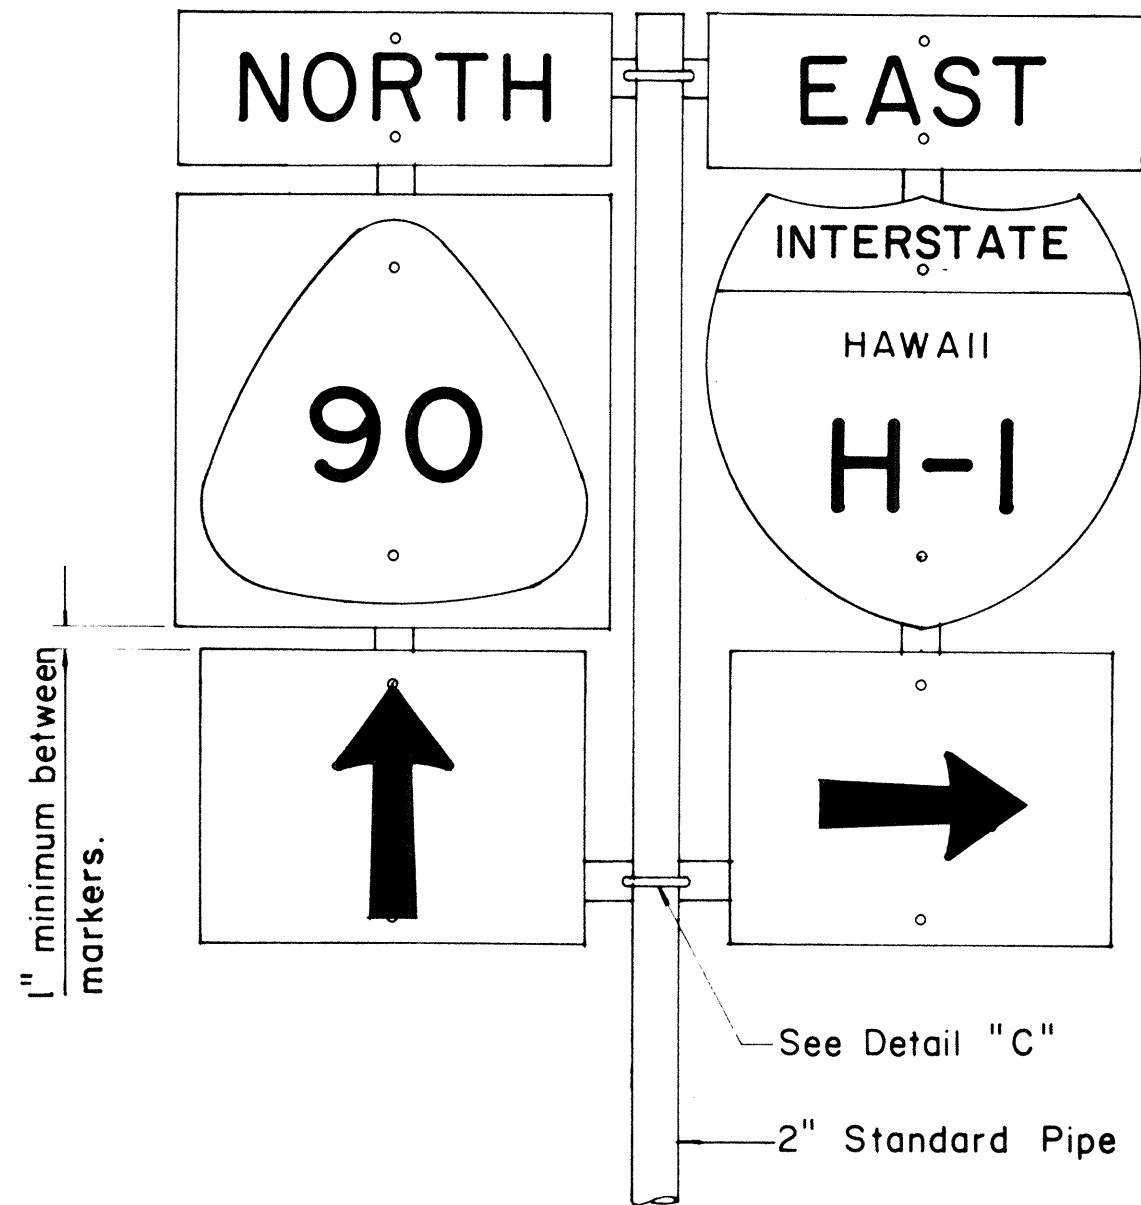


FRONT ELEVATION

TYPE "B" ASSEMBLY
Not to Scale

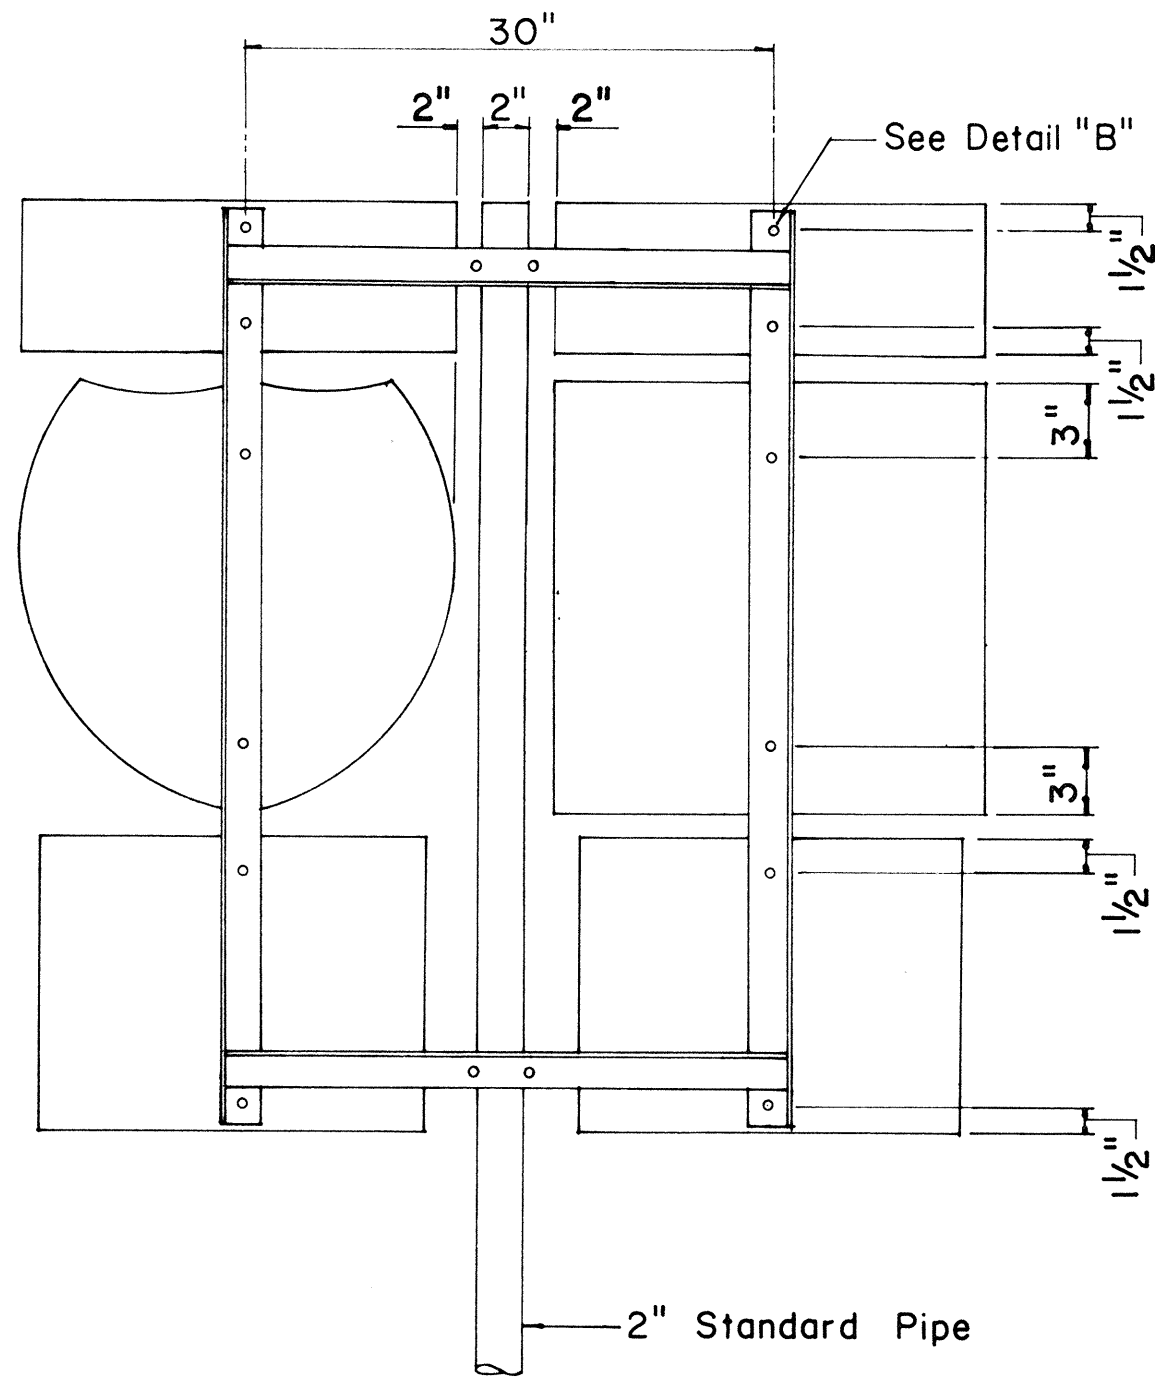


REAR ELEVATION

NOTE:
1. Minimum clearance between markers shall be one inch. (Larger clearances shall be in multiples of one inch.)
2. Pipe post for Type "A" & Type "B" Assembly shall be 2" Standard Pipe.

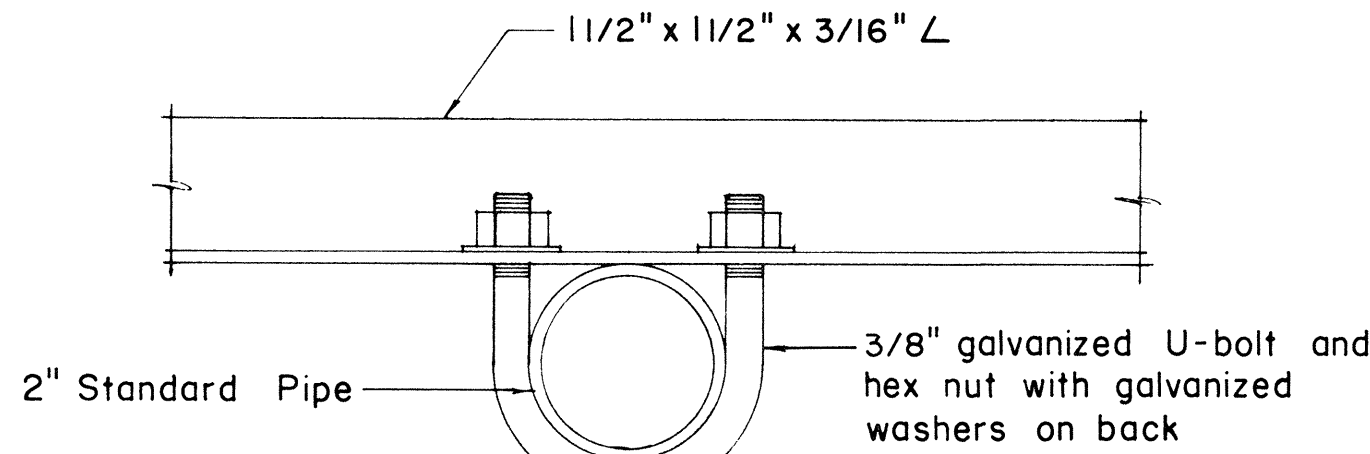


PLAN

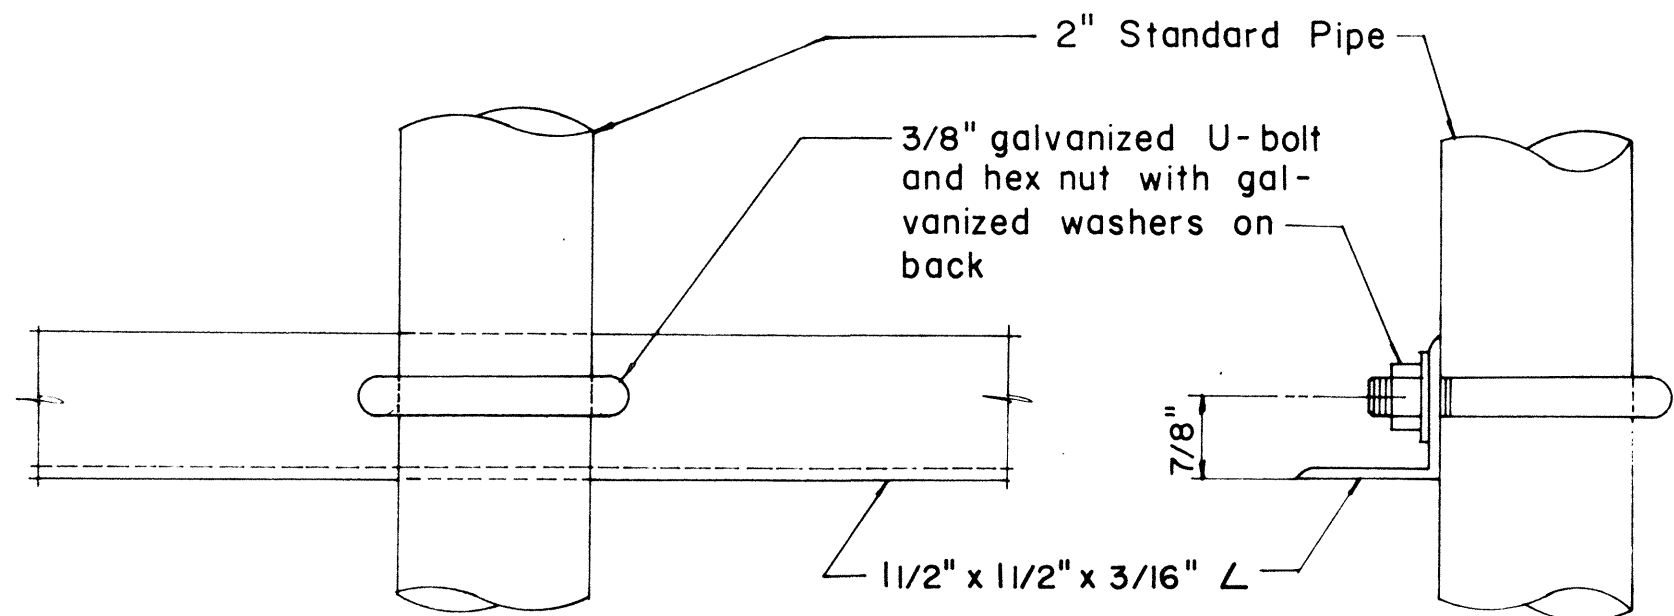

FRONT ELEVATION


SIDE ELEVATION

DETAIL "C"

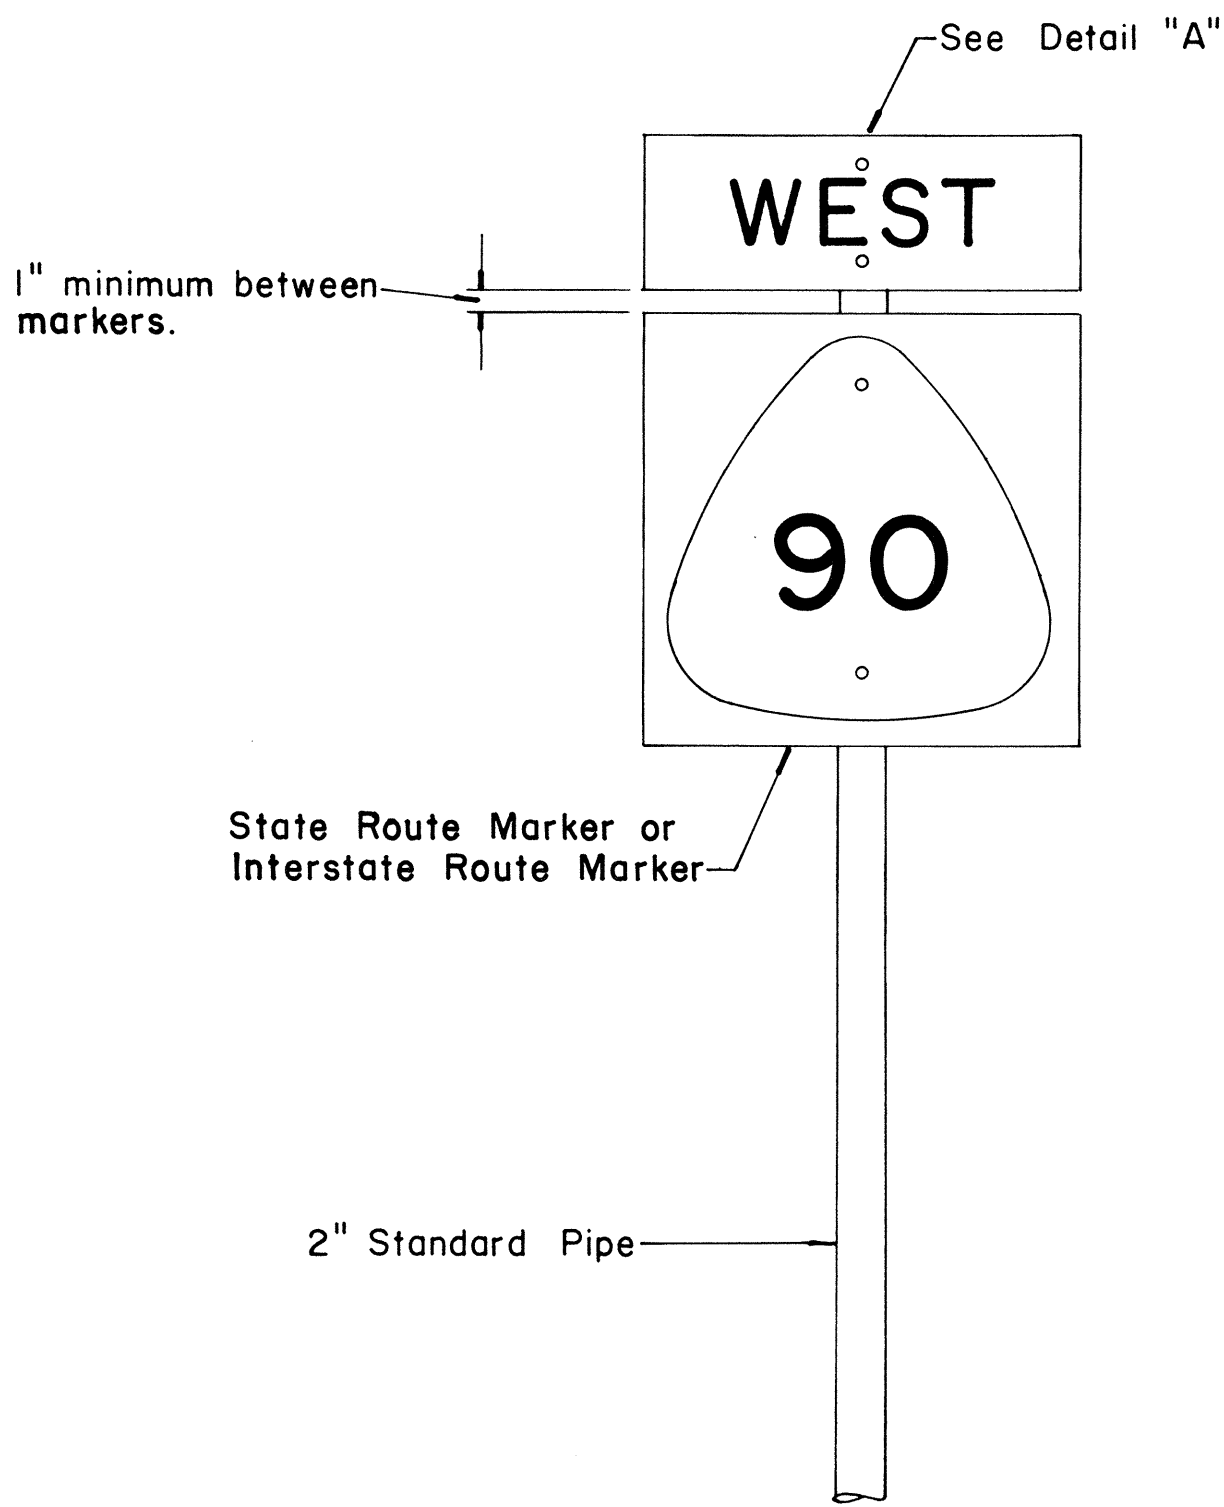


FRONT ELEVATION

TYPE "A" ASSEMBLY
Not to Scale

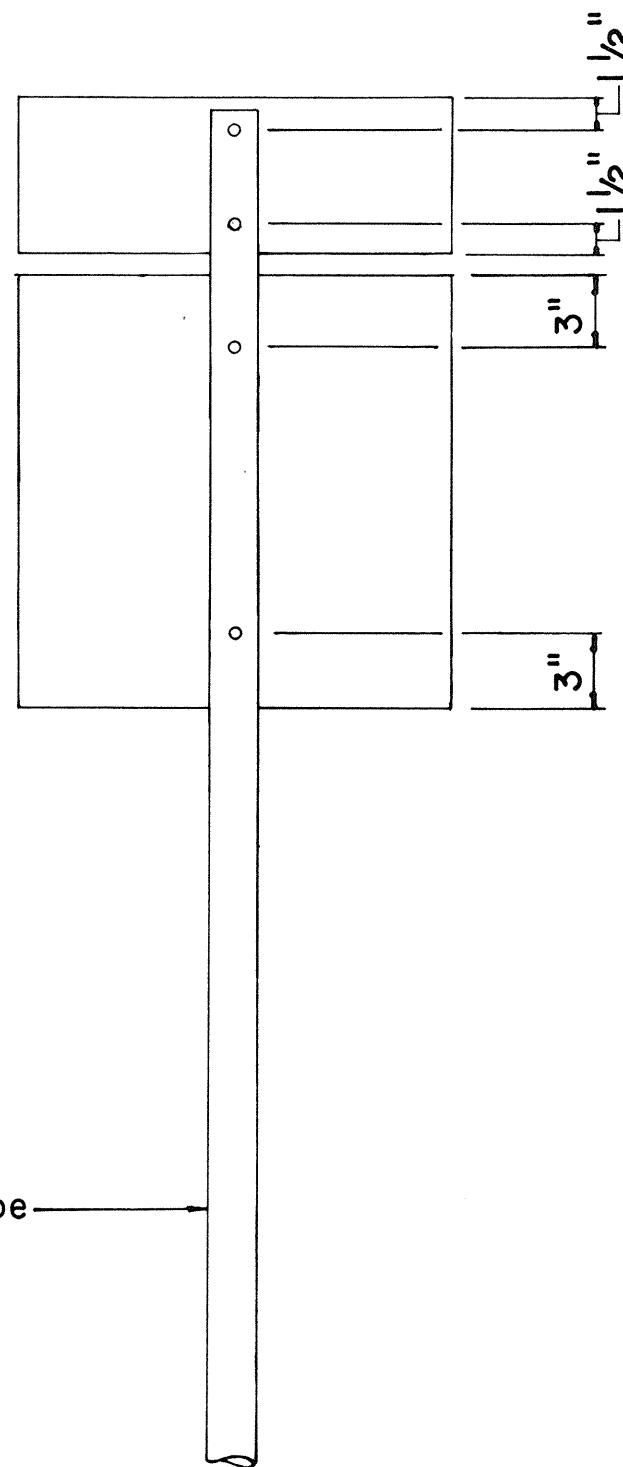


REAR ELEVATION

NOTE:
For height and lateral location of Route Marker Assembly, see plan sheet DT 100.

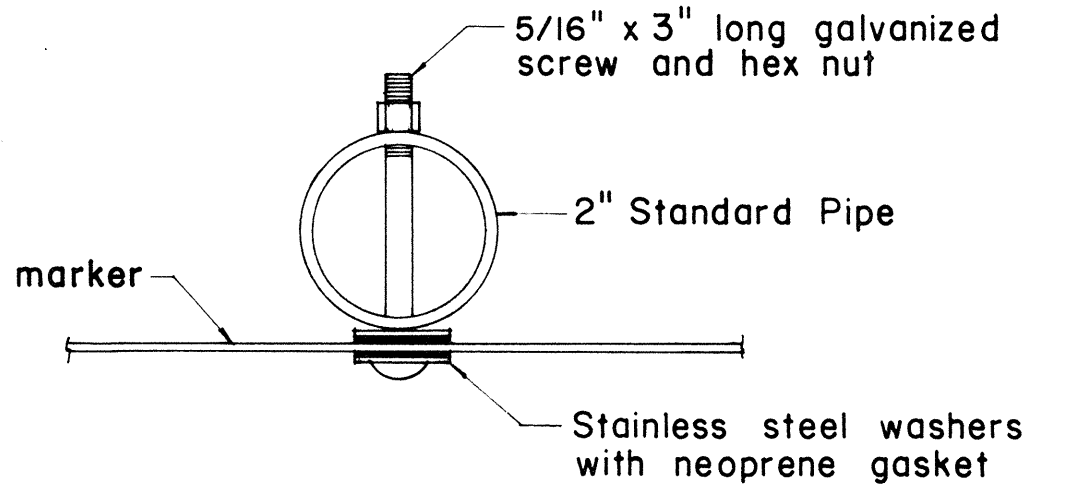


PLAN

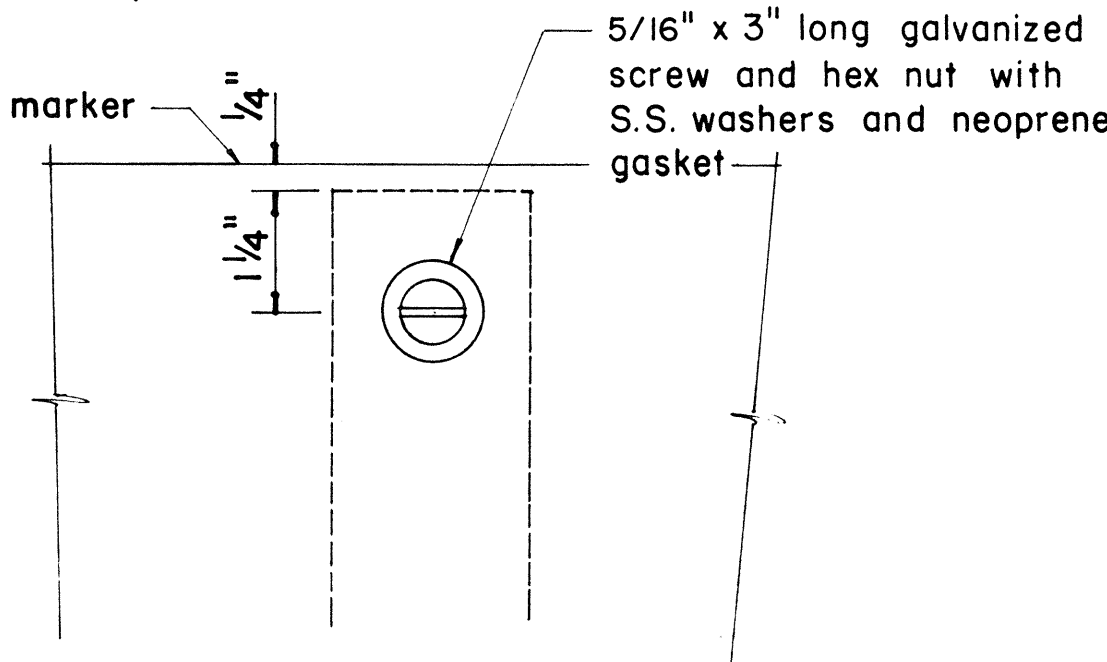


FRONT ELEVATION

DETAIL "A"

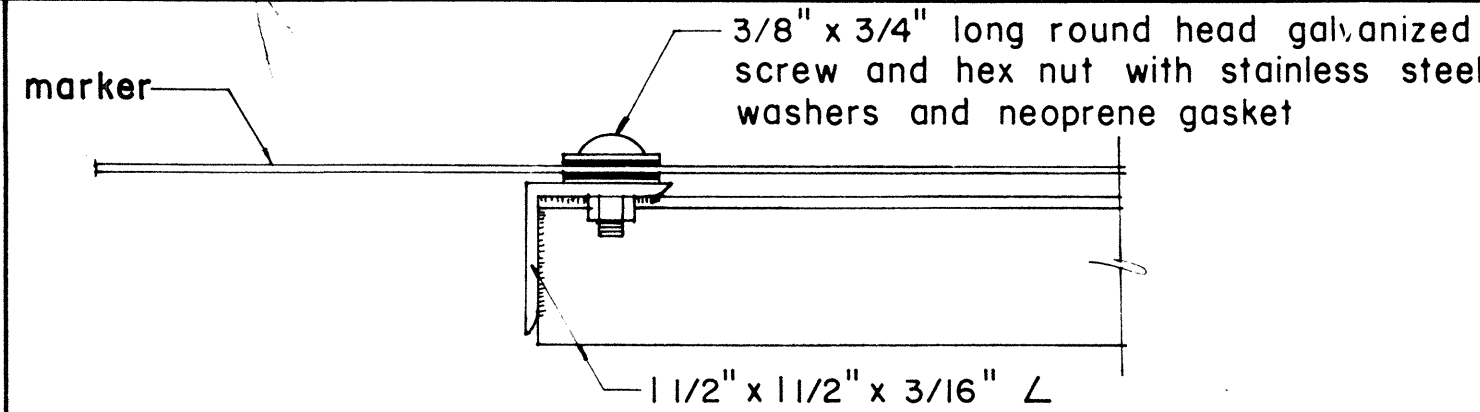


PLAN

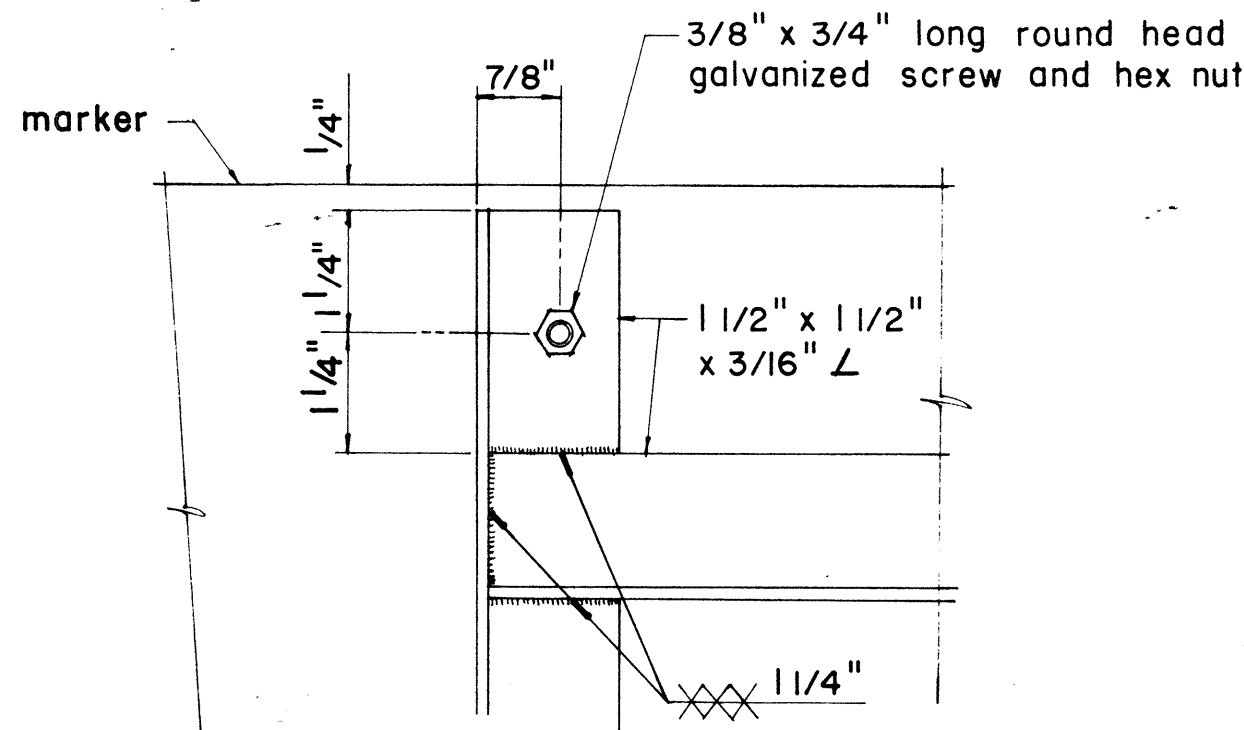

ELEVATION

DETAIL "B"

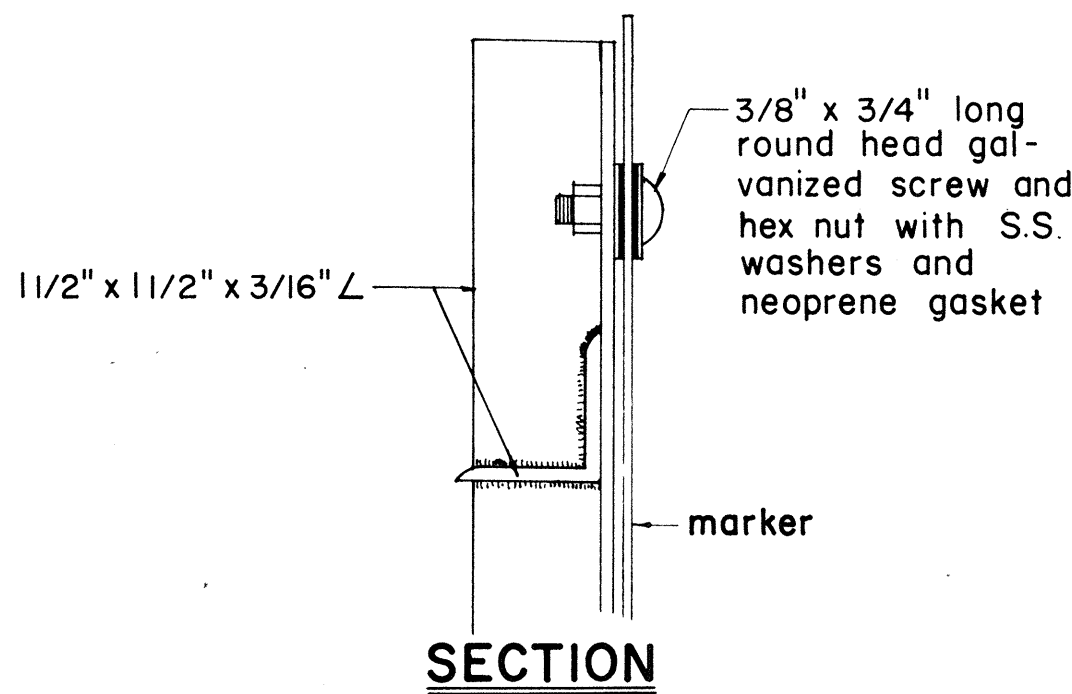

SECTION

APPROVAL RECOMMENDED:
Eishi Tanaka 12/23/69
TRAFFIC ENGINEER DATE

APPROVED:
John J. DeFek 12-30-69
ASSISTANT CHIEF, ENGINEERING DATE

NO.	REVISION	APPROVED BY	DATE
1	Revisions to Route Marker Assemblies.	H.T.	6/1/72

STATE OF HAWAII
DEPARTMENT OF TRANSPORTATION
LAND TRANSPORTATION FACILITIES DIVISION
STANDARD DETAILS
ROUTE MARKER ASSEMBLIES


Scale: As Shown
SHEET No. 6 OF 9 SHEETS DT 107

ORIGINAL	SURVEY PLOTTED BY	DATE
PLAN	DRAWN BY	
NOTE BOOK	TRACED BY	
No.	CHECKED BY	


FED. ROAD DIST. NO.	STATE	FED. AID PROJ. NO.	FISCAL YEAR	SHEET NO.	TOTAL SHEETS
HAWAII	HAW.	RS-0378(1)	1980	16	18

GENERAL NOTES:

1. Clearance markers (RM-3, RM-4) shall be installed with the edge of the marker in line with the inner edge of the obstruction.
2. (R) or (L) indicates right or left and shall be as shown on the plans.
3. Reflector markers RM-1 and RM-2 shall be:
 - a) Yellow if placed along the left edge of divided roadways, one-way roadways, and ramps in the direction of travel.
 - b) White if placed along the right edge of divided roadways, one-way roadways, and ramps in the direction of travel.
4. For reflector marker RM-9, reflective sheeting material may be used as an alternate.
5. For RM-4, the stripes shall slope downward at an angle of 45° in the direction of traffic.

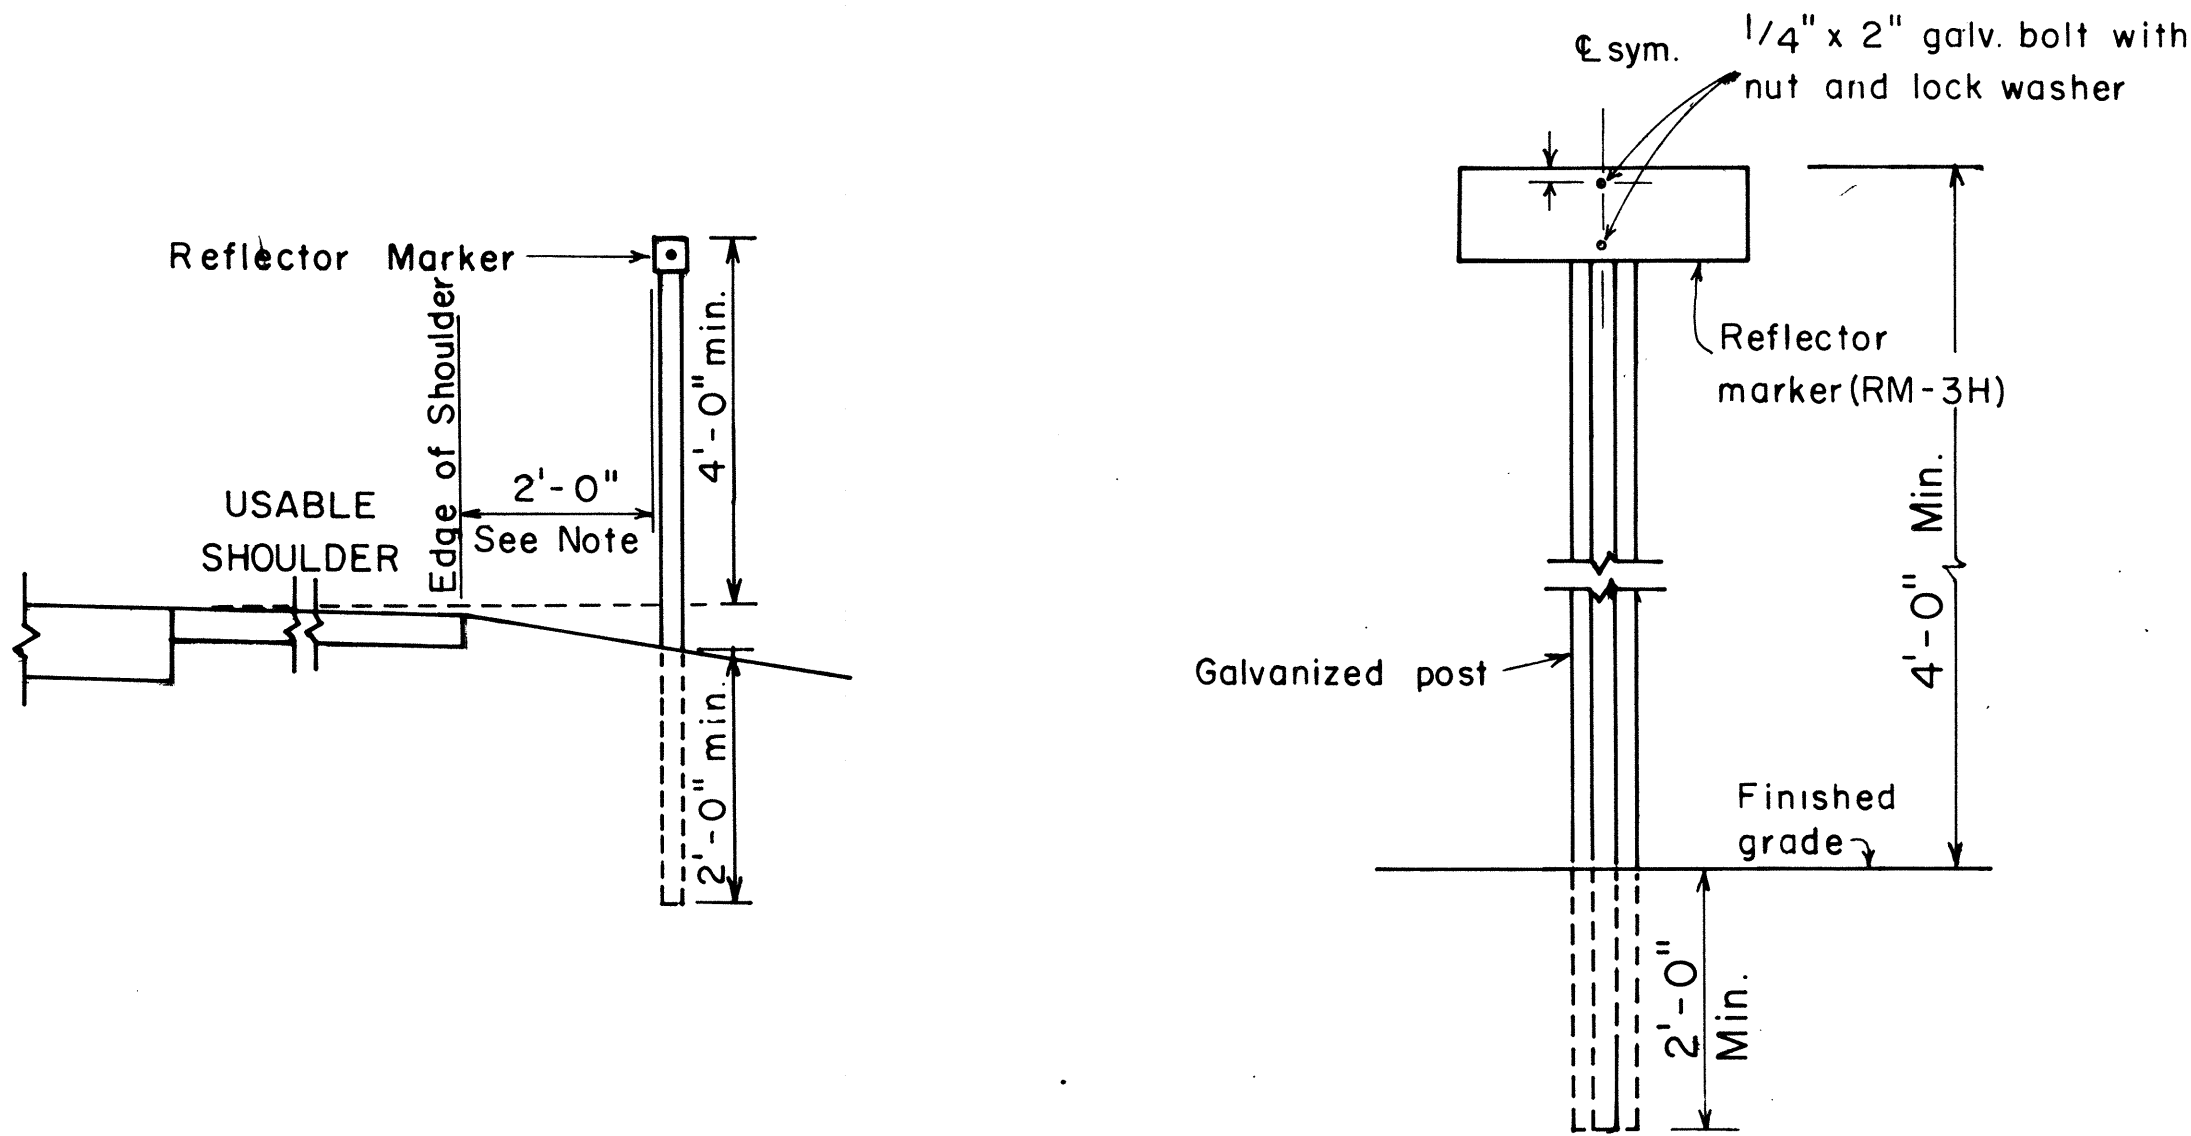


REFLECTOR MARKER MOUNTING DETAIL

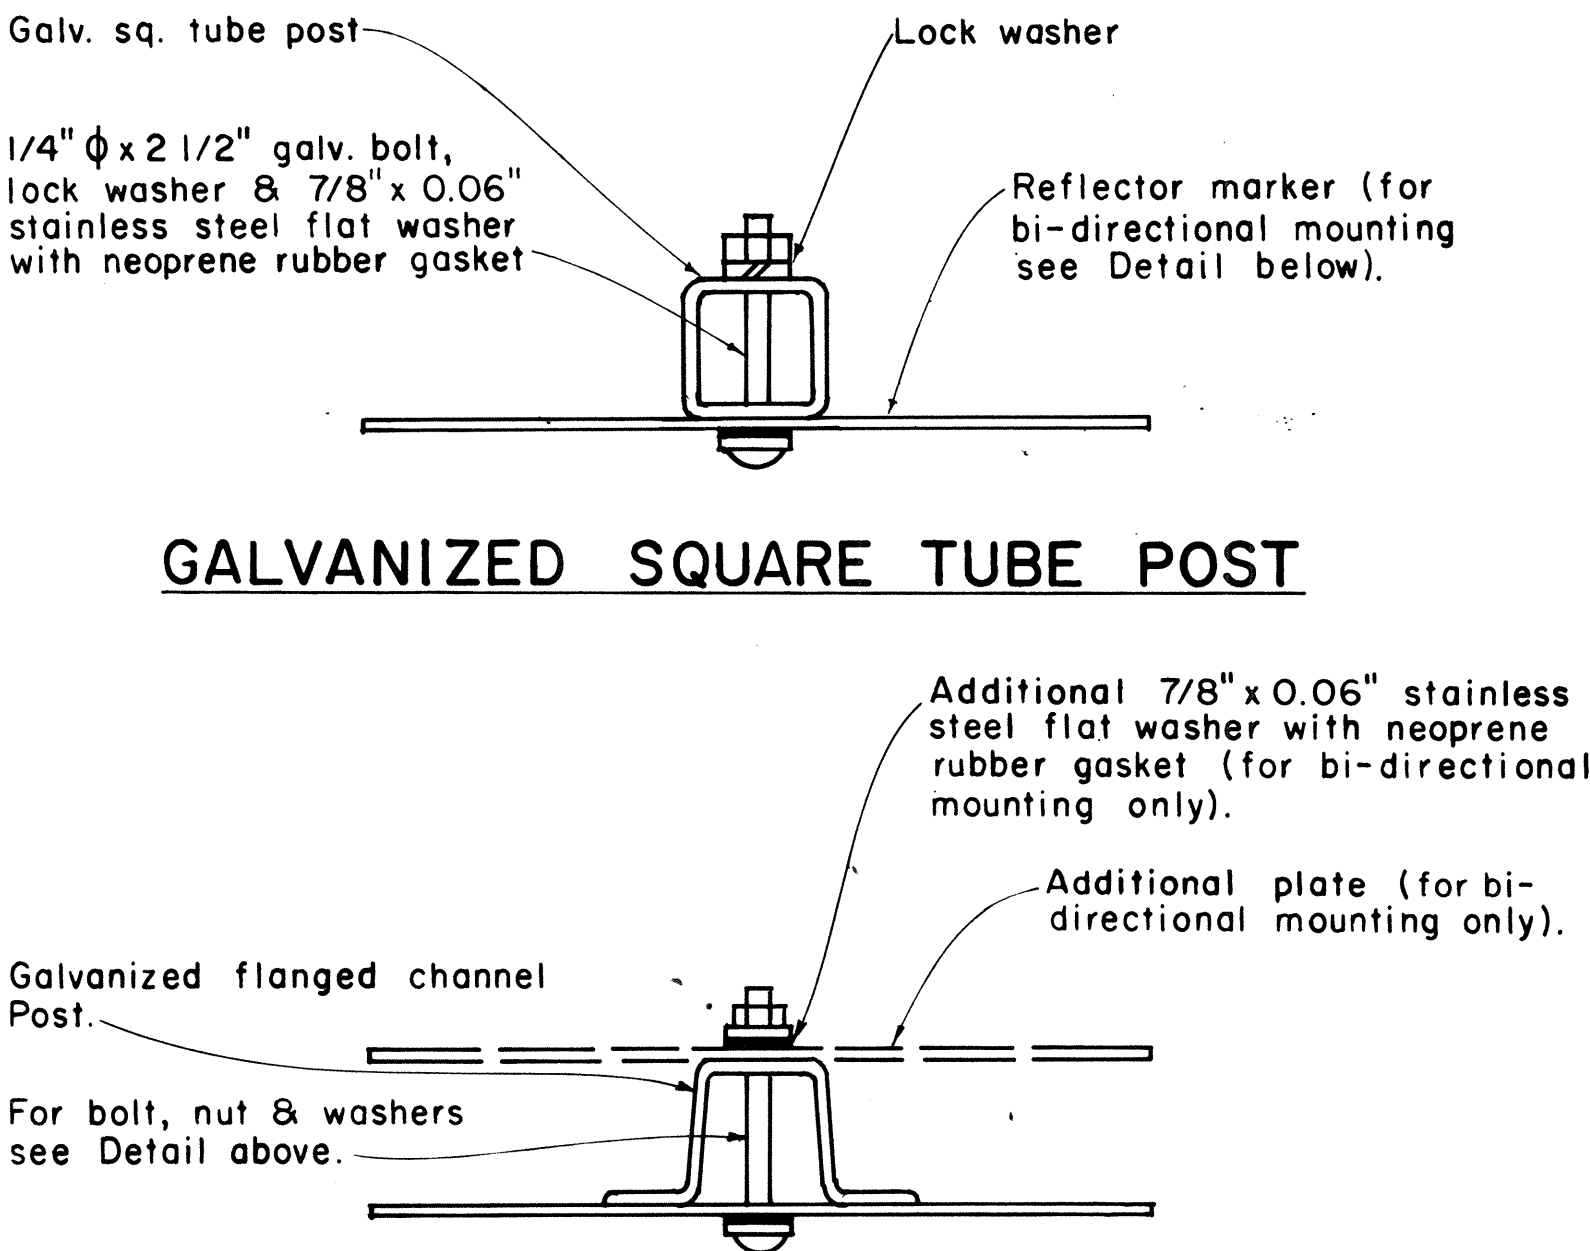

GALVANIZED FLANGED CHANNEL POST

TYPICAL MOUNTING DETAILS

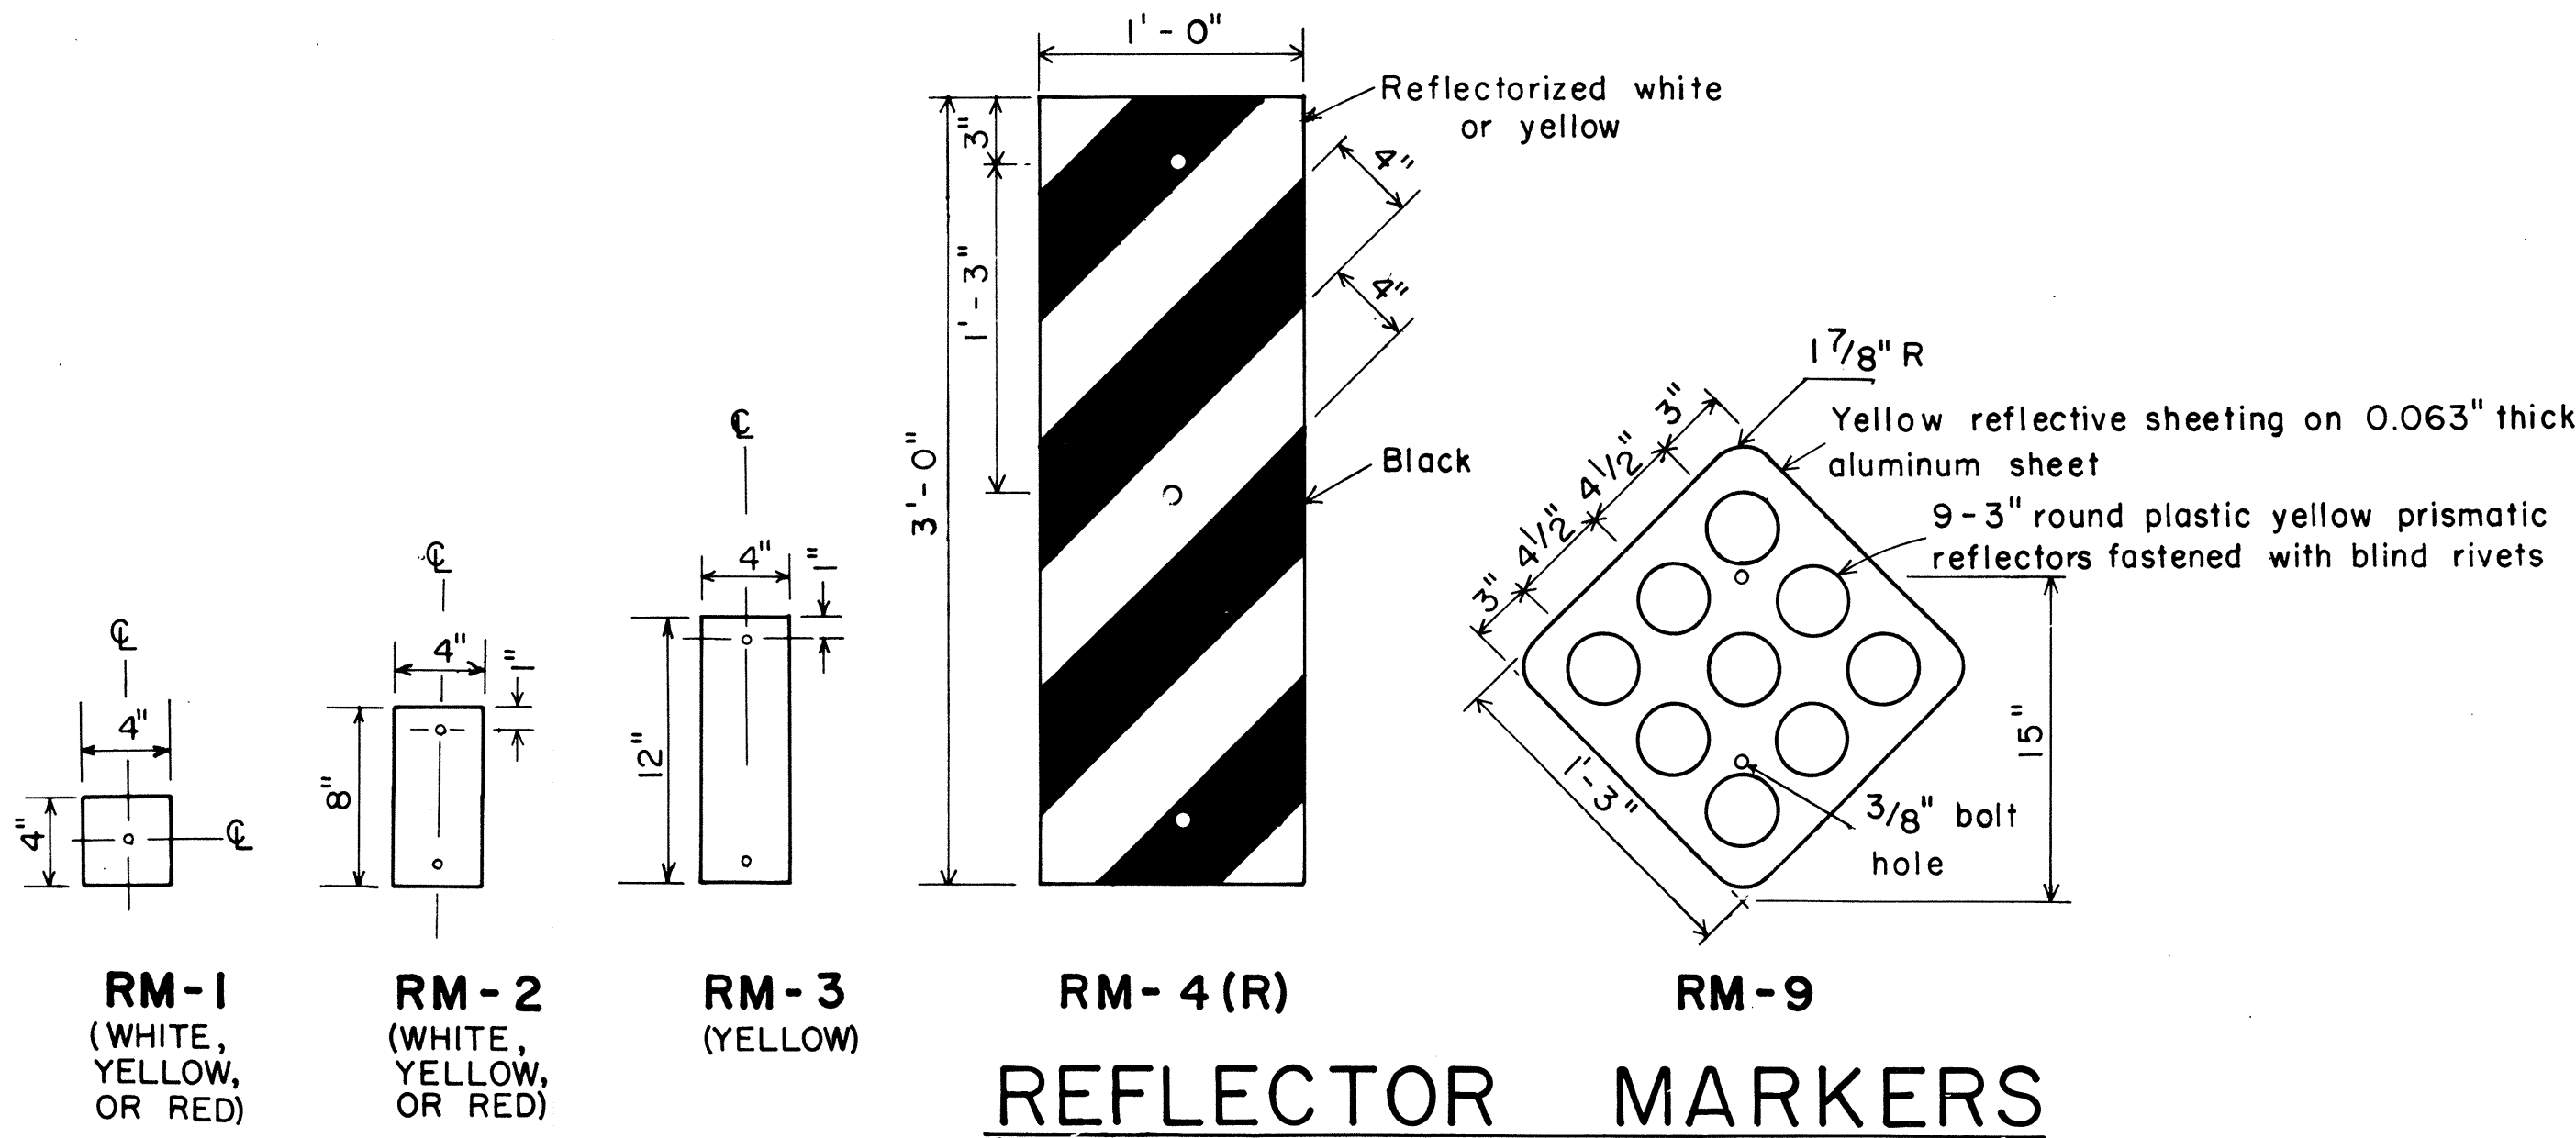

APPROVAL RECOMMENDED:
Enchi Tanaka 11/7/77
 TRAFFIC ENGINEER DATE

APPROVED:
Herbert B. Sakai 11/15/77
 ASSISTANT CHIEF, ENGINEERING DATE

NO.	REVISION	APPROVED BY	DATE
1	Revised Mounting Details	H-1	4/25/80


STATE OF HAWAII
DEPARTMENT OF TRANSPORTATION
HIGHWAYS DIVISION

STANDARD DETAILS
MISCELLANEOUS REFLECTOR MARKERS

Not to scale
June, 1977

DATE	_____
DESIGNED BY	_____
CHECKED BY	_____
NOTED BY	_____
ORIGINAL PLAN	_____
NO.	_____

MARKER SIZE	MULTIPLY DIMENSIONS BY	NUMERAL SIZE
		2 Digit - Series D 3 Digit - Series C
21"	1.3	8"
32"	2.0	12"
42"	2.63	16"

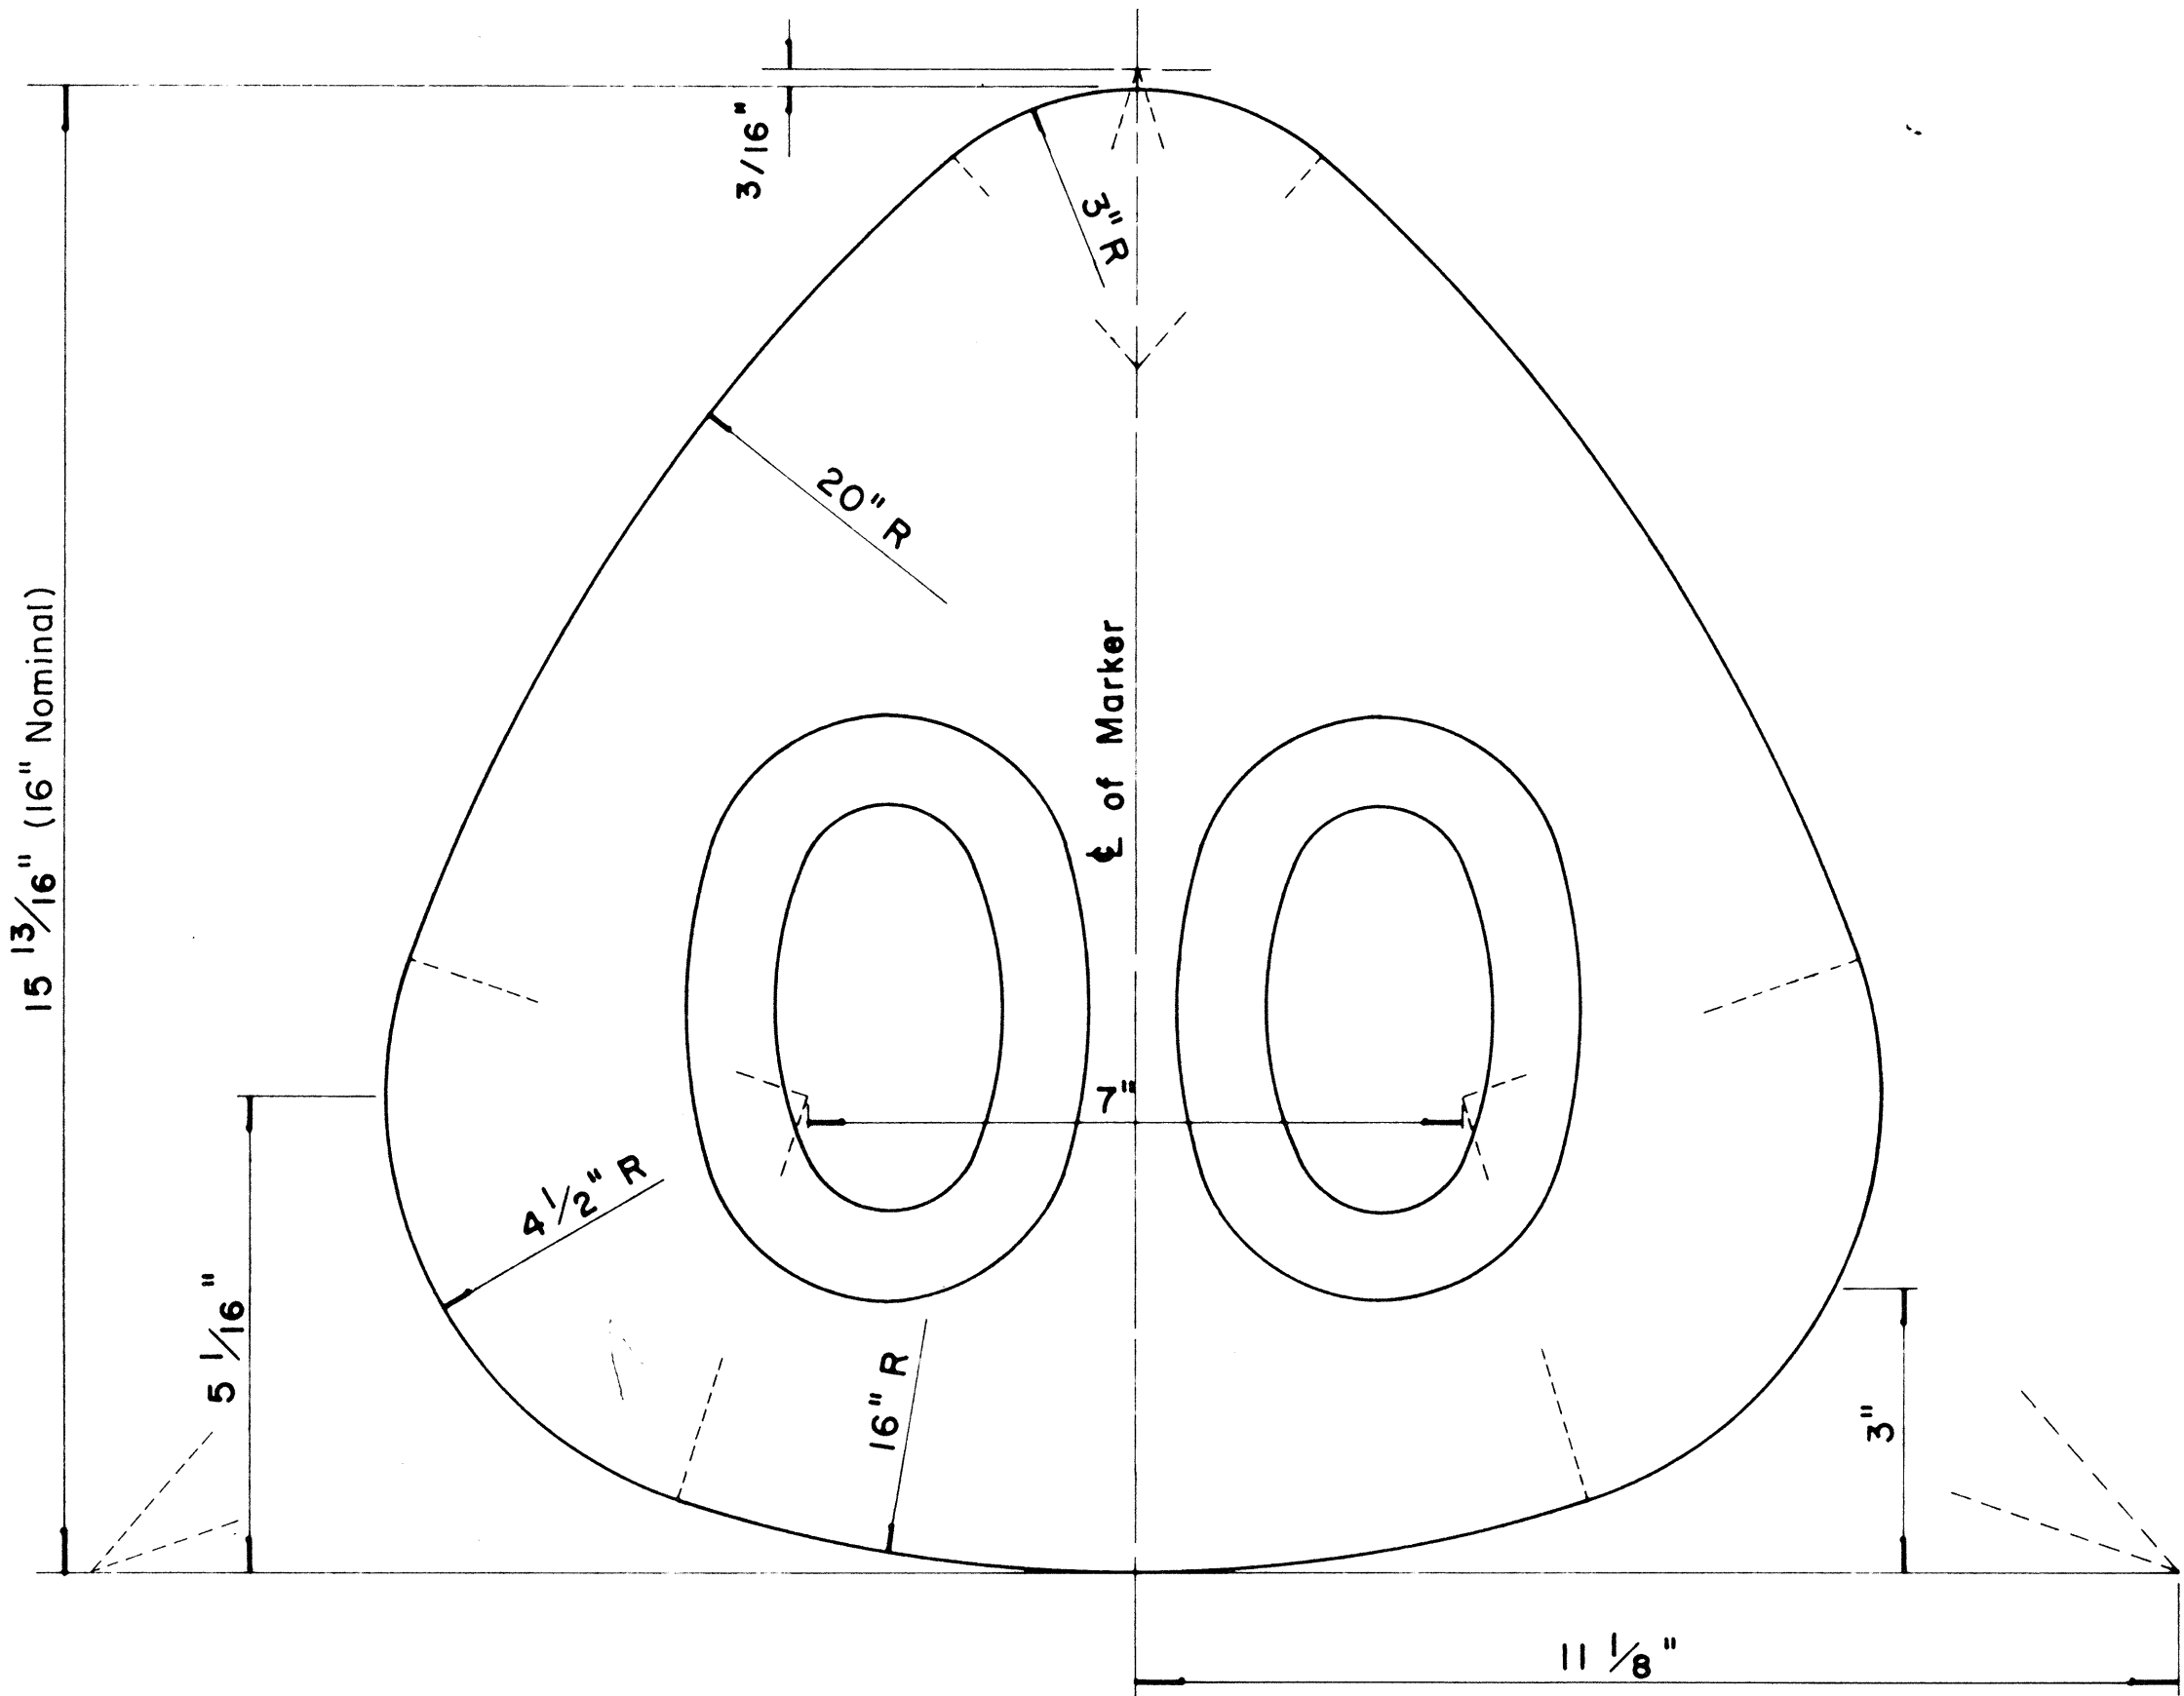

STATE ROUTE MARKER
FOR GUIDE SIGNS


Scale: Half Size

NOTE :

1. State Route Markers on Guide signs shall have black numerals on a white reflectorized background mounted on a flat aluminum cut-out.
2. Numerals shall conform to the FHWA publication "Standard Alphabets for Highway Signs," 1966.
3. Cut-outs shall be fastened on sign panel with aluminum blind rivets. See Standard Specifications.

FED. ROAD DIST. NO.	STATE	FED. AID PROJ. NO.	FISCAL YEAR	SHEET NO.	TOTAL SHEETS
HAWAII	HAW.	RS-0378(1)	1980	17	18

RADII FOR SIGNS		
Least Dimension of Sign	W	R
2' - 0" to 4' - 6"	2"	3"
4' - 9" to 5' - 6"	2"	6"
5' - 9" to 7' - 6"	2"	9"
7' - 9" and greater	2"	12"

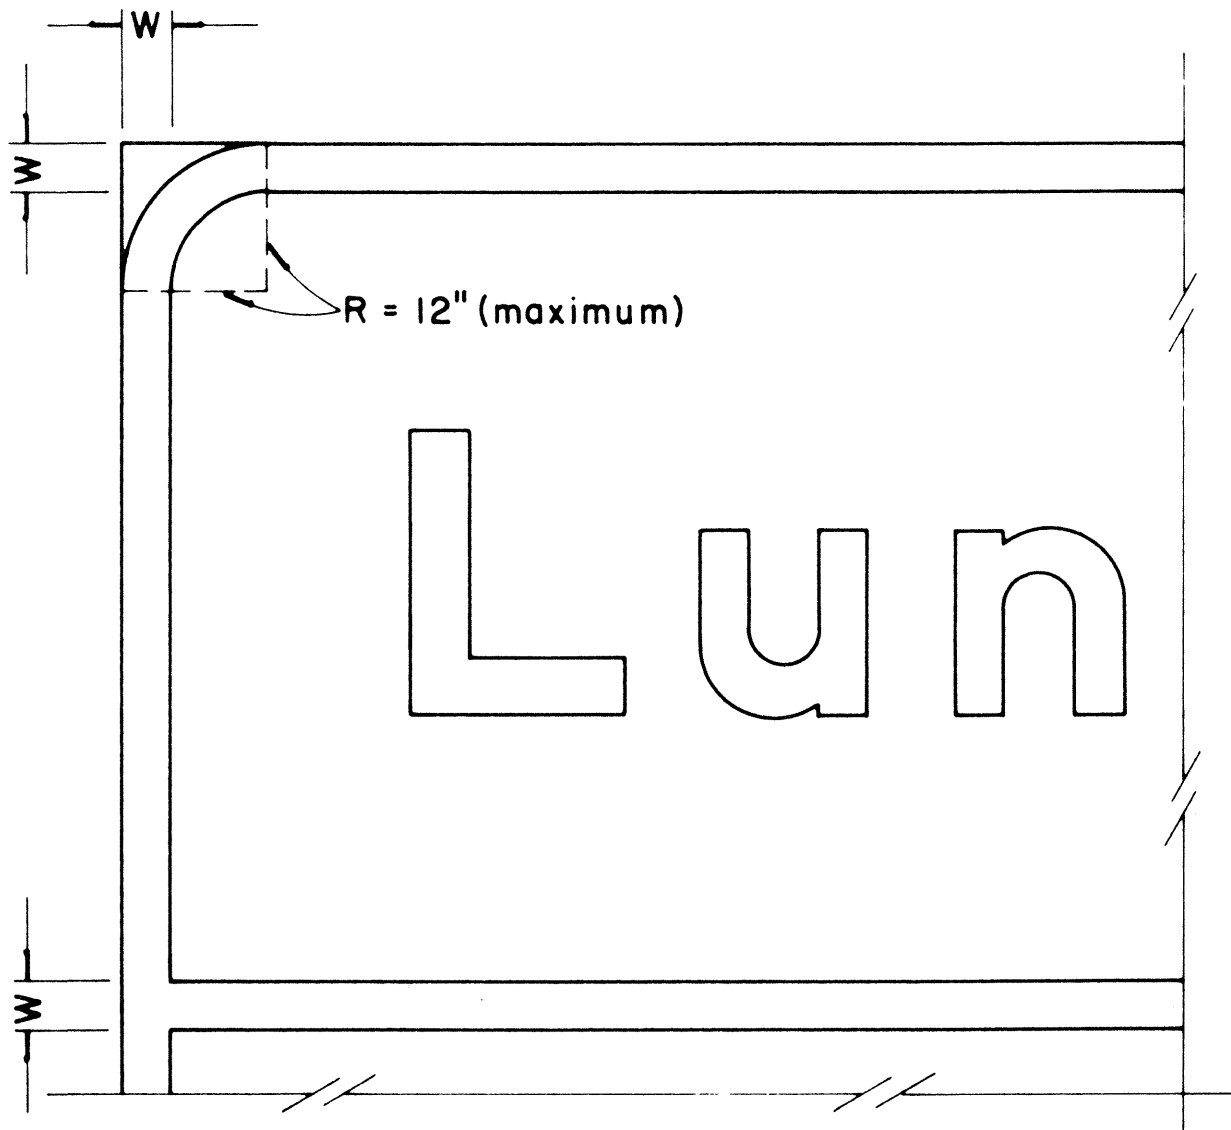

BORDER DETAIL
FOR GUIDE SIGNS

Not to Scale

NOTE:

1. Area outside corner radius need not be trimmed.
2. All borders shall be white reflectorized cut-outs.
3. All Guide signs shall have borders.

APPROVAL RECOMMENDED:

Erich Tanaka 4/11/72
TRAFFIC ENGINEER DATE


APPROVED:

Robert W. Sakai 4/12/72
ASSISTANT CHIEF, ENGINEERING DATE

NO	REVISION	APPROVED BY	DATE
1	Supersedes Sht. DT 209 Approved 12-30-69	H.T.	4/12/72
2	Revised Notes and Schedules	H.T.	9-14-70


STATE OF HAWAII DEPARTMENT OF TRANSPORTATION LAND TRANSPORTATION FACILITIES DIVISION STANDARD DETAILS STATE ROUTE MARKER AND BORDER DETAIL FOR GUIDE SIGNS Scale: As Shown SHEET No. 8 OF 9 SHEETS DT 209

FED. ROAD DIST. NO.	STATE	FED. AID PROJ. NO.	FISCAL YEAR	SHEET NO.	TOTAL SHEETS
HAWAII	HAW.	RS-0378(1)	1980	18	18

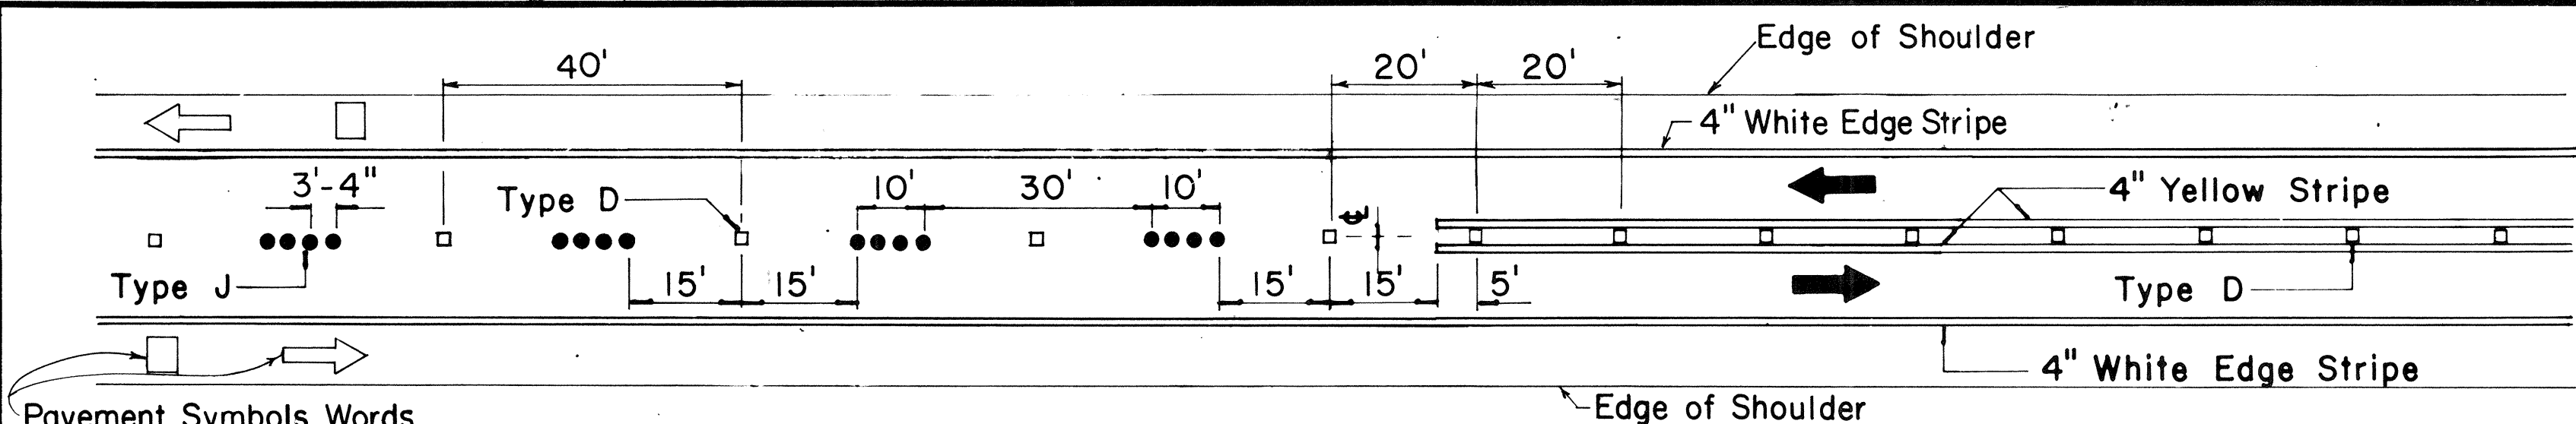


Pavement Symbols, Words, Arrows, and Legends for Bike Route as Required on Plans.

PASSING PERMITTED AND PASSING PROHIBITED

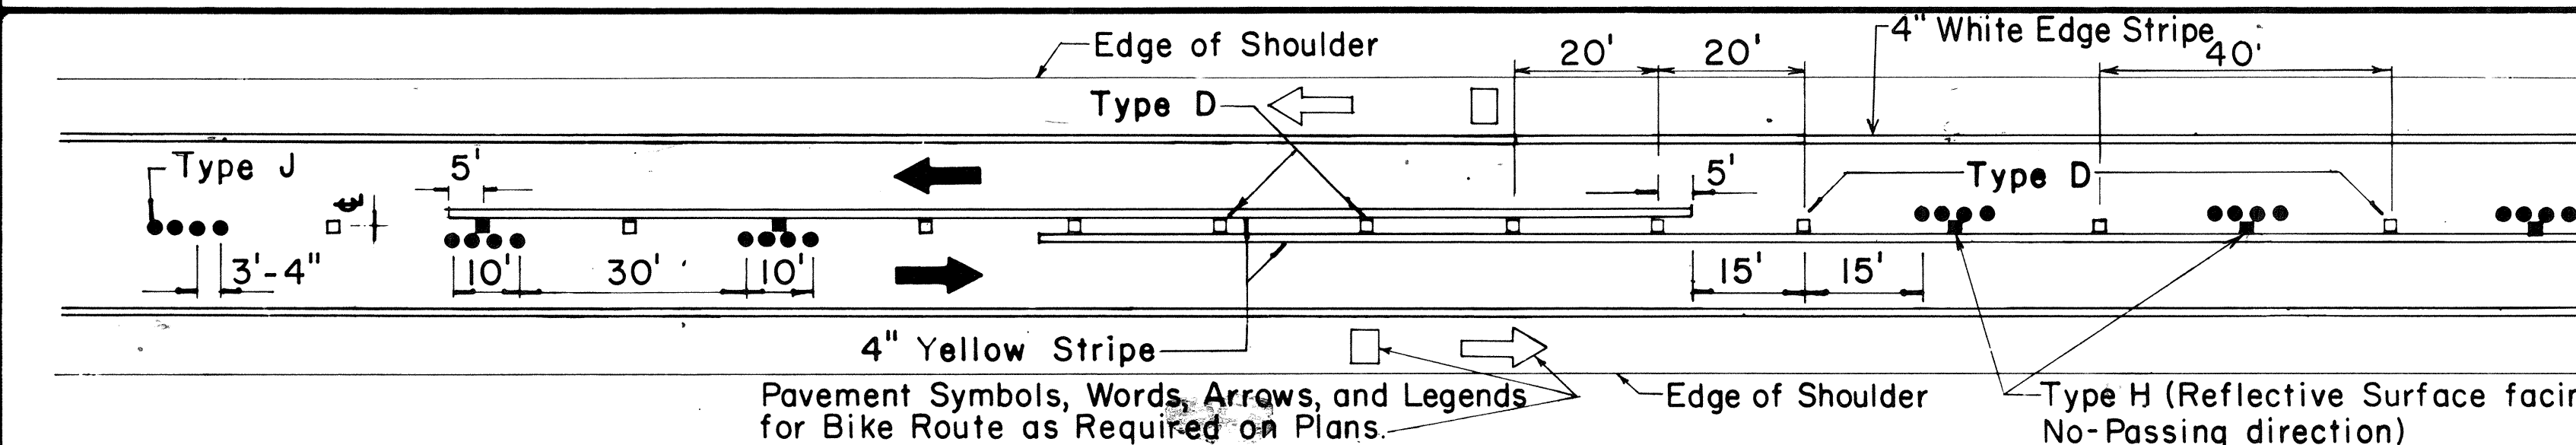


Pavement Symbols, Words, Arrows, and Legends for Bike Route as Required on Plans.


PASSING PROHIBITED ZONES

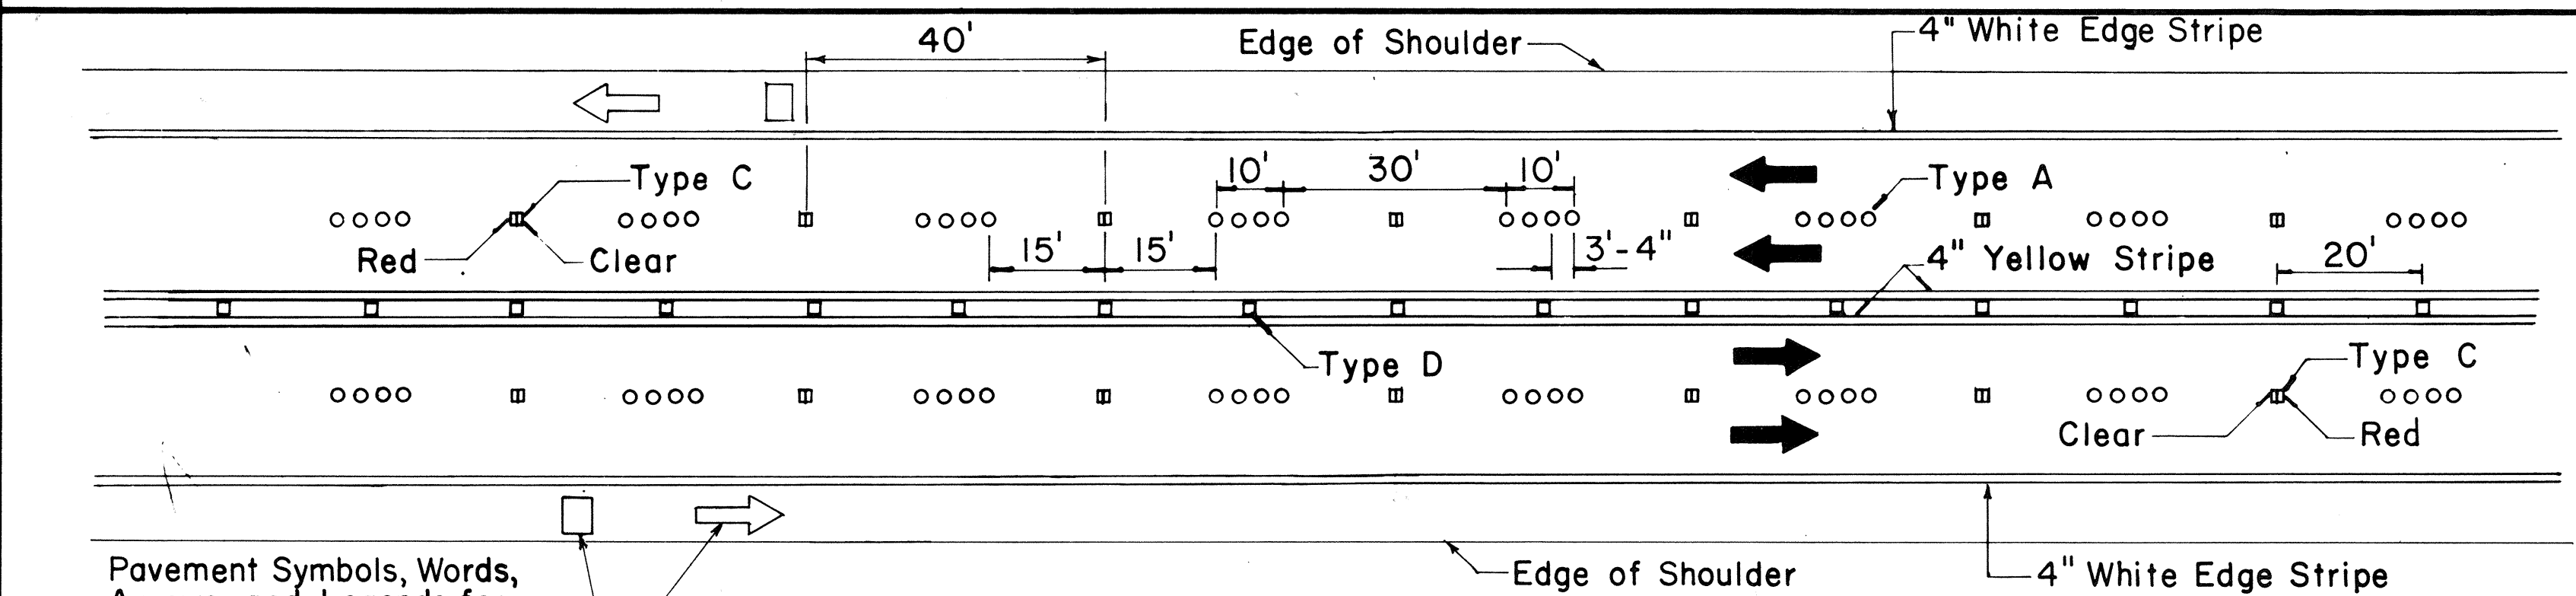

Pavement Symbols, Words, Arrows, and Legends for Bike Route as Required on Plans.

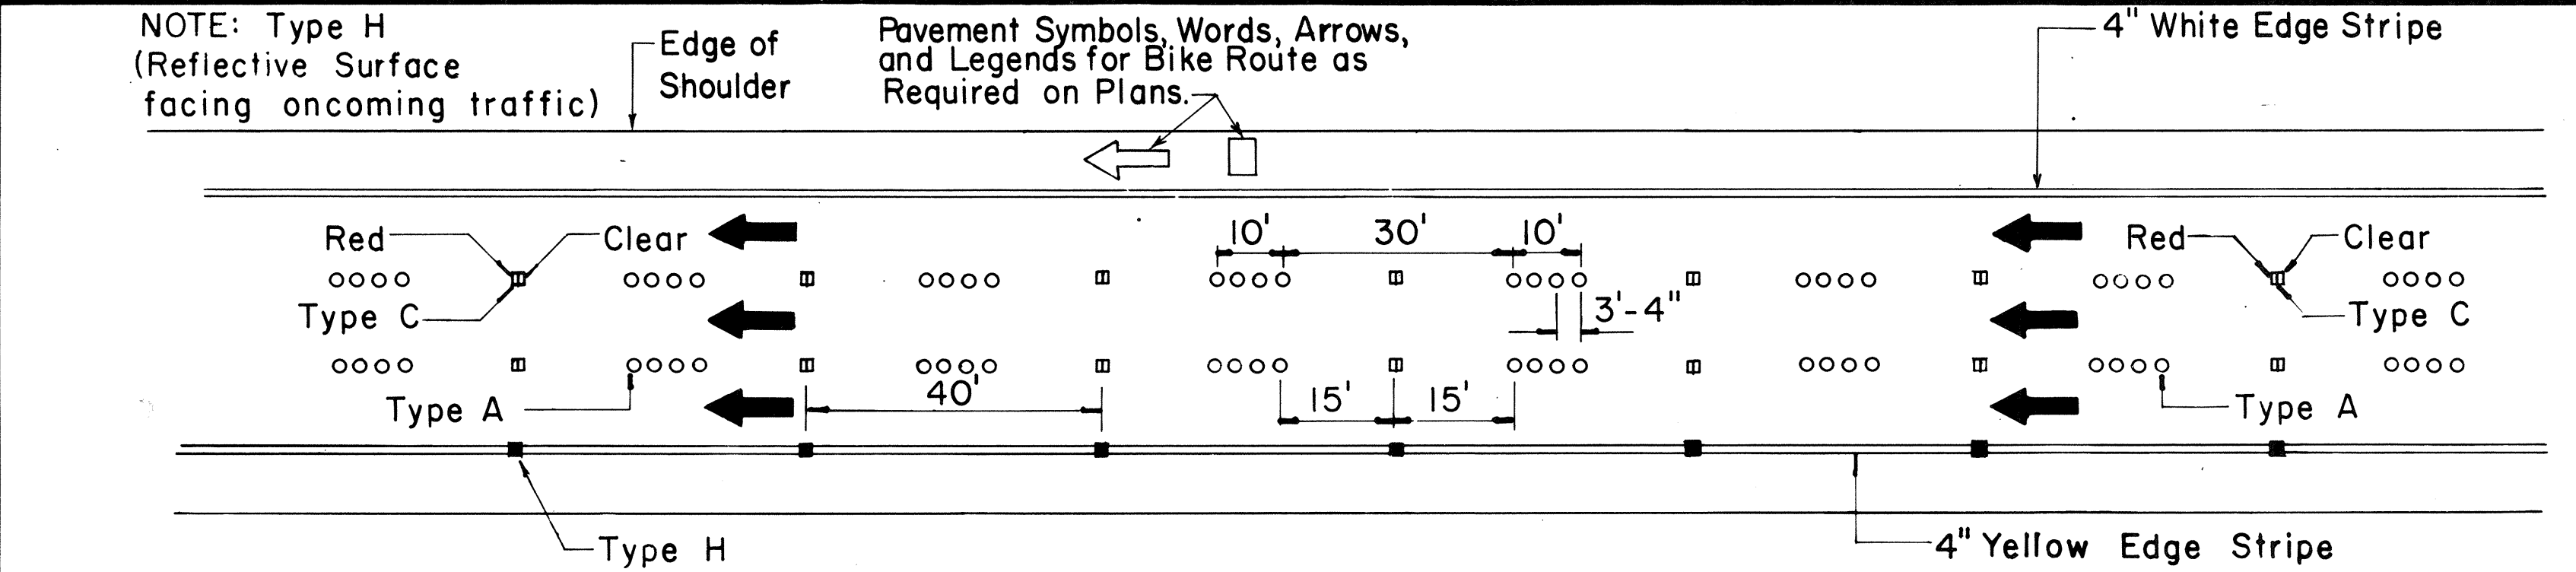

Pavement Symbols, Words, Arrows, and Legends for Bike Route as Required on Plans.

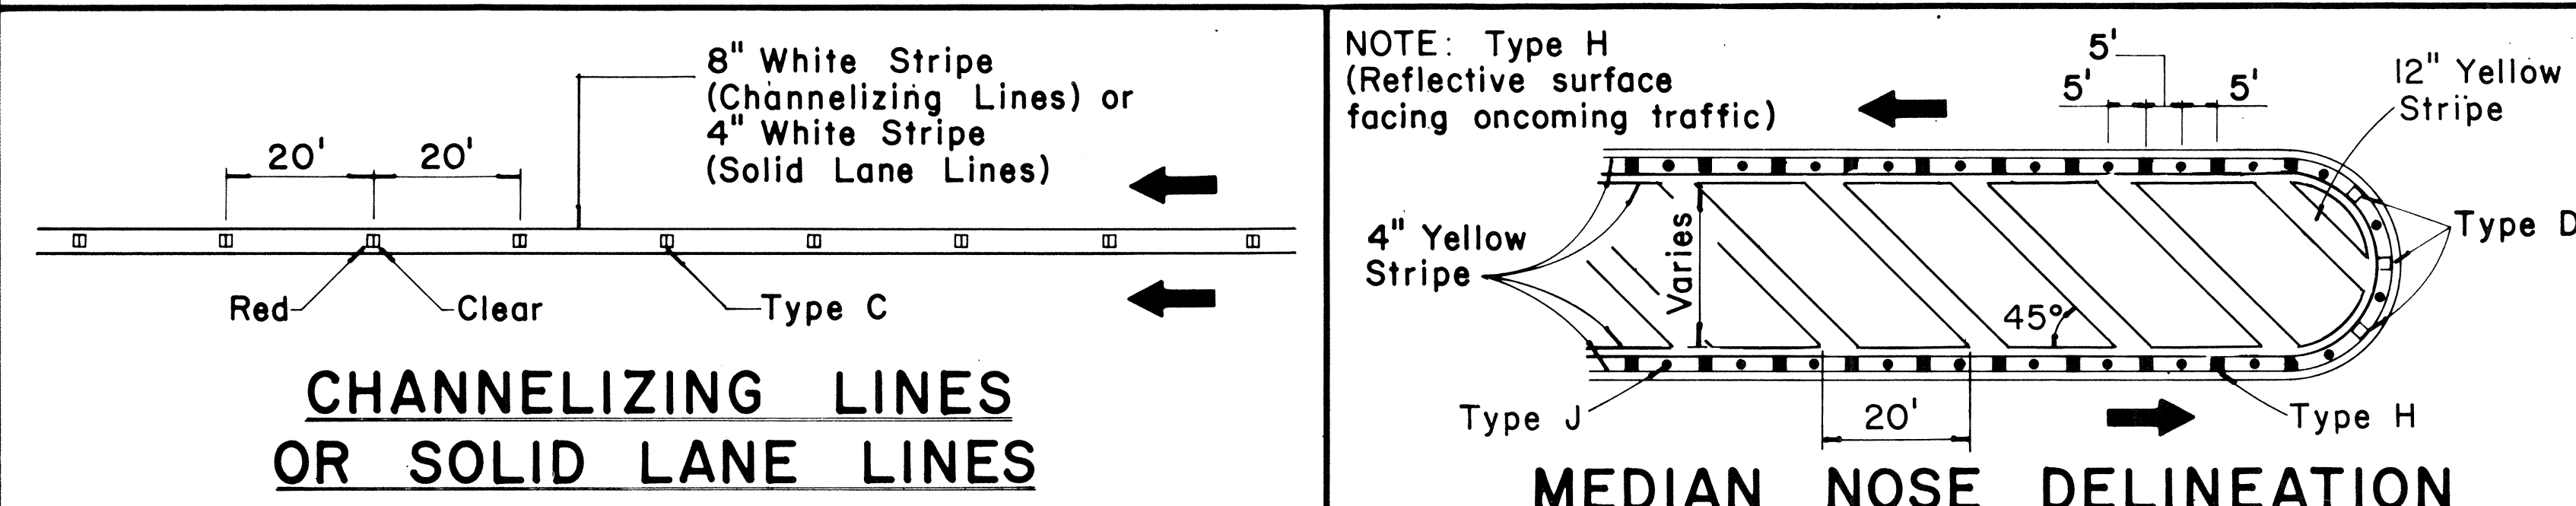

Pavement Symbols, Words, Arrows, and Legends for Bike Route as Required on Plans.


TWO - LANE

MULTI - LANE

DIVIDED HIGHWAY AND FREEWAY

MISCELLANEOUS

3.85" - 4.05" Dia.

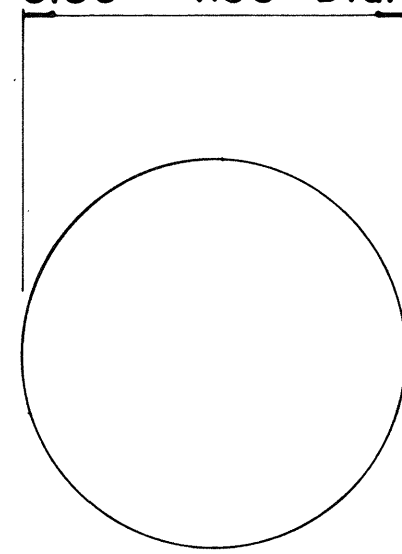


TYPE A
NON - REFLECTIVE WHITE MARKER


TYPE J

NON - REFLECTIVE YELLOW MARKER

0.68" - 0.80"

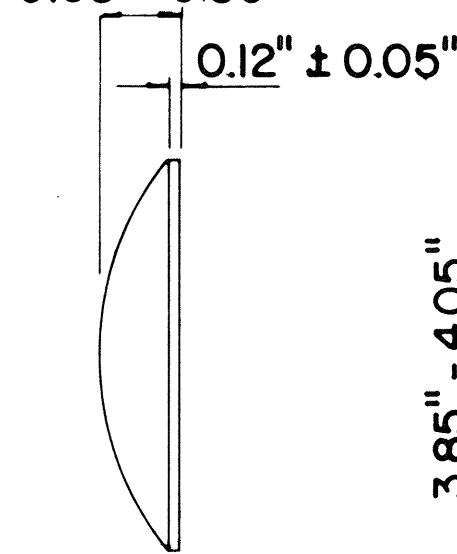


3.85" - 4.05"

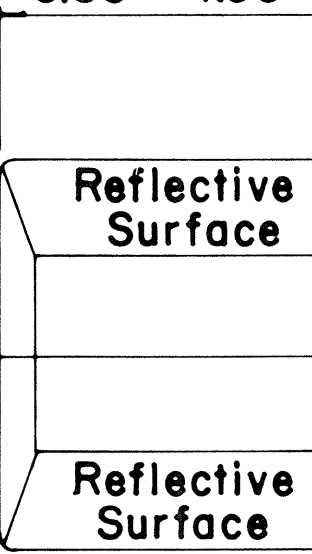


TYPE C
RED - CLEAR REFLECTIVE MARKER

0.50" - 0.70"

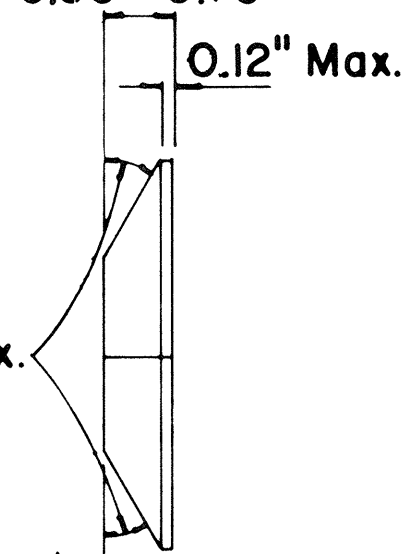

TYPE D
TWO-WAY YELLOW REFLECTIVE MARKER

3.85" - 4.05"

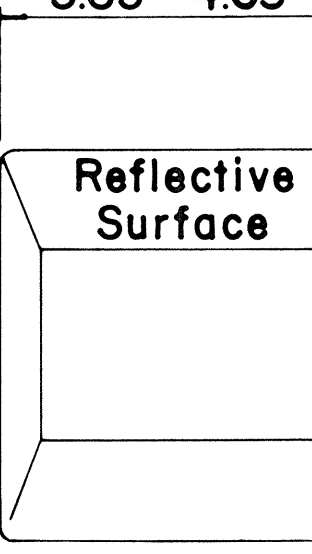

TYPE H
ONE-WAY YELLOW REFLECTIVE MARKER

GENERAL NOTES

- Pavement marking and striping shall conform to the latest "Manual on Uniform Traffic Control Devices for Streets and Highways," and as amended.
- Layout and installation of pavement marking and striping shall be done by the Contractor. The Contractor shall check the layouts with the Engineer prior to performing work.

LEGEND

- Type A
- Type C
- Type D
- Type H
- Type J

APPROVAL RECOMMENDED:

Erich Tanaka
TRAFFIC ENGINEER

7/21/78
DATE

APPROVED:

Harold J. Delia
ASSISTANT CHIEF, ENGINEERING

7/24/78
DATE

No.	REVISION	APPROVED BY	DATE
1	Supersedes DT 300 approved 11/18/71.	H.T.	7/24/78
2	Delete Type A Markers from Bike Route Delineation.	H.T.	10/15/79

STATE OF HAWAII
DEPARTMENT OF TRANSPORTATION
HIGHWAYS DIVISION

STANDARD DETAILS
RAISED PAVEMENT MARKERS
AND STRIPING

Not to Scale July 1978
SHEET No. 9 OF 9 SHEETS DT 300