

Erosion Control/BMP Notes:

- Measures to control erosion and other pollutants shall be in place before any construction work is initiated. These measures shall be properly constructed and maintained throughout the construction period.
- 2. All control measures shall be checked and repaired as necessary.
- 3. Temporary erosion/sediment control shall be provided using compost filter socks (BiosockTM or equivalent) and installed per manufacturer's recommendations.
- 4. Good housekeeping shall be utilized to ensure protection of roadways from mud, dirt, and debris.
- 5. The Contractor shall ensure that existing roadways used to access the project are cleaned af all debris, trash, dirt, mud, etc., throughout the work day.
- 6. The Contractor shall ensure that all tires of construction vehicles are sufficiently cleaned off so that dirt or debris is not tracked off the construction site. Washing off tires with water will not be acceptable unless the runoff is contained and does not enter the storm drain system or onto the State's Row or Maui County, properties.
- 7. All disturbed soil areas shall be restored with hydroseed upon completion of the project at no additional cost to the State.
- 8. Staging area shown is approximate. Staging and stockpile areas shall be coordinated and approved by DOT.

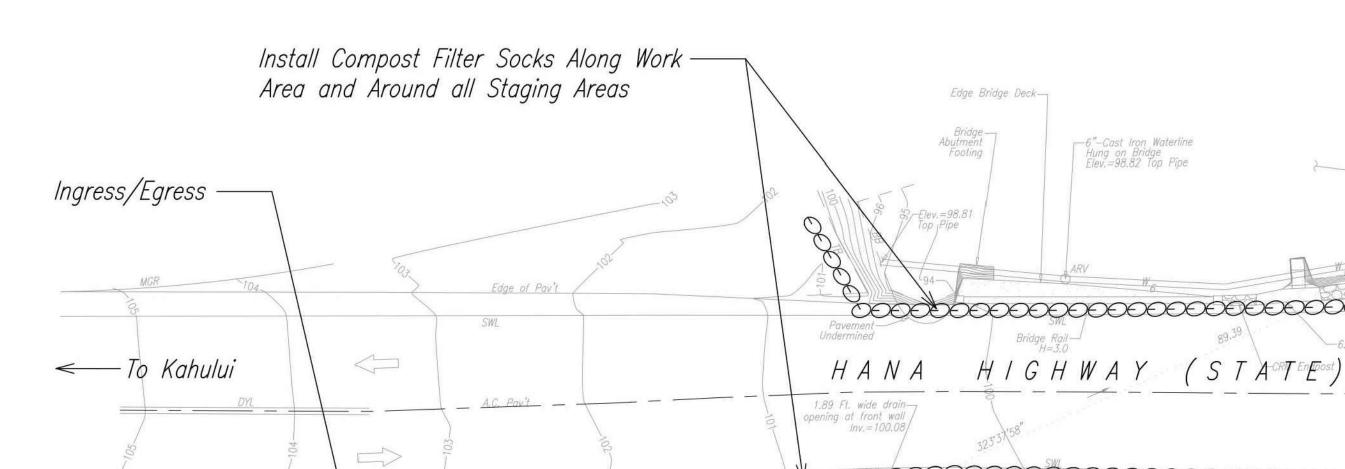

Potential Staging Area

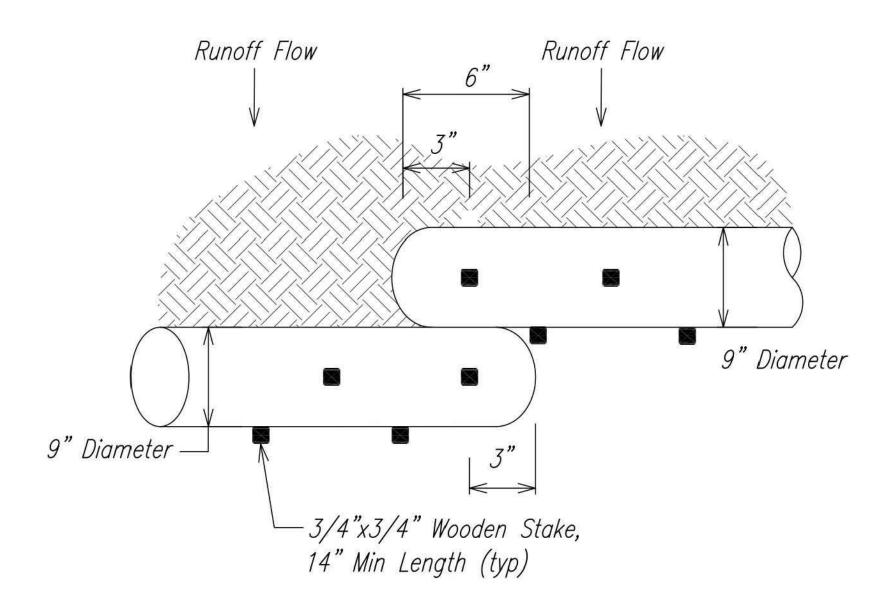

OVERLAPPING (ANCHORING)

1.94 Ft. wide opening-

CRM Retaining Wall-

-CRM Endpost

EROSION CONTROL PLAN

Scale: 1"=10'

Install Compost Filter


Socks Along Work Area —

TRUE NORTH

Scale: 1 in. = 10 ft.

Wood Post— 0.6' Dia. 3' High

Signs: "10 MPH" &: "Slippery When Wet"

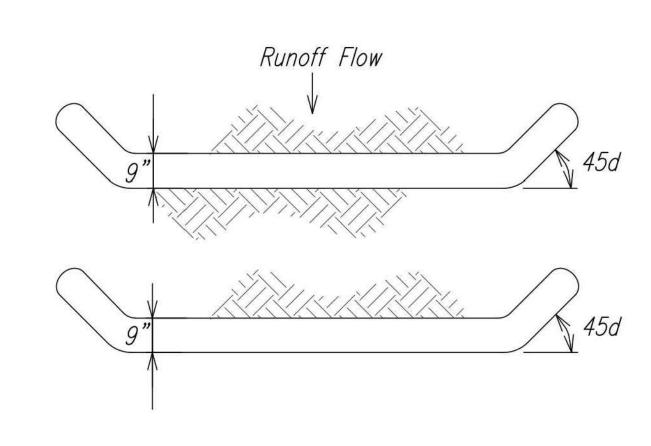

PLAN (SLOPE INTERRUPTION) Not To Scale

FED. ROAD DIST. NO. FISCAL SHEET TOTAL YEAR NO. SHEETS PROJ. NO. STATE 2018 ER-20(006)

<u>Slope Gradient</u>	<u>Wooden Stake Spacing</u>
<4:1	10' on Center
4:1 to 3:1	10' on Center
>3:1 to 2:1	5' to 10' on Center
>2:1	5' on Center

Compost Filter Sock Notes:

- 1. Details provided as a minimum requirement. Contractor also to adhere to manufacturer's installation instructions.
- 2. Stakes not required for installation on flat hard surfaces. Follow manufacturer's recommendations.
- 3. Compost shall be consistent with EPA guidelines.


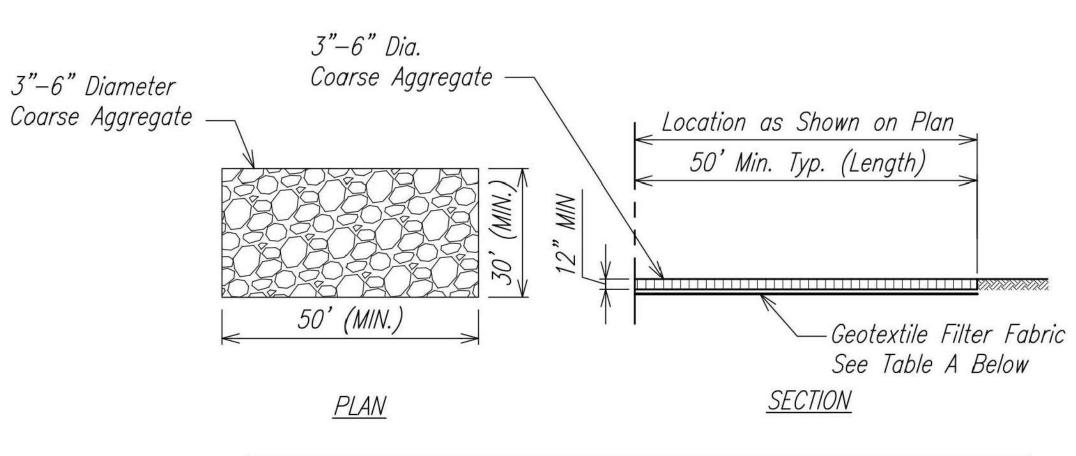


Table A Geotextile Requirements	
Physical Property	Requirements
Grab Tensile Strength	220 Lb (ASTM D1682)
Elongation Failure	60% (ASTM D1682)
Mullen Burst Strength	430 Lb (ASTM D3768)
Puncture Strength	125 Lb (ASTM D751, Modified)
Equivalent Opening	Size 40-80 (US STD Sieve, CW-02215)

STABILIZED INGRESS/EGRESS DETAIL

Not To Scale

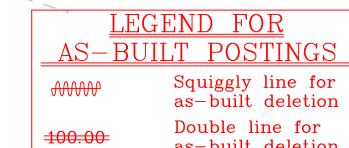

posting


as-built deletion Text for as-built

STATE OF HAWAII DEPARTMENT OF TRANSPORTATION HIGHWAYS DIVISION

Erosion Control Plan

and Details EMERGENCY REPAIRS AT PIINAAU BRIDGE HANA HIGHWAY, NEAR MILEPOST 17.0 PROJECT NO. ER-20(006), UNIT 1

Scale: As Noted Date: September 2018 SHEET No. 7 OF 16 SHEETS

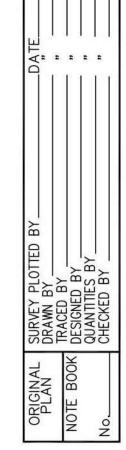

Corrugated Roof
Fenceline H=6.7

Corrugated Roof Fenceline H=6.7

To Hana --->