MINIMUM SPLICE & EMBEDMENT LENGTHS					
	CONCRETE STRENGTH = 4,000 PSI				
	LAP SPLICE		EMBEDMENT		
			STRAIGHT		
BAR SIZE	OTHER BARS	TOP BAR	OTHER BARS	TOP BAR	WITH STANDARD 90° HOOK
#3, #4	21"	29"	12"	17"	7"
#5	26"	36"	15"	21"	9"
#6	31"	43"	18"	26"	10"
#7	39"	54"	23"	32"	12"
#8	51"	71''	30"	42"	14"
#9	64"	90"	38"	53"	15"
#10	81"	114"	48"	67"	17"
#11	100"	140"	59"	82"	19"


## *Notes:*

D = 8d b for #9 to #11

Not to Scale

- 1. "Top Bars" are horizontal bars with 12" or more of concrete cast below.
- 2. Splice lengths may be reduced by multiplying the tabulated values by 0.765 if the centerline of splice of adjacent bars are staggered 6'-0" o.c. for #9 bar and smaller and 9'-0" o.c. for #10 bar and larger.
- 3. Embedment lengths for straight bars may be reduced by multiplying the tabulated values by 0.80 if the bars are spaced laterally not less than 6" center-to-center, with not less than 3" clear cover measured in the direction of the spacing.
- 4. Embedment lengths for bars with 90° hook are bars with side cover, normal to plane of hook, of not less than 21/2" and cover on bar extension beyond hook not less than 2". Increase embedment length by 43% for bars not meeting these requirements.



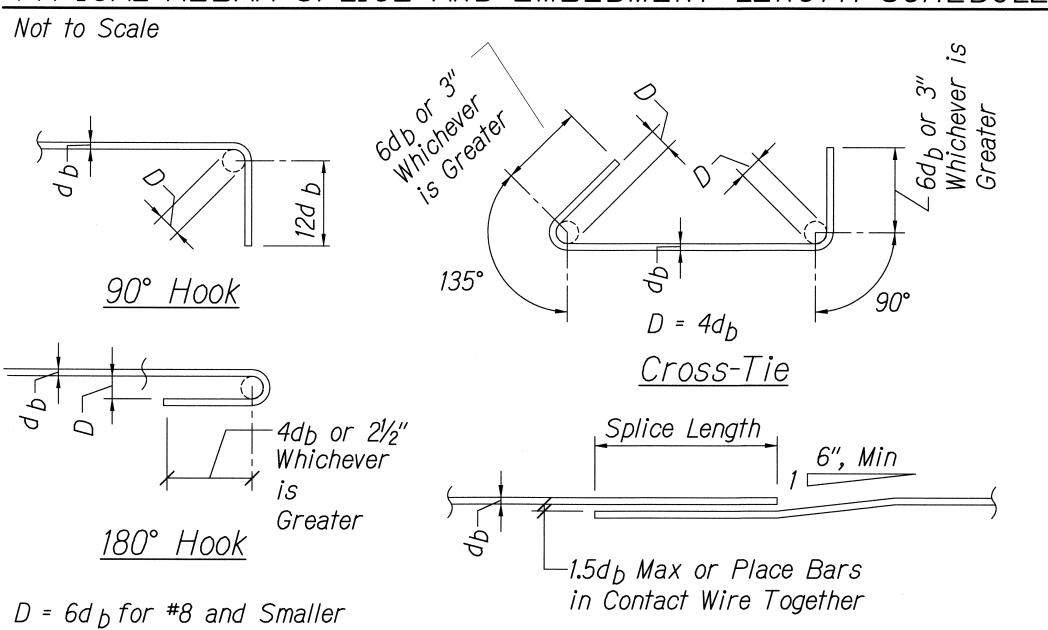

STANDARD HOOKS AND CROSS-TIE DETAIL

<u>Bar Lap</u>

(2) Bars to match -Vert Wall Reinforcement S0.2 S0.2 Typ Vert Bars Typ Horiz Bars TYPICAL WALL HORIZONTAL REINFORCEMENT DETAILS Not to Scale

S0.2 S0.2

Deck

Finish Coat with-

Flashing Compound

2nd Layer Fabric-

Finish Coat with

Flashing Compound

2nd Layer Fabric

Compound

Clean Concrete Surface

First Coat of Flashing

Before Application of

1/2" Built-up Flashing-

Not to Scale

Compound to 1/2"x1/2" Cont


WATERPROOFING DETAIL

Clean Concrete Surface

Before Application of First


Coat of Flashing Compound

FED. ROAD STATE FISCAL SHEET TOTAL YEAR NO. SHEETS PROJ. NO. HAWAII HAW. 360B-01-03 2012 13

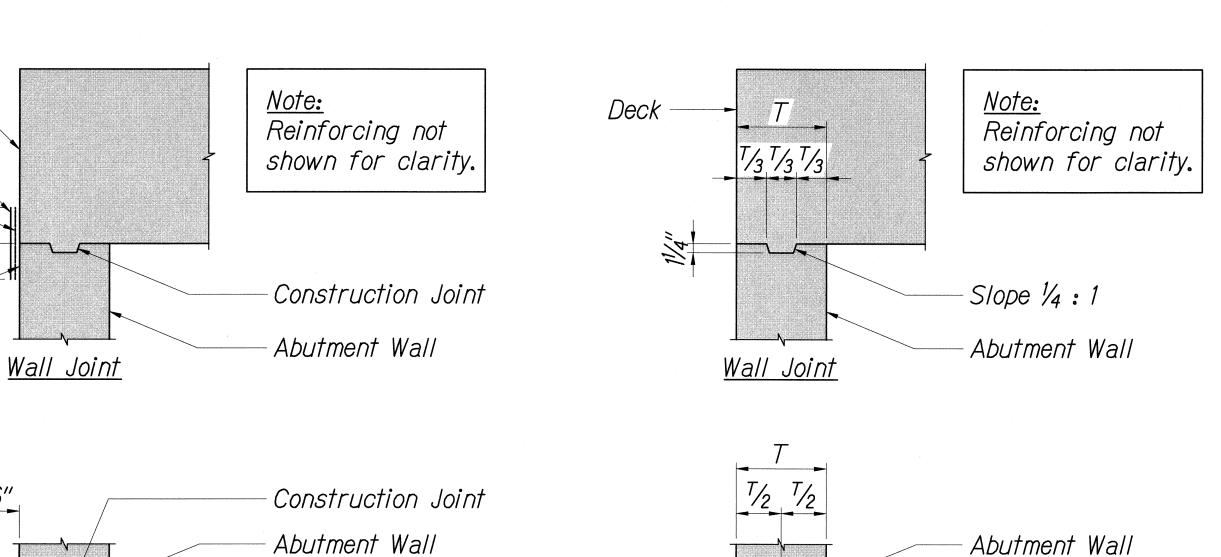

- Footing Wall Footing Joint

TYPICAL CONSTRUCTION JOINT Not to Scale

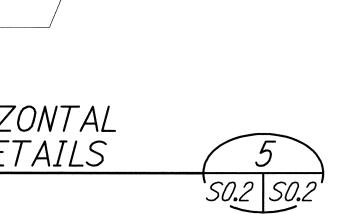

Wall Footing Joint

Footing



EXPIRATION DATE OF THE LICENSE 4/30/2012 THIS WORK WAS PREPARED BY ME OR UNDER MY SUPERVISION

STATE OF HAWAII

DEPARTMENT OF TRANSPORTATION

HIGHWAYS DIVISION TYPICAL DETAILS ROUTE 360 HANA HIGHWAY <u>IMPROVEMENTS</u> UAKEA ROAD TO KEAWA PLACE Project No. 360B-01-03

Date: December 2011 Scale: As Noted **SHEET No.** *S0.2* **OF** *7* SHEETS

15