

FED. ROAD DIST. NO.	STATE	PROJ. NO.	FISCAL YEAR	SHEET NO.	TOTAL SHEETS
HAWAII	HAW.	360A-02-05M	2005	11	27

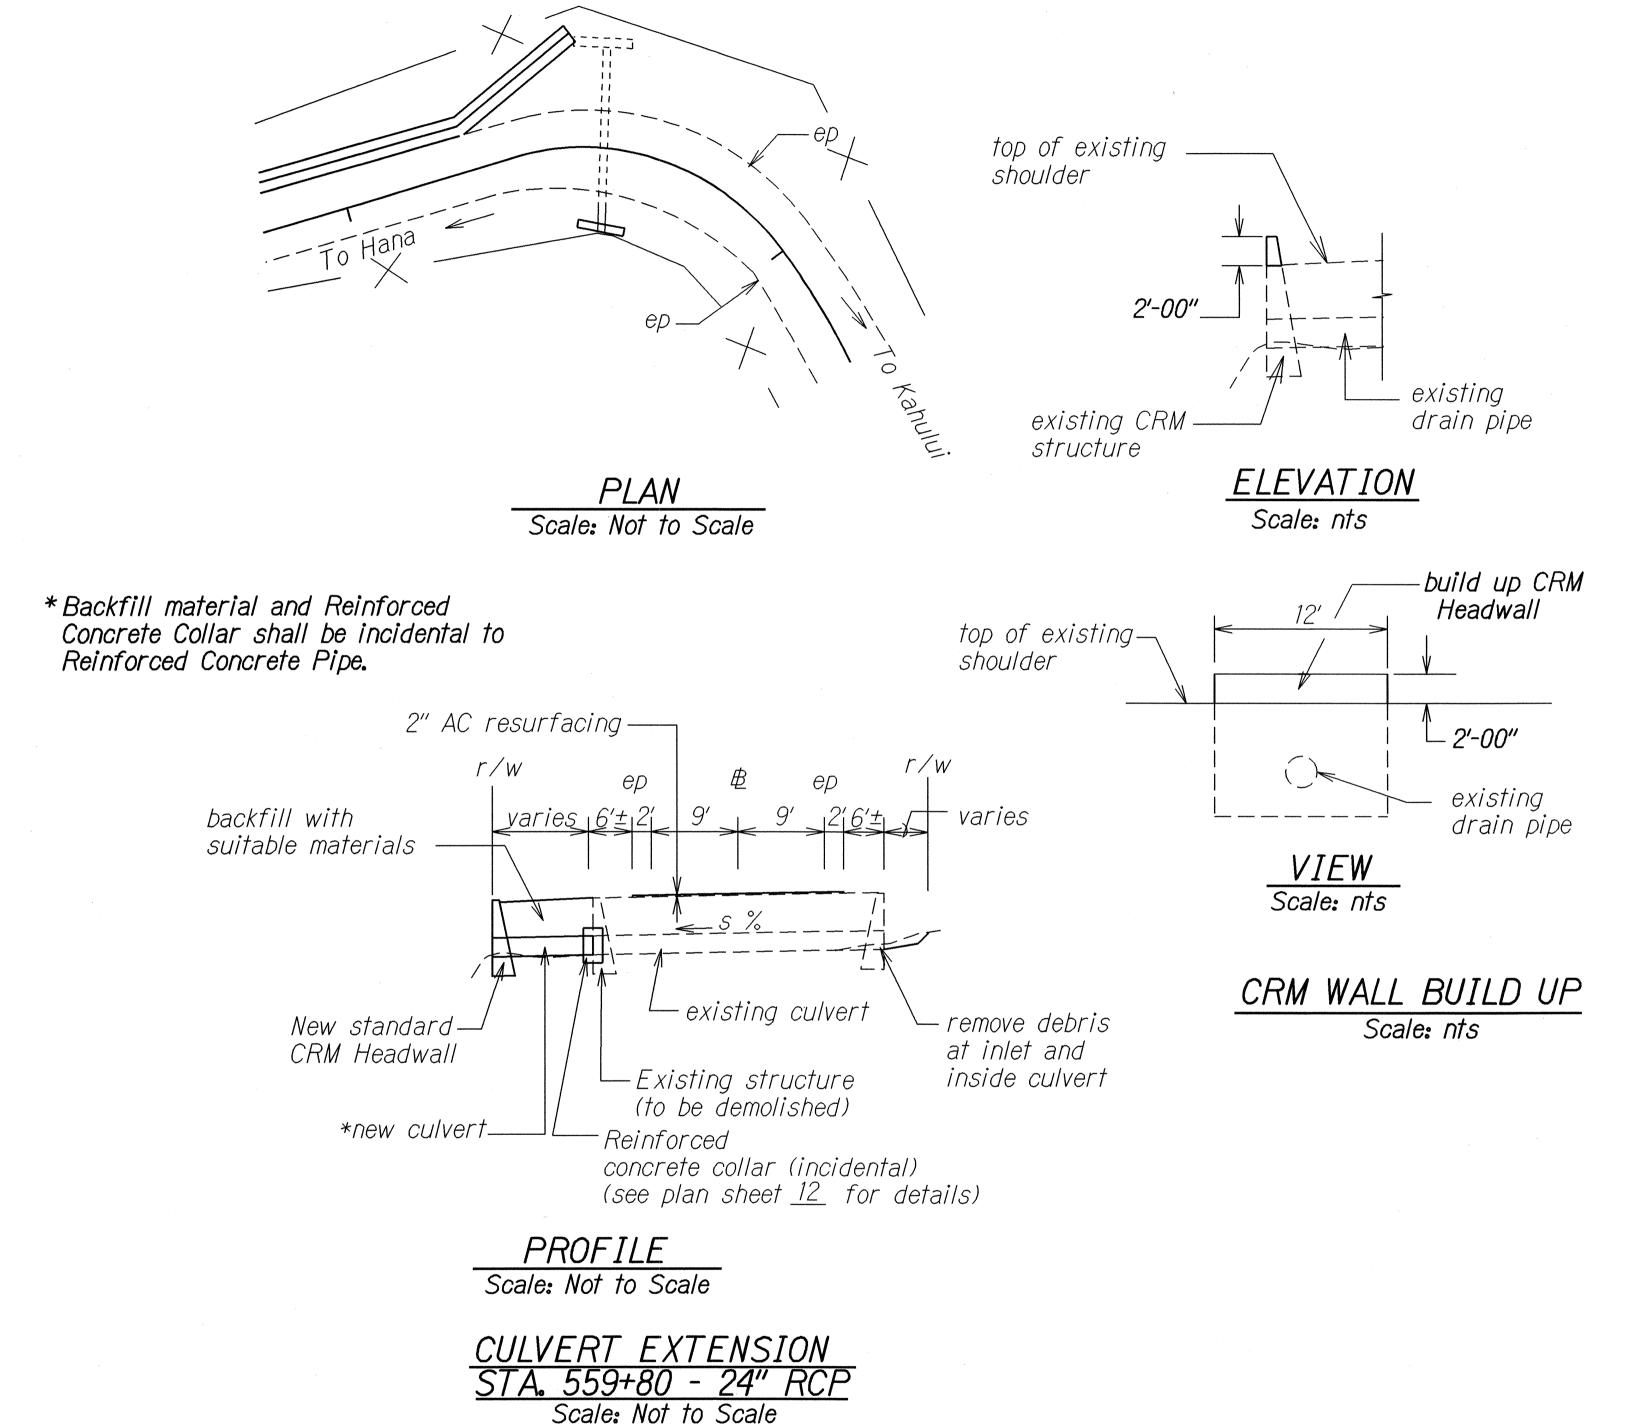


ORIGINAL
PLAN
DRAWN BY IM
TRACED BY
NOTE BOOK
DESIGNED BY IM
Me3.teddy
OUANTITIES BY

CHECKED BY
CHECKED BY
CHECKED BY

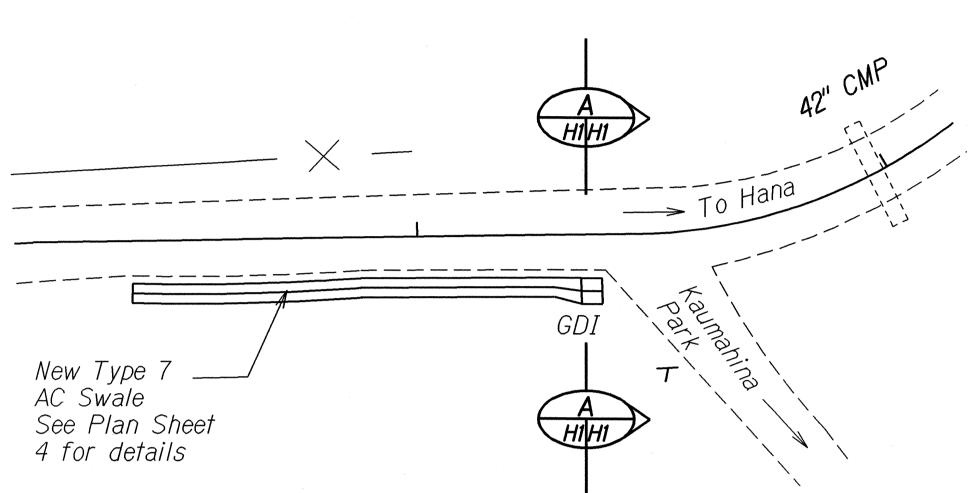

## GDI RECONSTRUCTION DETAIL AT STA. 493+40± RT. Scale: 1"=20'

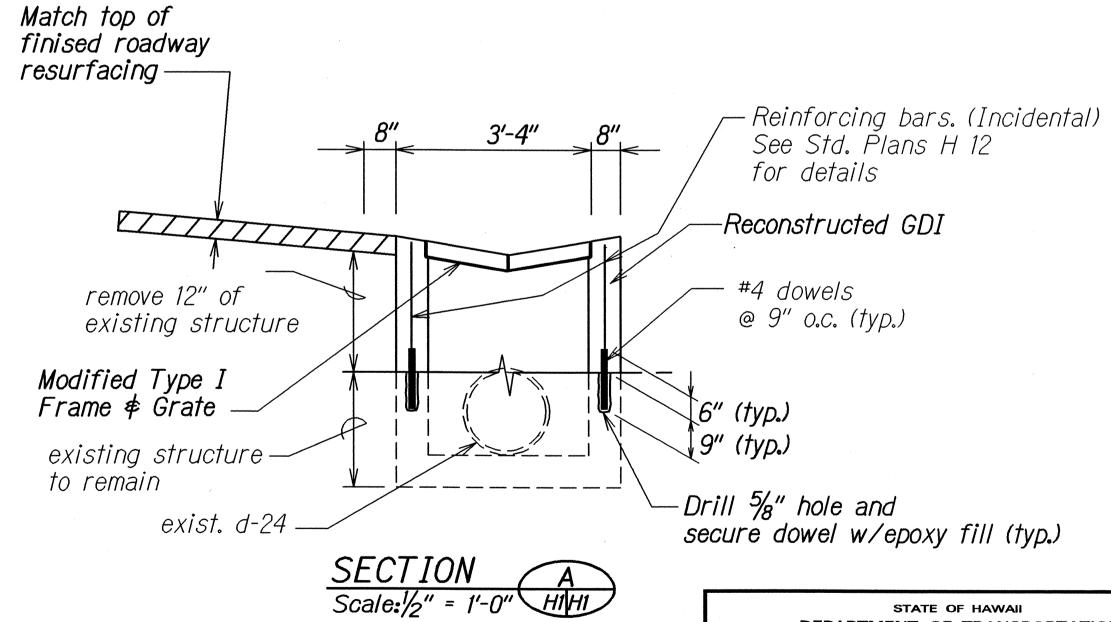

STATE OF HAWAII
DEPARTMENT OF TRANSPORTATION
HIGHWAYS DIVISION

## DRAINAGE PLANS & DETAILS

HANA HIGHWAY RESURFACING
Vicinity of Waikamoi Bridge to Honomanu Bridge
Project No. 360A-02-05M


Scale: As shown


Date: February, 2005

SHEET No. H1 OF 2 SHEETS

11

NOTE: Concrete for concrete collar shall be Class B. Reinforced concrete collar shall not be paid for separately but shall be considered incidental to 24-Inch Reinforced Concrete Pipe, Class IV. FED. ROAD DIST. NO. FISCAL SHEET YEAR NO. STATE PROJ. NO. HAW. 360A-02-05M 2005

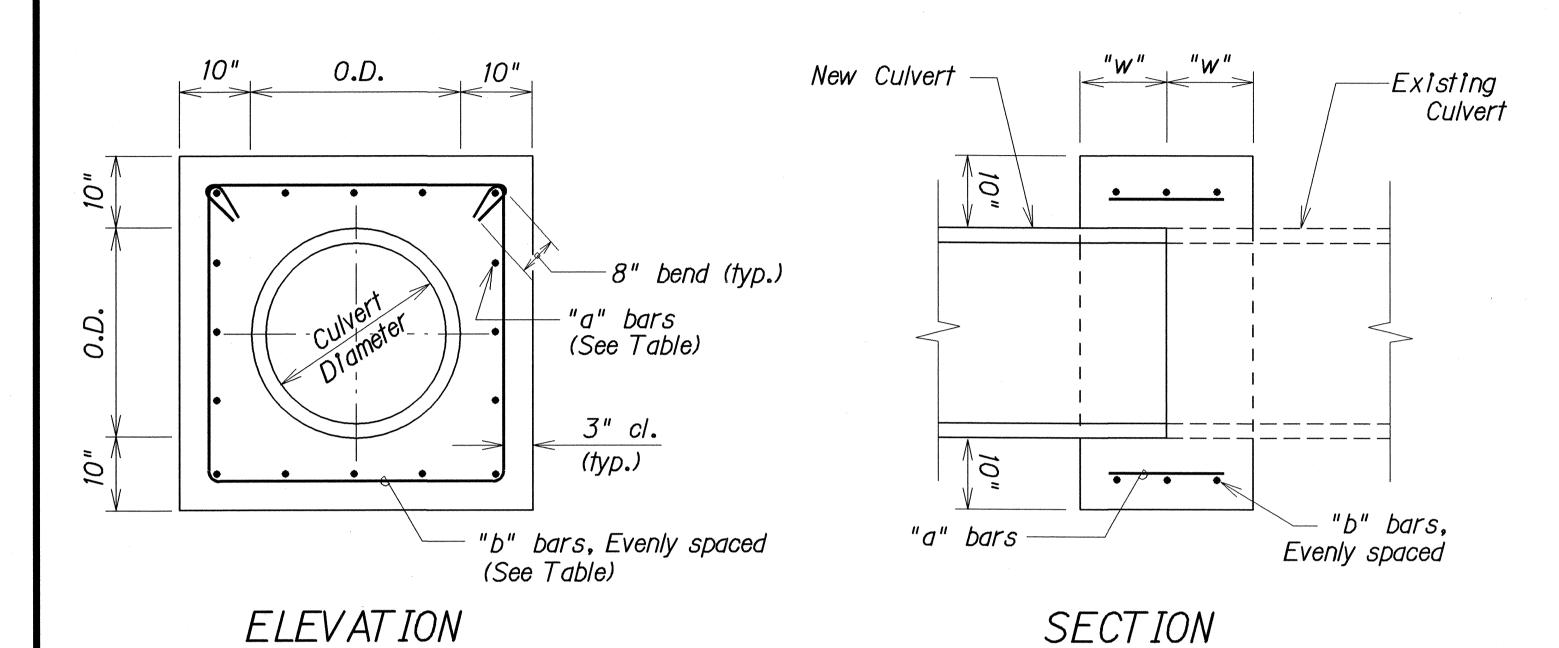


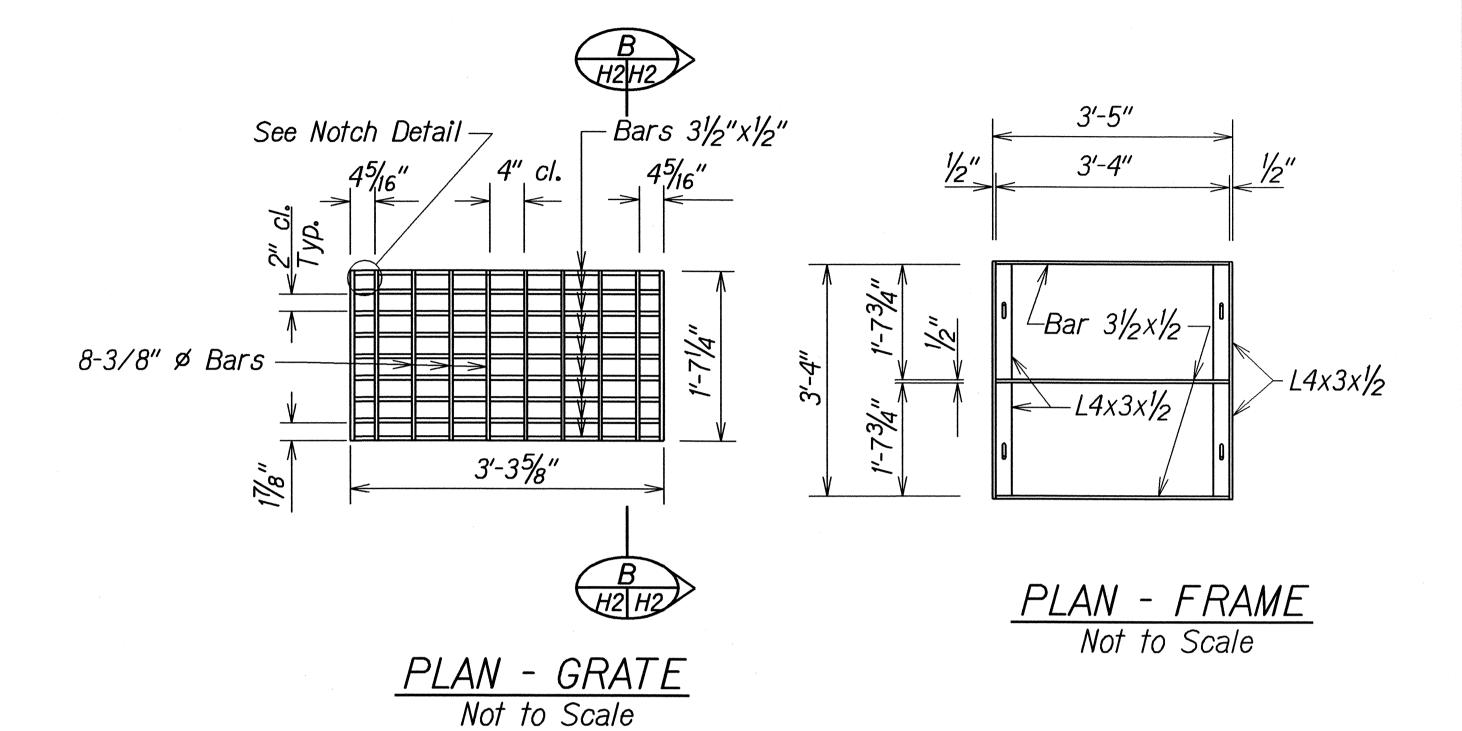


TYPICAL DETAILS OF REINFORCED CONCRETE COLLAR

Culvert Diameter	"a" bars	"b" bars	"w"
18" to 30"	#4 @ 9"	3- #4	12"
36" to 48"	#5 @ 9"	4- #4	15"

Note: Reinforcing Steel for Concrete Collar shall conform to the requirements of ASTM 615-Grade 60.

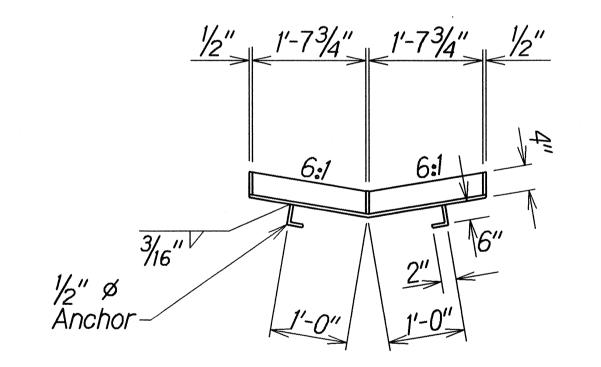

SECTION - FRAME Not to Scale

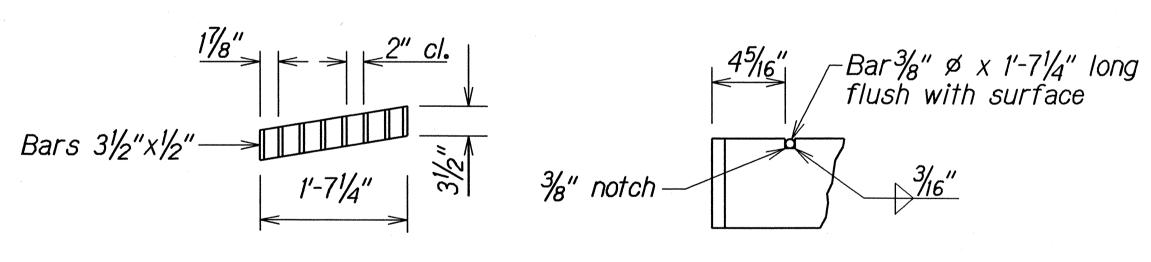

SECTION

NOTCH DETAIL Not to Scale

DETAILS OF MODIFIED TYPE "1" FRAME & GRATES

STATE OF HAWAII DEPARTMENT OF TRANSPORTATION

## DRAINAGE PLANS \* DETAILS

HANA HIGHWAY RESURFACING <u>Vicinity of Waikamoi Bridge to Honomanu Bridge</u> Project No. 360A-02-05M

Scale: As shown

Date: February, 2005

SHEET No. H2 OF 2 SHEETS