LEGEND

TRAFFIC SIGNAL HEADS MOUNTED ON TYPE II SIGNAL STANDARD, ARM SPREAD SHOWN IS 28' AND DISTANCE BETWEEN SIGNAL HEADS SHOWN IS 10'

12" RYG STANDARD TRAFFIC SIGNAL HEAD

STANDARD TRAFFIC AND PEDESTRIAN SIGNAL HEADS MOUNTED ON TYPE I SIGNAL STANDARD, HEIGHT = 10'

12" RYG <G /<Y 4-SECTION DUAL INDICATION TRAFFIC SIGNAL HEAD

CONTROLLER

TYPE "A" PULLBOX

TYPE "B" PULLBOX

TYPE "B" PULLBOX WITH MODIFIED COVER

LOOP DETECTOR, SERIES-PARALLEL CONNECTED

LOOP DETECTOR, SERIES CONNECTED

OPP POWER POLE

WATER VALVE

SEWER MANHOLE **EXISTING STRIPING**

EXISTING PAVEMENT MARKING TO BE REMOVED

NEW STRIPING

NEW PAVEMENT ARROW

NEW CROSSWALK MARKINGS **NEW PAVEMENT WORD**

EXISTING UTILITY LINES AS SHOWN


W = WATER

D = DRAIN

S = SEWER

CONSTRUCTION NOTES

- 1. LOCATIONS OF EXISTING UNDERGROUND STRUCTURES AND UTILITIES, SUCH AS PIPELINES, CONDUITS, CABLES, ETC., SHOWN ON PLANS ARE APPROXIMATE ONLY. IT IS NOT THE INTENT OF THESE PLANS TO SHOW THE EXACT LOCATION OF ALL UNDERGROUND UTILITIES AND STRUCTURES. IT IS THE RESPONSIBILITY OF THE CONTRACTOR TO VERIFY THE LOCATIONS OF ALL EXISTING UTILITIES WITH THE RESPECTIVE OWNERS. EXISTING UTILITIES DAMAGED BY THE CONTRACTOR SHALL BE REPAIRED BY THE CONTRACTOR AT HIS OWN COST.
- 2. THE LOCATIONS OF THE TRAFFIC SIGNAL STANDARDS, TRAFFIC SIGNAL STANDARDS WITH MAST-ARM, PEDESTRIAN PUSH BUTTONS, TRAFFIC CONTROLLERS, PULLBOXES, CONDUITS AND LOOP DETECTORS SHALL BE STAKED OUT IN THE FIELD BY THE CONTRACTOR AND APPROVAL OF THE LOCATIONS SHALL BE OBTAINED FROM THE ENGINEER PRIOR TO CONSTRUCTION AND INSTALLATION.
- 3. ALL TRAFFIC SIGNAL WORK SHALL CONFORM TO THE REQUIREMENTS OF THE "MANUAL ON UNIFORM TRAFFIC CONTROL DEVICES FOR STREETS AND HIGHWAYS", FEDERAL HIGHWAY ADMINISTRATION (1988) AND AMENDMENTS.
- 4. LOCATIONS OF PAVEMENT STRIPING, MARKERS, AND MARKINGS (PAVEMENT ARROWS, STOP LINES, CROSSWALK, ETC.) SHOWN ON THE PLANS SHALL BE VERIFIED WITH THE ENGINEER PRIOR TO THE INSTALLATION OF THE TRAFFIC SIGNAL SYSTEM.
- 5. MAINTENANCE OF TRAFFIC THROUGH THE CONSTRUCTION AREA SHALL BE IN ACCORDANCE WITH PART VI OF THE "MANUAL ON UNIFORM TRAFFIC CONTROL DEVICES FOR STREETS AND HIGHWAYS", FEDERAL HIGHWAY ADMINISTRATION (1988) AND AS SPECIFIED IN THE SPECIAL PROVISIONS. THE CONTRACTOR SHALL FURNISH AND MAINTAIN ADEQUATE BARRICADES, BLINKERS, CONSTRUCTION SIGNS, ETC. FOR THE SAFETY OF THE MOTORING PUBLIC.

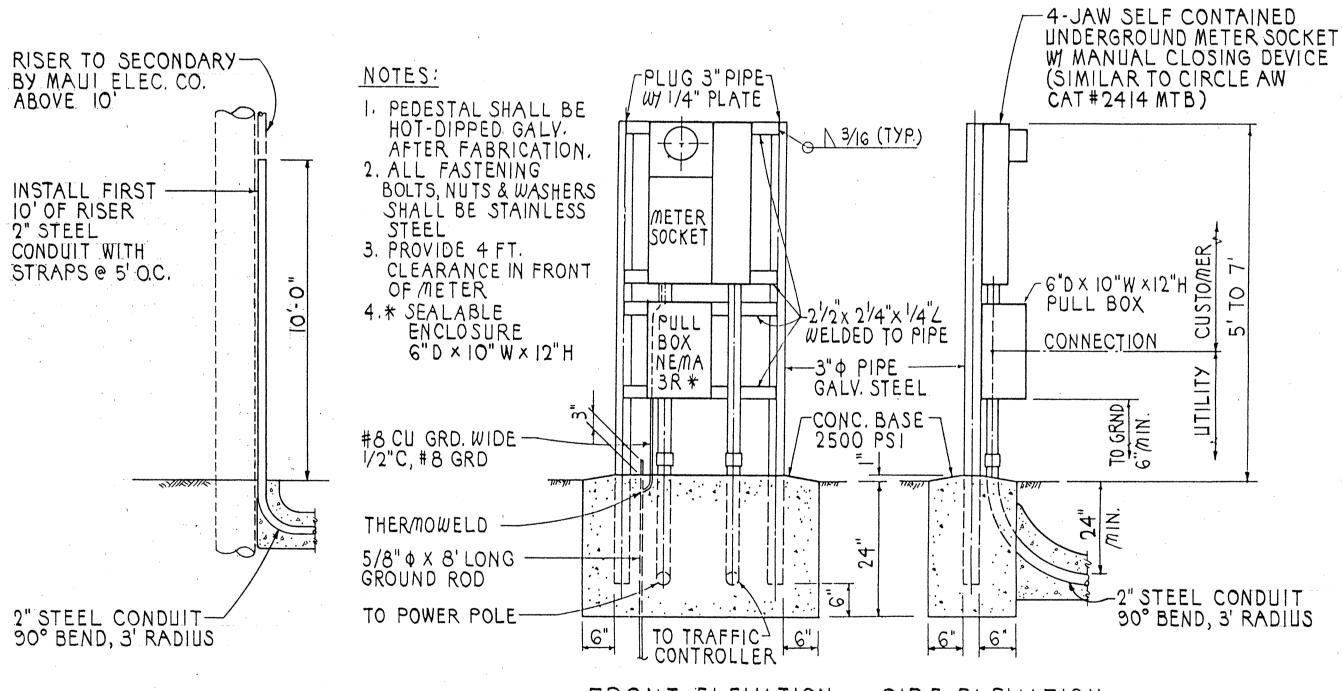

FRONT ELEVATION SIDE ELEVATION METER PEDESTAL FOR UNDERGROUND SERVICE NOT TO SCALE

NOTES


- 1. MAUI ELECTRIC CO. SHALL FURNISH AND INSTALL CABLE BETWEEN SECONDARY AND METER SOCKET.
- 2. CONTRACTOR SHALL MAKE ALL ELECTRICAL CONNECTIONS TO CONTROLLER, PROVIDE BREAKER, GROUND AND CONCRETE-ENCASED 2" STEEL CONDUIT.
- 3. CONTRACTOR SHALL PROVIDE MAUI ELECTRIC CO. ONE WEEK ADVANCE NOTICE FOR ANY WORK BY MAUI ELECTRIC CO.

ELECTRICAL SERVICE DETAIL

NOT TO SCALE

TRAFFIC SIGNAL NOTES

- 1. ALL TRAFFIC SIGNAL CONTROLLER EQUIPMENT SHALL BE COMPLETELY WIRED IN THE CABINET AND SHALL CONTROL THE TRAFFIC SIGNALS AS CALLED FOR ON THE PLANS.
- 2. SIGNAL INDICATIONS DURING CLEARANCE INTERVAL:
 - A. IF A SIGNAL IS G OR $\neg G$ AND WILL REMAIN G OR $\neg G$ DURING THE NEXT PHASE, IT SHALL BE G OR -G DURING THE CLEARANCE INTERVAL.
 - B. IF A SIGNAL IS G OR \rightarrow G AND WILL BECOME R OR EXTINGUISHED DURING THE NEXT PHASE, IT SHALL BE Y OR Y DURING THE CLEARANCE INTERVAL.
 - C. IF A SIGNAL IS R AND WILL REMAIN R OR BECOMES G DURING THE NEXT PHASE, IT SHALL REMAIN R DURING THE CLEARANCE INTERVAL.
- 3. THE LOOP AMPLIFIER UNITS FURNISHED FOR THIS PROJECT SHALL BE CAPABLE OF OPERATING THE LOOP DETECTOR CONFIGURATIONS SHOWN ON THE PLANS.
- 4. DETECTOR ASSIGNMENT SHALL BE PER CALIFORNIA DEPARTMENT OF TRANSPORTATION "TRAFFIC SIGNAL CONTROL LOCAL INTERSECTION PROGRAM", JULY, 1978.
- 5. CONTRACTOR SHALL FURNISH 50-AMP. CIRCUIT BREAKERS.
- 6. A SOLID #8 BARE COPPER WIRE SHALL BE PULLED WITH THE TRAFFIC CONTROL CABLE FOR EQUIPMENT GROUND. COST SHALL BE INCIDENTAL TO THE INSTALLATION OF THE CONTROL CABLE.
- 7. SHOULD ANY DEFECT BE ENCOUNTERED DURING THE WARRANTY PERIOD, THE MANUFAC-TURER WILL BE NOTIFIED AND HE SHALL PROMPTLY CORRECT SUCH DEFECT. SERVICE CALL (BY FACTORY QUALIFIED REPRESENTATIVE) DURING THE WARRANTY PERIOD FOR REPAIRS OR OTHER MAINTENANCE SHALL BE ANSWERED WITHIN 24 HOURS AND SHALL BE DONE AT NO EXPENSE WHATSOEVER TO THE STATE. ALL REPAIRS SHALL BE DONE AS SOON AS POSSIBLE.

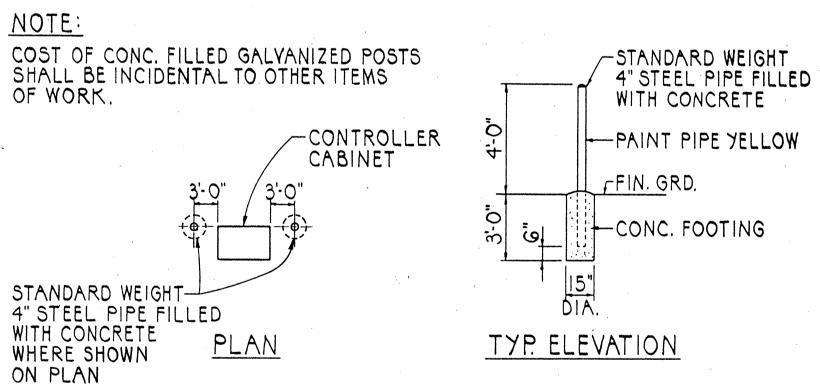

PIPE GUARD DETAIL NOT TO SCALE



OR UNDER MY SUPERVISION

STATE OF HAWAII DEPARTMENT OF TRANSPORTATION HIGHWAYS DIVISION

LEGEND AND NOTES

HANA HIGHWAY TRAFFIC SIGNALS AT BALDWIN AVENUE PROJECT NO. 36A-01-90

SCALE: AS NOTED

DATE: FEB. 8, 1991

SHEET No. | OF | SHEETS

ENCASE IN CONC.

-2" STEEL CONDUIT

CLASS "B"