

90°Elbow ____ Street Elbow

Water Main

STANDARD

DETAILS

1987 1985

REVISION

INTERIM

25

Bothways

Alternate location

or smaller

AIR RELIEF VALVE MANHOLE

SECTION THROUGH MANHOLE


SCALE: NTS

of water main if 12"

Position air relief valve assembly 4" front or back from inside

MAUI

wall of manhole

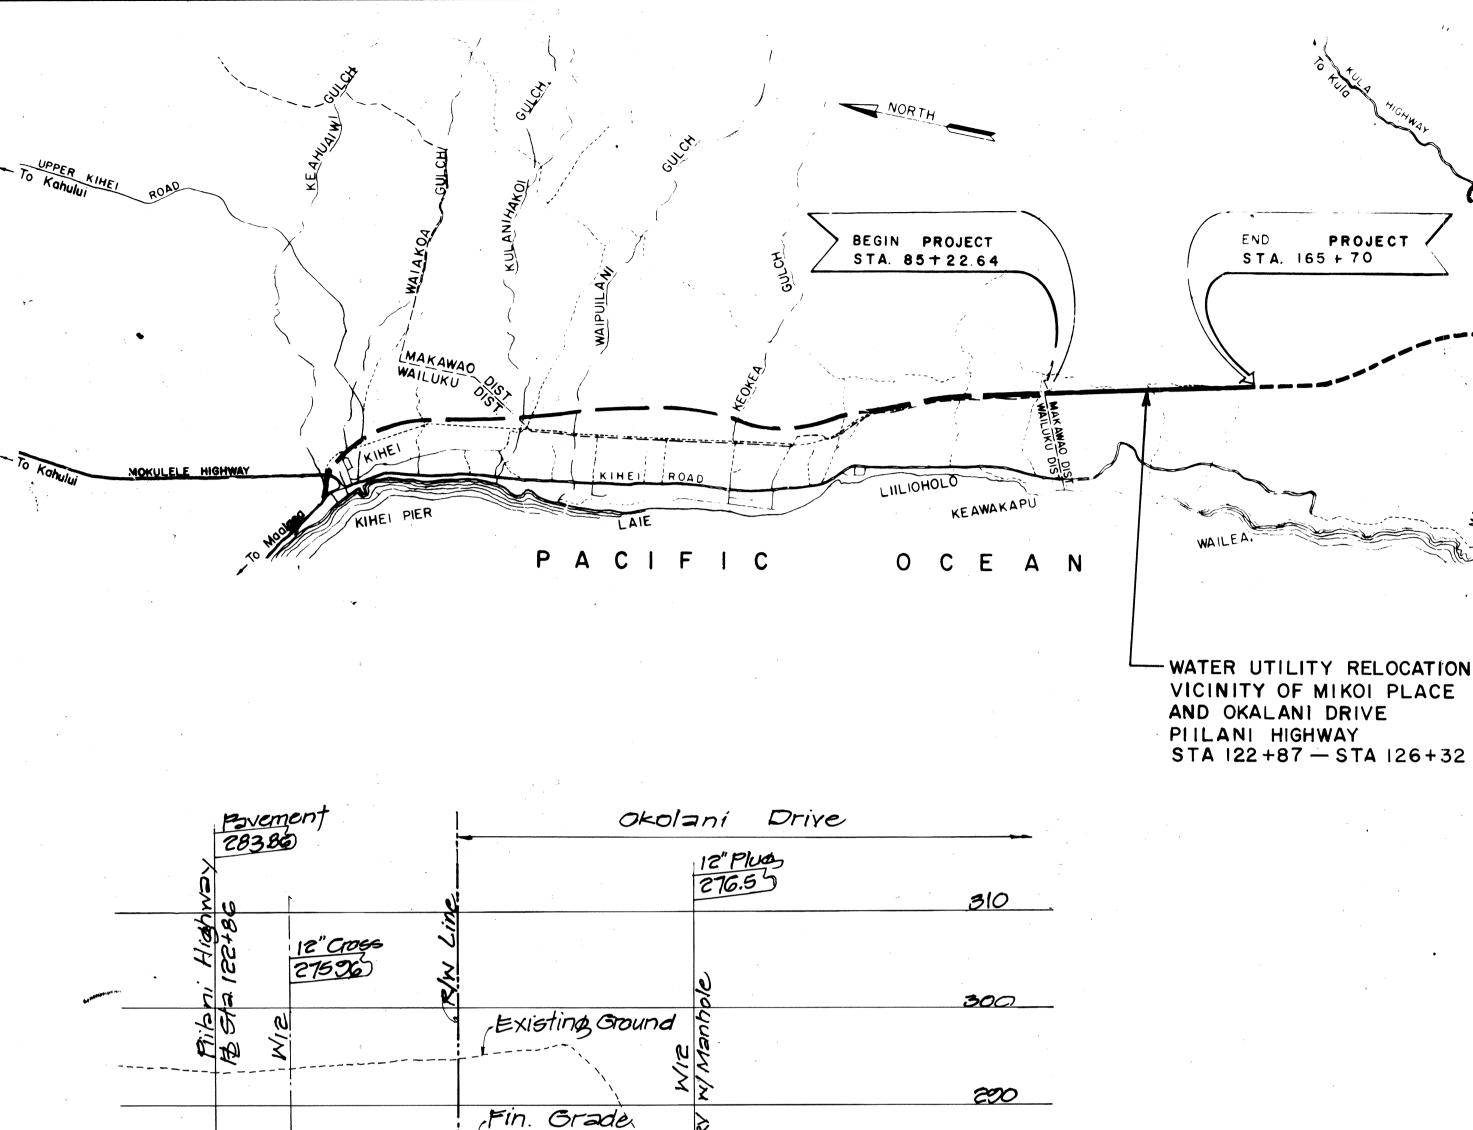

280

270

260

DEPARTMENT OF WATER SUPPY

LIMITED TO WATER SYSTEM WHICH WILL BE OTHE DEPARTMENT)

-12" Waterline Invert.

12" WATERLINE PROFILE AT OKOLANI DRIVE SCALE: HORIZ 1"=20' YERT. 1" = 101

FISCAL YEAR FED. ROAD DIST. NO. FED. AID PROJ. NO. SHEET NO. SHEETS F-031-1(1) HAW. HAWAII

VICINITY MAP

SCALE: | in = 4000 ft

CHLORINATION OF WATER SYSTEMS:

- 1. LIQUID CHLORINE OR CALCIUM HYPOCHLORITE, CONFIRMING TO AWWA STANDARDS SHALL BE USED FOR THE CHLORINATION OF THE PROJECT.
- 2. PRIOR TO CHLORINATION, THE PROJECT SHALL BE THOROUGHLY
- 3. THE INTERIOR SURFACES OF THE PROJECT SHALL BE EXPOSED TO THE CHLORINATION SOLUTION FOR A MINIMUM OF 24 HOURS AND THE CHLORINE RESIDUAL SHALL NOT BE LESS THAN 10 PPM AFTER SUCH TIME.
- 4. SHOULD CALCIUM HYPOCHLORITE BE USED, NO SOLID AND/OR UNDISSOLVED PORTION OF THE COMPOUND SHALL BE INTRODUCED INTO ANY SECTION OF THE PROJECT TO BE CHLORINATED.
- 5. AT THE END OF THE 24 HOUR PERIOD, REPRESENTATIVE SAMPLES SHALL BE TAKEN AND ANALYZED TO ASSURE A CHLORINE RESIDUAL OF AT LEAST 10 PPM.
- 6. SHOULD THE RESULTS INDICATE ADEQUATE CHLORINATION, THE PROJECT SHALL BE THOROUGHLY FLUSHED AND FILLED WITH WATER FROM THE EXISTING SYSTEM AND AGAIN TESTED FOR CHLORINE RESIDUAL. THE FLUSHING SHALL BE CONSIDERED ADEQUATE IF THE TEST RESULTS INDICATE THAT THE WATER IN THE PROJECT HAS A COMPARABLE CHLORINE RESIDUAL AS THE WATER IN THE EXISTING SYSTEM.
- 7. ON THE FIRST AND THIRD DAYS FOLLOWING THE ACCEPTABLE FLUSHING OF THE PROJECT, SAMPLES FROM REPRESENTATIVE POINTS IN THE PROJECT SHALL BE TAKEN AND SUBJECTED TO MICROBIOLOGICAL TESTS. POSITIVE RESULTS WILL NOT BE ACCEPTABLE AND THE PROCESS WILL BE REPEATED.
- 8. ANALYZES FOR RESIDUAL CHLORINE SHALL BE MADE IN ACCORDANCE WITH "STANDARD METHODS FOR THE EXAMINATION OF WATER AND WASTEWATER", AMERICAN PUBLIC HEALTH ASSOCIATION, 13TH EDITION, PP. 117-123.
- 9. MICROBIOLOGICAL TESTS SHALL BE MADE IN ACCORDANCE WITH "STANDARD METHODS FOR THE EXAMINATION OF WATER AND WASTEWATER", AMERICAN PUBLIC HEALTH ASSOCIATION, 13TH EDITION, PP. 662-688.
- 10. ALL MEASUREMENTS FOR CHLORINE RESIDUAL AND MICRO-BIOLOGICAL TESTS SHALL BE PERFORMED BY A LABORATORY APPROVED BY THE DIRECTOR.
- 11. THE DEVELOPER/CONTRACTOR SHALL BE RESPONSIBLE FOR ALL COSTS ASSOCIATED WITH ALL OF THE FOREGOING.

TRANS — MERIDIAN ENGINEERS & SURVEYORS 864 S. BERETANIA STREET HONOLULU, HAWAII 96813 REGISTERED PRUTESSIONAL ENGINEER

3-29-88

DATE

STATE OF HAWAII DEPARTMENT OF TRANSPORTATION HIGHWAYS DIVISION

WATER UTILITY PLAN

PILANI HIGHWAY VICINITY OF KILOHANA STREET

TO WAILEA IKE DRIVE FA PROJECT F-031-1(3)

SHEET No. 1

SCALE: AS SHOWN

DATE: JAN. 1988

THIS WORK WAS PEPARED BY
MY OR UNDER MY SUPERVISION

OF 2 SHEETS

